INDEX OF SHEETS

SHT NO.	DESCRIPTION
1 2 3 4-12 13-20 21-23A	COVER SHEET INDEX OF SHEETS, HIGHWAY STANDARDS, AND GENERAL NOTES LOCATION MAP SUMMARY OF QUANTITIES DISTRICT ONE STANDARD TRAFFIC SIGNAL DESIGN DETAILS DISTRICT ONE LIGHTING DETAILS
	TRAFFIC SIGNAL PLANS:
24 25-29 30-34 35-39 40-44 45-49 50-54 55-59 60-64 65-69 70-77	RETROREFLECTIVE TRAFFIC SIGNAL BACKPLATES TS 22531: US RTE 6 - US RTE 30 EB (JEFFERSON ST) AT US RTE 6 - IL RTE 53 NB (SCOTT ST) TS 21780: US RTE 6 - US RTE 30 WB (CASS ST) AT EASTERN AVE TS 21803: US RTE 6 - US RTE 30 WB (CASS ST) AT IL RTE 53 NB (SCOTT ST) TS 22526: US RTE 30 (JEFFERSON ST) AT US RTE 30 (CENTER ST) TS 22527: US RTE 30 EB (JEFFERSON ST) AT HICKORY ST TS 22528: US RTE 30 BE (JEFFERSON ST) AT JOLIET ST TS 22534: US RTE 30 WB (CASS ST) AT JOLIET ST TS 22533: US RTE 30 WB (WESTERN AVE) AT HICKORY ST TS 21802: IL RTE 53 NB (SCOTT ST) AT JACKSON ST INTERCONNECT PLANS
	LIGHTING PLANS:
78-79 80 81-82 83 84 85-86 87-88	TS 22531: US RTE 6 - US RTE 30 EB (JEFFERSON ST) AT US RTE 6 - IL RTE 53 NB (SCOTT ST) TS 21780: US RTE 6 - US RTE 30 WB (CASS ST) AT EASTERN AVE TS 22527: US RTE 30 EB (JEFFERSON ST) AT HICKORY ST TS 22528: US RTE 30 EB (JEFFERSON ST) AT JOLIET ST TS 22534: US RTE 30 WB (CASS ST) AT JOLIET ST TS 22533: US RTE 30 WB (WESTERN AVE) AT HICKORY ST TS 22532: US RTE 30 WB (SCOTT ST) AT JACKSON ST
89 90	TRAFFIC CONTROL AND PROTECTION FOR SIDE ROADS, INTERSECTIONS, AND DRIVEWAYS (TC-10) ARTERIAL ROAD INFORMATION SIGN (TC-22)

HIGHWAY STANDARDS

STD. NO.	TITLE
000001-07	STANDARD SYMBOLS, ABBREVIATIONS, AND PATTERNS
001001-02	AREAS OF REINFORCEMENT BARS
001006	DECIMAL OF AN INCH AND OF A FOOT
701001-02	OFF-RD OPERATIONS, 2L, 2W MORE THAN 15' (4.5m) AWAY
701006-05	OFF-RD OPERATIONS, 2L, 2W, 15' (4.5m) TO 24" (600mm) FROM PAVEMENT EDGE
701101-05	OFF-RD OPERATIONS, MULTILANE, 15' (4.5 m) TO 24" (600 mm) FROM PAVEMENT EDGE
701106-02	OFF-RD OPERATIONS, MULTILANE, MORE THAN 15' (4.5m) AWAY
701601-09	URBAN LANE CLOSURE, MULTILANE, 1W OR 2W WITH NONTRAVERSABLE MEDIAN
701606-10	URBAN SINGLE LANE CLOSURE, MULTILANE, 2W WITH MOUNTABLE MEDIAN
701701-10	URBAN LANE CLOSURE, MULTILANE INTERSECTION
701801-06	SIDEWALK, CORNER OR CROSSWALK CLOSURE
701901-08	TRAFFIC CONTROL DEVICES
720001-01	SIGN PANEL MOUNTING DETAILS
805001-01	ELECTRICAL SERVICE INSTALLATION DETAILS
814001-03	HANDHOLES
814006-02	DOUBLE HANDHOLES
857001-01	STANDARD PHASE DESIGNATION DIAGRAMS AND PHASE SEQUENCES
862001-01	UNINTERRUPTABLE POWER SUPPLY (UPS)
873001-02	TRAFFIC SIGNAL GROUNDING & BONDING
877001-08	STEEL MAST ARM ASSEMBLY AND POLE 16' THROUGH 55'
877002-04	STEEL MAST ARM ASSEMBLY AND POLE 56' THROUGH 75'
877011-10	STEEL COMB. MAST ARM ASSEMBLY AND POLE 16' THROUGH 55'
877012-07	STEEL COMB. MAST ARM ASSEMBLY AND POLE 56' THROUGH 75'
878001-10	CONCRETE FOUNDATION DETAILS
880001-01	SPAN WIRE MOUNTED SIGNALS AND FLASHING BEACON INSTALLATION
880006-01	TRAFFIC SIGNAL MOUNTING DETAILS
886001-01	DETECTOR LOOP INSTALLATIONS

GENERAL NOTES

BEFORE STARTING ANY EXCAVATION. THE CONTRACTOR SHALL CALL "J.U.L.I.E," AT (800) 892-0123 OR 811 FOR FIELD LOCATIONS OF BURIED ELECTRIC, TELEPHONE AND GAS UTILITIES. 48 HOUR NOTIFICATION IS REQUIRED.

THE CONTRACTOR SHALL CONTACT THE TRAFFIC CONTROL SUPERVISOR AT KALPANA.KANNAN-HOSADURGA@ILLINOIS.GOV, 72 HOURS IN ADVANCE OF BEGINNING

IT SHALL BE THE CONTRACTOR'S RESPONSIBILITY TO VERIFY ALL DIMENSIONS AND CONDITIONS EXISTING IN THE FIELD PRIOR TO ORDERING MATERIALS AND BEGINNING CONSTRUCTION. THIS SHALL INCLUDE LOCATING THE MAST ARM FOUNDATIONS AND VERIFYING THE MAST ARMS LENGTHS.

THE EXACT LOCATION OF ALL UTILITIES SHALL BE FIELD VERIFIED BY THE CONTRACTOR BEFORE ORDERING ANY MATERIALS AND STARTING ANY WORK. FOR LOCATIONS OF UTILITIES, LOCALLY OWNED EQUIPMENT, LEASED ENFORCEMENT CAMERA SYSTEM FACILITIES AND IDOT UNDERGROUND FACILITIES. CONTACT THE LOCAL COUNTIES. MUNICIPALITIES AND IDOT FOR LOCATES. THE CONTRACTOR SHALL CALL "JULIE" AT (800) 892-0123 OR 811, IN THE CITY OF CHICAGO CONTACT DIGGER AT (312) 744-7000 FOR FIELD LOCATIONS OF BURIED UTILITIES (48 HOURS NOTIFICATION REQUIRED).

IF THIS CONTRACT REQUIRES THE SERVICES OF AN ELECTRICAL CONTRACTOR. THE CONTRACTOR SHALL BE RESPONSIBLE AT HIS/HER OWN EXPENSE FOR LOCATING EXISTING IDOT ELECTRICAL FACILITIES PRIOR TO PERFORMING ANY WORK. IF THIS CONTRACT DOES NOT REQUIRE THE SERVICES OF AN ELECTRICAL CONTRACTOR. THE CONTRACTOR MAY REQUEST ONE FREE LOCATE FOR EXISTING IDOT ELECTRICAL FACILITIES FROM THE DISTRICT ONE ELECTRICAL MAINTENANCE CONTRACTOR PRIOR TO THE START OF ANY WORK. ADDITIONAL REQUESTS MAY BE AT THE EXPENSE OF THE CONTRACTOR. THE LOCATION OF UNDERGROUND TRAFFIC FACILITIES DOES NOT RELIEVE THE CONTRACTOR OF THEIR RESPONSIBILITY TO REPAIR ANY FACILITIES DAMAGED DURING CONSTRUCTION AT THEIR EXPENSE

THE CONTRACTOR SHALL CHECK THE PROPOSED TRAFFIC SIGNAL EQUIPMENT LOCATIONS FOR OVERHEAD UTILITY CONFLICTS. THE CONTRACTOR SHALL COORDINATE ANY CONFLICTS WITH THE UTILITY COMPANIES AND RESIDENT ENGINEER BEFORE ORDERING MATERIALS.

THE CONTRACTOR SHALL COORDINATE CONSTRUCTION ACTIVITIES WITH UTILITY COMPANIES, LOCAL GOVERNMENT AGENCIES AND IDOT.

RESTORATION OF THE TRAFFIC SIGNAL WORK AREA SHALL BE INCLUDED IN THE RELATED PAY ITEM SUCH AS FOUNDATION, CONDUIT, HANDHOLE, ETC., AND NO EXTRA COMPENSATION SHALL BE ALLOWED. ALL ROADWAY SURFACES SUCH AS SHOULDERS, MEDIAN, SIDEWALKS, PAVEMENT, ETC. SHALL BE REPLACED IN KIND. ALL DAMAGE TO MOWED LAWNS SHALL BE REPLACED WITH AN APPROVED SOD, AND ALL DAMAGED TO UNMOWED FIELDS SHALL BE SEEDED IN ACCORDANCE WITH STANDARD SPECIFICATIONS 252 AND 250 RESPECTIVELY.

THE CONTRACTOR SHALL BE RESPONSIBLE FOR THE PROTECTION OF ALL UNDERGROUND AND SURFACE UTILITIES EVEN THOUGH THEY MAY NOT BE SHOWN ON THE PLANS. ANY UTILITY THAT IS DAMAGED DURING CONSTRUCTION SHALL BE RESTORED TO A CONDITION EQUAL TO THAT EXISTING BEFORE THE DAMAGE INCURRED. THIS WORK SHALL BE AT THE CONTRACTOR'S EXPENSE.

THE HOLE FOR THE EXISTING CONDUIT TO BE ABANDONED THROUGHOUT THIS PROJECT AT ANY EXISTING HANDHOLES WILL BE PLUGGED UPON COMPLETION OF THE TRAFFIC SIGNAL WORK.

PARTIAL PAYMENT AS DESCRIBED IN ARTICLE 109.07(b) OF THE STANDARD SPECIFICATIONS WILL NOT BE ALLOWED FOR ITEMS INCLUDED IN THIS CONTRACT.

LOCATIONS WITH PEDESTRIAN EQUIPMENT HAVE BEEN DESIGNED TO BE ADA COMPLIANT. ANY DEVIATION FROM THE THE PLANS FOR TRAFFIC SIGNAL MAST ARM/POSTS THAT HAVE PEDESTRIAN EQUIPMENT WILL HAVE TO BE APPROVED BY THE ENGINEER TO INSURE ADA

CONTRACTOR SHALL ABANDON EXISTING CABLES IN CONDUIT UNLESS NOTED OTHERWISE ON THE PLANS. ALL ABANDONED CABLES SHALL BE TAGGED AND LABELED "ABANDONED" AT ALL HANDHOLES THEY PASS THROUGH OR TERMINATE IN. THIS WORK SHALL BE INCLUDED IN THE PAY ITEM "REMOVE EXISTING TRAFFIC SIGNAL EQUIPMENT" AND NO EXTRA COMPENSATION SHALL BE MADE.

THE CONTRACTOR'S ATTENTION IS DIRECTED TO THE FACT THAT BORING AND DRILLING THROUGH BEDROCK AND COBBLE DEFINED AS ROCK HEREIN MAY BE REQUIRED. IF BORING AND/OR DRILLING THROUGH ROCK IS REQUIRED, THE CONTRACTOR WILL BE PAID FOR DIRECTIONAL BORING THROUGH ROCK AND DRILLED SHAFT IN ROCK IN ADDITION TO THE ITEMS SHOWN ON THE PLANS. NOMINAL QUANTITIES HAVE BEEN PROVIDED IF AND WHEN BORING AND/OR DRILLING THROUGH ROCK IS REQUIRED. SHOULD COBBLES PREVENT BORING, THE COST FOR PROVIDING SPECIALTY EQUIPMENT (I.E. ROCK BORE MACHINE) AND/OR OPEN TRENCH AND RESTORATION ARE INCLUDED IN THE PAY ITEMS.

2018-141-TS&I

CONTRACT NO. 62H79



	USER NAME = \$USER\$	DESIGNED	-	EA	REVISED	-	3/9/2020
NC.		DRAWN	-	EA, AV	REVISED	-	▲ 4/6/2020
* 0	PL 0 T S CA E = 40 .000 '/ in .	CHECKED	-	PKG	REVISED	-	
	PLOT DATE = \$DATE\$	DATE	-	2/6/2020	REVISED	2	

REVISED 4/7/2020 TOTAL SHEET SHEETS NO. SECTION COUNTY

					CONSTRUCTION CODE													
					90% FEDERAL 7. 5% STATE 2. 5% JOLIET	90% FEDERAL 5% STATE 5% JOLIET	90% FEDERAL 10% STATE	90% FEDERAL 7. 5% STATE 2. 5% JOLIET	90% FEDERAL 5% STATE 5% JOLIET	90% FEDERAL 10% STATE	90% FEDERAL 7.5% STATE 2.5% JOLIET	90% FEDERAL 5% STATE 5% JOLIET	90% FEDERAL 10% JOLIET	90% FEDERAL 10% STATE	90% FEDERAL 3.3% STATE 6.7% JOLIET	90% FEDERAL 6.7% STATE 3.3% JOLIET	90% FEDERAL 10% STATE	100% JOLIET
				LOCATION NUMBER		9, 20, 21, 23, 24			9, 20, 21, 23, 24		1, 7, 18, 26	3, 4, 8, 11, 13, 14, 16, 25, 27, 28, 29, 32, 33, 36, 37, 39, 40, 41, 42, 44, 46, 47, 48	5	6, 12, 15, 45	17	22, 31, 34, 35, 38, 43		2, 9, 10, 19, 20, 21, 23, 24, 30
	CODE NO.	ITEM	UNIT	TOTAL QUANTITY		FIC SIC		eletera i	LIGHTIN	G		RETROREFLE		BACKPLA	TES		INTERCONNECT	EVP AND LED SIGNS
	20200200	ROCK EXCAVATION	CU YD	43	11	22	10	<u></u>										
	51604000	DRILLED SHAFT IN ROCK	CU YD	58	14	31	13	3							2			
				·····				<u>~</u> __										
*	66900200	NON-SPECIAL WASTE DISPOSAL	CU YD	180			180										- 0	
4	66900530	SOIL DISPOSAL ANALYSIS	EACH	4			4									-		<u> </u>
Τ .		JOIL DISTOSAL ANALISIS	LACII	7			3											
*	66901001	REGULATED SUBSTANCES PRE-CONSTRUCTION PLAN	L SUM	1			1								34			
*	66901003	REGULATED SUBSTANCES FINAL-CONSTRUCTION REPORT	L SUM	1			1								15	*		3
*	66901006	REGULATED SUBSTANCES MONITORING	DAYS	9	*		9		*									-
	67000400	ENGINEER'S FIELD OFFICE, TYPE A	CAL MO	15			15								22			
	67100100	MOBILIZATION	LSUM	1			1								13		- 8	
							,											
1	70102625	TRAFFIC CONTROL AND PROTECTION, STANDARD 701606	LSUM	1			1							<u> </u>	12			-
	70102630	TRAFFIC CONTROL AND PROTECTION, STANDARD 701601	LSUM	1			1								2			
																2.		2
1	70102635	TRAFFIC CONTROL AND PROTECTION, STANDARD 701701	LSUM	1			1				- 1							
	70102640	TRAFFIC CONTROL AND PROTECTION, STANDARD 701801	LSUM	1			1											
	* SPFCIΔ	LTY ITEM							•		11837		-	•		•	/1\ REVISE	D 4/7/2020

* SPECIALTY ITEM

REVISED 4/7/2020

		Ľ
_ (1)	GANDHI AND ASSOCIATES, INC. ENGINEERS AND PLANNERS 5035 N. NORTHWEST HIGHWAY	
	SUITE 306 CHCAGO, ELINOIS 60631TEL,(773)774-590	Р
	i	Р

	USER NAME = \$USER\$	DESIGNED	-	EA	REVISED	-	▲ 4/6/2020
٠.		DRAWN	-	EA, AV	REVISED	2.	
	P LO SCALE = 40.0000 '/ in.	CHECKED		PKG	REVISED	-	
	PLOT DATE = \$DATE\$	DATE	=	2/6/2020	REVISED	71	

STATE OF ILLINOIS
DEPARTMENT OF TRANSPORTATION

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SCALE: N.T.S.	SHEET NO.	OF	SHEETS	STA.	TO STA.

Ī	F.A	SECTION	COUNTY	TOTAL	SHEE NO.
	VAR	2018-141-TS&I	WILL	90	5
_			CONTRACT	NO. 6	2H79
	FED. RO.	AD DIST, NO. ILLINOIS FED. AL	D PROJECT		

				CONSTRUCTION CODE														
				90% FEDERAL 7.5% STATE 2.5% JOLIET	90% FEDERAL 5% STATE 5% JOLIET	90% FEDERAL 10% STATE	90% FEDERAL 7.5% STATE 2.5% JOLIET	90% FEDERAL 5% STATE 5% JOLIET	90% FEDERAL 10% STATE	90% FEDERAL 7.5% STATE 2.5% JOLIET	90% FEDERAL 5% STATE 5% JOLIET	90% FEDERAL 10% JOLIET	90% FEDERAL 10% STATE	90% FEDERAL 3.3% STATE 6.7% JOLIET	90% FEDERAL 6.7% STATE 3.3% JOLIET	90% FEDERAL 10% STATE	100% JOLIET	
			LOCATION NUMBER		9, 20, 21, 23, 24			9, 20, 21, 23, 24	30	1, 7, 18, 26	3, 4, 8, 11, 13, 14, 16, 25, 27, 28, 29, 32, 33, 36, 37, 39, 40, 41, 42, 44, 46, 47, 48	5	6, 12, 15, 45		22, 31, 34, 35, 38, 43		2, 9, 10, 19, 20, 21, 23, 24, 30	
CODE NO.	ITEM	UNIT	TOTAL QUANTITY	TRAF	TRAFFIC SIGNALS LIGHTING RETROREFLECTIVE BACKPLATES 0021					INTERCONNECT	EVP AND LED SIGNS							
X1400150	SERVICE INSTALLATION, GROUND MOUNTED, METERED	EACH	9	2	5	2												
X1400238	LUMINAIRE, LED, SPECIAL	EACH	16				2	12	2									
X1400360		FOOT	5,897	1,669	2,446	1,438	·····	*****	~~~~	*****		·····	~~~~	·····	*****	344	}	
X1400367	PEDESTRIAN SIGNAL POST, 10 FT	EACH	18	7	7	4					***************************************							
X1400388	VIDEO VEHICLE DETECTION SYSTEM, SINGLE APPROACH	EACH	21	3	13	5												
X8250091	COMBINATION LIGHTING CONTROLLER	EACH	7				1	5	1									
X8620200	UNINTERRUPTABLE POWER SUPPLY, SPECIAL	EACH	9	2	5	2												
X8710024	FIBER OPTIC CABLE IN CONDUIT, NO. 62.5/125, MM12F SM24F	FOOT	12, 350							,						12, 350		
X8772115	TEMPORARY MAST ARM, ALUMINUM, 15FT	EACH	6				1	4	1									
X8780010	CONCRETE FOUNDATION, TYPE A 10-INCH DIAMETER	FOOT	72	28	28	16		: :										
X8950100	RELOCATE EXISTING MASTER CONTROLLER	EACH	2			2												
			-															
Z0030850	TEMPORARY INFORMATION SIGNING	SQ FT	308.4	102.8	128.5	77. 1				-								
70077000	LUNATURA DE CASETA CARLE ASSENDIA	5.00	1.0					1.0									1	
20033020	LUMINAIRE SAFETY CABLE ASSEMBLY	EACH	16				2	12	2							,		

KinPROJECTSNProjects 2018/1007 Joliet RoadsN

GANDHI AND ASSOCIATES, INC.

EMPERE AND PLANGES
ON HUMBERS INDHAY
SHIT 306
CHCACO, ILLINOS 6063 IELLITI31714-590

ER NAME = \$USER\$	DESIGNED	-	EA	REVISED	*	⚠ 4/6/2020
	DRAWN	-	EA, AV	REVISED	æ	
OT SCALE = 40.0000 '/ in.	CHECKED	-	PKG	REVISED	35	
DT DATE = \$DATE\$	DATE	-	2/6/2020	REVISED	-	
	OT SCALE = 40.0000 '/ in.	DRAWN OT SCALE = 48.8888 '/ in. CHECKED	DRAWN - DT SCALE = 40.0000 '/ in. CHECKED -	DRAWN - EA, AV OT SCALE = 40.0000 '/ In. CHECKED - PKG	DRAWN - EA, AV REVISED OT SCALE = 40.0000 '/ in. CHECKED - PKG REVISED	DRAWN - EA, AV REVISED - OT SCALE = 40.0000 '/ in. CHECKED - PKG REVISED -

STATE OF ILLINOIS
DEPARTMENT OF TRANSPORTATION


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SHEET	NO.	OF	SHEETS	STA.	TO STA.

SCALE: N.T.S.

REVISED 4/7/2020

DESIGN	AREA	SIGN PANEL	SHEETING	QTY.
SERIES	(SQ FT)	TYPE	TYPE	REQUIRED
TOP LINE: D BOT. LINE: D	8. 25	LED	N/ A	1

SIGN SHALL BE DOUBLE-SIDED

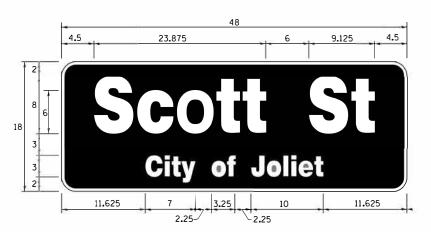

DESIGN	AREA	SIGN PANEL	SHEETING	QTY.
SERIES	(SQ FT)	TYPE	TYPE	REQUIRED
TOP LINE: D BOT. LINE: D	6.0	LED	N/ A	

SIGN SHALL BE DOUBLE-SIDED

NOTE: FOR ADDITIONAL DESIGN AND INSTALLATION INFORMATION PLEASE SEE LED ILLUMINATED STREET NAME INSTALLATION AND WIRING DIAGRAM DETAIL.

SCHEDULE OF QUANTITIES

	ITEM DESCRIPTION	UNITS	TOTAL OTY.	
**	ROCK EXCAVATION	CU YD	4	\longrightarrow \wedge
**	DRILLED SHAFT IN ROCK	CU YD	7	[} \(\ \)
	UNDERGROUND CONDUIT, GALVANIZED STEEL, 2" DIA.	FOOT	244	
	UNDERGROUND CONDUIT, GALVANIZED STEEL, 3" DIA.	FOOT	45	
	UNDERGROUND CONDUIT, GALVANIZED STEEL, 4" DIA.	FOOT	245	
	HANDHOLE	EACH	2	
	DOUBLE HANDHOLE	EACH	1 1	
	TRANSCEIVER - FIBER OPTIC	EACH	1	
	ELECTRIC CABLE IN CONDUIT, SIGNAL NO. 14 2C	FOOT	970	
	ELECTRIC CABLE IN CONDUIT, SIGNAL NO. 14 3C	FOOT	1250	
	ELECTRIC CABLE IN CONDUIT, SIGNAL NO. 14 5C	FOOT	870	
	ELECTRIC CABLE IN CONDUIT, SERVICE, NO. 6 2C	FOOT	120	
	ELECTRIC CABLE IN CONDUIT, EQUIPMENT GROUNDING CONDUCTOR, NO. 6 1C	FOOT	540	
	TRAFFIC SIGNAL POST, GALVANIZED STEEL 16 FT.	EACH	2	
	STEEL MAST ARM ASSEMBLY AND POLE, 34 FT.	EACH	1	
	STEEL COMBINATION MAST ARM ASSEMBLY AND POLE 34 FT.	EACH	1	
	CONCRETE FOUNDATION, TYPE A	FOOT	12	
	CONCRETE FOUNDATION, TYPE C	FOOT	4	
	CONCRETE FOUNDATION, TYPE E 30-INCH DIAMETER	FOOT	27	
	DRILL EXISTING HANDHOLE	EACH	5	
	SIGNAL HEAD, LED, 1-FACE, 3-SECTION, MAST ARM MOUNTED	EACH	5	
	SIGNAL HEAD, LED, 1-FACE, 3-SECTION, BRACKET MOUNTED	EACH	2	
	PEDESTRIAN SIGNAL HEAD, LED, 1-FACE, BRACKET MOUNTED WITH COUNTDOWN TIMER	EACH	8	
	TRAFFIC SIGNAL BACKPLATE, RETROREFLECTIVE	EACH	5	
*	LIGHT DETECTOR	EACH	2	
*	LIGHT DETECTOR AMPLIFIER	EACH	1	
	PEDESTRIAN PUSH-BUTTON	EACH	8	
	TEMPORARY TRAFFIC SIGNAL INSTALLATION	EACH	1 1	
	REMOVE EXISTING TRAFFIC SIGNAL EQUIPMENT	EACH	1	
	REMOVE EXISTING DOUBLE HANDHOLE	EACH	1	
	REMOVE EXISTING CONCRETE FOUNDATION	EACH	6	
*	EMERGENCY VEHICLE PRIORITY SYSTEM LINE SENSOR CABLE, NO. 20 3/C	FOOT	237	
*	LED INTERNALLY ILLUMINATED STREET NAME SIGN	EACH	2	
	FULL-ACTUATED CONTROLLER AND TYPE SUPER P CABINET (SPECIAL)	EACH	1	
	SERVICE INSTALLATION, GROUND MOUNTED, METERED	EACH	1	Λ
**	DIRECTIONAL BORING THROUGH ROCK	FOOT	534	
	PEDESTRIAN SIGNAL POST, 10 FT	EACH	3	
	VIDEO VEHICLE DETECTION SYSTEM, SINGLE APPROACH	EACH	2	
	UNINTERRUPTABLE POWER SUPPLY, SPECIAL	EACH	1	
	CONCRETE FOUNDATION, TYPE A 10-INCH DIAMETER	FOOT	12	
	TEMPORARY TRAFFIC SIGNAL TIMING	EACH	1	
	TEMPORARY INFORMATION SIGNING	SQ FT	51.4	
*	ELECTRIC CABLE IN CONDUIT, STREET NAME SIGN, NO. 14 3C, TYPE SOOW	FOOT	193	


- * 100% COST TO CITY OF JOLIET
- ** NOMINAL QUANTITY HAS BEEN PROVIDED FOR AREAS WHERE BED ROCK IS ENCOUNTERED WHEN DRILLING, EXCAVATING, AND/OR BORING FOR TEMPORARY WOOD POLES, CONCRETE FOUNDATIONS, HANDHOLES, AND CONDUIT.

1 REVISED 4/7/2020

TS 22531 ECON 121 LOCATION NO. 2

DESIGN	AREA	SIGN PANEL	SHEETING	QTY.
SERIES	(SQ FT)	TYPE	TYPE	REQUIRED
TOP LINE: D BOT. LINE: D	5. 25	LED	N/ A	

SIGN SHALL BE DOUBLE-SIDED

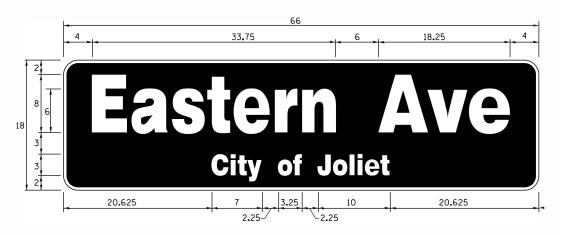

DESIGN	AREA	SIGN PANEL	SHEETING	OTY.
SERIES	(SQ FT)	TYPE	TYPE	REQUIRED
TOP LINE: D BOT. LINE: D	8. 25	LED	N/ A	

SIGN SHALL BE DOUBLE-SIDED

NOTE: FOR ADDITIONAL DESIGN AND INSTALLATION INFORMATION
PLEASE SEE LED ILLUMINATED STREET NAME INSTALLATION
AND WIRING DIAGRAM DETAIL.


SCHEDULE OF QUANTITIES

ITEM DESCRIPTION	UNITS	TOTAL OTY.	
ROCK EXCAVATION	CU YD	5	
DRILLED SHAFT IN ROCK	CU YD	3.5	}
UNDERGROUND CONDUIT, GALVANIZED STEEL, 2" DIA.	FOOT	397	
UNDERGROUND CONDUIT, GALVANIZED STEEL, 3" DIA.	FOOT	36	
UNDERGROUND CONDUIT, GALVANIZED STEEL, 4" DIA.	FOOT	291	
HANDHOLE	EACH	3	
DOUBLE HANDHOLE	EACH	1	
MAINTENANCE OF EXISTING TRAFFIC SIGNAL INSTALLATION	EACH	1	
TRANSCEIVER - FIBER OPTIC	EACH	1	
ELECTRIC CABLE IN CONDUIT, SIGNAL NO. 14 2C	FOOT	1018	
ELECTRIC CABLE IN CONDUIT, SIGNAL NO. 14 3C	FOOT	1290	
ELECTRIC CABLE IN CONDUIT, SIGNAL NO. 14 5C	FOOT	780	
ELECTRIC CABLE IN CONDUIT, SERVICE, NO. 6 2C	FOOT	199	
ELECTRIC CABLE IN CONDUIT, EQUIPMENT GROUNDING CONDUCTOR, NO. 6 1C	FOOT	735	
TRAFFIC SIGNAL POST, GALVANIZED STEEL 16 FT.	EACH	2	
STEEL COMBINATION MAST ARM ASSEMBLY AND POLE 26 FT.	EACH	1	
STEEL COMBINATION MAST ARM ASSEMBLY AND POLE 28 FT.	EACH	1	
CONCRETE FOUNDATION, TYPE A	FOOT	12	
CONCRETE FOUNDATION, TYPE C	FOOT	4	
CONCRETE FOUNDATION, TYPE E 30-INCH DIAMETER	FOOT	20	
DRILL EXISTING HANDHOLE	EACH	4	
SIGNAL HEAD, LED, 1-FACE, 3-SECTION, MAST ARM MOUNTED	EACH	4	
SIGNAL HEAD, LED, 1-FACE, 3-SECTION, BRACKET MOUNTED	EACH	2	
PEDESTRIAN SIGNAL HEAD, LED, 1-FACE, BRACKET MOUNTED WITH COUNTDOWN TIMER	EACH	8	
TRAFFIC SIGNAL BACKPLATE, RETROREFLECTIVE	EACH	4	
LIGHT DETECTOR	EACH	2	
LIGHT DETECTOR AMPLIFIER	EACH	1	
PEDESTRIAN PUSH-BUTTON	EACH	8	
REMOVE EXISTING TRAFFIC SIGNAL EQUIPMENT	EACH	1 1	
REMOVE EXISTING HANDHOLE	EACH	7	
REMOVE EXISTING DOUBLE HANDHOLE	EACH	1	
REMOVE EXISTING CONCRETE FOUNDATION	EACH	5	
EMERGENCY VEHICLE PRIORITY SYSTEM LINE SENSOR CABLE, NO. 20 3/C	FOOT	220	
LED INTERNALLY ILLUMINATED STREET NAME SIGN	EACH	2	
FULL-ACTUATED CONTROLLER AND TYPE SUPER P CABINET (SPECIAL)	EACH	1	
SERVICE INSTALLATION, GROUND MOUNTED, METERED	EACH	1	~~~
DIRECTIONAL BORING THROUGH ROCK	FOOT	724	
PEDESTRIAN SIGNAL POST, 10 FT	EACH	3	
VIDEO VEHICLE DETECTION SYSTEM, SINGLE APPROACH	EACH	2	
UNINTERRUPTABLE POWER SUPPLY, SPECIAL	EACH	1	
CONCRETE FOUNDATION, TYPE A 10-INCH DIAMETER	FOOT	12	
TEMPORARY INFORMATION SIGNING	SQ FT	25. 7	
ELECTRIC CABLE IN CONDUIT, STREET NAME SIGN, NO. 14 3C, TYPE SOOW	FOOT	205	

- * 100% COST TO CITY OF JOLIET
- ** NOMINAL QUANTITY HAS BEEN PROVIDED FOR AREAS WHERE BED ROCK IS ENCOUNTERED WHEN DRILLING, EXCAVATING, AND/OR BORING FOR CONCRETE FOUNDATIONS, HANDHOLES, AND CONDUIT.


1 REVISED 4/7/2020

TS 21780 ECON 123 LOCATION NO. 9 COUNTY SHEETS NO. WILL 90 34 CONTRACT NO. 62H79

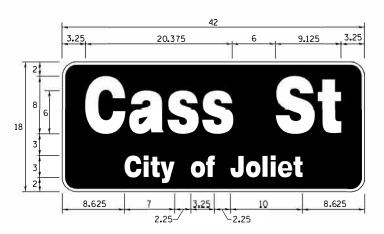

DESIGN	AREA	SIGN PANEL	SHEETING	QTY.
SERIES	(SQ FT)	TYPE	TYPE	REQUIRED
TOP LINE: D BOT. LINE: D	5. 25	LED	N/ A	1

SIGN SHALL BE DOUBLE-SIDED

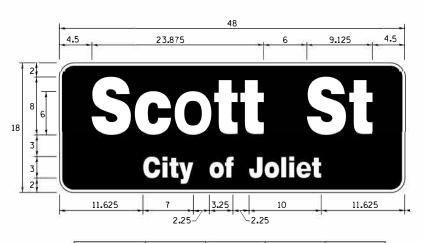

DESIGN	AREA	SIGN PANEL	SHEETING	QTY.
SERIES	(SQ FT)	TYPE	TYPE	REQUIRED
TOP LINE: D BOT. LINE: D	6.0	LED	N/A	

SIGN SHALL BE DOUBLE-SIDED

SCHEDULE OF QUANTITIES


ITEM DESCRIPTION	UNITS	TOTAL QTY.	
ROCK EXCAVATION	CU YD	5.5	\
DRILLED SHAFT IN ROCK	CU YD	5 5	1 1 /
UNDERGROUND CONDUIT, GALVANIZED STEEL, 2" DIA.	FOOT	494	
UNDERGROUND CONDUIT, GALVANIZED STEEL, 3" DIA.	FOOT	60	
UNDERGROUND CONDUIT, GALVANIZED STEEL, 4" DIA.	FOOT	271	
HANDHOLE	EACH	2	1
DOUBLE HANDHOLE	EACH	2	İ
MAINTENANCE OF EXISTING TRAFFIC SIGNAL INSTALLATION	EACH	1	
TRANSCEIVER - FIBER OPTIC	EACH	1	İ
ELECTRIC CABLE IN CONDUIT, SIGNAL NO. 14 2C	FOOT	984	İ
ELECTRIC CABLE IN CONDUIT, SIGNAL NO. 14 3C	FOOT	1422	i
ELECTRIC CABLE IN CONDUIT, SIGNAL NO. 14 5C	FOOT	1260	
ELECTRIC CABLE IN CONDUIT, SERVICE, NO. 6 2C	FOOT	183	i
ELECTRIC CABLE IN CONDUIT, EQUIPMENT GROUNDING CONDUCTOR, NO. 6 1C	FOOT	587	
TRAFFIC SIGNAL POST, GALVANIZED STEEL 16 FT.	EACH	2	İ
STEEL MAST ARM ASSEMBLY AND POLE, 26 FT.	EACH	1	
STEEL MAST ARM ASSEMBLY AND POLE. 44 FT.	EACH	1	i
CONCRETE FOUNDATION, TYPE A	FOOT	12	İ
CONCRETE FOUNDATION. TYPE C	FOOT	4	İ
CONCRETE FOUNDATION, TYPE E 30-INCH DIAMETER	FOOT	10	
CONCRETE FOUNDATION. TYPE E 36-INCH DIAMETER	FOOT	13	i
DRILL EXISTING HANDHOLE	EACH	6	İ
SIGNAL HEAD, LED, 1-FACE, 3-SECTION, MAST ARM MOUNTED	EACH	5	i
SIGNAL HEAD, LED, 1-FACE, 3-SECTION, BRACKET MOUNTED	EACH	2	
PEDESTRIAN SIGNAL HEAD, LED, 1-FACE, BRACKET MOUNTED WITH COUNTDOWN TIMER	EACH	8	
TRAFFIC SIGNAL BACKPLATE, RETROREFLECTIVE	EACH	5	İ
LIGHT DETECTOR	EACH	2	i
LIGHT DETECTOR AMPLIFIER	EACH	1	
PEDESTRIAN PUSH-BUTTON	EACH	8	İ
REMOVE EXISTING TRAFFIC SIGNAL EQUIPMENT	EACH	1	İ
REMOVE EXISTING HANDHOLE	EACH	1	i
REMOVE EXISTING DOUBLE HANDHOLE	EACH	1	
REMOVE EXISTING CONCRETE FOUNDATION	EACH	5	İ
EMERGENCY VEHICLE PRIORITY SYSTEM LINE SENSOR CABLE, NO. 20 3/C	FOOT	382	İ
LED INTERNALLY ILLUMINATED STREET NAME SIGN	EACH	2	İ
FULL-ACTUATED CONTROLLER AND TYPE SUPER R CABINET (SPECIAL)	EACH	1	
SERVICE INSTALLATION, GROUND MOUNTED, METERED	EACH	1	
DIRECTIONAL BORING THROUGH ROCK	FOOT	825	
PEDESTRIAN SIGNAL POST, 10 FT	EACH	3	
VIDEO VEHICLE DETECTION SYSTEM, SINGLE APPROACH	EACH	2	
UNINTERRUPTABLE POWER SUPPLY, SPECIAL	EACH	1	
CONCRETE FOUNDATION, TYPE A 10-INCH DIAMETER	FOOT	12	
RELOCATE EXISTING MASTER CONTROLLER	EACH	1	
TEMPORARY INFORMATION SIGNING	SO FT		
ELECTRIC CABLE IN CONDUIT, STREET NAME SIGN, NO. 14 3C, TYPE SOOW	FOOT	347	

- * 100% COST TO CITY OF JOLIET
- ** NOMINAL QUANTITY HAS BEEN PROVIDED FOR AREAS WHERE BED ROCK IS ENCOUNTERED WHEN DRILLING, EXCAVATING, AND/OR BORING FOR CONCRETE FOUNDATIONS, HANDHOLES, AND CONDUIT.

REVISED 4/7/2020


ECON 121 LOCATION NO. 10 COUNTY TOTAL SHEETS NO.
WILL 90 39

TS 21803

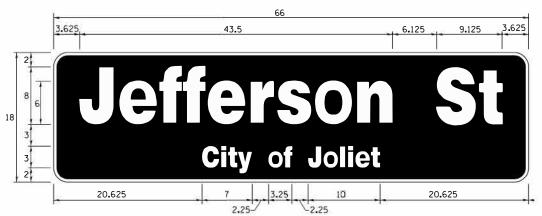

DESIGN	AREA	SIGN PANEL	SHEETING	QTY.
SERIES	(SQ FT)	TYPE	TYPE	REQUIRED
TOP LINE: D BOT. LINE: D	8. 25	LED	N/ A	

SIGN SHALL BE DOUBLE-SIDED

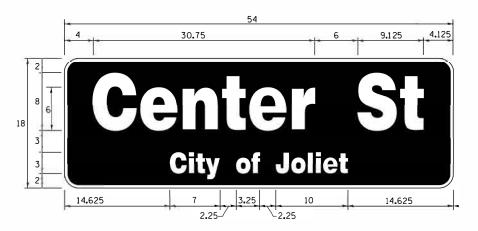

DESIGN	AREA	SIGN PANEL	SHEETING	QTY.
SERIES	(SQ FT)	TYPE	TYPE	REQUIRED
TOP LINE: D BOT. LINE: D	6. 75	LED	N/ A	

SIGN SHALL BE DOUBLE-SIDED

SCHEDULE OF QUANTITIES

ITEM DESCRIPTION	UNITS	TOTAL QTY.	
ROCK EXCAVATION	CU YD	7	my /
DRILLED SHAFT IN ROCK	CU YD	win.	
UNDERGROUND CONDUIT, GALVANIZED STEEL, 2" DIA.	FOOT	745	1
UNDERGROUND CONDUIT, GALVANIZED STEEL, 3" DIA.	FOOT	98	i
UNDERGROUND CONDUIT, GALVANIZED STEEL, 4" DIA.	FOOT	292	1
HANDHOLE	EACH	4	1
DOUBLE HANDHOLE	EACH	2	1
TRANSCEIVER - FIBER OPTIC	EACH	1	1
ELECTRIC CABLE IN CONDUIT, SIGNAL NO. 14 2C	FOOT	1325	1
ELECTRIC CABLE IN CONDUIT, SIGNAL NO. 14 3C	FOOT	2000	1
ELECTRIC CABLE IN CONDUIT, SIGNAL NO. 14 5C	FOOT	1275	1
ELECTRIC CABLE IN CONDUIT, SIGNAL NO. 14 SC ELECTRIC CABLE IN CONDUIT, LEAD-IN, NO. 14 1 PAIR	FOOT	400	-
	FOOT		4
ELECTRIC CABLE IN CONDUIT, SERVICE, NO. 6 2C		325	1
ELECTRIC CABLE IN CONDUIT, EQUIPMENT GROUNDING CONDUCTOR, NO. 6 1C	FOOT	920	-
TRAFFIC SIGNAL POST, GALVANIZED STEEL 16 FT.	EACH	2	
STEEL MAST ARM ASSEMBLY AND POLE, 20 FT.	EACH	1	
STEEL MAST ARM ASSEMBLY AND POLE, 22 FT.	EACH	1	
STEEL MAST ARM ASSEMBLY AND POLE, 28 FT.	EACH	1	1
CONCRETE FOUNDATION, TYPE A	FOOT	12	1
CONCRETE FOUNDATION, TYPE C	FOOT	4	
CONCRETE FOUNDATION, TYPE E 30-INCH DIAMETER	FOOT	30	
DRILL EXISTING HANDHOLE	EACH	1	
SIGNAL HEAD, LED, 1-FACE, 3-SECTION, MAST ARM MOUNTED	EACH	6	
SIGNAL HEAD, LED, 1-FACE, 3-SECTION, BRACKET MOUNTED	EACH	4	
PEDESTRIAN SIGNAL HEAD, LED, 1-FACE, BRACKET MOUNTED WITH COUNTDOWN TIMER	EACH	12	
TRAFFIC SIGNAL BACKPLATE, RETROREFLECTIVE	EACH	6	
INDUCTIVE LOOP DETECTOR	EACH	3	1
DETECTOR LOOP, TYPE I	FOOT	280	
LIGHT DETECTOR	EACH	2	
LIGHT DETECTOR AMPLIFIER	EACH	1	1
PEDESTRIAN PUSH-BUTTON	EACH	10	1
TEMPORARY TRAFFIC SIGNAL INSTALLATION	EACH	1	i
REMOVE EXISTING TRAFFIC SIGNAL EQUIPMENT	EACH	1	i
REMOVE EXISTING HANDHOLE	EACH	9	1
REMOVE EXISTING DOUBLE HANDHOLE	EACH	2	1
REMOVE EXISTING CONCRETE FOUNDATION	EACH	7	1
EMERGENCY VEHICLE PRIORITY SYSTEM LINE SENSOR CABLE, NO. 20 3/C	FOOT	356	1
LED INTERNALLY ILLUMINATED STREET NAME SIGN	EACH	2	1
FULL-ACTUATED CONTROLLER AND TYPE SUPER P CABINET (SPECIAL)	EACH	1	1
SERVICE INSTALLATION, GROUND MOUNTED, METERED	EACH	1 1	-
DIRECTIONAL BORING THROUGH ROCK	FOOT	1,135	· · · · · · · · · · · · · · · · · · ·
PEDESTRIAN SIGNAL POST. 10 FT	EACH	4	·····
			-
VIDEO VEHICLE DETECTION SYSTEM, SINGLE APPROACH	EACH	1	-
UNINTERRUPTABLE POWER SUPPLY, SPECIAL	EACH	1	
CONCRETE FOUNDATION, TYPE A 10-INCH DIAMETER	FOOT	16	1
TEMPORARY INFORMATION SIGNING	SQ FT		1
TEMPORARY TRAFFIC SIGNAL TIMING	EACH	1	
ELECTRIC CABLE IN CONDUIT, STREET NAME SIGN, NO. 14 3C, TYPE SOOW	FOOT	345	1

- * 100% COST TO CITY OF JOLIET
- ** NOMINAL QUANTITY HAS BEEN PROVIDED FOR AREAS WHERE BED ROCK IS ENCOUNTERED WHEN DRILLING, EXCAVATING, AND/OR BORING FOR TEMPORARY WOOD POLES, CONCRETE FOUNDATIONS, HANDHOLES, AND CONDUIT.


REVISED 4/7/2020
TS 22526
ECON 121

GANDHI AND ASSOCIATES, INC.
ENGERS AND PLANERS
503 R. NORTHEST HORNAY
SUIT: 506
ONCAGO, LLINOS 6063/TE, (173)/174-590
PLO

	USER NAME = \$USER\$	DESIGNED -	EA	REVISED	Ξ	3/9/2020
C.		DRAWN -	EA, AV	REVISED	25	▲ 4/6/2020
-	PLOT SCALE = 40.0000 '/ in.	CHECKED -	PKG	REVISED	0	j
i	PLOT DATE = \$DATE\$	DATE -	2/6/2020	REVISED	2	T T

DESIGN	AREA	SIGN PANEL	SHEETING	QTY.	
SERIES	(SQ FT)	TYPE	TYPE	REQUIRED	
TOP LINE: D BOT. LINE: D	8. 25	LED	N/ A	1	

SIGN SHALL BE DOUBLE-SIDED

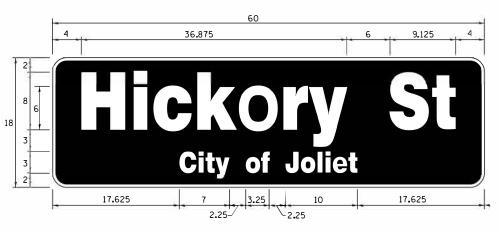

DESIGN SERIES			SHEETING TYPE	QTY. REQUIRED	
TOP LINE: D BOT. LINE: D	7.5	LED	N/ A	1	

SIGN SHALL BE DOUBLE-SIDED

SCHEDULE OF QUANTITIES


	ITEM DESCRIPTION	UNITS	TOTAL QTY.	
**	ROCK EXCAVATION	CU YD	4	~~~~
**	DRILLED SHAFT IN ROCK	CU YD	7.5	} <u> </u>
	UNDERGROUND CONDUIT, GALVANIZED STEEL, 2" DIA.	FOOT	96	·····
	UNDERGROUND CONDUIT, GALVANIZED STEEL, 3" DIA.	FOOT	5	
	UNDERGROUND CONDUIT, GALVANIZED STEEL, 4" DIA.	FOOT	202	
	HANDHOLE	EACH	2	
	DOUBLE HANDHOLE	EACH	ī	
	TRANSCEIVER - FIBER OPTIC	EACH	1	
	ELECTRIC CABLE IN CONDUIT, SIGNAL NO. 14 2C	FOOT	855	
	ELECTRIC CABLE IN CONDUIT, SIGNAL NO. 14 3C	FOOT	1190	
	ELECTRIC CABLE IN CONDUIT, SIGNAL NO. 14 5C	FOOT	1220	
	ELECTRIC CABLE IN CONDUIT, SERVICE, NO. 6 2C	FOOT	107	
	ELECTRIC CABLE IN CONDUIT, EQUIPMENT GROUNDING CONDUCTOR, NO. 6 1C	FOOT	450	
	TRAFFIC SIGNAL POST, GALVANIZED STEEL 16 FT.	EACH	1	
	STEEL COMBINATION MAST ARM ASSEMBLY AND POLE 34 FT.	EACH	i	
	STEEL COMBINATION MAST ARM ASSEMBLY AND POLE 54 FT.	EACH	i	
	CONCRETE FOUNDATION. TYPE A	FOOT	8	
	CONCRETE FOUNDATION, TYPE C	FOOT	4	
	CONCRETE FOUNDATION, TYPE E 30-INCH DIAMETER	FOOT	13.5	
	CONCRETE FOUNDATION, TYPE E 36-INCH DIAMETER	FOOT	15	
	DRILL EXISTING HANDHOLE	EACH	3	
	SIGNAL HEAD, LED, 1-FACE, 3-SECTION, MAST ARM MOUNTED	EACH	6	
	SIGNAL HEAD. LED. 1-FACE. 3-SECTION. BRACKET MOUNTED	EACH	2	
	PEDESTRIAN SIGNAL HEAD, LED, 1-FACE, BRACKET MOUNTED WITH COUNTDOWN TIMER	EACH	8	
	TRAFFIC SIGNAL BACKPLATE, RETROREFLECTIVE	EACH	6	
*	LIGHT DETECTOR	EACH	2	
*	LIGHT DETECTOR AMPLIFIER	EACH	1	
	PEDESTRIAN PUSH-BUTTON	EACH	8	
	TEMPORARY TRAFFIC SIGNAL INSTALLATION	EACH	1	
	REMOVE EXISTING TRAFFIC SIGNAL EQUIPMENT	EACH	1	
	REMOVE EXISTING HANDHOLE	EACH	2	
	REMOVE EXISTING DOUBLE HANDHOLE	EACH	1	
	REMOVE EXISTING CONCRETE FOUNDATION	EACH	6	
*	EMERGENCY VEHICLE PRIORITY SYSTEM LINE SENSOR CABLE, NO. 20 3/C	FOOT	300	
*	LED INTERNALLY ILLUMINATED STREET NAME SIGN	EACH	2	
	FULL-ACTUATED CONTROLLER AND TYPE SUPER P CABINET (SPECIAL)	EACH	1	
	SERVICE INSTALLATION, GROUND MOUNTED, METERED	EACH	correst season	Constantinous A
**	DIRECTIONAL BORING THROUGH ROCK	FOOT	303	
	PEDESTRIAN SIGNAL POST, 10 FT	EACH	3	
	VIDEO VEHICLE DETECTION SYSTEM. SINGLE APPROACH	EACH	2	
	UNINTERRUPTABLE POWER SUPPLY, SPECIAL	EACH	1	
	CONCRETE FOUNDATION, TYPE A 10-INCH DIAMETER	FOOT	12	
	TEMPORARY INFORMATION SIGNING	SQ FT	25. 7	
	TEMPORARY TRAFFIC SIGNAL TIMING	EACH	1	
*	ELECTRIC CABLE IN CONDUIT, STREET NAME SIGN, NO. 14 3C. TYPE SOOW	FOOT	246	
	*			

- * 100% COST TO CITY OF JOLIET
- ** NOMINAL QUANTITY HAS BEEN PROVIDED FOR AREAS WHERE BED ROCK IS ENCOUNTERED WHEN DRILLING, EXCAVATING, AND/OR BORING FOR TEMPORARY WOOD POLES, CONCRETE FOUNDATIONS, HANDHOLES, AND CONDUIT.

TS 22527 ECON 121


GANDHI AND ASSOCIATES, INC.
ENGLESS MO PLAMESS
6038 A NORTHEST HORAY
SUIT 3/06
CHCACO, LLINDS 6063/1EL/1733/174-590

STATE OF ILLINOIS
DEPARTMENT OF TRANSPORTATION

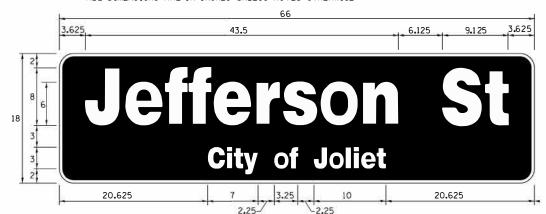

DESIGN	AREA	SIGN PANEL	SHEETING	QTY.	
SERIES	(SQ FT)	TYPE	TYPE	REQUIRED	
TOP LINE: D BOT. LINE: D	8. 25	LED	N/A	2	

SIGN SHALL BE DOUBLE-SIDED

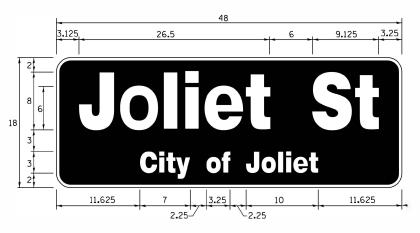

DESIGN	AREA	SIGN PANEL	SHEETING	QTY.	
SERIES	(SQ FT)	TYPE	TYPE	REQUIRED	
TOP LINE: D BOT. LINE: D	6.0	LED	N/ A		

SIGN SHALL BE DOUBLE-SIDED


SCHEDULE OF QUANTITIES

ITEM DESCRIPTION	UNITS	TOTAL QTY.	
ROCK EXCAVATION	CU YD	4	
DRILLED SHAFT IN ROCK	CU YD	5.5	3 2
UNDERGROUND CONDUIT, GALVANIZED STEEL, 2" DIA.	FOOT	142	
UNDERGROUND CONDUIT, GALVANIZED STEEL, 3" DIA.	FOOT	56	
UNDERGROUND CONDUIT, GALVANIZED STEEL, 4" DIA.	FOOT	242	
HANDHOLE	EACH	1	
DOUBLE HANDHOLE	EACH	1	
MAINTENANCE OF EXISTING TRAFFIC SIGNAL INSTALLATION	EACH	1	
TRANSCEIVER - FIBER OPTIC	EACH	1	
ELECTRIC CABLE IN CONDUIT, SIGNAL NO. 14 2C	FOOT	917	
ELECTRIC CABLE IN CONDUIT. SIGNAL NO. 14 3C	FOOT	1200	
ELECTRIC CABLE IN CONDUIT, SIGNAL NO. 14 5C	FOOT	975	
ELECTRIC CABLE IN CONDUIT, SIGNAL NO. 14 7C	FOOT	233	
ELECTRIC CABLE IN CONDUIT, SERVICE, NO. 6 2C	FOOT	117	
ELECTRIC CABLE IN CONDUIT, EQUIPMENT GROUNDING CONDUCTOR, NO. 6 1C	FOOT	632	
TRAFFIC SIGNAL POST, GALVANIZED STEEL 16 FT.	EACH	2	
STEEL MAST ARM ASSEMBLY AND POLE, 28 FT.	EACH	1	
STEEL MAST ARM ASSEMBLY AND POLE, 32 FT.	EACH	1	
STEEL COMBINATION MAST ARM ASSEMBLY AND POLE 26 FT.	EACH	1	
CONCRETE FOUNDATION. TYPE A	FOOT	12	
CONCRETE FOUNDATION, TIPE A	FOOT	4	
CONCRETE FOUNDATION, TIPE C	FOOT	33. 5	
DRILL EXISTING HANDHOLE	EACH	6	
SIGNAL HEAD, LED, 1-FACE, 3-SECTION, MAST ARM MOUNTED	EACH	6	
SIGNAL HEAD, LED, 1-FACE, 3-SECTION, MAST ARM MOUNTED SIGNAL HEAD, LED, 1-FACE, 3-SECTION, BRACKET MOUNTED	EACH	2	
SIGNAL HEAD, LED, 1-FACE, 5-SECTION, BRACKET MOUNTED	EACH	1	
SIGNAL HEAD, LED, 1-FACE, 5-SECTION, MAST ARM MOUNTED	EACH	1	
PEDESTRIAN SIGNAL HEAD, LED, 1-FACE, BRACKET MOUNTED WITH COUNTDOWN TIMER	EACH	8	
TRAFFIC SIGNAL BACKPLATE, RETROREFLECTIVE	EACH	7	
LIGHT DETECTOR	EACH	2	
LIGHT DETECTOR AMPLIFIER	EACH	1	
PEDESTRIAN PUSH-BUTTON	EACH	8	
REMOVE EXISTING TRAFFIC SIGNAL EQUIPMENT	EACH	1	
REMOVE EXISTING HANDHOLE	EACH	1 :	
REMOVE EXISTING CONCRETE FOUNDATION	EACH	6	
EMERGENCY VEHICLE PRIORITY SYSTEM LINE SENSOR CABLE, NO. 20 3/C	FOOT	227	
LED INTERNALLY ILLUMINATED STREET NAME SIGN	EACH	3	
FULL-ACTUATED CONTROLLER AND TYPE SUPER P CABINET (SPECIAL)	EACH	1	
SERVICE INSTALLATION, GROUND MOUNTED, METERED	EACH	1	
DIRECTIONAL BORING THROUGH ROCK	F00T	440	
PEDESTRIAN SIGNAL POST, 10 FT	EACH	1	
VIDEO VEHICLE DETECTION SYSTEM, SINGLE APPROACH	EACH	3	
UNINTERRUPTABLE POWER SUPPLY, SPECIAL	EACH	1	
CONCRETE FOUNDATION, TYPE A 10-INCH DIAMETER	FOOT	4	
TEMPORARY INFORMATION SIGNING	SQ FT	25. 7	
ELECTRIC CABLE IN CONDUIT, STREET NAME SIGN, NO. 14 3C. TYPE SOOW	FOOT	350	

- * 100% COST TO CITY OF JOLIET
- ** NOMINAL QUANTITY HAS BEEN PROVIDED FOR AREAS WHERE BED ROCK IS ENCOUNTERED WHEN DRILLING, EXCAVATING, AND/OR BORING FOR CONCRETE FOUNDATIONS, HANDHOLES, AND CONDUIT.


TS 22528

ECON 121 LOCATION NO. 21 COUNTY TOTAL SHEET NO.

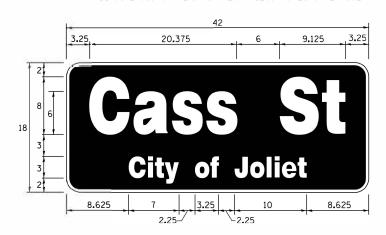

DESIGN	AREA	SIGN PANEL	SHEETING	QTY.	
SERIES	(SQ FT)	TYPE	TYPE	REQUIRED	
TOP LINE: D BOT. LINE: D	5. 25	LED	N/ A		

SIGN SHALL BE DOUBLE-SIDED

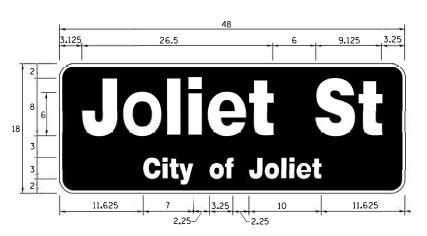

DESIGN	AREA	SIGN PANEL	SHEETING	QTY.	
SERIES	(SQ FT)	TYPE	TYPE	REQUIRED	
TOP LINE: D BOT. LINE: D	6.0	LED	N/ A		

SIGN SHALL BE DOUBLE-SIDED

SCHEDULE OF QUANTITIES

	ITEM DESCRIPTION	UNITS	TOTAL QTY.	8866
**	ROCK EXCAVATION	CU YD	4	~ (~
**	DRILLED SHAFT IN ROCK	CU YD	6.5	
	UNDERGROUND CONDUIT, GALVANIZED STEEL, 2" DIA.	FOOT	104	
	UNDERGROUND CONDUIT, GALVANIZED STEEL, 3" DIA.	FOOT	60	
	UNDERGROUND CONDUIT, GALVANIZED STEEL, 4" DIA.	FOOT	341	
	DOUBLE HANDHOLE	EACH	2	
	MAINTENANCE OF EXISTING TRAFFIC SIGNAL INSTALLATION	EACH	1	
	TRANSCEIVER - FIBER OPTIC	EACH	1	
	ELECTRIC CABLE IN CONDUIT, SIGNAL NO. 14 2C	FOOT	1104	
	ELECTRIC CABLE IN CONDUIT, SIGNAL NO. 14 3C	FOOT	1471	
	ELECTRIC CABLE IN CONDUIT, SIGNAL NO. 14 5C	FOOT	1492	
	ELECTRIC CABLE IN CONDUIT, SIGNAL NO. 14 7C	FOOT	274	
	ELECTRIC CABLE IN CONDUIT, SERVICE, NO. 6 2C	FOOT	125	
	ELECTRIC CABLE IN CONDUIT, EQUIPMENT GROUNDING CONDUCTOR, NO. 6 1C	FOOT	520	
	TRAFFIC SIGNAL POST, GALVANIZED STEEL 16 FT.	EACH	1	
	STEEL MAST ARM ASSEMBLY AND POLE, 28 FT.	EACH	1	
	STEEL MAST ARM ASSEMBLY AND POLE, 44 FT.	EACH	1	
	STEEL COMBINATION MAST ARM ASSEMBLY AND POLE 32 FT.	EACH	1	
	CONCRETE FOUNDATION, TYPE A	FOOT	8	
	CONCRETE FOUNDATION, TYPE C	FOOT	4	
	CONCRETE FOUNDATION, TYPE E 30-INCH DIAMETER	FOOT	23.5	
	CONCRETE FOUNDATION, TYPE E 36-INCH DIAMETER	FOOT	13	
	DRILL EXISTING HANDHOLE	EACH	6	
	SIGNAL HEAD, LED, 1-FACE, 3-SECTION, MAST ARM MOUNTED	EACH	6	
	SIGNAL HEAD, LED, 1-FACE, 3-SECTION, BRACKET MOUNTED	EACH	2	
	SIGNAL HEAD, LED, 1-FACE, 5-SECTION, BRACKET MOUNTED	EACH	1	
	SIGNAL HEAD, LED, 1-FACE, 5-SECTION, MAST ARM MOUNTED	EACH	1	
	PEDESTRIAN SIGNAL HEAD, LED, 1-FACE, BRACKET MOUNTED WITH COUNTDOWN TIMER	EACH	8	
	TRAFFIC SIGNAL BACKPLATE, RETROREFLECTIVE	EACH	7	
*	LIGHT DETECTOR	EACH	2	
*	LIGHT DETECTOR AMPLIFIER	EACH	1	
	PEDESTRIAN PUSH-BUTTON	EACH	8	
	REMOVE EXISTING TRAFFIC SIGNAL EQUIPMENT	EACH	1	
	REMOVE EXISTING CONCRETE FOUNDATION	EACH	5	
*	EMERGENCY VEHICLE PRIORITY SYSTEM LINE SENSOR CABLE, NO. 20 3/C	FOOT	311	
*	LED INTERNALLY ILLUMINATED STREET NAME SIGN	EACH	3	
	FULL-ACTUATED CONTROLLER AND TYPE SUPER P CABINET (SPECIAL)	EACH	1	
	SERVICE INSTALLATION, GROUND MOUNTED, METERED	EACH		۸
**	DIRECTIONAL BORING THROUGH ROCK	FOOT	505	/1
	VIDEO VEHICLE DETECTION SYSTEM, SINGLE APPROACH	EACH	3	
	UNINTERRUPTABLE POWER SUPPLY, SPECIAL	EACH	1	
	TEMPORARY INFORMATION SIGNING	SQ FT	25. 7	
*	ELECTRIC CABLE IN CONDUIT, STREET NAME SIGN, NO. 14 3C, TYPE SOOW	FOOT	499	

* 100% COST TO CITY OF JOLIET

SCALE: N.T.S.


** NOMINAL QUANTITY HAS BEEN PROVIDED FOR AREAS WHERE BED ROCK IS ENCOUNTERED WHEN DRILLING, EXCAVATING, AND/OR BORING FOR CONCRETE FOUNDATIONS, HANDHOLES, AND CONDUIT.

 \bigwedge REVISED 4/7/2020 TS 22534 **ECON 121**

REVISED = 3/9/2020 DESIGNED - EA USER NAME = \$USER\$ DRAWN - EA, AV REVISED - 14/6/2020 PLOT SCALE = 40.0000 ' / in. CHECKED - PKG REVISED PLOT DATE = \$DATE\$ - 2/6/2020 DATE REVISED


MAST ARM MOUNTED LED STREET NAME SIGNS AND SCHEDULE OF QUANTITIES US RTE 30 WB (CASS ST) AT JOLIET ST
SHEET NO. OF SHEETS STA. T

LOCATION NO. 23 COUNTY TOTAL SHEET NO.
WILL 90 59
CONTRACT NO. 62H79 SECTION 2018-141-TS&I

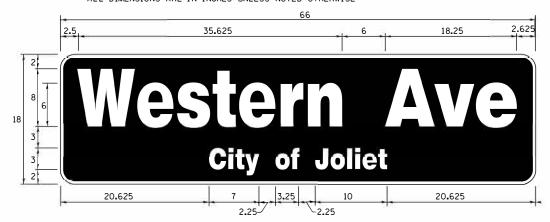

ĺ	DESIGN	AREA	SIGN PANEL	SHEETING	QTY.	
	SERIES	(SQ FT)	TYPE	TYPE	REQUIRED	
	TOP LINE: D BOT. LINE: D	8. 25	LED	N/A	2	

SIGN SHALL BE DOUBLE-SIDED

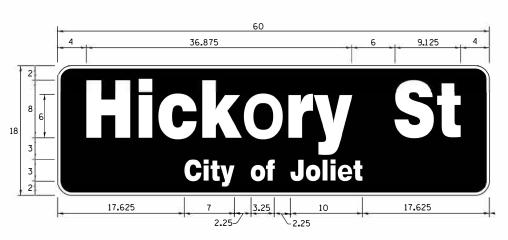

DESIGN	AREA	SIGN PANEL	SHEETING	QTY.	
SERIES	(SQ FT)	TYPE	TYPE	REQUIRED	
TOP LINE: D BOT. LINE: D	7.5	LED	N/ A		

SIGN SHALL BE DOUBLE-SIDED


SCHEDULE OF QUANTITIES

	ITEM DESCRIPTION	UNITS	TOTAL QTY.	
**	ROCK EXCAVATION	CU YD	5	~ ^
**	DRILLED SHAFT IN ROCK	CU YD	8	1 1
	UNDERGROUND CONDUIT, GALVANIZED STEEL, 2" DIA.	FOOT	163	
	UNDERGROUND CONDUIT, GALVANIZED STEEL, 3" DIA,	FOOT	27	
	UNDERGROUND CONDUIT, GALVANIZED STEEL, 4" DIA.	FOOT	284	
	HANDHOLE	EACH	3	
	DOUBLE HANDHOLE	EACH	1	
İ	TRANSCEIVER - FIBER OPTIC	EACH	1	
	ELECTRIC CABLE IN CONDUIT, SIGNAL NO. 14 2C	FOOT	846	
	ELECTRIC CABLE IN CONDUIT, SIGNAL NO. 14 3C	FOOT	1041	
	ELECTRIC CABLE IN CONDUIT, SIGNAL NO. 14 5C	FOOT	1615	
	ELECTRIC CABLE IN CONDUIT, SERVICE, NO. 6 2C	FOOT	159	
	ELECTRIC CABLE IN CONDUIT, EQUIPMENT GROUNDING CONDUCTOR, NO. 6 1C	FOOT	540	
	TRAFFIC SIGNAL POST, GALVANIZED STEEL 16 FT.	EACH	2	
	STEEL MAST ARM ASSEMBLY AND POLE, 36 FT.	EACH	1	
	STEEL COMBINATION MAST ARM ASSEMBLY AND POLE 20 FT.	EACH	1	
	STEEL COMBINATION MAST ARM ASSEMBLY AND POLE 34 FT.	EACH	1	
	CONCRETE FOUNDATION, TYPE A	FOOT	12	
	CONCRETE FOUNDATION, TYPE C	FOOT	4	
	CONCRETE FOUNDATION, TYPE E 30-INCH DIAMETER	FOOT	37	
	DRILL EXISTING HANDHOLE	EACH	2	
	SIGNAL HEAD, LED, 1-FACE, 3-SECTION, MAST ARM MOUNTED	EACH	7	
	SIGNAL HEAD, LED, 1-FACE, 3-SECTION, BRACKET MOUNTED	EACH	3	
	PEDESTRIAN SIGNAL HEAD, LED, 1-FACE, BRACKET MOUNTED WITH COUNTDOWN TIMER	EACH	6	
	TRAFFIC SIGNAL BACKPLATE, RETROREFLECTIVE	EACH	7	
*	LIGHT DETECTOR	EACH	2	
*	LIGHT DETECTOR AMPLIFIER	EACH	1	
	PEDESTRIAN PUSH-BUTTON	EACH	6	
	TEMPORARY TRAFFIC SIGNAL INSTALLATION	EACH	1	
	REMOVE EXISTING TRAFFIC SIGNAL EQUIPMENT	EACH	1	
	REMOVE EXISTING HANDHOLE	EACH	3	
	REMOVE EXISTING DOUBLE HANDHOLE	EACH	1	
	REMOVE EXISTING CONCRETE FOUNDATION	EACH	8	
*	EMERGENCY VEHICLE PRIORITY SYSTEM LINE SENSOR CABLE, NO. 20 3/C	FOOT	295	
*	LED INTERNALLY ILLUMINATED STREET NAME SIGN	EACH	3	
	FULL-ACTUATED CONTROLLER AND TYPE SUPER P CABINET (SPECIAL)	EACH	1	
	SERVICE INSTALLATION, GROUND MOUNTED, METERED	EACH	1	۸
**	DIRECTIONAL BORING THROUGH ROCK	FOOT	474	1\
	VIDEO VEHICLE DETECTION SYSTEM, SINGLE APPROACH	EACH	3	
	UNINTERRUPTABLE POWER SUPPLY, SPECIAL	EACH	1	
	TEMPORARY INFORMATION SIGNING	SQ FT	25. 7	
	TEMPORARY TRAFFIC SIGNAL TIMING	EACH	1	
*	ELECTRIC CABLE IN CONDUIT, STREET NAME SIGN, NO. 14 3C, TYPE SOOW	FOOT	452	

- * 100% COST TO CITY OF JOLIET
- ** NOMINAL QUANTITY HAS BEEN PROVIDED FOR AREAS WHERE BED ROCK IS ENCOUNTERED WHEN DRILLING, EXCAVATING, AND/OR BORING FOR TEMPORARY WOOD POLES, CONCRETE FOUNDATIONS, HANDHOLES, AND CONDUIT.


1 REVISED 4/7/2020

TS 22533 ECON 121 LOCATION NO. 24

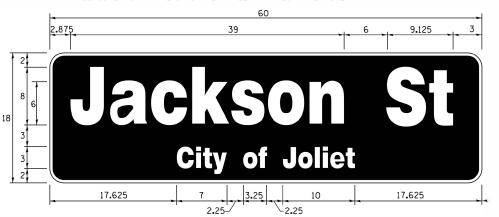

DESIGN	AREA	SIGN PANEL	SHEETING	OTY.
SERIES	(SQ FT)	TYPE	TYPE	REQUIRED
TOP LINE: D BOT. LINE: D	7.5	LED	N/A	

SIGN SHALL BE DOUBLE-SIDED

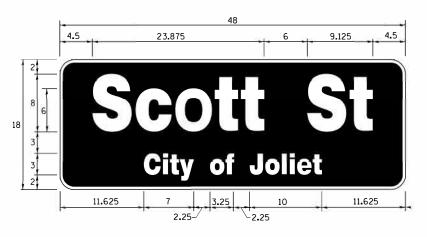

DESIGN	AREA	SIGN PANEL	SHEETING	QTY.	
SERIES	(SQ FT)	TYPE	TYPE	REQUIRED	
TOP LINE: D BOT. LINE: D	6.0	LED	N/ A		

SIGN SHALL BE DOUBLE-SIDED

SCHEDULE OF QUANTITIES

	ITEM DESCRIPTION	UNITS	TOTAL OTY.	
**	ROCK EXCAVATION	CU YD	4.5	~
**	DRILLED SHAFT IN ROCK	CU YD	8	} \(\frac{1}{1} \)
	UNDERGROUND CONDUIT, GALVANIZED STEEL, 2" DIA.	FOOT	287	
	UNDERGROUND CONDUIT, GALVANIZED STEEL, 3" DIA.	FOOT	20	
	UNDERGROUND CONDUIT, GALVANIZED STEEL, 4" DIA.	FOOT	306	
	HANDHOLE	EACH	1	
	DOUBLE HANDHOLE	EACH	2	
	TRANSCEIVER - FIBER OPTIC	EACH	1	
	ELECTRIC CABLE IN CONDUIT, SIGNAL NO. 14 2C	FOOT	931	
	ELECTRIC CABLE IN CONDUIT, SIGNAL NO. 14 3C	FOOT	1360	
	ELECTRIC CABLE IN CONDUIT, SIGNAL NO. 14 5C	FOOT	1013	
	ELECTRIC CABLE IN CONDUIT, SIGNAL NO. 14 7C	FOOT	330	
	ELECTRIC CABLE IN CONDUIT, SERVICE, NO. 6 2C	FOOT	213	
	ELECTRIC CABLE IN CONDUIT, EQUIPMENT GROUNDING CONDUCTOR, NO. 6 1C	FOOT	620	
	TRAFFIC SIGNAL POST, GALVANIZED STEEL 16 FT.	EACH	1	
	STEEL MAST ARM ASSEMBLY AND POLE, 26 FT.	EACH	1	
	STEEL MAST ARM ASSEMBLY AND POLE, 44 FT.	EACH	1	
	STEEL COMBINATION MAST ARM ASSEMBLY AND POLE 28 FT.	EACH	1	
	CONCRETE FOUNDATION, TYPE A	FOOT	8	
	CONCRETE FOUNDATION, TYPE C	FOOT	4	
	CONCRETE FOUNDATION, TYPE E 30-INCH DIAMETER	FOOT	20	
	CONCRETE FOUNDATION, TYPE E 36-INCH DIAMETER	FOOT	13	
	DRILL EXISTING HANDHOLE	EACH	3	
	SIGNAL HEAD, LED, 1-FACE, 3-SECTION, MAST ARM MOUNTED	EACH	6	
	SIGNAL HEAD, LED, 1-FACE, 3-SECTION, BRACKET MOUNTED	EACH	2	
	SIGNAL HEAD, LED, 1-FACE, 5-SECTION, BRACKET MOUNTED	EACH	1	
	SIGNAL HEAD, LED, 1-FACE, 5-SECTION, MAST ARM MOUNTED	EACH	1	
	PEDESTRIAN SIGNAL HEAD, LED, 1-FACE, BRACKET MOUNTED WITH COUNTDOWN TIMER	EACH	8	
	TRAFFIC SIGNAL BACKPLATE, RETROREFLECTIVE	EACH EACH	7	
*	LIGHT DETECTOR AMPLIFIER	EACH	2	
不	PEDESTRIAN PUSH-BUTTON	EACH	8	
	TEMPORARY TRAFFIC SIGNAL INSTALLATION	EACH	1	
	REMOVE EXISTING TRAFFIC SIGNAL EQUIPMENT	EACH	1	
	REMOVE EXISTING HANDHOLE	EACH	7	
	REMOVE EXISTING CONCRETE FOUNDATION	EACH	6	
*	EMERGENCY VEHICLE PRIORITY SYSTEM LINE SENSOR CABLE, NO. 20 3/C	FOOT	373	
*	LED INTERNALLY ILLUMINATED STREET NAME SIGN	EACH	3	
	FULL-ACTUATED CONTROLLER AND TYPE SUPER R CABINET (SPECIAL)	EACH	1	
	SERVICE INSTALLATION, GROUND MOUNTED, METERED	EACH	1	ē .
**	DIRECTIONAL BORING THROUGH ROCK	FOOT	613	
	PEDESTRIAN SIGNAL POST, 10 FT	EACH	1	
	VIDEO VEHICLE DETECTION SYSTEM, SINGLE APPROACH	EACH	3	
	UNINTERRUPTABLE POWER SUPPLY, SPECIAL	EACH	1	
	CONCRETE FOUNDATION. TYPE A 10-INCH DIAMETER	FOOT	4	
	RELOCATE EXISTING MASTER CONTROLLER	EACH	1	
	TEMPORARY INFORMATION SIGNING	SQ FT	25. 7	
	TEMPORARY TRAFFIC SIGNAL TIMING	EACH	1	
*	ELECTRIC CABLE IN CONDUIT, STREET NAME SIGN, NO. 14 3C, TYPE SOOW	FOOT	405	

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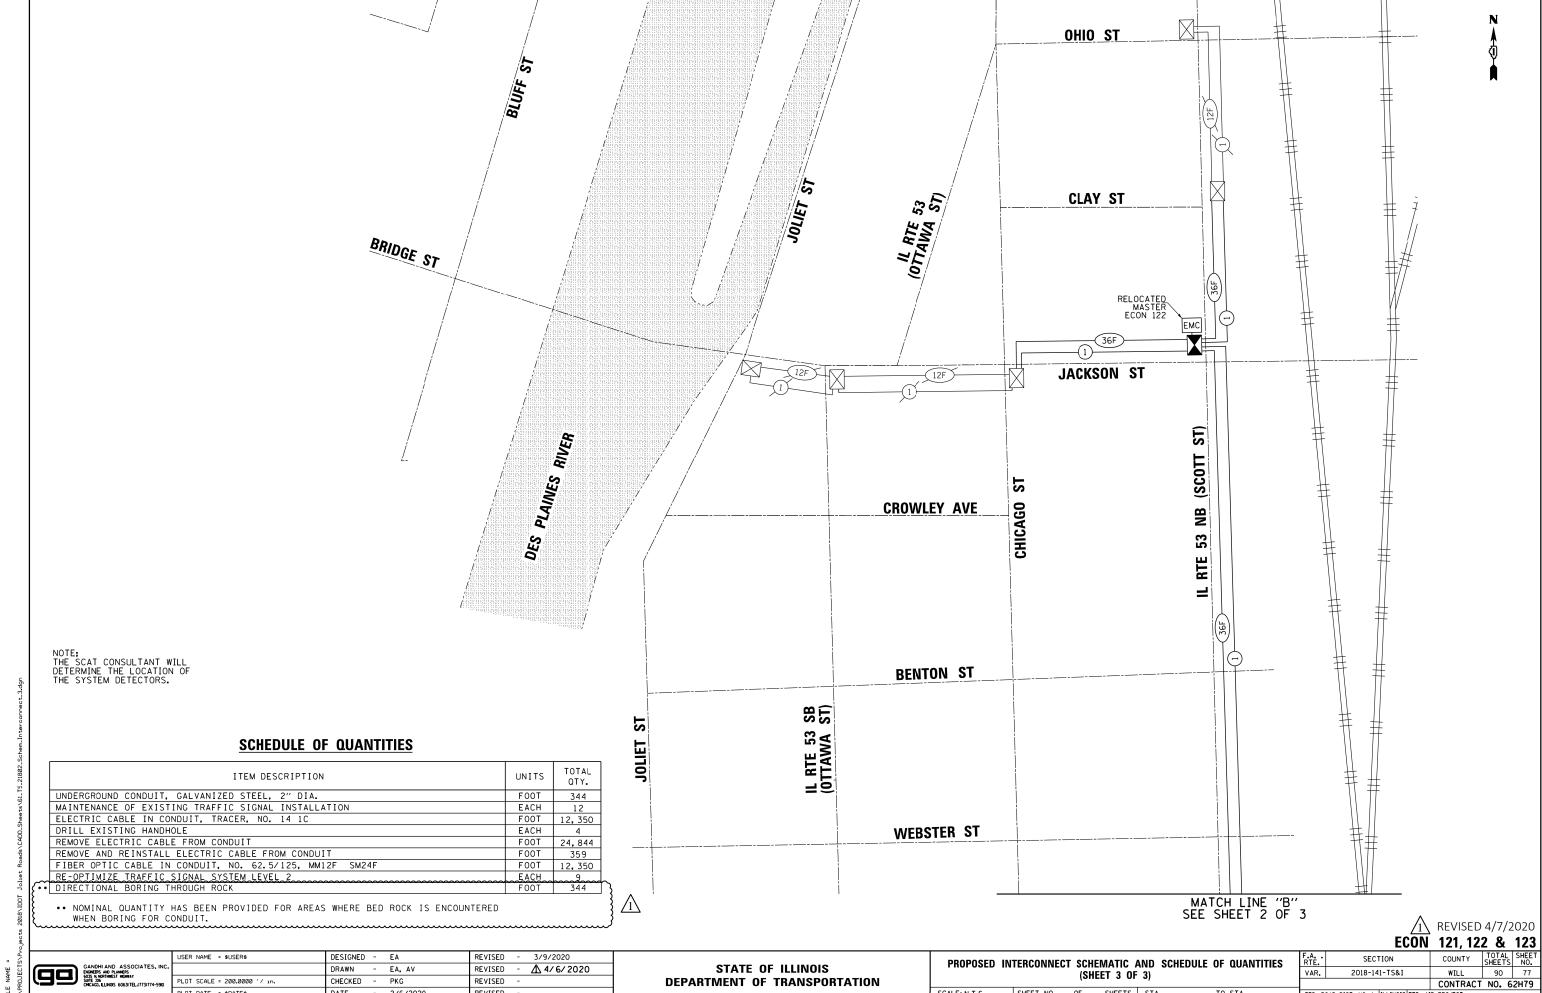
REVISED 4/7/2020 TS 21802 **ECON 122**

PLOT SCALE = 40.0000 ' / in. PLOT DATE = \$DATE\$

REVISED = 3/9/2020 USER NAME = \$USER\$ DESIGNED - EA DRAWN - EA, AV REVISED - 14/6/2020 CHECKED - PKG REVISED DATE - 2/6/2020 REVISED

STATE OF ILLINOIS **DEPARTMENT OF TRANSPORTATION**

LOCATION NO. 30 COUNTY TOTAL SHEET NO.
WILL 90 69
CONTRACT NO. 62H79 MAST ARM MOUNTED LED STREET NAME SIGNS SECTION AND SCHEDULE OF QUANTITIES VAR 2018-141-TS&I IL RTE 53 NB (SCOTT ST) AT JACKSON ST
SHEET NO. OF SHEETS STA. TO SCALE: N.T.S. TO STA.



SHEET NO. OF SHEETS STA.

TO STA.

SCALE: N.T.S.

DATE

2/6/2020

REVISED