04-24-2020 LETTING ITEM 150

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- SCHEDULES OF QUANTITIES
- EXISTING CONTROL, DEMOLITION PLAN AND PROFILE VIEWS

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000001-07

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PLAN

PROFILE HORIZONTAL

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- RRFB LAYOUT PLAN
- URBAN ENTRANCES, ACCESSIBLE TO THE DISABLED, FOR SEPARATED SIDEWALKS

STANDARD SYMBOLS, ABBREVIATIONS AND PATTERNS

COMB. CURB TYPE B & COMB. CONCRETE CURB AND GUTTER

LANE CLOSURE, 2L, 2W, DAY ONLY, FOR SPEEDS > = 45MPH

LANE CLOSURE, 2L, 2W, SLOW MOVING OPERATIONS, DAY ONLY, FOR SPEEDS >= 45MPH

LANE CLOSURE, 2L, 2W, SHORT TIME OPERATIONS

URBAN LANE CLOSURE, MULTI-LANE INTERSECTION

SIDEWALK, CORNER OR CROSSWALK CLOSURE

ELECTRICAL SERVICE INSTALLATION DETAILS

URBAN LANE CLOSURE, 2L, 2W, UNDIVIDED

MID-BLOCK CURB RAMPS FOR SIDEWALKS MEDIAN PEDESTRIAN CROSSING

PC CONCRETE ISLANDS AND MEDIANS

STATE OF ILLINOIS **DEPARTMENT OF TRANSPORTATION DIVISION OF HIGHWAYS**


PLANS FOR PROPOSED SAFE ROUTE TO SCHOOLS

FAS 1380 (ILLINOIS ROUTE 91)

SECTION 19-00027-00-SW FEDERAL PROJECT NO. YPHN(839) JOB NO. C-94-011-20 **COUNTY OF PEORIA, ILLINOIS** VILLAGE OF DUNLAP

JACK FENNELL, PRESIDENT TRACY KORGER, VILLAGE CLERK

R-7-E, 3rd. P.M. · HIGH SCHOOL VILLAGE OF DUNLAP PROJECT LOCATION

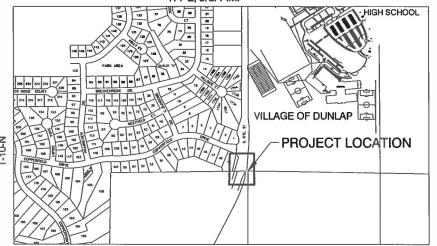

IL RTE. 91 FROM COPPERFIELD DR. SOUTH 270 FT. TO SCHOOL PROPERTY GROSS LENGTH OF PROJECT: 0.058 MI NET LENGTH OF PROJECT: 0.058 MI. TOTAL NUMBER OF PLAN SHEETS = 4

> PROPOSED IMPROVEMENT CONSISTS OF CONSTRUCTING NEW SIDEWALKS AND REFUGE ISLAND, INSTALLING SIGNAGE, LIGHTING

VILLAGE OFFICIALS

DWIGHT JOHNSON, VILLAGE TREASURER

BOARD OF TRUSTEES

BOB ANDERSON JACK ESTERDAHI **BEAU FEUCHTER** ERIC KEYSTER ROGER NELSON SHEILA TAYLOR

DISTRICT 4 ENGINEER OF RELEASING FOR REGION THREE ENGINEER STATE OF ILLINOIS DEPARTMENT OF TRANSPORTATION

PRINTED BY THE AUTHORITY OF THE STATE OF ILLINOIS

W. Franklin Sturm

W. FRANKLIN STURM TO BELLINOIS REGISTRATION 430001

essional Design Firm #184,005091

JULIE LOCATION

CALL JULIE 811 OR 1-800-892-0123 48 HOURS BEFORE YOU DIG EXCLUDING SATURDAYS, SUNDAYS, AND HOLIDAYS

CONTRACT NO. 89773 CATALOG # 035843-00



MOHR & KERR ENGINEERING & LAND SURVEYING, P.C. 5901 N. Prospect Road, Suite 6B Peoria, Illinois 61614 Fax: (309) 692-8501 Fax: (309) 692-8501

LOCATION OF PROPOSED IMPROVEMENT


19-00027-00-SW

FEDERAL ROAD DIST NO.

PEORIA 11 1

ILLINOIS CONTRACT NO. 89773

EXISTING TYPICAL SECTION - ILLINOIS ROUTE 91

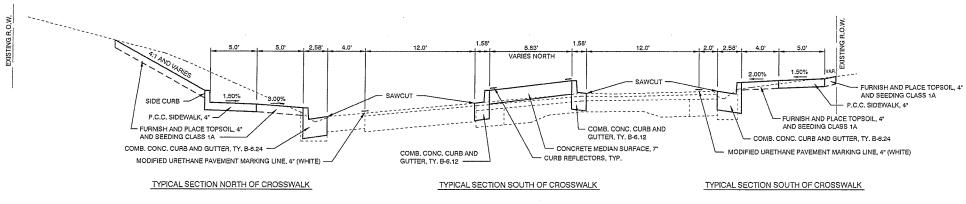

PROPOSED TYPICAL SECTION - ILLINOIS ROUTE 91 SCALE: 1" = 5' HORIZ 1" = 2' VERT.

GENERAL NOTES

- PLAN ELEVATIONS U.S.G.S. MEAN SEA LEVEL DATUM
 ALL ELEVATIONS SHOWN ON THE PLANS ARE ESTABLISHED FROM U.S.G.S. MEAN SEA LEVEL DATUM.
- EARTH EXCAVATION INCIDENTAL TO CURB, GUTTER, DRIVEWAY, AND SIDEWALK
 EARTH EXCAVATION AND BACKFILL FOR PROPOSED CURB AND GUTTERS, DRIVEWAY PAVEMENTS, AND SIDEWALKS SHALL BE INCLUDED IN THE UNIT COST OF THE VARIOUS ITEMS.

ENVIRONMENTAL REVIEWS
PRIOR TO THE USE OF ANY PROPOSED BORROW AREAS, USE AREAS (TEMPORARY ACCESS ROADS, DETOURS, RUN-AROUNDS, ETC.) AND/OR WASTE AREAS, THE CONTRACTOR SHALL FILE THE REQUIRED ENVIRONMENTAL RESOURCE REQUEST SURVEYS ACCORDING TO SECTION 107.22
OF THE STANDARD SPECIFICATIONS, THESE SURVEYS ARE REQUIRED IN ORDER FOR THE DEPARTMENT TO CONDUCT CULTURAL AND BIOLOGICAL RESOURCE SURVEYS FOR THE PROPOSED SITE.

THE REQUIRED ENVIRONMENTAL RESOURCE DOCUMENTATION SHALL INCLUDE THE FOLLOWING:

- BDE FORM 2289 (CULTURAL AND NATURAL RESOURCES REVIEW OF BORROW AREAS)
- BDE FORM 2290 (WASTE,USE AREA REVIEW)
 A LOCATION MAP SHOWING THE SIZE LIMITS AND LOCATION OF THE USE AREA COLOR PHOTOGRAPHS DEPICTING THE USE AREA
- BORROW AREA ENTRY AGREEMENT FORM D4 PI0101

PRIOR TO ANY WASTE MATERIALS BEING REMOVED FROM THE CONSTRUCTION SITE, THE REQUIRED ENVIRONMENTAL RESOURCE SURVEYS SHALL BE OBTAINED AND FILED BY THE CONTRACTOR. EXCESS WASTE PRODUCTS REMOVED FROM THE CONSTRUCTION SITE SHALL BE DISPOSED OF AS REQUIRED IN SECTION 202,03 OF THE STANDARD SPECIFICATIONS.

ANY PROTRUDING METAL BARS SHALL BE REMOVED PRIOR TO THE DISPOSAL OF BROKEN CONCRETE AT APPROVED DISPOSAL SITES.

PLEASE NOTE THAT A MINIMUM OF FOUR WEEKS SHALL BE ALLOWED FOR THE DISTRICT TO OBTAIN THE REQUIRED WASTE SITE ENVIRONMENTAL CLEARANCES, AND SIX WEEKS FOR THE REQUIRED BORROW SITE ENVIRONMENTAL CLEARANCES.

SIGN POST HOLES
VERTICAL HOLES SHALL BE CONSTRUCTED IN THE ISLAND PAVEMENT AND/OR CONCRETE MEDIAN OF THE TYPE SPECIFIED OR CONCRETE MEDIAN SURFACE 4 INCHES (100MM), THE HOLES SHALL BE 24 INCHES (600MM) IN DIAMETER OR 24 INCHES (600MM) SQUARE AND THEY SHALL BE FREE OF ANY OBSTRUCTION, EXCEPT EARTH, FOR A DEPTH OF 5 FEET (1.5M) AT THE LOCATIONS SHOWN ON THE PLANS OR AS DIRECTED BY THE ENGINEER, ANY HOLES NOT USED FOR THE PLACEMENT OF SIGNS SHALL BE FILLED AND COMPACTED FLUSH WITH THE TOP OF THE ISLAND PAVEMENT, CONCRETE MEDIAN OF THE TYPES SPECIFIED, OR CONCRETE MEDIAN SURFACE 4 INCHES (100MM), THE TOP 3 INCHES (75MM) OF SAID COMPACTED FILL SHALL CONSIST OF A HOT-MIX ASPHALT MIXTURE. ALL HOLES IN WHICH THE SIGN POSTS ARE INSTALLED AT THE TIME OF THIS CONTRACT SHALL BE SIMILARLY FILLED.

THIS WORK, INCLUDING ANY REQUIRED PAVEMENT REMOVAL NECESSARY TO CONSTRUCT THE SIGN POST HOLES, WILL NOT BE PAID FOR SEPARATELY BUT SHALL BE INCLUDED IN THE CONTRACT UNIT PRICE PER SQUARE FOOT (SQUARE METER) FOR ISLAND PAVEMENT AND/OR CONCRETE MEDIAN OF THE TYPE SPECIFIED, OR CONCRETE MEDIAN SURFACE, 4 INCHES (100MM).

ADDITIONAL SUPPLEMENTAL TRAFFIC CONTROL
THE DEPARTMENT RESERVES THE RIGHT AT ANY TIME TO ADD ADDITIONAL TRAFFIC CONTROL SYSTEMS OR DEVICES WITHIN THE ACTIVE CONTRACT LIMITS, BY MEANS OF AN ADDITIONAL CONTRACT, ALL TERMS OF ARTICLE 105.08 OF THE STANDARD SPECIFICATIONS SHALL BE FOLLOWED BY EACH CONTRACTOR.

6. SIGNING SIGN LOCATIONS MAY VARY FROM THE STATIONS SHOWN ON THE FLANS IN ACCORDANCE WITH DIRECTIONS FROM THE ENGINEER AT THE TIME OF CONSTRUCTION. SIGN LOCATIONS MAY BE ADJUSTED IN THE FIELD TO AVOID ANY FOUND UTILITIES.


ALL WOOD POST LOCATIONS SHALL BE VERIFIED WITH THE BUREAU OF OPERATIONS, TRAFFIC SECTION, BEFORE INSTALLATION.

P.C.C. SIDEWALK
ALL SIDEWALKS SHALL BE ADA COMPLIANT. THE SIDE CURB AT ACCESSIBLE RAMPS AND AT THE BACK OF SIDEWALKS SHALL BE INCLUDED IN THE COST AND MEASUREMENT OF THE P.C.C. SIDEWALK, 4*.

SUMMARY OF QUANTITIES

CODE NO.	<u>ITEM</u>	QUANTITY	UNIT
20101400	NITROGEN FERTILIZER NUTRIENT	9	LB.
20101500	PHOSPHORUS FERTILIZER NUTRIENT	9	LB.
20101600	POTASSIUM FERTILIZER NUTRIENT	9	LB.
21101615	TOPSOIL FURNISH AND PLACE, 4"	436	S.Y.
25000110	SEEDING, CLASS 1A	0.1	ACRE
25100115	MULCH, METHOD 2	0.1	ACRE
42300300	PORTLAND CEMENT CONCRETE DRIVEWAY PAVEMENT, 7"	39	5.Y.
42400100	PORTLAND CEMENT CONCRETE SIDEWALK, 4"	1654	S.F.
42400800	DETECTABLE WARNINGS	40	S.F.
44000100	PAVEMENT REMOVAL	252	5.Y.
44000400	GUTTER REMOVAL	338	FT.
60603800	COMBINATION CONCRETE CURB & GUTTER, TYPE 8-6.12	210	FT.
60605000	COMBINATION CONCRETE CURB & GUTTER, TYPE 8-6.24	337	FT.
60618330	CONCRETE MEDIAN SURFACE, 7"	684	S.F.
67100100	MOBILIZATION	1	L SUM
70100450	TRAFFIC CONTROL AND PROTECTION, STANDARD 701201	1	L. SUM
△ 72000100	SIGN PANEL - TYPE 1	18	S.F.
72400310	REMOVE SIGN PANEL - TYPE 1	44	S.F.
△ 72800100	TELESCOPING STEEL SIGN SUPPORT	30	FT.
△78009000	MODIFIED URETHANE PAVEMENT MARKING - LETTERS AND SYMBOLS	47	S.F.
△78009004	MODIFIED URETHANE PAVEMENT MARKING -LINE, 4"	1096	FT.
△ 78009006	MODIFIED URETHANE PAVEMENT MARKING -LINE, 6"	60	FT.
△ 78009008	MODIFIED URETHANE PAVEMENT MARKING -LINE, 8"	174	FT.
△78009024	MODIFIED URETHANE PAVEMENT MARKING -LINE, 24"	54	FT.
△ 78200020	CURB REFLECTORS	19	EA.
△ 80500100	ELECTRIC SERVICE INSTALLATION, TYPE A	1	EA.
△ 81028340	UNDERGROUND CONDUIT, PVC, 1.5" DIA.	491	FT.
△ 81400700	HANDHOLE, PORTLAND CEMENT CONCRETE	2	EA.
△ 81702120	ELECTRIC CABLE IN CONDUIT, 600V (XLP-TYPE USE) 1/C NO. 8	1302	FT.
△ 81702130	ELECTRIC CABLE IN CONDUIT, 600V (XLP-TYPE USE) 1/C NO. 6	10	FT.
△ 81702150	ELECTRIC CABLE IN CONDUIT, 600V (XLP-TYPE USE) 1/C NO. 2	14	FT.
△ 83600200	LIGHT POLE FOUNDATION, 24" DIA.	25	FT.
△ 87301225	ELECTRIC CABLE IN CONDUIT, SIGNAL NO. 14 3C	242	FT.
∆ X0326263	EQUIPMENT CABINET	1	EA.
∆ X0327008	REMOVE AND RELOCATE SIGN, (SPECIAL)	1	EA.
X0327980	PAVEMENT MARKING REMOVAL - WATER BLASTING	658	5.F.
X0556100	PARTIAL DEPTH PATCHING (SPECIAL)	10	5.Y.
△ X1400211	LIGHT POLE SPECIAL, 30'	5	EA.
∆ X1400326	RECTANGULAR RAPID FLASHING BEACON ASSEMBLY (COMPLETE)	4	EA.
X7270025	REMOVE EXISTING SIGN SUPPORT	2	EA.
△ X8130110	JUNCTION BOX (SPECIAL)	2	EA.
△ X8250505	LIGHTING CONTROLLER, SPECIAL	1	EA.

A SPECIALTY ITEMS

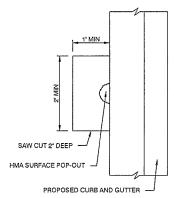

REMOVE AND REPLACE SURFACE WITH HMA SURFACE COURSE, MIX D, N50

PARTIAL DEPTH PATCH DETAIL N.T.S.

MOHR & KERR ENGINEERING & LAND SURVEYING, P.C 5901 N. Prospect Road, Suite 6B Office: (309) 692-8500 Peoria, Illinois 61614

Fax: (309) 692-8501 Professional Design Firm #184,005091

)	DESIGNED	WFS	REVISED	
J.	DRAWN	DH/BR	REVISED	
	CHECKED	WFS	REVISED	
	DATE	02-19-20	REVISED	

STATE OF ILLINOIS **DEPARTMENT OF TRANSPORTATION**

S.R.T.S., IL. RTE. 91 CROSSING, DUNLAP, IL
TYPICAL SECTIONS AND SUMMARY OF QUANTITIES

SCALE: AS NOTED SHEET NO. 2 OF 10 SHEETS STA.

	F.A.S. ROUTE	SECTION		COUNTY	TOTAL SHEETS	SHEE NO.
	1380	19-00027-00-SW		PEORIA	11	2
_				CONTRAC	CT NO. 8	9773
		ILLINOIS	FEDER	RAL ROAD DIST N	₹O.	

SEEDING SCHEDULE

FERTILIZER TO BE APPLIED @ 270 LB. PER ACRE @ 1-1-1 RATIO

	TOPSOIL FURNISHING AND PLACING, 4"	SEEDING CLASS 1A	NITROGEN FERTILIZER NUTRIENT	PHOSPHORUS FERTILIZER NUTRIENT	POTASSIUM FERTILIZER NUTRIENT	MULCH METHOD 2
LOCATION	(S.Y.) * 21101615	(ACRE) 25000110	(POUND) 20101400	(POUND) 20101500	(POUND) 20101600	(ACRE) 25100115
ILLINOIS ROUTE 91						
LT. SIDE = 0.070 ACRE	436	0.07	6	6	6	0.07
RT. SIDE = 0.030 ACRE		0.03	3	3	3	0.03
PROJECT TOTALS	436 S.Y.	0.1 ACRE	9 LB.	9 LB.	9 LB.	0.1 ACRE

* 436 S.Y EQUATES TO 48.4 C.Y. OF TOPSOIL AT 4" THICK

PORTLAND CEMENT CONCRETE DRIVEWAY PAVEMENT, 7"	42300300
LOCATION	
RT. STA. 79+13.23 TO RT. STA. 79+52.56	39 S.Y.
PROJECT TOTAL	39 S.Y.

PORTLAND CEMENT CONCRETE SIDEWALK, 4"	42400100
LOCATION	
26.58' RT. STA. 78+99.82 TO 26.58' RT. STA. 79+13.23	69 S.F.
26.58' RT. STA. 79+52.56 TO 22.00' RT. STA. 80+07.04	325 S.F.
24.00' LT. STA. 80+07.04 TO 76.49' LT. STA. 81+89.28	1188 S.F.
RT. STA. 80+07.04 TO LT. STA. 80+07.04	72 S.F.
PROJECT TOTAL	1654 S.F.

DETECTABLE WARNINGS	42400800	
LOCATION		
03.50' LT. STA. 80+07.04	10 S.F.	
25.53' LT. STA. 80+07.04	10 S.F.	
03.50' RT. STA. 80+07.04	10 S.F.	
24.08' RT. STA. 80+07.04	10 S.F.	
PROJECT TOTAL	40 S.F.	

PAVEMENT REMOVAL	44000100
LOCATION	
CL. STA. 79+49.7 TO CL. STA. 80+56.6	175 S.Y.
18.0' RT. STA. 78+94.4 TO 18.0' RT. STA. 80+35.95	29 S.Y.
20.0' LT. STA. 79+72.9 TO 25.3' LT. STA. 81+69.25	48 S.Y.
PROJECT TOTAL	252 S.Y.

GUTTER REMOVAL	44000400
LOCATION	
18.00' RT. STA. 78 + 94.39 TO 18.00' RT. STA. 80 + 35.95	142 FT.
20.00' LT. STA. 79 + 72.89 TO 25.29' LT. STA. 81 + 69.29	196 FT.
PROJECT TOTAL	338 FT

COMBINATION CONCRETE CURB AND GUTTER, TYPE B-6.12	60603800
LOCATION	
LT. STA. 79+52.67 TO 3.16' LT. STA. 80+53.61	105 FT.
RT. STA. 79+52.67 TO 3.16' LT. STA. 80+53.61	105 FT.
PROJECT TOTAL	210 FT.

COMBINATION CONCRETE CURB AND GUTTER, TYPE B-6.24	60605000
LOCATION	
19.48' RT. STA. 78+94.40 TO 20.00' RT. STA. 80+35.93	144 FT.
21.77' LT. STA. 79+72.89 TO 27.01' LT. STA. 81+68.26	193 FT.
PROJECT TOTAL	337 FT.

CONCRETE MEDIAN SURFACE, 7 INCH	60618330
LOCATION	
CL. STA. 79+53.3 TO CL. STA. 80+03.0	431 S.F.
CL. STA. 80+11.1 TO 03.1' LT. STA. 80+53.0	253 S.F.
PROJECT TOTAL	684 S.F.

7200010	
9 S.	
9 S.	
18 S.	

REMOVE SIGN PANEL - TYPE 1	72400310
LOCATION	
30.75' LT. STA. 80+23.23	22 S.F.
29.47' RT. STA. 80+22.61	22 S.F.
PROJECT TOTAL	44 S.F.

TELESCOPING STEEL SIGN SUPPORT	72800100	
LOCATION		
25.50' RT. STA. 79+54.25	15 FT.	
27.50' LT. STA. 80+61.10	15 FT.	
PROJECT TOTAL	30 FT.	

MODIFIED URETHANE PAVEMENT MARKINGS

IL. RTE. 91 STA. 78+94.39 TO STA. 81+93.23

	/- <u></u>	WHITE	YELLOW	TOTAL		
LETTERS AND SYMBOLS	(S.F.) 78009000	47	-	47	S.F.	
4" LINE (FT.) 78009004		539	557	1096	FT.	
6" LINE (FT.) 78009006		60	<u>¥</u>	60	FT.	
8" LINE (FT.) 78009008		100	74	174	FT.	
24" LINE (FT.) 78009024		54	9	54	FT.	

CURB REFLECTORS	78200020
LOCATION	
CL. STA. 79+52.67 TO 3.16' LT. STA. 80+53.61	19 EA.
PROJECT TOTAL	19 EA.

CONDUITAN	DELL	ECIRI	CCA	RL
-----------	------	-------	-----	----

FROM	TO	UNDRGRD C PVC 1.5"	EC C XLP USE 1 C 2	EC C XLP USE 1 C 6	EC C XLP USE 1 C 8
		81028340	81702150	81702130	81702120
AMEREN POLE	SERV. INSTALL	4 FT.	14 FT.	10 FT.	0 FT.
SERV. INSTALL	LIGHT CONTROLLER	40 FT.	0 FT.	0 FT.	132 FT.
LIGHT CONTROLLER SPL	H.H. #1	5 FT.	0 FT.	0 FT.	27 FT.
H.H. #1	L-1	3 FT.	0 FT.	0 FT.	21 FT.
H.H. #1	L-2	130 FT.	0 FT.	0 FT.	402 FT.
L-1	H.H. #2	68 FT.	0 FT.	0 FT.	216 FT.
H.H. #2	L-3	4 FT.	0 FT.	0 FT.	24 FT.
H.H. #2	L-4	72 FT.	0 FT.	0 FT.	228 FT.
L-4	L-5	80 FT.	0 FT.	0 FT.	252 FT.
PAGE TOTALS		406 FT.	14 FT.	10 FT.	1302 FT.

81400700	
1 EA.	
1 EA.	
2 EA.	

CONDUIT AND ELECTRIC CABLE

FROM	TO	UNDRGRD C PVC 1.5"	ELCBL C SIGNAL 14 3C
		81028340	87301225
RRFB CONTR.	JB1	6 FT.	24 FT.
JB1	RRFB1	3 FT.	18 FT.
JB1	JB2	27 FT.	66 FT.
JB2	RRFB2	3 FT.	18 FT.
JB2	RRFB3	12 FT.	36 FT.
JB2	RRFB4	34 FT.	80 FT.
PAGE TOTALS		85 FT.	242 FT.

LIGHT POLE FOUNDATION, 24" DIA.	83600200
LOCATION	
L-1	5 FT.
L-2	5 FT.
L-3	5 FT.
L-4	5 FT.
L-5	5 FT.
PROJECT TOTAL	25 FT.

NOJEULO	
1 EA.	
1 EA.	

REMOVE AND RELOCATE SIGN, (SPECIAL)	X032/008		
LOCATION			
(E) 32' RT. STA. 79+16 TO 32' RT. STA. 78+98	1 EA.		
PROJECT TOTAL	1 EA.		

PAVEMENT MARKINGS REMOVAL - WATER BLASTING	X0327980
OCATION	
EFT ARROW	31 S.F.
4" LINE	487 S.F.
5" LINE	42 S.F.
B" LINE	98 S.F.
PROJECT TOTAL	658 S F

PARTIAL DEPTH PATCHING (SPECIAL)	X0556100
LOCATION	
VARIOUS	10 S.Y.
PROJECT TOTAL	10 S.Y.

LIGHT POLE SPECIAL, 30'	X1400211	
LOCATION		
32.3' RT. STA. 79+04.7	1 EACH	
29.4' RT. STA. 80+12.0	1 EACH	
37.2' LT. STA. 80+07.0	1 EACH	
37.2' LT. STA. 80+85.6	1 EACH	
45.4' LT. STA. 81+64.6	1 EACH	
PROJECT TOTAL	5 EACH	

R R FL BEACON A COMP	X1400326
LOCATION	QUANTITY
01.50' LT. STA. 80+02.45	1 EA.
28.59' LT. STA. 80+03.39	1 EA.
26.58' RT. STA. 80+10.56	1 EA.
01.49' RT. STA. 80+11.62	1 EA.
PROJECT TOTALS	4 EA.

REMOVE EXISTING SIGN SUPPORT	X7270025
LOCATION	
30.75' LT. STA. 80+23.23	1 EA.
29.47' RT. STA. 80+22.61	1 EA.
PROJECT TOTAL	2 EA.

JUNCTION BOX (SPECIAL)	X813011
LOCATION	
1.27' LT. STA. 80+13.52	1 EA
26.62' RT. STA. 80+13.52	1 EA
PROJECT TOTAL	2 EA

LIGHTING CONTROLLER, (SPECIAL)	X8250505
LOCATION	
32.04' RT. STA. 80+16.52	1 EA.
DROIECT TOTAL	1 EA

M

 MOHR & KERR ENGINE BRING & LAND SURVEYING, P.C.
 DESIGNED
 WFS
 REVISED

 5901 N. Prospect Road, Suite 6B Peoria, Illinois 61614 www.mohrandkerr.com
 Office: (309) 692-8501 Fax: (309) 692-8501
 CHECKED
 WFS
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 DATE
 02-19-20
 REVISED


STATE OF ILLINOIS
DEPARTMENT OF TRANSPORTATION

S.R.T.S., IL. RTE. 91 CROSSING, DUNLAP, IL

SCHEDULES OF QUANTITIES

SCALE: AS NOTED SHEET NO. 3 OF 10 SHEETS STA. - TO STA.

F.A.S. ROUTE	SECTION	COUNTY	TOTAL SHEETS	SHE
1380	19-00027-00-SW	PEORIA	11	3
		CONTRA	CT NO. 8	39773
ILLINOIS EEDERAL BOAD DIST NO				

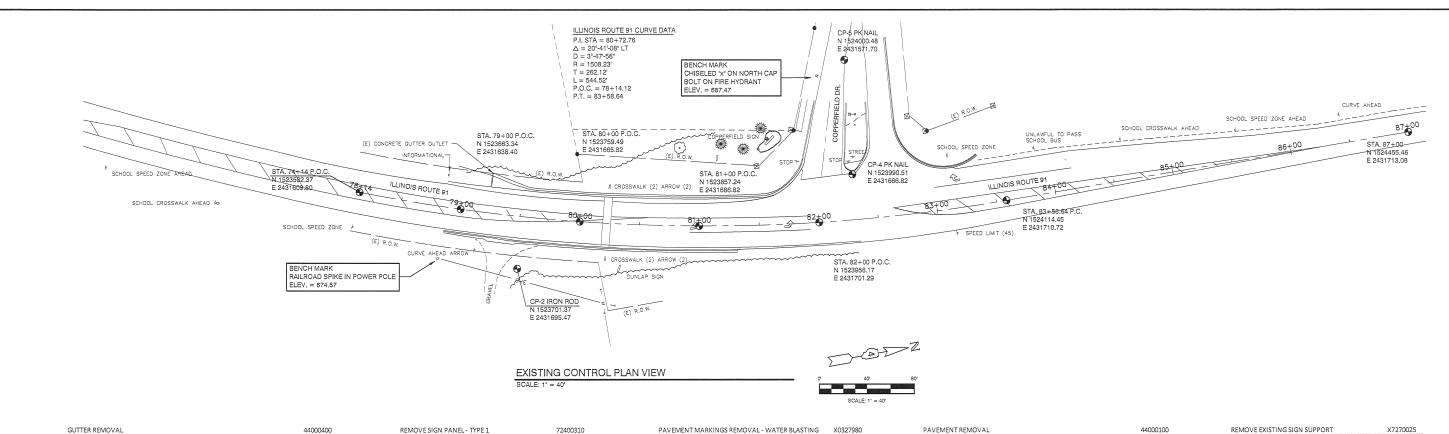

487 S.F.

42 S.F.

98 S.F.

658 S.F.

LOCATION

4" LINE

6" LINE


8" LINE

PROJECT TOTAL

22 S.F.

22 S.F.

44 S.F.

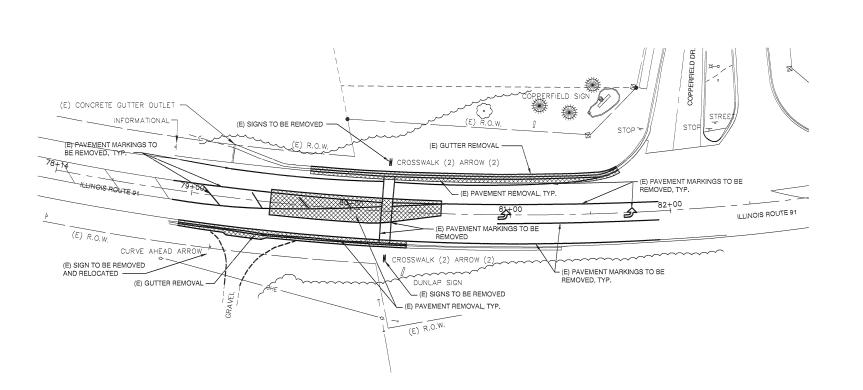

LOCATION

PROJECT TOTAL


196 FT.

338 FT.

30.75' LT. STA. 80+23.23

29.47' RT. STA. 80+22.61

PAVEMENT REMOVAL	44000100	REMOVE EXISTING SIGN SUPPORT	X7270025
OCATION		LOCATION	
CL. STA. 79+49.7 TO CL. STA. 80+56.6	175 S.Y.	30.75' LT. STA. 80+23.23	1 EA.
.8.0' RT. STA. 78+94.4 TO 18.0' RT. STA. 80+35.95	29 S.Y.	29.47' RT. STA. 80+22.61	1 EA.
0.0' LT. STA. 79+72.9 TO 25.3' LT. STA. 81+69.25	48 S.Y.	PROJECT TOTAL	2 EA.
PROJECT TOTAL	252 S.Y.		

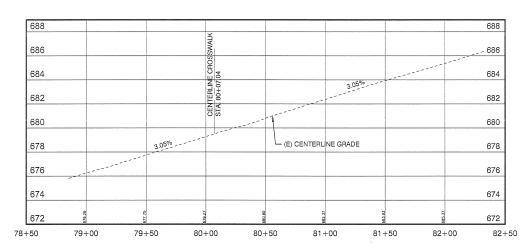

EXISTING CENTERLINE PROFILE VIEW SCALE: 1" = 40' HORIZ. 1" = 4' VERT.

EXISTING DEMOLITION PLAN VIEW

SCALE: 1" = 30'

DESIGNED WFS REVISED DRAWN DH/BR REVISED

STATE OF ILLINOIS DEPARTMENT OF TRANSPORTATION

S.R.T.S., IL. RTE. 91 CROSSING, DUNLAP, IL EXISTING CONTROL, DEMOLITION PLAN AND PROFILE VIEWS SCALE: AS NOTED SHEET NO. 4 OF 10 SHEETS STA. 74+15 TO STA. 87+00

SECTION COUNTY 1380 19-00027-00-SW PEORIA 11 4 CONTRACT NO. 89773

LOCATION


PROJECT TOTAL


18.00' RT. STA. 78 + 94.39 TO 18.00' RT. STA. 80 + 35.95


20.00' LT. STA. 79 + 72.89 TO 25.29' LT. STA. 81 + 69.29


MOHR & KERR ENGINEERING & LAND SURVEYING, P.C. 5901 N. Prospect Road, Suite 6B Office: (309) 692-8500 Professional Design Firm #184.005091


CHECKED WFS REVISED DATE 02-19-20 REVISED

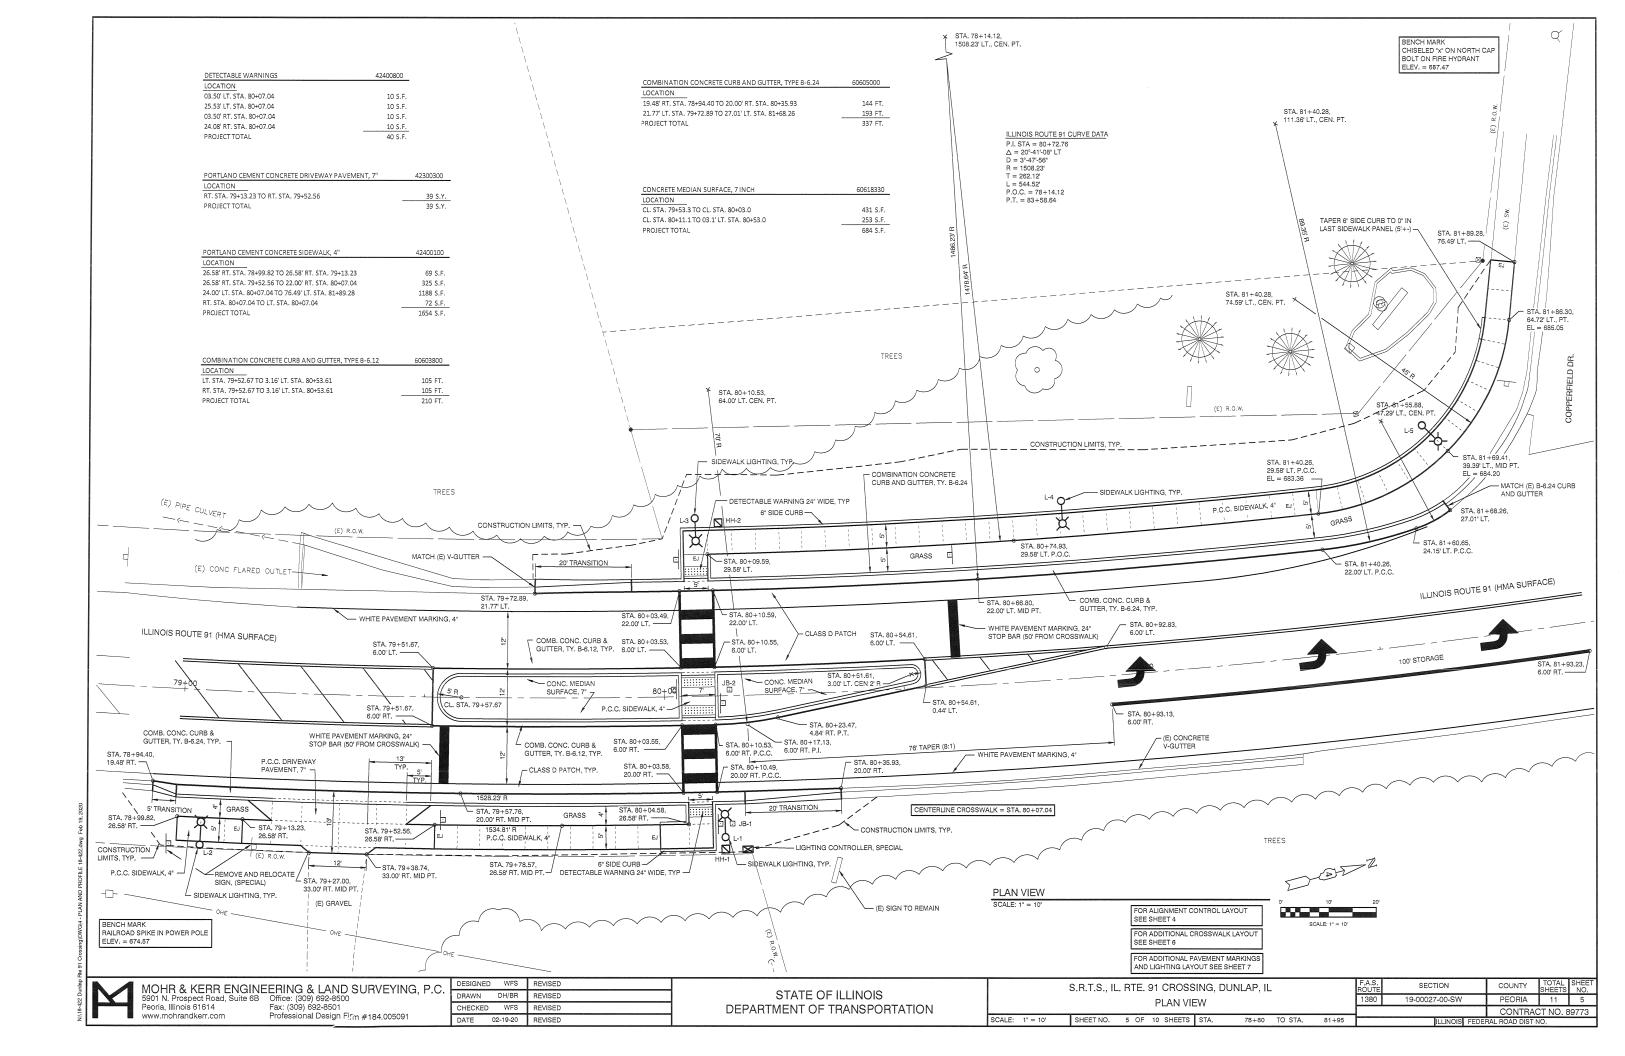


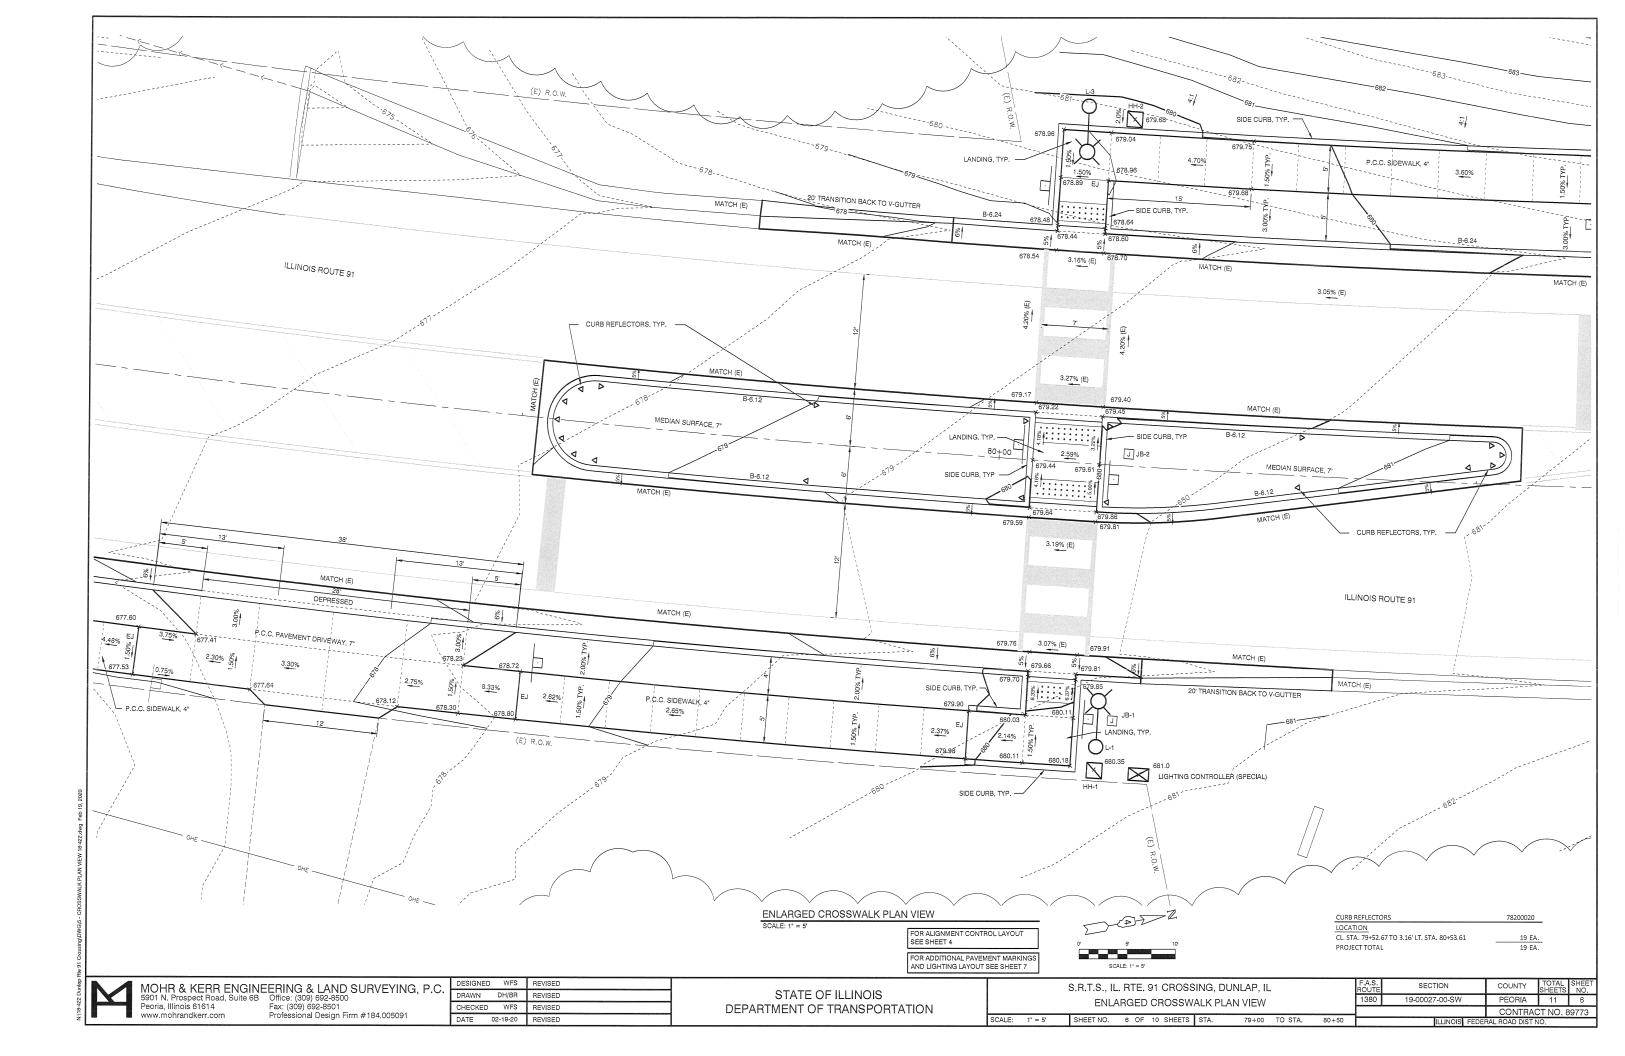


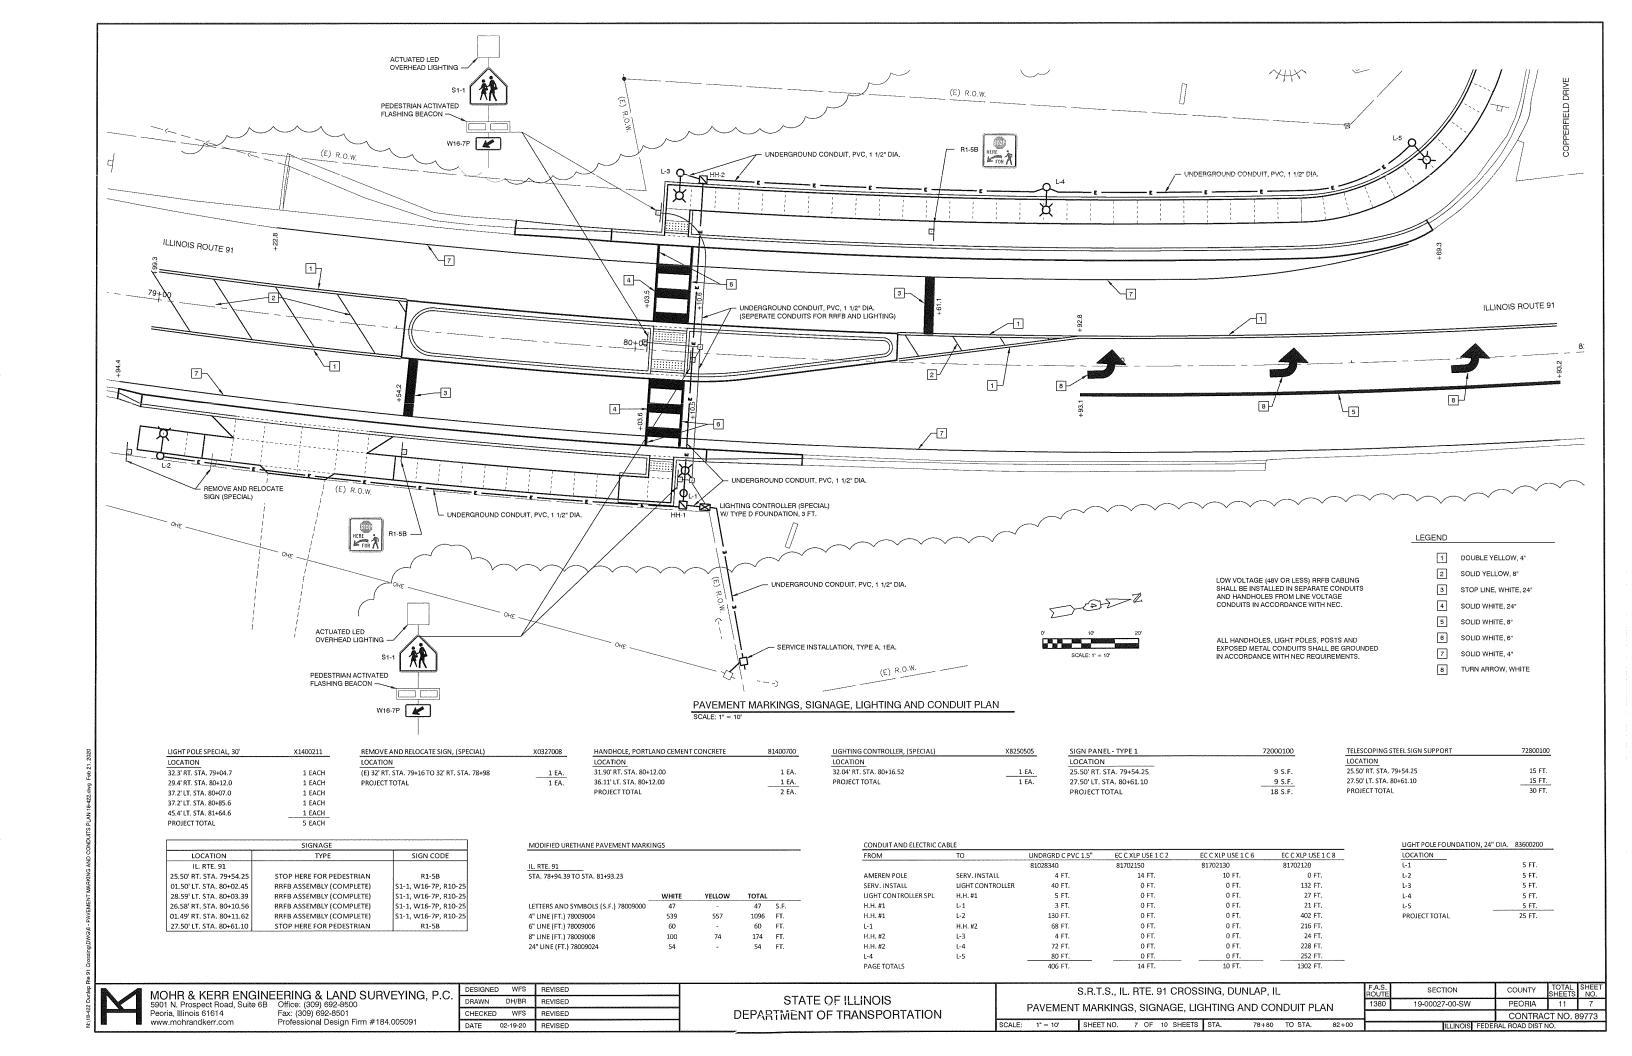

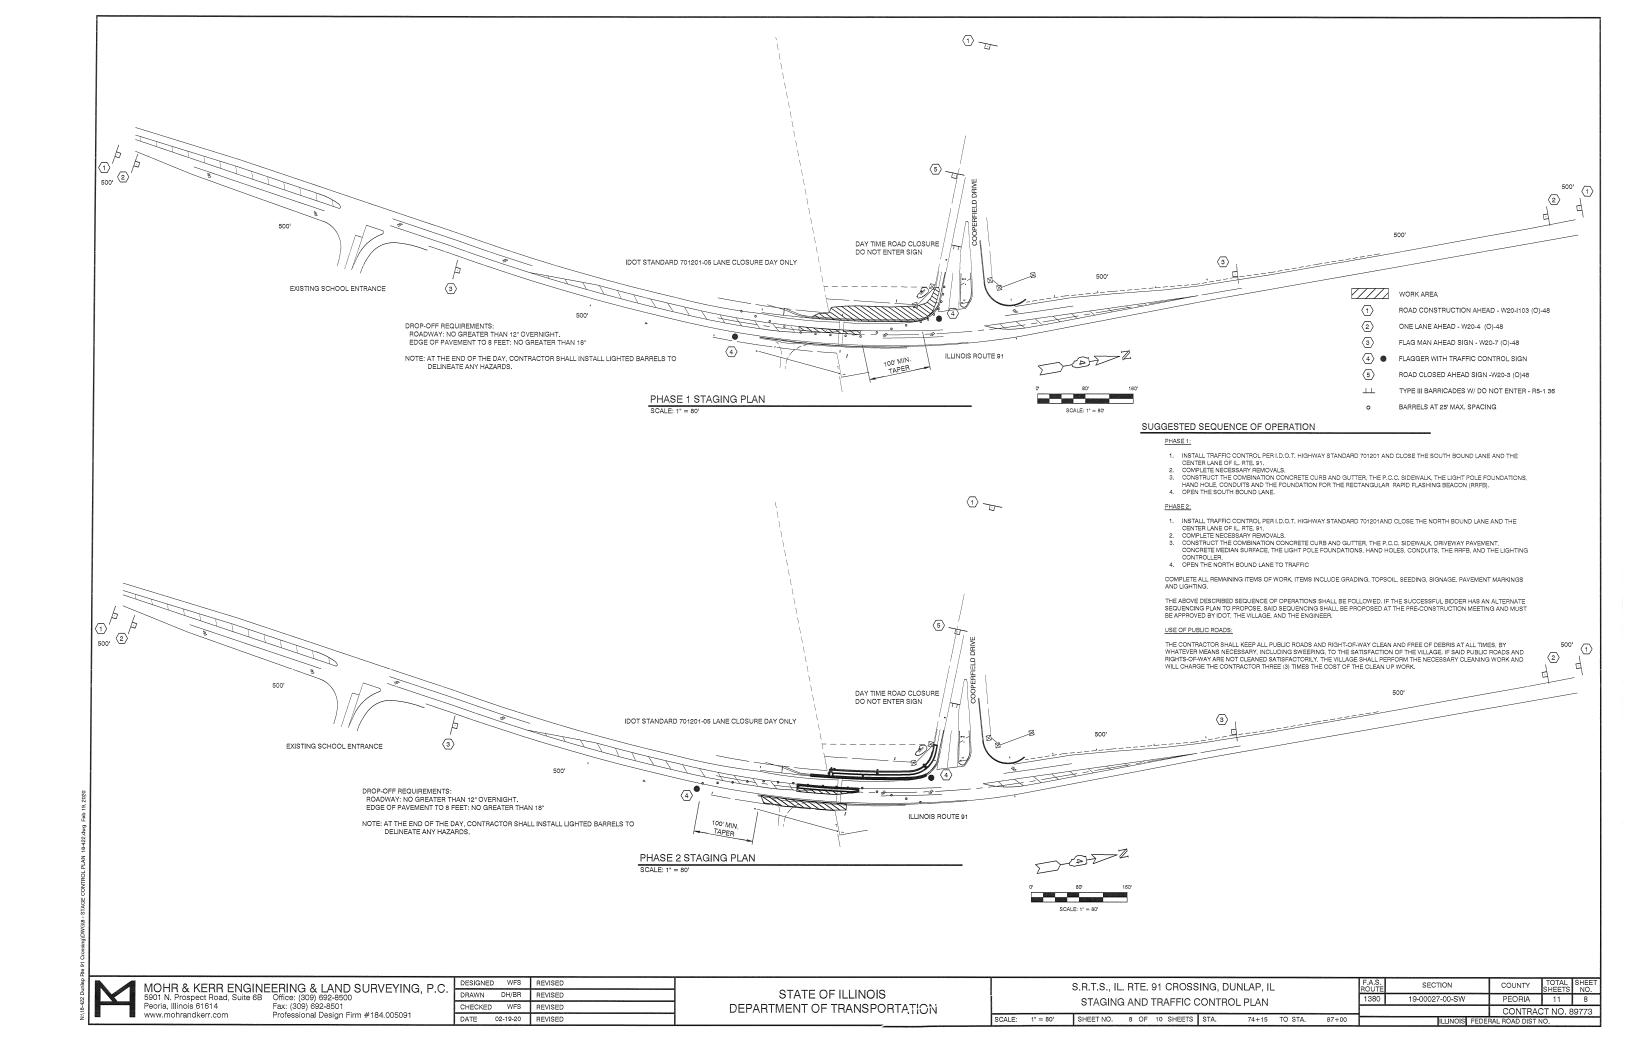

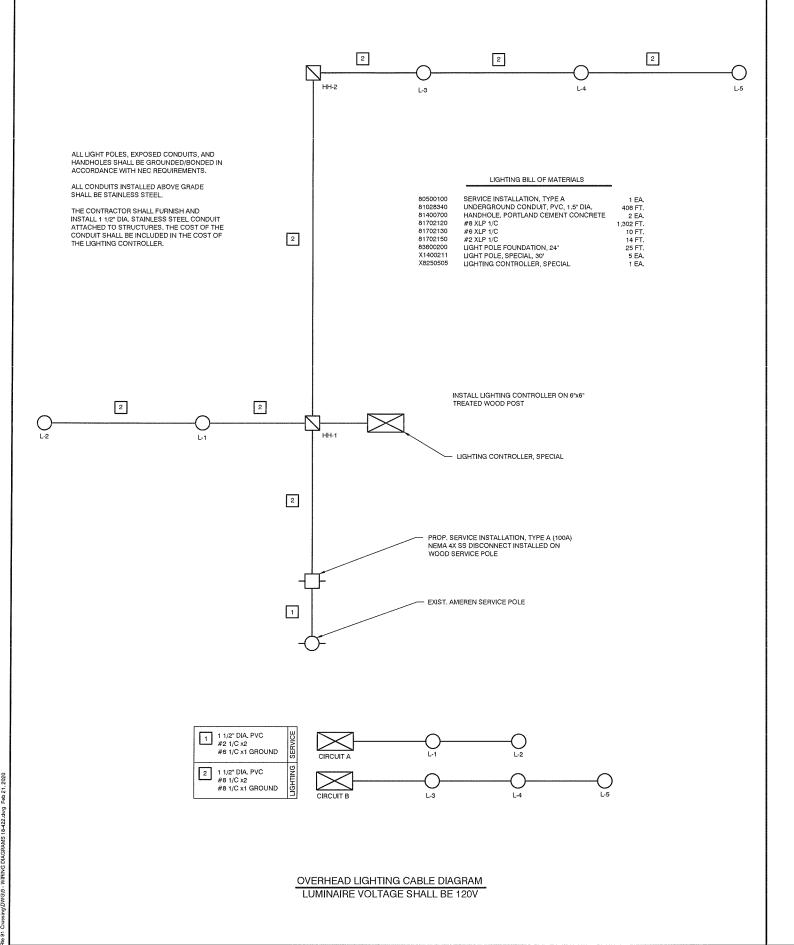

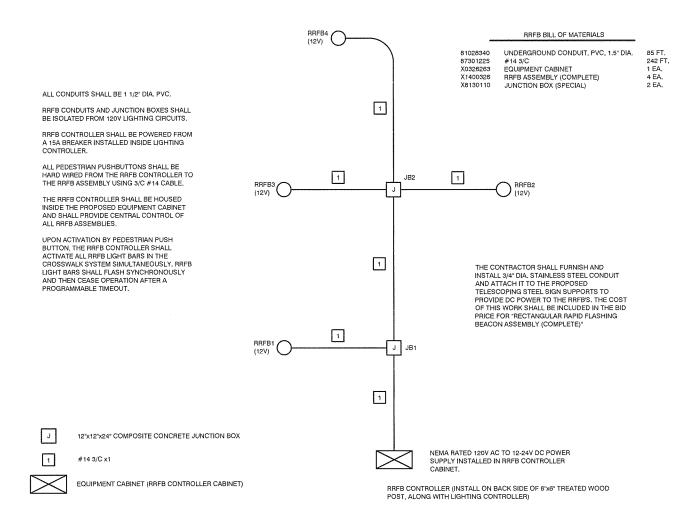

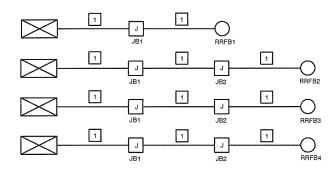

RRFB CABLE DIAGRAM RRFB OPERATING VOLTAGE SHALL BE 12-24V DC (NOT TO EXCEED 48V PER NEC)

MOHR & KERR ENGINEERING & LAND SURVEYING, P.C. 5901 N. Prospect Road, Suite 6B Office: (309) 692-8500 Peoria Illinois 61614

Professional Design Firm #184.005091

١.	DESIGNED	WFS	REVISED
'	DRAWN	BWR	REVISED
	CHECKED	WFS	REVISED
	DATE	02-19-20	REVISED

STATE OF ILLINOIS


S.R.T.S., IL. RTE. 91 CROSSING, DUNLAP, IL CABLE DIAGRAMS SHEET NO. 9 OF 10 SHEETS STA. TO STA.

SCALE: N.T.S.

F.A.S. ROUTE	SECTION	COUNTY	TOTAL SHEETS	SHEE NO.	
1380	19-00027-00-SW	PEORIA	11	9	
CONTRACT NO. 89773					
III INOIC FEDERAL BOAR DICT NO					

Fax: (309) 692-8501 www.mohrandkerr.com

DEPARTMENT OF TRANSPORTATION

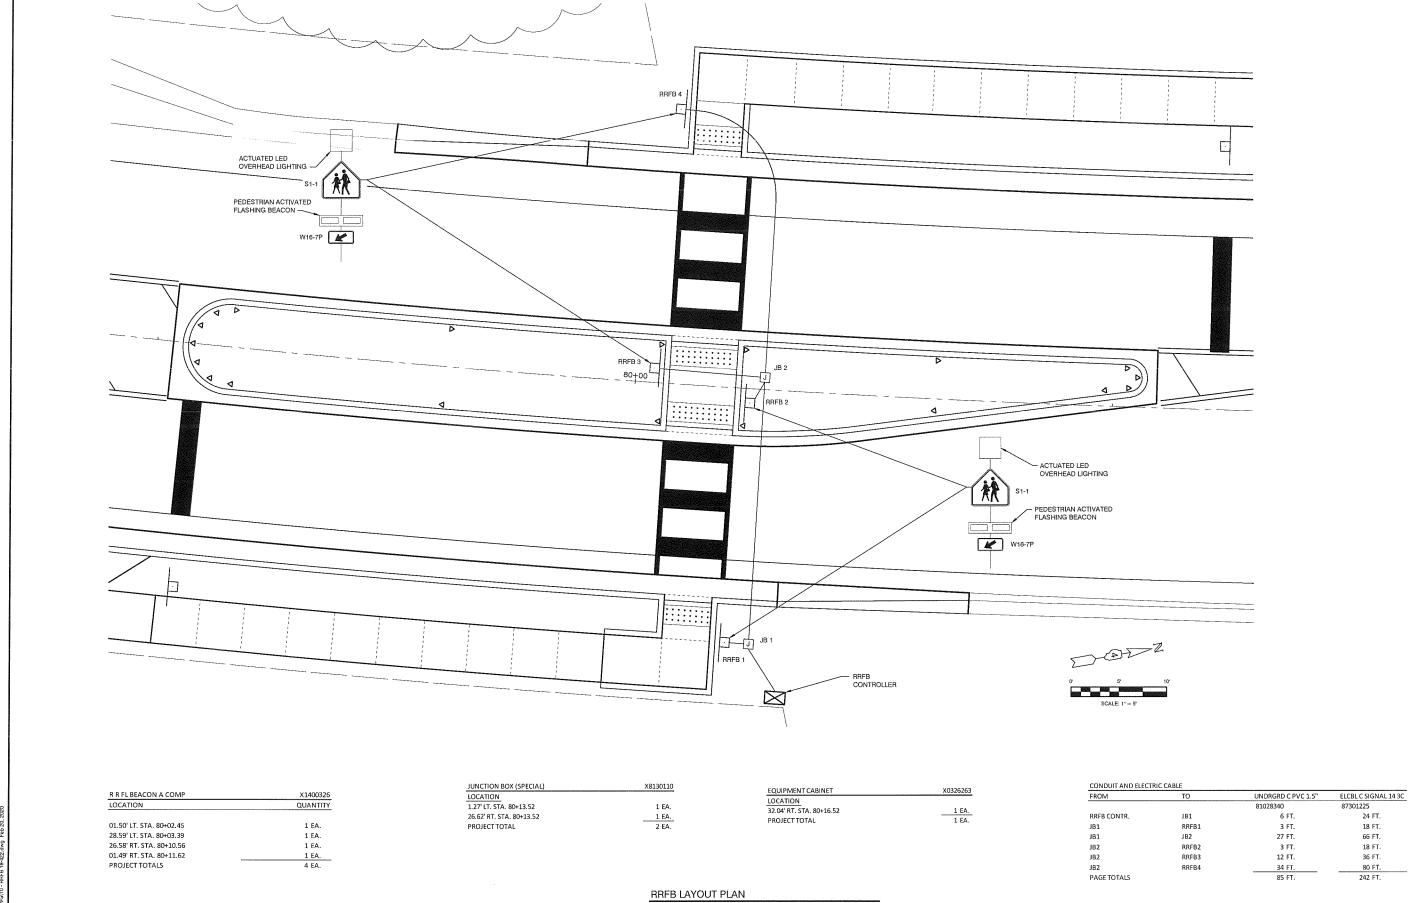

MOHR & KERR ENGINEERING & LAND SURVEYING, P.C. 5901 N. Prospect Road, Suite 6B Peoria, Illinois 61614 Fax: (309) 692-8501 Fax: (309) 692-8501 Professional Design Firm #184.005091

 DESIGNED
 WFS
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 BWR
 REVISED


 CHECKED
 WFS
 REVISED


 DATE
 02-19-20
 REVISED

STATE OF ILLINOIS DEPARTMENT OF TRANSPORTATION S.R.T.S., IL. RTE. 91 CROSSING, DUNLAP, IL

RRFB LAYOUT PLAN

SCALE: 1" = 5" SHEET NO. 10 OF 10 SHEETS STA. 79+55 TO STA. 80+50

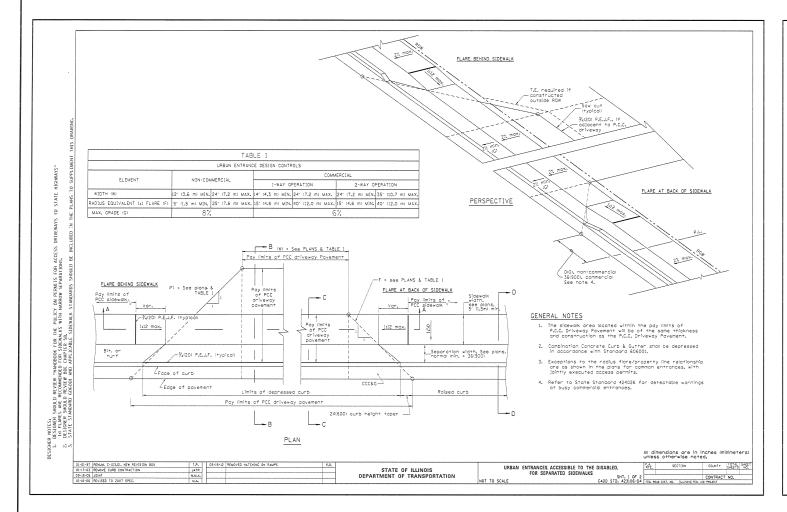

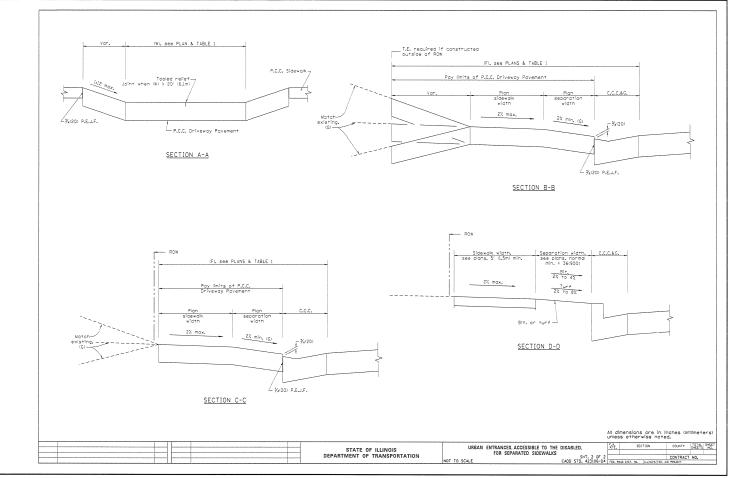

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Peoria, Illinois 61614
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Professional Design Firm #184.005091

DESIGNED WFS REVISED

DRAWN REVISED

CHECKED WFS REVISED

DATE 02-19-20 REVISED

STATE OF ILLINOIS

DEPARTMENT OF TRANSPORTATION

SCALE: 1" = 20' SHEET NO. 8 OF 10 SHEET

S.R.T.S., IL. RTE. 91 CROSSING, DUNLAP, IL
URBAN ENTRANCES, ACCESSIBLE TO THE
DISABLED, FOR SEPARATED SIDEWALKS

SCALE: 1" = 20' SHEET NO. 8 0F 10 SHEETS STA. 25+00 TO STA. 30+50

| S.R.T.S., IL. RTE. 91 CROSSING, DUNLAP, IL
ROUTE | SECTION | COUNTY | TOTAL | SHEETS | NO. |
| 1380 | 19-00027-00-SW | PECRIA | 11 | 11 |
| CONTRACT NO. 89773