04-25-2025 LETTING ITEM 049

FOR INDEX OF SHEETS, SEE SHEET NO. 2

IMPROVEMENTS ARE LOCATED IN

IL 120 (BELVIDERE ROAD) AND

ADT = 33,400 VPD (2023) WEST OF I-94 ADT = 30,700 VPD (2023) EAST OF I-94

**US 41 (SKOKIE HIGHWAY): OTHER PRINCIPAL ARTERIAL** 

STA 100+30.00

VILLAGE OF GURNEE

**DESIGN DESIGNATION** 

 $\overline{ADT} = 30,500 \text{ VPD } (2023)$ 

US 41 (SKOKIE HWY): 45 MPH IL 120 (BELVIDERE RD): 55 MPH

ENGINEERING SCALES, REDUCED SIZED PLANS WILL NOT CONFORM TO STANDARD SCALES. IN MAKING MEASUREMENTS ON REDUCED PLANS, THE ABOVE SCALES MAY BE USED.

JOINT UTILITY LOCATION INFORMATION FOR EXCAVATION

PROJECT ENGINEER: RODRIGO LEDEZMA (847) 705-4580

TRAFFIC DATA

**POSTED SPEED** 

**US 41** 

**IL 120** 

 $\circ$ 

# STATE OF ILLINOIS **DEPARTMENT OF TRANSPORTATION**

#### VAR (125X-HB(1&2)R-1) B 24 LAKE ILLINOIS CONTRACT NO. 62X39

D-91-024-25

# **PROPOSED HIGHWAY PLANS**

**FAP ROUTE 0346 AND 0333 (US 41 AND IL 120)** US 41 NB AT IL 132 (GRAND AVE) IL 120 EB AT I-94 (TRI-STATE TOLLWAY) SECTION: (125X-HB(1&2)R-1) B 24 **BRIDGE APPROACH OVERLAY** 

C-91-026-25

**LAKE COUNTY** 


PROJECT LOCATION: **US 41 (SKOKIE HIGHWAY)** STA 301+01.80


SN 049-0209

Michael Baker

INTERNATIONAL

200 W Adams Street, Suite 1800, Chicago, IL 60606 Phone: (312) 707-8770 · MBAKERINTL.COM

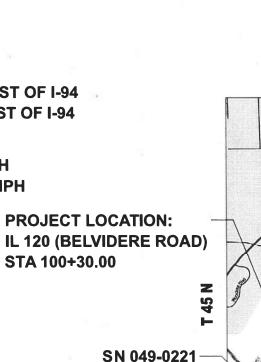

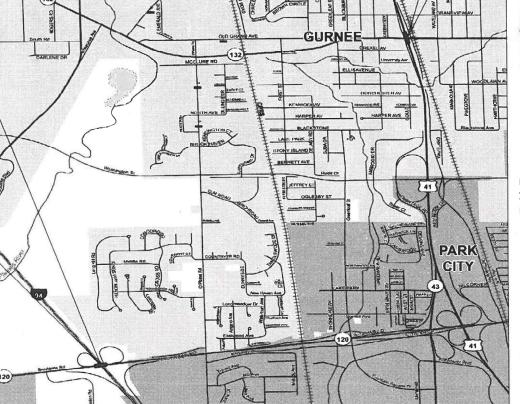



LICENSE EXPIRES 11-30-2025 **ZACHARY TANNER MICHAEL BAKER INTERNATIONAL** 

STATE OF ILLINOIS

LOCATION OF SECTION INDICATED THUS: -

PRINTED BY THE AUTHORITY OF THE STATE OF ILLINOIS

GROSS LENGTH = 70 FT. = 0.013 MILE, IL 120 (BELVIDERE RD)

**WARREN TOWNSHIP** 

= 56 FT. = 0.011 MILE, US 41 (SKOKIE HWY)

TOTAL LENGTH = 126 FT. = 0.024 MILE

LOCATION MAP NOT TO SCALE

**CONTRACT NO. 62X39** 

**REV-SEP** 

DATE: 01-17-2025

SHEETS 1 to 9

PROJECT MANAGER: J. ALAIN MIDY (847) 221-3056

0

1-800-892-0123

#### **INDEX OF SHEETS**

IEET NO.	SHEET TITLE
1	COVER SHEET
2	INDEX OF SHEETS, HIGHWAY STANDARDS AND GENERAL NOTES
3 - 4	SUMMARY OF QUANTITIES
5	TYPICAL SECTIONS
6 - 7	ROADWAY AND PAVEMENT MARKING PLAN
8 - 9	ROADWAY DETAILS
10	TYPICAL APPLICATIONS RAISED REFLECTIVE PAVEMENT MARKERS (SNOW PLOW RESISTANT) (TC-11)
11	DISTRICT ONE TYPICAL PAVEMENT MARKINGS (TC-13)
12	TRAFFIC CONTROL CLOSURE FOR FREEWAY SHOULDER CLOSURES AND PARTIAL RAMP CLOSURE (TC-17)
13	ARTERIAL ROAD INFORMATION SIGN (TC-22)

#### **HIGHWAY STANDARDS**

STD. NO.	DESCRIPTION
000001-08	STANDARD SYMBOLS, ABBREVIATIONS AND PATTERNS
001006	DECIMAL OF AN INCHAND OF A FOOT
630001-13	STEEL PLATE BEAM GUARDRAIL
631031-18	TRAFFIC BARRIER TERMINAL, TYPE 6
642001-03	SHOULDER RUMBLE STRIPS, 16 IN.
701101-05	OFF-RD OPERATIONS, MULTILANE, 15' TO 24" FROM PAVEMENT EDGE
701411-09	LANE CLOSURE, MULTILANE, AT ENTRANCE OR EXIT RAMP >= 45 MPH
701421-08	LANE CLOSURE, MULTILANE, DAY OPERATIONS ONLY, >= 45 TO 55 MPH
701426-09	LANE CLOSURE, MULTILANE, INTERMITTENT OR MOVING OPER. >= 45 MPH
701901-10	TRAFFIC CONTROL DEVICES
780001-05	TYPICAL PAVEMENT MARKINGS
781001-04	TYPICAL APPLICATIONS RAISED REFLECTIVE PAVEMENT MARKERS

#### **GENERAL NOTES**

- THE CONTRACTOR WILL NOT BE ALLOWED TO SET UP A YARD OR FIELD OFFICE ON STATE PROPERTY WITHOUT WRITTEN PERMISSION FROM THE DEPARTMENT.
- 2. ALL MILLED SURFACES SHALL BE A UNIFORM CROSS SLOPE PER LANE AND FREE OF RIDGES BETWEEN PASSES. ANY DEVIATIONS SHALL BE CORRECTED AT NO COST TO THE DEPARTMENT.
- 3. AFTER THE REMOVAL OF PCC SURFACE ON IL 120 EB, THE REMAINING TRANSVERSE CRACKS SHALL BE ROUTED AND FILLED AS SHOWN ON THE PLANS AND/OR AS DIRECTED BY THE ENGINEER.
- 4. DO NOT SCALE PLANS FOR CONSTRUCTION DIMENSIONS.
- IT SHALL BE THE CONTRACTOR'S RESPONSIBILITY TO VERIFY ALL EXISTING DIMENSIONS AND CONDITIONS IN THE FIELD PRIOR TO CONSTRUCTION AND ORDERING OF MATERIALS.
- 6. THE ENGINEER SHALL CONTACT BRANDY KENNEDY, AREA TRAFFIC FIELD ENGINEER, AT <u>BRANDY.KENNEDY@ILLINOIS.GOV</u> A MINIMUM OF TWO (2) WEEKS PRIOR TO THE PLACEMENT OF PERMANENT PAVEMENT MARKINGS.
- 7. THE CONTRACTOR SHALL CONTACT THE DISTRICT ONE TRAFFIC CONTROL SUPERVISOR AT KALPANA, KANNAN-HOSADURGA@ILLINOIS, GOV A MINIMUM OF 72 HOURS IN ADVANCE OF BEGINNING WORK.
- 8. WHEN THE MILLED PAVEMENT IS OPEN TO TRAFFIC THE MAXIMUM GRADE DIFFERENTIAL BETWEEN PASSES OF THE MILLING MACHINE SHALL NOT EXCEED 1.5 INCHES WHERE THE SPEED LIMIT IS 40 MPH OR LESS, AND 1 INCH WHERE THE SPEED LIMIT IS GREATER THAN 40 MPH. WITH WRITTEN APPROVAL OF THE ENGINEER, A MAXIMUM GRADE DIFFERENTIAL OF 3 INCHES MAY BE ALLOWED IF THE EDGE OF THE MILLING IS SLOPED A MINIMUM 1:3 (V:H).
- 9. ALL SHORT-TERM PAVEMENT MARKINGS ON FINAL SURFACES SHALL BE TYPE IV
- 10. ANY DAMAGE TO EXISTING PAVEMENT MARKINGS OR REFLECTIVE PAVEMENT MARKERS OUTSIDE THE REMOVAL LINES SHOWN ON THE PLANS SHALL BE REPLACED AT NO ADDITIONAL COST TO THE DEPARTMENT.
- 11. BEFORE BEGINNING ANY WORK, THE CONTRACTOR SHALL RETAIN AND RECORD FOR REFERENCE ALL EXISTING PAVEMENT MARKING LINES AND REFLECTIVE PAVEMENT MARKERS IN ORDER THAT THESE LOCATIONS CAN BE RE-ESTABLISHED FOR STRIPING. EXACT LOCATIONS OF ALL PAVEMENT MARKINGS SHALL BE AS DIRECTED BY THE ENGINEER.

	USER NAME =	DESIGNED	-	CEL	REVISED -
		DRAWN	-	WJT	REVISED -
06		CHECKED	-	ZJT	REVISED -
00	PLOT DATE = 3/5/2025	DATE	-	11/5/2024	REVISED -

				CONSTRUCTION CODE						
				IL 120	U.S. 41					
_				100% STATE	100% STATE					
2005			TOTAL	ROADWAY	ROADWAY					
CODE NO.	ITEM	UNIT	TOTAL QUANTITY	0005	0005					
140.	IILIW	- OIGH	QUARTITI							
40600290	BITUMINOUS MATERIALS (TACK COAT)	POUND	262	141	121					
40600370	LONGITUDINAL JOINT SEALANT	FOOT	373	208	165					
	POLYMERIZED HOT-MIX ASPHALT SURFACE COURSE, STONE									
40605026	MATRIX ASPHALT, 9.5, MIX "F", N80	TON	84	44	40					
44900105	REMOVAL AND REPLACEMENT OF PREFORMED ELASTOMERIC	FOOT	92	45	47					
	JOINT SEALS FOR PAVEMENT									
45200100	JOINT OR CRACK ROUTING (PC CONCRETE PAVEMENT AND SHOULDER)	FOOT	52	52						
45200300	JOINT OR CRACK FILLING	POUND	20	20						
63300575	REMOVE AND REERECT RAIL ELEMENT OF EXISTING GUARDRAIL	FOOT	200	200						
64200116	SHOULDER RUMBLE STRIPS, 16 INCH	FOOT	109		109					
07100100	MORILIZATION	1.01114	1	0.5	2.5					
67100100	MOBILIZATION	LSUM	1	0.5	0.5					
70100310	TRAFFIC CONTROL AND PROTECTION, STANDARD 701421	LSUM	1	0.5	0.5					
70100420	TRAFFIC CONTROL AND PROTECTION, STANDARD 701411	EACH	1	1						
70300100	SHORT TERM PAVEMENT MARKING	FOOT	144	72	72					
70300150	SHORT TERM PAVEMENT MARKING REMOVAL	SQ FT	48	24	24					
72400200	REMOVE SIGN PANEL ASSEMBLY - TYPE B	EACH	3	1	2					
78000200	THERMOPLASTIC PAVEMENT MARKING - LINE 4"	FOOT	282	159	123					

\* SPECIALTY ITEM

Michael Baker

INTERNATIONAL

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Phone: (312) 707-8770 MBAKERINTL.COM

	user NAME = Zach.Tanner	DESIGNED	-	CEL	REVISED -	Γ
		DRAWN	-	WJT	REVISED -	
0606		CHECKED	-	ZJT	REVISED -	
	PLOT DATE = 11/19/2024	DATE	-	11/5/2024	REVISED -	

STATE OF ILLINOIS DEPARTMENT OF TRANSPORTATION

 SUMMARY OF QUANTITIES

 US 41 NB AT IL 132 (GRAND AVE) AND IL 120 EB AT I-94

 SCALE: N.T.S.
 SHEET 1
 OF 2 SHEETS STA. TO STA.

A.P. SECTION COUNTY TOTAL SHEET NO. (125X-HB(1&2)R-1)B24 LAKE 13 3

CONTRACT NO. 62X39

| ILLINOIS | FED. AID PROJECT

				IL 120 100% STATE	U.S. 41 100% STATE		
				ROADWAY	ROADWAY		
CODE			TOTAL	0005	0005		
NO.	ITEM	UNIT	QUANTITY				
78100100	RAISED REFLECTIVE PAVEMENT MARKER	EACH	2	1	1		
78300200	RAISED REFLECTIVE PAVEMENT MARKER REMOVAL	EACH	2	1	1		
Z0013798	CONSTRUCTION LAYOUT	LSUM	1	0.5	0.5		
X7200061	TEMPORARY INFORMATION SIGNING	SQ FT	50	25	25		
X4400100	PORTLAND CEMENT CONCRETE SURFACE REMOVAL (VARIABLE DEPTH)	SQ YD	665	352	313		
X6700407	ENGINEER'S FIELD OFFICE, TYPE A (D1)	CAL MO	6	3	3		
			<u> </u>				

\* SPECIALTY ITEM

Michael Baker

N T E R N A T I O N A L

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Phone: (312) 707-8770- MBAKERINTL.COM


STATE OF ILLINOIS
DEPARTMENT OF TRANSPORTATION

CONSTRUCTION CODE

SUMMARY OF QUANTITIES
US 41 NB AT IL 132 (GRAND AVE) AND IL 120 EB AT I-94

SCALE: N.T.S. SHEET 2 OF 2 SHEETS STA. TO STA.

IL 120 (EB) STA. 100+30.0 TO STA. 101+00.2

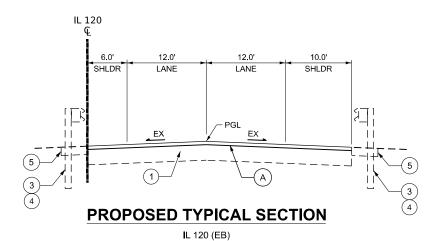

STA. 100+30.0 TO STA. 101+00.2


#### **EXISTING LEGEND**

- 1 EXIST. P.C. CONCRETE PAVEMENT, 10"
- 2 P.C. CONCRETE SURFACE REMOVAL, VAR. DEPTH
- (3) EXIST. S.P.B. GUARDRAIL OR BARRIER TERMINAL
- 4 REMOVE & RE-ERECT GUARDRAIL OR BARRIER TERMINAL
- (5) EXIST. P.C. CONCRETE SHOULDER 6"
- (6) EXIST. CONCRETE BARRIER

REMOVAL


#### **PROPOSED LEGEND**

A POLY. HMA SURFACE CSE, SMA, 9.5 MIX "F" N80 (VAR. DEPTH; MIN. 1.75")

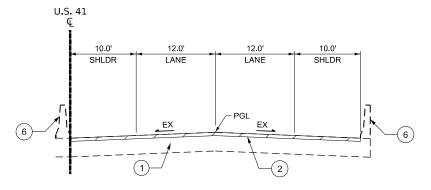

# **EXISTING TYPICAL SECTION**

U.S. 41 (NB) STA. 300+81.0 TO STA. 301+36.5

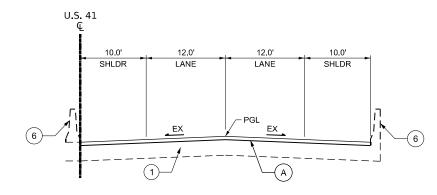

# PROPOSED TYPICAL SECTION

U.S. 41 (NB) STA. 300+81.0 TO STA. 301+36.5

HOT-MIX ASPHALT MIXTURE REQUIREMENTS							
MIXTURE TYPE	AIR VOIDS @ Ndes	QMP					
PAVEMENT RESURFACING							
POLY. HOT-MIX ASPHALT SURFACE COURSE, SMA, 9.5, MIX "F", N80	3.5% @ 80 GYR.	QC/QA					
QMP DESIGNATION: QUALITY CONTROL/QUALITY ASSURANCE (QC/QA)		•					

#### NOTES:

SCALE: N.T.S.


- 1. THE UNIT WEIGHT USED TO CALCULATE ALL HOT-MIX ASPHALT SURFACE MIXTURE QUANITITES IS 112 LBS/SQ YD/IN.
- THE AC TYPE FOR POLYMERIZED HMA MIXES SHALL BE "SBS/SBR PG 76-22" AND FOR NON-POLYMERIZED HMA THE "AC TYPE" SHALL BE "PG 64-22" UNLESS MODIFIED BY RECLAIMED MATERIALS SPECIFICATIONS.
- 3. LONGITUDINAL JOINT SEALANT SHALL BE PLACED UNDER THE POLY. HMA SC, SMA 9.5 MIX "F" N80.


Michael Baker				
MICHAEL DAKE				
INTERNATIONAL				
200 West Adams Street, Suite 1800, Chicago, IL 60606				
Dhone, (212) 707 9770 - MDAKEDINTI COM				

USER NAME = Jaime.Rivera	DESIGNED -	CEL	REVISED -
	DRAWN -	WJT	REVISED -
	CHECKED -	ZJT	REVISED -
PLOT DATE = 11/13/2024	DATE -	11/5/2024	REVISED -


STATE OF ILLINOIS
<b>DEPARTMENT OF TRANSPORTATION</b>


					F.A.P. RTE	SECTION	N		COUNTY	TOTAL SHEETS	SHEET NO.		
119 41	US 41 NB AT IL 132 (GRAND AVE) AND IL 120 EB AT I-94						(125X-HB(1&2)	R-1)B24		LAKE	13	5	
00 71	US 41 ND AT IL 132 (GRAND AVL) AND IL 120 ED AT 1-34									CONTRAC	T NO. 62	<b>K</b> 39	
I.T.S.	SHEET 1	OF 1	SHEETS	STA.	TO STA.		ILLI	INOIS F	ED. AID	PROJECT			

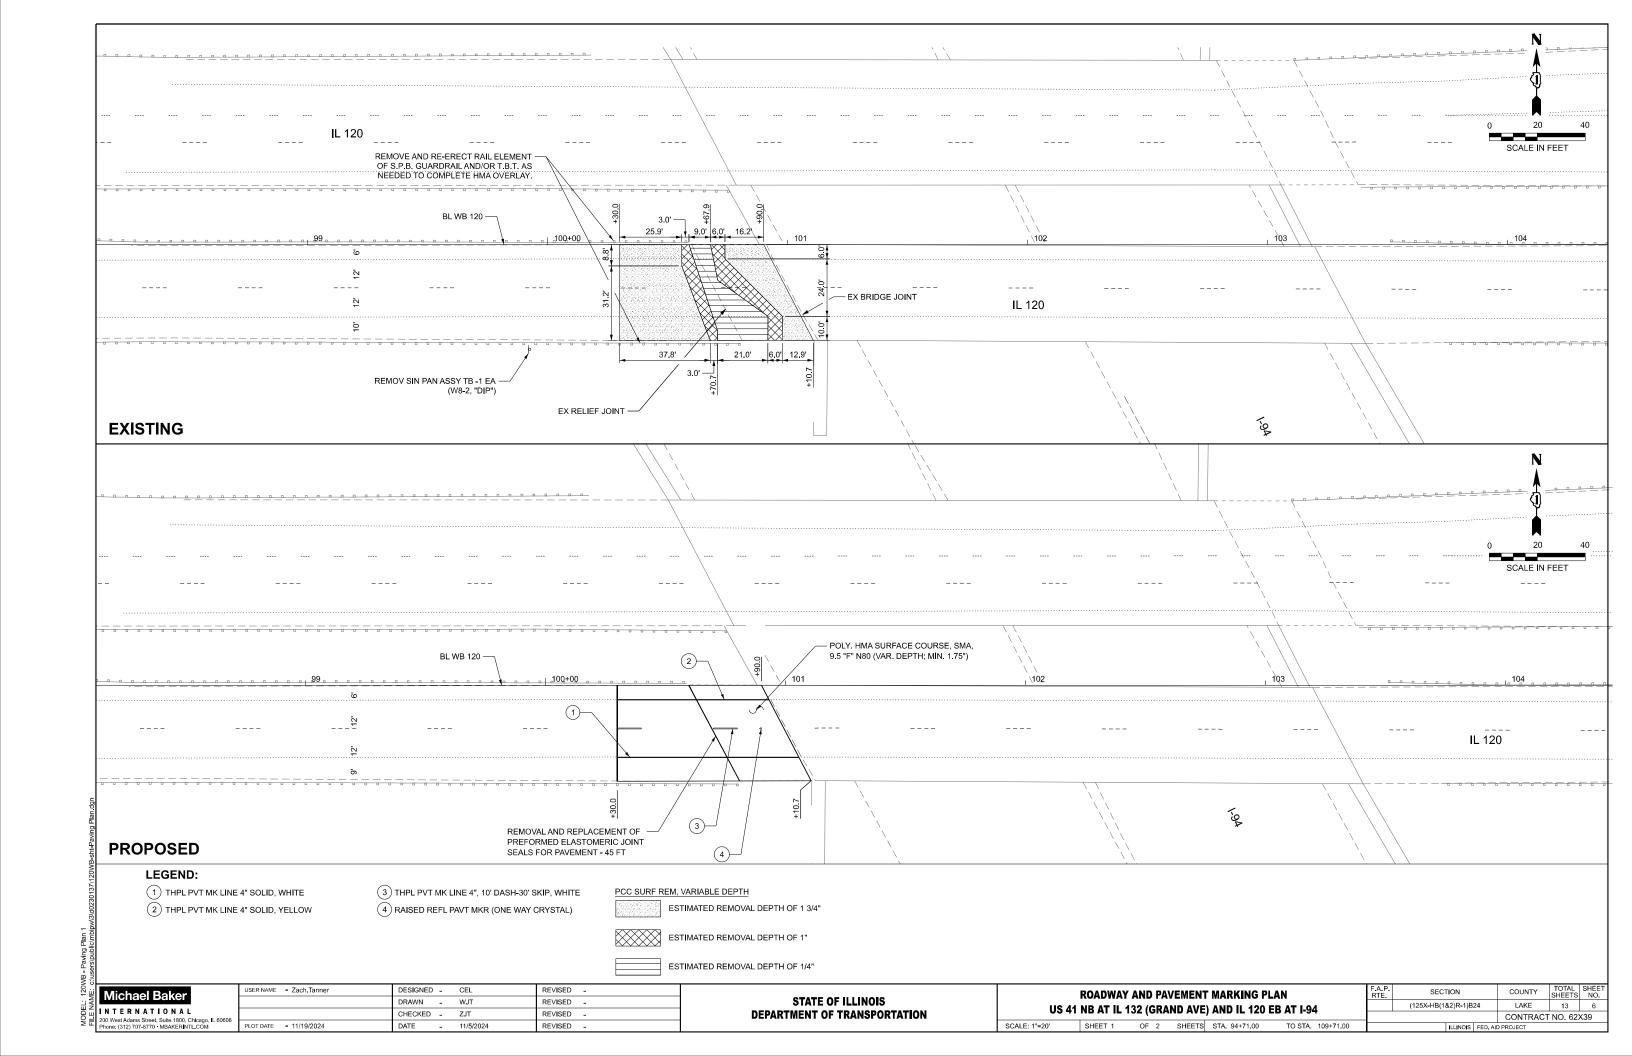

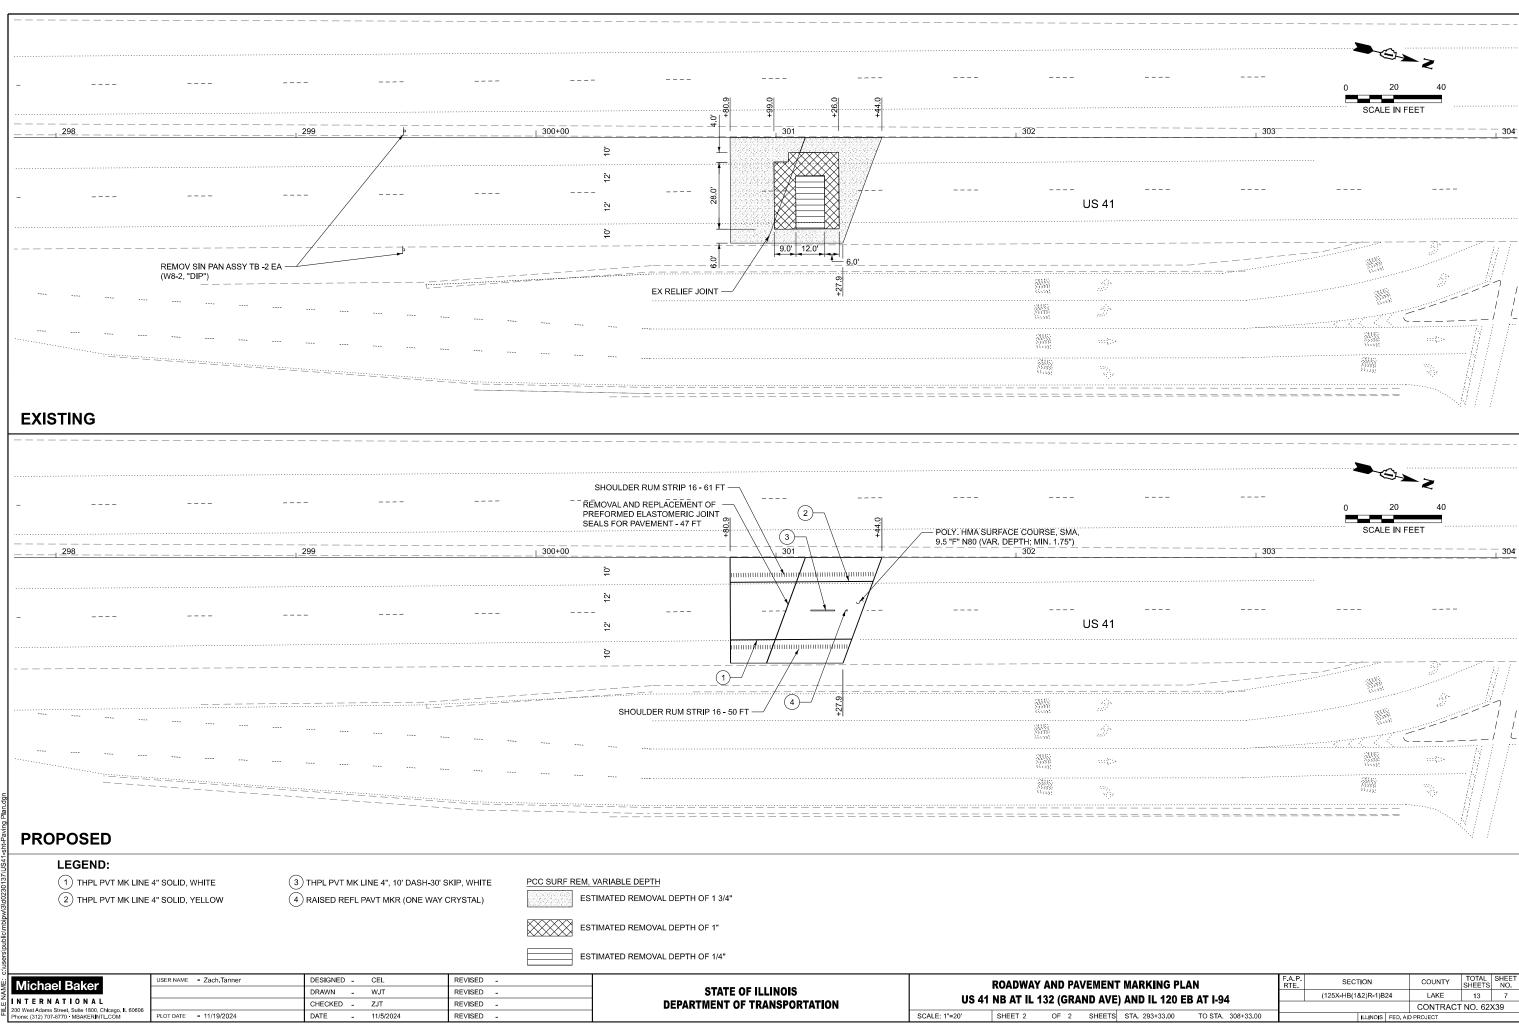

IEL: ExBL1 - Paving Plan 2

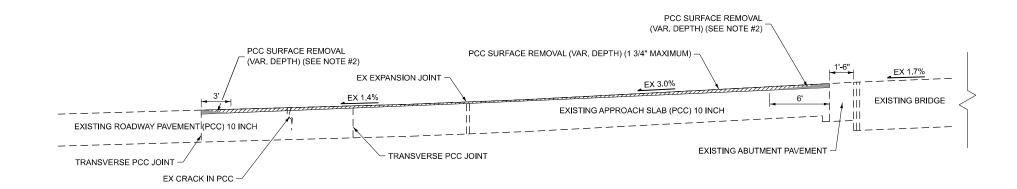

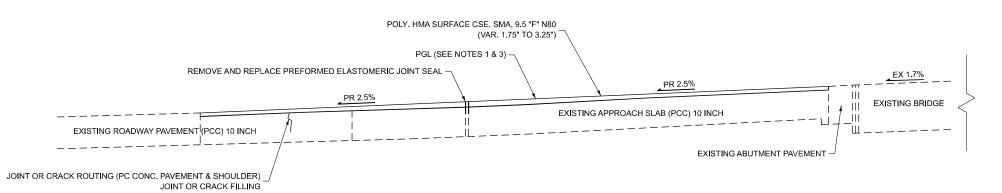

# **HMA OVERLAY DETAIL**

IL 120 (EB) STA, 100+30,0 TO STA, 101+00,2

#### NOTES

- 1. EXISTING AND PROPOSED GRADE LABELS ARE TAKEN ALONG PGL AND WILL VARY BY OFFSET.
- 2. PCC SURFACE IN SHADED AREA ( ) SHALL BE REMOVED ON THE SAME DAY AS PLACEMENT OF PROPOSED HMA COURSES.
- IT IS ASSUMED THAT THE PROPOSED HMA
   OVERLAY WILL HAVE A STRAIGHT-LINE PROFILE
   BETWEEN THE REMOVAL LIMITS AS SHOWN IN
   THESE DETAILS.


Michael Baker	L				
MICHAEL BAKEL					
INTERNATIONAL	Г				
200 West Adams Street, Suite 1800, Chicago, IL 60606 Phone: (312) 707-8770 - MRAKERINTI, COM	F				


USER NAME = Jaime.Rivera	DESIGNED -	CEL	REVISED -
	DRAWN -	WJT	REVISED -
	CHECKED -	ZJT	REVISED -
PLOT DATE = 11/13/2024	DATE -	11/5/2024	REVISED -

STATE OF ILLINOIS
DEPARTMENT OF TRANSPORTATION

SCALE: N.T.S.

	ROADWAY DETAILS						SECT	TION		COUNTY	TOTAL SHEETS	SHEET NO.
18 41	NR AT II 1	32 (GRA	ND AVE	ANDI	I 120 FR AT LQ4		(125X-HB(1	(125X-HB(1&2)R-1)B24		LAKE	13	8
75	6 41 NB AT IL 132 (GRAND AVE) AND IL 120 EB AT I-94									CONTRAC	ΓNO. 62	(39
	SHEET 1	OF 2	SHEETS	STA.	TO STA.			ILLINOIS	FED. AII	PROJECT		

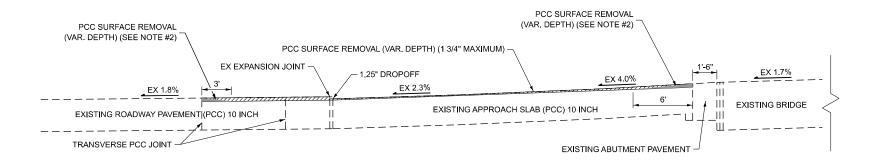

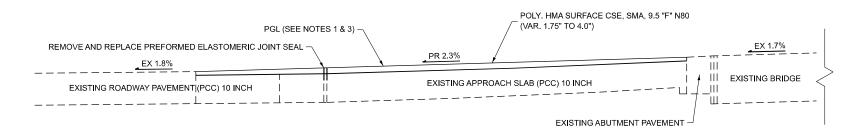

# **HMA OVERLAY DETAIL**

U.S. 41 (NB) STA, 300+81,0 TO STA, 301+36,5

#### NOTES

- 1. EXISTING AND PROPOSED GRADE LABELS ARE TAKEN ALONG PGL AND WILL VARY BY OFFSET.
- 2. PCC SURFACE IN SHADED AREA ( ) SHALL BE REMOVED ON THE SAME DAY AS PLACEMENT OF PROPOSED HMA COURSES.
- IT IS ASSUMED THAT THE PROPOSED HMA
   OVERLAY WILL HAVE A STRAIGHT-LINE PROFILE
   BETWEEN THE REMOVAL LIMITS AS SHOWN IN
   THESE DETAILS.


Michael Baker	ŀ
INTERNATIONAL 200 West Adams Street, Suite 1800, Chicago, IL 60606 Phone: (312) 707-8770 · MBAKERINTL COM	ŀ

USER NAME = Jaime.Rivera	DESIGNED -	CEL	REVISED -
	DRAWN -	WJT	REVISED -
	CHECKED -	ZJT	REVISED -
PLOT DATE = 11/13/2024	DATE -	11/5/2024	REVISED -

STATE OF ILLINOIS
DEPARTMENT OF TRANSPORTATION

	ROADWAY DETAILS							F.A.P. SECTION			COUNTY	TOTAL SHEETS	SHEET NO.
ı	IIS 41	US 41 NB AT IL 132 (GRAND AVE) AND IL 120 EB AT I-94							%2)R-1)B	24	LAKE	13	9
ı		ND AL IL	132 (0117	IND AVE	, 4110 1	L IZO LB AI I-34					CONTRACT	NO. 62	X39
	SCALE: N.T.S.	SHEET 2	OF 2	SHEETS	STA.	TO STA.	ILLINOIS FED AID			PROJECT			

DDEL: RDWY DTL-2

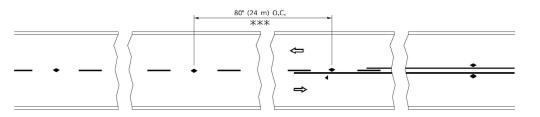


\*\*\* REDUCE TO 40' (12 m) O.C. ON CURVES WITH POSTED OR ADVISORY SPEED 45 M.P.H. (70 km/h) OR LESS.

# 

LANE REDUCTION TRANSITION

SEE FIGURE 3B-14 MUTCD

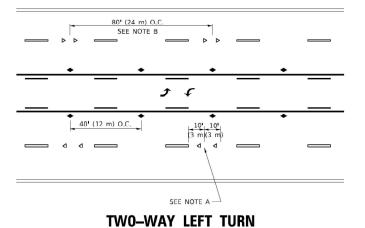

SYMBOLS

ONE-WAY AMBER MARKER


TWO-WAY AMBER MARKER


■ ONE-WAY CRYSTAL MARKER (W/O)

YELLOW STRIPE

WHITE STRIPE


#### TWO-LANE/TWO-WAY

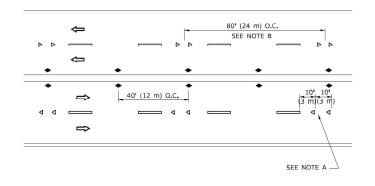


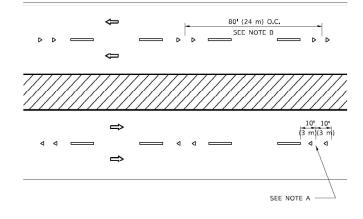

#### MULTI-LANE/UNDIVIDED



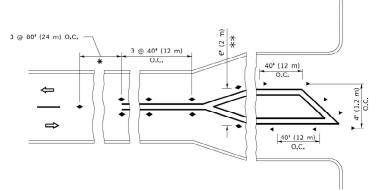

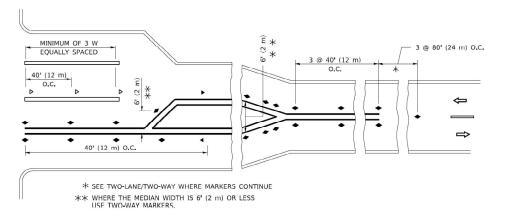

#### **TURN LANES**

#### **GENERAL NOTES**

- MARKERS USED WITH DASHED LINES SHALL BE CENTERED IN THE GAP BETWEEN SEGMENTS.
- 2. MARKERS USED ADJACENT TO SOLID LINES SHALL BE OFFSET 2 TO 3 (50 TO 75) TOWARD TRAFFIC AS SHOWN.
- MARKERS THROUGH TANGENTS LESS THAN 500' (150 m) IN LENGTH BETWEEN CURVES SHALL BE INSTALLED AT THE LESSER OF THE TWO CURVE SPACINGS.
- 4. MARKERS ARE TO BE USED ADJACENT TO BOTH SOLID WHITE LINES IN DUAL LEFT TURN LANES

# LANE MARKER NOTES

- A. USE DOUBLE LANE LINE MARKERS SPACED AS SHOWN.
- B. REDUCE TO 40' (12 m) O.C. ON CURVES WHERE ADVISORY SPEEDS ARE 10 M.P.H (20 km/h) LOWER THAN POSTED SPEEDS.


#### **DESIGN NOTES**

- 1. DOUBLE LANE LINE MARKERS SHALL BE USED UNLESS SPECIFIED OTHERWISE,
- EXCEPT AS SHOWN ON THE LANE REDUCTION TRANSITION AND FREEWAY EXIT RAMP DETAIL, MARKERS ARE NOT TO BE SPECIFIED ON RIGHT EDGE LINES.
- THE EXACT MARKER LIMITS, SPACING, AND COLOR SHALL BE INCLUDED IN THE PLANS WHEN STANDARD SPECIFICATIONS ARE NOT BEING USED.
- MARKERS SHOULD NOT BE USED ALONGSIDE CURBS EXCEPT FOR EXTREMELY SHORT SECTIONS OF CURBS WHERE NOT MORE THAN TWO MARKERS WOULD BE INVOLVED.

All dimensions are in inches (millimeters) unless otherwise shown.

ISER NAME = footem DESIGNED -REVISED - T. RAMMACHER 03-12-99 SECTION COUNTY TYPICAL APPLICATIONS DRAWN REVISED - T. RAMMACHER 01-06-00 STATE OF ILLINOIS LAKE RAISED REFLECTIVE PAVEMENT MARKERS (SNOW-PLOW RESISTANT) REVISED - C. JUCIUS 09-09-09 **DEPARTMENT OF TRANSPORTATION** CHECKED -PLOT SCALE = 50.0000 ' / In. CONTRACT NO.62X39 TC-11 PLOT DATE = 3/4/2019 REVISED -C. JUCIUS 07-01-13

JistStd.2Xx34%ADData\CADSheets\tci 1.dgn

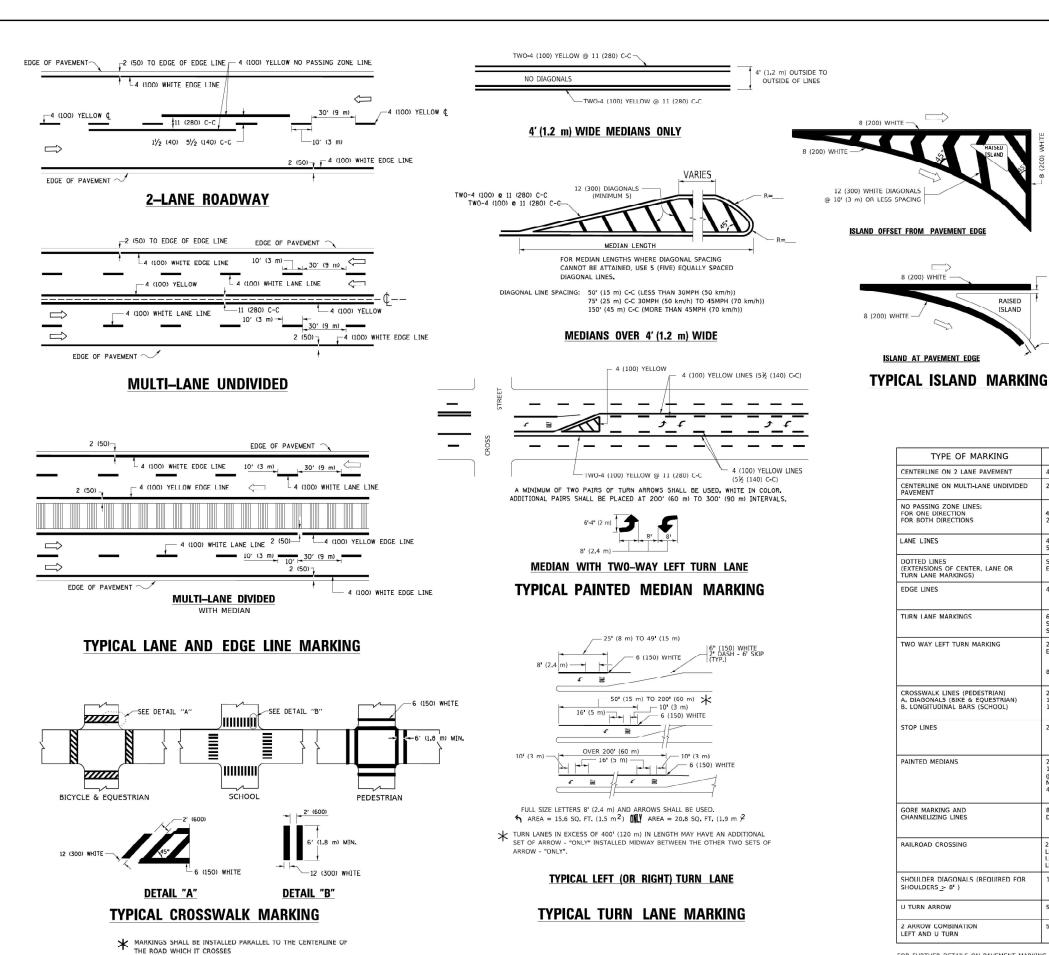

D(FT) SPEED LIMIT 345 425 665 750 55 40 (1020) 64 (1620) COMBINATION LEFT AND U-TURN — 2 (50) 5'-4" (1620) 2 (50) LANE REDUCTION TRANSITION \* LANE REDUCTION ARROWS REQUIRED AT SPEEDS OF 45 MPH OR GREATER OR WHEN SPECIFIED IN PLANS, U-TURN **PATTERN** COLOR SPACING / REMARKS SKIP-DASH YELLOW 10' (3 m) LINE WITH 30' (9 m) SPACE

TYPE OF MARKING WIDTH OF LINE CENTERLINE ON 2 LANE PAVEMENT SOLID rELLOW 2 @ 4 (100) 11 (280) C-C CENTERLINE ON MULTI-LANE UNDIVIDED PAVEMENT NO PASSING ZONE LINES: FOR ONE DIRECTION FOR BOTH DIRECTIONS 5½ (140) C-C FROM SKIP-DASH CENTERLINE 11 (280) C-C OMIT SKIP-DASH CENTERLINE BETWEEN 4 (100) 2 @ 4 (100) LANE LINES SKIP-DASH SKIP-DASH WHITE 10' (3 m) LINE WITH 30' (9 m) SPACE 4 (100) 5 (125) ON FREEWAYS DOTTED LINES (EXTENSIONS OF CENTER, LANE OR TURN LANE MARKINGS) SAME AS LINE BEING EXTENDED SKIP-DASH SAME AS LINE BEING EXTENDED 2' (600) LINE WITH 6' (1.8 m) SPACE EDGE LINES 4 (100) SOLID YELLOW-LEFT WHITE-RIGHT OUTLINE MEDIANS IN YELLOW 6 (150) LINE: FULL SIZE LETTERS & SYMBOLS (8' (2.4m)) TURN LANE MARKINGS SOLID WHITE SEE TYPICAL TURN LANE MARKING DETAIL SKIP-DASH AND SOLID IN PAIRS TWO WAY LEFT TURN MARKING YELLOW 10' (3 m) LINE WITH 30' (9 m) SPACE FOR SKIP-DASH; 5½ (140) C-C BETWEEN SOLID LINE AND SKIP-DASH LINE SEE TYPICAL TWO-WAY LEFT TURN MARKING DETAIL NOT LESS THAN 6' (1.8 m) APART 2' (600) APART 2' (600) APART SEE TYPICAL CROSSWALK MARKING DETAILS. PLACE 4\* (1.2 m) IN ADVANCE OF AND PARALLEL TO CROSSWALK, IF PRESENT. UHERWINS, PLACE AT DESINED STOPPING POINT. PARALLEL TO CROSSROAD CENTERLINE, WHERE POCECULE STOP LINES 24 (600) SOLID WHITE PAINTED MEDIANS 2 @ 4 (100) WITH 12 (300) DIAGONALS SOLID 11 (280) C-C FOR THE DOUBLE LINE TWO WAY TRAFFIC @ 45°
NO DIAGONALS USED FOR
4' (1.2 m) WIDE MEDIANS WHITE: ONE WAY TRAFFIC GORE MARKING AND 8 (200) WITH 12 (300) DIAGONALS @ 45° SOLID DIAGONALS: 15' (4.5 m) C-C (LESS THAN 30MPH (50 km/h)) 20' (6 m) C-C 30MPH (50 km/h) TO 45MPH (70 km/h)) 30' (9 m) C-C (OVER 45MPH (70 km/h)) CHANNELIZING LINES SEE STATE STANDARD 780001 24 (600) TRANSVERSE LINES; "RR" IS 6' (1.8 m) LETTERS; 16 (400) LINE FOR "X" RAILROAD CROSSING SOLID 50' (15 m) C-C (LESS THAN 30MPH (50 km/h)) 75' (25 m) C-C (30 MPH (50 km/h) TO 45MPH (70 km/h)) 150' (45 m) C-C (OVER 45MPH (70 km/h)) SHOULDER DIAGONALS (REQUIRED FOR SHOULDERS > 81) WHITE - RIGHT YELLOW - LEFT 12 (300) @ 45° SOLID U TURN ARROW SEE DETAIL SOLID WHITE 2 ARROW COMBINATION LEFT AND U TURN SEE DETAIL SOLID 30.4 SF

FOR FURTHER DETAILS ON PAVEMENT MARKING REFER TO STANDARD SPECIFICATIONS FOR ROAD AND BRIDGE CONSTRUCTION AND STATE STANDARD 780001.

SCALE: NONE

8 (200) WHITE

RAISED


ISLAND


All dimensions are in inches (millimeters) unless otherwise shown.

USER NAME = footemj	DESIGNED	-	EVERS	REVISED	-	C. JUCIUS 09-09-09
	DRAWN	-		REVISED	-	C. JUCIUS 07-01-13
PLOT SCALE = 50.0000 * / In.	CHECKED	-		REVISED	-	C. JUCIUS 12-21-15
PLOT DATE = 3/4/2019	DATE	-	03-19-90	REVISED	-	C. JUCIUS 04-12-16

**STATE OF ILLINOIS DEPARTMENT OF TRANSPORTATION** 

DISTRICT ONE TYPICAL PAVEMENT MARKINGS			F.A.P. RTE.	SECTION	COUNTY	TOTAL SHEETS	SHE				
				(125X-HB(1&2)R-1)B24	LAKE	13	11				
				TC-13	CONTRA	CT NO.62	X39				
EET	1	OF	2	SHEETS	STA	TO STA		III INOIC E	ED AID DECIECT		

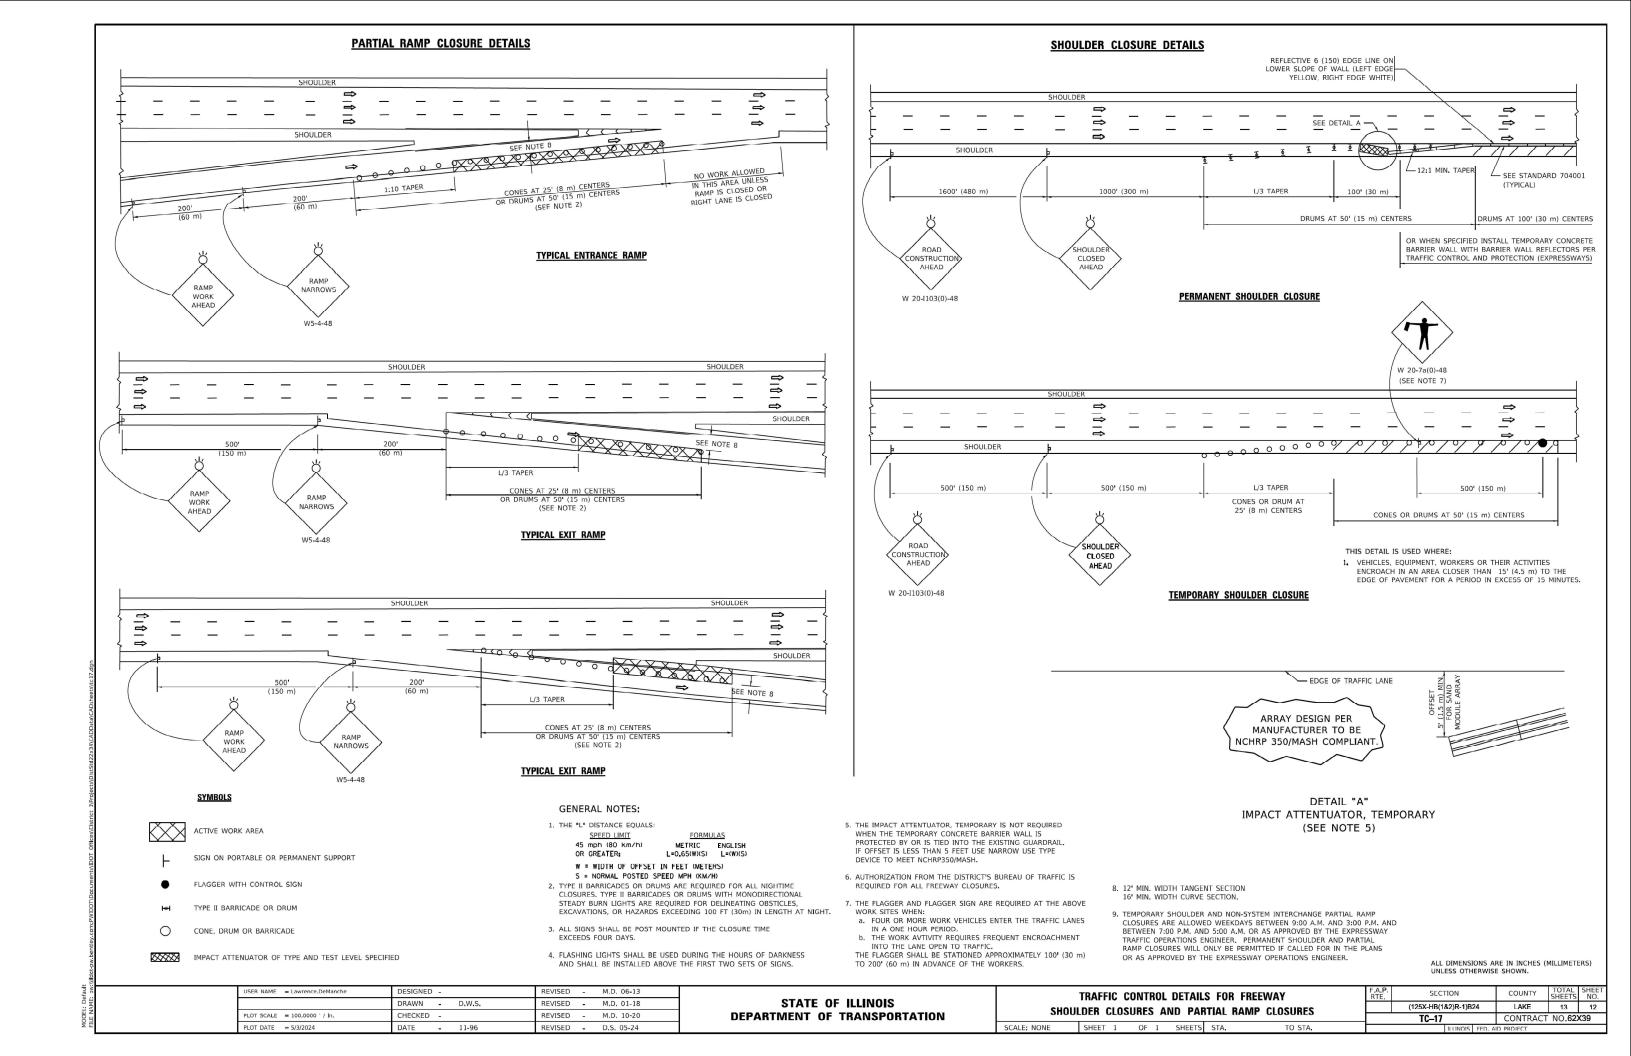

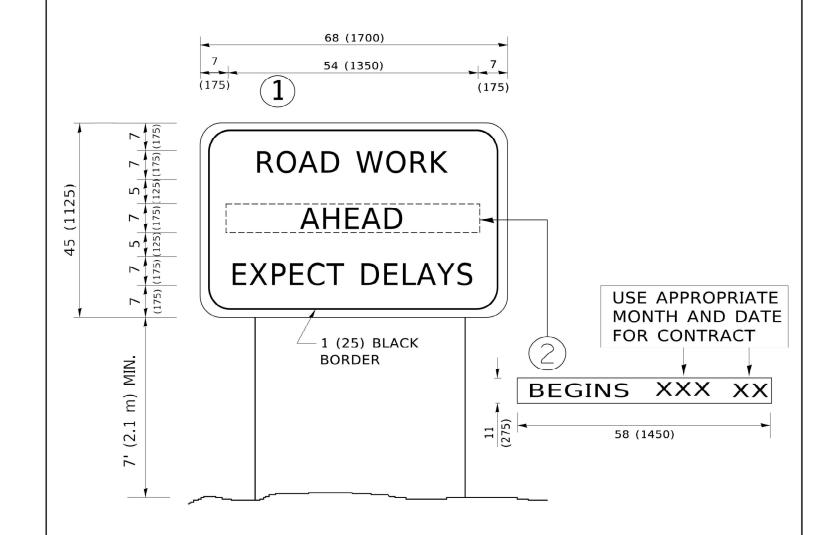

# **NOTES:**

- 1. USE BLACK LETTERING ON ORANGE BACKGROUND.
- 2. ERECT SIGNS IN ADVANCE OF THE LOCATION FOR THE "ROAD CONSTRUCTION AHEAD" SIGN AT LOCATIONS AS DIRECTED BY THE ENGINEER.
- 3. ERECT SIGN(1)WITH INSTALLED PANEL(2)ONE WEEK PRIOR TO THE START OF CONSTRUCTION.
- 4. REMOVE PANEL 2 SOON AFTER THE START OF CONSTRUCTION.
- 5. SEE SPECIAL PROVISION FOR "TEMPORARY INFORMATION SIGNING" FOR ADDITIONAL INFORMATION.
- 6. ONE SIGN ASSEMBLY EQUALS 25.70 SQ. FT. (2.3 SQ. M.)
- 7. SHALL BE PAID FOR AS TEMPORARY INFORMATION SIGNING.

SCALE: NONE

ALL DIMENSIONS ARE IN INCHES (MILLIMETERS) UNLESS OTHERWISE SHOWN.

USER NAME = footemj	DESIGNED -	REVISED - R. MIRS 09-15-97	
	DRAWN -	REVISED - R. MIRS 12-11-97	STA
PLOT SCALE = 50.0000 * / In.	CHECKED -	REVISED -T. RAMMACHER 02-02-99	DEPARTMEN
PLOT DATE = 3/4/2019	DATE -	REVISED - C. JUCIUS 01-31-07	

STATI	E 01	F ILLINOIS
DEPARTMENT	OF	TRANSPORTATION

	ARTERIAL ROAD		F.A.P. RTE.	SECT	ION		T
	INFORMATION SIGN			(125X-HB(18	\$2)R-1)B2	24	
	INI OHIVIATION SIGN			TC-22			
1	OF 1 SHEETS STA	TO STA			HILIMOIC	EED	AID D