Illinois Registered Engineer No. 062-072372 Registration Expires Nov. 30, 2025 Signature and Seal Apply to Drawings 1-9



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01/24/2025

Jose Canales Illinois Registered Engineer No. 062-076979 Registration Expires Nov. 30, 2025 Signature and Seal Apply to Drawings 10-26

FOR INDEX OF SHEETS, SEE SHEET NO. 2

IMPROVEMENTS ARE LOCATED IN THE CITY OF JOLIET

TRAFFIC DATA:

MCDONOUGH STREET (US 6/US 52) (MINOR ARTERIAL)

2023 ADT = 9,800 VPD


POSTED AND DESIGN SPEED = 30 MPH

TRAFFIC DATA:

BRANDON ROAD (MINOR ARTERIAL)

2023 ADT = 6,800 VPD

POSTED AND DESIGN SPEED = 35 MPH

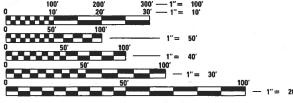

ENGINEERING SCALES. REDUCED SIZED PLANS WILL NOT CONFORM TO STANDARD SCALES. IN MAKING MEASUREMENTS ON REDUCED PLANS, THE ABOVE SCALES MAY BE USED.

JOINT UTILITY LOCATION INFORMATION FOR EXCAVATORS 1-800-892-0123

OR 811

PROJECT ENGINEER: RODRIGO LEDEZMA, P.E. (847) 705-4580 PROJECT MANAGER: J. ALAIN MIDY, P.E. (847) 221-3056

STA. 9+90 TO STA. 10+34

PLAINES RIVER STRUCTURE NO. 099-9903 STA. 3+18 TO STA. 8+10

CONTRACT NO. 62X93


STATE OF ILLINOIS **DEPARTMENT OF TRANSPORTATION**

PROPOSED HIGHWAY PLANS


F.A.U. ROUTE 313 MCDONOUGH STREET (US 6/US 52) **OVER THE DES PLAINES RIVER** F.A.U. ROUTE 341 BRANDON ROAD OVER THE DES PLAINES RIVER

WILL COUNTY SECTION (1981-082B-I) BR 24 LIFT GATE REPLACEMENT


C-91-119-25

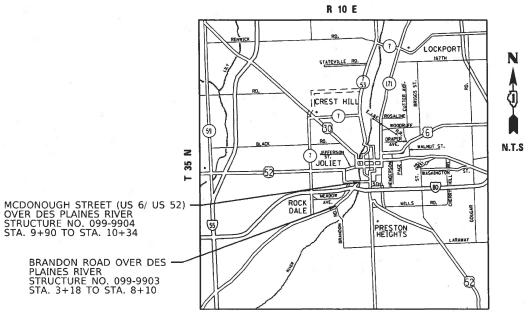




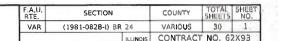

D-91-084-25

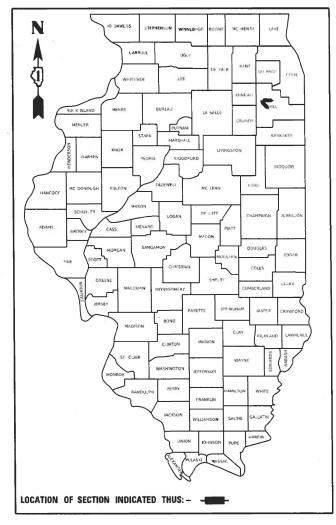

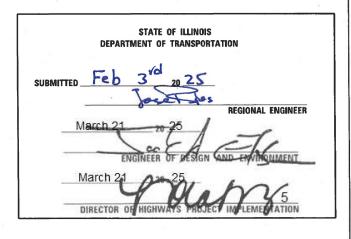

PRINTED BY THE AUTHORITY OF THE STATE OF ILLINOIS

INDEX OF SHEETS

- COVER SHEET
- INDEX, HIGHWAY STANDARDS & GENERAL NOTES
- SUMMARY OF QUANTITIES 3-4
- REMOVAL AND PROPOSED PLAN (MCDONOUGH STREET)
- REMOVAL AND PROPOSED PLAN (BRANDON STREET)
- DETOUR PLAN (MCDONOUGH STREET) DETOUR PLAN (BRANDON STREET)
- ELECTRICAL PLANS (MCDONOUGH STREET) 10-17
- ELECTRICAL PLANS (BRANDON STREET) 18-26
- TRAFFIC CONTROL AND PROTECTION FOR SIDE ROADS, INTERSECTIONS, AND DRIVEWAYS (TC-10)
- DETOUR SIGNING FOR CLOSING STATE HIGHWAYS (TC-21)
- 30 ARTERIAL ROAD INFORMATION SIGN (TC-22)

HIGHWAY STANDARDS

000001-08	STANDARD	SYMBOLS	ARREVIATIONS	AND	PATTERNS	

DECIMAL OF AN INCH AND OF A FOOT

630001-13 STEEL PLATE BEAM GUARDRAIL

TRAFFIC BARRIER TERMINAL, TYPE 2

631032-10 TRAFFIC BARRIER TERMINAL, TYPE 6A

701301-04 LANE CLOSURE, 2L, 2W, SHORT TIME OPERATIONS

701427-05 LANE CLOSURE, MULTILANE, INTERMITTENT OR MOVING OPERATION, FOR SPEEDS ≤ 40 MPH

701801-06 SIDEWALK, CORNER OR CROSSWALK CLOSURE

701901-10 TRAFFIC CONTROL DEVICES 725001-01 OBJECT AND TERMINAL MARKERS

782006-01 GUARDRAIL AND BARRIER BARRIER WALL REFLECTOR MOUNTING DETAILS

GENERAL NOTES

- 1. THE CONTRACTOR SHALL CALL "J.U.L.I.E" AT (800) 892-0123 OR 811 AT LEAST 48 HOURS PRIOR TO EXCAVATION TO DETERMINE WHICH BURIED ELECTRIC, TELEPHONE, AND GAS UTILITIES ARE IN THE AREA.
- 2. THE CONTRACTOR SHALL COORDINATE CONSTRUCTION ACTIVITIES WITH AFFECTED UTILITY COMPANIES THE
- 3. THE CONTRACTOR SHALL NOT SET UP A YARD OR FIELD OFFICE ON STATE PROPERTY WITHOUT WRITTEN PERMISSION FROM THE DEPARTMENT
- 4. THE CONTRACTOR SHALL CONTRACT THE DISTRICT ONE TRAFFIC CONTROL SUPERVISOR KALPANA KANNAN-HOSADURGA, AT KALPANA.KANNAN-HOSADURGA@ILLINOIS.GOV A MINIMUM OF 72 HOURS IN ADVANCE OF BEGINNING ANY WORK.
- 5. DO NOT SCALE PLANS FOR CONSTRUCTION DIMENSIONS.
- 6. THE CONTRACTOR SHALL USE CARE NEAR ANY AND ALL EXISTING ITEMS THAT WILL NOT BE REMOVED. ANY DAMAGE DONE TO EXISTING ITEMS BY THE CONTRACTOR SHALL BE REPAIRED OR REPLACED TO THE SATISFACTION OF THE ENGINEER AT THE CONTRACTOR'S OWN EXPENSE.
- 7. THE CONTRACTOR SHALL BE REQUIRED TO PROVIDE ACCESS TO ABUTTING PROPERTIES AT ALL TIMES DURING THE CONSTRUCTION OF THE PROJECT.
- 8. THE LOCATION OF THE EXISTING DRAINAGE STRUCTURES, STORM SEWERS, WATER MANS, SANITARY SEWERS, AND ANY OTHER PUBLIC OR PRIVATE UTILITIES SHOWN ON THE PLANS IS APPROXIMATE AND THEIR EXACT LOCATION IS TO BE DETERMINED IN THE FIELD BY THE CONTRACTOR.
- 9. THE CONTRACTOR SHALL BE RESPONSIBLE FOR THE PROTECTION OF ALL UNDERGROUND AND SURFACE UTILITIES EVEN THOUGH THEY MIGHT BE SHOWN IN THE PLANS. ANY UTILITY PROPERTY DAMAGED DURING CONSTRUCTION SHALL BE REPAIRED OR REPLACED TO THE SATISFACTION OF THE ENGINEER.
- 10. ANY LOOSE MATERIAL DEPOSITED IN THE FLOW LINE OF DRAINAGE STRUCTURES WHICH OBSTRUCTS THE NATURAL FLOW OF WATER SHALL BE REMOVED AT THE CLOSE OF EACH WORKING DAY. PRIOR TO ACCEPTANCE OF THE IMPROVEMENT, ALL DRAINAGE STRUCTURES SHALL BE FREE OF DIRT AND DEBRIS. THIS WORK WILL NOT BE PAID FOR SEPARATELY, BUT SHALL BE CONSIDERED AS INCLUDED IN THE UNIT BID PRICES OF THE CONTRACT
- 11. IT SHALL BE THE CONTRACTORS RESPONSIBILITY TO VERIFY ALL DIMENSIONS AND CONDITIONS EXISTING IN THE FIELD PRIOR TO CONSTRUCTION AND ORDERING MATERIALS.
- 12. ANY REFERENCE TO A STANDARD IN THESE PLANS SHALL BE INTERPRETED TO MEAN THE EDITION AS INDICATED BY THE SUB NUMBER SHOWN IN THE LIST OF STANDARDS OR THE COPY INCLUDED IN THESE

USER NAME = USAT719599	DESIGNED	-	AT	REVISED -
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PLOT DATE = 1/24/2025	DATE	-	01/24/2025	REVISED -

STATE OF ILLINOIS **DEPARTMENT OF TRANSPORTATION**

SCALE:

	MCDON	F.A.U. RTE.	SECTION				
INI	DEX. HIGH\	VAR	(1981-082B-I) BR 2				
HAL	LA, IIIGIII						
	CHEET	OE	CHEETS	STA	TO STA	I	Luumoral

				STATE 100%	STATE 100%		
		1		MCDONOUGH ST	BRANDON ST		
CODE	ITEM	LINIT	TOTAL	ROADWAY	ROADWAY		
NO.	ITEM	UNIT	QUANTITY	0005	0005		
				URBAN	URBAN		
50102400	CONCRETE REMOVAL	CU YD	0.1	0	0.1		
50300335	CONCRETE STRUCTURES	CIL VID	0.2		0.2		
50300225	CONCRETE STRUCTURES	CU YD	0.2	0	0.2		
50800205	REINFORCEMENT BARS, EPOXY COATED	POUND	20	0	20		
52100510	ANCHOR BOLTS, 3/4"	EACH	24	16	8		
63000001	STEEL PLATE BEAM GUARDRAIL, TYPE A, 6 FOOT POSTS	FOOT	175	62.5	112.5		
03000001	STEEL TEATE BEAM GUANDIVAIL, TITE A, 0 TOOT TOSTS	1001	175	02.5	112.5		
63100045	TRAFFIC BARRIER TERMINAL, TYPE 2	EACH	3	1	2		
63100087	TRAFFIC BARRIER TERMINAL, TYPE 6A	EACH	4	0	4		
63100167	TRAFFIC BARRIER TERMINAL, TYPE 1 (SPECIAL) TANGENT	EACH	3	1	2		
63200310	GUARDRAIL REMOVAL	FOOT	437.5	50	387.5		
67100100	MOBILIZATION	L SUM	1	0.5	0.5		
07100100	TION TO THE TION	2 3011	•		0.5		
70107025	CHANGEABLE MESSAGE SIGN	CAL DA	56	28	28		
78200005	GUARDRAIL REFLECTORS, TYPE A	EACH	20	4	16		
,3200003	SUMMUNAL NEI LECTONS, THE A	LACT			10		
X0326366	ELECTRICAL EQUIPMENT REMOVAL AND SALVAGE	EACH	6	4	2		
V0337733	MICCELLANGOUG ELECTRICAL WORK	1 61	1	0.5	0.5		
X0327739	MISCELLANEOUS ELECTRICAL WORK	L SUM	1	0.5	0.5		



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STATE OF ILLINOIS DEPARTMENT OF TRANSPORTATION

MCDO	ONOUGH	AND BRA	NDON	STREET								
SUMMARY OF QUANTITIES												
SHEET	OF	SHEETS	STΔ		TO STA							

SCALE:


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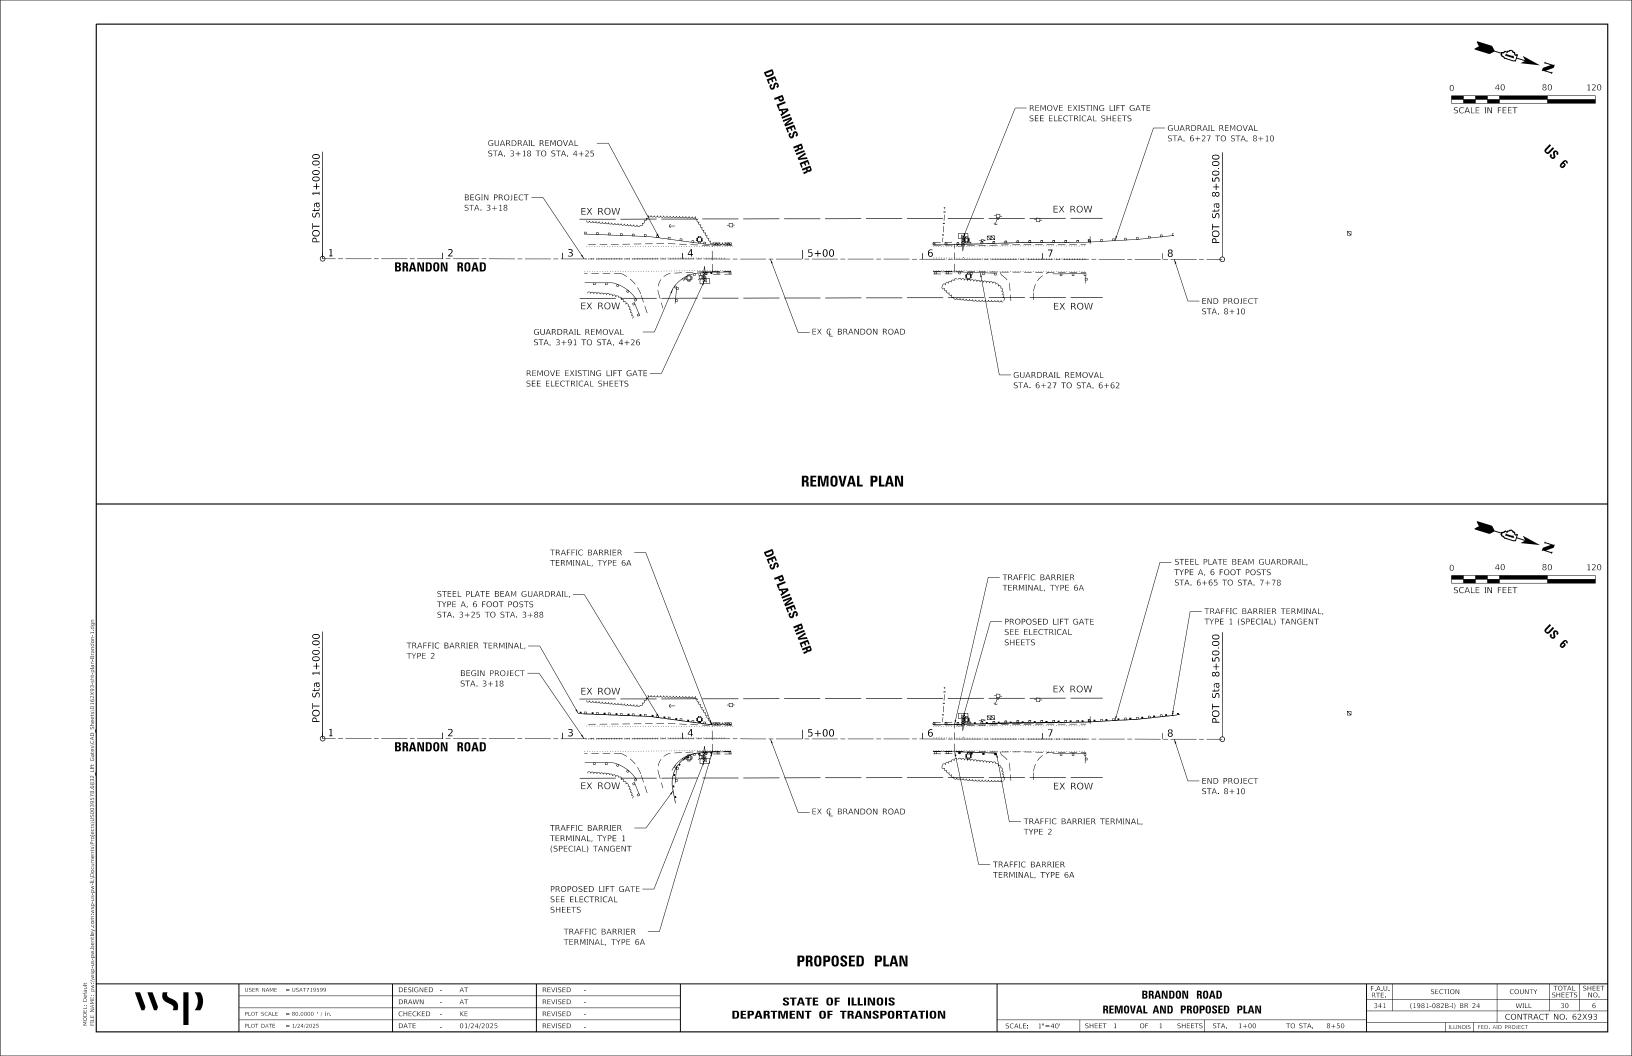
COUNTY TOTAL SHEET NO.
WILL 30 3 SECTION (1981-082B-I) BR 24 CONTRACT NO. 62X93


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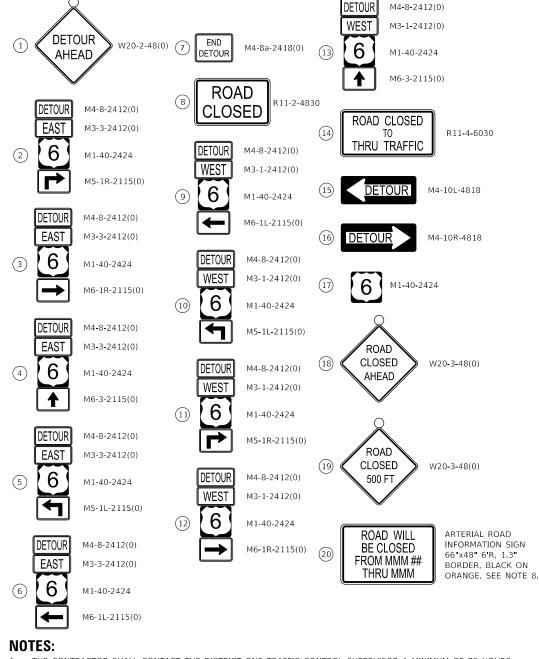
STATE OF ILLINOIS
DEPARTMENT OF TRANSPORTATION MCDONOUGH AND BRANDON STREET
SUMMARY OF QUANTITIES
SHEET OF SHEETS STA. TO STA. SECTION (1981-082B-I) BR 24

									X0328503	Z0073510	X7200061	X7010216	X6700407	NO.	CODE		
									TRAFFIC GATE ASSEMBLY-VW4	TEMPORARY TRAFFIC SIGNAL TIMING	TEMPORARY INFORMATION SIGNING	TRAFFIC CONTROL AND PROTECTION, (SPECIAL)	ENGINEER'S FIELD OFFICE, TYPE A (D1)	IIEM	1 1 1 1 2 2 2		
									EACH	EACH	SQ FT	L SUM	CAL MO	CNI			
									6	35	102.8	1	ω	QUANTITY			
									4	27	51.4	0.5	2	0005 URBAN	ROADWAY	STATE 100% MCDONOUGH ST	
									2	80	51.4	0.5	1	0005 URBAN	ROADWAY	STATE 100% BRANDON ST	
																	CONSTRU
																	CONSTRUCTION CODE





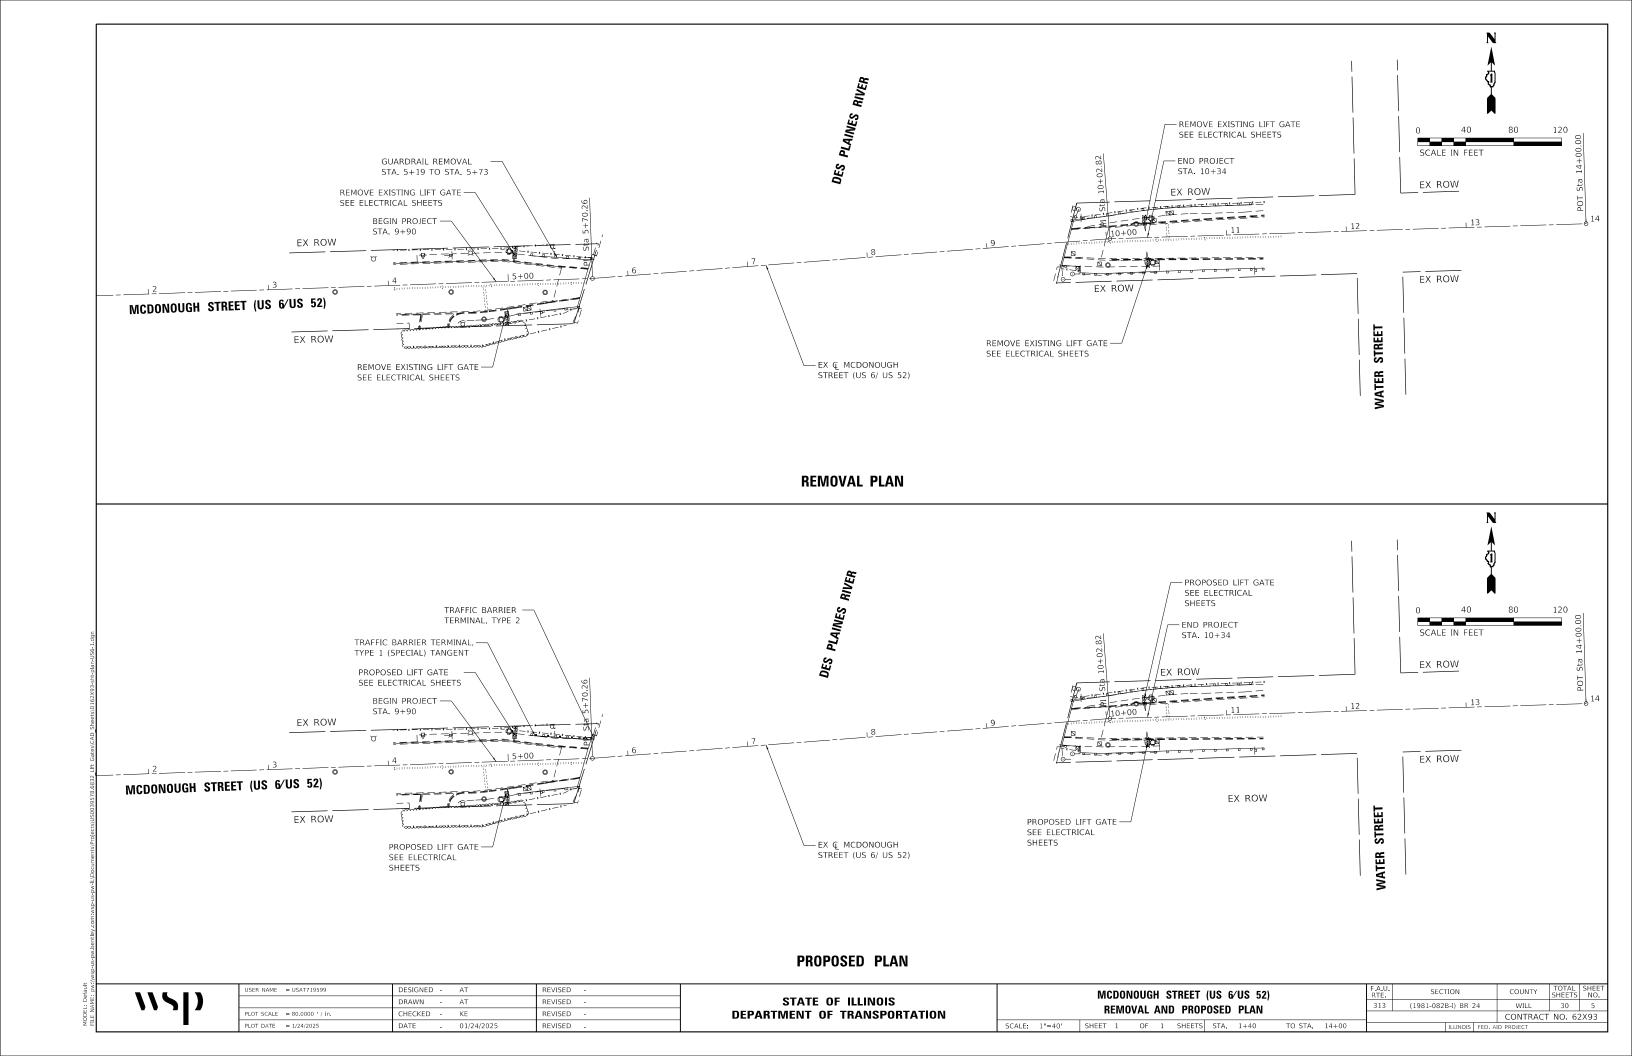

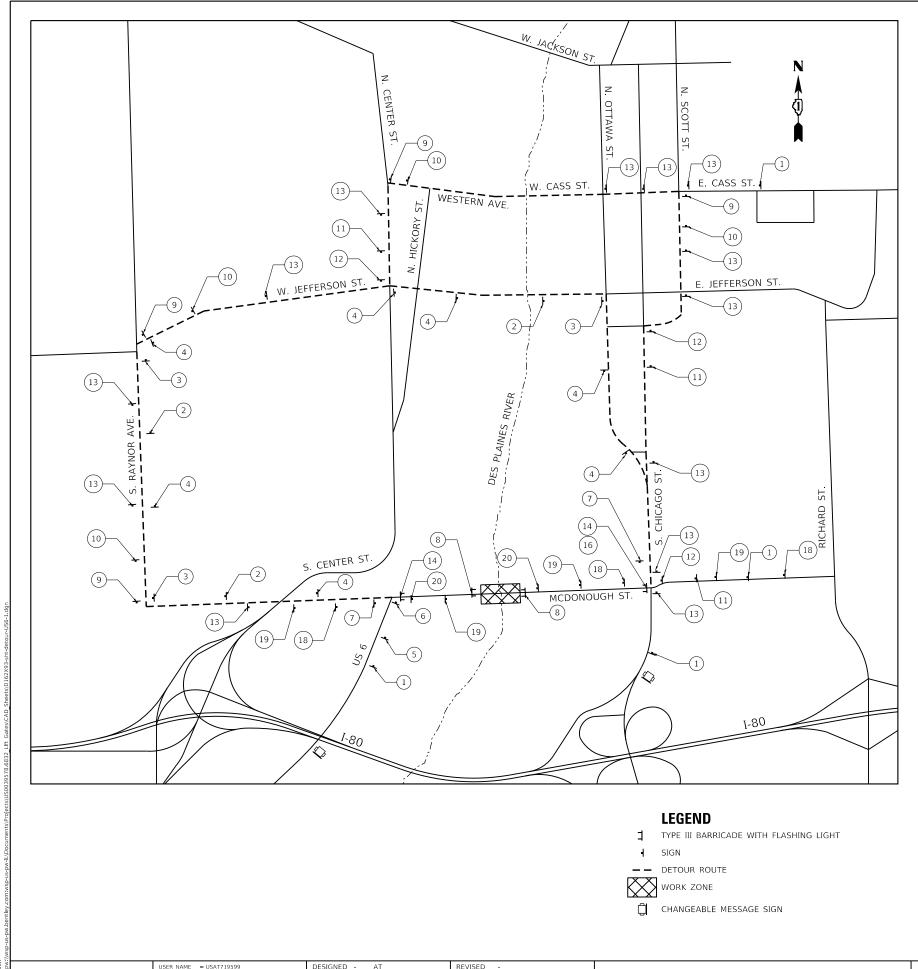

- THE CONTRACTOR SHALL CONTACT THE DISTRICT ONE TRAFFIC CONTROL SUPERVISOR A MINIMUM OF 72 HOURS PRIOR TO BEGINNING WORK.
- THE LOCATIONS OF SIGNAGE AS SHOWN ON THE DETOUR PLAN ARE CONSIDERED APPROXIMATE. THE CONTRACTOR SHALL ADJUST SIGNAGE LOCATIONS AS NEEDED TO FIT FIELD CONDITIONS. FINAL LOCATIONS SHALL BE APPROVED BY THE ENGINEER.
- EXISTING TRAFFIC SIGNS THAT CONFLICT WITH THE DETOUR SIGNAGE SHALL BE COVERED AS DIRECTED BY THE ENGINEER.
- UTILIZE IDOT HIGHWAY STANDARD TC-21 FOR TYPICAL SIGN SPACING.
- THE CONTRACTOR SHALL NOT OBSTRUCT ANY EXISTING SIGN WITH THE PLACEMENT OF DETOUR SIGNAGE.
- A MINIMUM OF FOURTEEN (14) DAYS IN ADVANCE OF THE ROAD CLOSURE, THE CONTRACTOR SHALL PLACE ONE (1) ARTERIAL ROAD INFORMATION SIGN AT EACH END OF THE PROJECT AS DIRECTED AND AT A LOCATION DESIGNATED BY THE ENGINEER TO INFORM MOTORISTS OF THE UPCOMING CLOSURE. THE MESSAGE SHALL BE APPROVED BY THE ENGINEER. THIS WORK IS TO BE PAID FOR AT THE CONTRACT UNIT PRICE FOR CHANGEABLE
- 7. DETOUR SIGNAGE SHALL BE CONSIDERED INCLUDED IN THE COST FOR TEMPORARY TRAFFIC CONTROL AND PROTECTION (SPECIAL) EXCEPT AS OTHERWISE NOTED.
- ARTERIAL ROAD INFORMATION SIGN SHALL BE PAID AS TEMPORARY INFORMATION SIGNING.
- CONTRACT SHALL COORDINATE TRAFFIC CONTROL OPERATIONS WITH ADJACENT CONTRACTS PRIOR TO IMPLEMENTATION OF DETOUR.


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PLOT DATE = 1/24/2025	DATE - 01/24/2025	REVISED -

STATE OF ILLINOIS **DEPARTMENT OF TRANSPORTATION**

SCALE: NTS

	MCDONOUGH STREET (US 6/US 52)							SECTION	COUNTY	TOTAL SHEETS	SHEET NO.
	CAR DETOUR PLAN						313	(1981-082B-I) BR 24	WILL	30	7
									CONTRACT	NO. 62	2X93
	SHEET 1 OF 2 SHEETS STA.			TO STA.		ILLINOIS FED. A	ID PROJECT				

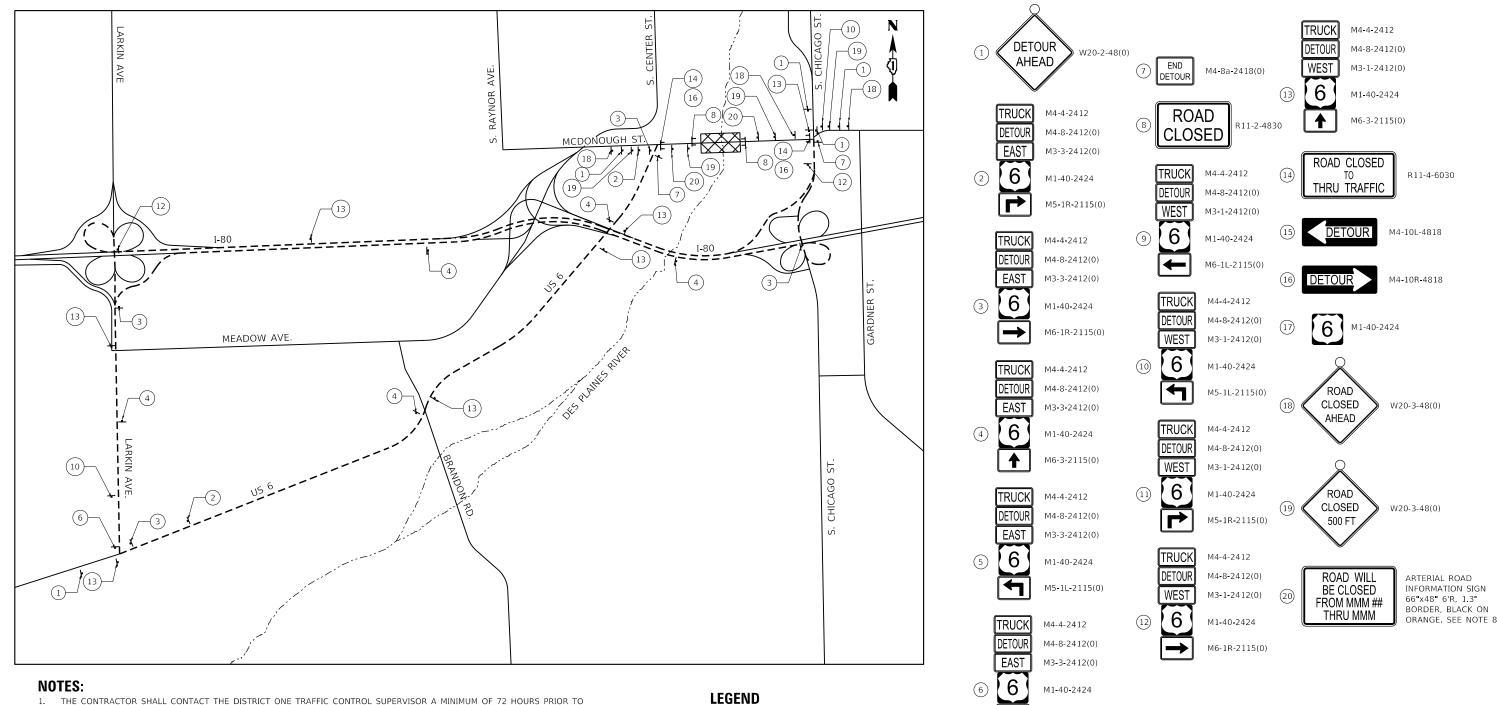

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- DETOUR SIGNAGE SHALL BE CONSIDERED INCLUDED IN THE COST FOR TEMPORARY TRAFFIC CONTROL AND PROTECTION (SPECIAL) EXCEPT AS OTHERWISE NOTED.
- ARTERIAL ROAD INFORMATION SIGN SHALL BE PAID AS TEMPORARY INFORMATION SIGNING.
- PRIOR TO IMPLEMENTATION OF

-- DETOUR ROUTE

WORK ZONE

- TYPE III BARRICADE WITH FLASHING LIGHT
- SIGN

CHANGEABLE MESSAGE SIGN

9. CON DETO	SHALL	COORDINATE	TRAFFIC	CONTROL	OPERATIONS	WITH	ADJACENT	CONTRACT	S P

STATE OF ILLINOIS


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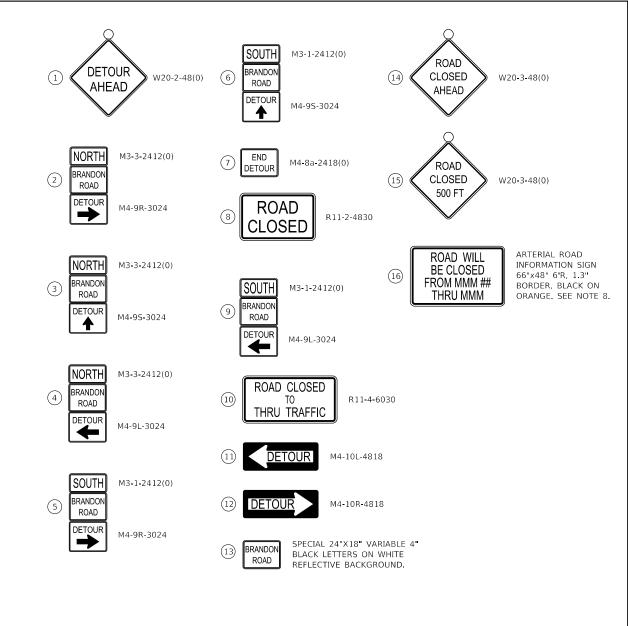
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	TRIIC	· N	DETOUR	DIAN	•	313	3	(1981-082)	B-I) BR 2	24	WILL	Τ
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DEPARTMENT OF TRANSPORTATION






NOTES:

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- ARTERIAL ROAD INFORMATION SIGN SHALL BE PAID AS TEMPORARY INFORMATION SIGNING.
- CONTRACT SHALL COORDINATE TRAFFIC CONTROL OPERATIONS WITH ADJACENT CONTRACTS PRIOR TO IMPLEMENTATION OF DETOUR.

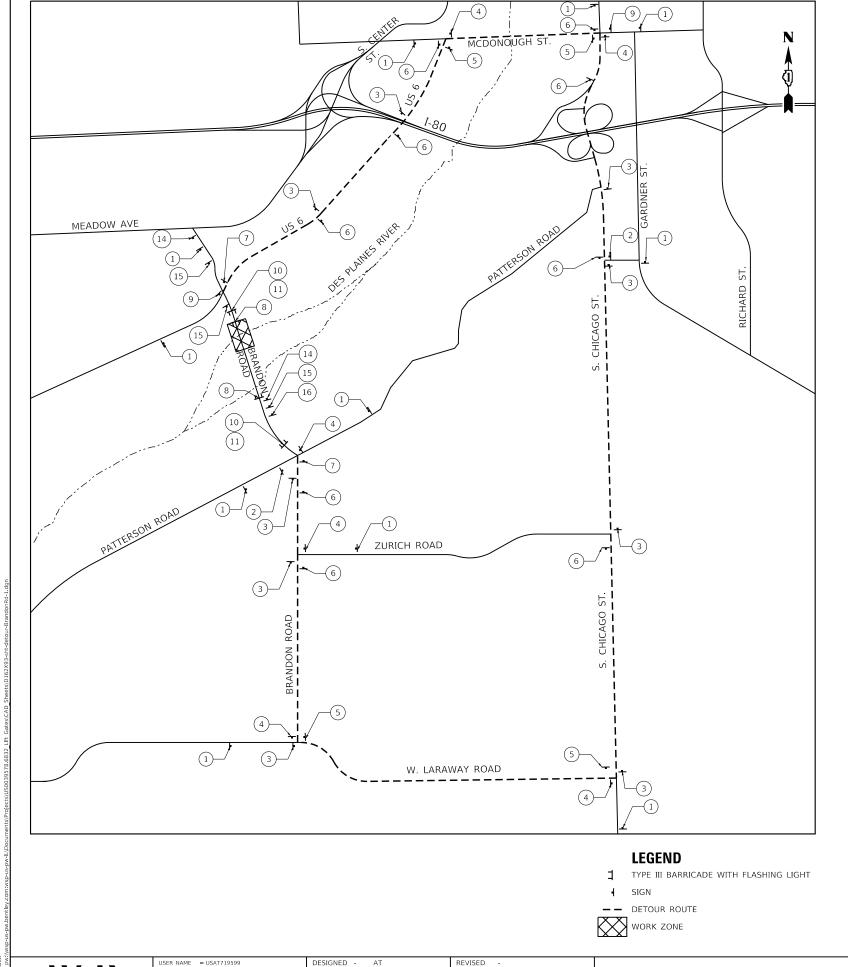STATE OF HILINOIS				RTE.	SECTION		COUNTY	SHEETS					
STATE OF ILLINOIS	DETOUR PLAN					341	(1981-082B-I) BR 2	24	WILL	30	9		
ARTMENT OF TRANSPORTATION				LIU	011 1 12	114					CONTRACT	NO. 6	52X93
	SCALE: NTS	SHEET 1	OF	1	SHEETS	STA.	TO STA.		ILLINOIS	FED. AI	ID PROJECT		

DRAWN AT REVISED OT SCALE = 1000.0000 ' / in. HECKED -REVISED PLOT DATE = 1/24/2025 DATE REVISED

DEPAR

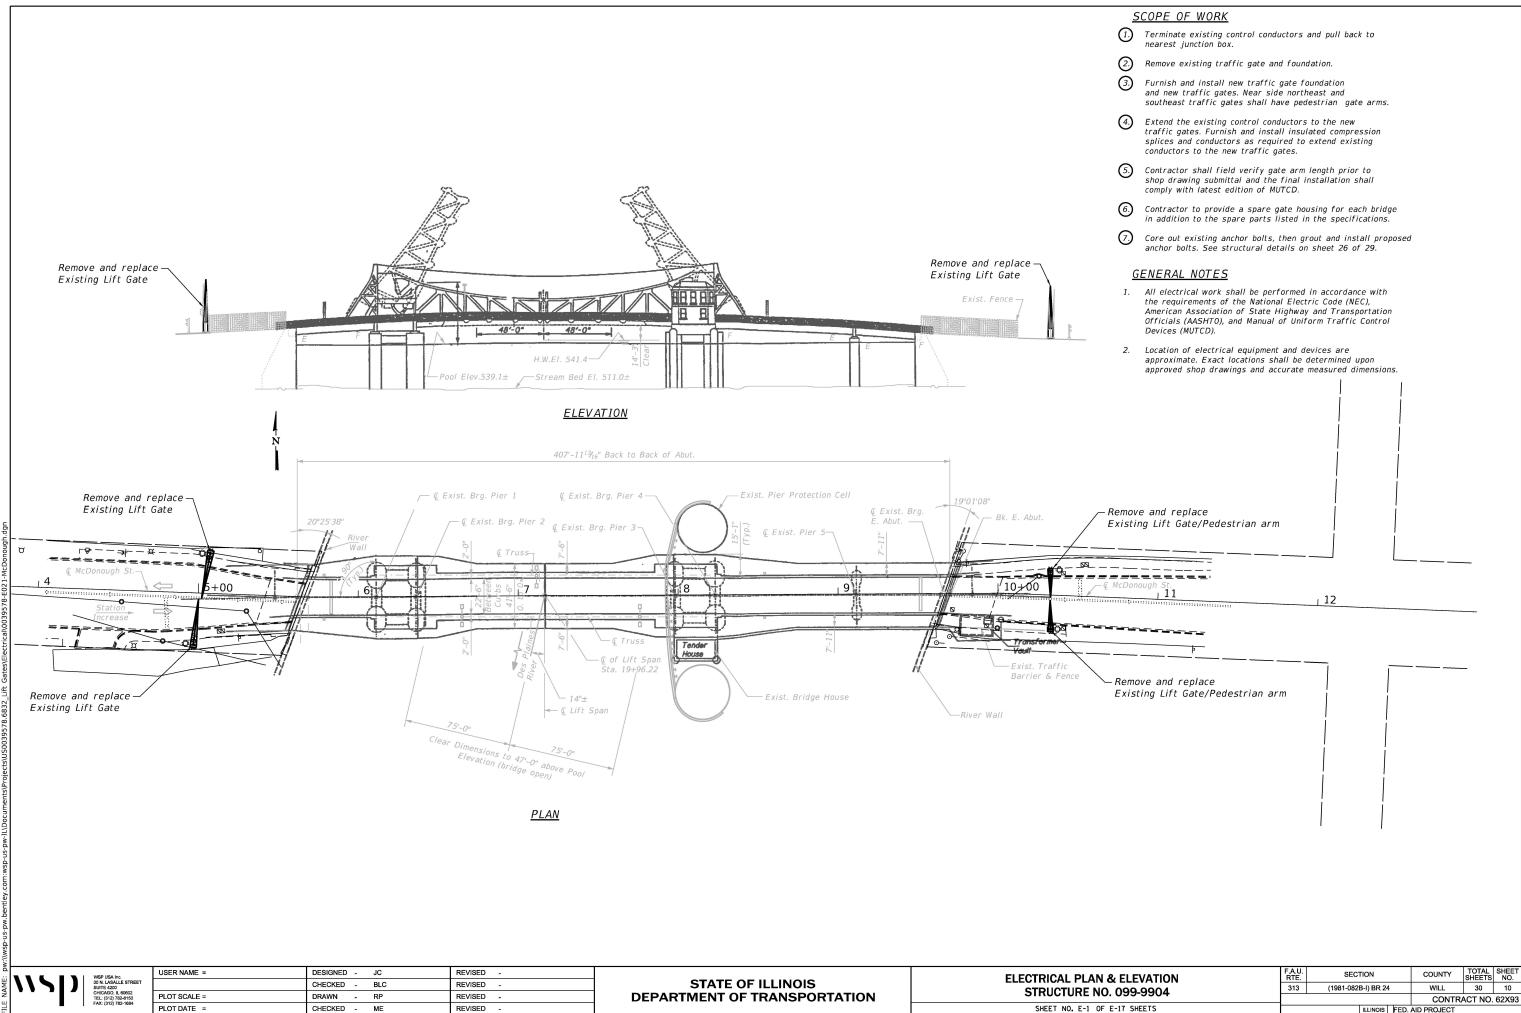

CL = Clearance light

HAND SWITCHES - HS

Toggle switch

Brake

PUSH BUTTON

-Normally open

Normally closed مله

Mushroom head maintained push button

(R)Indicating Light Color R = Red G = GreenA = Amber B = BlueW = White

(CR)Relay Coil $CR = Control \ relay$ M = Motor contactor

RELAY CONTACTS

 Θ Normally open contact

01/60 Normally closed contact

 \Diamond Center lock operator

Gate operator

Aerial cable connection point

Terminal XXX X = Panel or BoxXXX = Wire number

POSITION (LIMIT) SWITCHES - LS

Normally closed 0/10

000 Normally closed held open

Normally open

9 Normally open held closed

> Limit switches are shown with bridge down, locks driven and traffic gates up

A, AMPS *AMPERES* AUXILIARY PANEL APCONSOLE CBCIRCUIT BREAKER CONTROL RELAY CRDISCONNECT DISC FS FAR SIDE

FAR SIDE FULLY OPEN FAR SIDE TRAFFIC GATE DOWN FSF0 FSTGD GROUND

GNDHAND RELEASED HRINDICATOR LIGHT ΙL LCPLEAF CONTROL PANEL

LLCBPR LEAF LOCK CONTROL BYPASS RELAY

LS LIMIT SWITCH

MDPNEAR SIDE MACHINERY AREA MAIN DISTRIBUTION PANEL

NAVIGATION NAVNL NAVIGATION LIGHTS NS NEAR SIDE NEAR SIDE FULLY OPEN NSF0

NSTGD NEAR SIDE TRAFFIC GATE DOWN 0L

OVERLOAD


OVERLOAD PROTECTION MODULE OPMPULL


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STATE OF ILLINOIS DEPARTMENT OF TRANSPORTATION **ELECTRICAL LEGEND AND ABBREVIATIONS STRUCTURE NO. 099-9904** SHEET NO. E-2 OF E-17 SHEETS

SECTION COUNTY 313 (1981-082B-I) BR 24 WILL 30 11 CONTRACT NO. 62X93



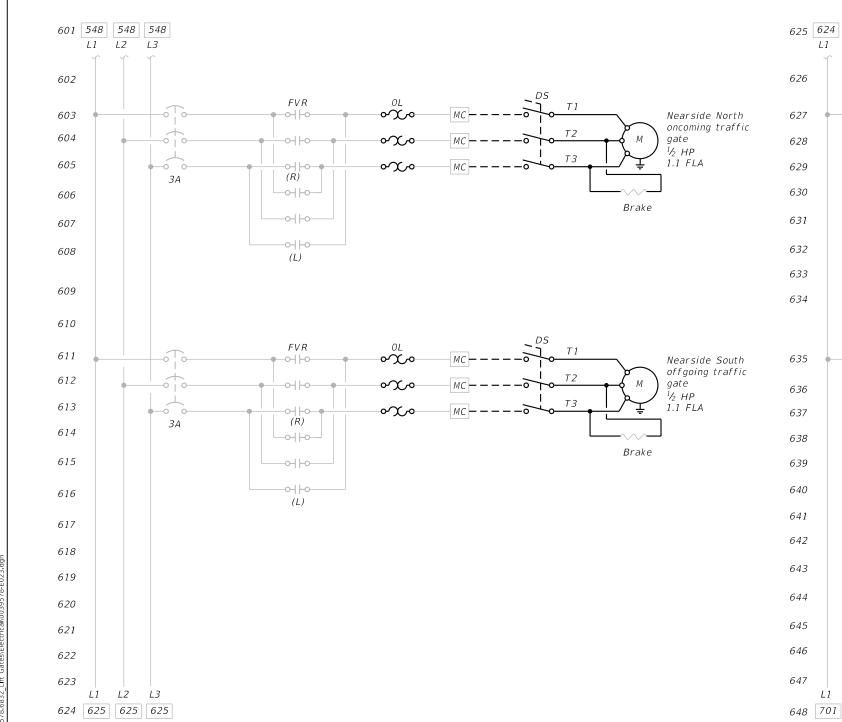

Note:

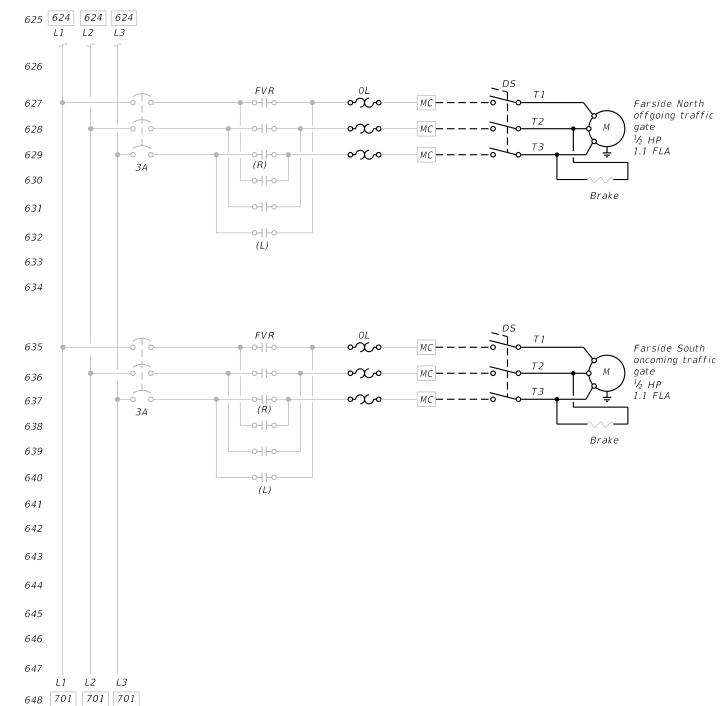- Note.


 1. Schematic diagrams are from 1990 shop drawing. All pertinent circuits and wire numbers shall be field verified by the Contractor before beginning work.
- 2. Replace overload heaters as needed for 125% of nameplate full load current at 480 Va.c.
- 3. Traffic gate disconnect switch (DISC) is integral to the gate enclosure.


''')	WSP USA Inc. 30 N. LASALLE ST SUITE 4200 CHICAGO, IL 6060: TEL: (312) 782-168 FAX: (312) 782-168
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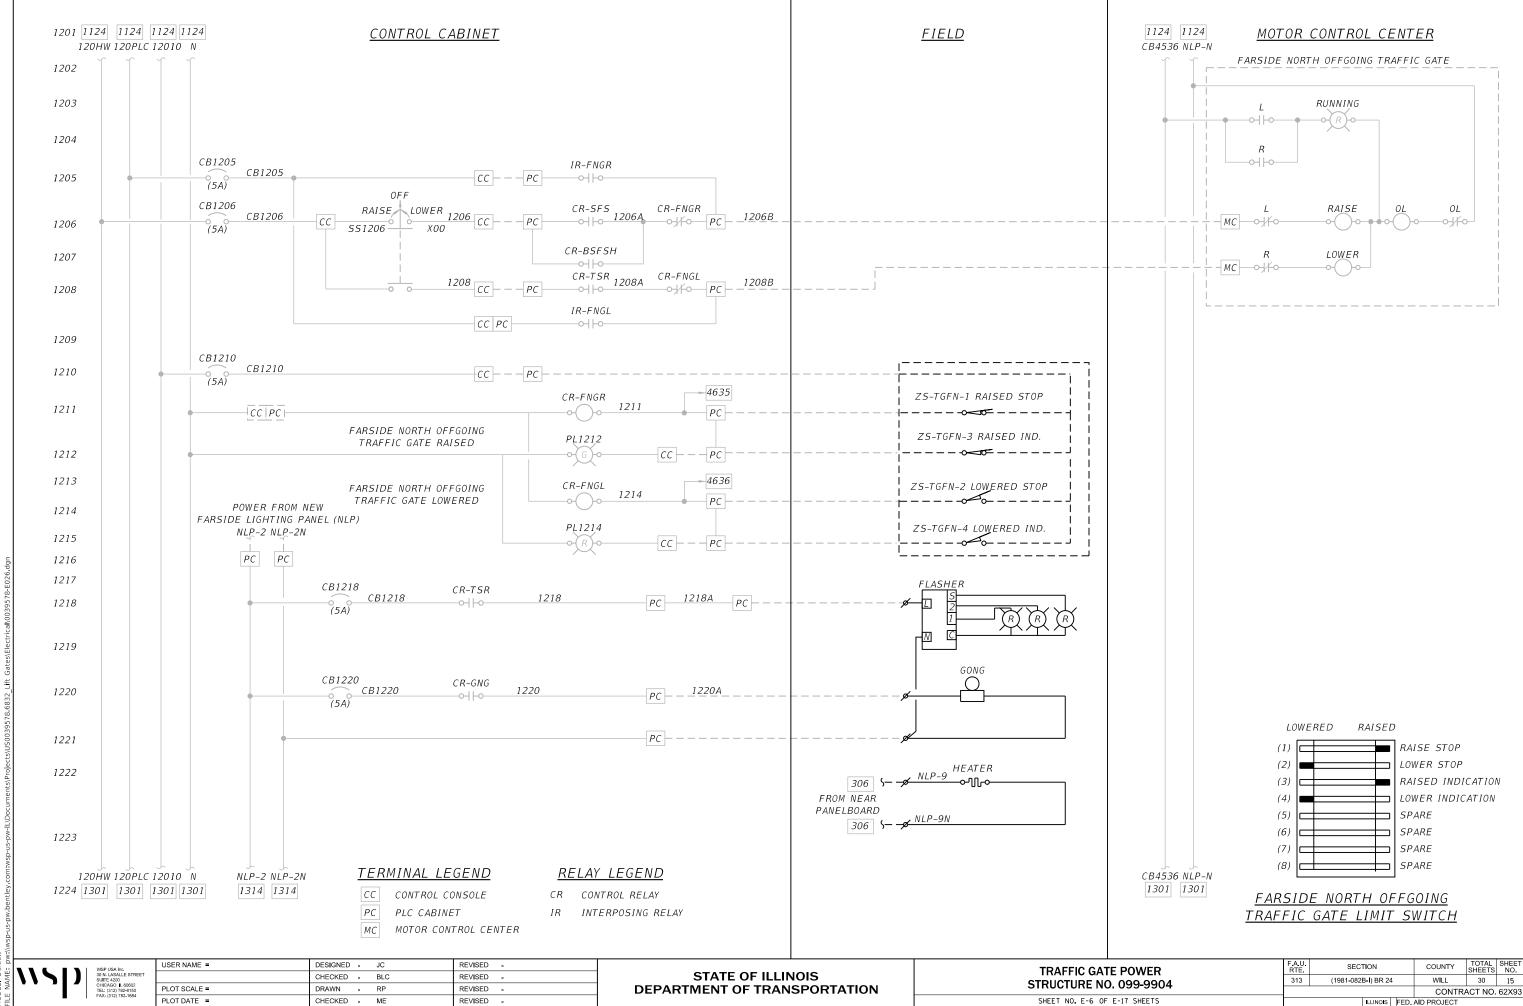
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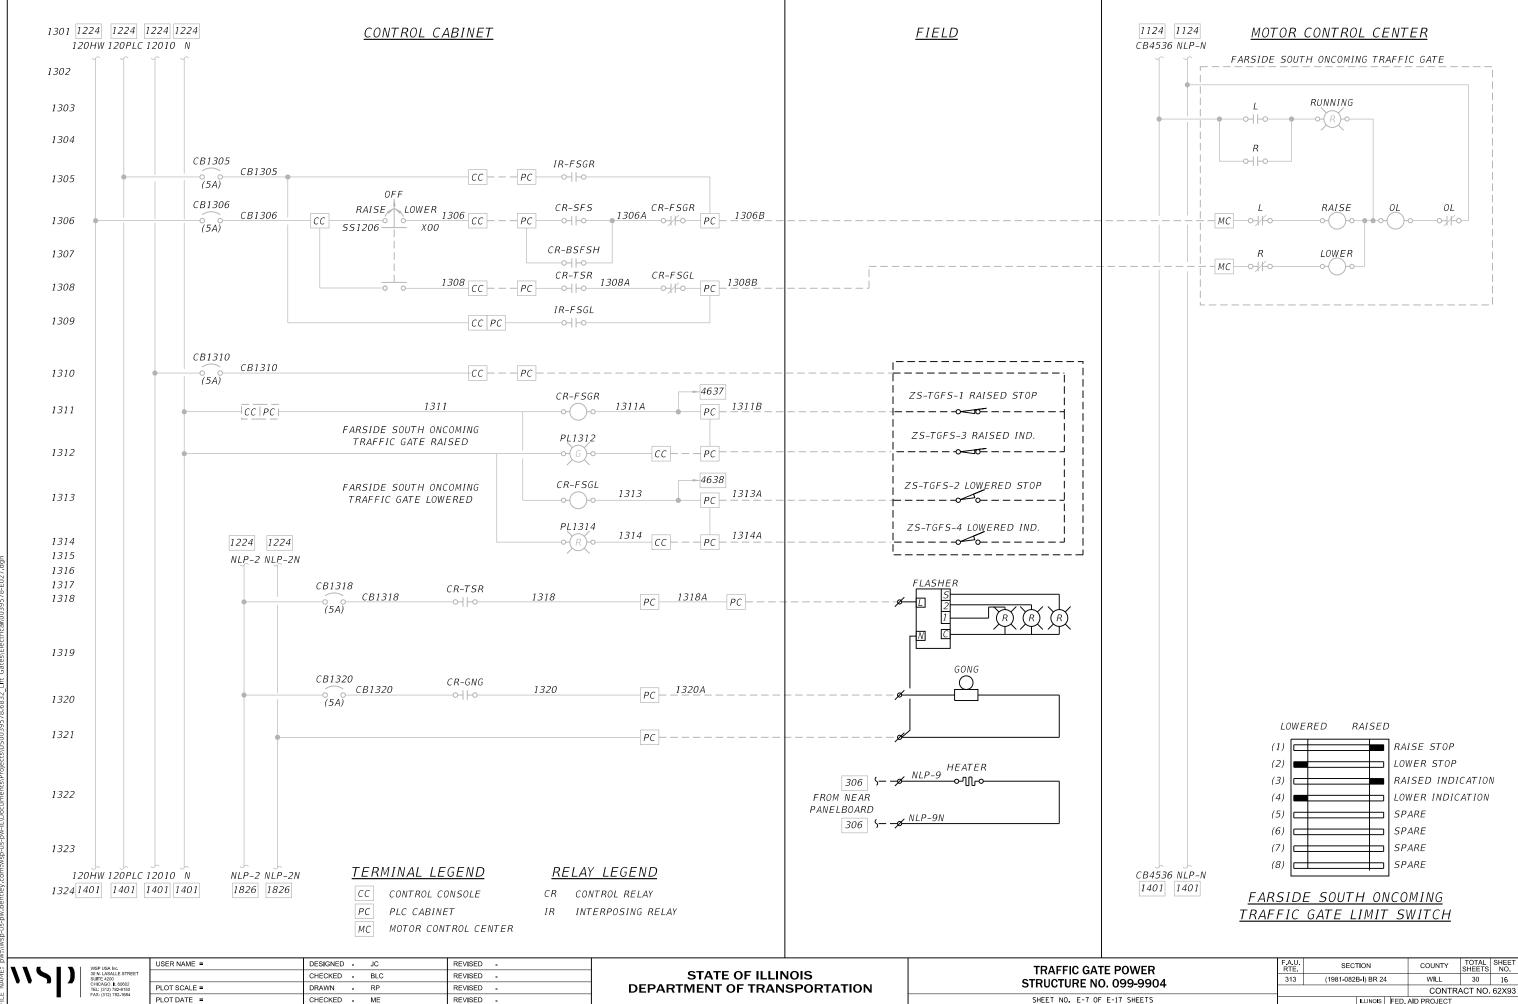
STATE OF ILLINOIS
DEPARTMENT OF TRANSPORTATION


TRAFFIC GATE POWER	F.A.U. RTE	SECTION	COUNTY	TOTAL SHEETS	SHEET NO.
STRUCTURE NO. 099-9904	313	(1981-082B-I) BR 24	WILL	30	12
5111001011E 1101 033 330+			CONTR	ACT NO.	62X93
CHEET NO E-3 OF E-17 CHEETS		TURNOTO FEE	ALD DOO ITOT		






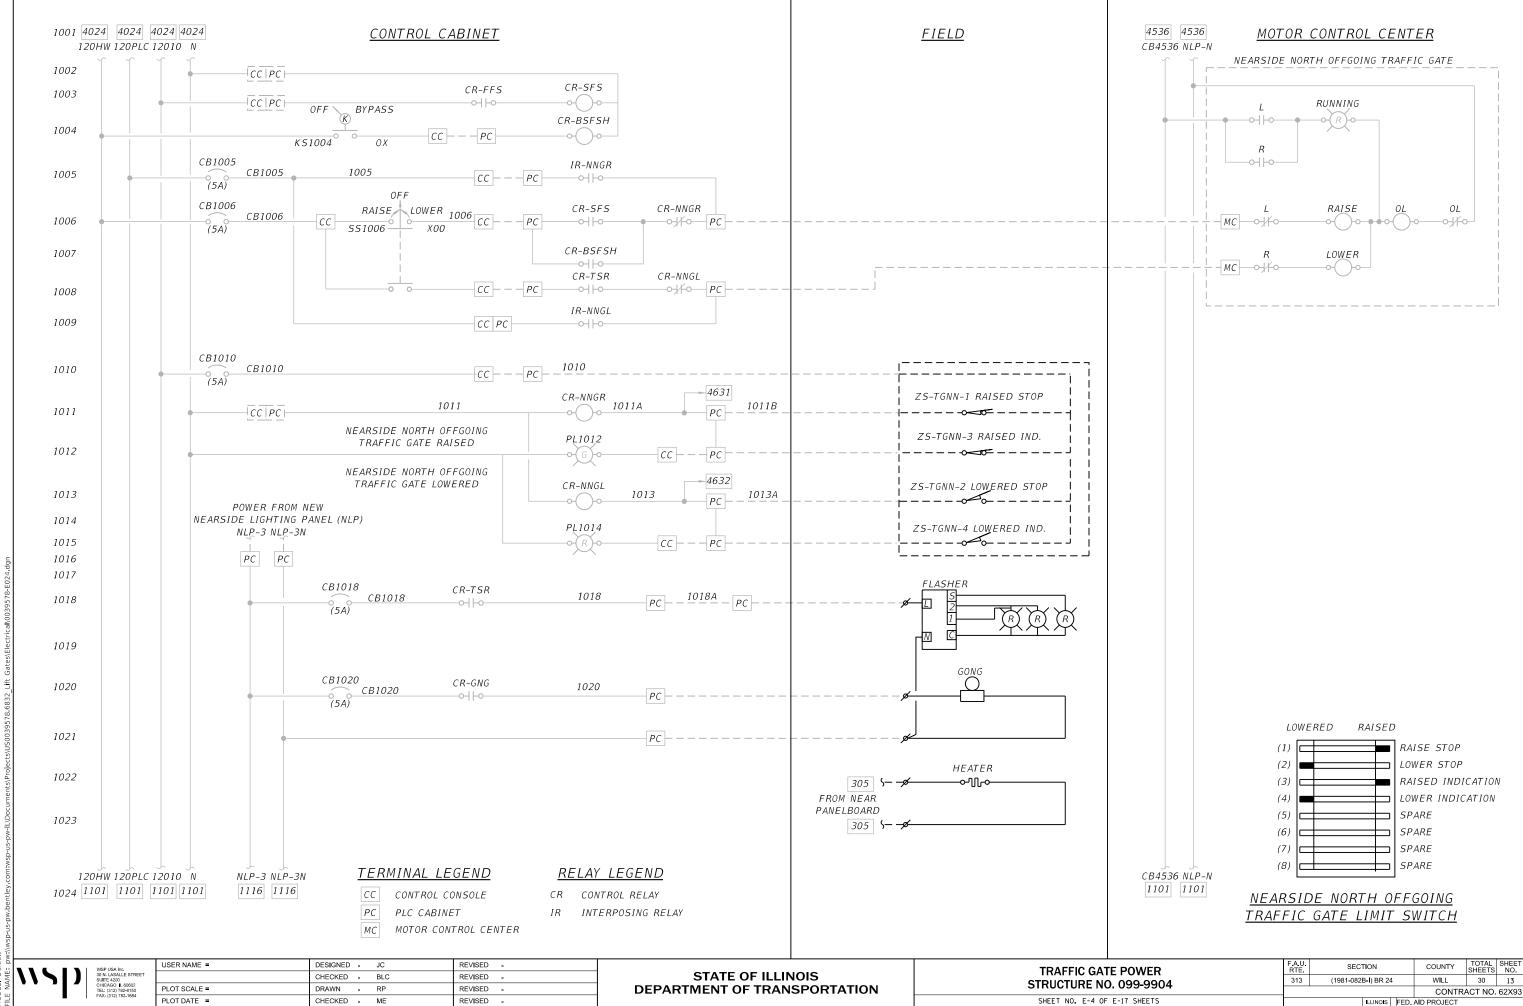

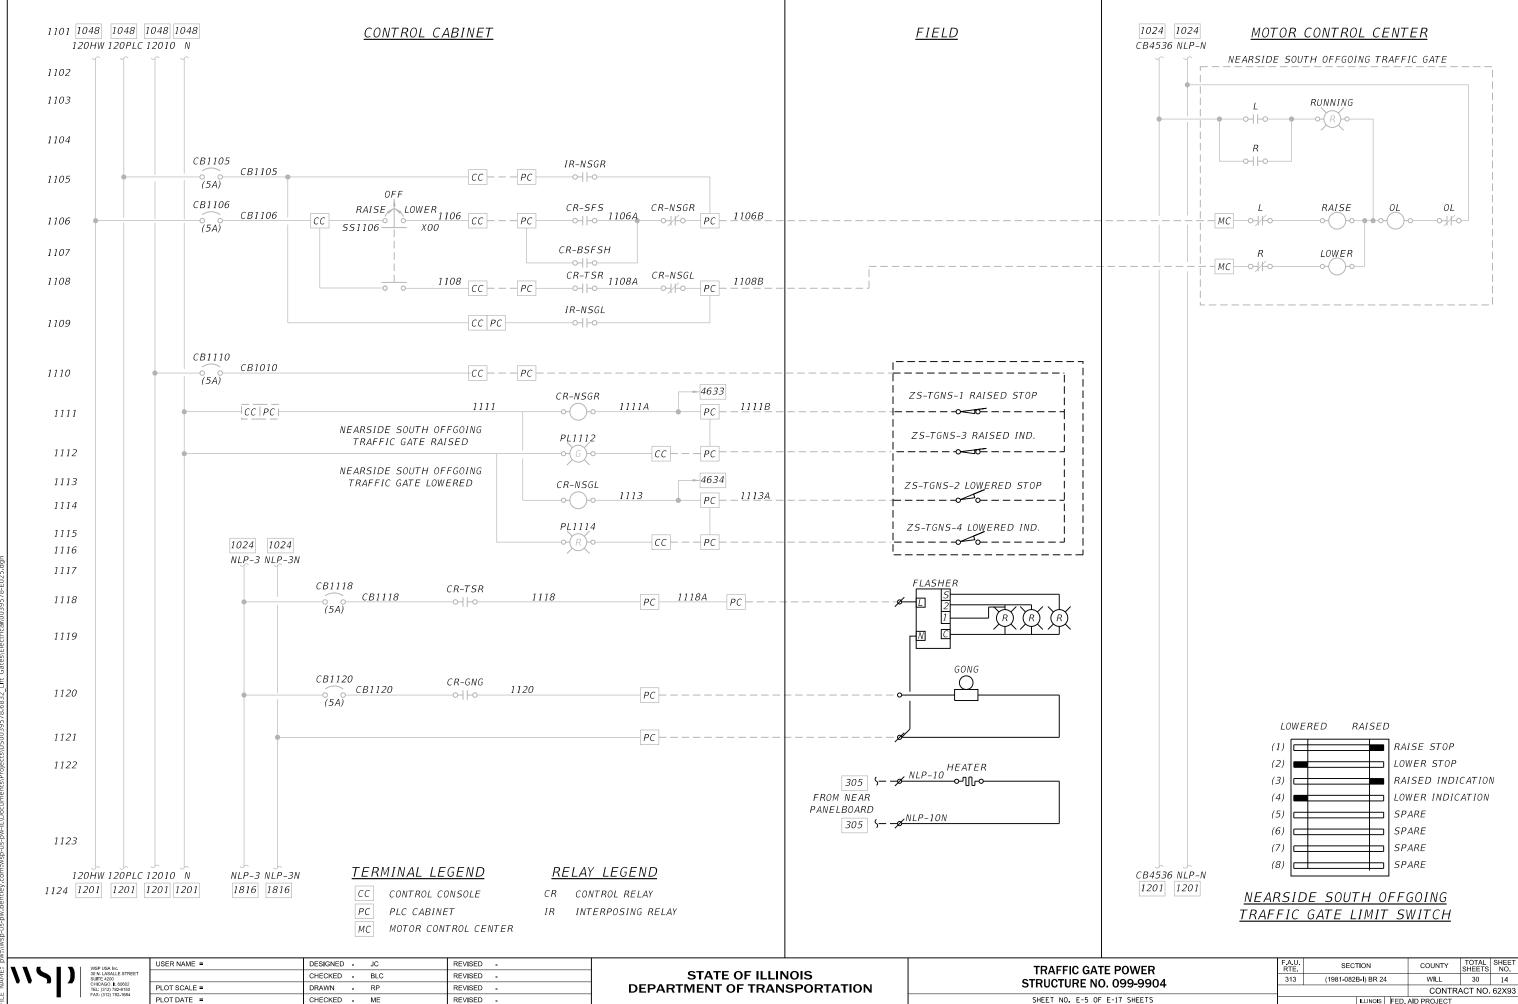

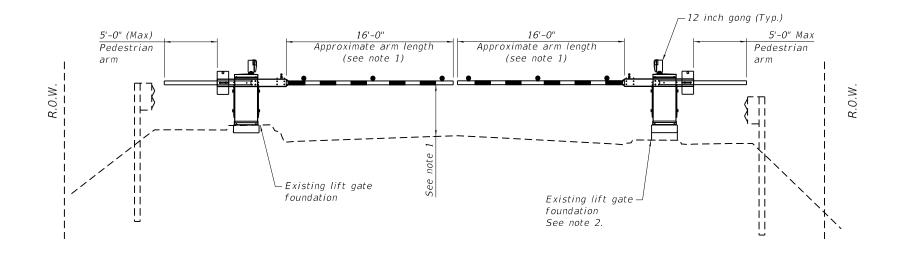

EAST SIDE OF MCDONOUGH ST BRIDGE STA. 10+33.00

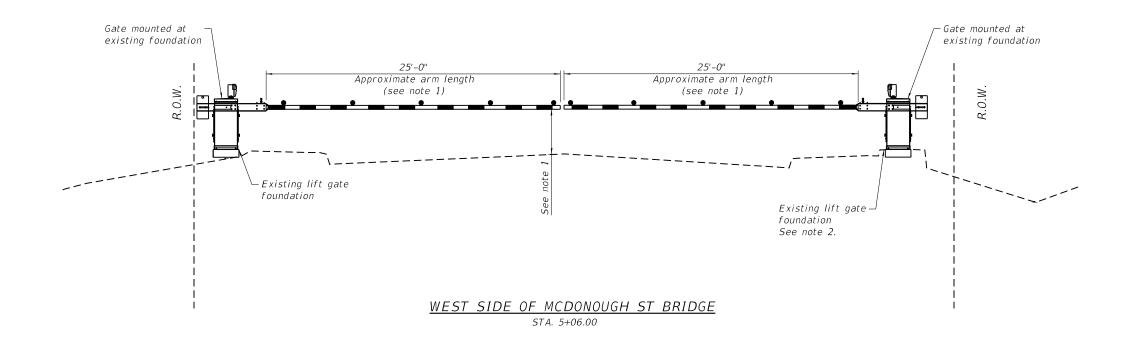

STATE OF ILLINOIS
DEPARTMENT OF TRANSPORTATION

GATE CROSS SECTIONS
STRUCTURE NO. 099-9904
SHEET NO. E-8 OF E-17 SHEETS


<u>NOTES</u>

Contractor shall field verify gate arm length prior


Add grout bedding as needed in field to facilitate both gate arms lining up level with each other. See Sheet 27 for anchor bolt details and notes.

to shop drawing submittal and the final installation shall comply with latest edition of MUTCD.

1/24/2025 2:14:28 PM

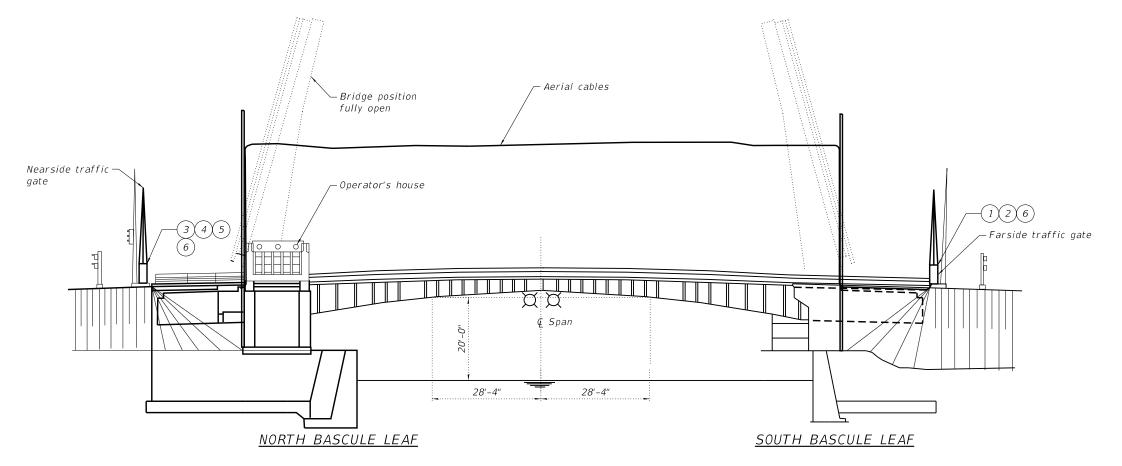

<u>ELEVATION</u>

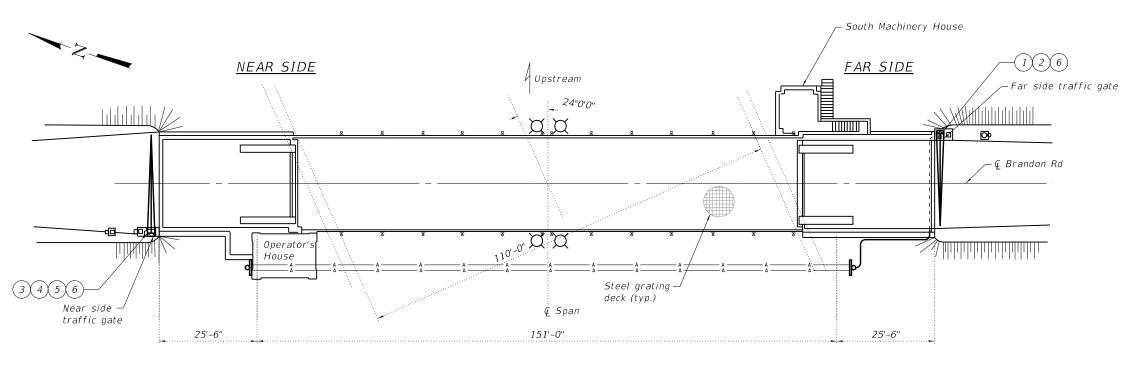

SCOPE OF WORK

- 1 Remove existing far side traffic gate, conductors back to aerial cable connection, and gate foundation.
- 2 Furnish and install new far side traffic gate foundation, traffic gate, and conductors. Reconnect conductors to aerial cable.
- Remove existing near side traffic gate, gate foundation, and conductors back to auxiliary panel connection.
- 4 Furnish and install new near side traffic gate foundation, traffic gate, and conductors. Reconnect conductors to auxiliary panel.
- 5 Contractor to provide a spare gate housing for each bridge in addition to the spare parts listed in the specifications.
- 6 Contractor shall field verify gate arm length prior to shop drawings submittal and the final installation shall comply with latest edition of MUTCD.
- Repair gate foundation. See structural details on sheet 26 of 29.
- 8 Core out existing anchor bolts, then grout and install proposed anchor bolts. See structural details on sheet 26 of 29.

GENERAL NOTES

- All electrical work shall be performed in accordance with the requirements of the National Electric Code (NEC), American Association of State Highway and Transportation Officials (AASHTO), and Manual of Uniform Traffic Control Devices (MUTCD).
- Location of electrical equipment and devices are approximate. Exact locations shall be determined upon approved shop drawings and accurate measured dimensions.

<u>PLAN</u>

WSP 30 N. Suffriction Child Teles

STATE OF ILLINOIS
DEPARTMENT OF TRANSPORTATION

ELECTRICAL PLAN AND ELEVATION STRUCTURE NO. 099-9903 SHEET NO. E-9 OF E-17 SHEETS

<u>SYMBOLS</u>

	Existing conduit or wire
	New conduit or wire
	Field conduit or wire
•	Droop cable
#	AC Motor # = Horsepower
\ \ \	Disconnect Switch Non-fused
	Box/Cabinet JB = Junction box PB = Pull box TB = Termination box
\square	Navigation Light CL = Clearance light
——	Solenoid brake
HAND SWITCH	HES - HS
0-0	Toggle switch

PUSH BUTTON	
0 0	Normally open
ماه	Normally closed
مآه	Mushroom head maintained push button

<u>ABBREVIATIONS</u>

A, AMPS AP	AMPERES AUXIITARY PANFI
C	CONSOLE
CB	CIRCUIT BREAKER
CR	CONTROL RELAY
DISC	DISCONNECT
ES.	FAR SIDE
	FAR SIDE FULLY OPEN
FSF0 FSTGD	FAR SIDE TRAFFIC GATE DOWN
GND	GROUND
HR	HAND RELEASED
IL	INDICATOR LIGHT
LCP	LEAF CONTROL PANEL
LLCBPR	LEAF LOCK CONTROL BYPASS RELAY
LS	LIMIT SWITCH
М	MOTOR
MDP	NEAR SIDE MACHINERY AREA MAIN DISTRIBUTION PANEL
NAV	NAVIGATION
NL	NAVIGATION LIGHTS
NS	NEAR SIDE
NSF0	NEAR SIDE FULLY OPEN
NSTGD	NEAR SIDE TRAFFIC GATE DOWN
OL	OVERLOAD
OPM	OVERLOAD PROTECTION MODULE
P	PULL
PH	PHASE

POSITION (LIMIT) SWITCHES - LS

R

(CR)

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XXX

RELAY CONTACTS

Indicating Light Color

R = Red G = Green

A = Amber B = Blue

CR = Control relay
M = Motor contactor

Normally open contact

Normally closed contact

Aerial cable connection point

Center lock operator

X = Panel or Box XXX = Wire number

Gate operator

Terminal

W = White

Relay Coil


Normally closed
Normally closed held open
Normally open

9 Normally open held closed

Limit switches are shown with bridge down, locks driven and traffic gates up

USER NAME =	DESIGNED	
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PLOT SCALE =	DRAWN	-
PLOT DATE =	CHECKED	-

ELECTRICAL LEGEND AND ABBREVIATIONS STRUCTURE NO. 099-9903	F.A.U. RTE	SECTION	COUNTY	TOTAL SHEETS	
	0341	(1981-082B-I) BR 24	WILL	30	19
311(00101\L 1\0. 033-3303		CONTRACT NO. 62X9			
SHEET NO. E-10 OF E-17 SHEETS	ILLINOIS FED. AID PROJECT				

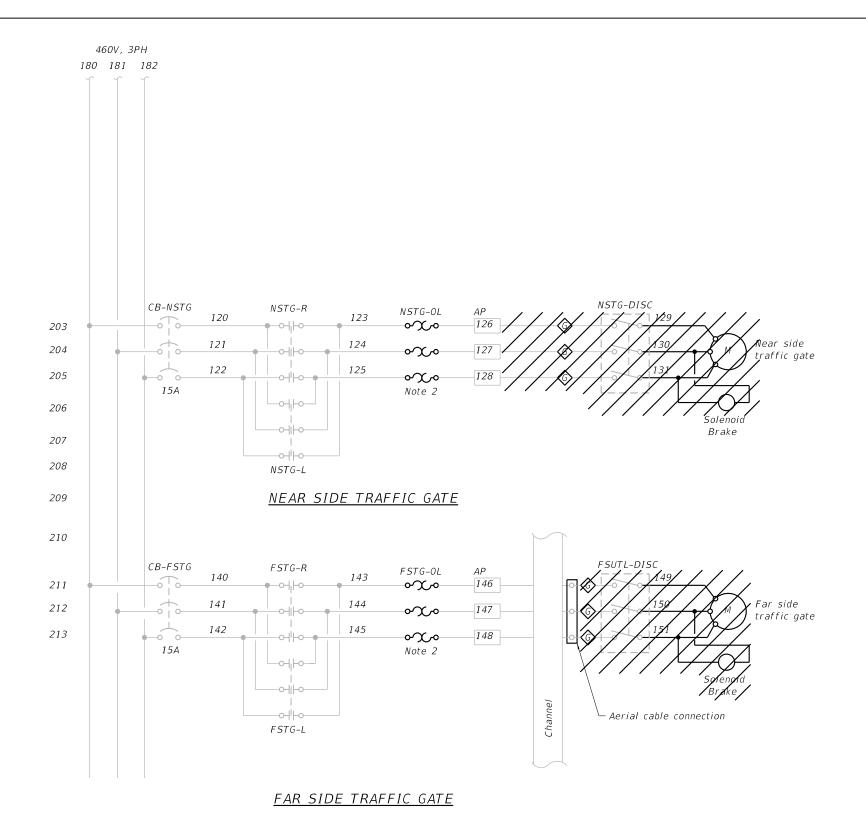


LEGEND

Equipment to be demolished


- 1. Schematic diagrams are from 1990 shop drawing. All pertinent circuits and wire numbers shall be field verified by the contractor before beginning work.
- 2. Replace overload heaters as needed for 125% of nameplate full load current at 480 Va.c.
- 3. Traffic gate disconnect switch (DISC) is integral to the gate enclosure.

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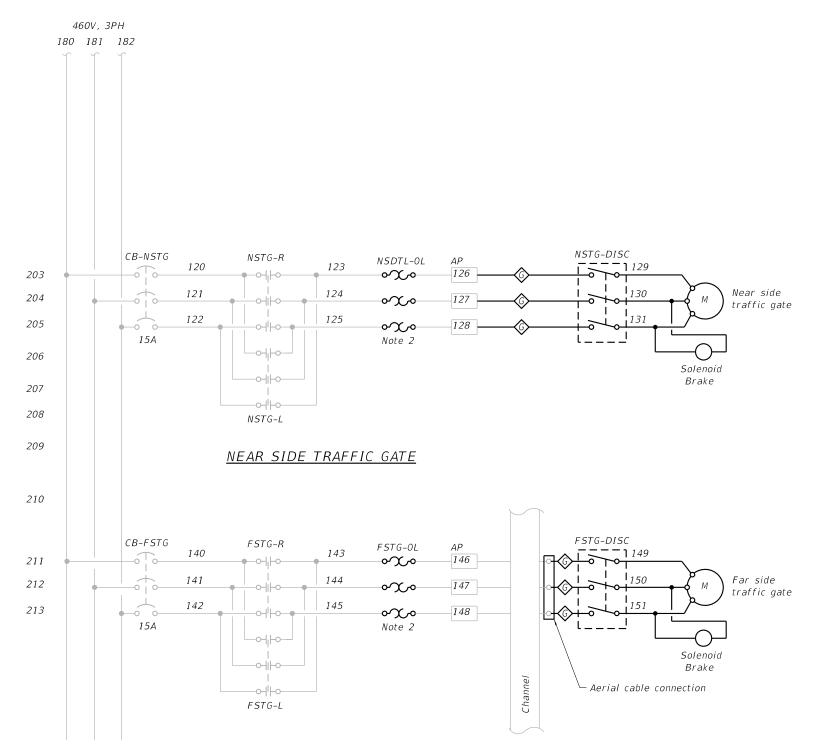
shop drawing. All pertinent circuits and wire numbers shall be field verified by the contractor before beginning work.

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	PLOT DATE =	CHECKED -	ME	REVISED	-

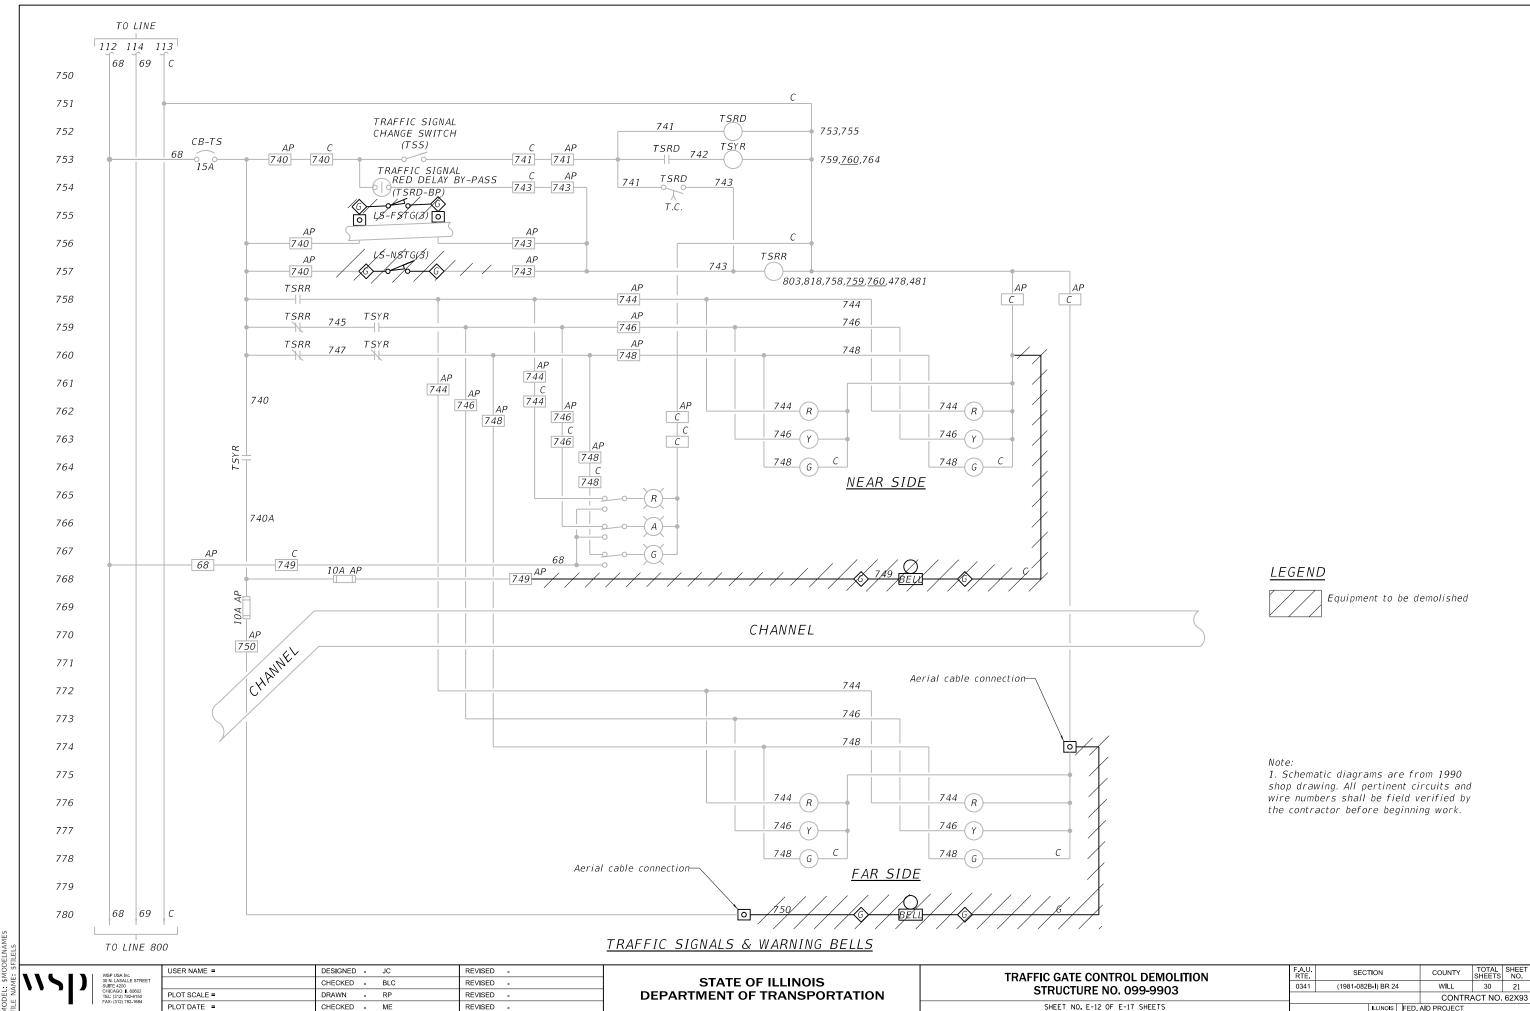STATE OF ILLINOIS
DEPARTMENT OF TRANSPORTATION

TRAFFIC GATE POWER DEMOLITION 2	F.A.U. RTE	SECTION	COUNTY	TOTAL SHEETS	
STRUCTURE NO. 099-9903	0341	(1981-082B-I) BR 24	WILL	30	22
- CINCOTONE NOT 033 3300			CONTRA	ACT NO.	62X93
SHEET NO.E-13 OF E-17 SHEETS		ILLINOIS FE	D. AID PROJECT		

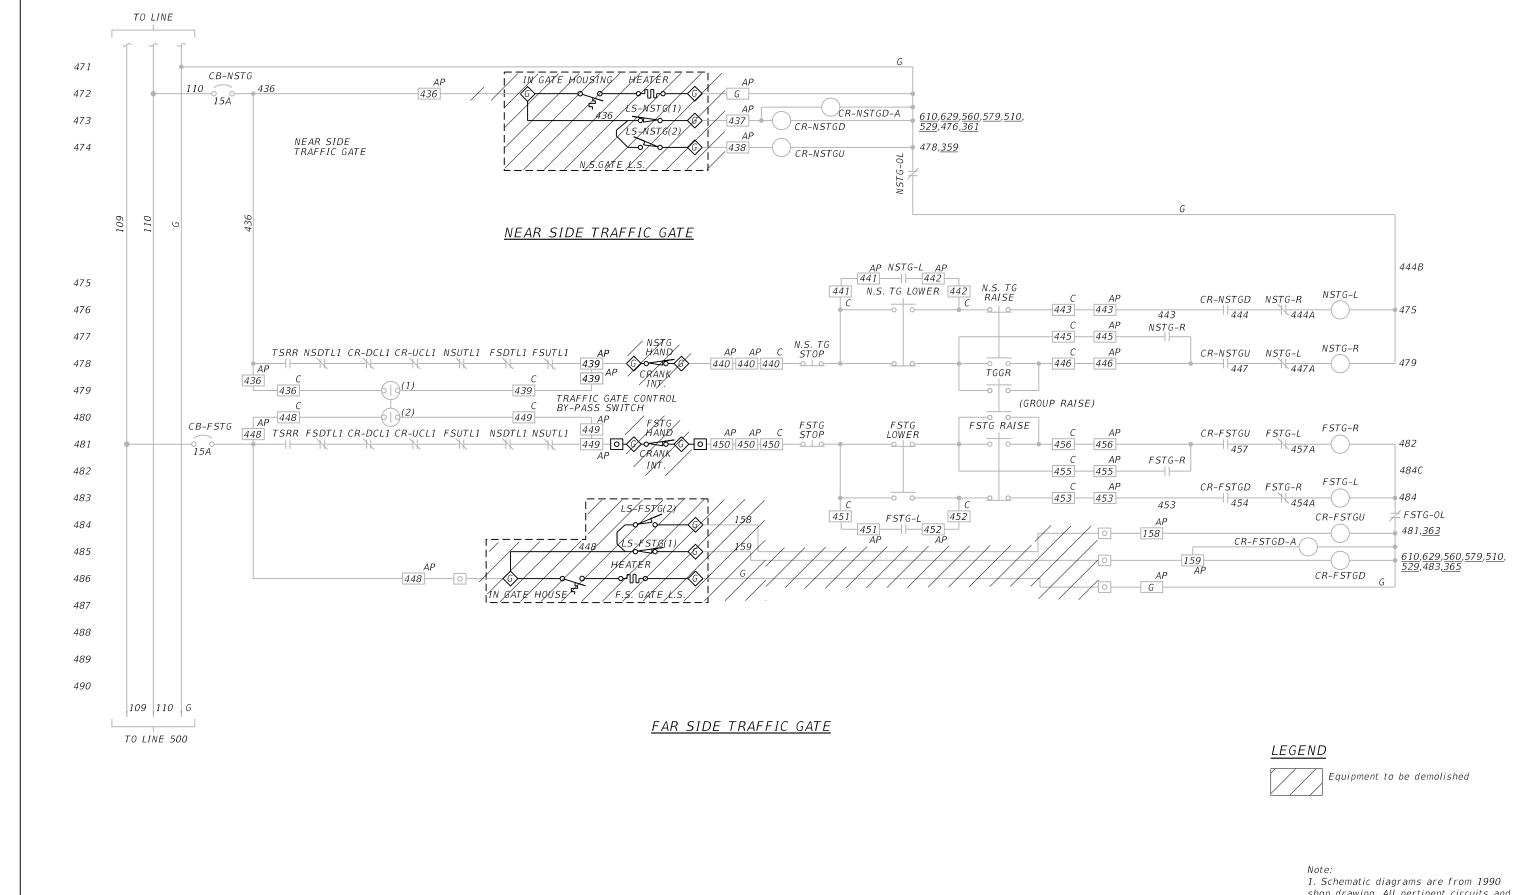

FAR SIDE TRAFFIC GATE


Note:


- 1. Schematic diagrams are from 1990 shop drawing. All pertinent circuits and wire numbers shall be field verified by the contractor before beginning work.
- 2. Replace overload heaters as needed for 125% of nameplate full load current at 480 Va.c.
- 3. Traffic gate disconnect switch (DISC) is integral to the gate enclosure.

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PLOT DATE =	CHECKED -	ME	REVISED -	

TRAFFIC GATE POWER STRUCTURE NO. 099-9903	F.A.U. RTE	SECTION	COUNTY	TOTAL SHEETS	SHEET NO.
	0341	(1981-082B-I) BR 24	WILL	30	23
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SHEET NO E-14 OF E-17 SHEETS		Trumpia EED	AID DDG IEGE		



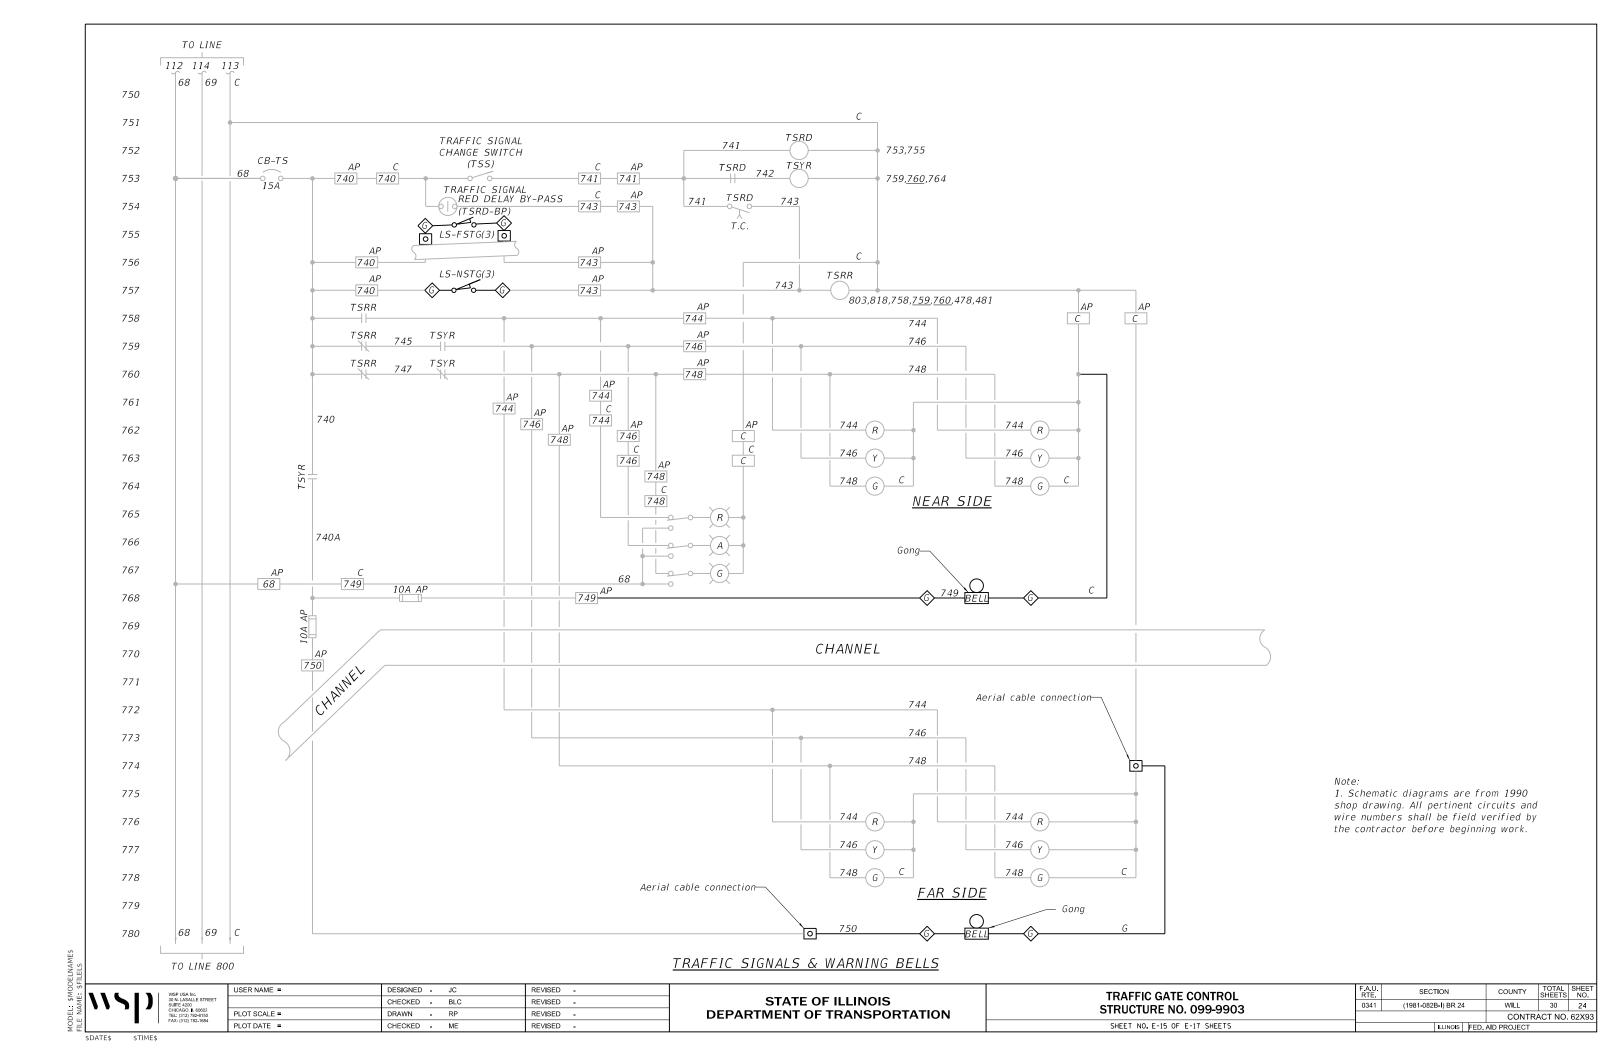

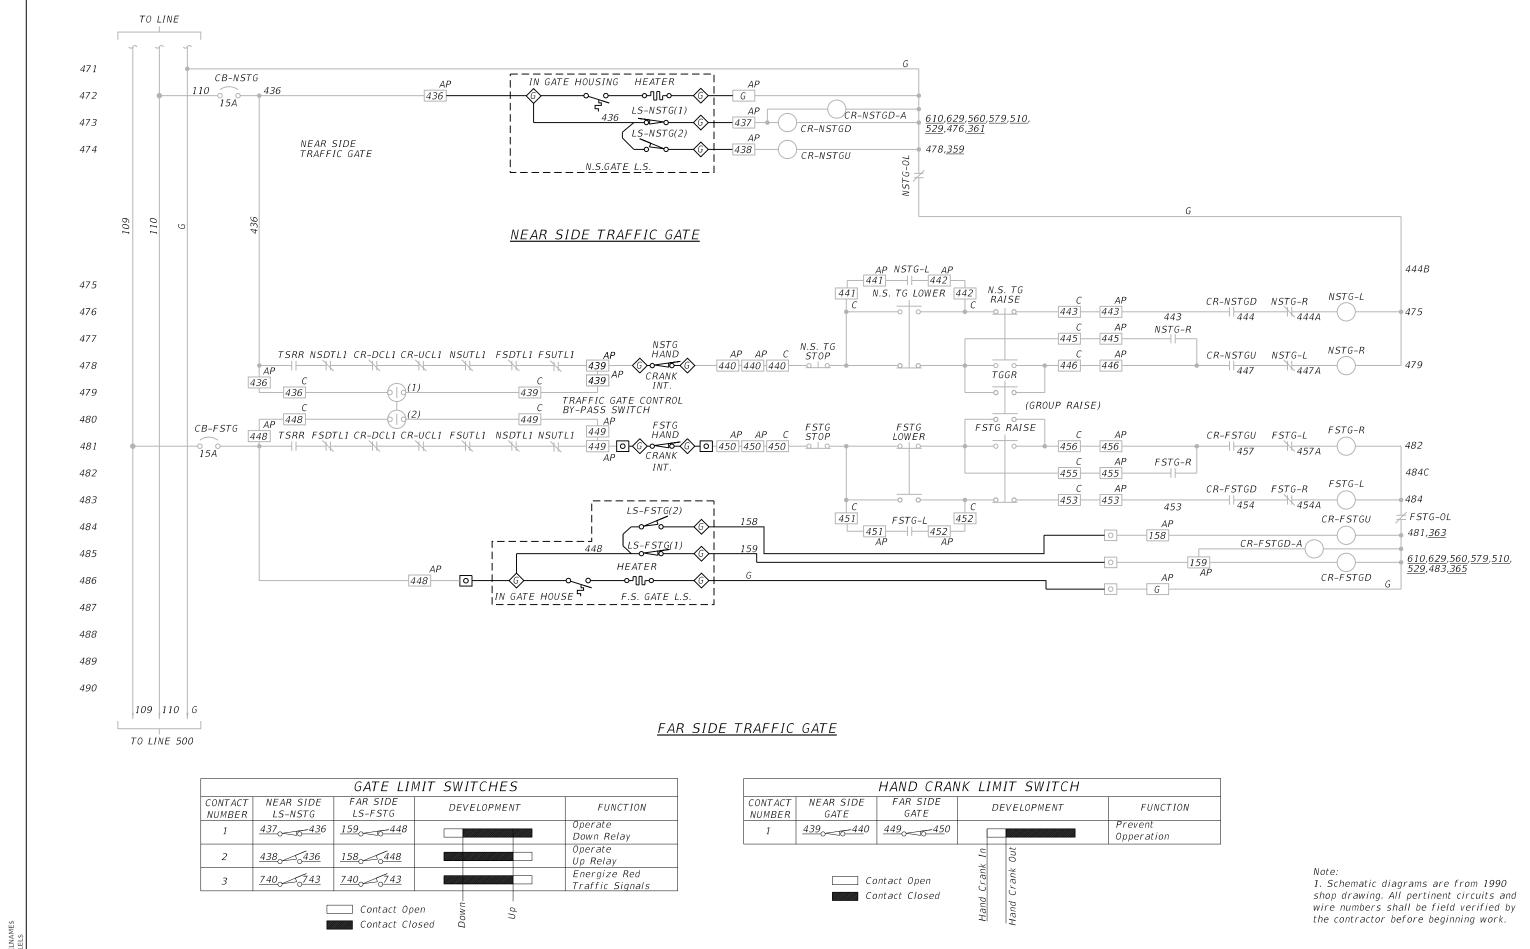
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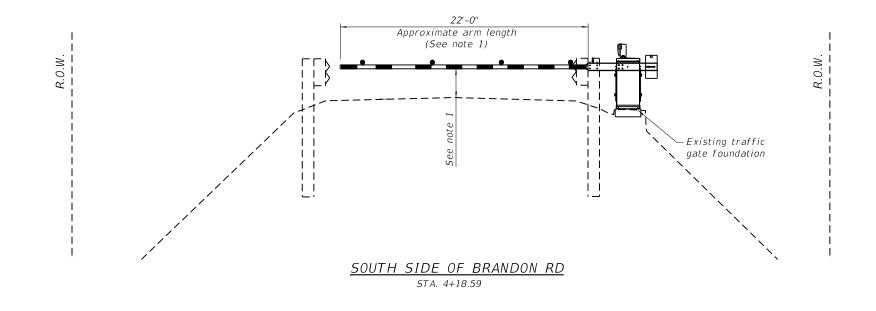
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STATE OF ILLINOIS **DEPARTMENT OF TRANSPORTATION** **TRAFFIC GATE CONTROL 2 STRUCTURE NO. 099-9903** SHEET NO. E-16 OF E-17 SHEETS

SECTION COUNTY 0341 (1981-082B-I) BR 24 WILL 30 25 CONTRACT NO. 62X93



NORTH SIDE OF BRANDON RD STA. 6+33.82

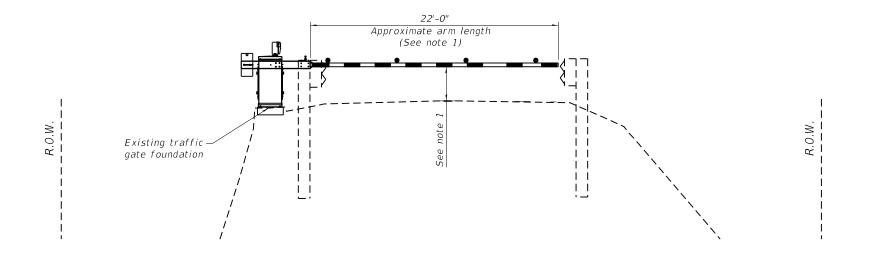

WSP USA Inc. 30 N. I.ASALLE SUITE 4200 CHICAGO II. 61 ETEL (312) 782-FAX: (312) 782-

 USER NAME =
 DESIGNED - JC
 REVISED

 CHECKED - BLC
 REVISED

 PLOT SCALE =
 DRAWN - RP
 REVISED

 PLOT DATE =
 CHECKED - ME
 REVISED

STATE OF ILLINOIS DEPARTMENT OF TRANSPORTATION

GATE CROSS SECTIONS
STRUCTURE NO. 099-9903

SHEET NO. E-17 OF E-17 SHEETS

<u>NOTES</u>

Contractor shall field verify gate arm length prior to shop drawing submittal and the final installation shall comply with latest edition of MUTCD.

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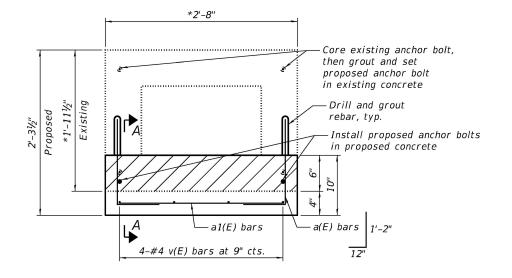
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GENERAL NOTES


- 1. Reinforcement bars designated (E) shall be epoxy coated.
- 2. See sheet 10 for Scope of Work on SN 099-9904, McDonough Street over Des Plaines River and sheet 18 for Scope of Work on SN 099-9903, Brandon Road over Des Plaines River.
- 3. Plan dimensions and details relative to the existing foundations have been taken from a field survey and are subject to nominal construction variations. The Contractor shall field verify existing dimensions and details affecting new construction and make necessary approved adjustments prior to construction or ordering of materials. Such variations shall not be cause for additional compensation for a change in scope of the work, however, the Contractor will be paid for the quantity actually furnished at the unit price bid for the work.
- 4. The proposed anchor bolt layout locations shall be verified in the filed by the Contractor prior to coring out the existing anchor bolts to ensure minimum 2" clearance from edge-of-core to edge-of-concrete. Core holes may be adjusted to accommodate the proposed anchor bolt layout.
- 5. Cost of drilling and grouting reinforcing bars included in cost of Concrete Structures.
- 6. Bars shall be drilled and set according to Article 584 of the Standard Specifications. Bars shall have a minimum 6" embedment depth.
- 7. Cost of coring out the existing anchor bolt and installing grout for the proposed anchor bolts are included in cost of Anchor Bolts, 3/4".
- The grout for the anchor bolts shall be according to Articles 584.03 and 1024.02 of the Standard Specifications.
- 9. Grout bedding and additional anchor bolt length shall be provided to adjust heights of top of foundations at the McDonough Street foundations as needed to facilitate level gate arms adjacent to each another.


TOTAL BILL OF MATERIAL

ITEM	UNIT	TOTAL
Concrete Removal	Cu Yd	0.1
Concrete Structures	Cu Yd	0.2
Reinforcement Bars, Epoxy Coated	Pound	20
Anchor Bolts, 3/4"	Each	24



DETAIL A - PLAN

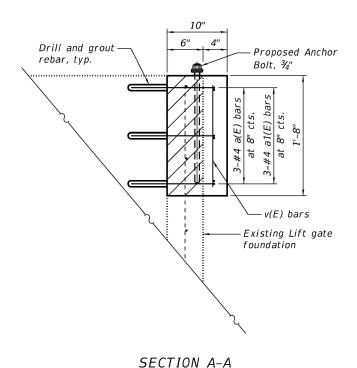

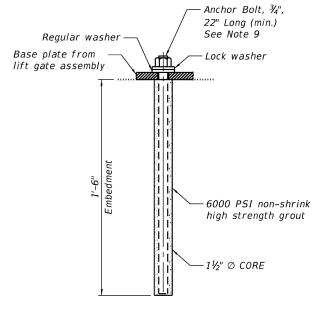

DETAIL B ANCHOR BOLT CORE DETAIL

(6 locations at the Brandon Road Bridge, 16 locations at the McDonough Street Bridge)

LEGEND

* Contractor to verify in the field.





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DESIGNED - MGH REVISED -CHECKED - BJD REVISED DRAWN REVISED CHECKED -B.ID REVISED

STATE OF ILLINOIS DEPARTMENT OF TRANSPORTATION

SECTION COUNTY STRUCTURE PLANS 30 27 (1981-082B-I) BR 24 WILL CONTRACT NO. 62X93 SHEET 1 OF 1 SHEETS



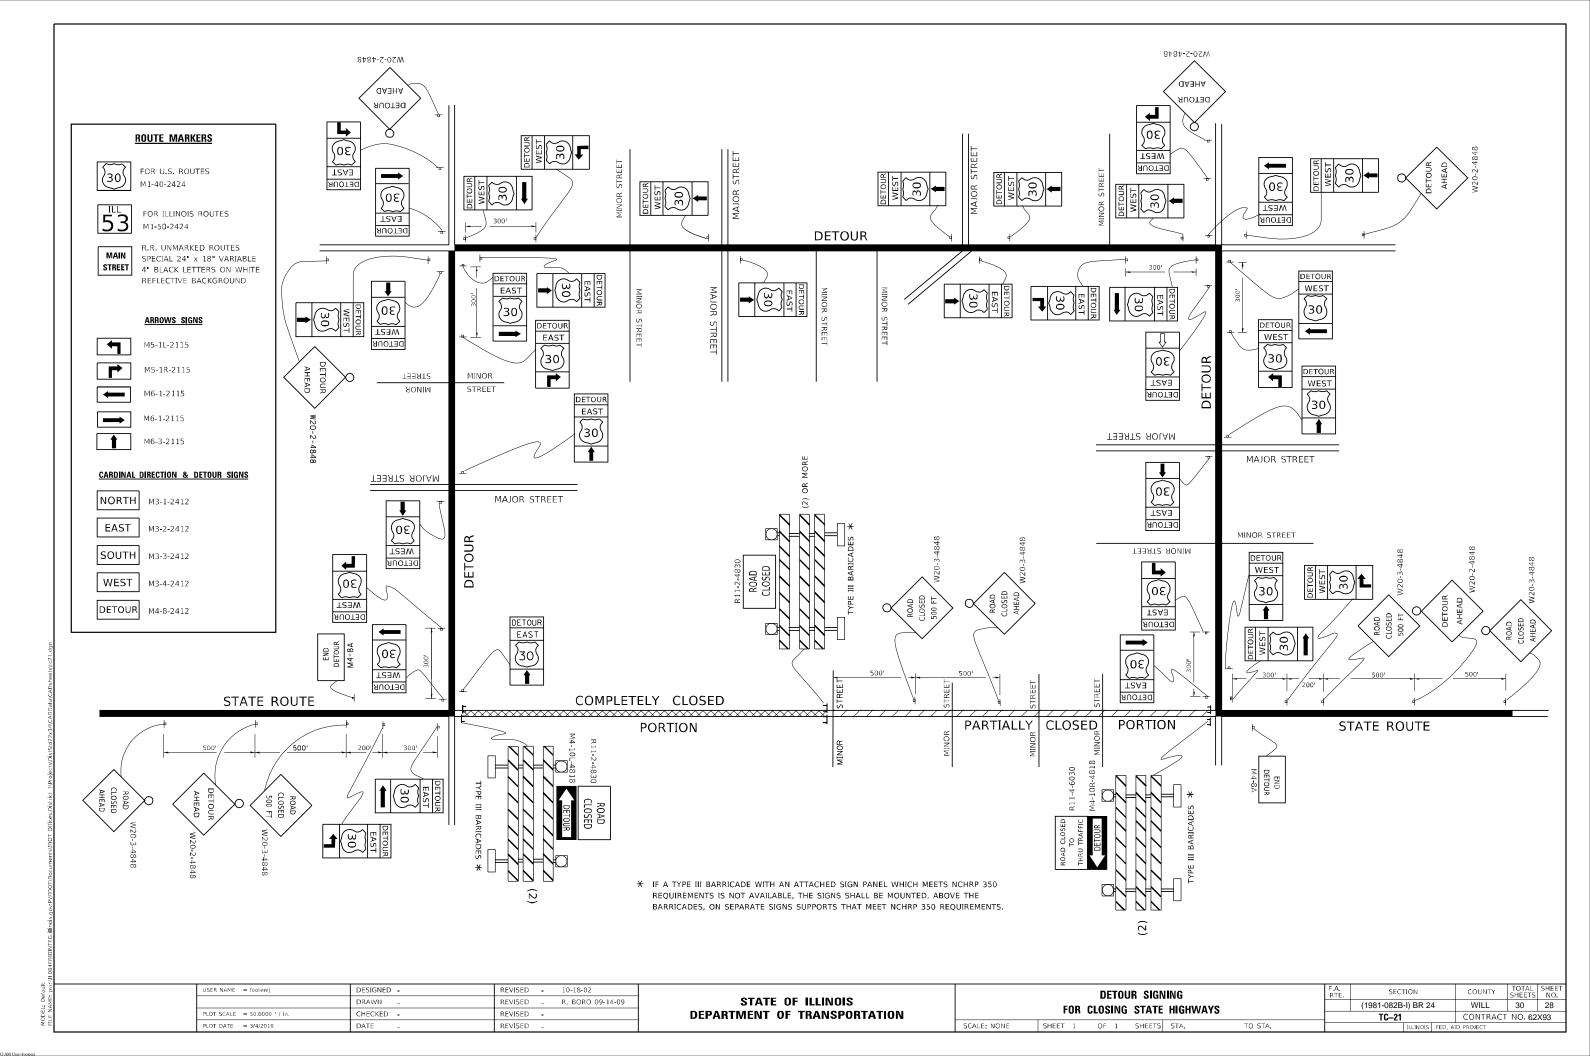

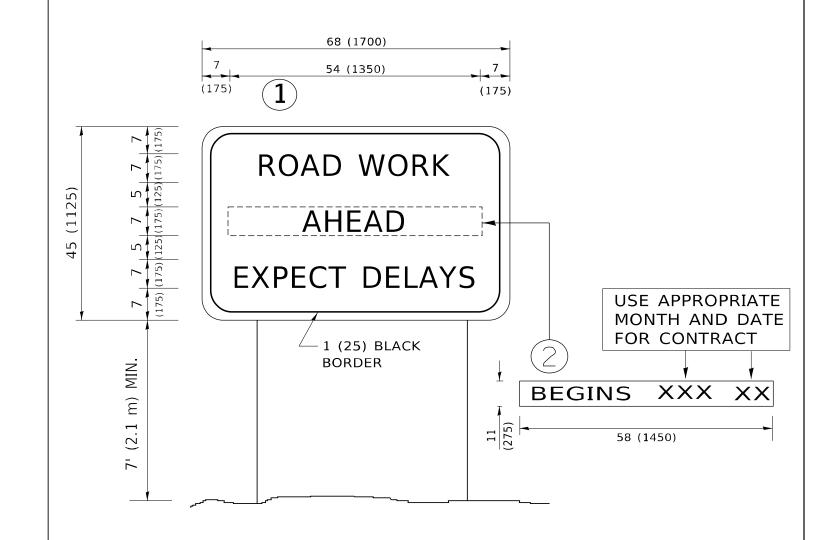NOTES:

- 1. USE BLACK LETTERING ON ORANGE BACKGROUND.
- 2. ERECT SIGNS IN ADVANCE OF THE LOCATION FOR THE "ROAD CONSTRUCTION AHEAD" SIGN AT LOCATIONS AS DIRECTED BY THE ENGINEER.
- 3. ERECT SIGN 1 WITH INSTALLED PANEL 2 ONE WEEK PRIOR TO THE START OF CONSTRUCTION.
- 4. REMOVE PANEL(2)SOON AFTER THE START OF CONSTRUCTION.
- 5. SEE SPECIAL PROVISION FOR "TEMPORARY INFORMATION SIGNING" FOR ADDITIONAL INFORMATION.

SHEET 1

6. ONE SIGN ASSEMBLY EQUALS 25.70 SQ. FT. (2.3 SQ. M.)

SCALE: NONE


7. SHALL BE PAID FOR AS TEMPORARY INFORMATION SIGNING.

ALL DIMENSIONS ARE IN INCHES (MILLIMETERS) UNLESS OTHERWISE SHOWN.

USER NAME = footemj	DESIGNED -	REVISED	 R. MIRS 09-15-97
	DRAWN -	REVISED	- R. MIRS 12-11-97
PLOT SCALE = 50.0000 ' / in.	CHECKED -	REVISED	-T. RAMMACHER 02-02-9
PLOT DATE = 3/4/2019	DATE -	REVISED	- C. JUCIUS 01-31-07

STATE OF ILLINOIS				
DEPARTMENT OF	TRANSPORTATION			

	ARTE	RIAL ROAD		F.A. RTE	SECTION
	INFORK	ATION SIGN			(1981-082B-I) B
	IIVI OIII	MATION SIGN			TC-22
1	OF 1	SHEETS STA.	TO STA.		TLLTN

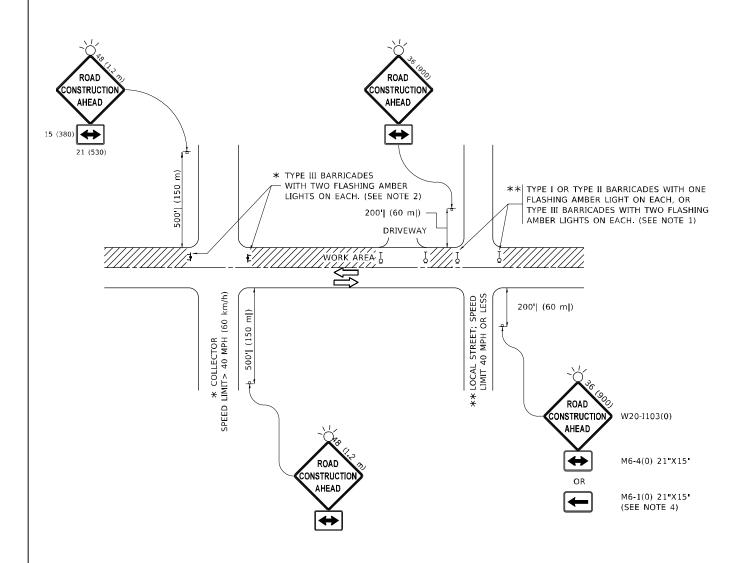

NOTES:

- 1. SIDE ROAD WITH A SPEED LIMIT OF 40 MPH (60 km/h) OR LESS AS SHOWN ON THE DRAWING AND AS DIRECTED BY THE ENGINEER:
- a) ONE "ROAD CONSTRUCTION AHEAD" SIGN 36 x 36 (900x900) WITH A FLASHER MOUNTED ON IT APPROXIMATELY 200' (60 m) IN ADVANCE OF THE MAIN ROUTE.
- b) THE CLOSED PORTION OF THE MAIN ROUTE SHALL BE PROTECTED BY BLOCKING WITH TYPE I, TYPE II OR TYPE III BARRICADES, 1/3 OF THE CROSS SECTION OF THE CLOSED PORTION.
- 2. SIDE ROAD WITH A SPEED LIMIT GREATER THAN 40 MPH (60 km/h) AS SHOWN ON THE DRAWING AND AS DIRECTED BY THE ENGINEER:
- a) ONE "ROAD CONSTRUCTION AHEAD" SIGN 48 x 48 (1.2 m x 1.2 m) WITH A FLASHER MOUNTED ON IT APPROXIMATELY 500' (150 m) IN ADVANCE OF THE MAIN ROUTE.
- THE CLOSED PORTION OF THE MAIN ROUTE SHALL BE PROTECTED BY
 b) BLOCKING WITH TYPE III BARRICADES, 1/2 OF THE CROSS SECTION
 OF THE CLOSED PORTION.
- 3. CONES MAY BE SUBSTITUTED FOR BARRICADES OR DRUMS AT HALF THE SPACING DURING DAY OPERATIONS. CONES SHALL BE A MINIMUM OF 28 (710)

 IN HEIGHT
- WHEN THE SIDE ROAD LIES BETWEEN THE BEGINNING OF THE MAINLINE
 4. SIGNING AND THE WORK ZONE, A SINGLE HEADED ARROW (M6-1) SHALL
 BE USED IN LIEU OF THE DOUBLE HEADED ARROW (M6-4).

SCALE: NONE

- 5. WHEN WORK IS BEING PERFORMED ON A SIDE ROAD OR DRIVEWAY, FOLLOW THE APPLICABLE STANDARD(S). THE DIRECTIONAL ARROW (M6-1 OR M6-4) SHALL BE COVERED OR REMOVED WHEN NO LONGER CONSISTENT WITH THE TRAFFIC CONTROL SET-UP.
- 6. ADVANCE WARNING SIGNS ARE TO BE OMITTED ON DRIVEWAYS UNLESS OTHERWISE SPECIFIED IN THE PLANS OR BY THE ENGINEER
- 7. THE TRAFFIC CONTROL AND PROTECTION FOR SIDE ROADS, INTERSECTIONS, AND DRIVEWAYS SHALL BE INCLUDED IN THE COST OF SPECIFIED TRAFFIC CONTROL STANDARDS OR ITEMS.

All dimensions are in inches (millimeters) unless otherwise shown.

USER NAME = Lawrence.DeManche	DESIGNED L.H.A.	REVISED - T. RAMMACHER 01-06-00
	DRAWN -	REVISED - A. SCHUETZE 07-01-13
PLOT SCALE = 100.0000 / In.	CHECKED -	REVISED - A. SCHUETZE 09-15-16
PLOT DATE = 5/3/2024	DATE - 06-89	REVISED - D. SENDERAK 05-03-24

STATE OF ILLINOIS
DEPARTMENT OF TRANSPORTATION

TRAFFIC CONTROL AND PROTECTION FOR SIDE ROADS, INTERSECTIONS, AND DRIVEWAYS SHEET 1 OF 1 SHEETS STA. TO STA.								
	SHEET	1	OF	1	SHEETS	STA.	TO STA.	

F.A. RTE	SECT	TION	COUNTY	TOTAL SHEETS	SHE	
	(1981-082B	WILL	30	30		
TC-10			CONTRACT	NO. 62	2X93	
		ILLINOIS	FED. A	ID PROJECT		