


<u>PLAN VIEW</u> <u>APPROACH SLAB OR BRIDGE APPROACH SHOULDER</u> (STANDARD 609001 or 609006)

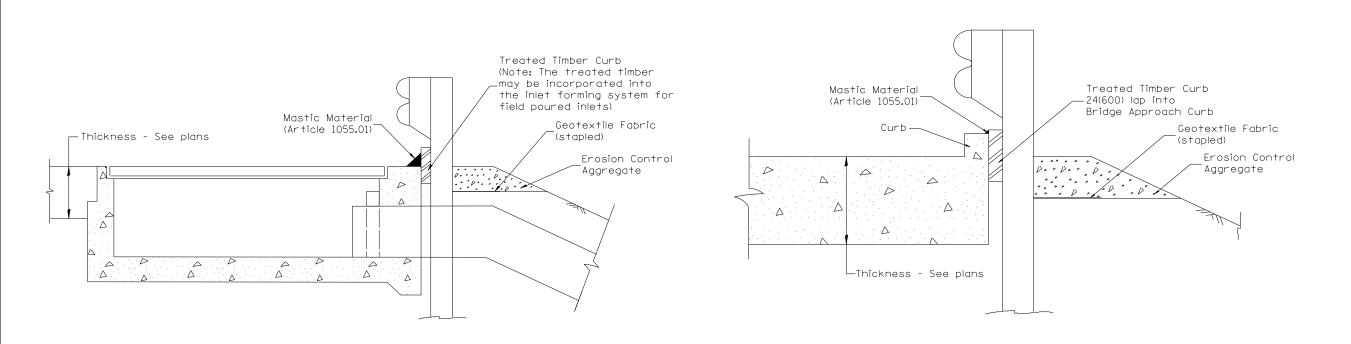

TYPICAL SECTION WITH EROSION CONTROL CURB

AT BRIDGE APPROACH CURB

(STANDARD 609001 OR 609006)

SECTION A-A

GUARDRAIL EROSION CONTROL TREATMENTS

All dimensions are in inches (millimeters) unless otherwise noted.

	US				
LIN ENGINEERING,LTD.					
Consulting Engineers	PI				
Springfield, Illinois	F-				

	USER NAME = \$USER\$	DESIGNED	-		REVISED	-
D.		DRAWN	-		REVISED	-
	PLOT SCALE = \$SCALE\$	CHECKED	-		REVISED	-
	PLOT DATE = \$DATE\$	DATE	-	11/2012	REVISED	-

TYPICAL SECTION WITH EROSION CONTROL CURB

AT INLETS TYPE E & F (STANDARD 610001)

STATE OF ILLINOIS DEPARTMENT OF TRANSPORTATION

DISTRICT 4 STANDARDS				F.A.P. SECTION		COUNTY	TOTAL	SHEET NO.	
IL ROUTE 116					RTE.	(144-B-1)BR	FULTON	48	39
						630101 PAGE 2 OF 2	CONTRACT NO. 68778		
	SCALE: N.T.S. SHEET NO. 5 OF	11 SHEETS	STA.	TO STA.		ILLINOIS FED. A	ID PROJECT		