# 04-26-2024 LETTING ITEM 006

FOR INDEX OF SHEETS, SEE SHEET NO. 2

FOR HIGHWAY STANDARDS, SEE SHEET NO. 2

# **KOSTNER AVENUE**



**POSTED SPEED LIMIT-**25 MPH FUNCTIONAL CLASSIFICATION-LOCAL ROAD

## LECLAIRE AVENUE

POSTED SPEED LIMIT-25 MPH **FUNCTIONAL CLASSIFICATION-**LOCAL ROAD

# **117TH STREET**

=

**SCHAUMBURG** 

щ

CARMEN RAMOS,

ENGINEER:

OGRAM

AID

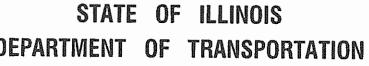
POSTED SPEED LIMIT-25 MPH FUNCTIONAL CLASSIFICATION-

SCALES. P! AN


FULL SIZE PLANS HAVE BEEN PREPARED USING STANDARD ENGINEERING SCALES, REDUCED SIZED PLANS WILL NOT CONFORM TO STANDARD SCALES, IN MAKING MEASUREMENTS ON REDUCED PLANS, THE ABOVE SCALES MAY BE USED.

J. U. L. I. E. JOINT UTILITY LOCATION INFORMATION FOR EXCAVATION 1 - 800 - 892 - 0123 OR 811

# CONTRACT NO. 61K31



# PLANS FOR PROPOSED

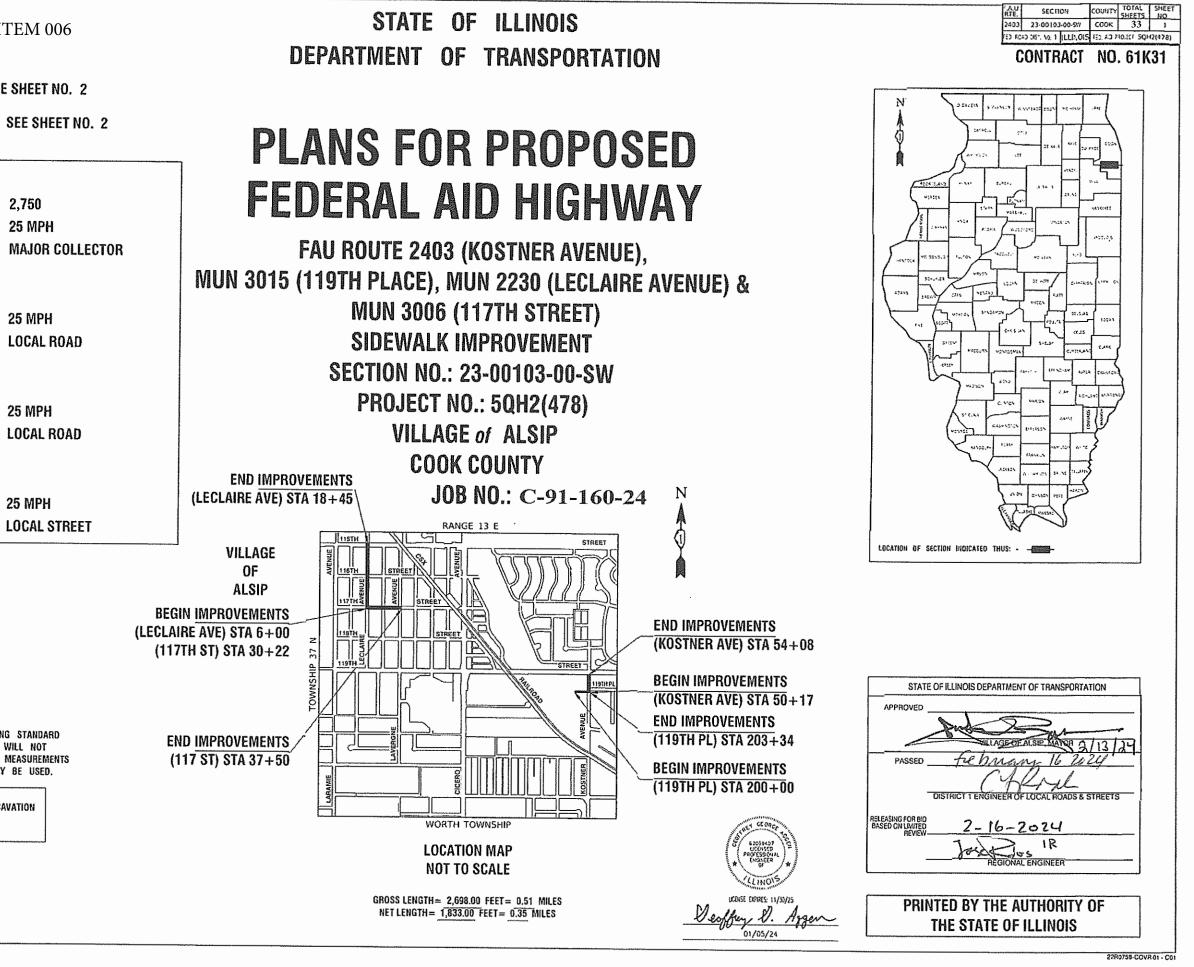

#### **INDEX OF SHEETS**

- COVER SHEET 1
- INDEX OF SHEETS, HIGHWAY STANDARDS AND GENERAL NOTES 2
- 3-6 SUMMARY OF QUANTITIES
- 7 TYPICAL CROSS SECTIONS
- 8 ALIGNMENT, TIES AND BENCHMARKS
- 9-15 PLAN AND PROFILE
- 16 PAVEMENT MARKING, LANDSCAPING, AND EROSION CONTROL
- 17 STORM WATER POLLUTION PREVENTION PLAN
- IDOT DISTRICT ONE STANDARDS 18-20
- 21-33 CROSS SECTIONS

### **HIGHWAY STANDARDS**

000001-08	STANDARD SYMBOLS, ABBREVIATIONS AND PATTERNS
280001-07	TEMPORARY EROSION CONTROL SYSTEMS
424001-11	PERPENDICULAR CURB RAMPS FOR SIDEWALKS
424016-05	MID-BLOCK CURB RAMPS FOR SIDEWALKS
424021-06	DEPRESSED CORNER FOR SIDEWALKS
442201-03	CLASS C AND D PATCHES
606001-08	CONCRETE CURB TYPE B AND COMBINATION CONCRETE CURB AND GUTTER
701001-02	OFF ROAD OPERATIONS, 2L, 2W, MORE THAN 15'(4.5m) AWAY
701006-05	OFF ROAD OPERATIONS, 2L, 2W, 15'(4.5m) TO 24"(600mm) FROM PAVEMENT EDGE
701011-04	OFF ROAD MOVING OPERATIONS, 2L,2W, DAY ONLY
701101-05	OFF ROAD OPERATIONS, MULTILANE, 15'(4.5m) TO 24"(600mm) FROM PAVEMENT EDGE
701301-04	LANE CLOSURE, 2L, 2W, SHORT TIME OPERATIONS
701311-03	LANE CLOSURE, 2L, 2W, MOVING OPERATIONS - DAY ONLY
701427-05	LANE CLOSURE, MULTILANE, INTERMITTENT OR MOVING OPER., FOR SPEEDS $\leq$ 40 MPH
701501-06	URBAN LANE CLOSURE, 2L, 2W, UNDIVIDED
701606-10	URBAN SINGLE LANE CLOSURE, MULTILANE, 2W WITH MOUNTABLE MEDIAN
701801-06	SIDEWALK, CORNER OR CROSSWALK CLOSURE
701901-09	TRAFFIC CONTROL DEVICES
780001-05	TYPICAL PAVEMENT MARKINGS

#### DISTRICT ONE DETAILS

- PAVEMENT PATCHING FOR HMA SURFACED PAVEMENT BD-22
- TC-10 TRAFFIC CONTROL AND PROTECTION FOR SIDE ROADS, INTERSECTIONS AND DRIVEWAYS
- TC-13 TYPICAL PAVEMENT MARKINGS

#### **GENERAL NOTES**

- 1. ITEMS OF WORK LISTED IN THE SUMMARY OF QUANTITIES NOT SPECIFICALLY CALLED OUT ON THE PLANS SHALL BE PERFORMED AS DIRECTED BY THE ENGINEER.
- 2. THE ROBINSON ENGINEERING, LTD. FIELD OFFICE (708-331-6700), AND THE PUBLIC WORKS DIRECTOR, AT THE VILLAGE OF ALSIP (708-385-6902), SHALL BE NOTIFIED THREE (3) WORKING DAYS BEFORE CONSTRUCTION BEGINS.
- 3. BEFORE STARTING ANY EXCAVATION THE CONTRACTOR SHALL CALL "J.U.L.I.E." AT (800) 892-0123 OR 811 AND (312) 744-7000 FOR FIELD LOCATIONS OF BURIED ELECTRIC, TELEPHONE AND GAS UTILITIES. (48 HOUR NOTIFICATION REQUIRED)
- 4. UTILITIES INDICATED ON THE PLANS ARE PROVIDED FOR THE CONTRACTOR'S USE AND ARE BASED UPON INFORMATION AVAILABLE AT THE TIME OF THE ADVERTISEMENT FOR BIDS. THE OWNER AND ENGINEER DO NOT GUARANTEE THE ACCURACY OF UTILITY INFORMATION.
- 5. IT SHALL BE THE CONTRACTOR'S RESPONSIBILITY TO VERIFY ALL DIMENSIONS AND CONDITIONS EXISTING IN THE FIELD PRIOR TO CONSTRUCTION AND ORDERING OF MATERIALS.
- 6. ANY LOOSE MATERIAL DEPOSITED IN THE FLOW LINE OF DITCHES, GUTTERS OR OTHER DRAINAGE STRUCTURES SHALL BE REMOVED BY THE END OF EACH DAY BY THE CONTRACTOR.
- 7. CONTRACTOR SHALL TAKE PRECAUTION BY PRESERVING EXISTING TREES WITHIN THE RIGHT OF WAY. IF ANY DAMAGE OCCURS, TREES SHALL BE REPLACED IN KIND PER ARTICLE 201.07 REPAIR OR REPLACEMENT OF EXISTING PLANT MATERIAL REQUIREMENTS STATED HEREIN.
- 8. NO PAVEMENT PATCHING SHALL BE PERMITTED AFTER FRIDAY AT 3:00 PM OF EACH AND EVERY WEEK AND NO HOLES WILL BE ALLOWED TO REMAIN OPEN OVERNIGHT OR OVER THE WEEKEND.
- 9. ALL EQUIPMENT SHALL BE REMOVED OFF THE VILLAGE STREETS DURING ALL HOLIDAY WEEKENDS AS COORDINATED WITH THE VILLAGE.
- 10. AGGREGATE SUBGRADE IMPROVEMENT (CU YD) HAS BEEN PROVIDED FOR USE AT THE LOCATIONS INDICATED FOR SOILS THAT TEND TO BE UNSTABLE AND/OR UNSUITABLE. THE ACTUAL NEED FOR REMOVAL AND REPLACEMENT WITH ABOVE ITEM WILL BE DETERMINED IN THE FIELD AT THE TIME OF CONSTRUCTION BY THE GEOTECHNICAL ENGINEER. ALL POTENTIALLY UNSTABLE SOILS SHOULD BE TESTED WITH A STATIC OR DYNAMIC CONE PENETROMETER AND TREATED IN ACCORDANCE WITH ARTICLE 301.04 OF THE SSRBC AND IDOT SUBGRADE STABILITY MANUAL. IF UNSTABLE AND/OR UNSUITABLE SOILS ARE NOT ENCOUNTERED, THEN THE QUANTITY SHALL BE DEDUCTED AND NO ADDITIONAL COMPENSATION WILL BE DUE TO THE CONTRACTOR.

#### COMMITMENTS

NONE

FILE NAME	= 22R0758-INDX-01 - P01	USER NAME =	DESIGNED — MG	REVISED —			ALSIP			F.A.U BTE	SECTION	COUNTY	TOTAL	SHEET NO
			CHECKED - WPD	REVISED —	STATE OF ILLINOIS	SAFE ROUTES TO SCHOOL SIDEWALK INDEX OF SHEETS, STATE STANDARDS & GENERAL NOTES			2403	23-00103-00-SW	соок	33	2	
		PLOT SCALE =	DRAWN — KWM	REVISED —	DEPARTMENT OF TRANSPORTATION			NOTES			CONTRACT	NO. 61K		
		PLOT DATE = 01/05/24	CHECKED — AG	REVISED —		SCALE: NONE	SHEET NO. 2 OF 33 SHEETS	STA. TO	STA.	FED. ROAD D	IST. NO. 1 ILLINOIS	FED. AID PROJECT 5QH2	2(478)	

			_	FED 80%	FED 80%
				VILLAGE 20%	VILLAGE 20%
				ROADWAY	SAFETY
CODE NO.	PAYITEM	UNIT	TOTAL QUANTITY	CONSTRUCTIO	IN TYPE CODE
CODE NO.		UNIT	TOTAL QUANTIT	0021	0021
20101100	TREE TRUNK PROTECTION	EACH	11	11	
		54014			
20101200	TREE ROOT PRUNING	EACH	8	8	
20101350	TREE PRUNING (OVER 10 INCH DIAMETER)	EACH	2	2	
20101400	NITROGEN FERTILLIZER NUTRIENT	POUND	68	68	
20101500	PHOSPHORUS FERTILLIZER NUTRIENT	POUND	68	68	
20101600	POTASSIUM FERTILLIZER NUTRIENT	POUND	68	68	
20101700	SUPPLEMENTAL WATERING	UNIT	1	1	
20201200	REMOVAL AND DISPOSAL OF UNSUITABLE MATERIAL	CU YD	15	15	
20800150	TRENCH BACKFILL	CU YD	16	16	
28100105	STONE RIPRAP, CLASS A3	SQ YD	5	5	
21101615	TOPSOIL FURNISH AND PLACE, 4"	SQ YD	2910	2910	
21400100	GRADING AND SHAPING DITCHES	FOOT	800	800	
25100630	EROSION CONTROL BLANKET	SQ YD	2910	2910	
28000305	TEMPORARY DITCH CHECKS	FOOT	60	60	
28000400	PERIMETER EROSION BARRIER	FOOT	300	300	

\* SPECIALTY ITEM

FILE NAME = 2280758-QUAN-01 - P01	USER NAME =	DESIGNED MG	REVISED		ALSIP	F.A.U SECTION COUNTY TOTAL SHEET
		CHECKED — GA	REVISED -	STATE OF ILLINOIS	SAFE ROUTES TO SCHOOL SIDEWALK	2403 23-00103-00-SW COOK 32 3
	PLOT SCALE =	DRAWN - KWM	REVISED	DEPARTMENT OF TRANSPORTATION	SUMMARY OF QUANTITIES	CONTRACT NO. 61K31
	PLOT DATE = 01/05/24	CHECKED - AG	REVISED -		SCALE: NONE SHEET NO. 3 OF 32 SHEETS STA. TO STA.	FED. ROAD DIST. NO. 1 ILUNOIS FED. AID PROJECT 50H2(478)

				FED 80%	FED 80%	
				VILLAGE 20%	VILLAGE 20%	
				ROADWAY	SAFETY	
CODE NO.	PAYITEM	UNIT	TOTAL QUANTITY	CONSTRUCTION TYPE COL		
				0021	0021	
28000510	INLET FILTERS	EACH	17	17		
20200004						
30300001	AGGREGATE SUBGRADE IMPROVEMENT	CU YD	15	15		
35101600	AGGREGATE BASE COURSE, TYPE B 4"	SQ YD	1110	1110		
40201000	AGGREGATE FOR TEMPORARY ACCESS	TON	15	15		
42300300	PORTLAND CEMENT CONCRETE DRIVEWAY PAVEMENT, 7 INCH	SQ YD	96	96		
42400200	PORTLAND CEMENT CONCRTE SIDEWALK 5 INCH	SQ FT	10000		10000	
42400800	DETECTABLE WARNINGS					
42400000		SQ FT	305		305	
44000200	DRIVEWAY PAVEMENT REMOVAL	SQ YD	125	125		
44000500	COMBINATION CURB AND GUTTER REMOVAL	FOOT	85	85		
44000600	SIDEWALK REMOVAL	SQ FT	1535		1535	
542D0217	PIPE CULVERTS, CLASS D, TYPE 1 12"				<u> </u>	
J72DU217		FOOT	10	10		
54262712	METAL FLARED END SECTIONS 12"	EACH	2	2		
550A0040	STORM SEWERS, CLASS A, TYPE 1 10"	FOOT	41	41		
60236200	INLETS, TYPE A, TYPE 8 GRATE	EACH	1	1		

\* SPECIALTY ITEM

FILE NAME = 22R0758-QUAN-01 - P02	USER NAME =	DESIGNED MG	REVISED -		ALSIP	FAU SECTION	COUNTY TOTAL SHEET
		CHECKED - GA	REVISED	STATE OF ILLINOIS	SAFE ROUTES TO SCHOOL SIDEWALK		COOK 32 4
	PLOT SCALE =	DRAWN KWM	REVISED -	DEPARTMENT OF TRANSPORTATION	SUMMARY OF QUANTITIES		ONTRACT NO. 61K31
	PLOT DATE = 01/05/24	CHECKED - AG	REVISED		SCALE: NONE SHEET NO. 4 OF 32 SHEETS STA. TO STA.		OJECT 50H2(478)

				FED 80% VILLAGE 20% ROADWAY	FED 80% VILLAGE 20° SAFETY
CODE NO.	PAY ITEM			CONSTRUCTIO	ON TYPE CODE
		UNIT	TOTAL QUANTITY	0005	0021
60266600	VALVE BOXES TO BE ADJUSTED	EACH	1	1	
60608562	COMBINATION CONCRETE CURB AND GUTTER, TYPE M-4.12	FOOT	85	85	
67100100	MOBILIZATION	L SUM	1	1	
				1	
70102620	TRAFFIC CONTROL AND PROTECTION, STANDARD 701501	L SUM			
			1		1
70102625	TRAFFIC CONTROL AND PROTECTION, STANDARD 701606			·	
70102023	TRAFTIC CONTROL AND PROTECTION, STANDARD 701606	L SUM	1		1
70102640					
70102840	TRAFFIC CONTROL AND PROTECTION, STANDARD 701801	L SUM	1		1
72400500	RELOCATE SIGN PANEL ASSEMBLY - TYPE A	EACH	2		2
78000600	THERMOPLASTIC PAVEMENT MARKING - LINE 12"	FOOT	880		880
78000650	THERMOPLASTIC PAVEMENT MARKING - LINE 24"	FOOT	65		65
X2020410	EARTH EXCAVATION (SPECIAL)	CU YD	411	411	
X2500920	SEEDING, CLASS 1A (SPECIAL)	ACRE	0.75	0.75	
X5427602	REMOVE EXISTING FLARED END SECTION	EACH	2	2	
X5510010	STORM SEWER CONNECTION	EACH	2	2	

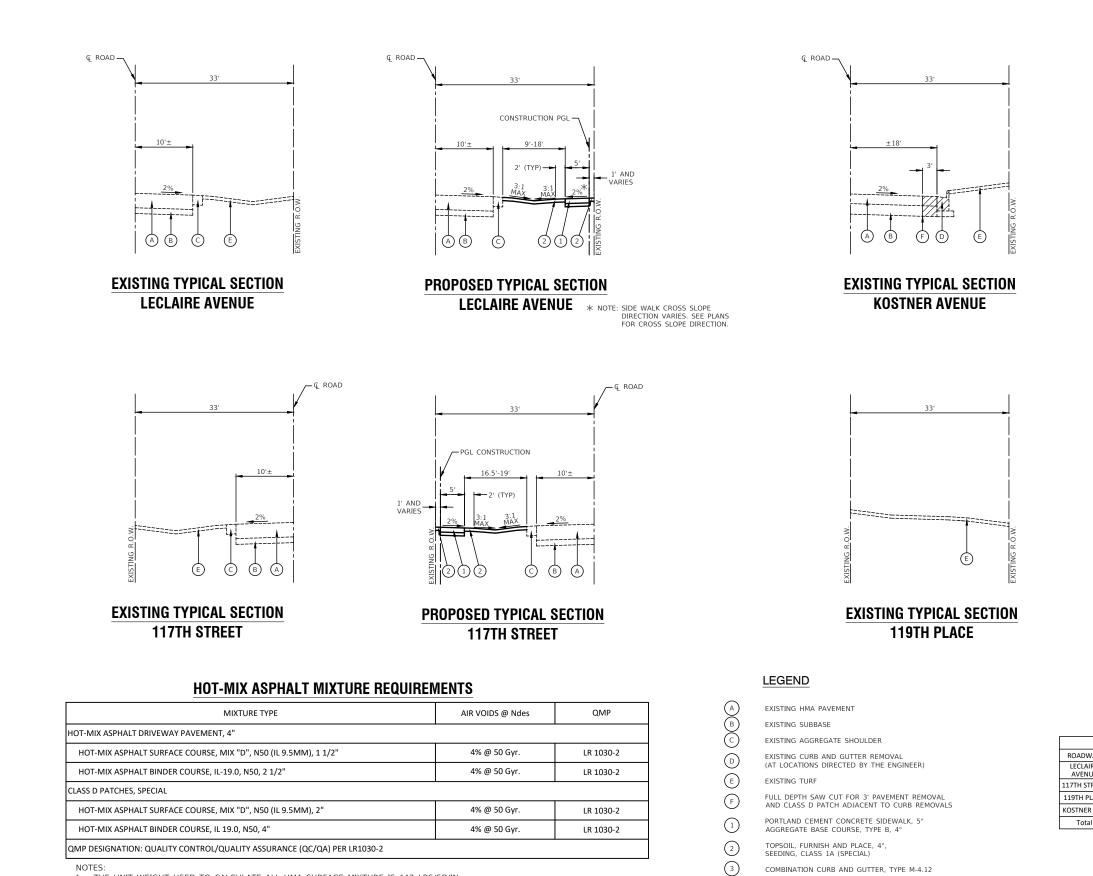
\*SPECIALITY ITEM

FILE NAME = 22R0758-QUAN-01 - P03	USER NAME =	DESIGNED MG	REVISED -		ALSIP	F.A.U SECTION COUNTY TOTAL SHEET
		CHECKED - GA	REVISED -	STATE OF ILLINOIS	SAFE ROUTES TO SCHOOL SIDEWALK	HIE.         SHEETS         NO.           2403         23-00103-00-SW         COOK         33         5
	PLOT SCALE =	DRAWN KWM	REVISED	DEPARTMENT OF TRANSPORTATION	SUMMARY OF QUANTITIES	CONTRACT NO. 61K31
	PLOT DATE == 01/05/24	CHECKED - AG	REVISED -		SCALE: NONE SHEET NO. 5 OF 33 SHEETS STA. TO STA.	FED. ROAD DIST. NO. 1 ILLINOIS FED. AID PROJECT 5QH2(478)

				FED 80%	FED 80%
				VILLAGE 20%	VILLAGE 20%
				ROADWAY	SAFETY
CODE NO.	PAYITEM	UNIT	TOTAL QUANTITY	CONSTRUCTI	ON TYPE CODE
CODE NO.				0021	0021
XX004774	BRICK DRIVEWAY REMOVAL AND REPLACEMENT	SQ FT	37	37	
XX009224	CLASS D PATCHES, SPECIAL	SQ YĐ	35	35	
Z0004514	HOT-MIX ASPHALT DRIVEWAY PAVEMENT, 4"	SQ YD	175	175	
Z0004544	HOT-MIX ASPHALT DRIVEWAY PAVEMENT REMOVAL	SQ YD	175	175	
Z0017400	DRAINAGE & UTILITY STRUCTURES TO BE ADJUSTED	EACH	6	6	
Z0017700	DRAINAGE & UTILITY STRUCTURE TO BE RECONSTRUCTED	EACH	1	1	

\* SPECIALTY ITEM

FILE NAME = 22R0758-QUAN-01 - P04	USER NAME #	DESIGNED - MG	REVISED -		ALSIP SAFE ROUTES TO SCHOOL SIDEWALK		F.A.U SECTION COUNTY TOTAL SHEET BTE SHEETS NO.
		CHECKED GA	REVISED	STATE OF ILLINOIS			2403 23-00103-00-SW COOK 32 6
	PLOT SCALE -	DRAWN - KWM	REVISED -	DEPARTMENT OF TRANSPORTATION		SUMMARY OF QUANTITIES	CONTRACT NO. 61K31
	PLOT DATE = 01/05/24	CHECKED - AG	REVISED -		SCALE: NONE	SHEET NO. 6 OF 32 SHEETS STA. TO STA.	FED, ROAD DIST, NO. 1 ILLINOIS FED, AID PROJECT 5QH2(478)



NOTES

USER NAME =

PLOT SCALE =

PLOT DATE = 01/05/24

FILE NAME = 22R0758-TYPX-01 - TYPX01

1. THE UNIT WEIGHT USED TO CALCULATE ALL HMA SURFACE MIXTURE IS 112 LBS/SQ/IN.

2. THE "AC TYPE" FOR POLYMERIZED HMA MIXES SHALL BE "SBS/SBR PG 76-22" AND FOR NON-POLYMERIZED HMA THE "AC TYPE" SHALL BE "PG-64-22" UNLESS MODIFIED BY RECLAIMED MATERIALS SPECIFICATIONS.

DRAWN

DESIGNED - MG

CHECKED - GA

CHECKED - AG

— KWM

BEVISED - ##


REVISED - ## ALSIP STATE OF ILLINOIS REVISED - ## SAFE ROUTES TO SCH TYPICAL CROSS S REVISED - ## DEPARTMENT OF TRANSPORTATION

(4)


COMBINATION CURB AND GUTTER, TYPE M-4.12

CLASS D PATCHES, SPECIAL (AS DIRECTED BY THE ENGINEER)

	11	FICAL	00000	`
SCALE: NONE	SHEET NO. 7	OF 33	SHEETS	

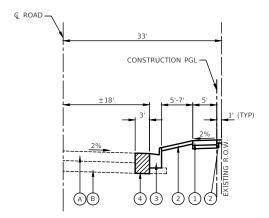


# **PROPOSED TYPICAL SECTION KOSTNER AVENUE**

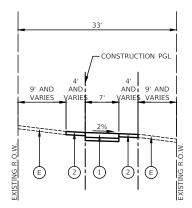


# **PROPOSED TYPICAL SECTION 119TH PLACE**

	EARTHWORK TABLE										
VAY	CUT (CU YD)	FILL (CU YD)	NET CUT (CU YD)								
IRE UE	178	0	178								
TREET	90	0	90								
LACE	63	3	60								
R AVE	80	0	80								
al	411	3	408								

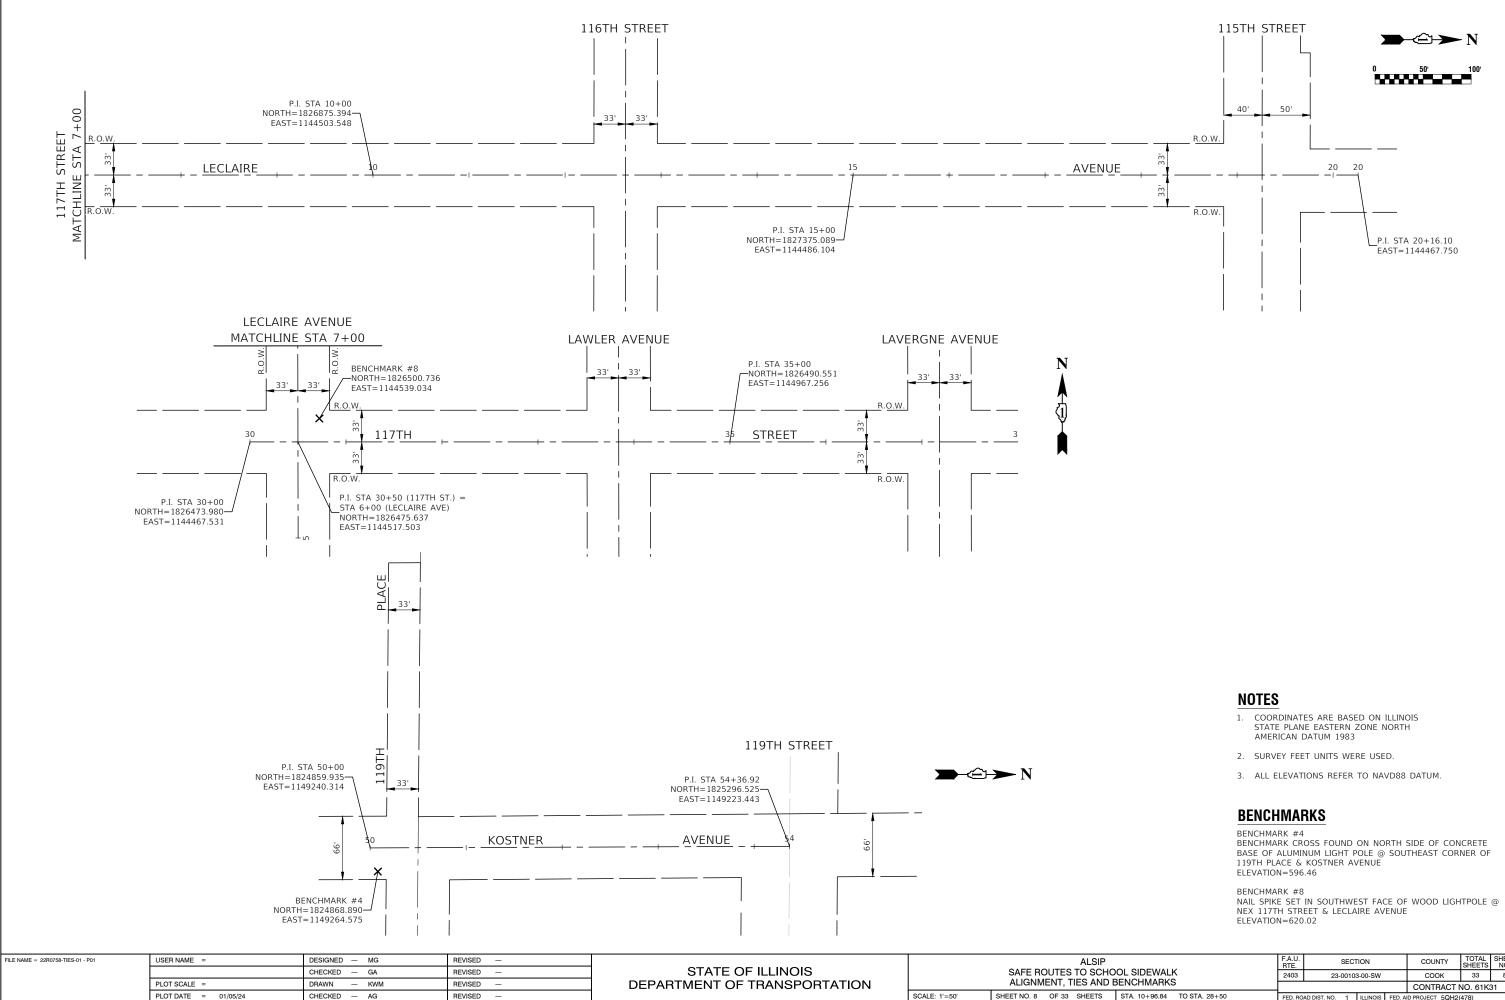
			F.A.# RTE.	SECT	ΓΙΟΝ		COUNTY	TOTAL SHEETS	SHEET NO.
	OL SIDEV	VALK	2403	23-0010	33	7			
SE	CTIONS						CONTRACT I	NO. 61K	31
	STA.	TO STA.	FED. RC	DAD DIST. NO. 1	ILLINOIS	FED. A	D PROJECT 5QH2	(478)	




 		F.A.U. RTE.	SECT	ION		COUNTY	TOTAL SHEETS	SHEET NO.
 OL SIDEWALK	-	2403	23-00103	COOK	33	8		
BENCHMARKS						CONTRACT	NO. 61K	31
STA. 10+96.84	TO STA. 28+50	FED. RO	AD DIST. NO. 1	ILLINOIS	FED. A	D PROJECT 5QH2	478)	

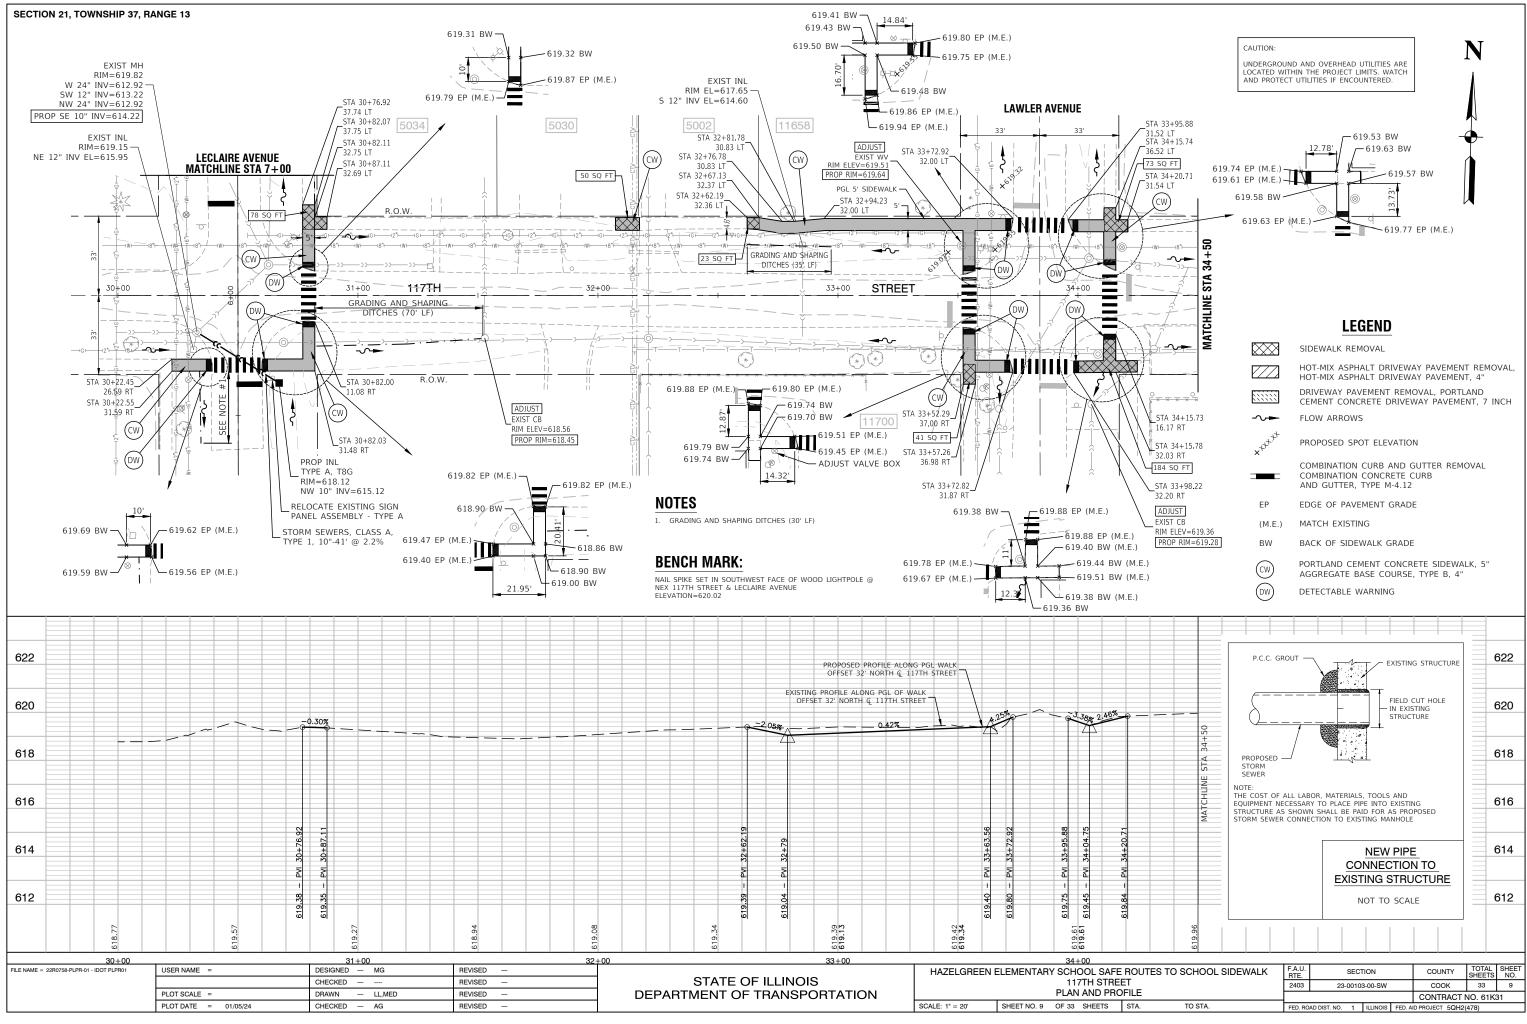


_		O SCHOOL SIDEWALK	F.A.U. RTE.		SECT	TION		COUNTY	SHEETS	NO.	
E			2403	23-	0010	3-00-SW		COOK	33	9	
łŪ	FILE						CONTRACT I	NO. 61K	31		
	STA.	FED. RO	AD DIST. NO.	1	ILLINOIS	FED. A	D PROJECT 5QH2	478)			

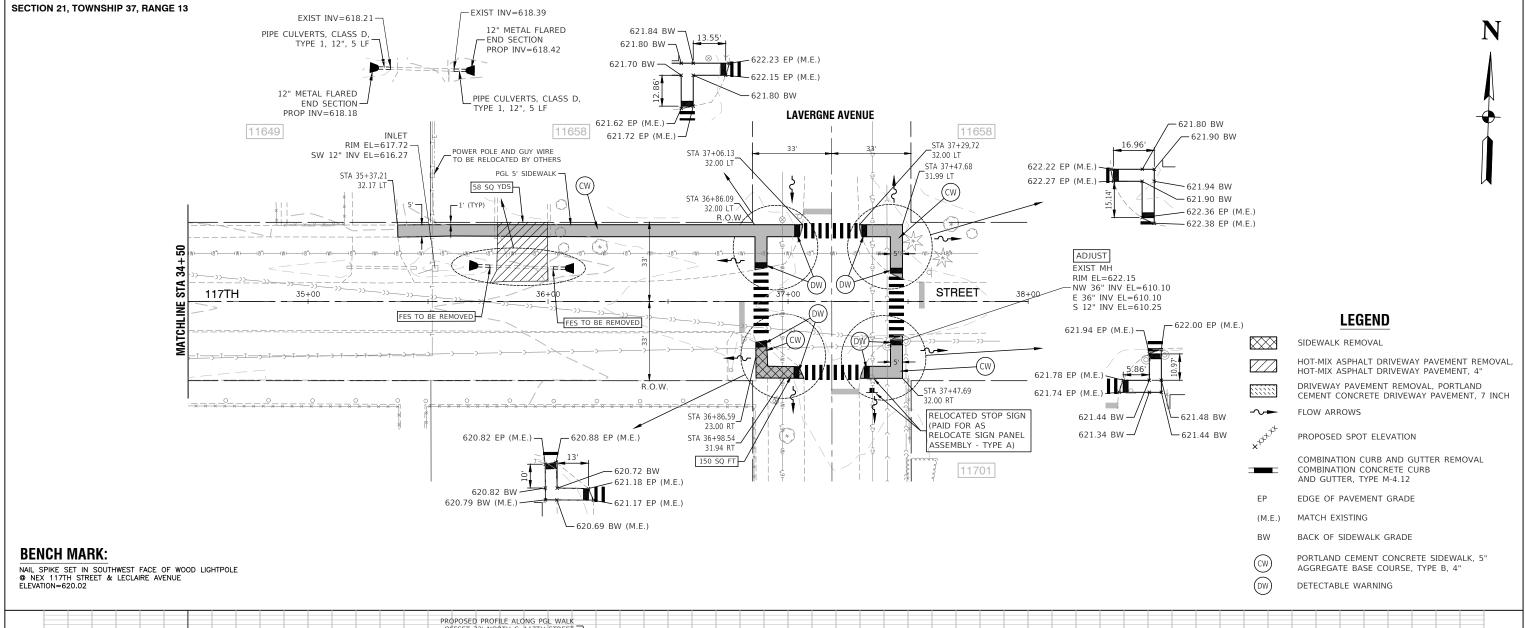

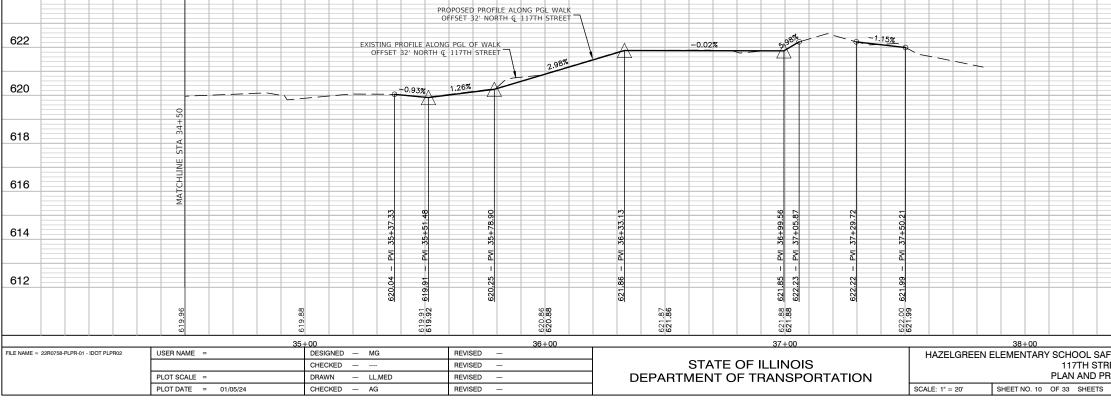

	22	NOK	<u> </u>		03 03 00103 00 5W					ET							
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		O SCHOOL SIDEWALK	RTE.			0001		SHEETS	NO.		
REI			2403	23-0	0010	3-00-SW		COOF	<	33	10
ιC	FILE							CONTR/	ACT N	VO. 61K3	31
	STA.	FED. RO	AD DIST. NO.	1	ILLINOIS	FED. AI	D PROJECT	5QH2(	478)		

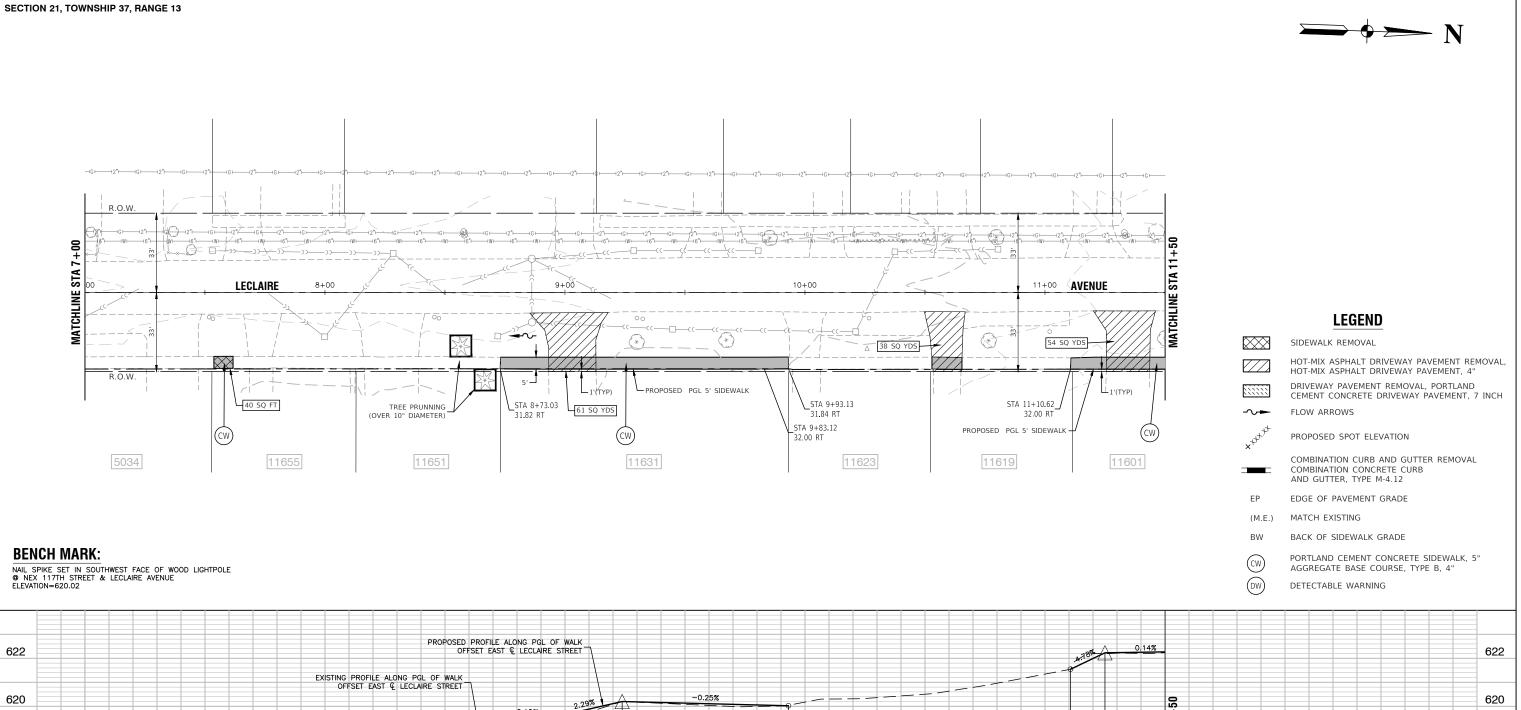


622 620 -0.18% 8 618 STA . Ë CHLI 616 MA 614 612 619. 619.62 619.65 620.08 620.13 20 31 7+00 FILE NAME = 22R0758-PLPR-01 - IDOT PLPR03 8+00 DESIGNED — MG 9+00 10+00 11+00 USER NAME = REVISED HAZELGREEN ELEMENTARY SCHOOL SAF STATE OF ILLINOIS CHECKED -REVISED PLAN AND PR PLOT SCALE = DRAWN LL,MED REVISED DEPARTMENT OF TRANSPORTATION PLOT DATE = 01/05/24 SCALE: H 1"=20' V 1"=5' SHEET NO. 11 OF 33 SHEETS CHECKED - AG REVISED

Ŧ STA -618 ATCHLINE 616 ≥ 614 612 622.23 622.27

622.23

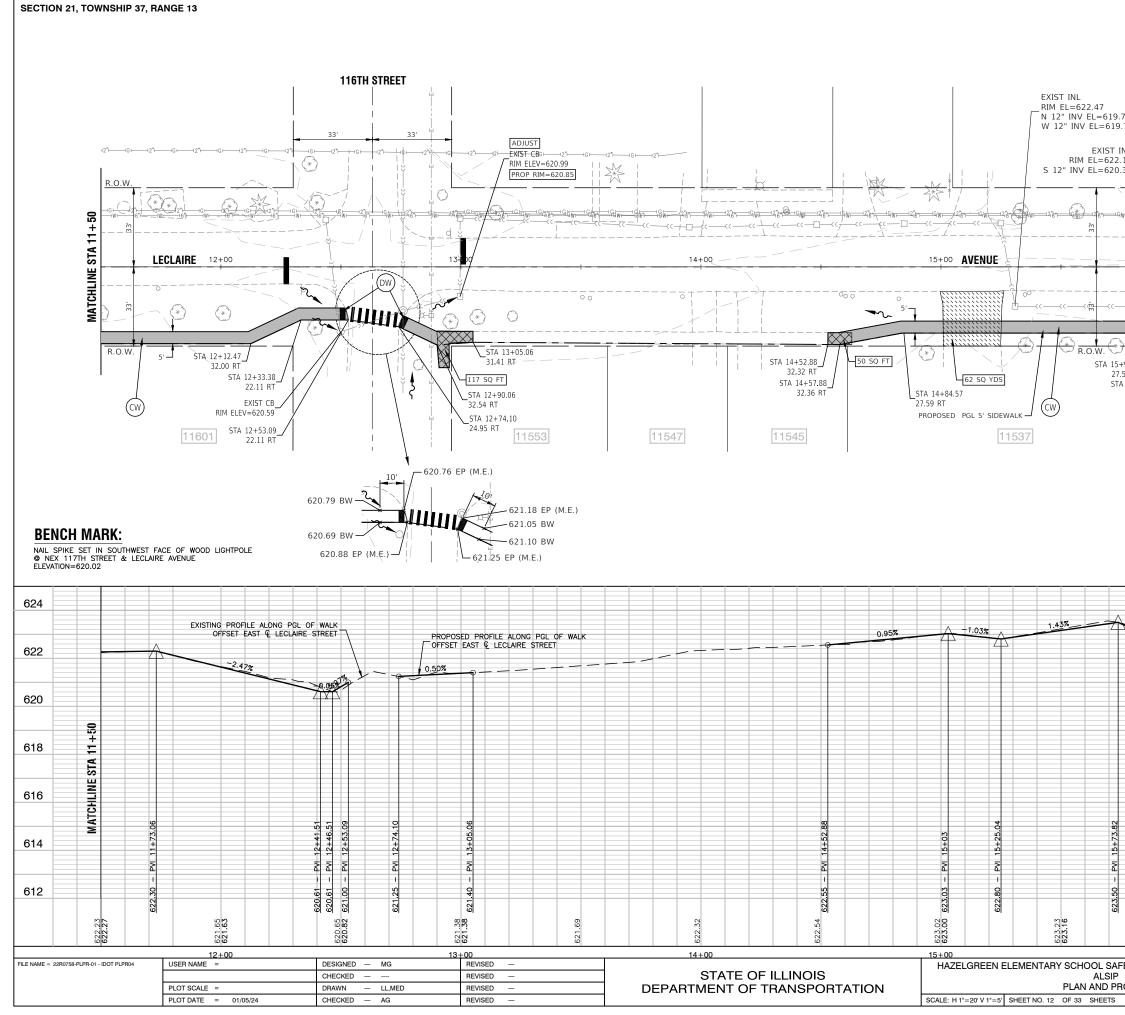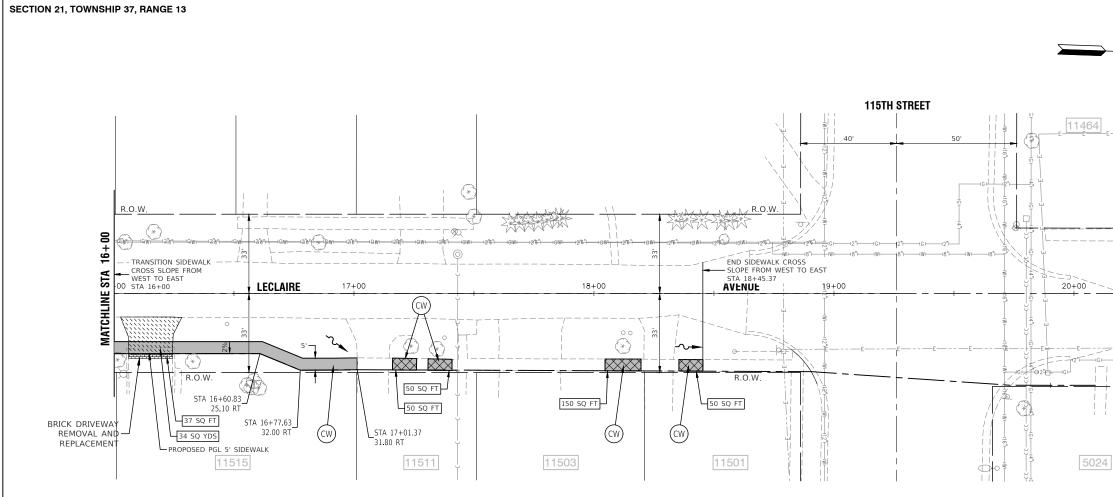
ALSIP

FE	ROUTES T	O SCHOOL SIDEWALK	F.A.U. RTE.		SECT	ION		COUNTY	TOTAL SHEETS	SHEET NO.	
			2403	23-	0010	3-00-SW		COOK	33	11	
RO	FILE							CONTRACT	NO. 61K	31	
	STA.	FED. RO	AD DIST. NO.	1	ILLINOIS	FED. A	D PROJECT 5QH	2(478)			
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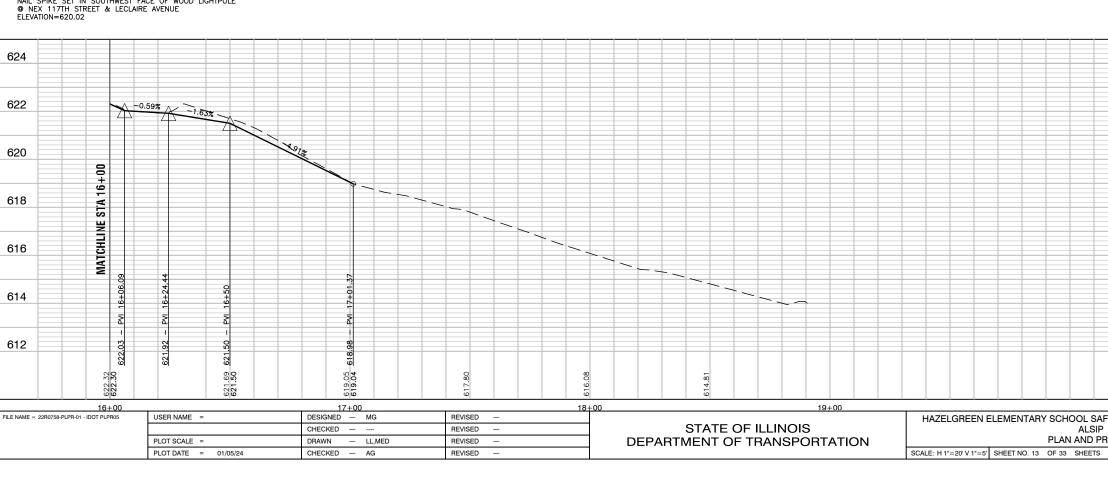


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	ILINE												
	ATCH												616
	Σ												
													614

670		622.32 622.30														
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'RO	FILE											CON	TRACT	NO. 61	K31	1
	STA.	TO S	STA.			FE	D. ROAD	DIST. NO.	1	ILLINOIS	FED. AI	D PROJEC	T 5QH2	2(478)		



**BENCH MARK:** 



MAIL SPIKE SET IN SOUTHWEST FACE OF WOOD LIGHTPOLE © NEX 117TH STREET & LECLAIRE AVENUE ELEVATION=620.02

20 + 26.10	
>	

LEGEND

SIDEWALK REMOVAL

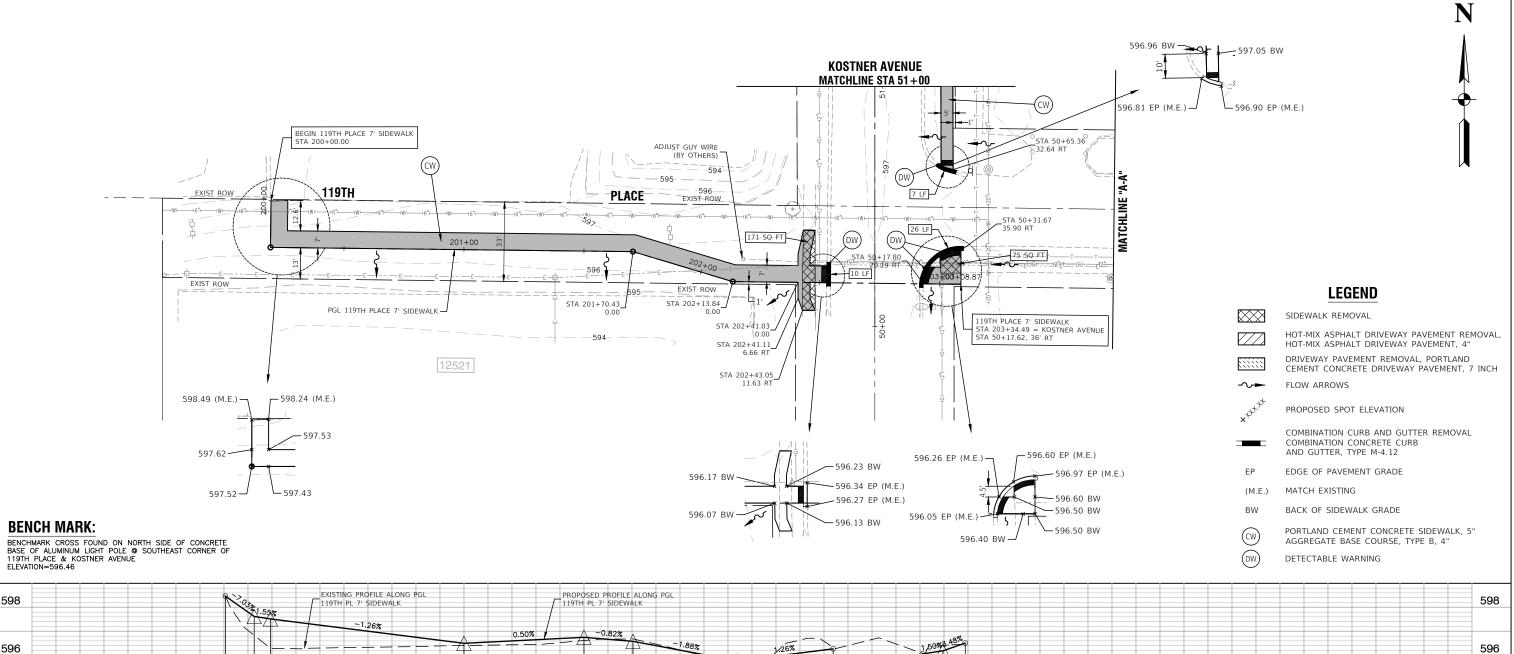
 $\boxtimes$ 

	HOT-MIX ASPHALT DRIVEWAY PAVEMENT REMOVAL, HOT-MIX ASPHALT DRIVEWAY PAVEMENT, 4"
	DRIVEWAY PAVEMENT REMOVAL, PORTLAND CEMENT CONCRETE DRIVEWAY PAVEMENT, 7 INCH
-~-	FLOW ARROWS
×t+t+t+t	PROPOSED SPOT ELEVATION
	COMBINATION CURB AND GUTTER REMOVAL COMBINATION CONCRETE CURB AND GUTTER, TYPE M-4.12
EP	EDGE OF PAVEMENT GRADE
(M.E.)	MATCH EXISTING
BW	BACK OF SIDEWALK GRADE
CW	PORTLAND CEMENT CONCRETE SIDEWALK, 5" AGGREGATE BASE COURSE, TYPE B, 4"
DW	DETECTABLE WARNING

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_																							624
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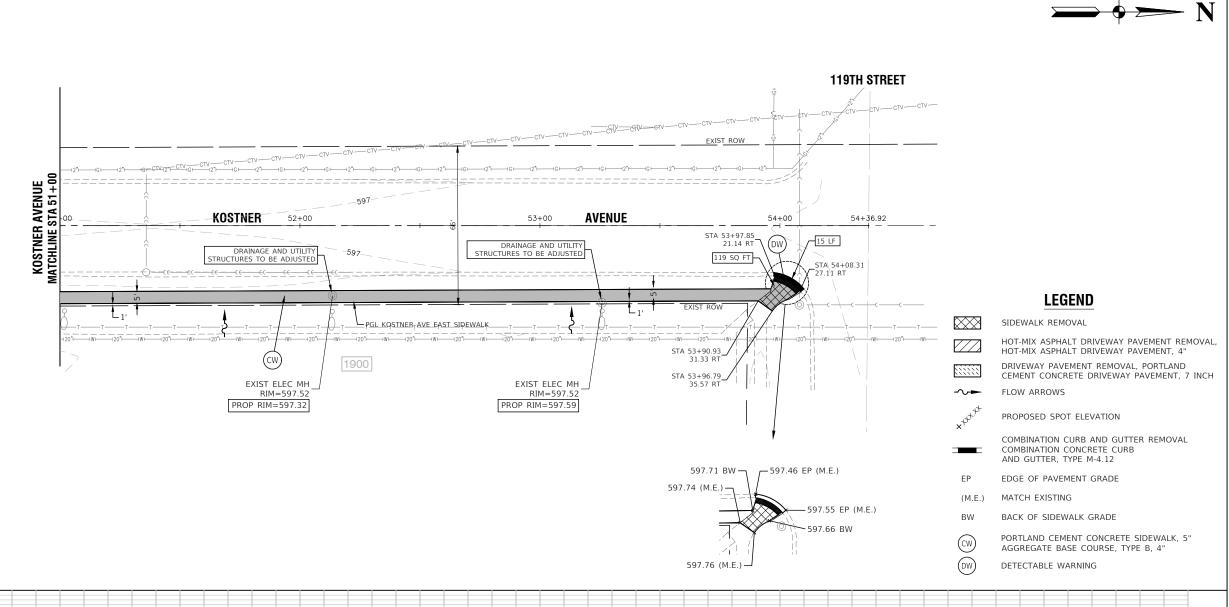


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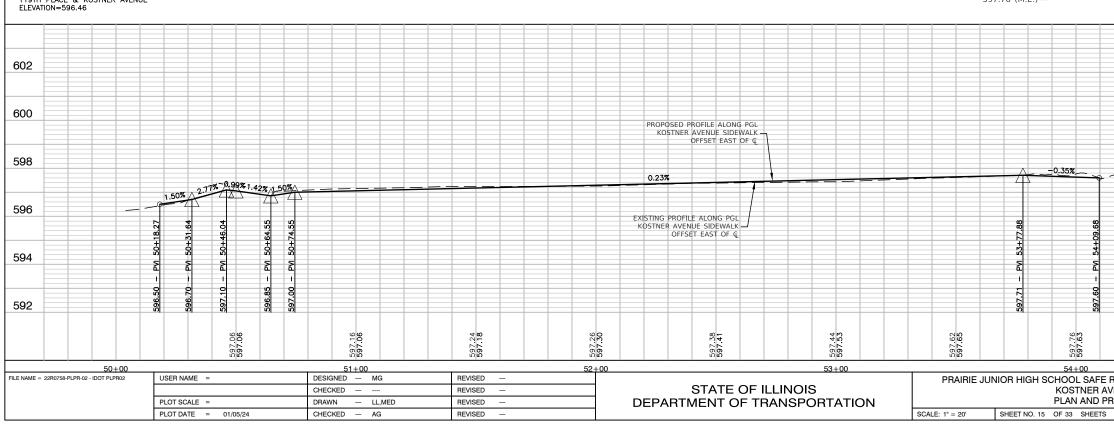
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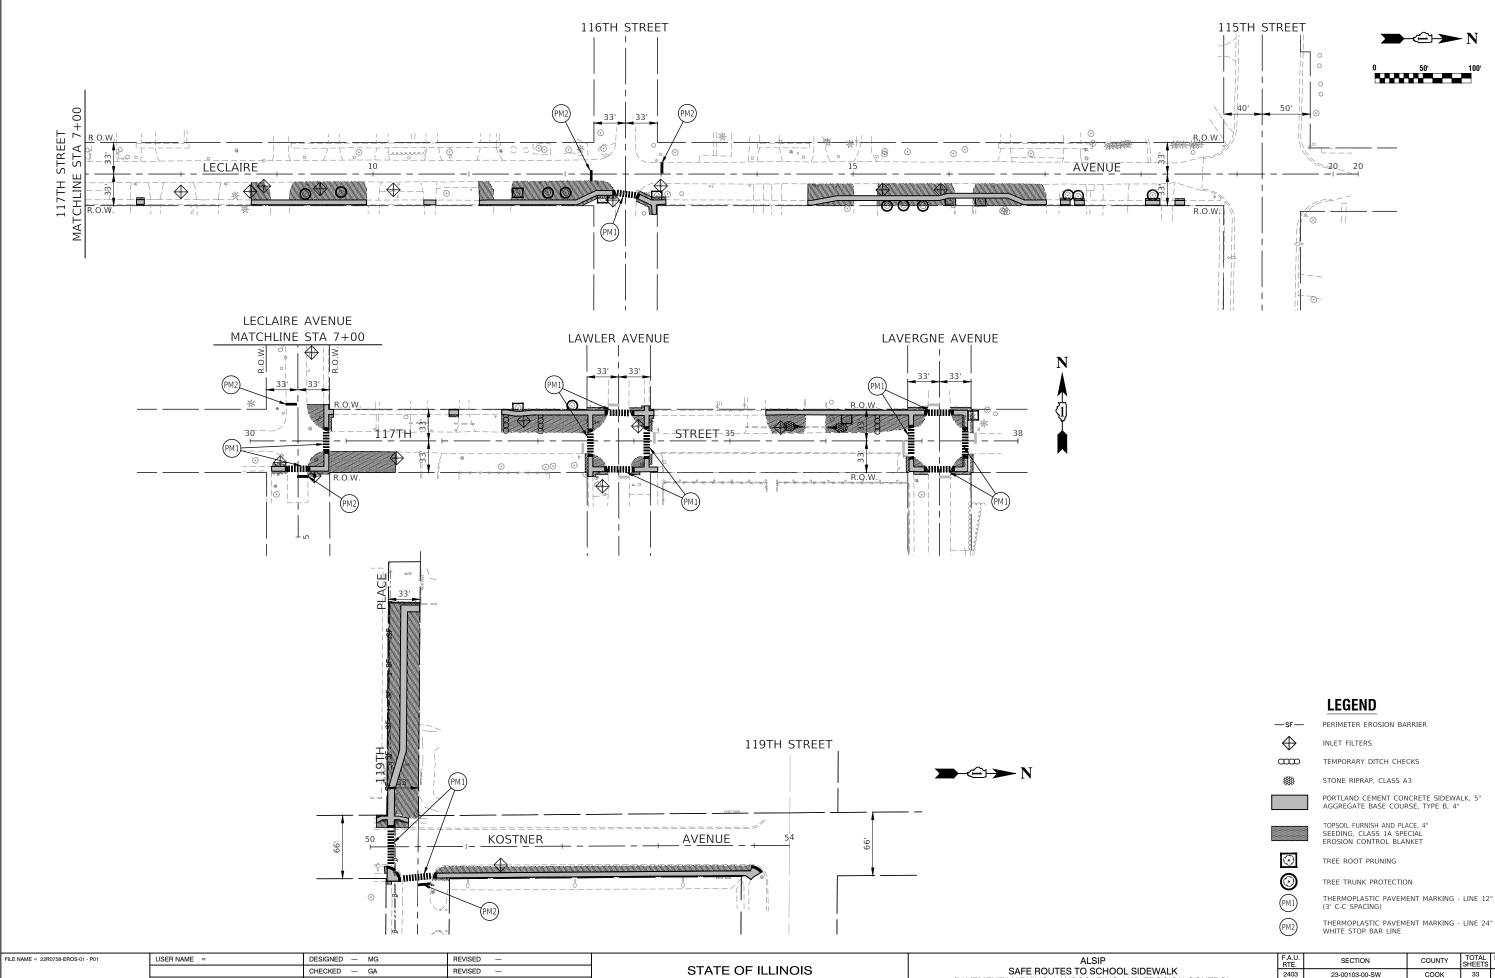
## **BENCH MARK:**



BENCHMARK CROSS FOUND ON NORTH SIDE OF CONCRETE BASE OF ALLWINIUM LIGHT POLE @ SOUTHEAST CORNER OF 119TH PLACE & KOSTNER AVENUE ELEVATION=596.46

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AG	REVISED —		SCALE: 1'=50'	SHEET NO. 16 OF 33 SHEETS	STA. 10+96.84 TO STA. 28+50	FED. ROAD	DIST. NO. 1 ILLINOIS FED. A	D PROJECT 5QH2	(478)	

THERMOPLASTIC PAVEMENT MARKING - LINE 12" (3' C-C SPACING)

### GENERAL NOTES

THIS STORMWATER POLLUTION PREVENTION PLAN (SWPPP) HAS BEEN PREPARED TO COMPLY WITH THE PROVISIONS OF NPDES ILR10 CONSTRUCTION GENERAL PERMIT (CGP) ISSUED BY THE ILLINOIS ENVIRONMENTAL PROTECTION AGENCY FOR STORWATER DISCHARGES FROM CONSTRUCTION SITE ACTIVITIES.

THE CONTRACTOR IS RESPONSIBLE FOR HAVING THE SWPPP ON SITE AT ALL TIMES. THE CONTRACTOR IS ALSO RESPONSIBLE FOR PROVIDING THE QUALIFIED PERSONNEL AND FOR PERFORMING THE REQUIRED INSPECTIONS.

#### 1. PROJECT DESCRIPTION

THE PROJECT CONSISTS OF THE CONSTRUCTION OF SIDEWALKS, INSTALLATION OF NEW STORM SEWER / PIPE CULVERTS AND EXTENSION OF EXISTING PIPE CULVERTS. THE TOTAL AREA OF DISTURBANCE IS APPROXIMATELY 0.90 ACRES.

#### 2. EXISTING SITE CONDITIONS AND SURROUNDING AREAS

HE WORK IS CONTAINED WITHIN THE VILLAGE OF ALSIP RIGHT-OF-WAY AND/OR OTHER PUBLIC SURFACE. AREAS SURROUNDING THE PROJECT ARE RESIDENTIAL AND INDUSTRIAL

З.

SOILS THE SOIL WITHIN THE PROJECT SITE ARE A MIXTURES OF ORTHENTS AND THE CAUPY LOAMS AND MARTINTON SILT LOAMS. MIXTURES OF WESLEY FINE SANDY LOAMS AND MARTINTON SILT LOAMS. EXCAVATION OUTSIDE OF PAVED AREAS WILL BE BACKFILLED WITH NATIVE SOLIS

#### STANDARD SOIL EROSION AND SEDIMENTATION CONTROL 4. PRACTICES

SOIL EROSION AND SEDIMENT CONTROL PRACTICES FOR THIS PROJECT SHALL BE PERFORMED IN ACCORDANCE WITH THE DETAILS AS PROVIDED IN THE PLANS. ALL EROSION CONTROL PRACTICES SHALL BE INSTALLED PRIOR TO STARTING EACH PHASE OF CONSTRUCTION. AFTER AWARD OF THE CONTRACT, THE CONTRACTOR FOR THE PROJECT SHALL SIGN THIS PLAN ACKNOWLEDGING RESPONSIBILITY FOR THE IMPLEMENTATION OF ON-GOING MAINTENANCE OF THIS PLAN. THE EROSION CONTROL PRACTICES SHALL BE INSPECTED AT LEAST WEEKLY, AND AFTER ANY RAINFALL GREATER THAN 0.5". ANY VISIBLE DISRUPTION TO THE EROSION CONTROL PRACTICES SHALL BE IMMEDIATELY REPAIRED. ANY EXISTING SUBSURFACE DRAINAGE SYSTEMS OR FIELD TILES THAT ARE DISTURBED DURING THE CONSTRUCTION SHALL BE RESTORED. TOPSOIL SHALL BE STRIPPED AT THE TIME OF EXCAVATION AND REPLACED DURING THE BACKFILL OPERATION. ANY DUST OR MUD FROM THIS PROJECT TRACKED ONTO PUBLIC STREETS SHALL BE CLEANED UP AT THE END OF EACH WORKING DAY

#### PERMANENT STABILIZATION PLANS 5.

SEED AND EROSION CONTROL BLANKET SHALL BE INSTALLED ON ALL DISTURBED AREAS IN ACCORDANCE WITH THE RESTORATION PLANS. THE CONTRACTOR SHALL BE RESPONSIBLE FOR MAINTENANCE OF ALL VEGETATION AND SEEDED AREAS FOR A PERIOD OF ONE-YEAR AFTER COMPLETION OF THE PROJECT.

#### MAINTENANCE OF EROSION CONTROL PRACTICES 6.

HE CONTRACTOR SHALL BE RESPONSIBLE FOR INSPECTION AND MAINTENANCE OF EROSION CONTROL PRACTICES. PRIOR TO COMMENCING WORK, THE CONTRACTOR SHALL DESIGNATE A CONTACT PERSON FOR MAINTENANCE FOR ENSURING ALL VEGETATION. EROSION AND SEDIMENT CONTROL MEASURES AND OTHER PROTECTIVE MEASURES IDENTIFIED IN THIS PLAN ARE KEPT IN GOOD AND EFFECTIVE OPERATING CONDITIONS

THE PROCEDURES SET FORTH IN THE ILLINOIS URBAN MANUAL SHALL BE FOLLOWED WHERE APPLICABLE. IF NOT, APPLICABLE PROCEDURES SHALL BE FOLLOWED IN ACCORDANCE WITH MANUFACTURERS STANDARDS.

#### CONSTRUCTION SEQUENCE

INSTALL EROSION CONTROL 2. STORM SEWER / CULVERTS 3. CONSTRUCTION OF SIDEWALK 4. RESTORATION

#### INSPECTIONS

QUALIFIED PERSONNEL SHALL INSPECT DISTURBED AREAS OF THE CONSTRUCTION SITE, WHICH HAVE NOT BEEN FINALLY STABILIZED OR EXITUTINAL CONTROL MEASURES AND LOCATIONS WHERE VEHICLES ENTER OR EXIT THE SITE. SUCH INSPECTIONS SHALL BE CONDUCTED AT LEAST ONCE EVERY SEVEN (7) CALENDAR DAYS AND WITHIN 24 HOURS OF THE END OF A STORM THAT IS 0.5 INCHES OR GREATER (OR EQUIVALENT SNOWFALL).

- DISTURBED AREAS AND AREAS USED FOR STORAGE OF MATERIALS THAT ARE EXPOSED TO PRECIPITATION SHALL BE INSPECTED FOR EVIDENCE OF, OR THE POTENTIAL FOR, POLLUTANTS ENTERING THE DRAINAGE SYSTEM. EROSION AND SEDIMENT CONTROL MEASURES IDENTIFIED IN THE IMPROVEMENT PLANS SHALL BE OBSERVED TO LOCATIONS OR POINTS ARE ACCESSIBLE, THEY SHALL BE INSPECTED TO ASCERTAIN WHETHER EROSION CONTROL MEASURES ARE FEFECTIVE IN PREVENTING SIGNIFICANT IMPACTS TO RECEIVING WATERS. LOCATIONS WHERE VEHICLES ENTER OR EXIT THE SITE SHALL BE INSPECTED FOR EVIDENCE OF OFF-SITE SEDIMENT TRACKING
- BASED ON THE RESULTS OF THE INSPECITION, THE DESCRIPTION OF POTENTIAL POLLUTANT SOURCES IDENTIFIED IN THE PROJECT DESCRIPTION AND POLLUTION PREVENTION MEASURES IDENTIFIED UNDER EROSION AND SEDIMENT CONTROLS SHALL BE REVISED AS APPROPRIATE AS SOON AS PRACTICABLE AFTER SUCH INSPECTION. В. ANY CHANGES TO THIS PLAN RESULTING FROM THE REOLIIRED NSPECTIONS SHALL BE IMPLEMENTED WITHIN SEVEN (7) CALENDAR DAYS FOLLOWING THE INSPECTION.
- A REPORT SUMMARIZING THE SCOPE OF THE INSPECTION, NAME(S) AND QUALIFICATIONS OF PERSONNEL MAKING THE INSPECTION, DATE(S) OF THE INSPECTION(S), MAJOR OBSERVATIONS RELATING TO THE IMPLEMENTATION OF THIS STORMWATER POLLUTION PREVENTION PLAN AND ACTIONS TAKEN IN ACCORDANCE WITH THE ABOVE SECTION B SHALL BE MADE AND RETAINED AS PART OF THE PLAN FOR AT LEAST THREE (3) YEARS AFTER THE DATE OF THE INSPECTION. THE REPORT SHALL BE SIGNED IN ACCORDANCE WITH PART VI. G OF THE GENERAL PERMIT.
- IF ANY VIOLATION OF THE PROVISIONS OF THIS PLAN IS IDENTIFIED DURING THE CONDUCT OF THE CONSTRUCTION WORK COVERED BY THIS PLAN, THE INSPECTOR SHALL COMPLETE AND FILE AN INCIDENCE OF NONCOMPLIANCE" (ION) REPORT FOR THE IDENTIFIED VIOLATION. THE RESIDENT ENGINEER OR RESIDENT TECHNICIAN SHALL USE FORMS PROVIDED BY THE ILLINOIS EVNIRONMENTAL PROTECTION AGENCY AND SHALL INCLUDE SPECIFIC INFORMATION ON THE CAUSE OF THE NONCOMPLIANCE, ACTIONS TAKEN TO PREVENT ANY FURTHER CAUSES OF NONCOMPLIANCE AND A STATEMENT DETAILING ANY ENVIRONMENTAL IMPACT WHICH MAY HAVE RESULTED FROM THE NONCOMPLIANCE. ALL REPORTS OF NONCOMPLIANCE SHALL BE SIGNED BY A RESPONSIBLE AUTHORITY IN ACCORDANCE WITH PART VI. G OF THE GENERAL PERMIT.

THE REPORT OF NONCOMPLIANCE SHALL BE MAILED TO THE FOLLOWING ADDRESS

> ILLINOIS ENVIRONMENTAL PROTECTION AGENCY DIVISION OF WATER POLLUTION CONTROL ATTN: COMPLIANCE ASSURANCE SECTION 1021 NORTH GRAND FAST POST OFFICE BOX 1927 SPRINGFIELD, ILLINOIS 62794-9276

(WITH COPIES SENT TO THE OWNER AND ENGINEER)

## **DESCRIPTION OF** STORMWATER MANAGEMENT CONTROLS

- 1. INSTALL PERIMETER EROSION BARRIER AS INDICATED ON THE LANDSCAPING AND EROSION CONTROL PLAN.
- 2. AFTER CONSTRUCTION OF THE PROPOSED STORM SEWERS AND CULVERTS. PLACE INLET FILTERS PER THE DETAIL ON THE PLANS OF APPROVED EQUAL IN ALL STORM STRUCTURES ACCEPTING SURFACE FLOW OUTSIDE OF PAVED AREAS.
- 3. INSTALL PERMANENT EROSION CONTROL MEASURES SEED AND BLANKET AS SHOWN ON THE LANDSCAPING AND EROSION CONTROL PI AN

## **STABILIZATION PRACTICES**

THIS SECTION OF THE PLAN ADDRESSES THE VARIOUS CONTROLS THAT WILL BE IMPLEMENTED FOR EACH OF THE MAJOR CONSTRUCTION ACTIVITIES DESCRIBED. FOR EACH MEASURE DISCUSSED, THE CONTRACTOR THAT WILL BE RESPONSIBLE FOR ITS IMPLEMENTATION IS INDICATED. EACH SUCH CONTRACTOR SHALL SIGN THE REQUIRED CERTIFICATION ON FORMS WHICH ARE PART OF THIS PLAN.

INSTALL ONSITE SEDIMENT CONTROL MEASURES AS SHOWN ON THE 1. IMPROVEMENT PLANS PRIOR TO INITIATING CONSTRUCTION

- 2. STABILIZATION OF DISTURBED AREAS MUST BE INITIATED WITHIN ONE (1) WORKING DAY OF PERMANENT OR TEMPORARY CESSATION OF EARTH DISTURBING ACTIVITIES AND SHALL BE COMPLETED AS SOON AS POSSIBLE BUT NOT LATER THAN 14 DAYS FROM THE INITIATION OF THE STABILIZATION WORK IN AN AREA.
- TEMPORARY SEED MIXTURE SHALL BE APPLIED AT 100 LBS/ ACRE OR 150 LBS/ ACRE DEPENDING ON THE SEED MIXTURE USED.
- TOPSOIL STOCKPILES SHALL BE SEEDED WITHIN ONE (1) WORKING DAY OF PERMANENT OR TEMPORARY CESSATION OF EARTH DISTURBING ACTIVITIES AND SHALL BE COMPLETED AS SOON AS POSSIBLE BUT NOT LATER THAN 14 DAYS FROM THE INITIATION OF THE STABILIZATION WORK IN AN AREA. ALL SOIL STORAGE PILES SHALL BE PROTECTED FROM EROSION WITH SILT FENCE ON THE DOWNSLOPE SIDE OF THE PILES.
- WATER PUMPED DURING CONSTRUCTION OPERATION SHALL BE FILTERED.
- 6. DUST CONTROL SHALL BE PERFORMED ON A DAILY BASIS USING WATER DISPERSED FROM TRUCK MOUNTED TANK WITH STANDARD DISCHARGE HEADER TO PROVIDE A UNIFORM RATE OF APPLICATION.
- PREVENT SEDIMENT FROM BEING TRACKED ONTO PUBLIC ROADWAYS. ANY SEDIMENT REACHING A PUBLIC ROAD SHALL BE REMOVED BY SHOVELING OR STREET CLEANING BEFORE THE END OF EACH WORKING
- 8. ALL TEMPORARY AND PERMANENT EROSION CONTROL MEASURES MUST BE MAINTAINED AND REPAIRED AS NEEDED TO ASSURE EFFECTIVE PERFORMANCE
- ADDITIONAL FROSION CONTROL MEASURES MAY BE REQUIRED BY THE MUNICIPALITY AS CONSTRUCTION PROGRESSES.
- 10. ALL EROSION AND SEDIMENTATION CONTROL MEASURES SHALL BE REMOVED AND DISPOSED OF WITHIN 30 DAYS OF FINAL STABILIZATION.
- 11. ALL EROSION AND SEDIMENTATION CONTROL SHALL BE IN ACCORDANCE WITH IDOT AND THE VILLAGE OF ALSIP ORDINANCES
- 12. SPECIFIC EROSION CONTROLS ARE SHOWN ON THE LANDSCAPING AND EROSION CONTROL PLAN IN THIS SET

#### **NON-STORMWATER DISCHARGES**

EXCEPT FOR FLOWS FROM FIRE FIGHTING ACTIVITIES, SOURCES OF NON-STORMWATER THAT IS COMBINED WITH STORMWATER DISCHARGES ASSOCIATED WITH THE CONSTRUCTION ADDRESSED IN THIS PLAN MUST BE DESCRIBED BELOW. APPROPRIATE POLLUTION PREVENTION MEASURES, AS DESCRIBED BELOW, WILL BE IMPLEMENTED FOR THE NON-STORMWATER CONPONENT(S) OF THE DISCHARGE

WATERMAIN FLUSHING FIRE HYDRANT FLUSHING GROUNDWATER (TRENCH DE-WATERING WATER) WATERING FOR DUST CONTROL DRAINAGE FOR VEGITATIVE GROWTH

#### **APPROVED STATE OR LOCAL PLANS**

THE MANAGEMENT PRACTICES, CONTROLS AND PROVISIONS CONTAINED IN THIS PLAN WILL BE IN ACCORDANCE WITH IDOT SPECIFICATIONS, WHICH ARE AT LEAST AS PROTECTIVE AS THE REQUIREMENTS CONTAINED IN THE ILLINOIS ENVIRONMENTAL PROTECTION AGENCY'S ILLINOIS LIBBAN MANUAL LATEST EDITION. REQUIREMENTS SPECIFIED IN THE SWPPP. OR SITE PERMITS APPROVED BY LOCAL OFFICIALS THAT ARE APPLICABLE TO PROTECTING SURFACE WATER RESOURCES ARE TO BE AUTHORIZED TO DISCHARGE UNDER PERMITS ILR10 INCORPORATED BY REFERENCE AND ARE ENFORCEABLE UNDER THIS PERMIT EVEN IF THEY ARE NOT SPECIFICALLY INCLUDED IN THE PLAN.

## **EROSION CONTROL NOTES**

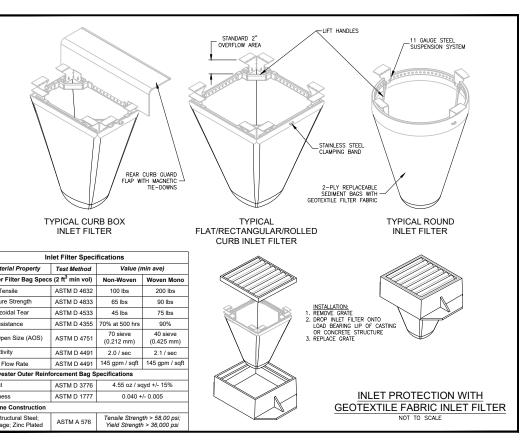
THE CONTRACTOR SHALL TAKE THE NECESSARY STEPS TO CONTROL WASTE SUCH AS DISCARDED CONSTRUCTION MATERIALS, CONCRETE TRUCK WASHOUT CHEMICALS, LITTER AND SANITARY WASTE AT THE CONSTRUCTION SITE THAT MAY CAUSE ADVERSE IMPACTS TO WATER QUALIT

ALL EROSION CONTROL PRACTICES SHALL BE INSTALLED PRIOR TO THE START OF CONSTRUCTION

ANY OBSERVED DISRUPTION TO THE EROSION CONTROL PRACTICES SHALL BE IMMEDIATELY REPAIRED BY THE CONTRACTOR.

ANY DUST OR MUD TRACKED ONTO STREETS SHALL BE CLEANED AT THE END OF EACH WORKING DAY.


STABILIZATION OF DISTURBED AREAS MUST BE INITIATED WITHIN ONE (1) WORKING DAY OF PERMANENT OR TEMPORARY CESSATION OF EARTH DISTURBING ACTIVITIES AND SHALL BE COMPLETED AS SOON AS POSSIBLE BUT NOT LATER THAN 14 DAYS FROM THE INITIATION OF THE STABILIZATION WORK IN AN AREA



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> Inner Filter Bag Specs	s (2 ft <sup>3</sup> min vol)	Non-Wove										
Grab Tensile	ASTM D 4632	100 lbs										
Puncture Strength	ASTM D 4833	65 lbs										
Trapezoidal Tear	ASTM D 4533	45 lbs										
UV Resistance	ASTM D 4355	70% at 500										
App Open Size (AOS)	ASTM D 4751	70 sieve (0.212 mm										
Permittivity	ASTM D 4491	2.0 / sec										
Water Flow Rate	ASTM D 4491	145 gpm / s										
> Polyester Outer Reinf	orcement Bag S	pecifications										
Weight	ASTM D 3776	4.55 oz										
Thickness	ASTM D 1777	0.04										
> Frame Construction												
A36 Structural Steel;	ASTM A 576	Tensile Str										
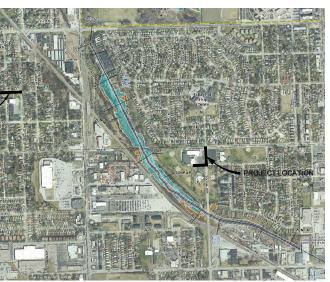
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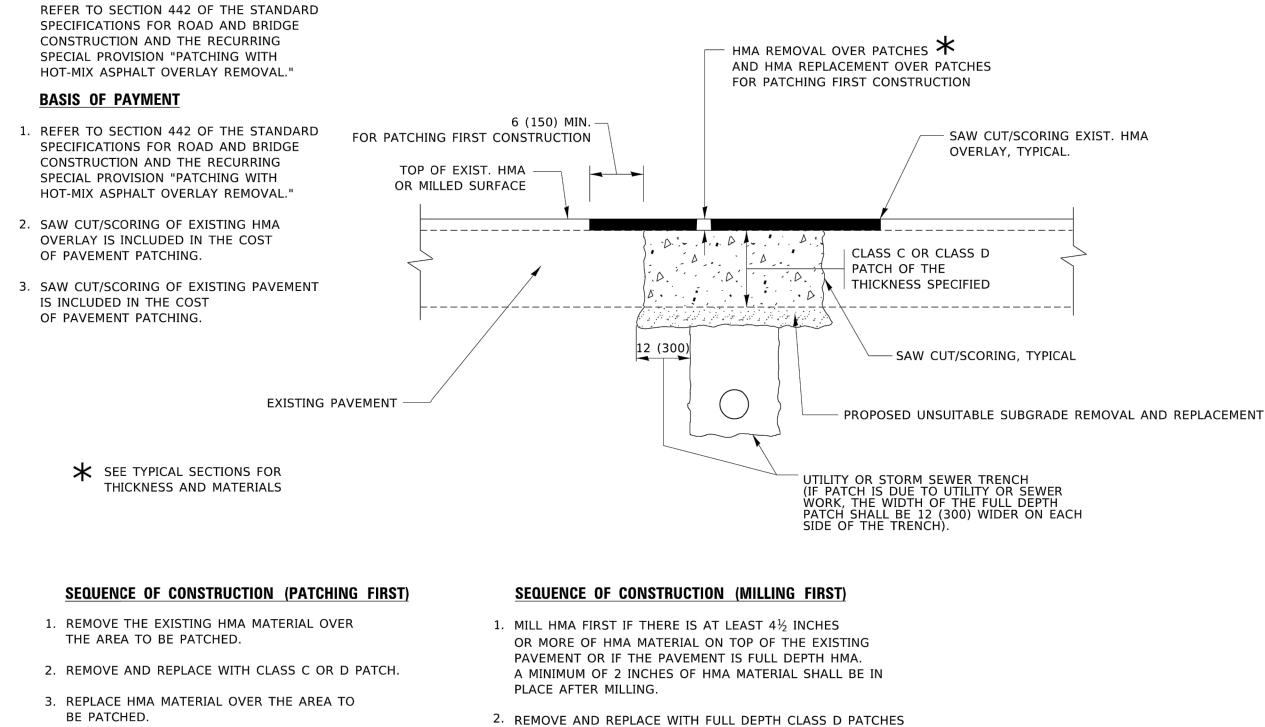
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## VILLAGE OF ALSIP

				.U. E.	SECT	ION		COUNTY	TOTAL SHEETS	SHEET NO.
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	STA. TO STA.		FED.	. ROAE	D DIST. NO. 1	ILLINOIS	FED. AI	D PROJECT 5QH2(	478)	

#### METHOD OF MEASUREMENT



: md	USER NAME = Lawrence.DeManche	DESIGNED - R. SHAH	REVISED - R. BORO 01-01-07		PAVEMENT PATCHING FOR	F.A. SECTION	COUNTY TOTAL SHEET
AME		DRAWN -	REVISED - R. BORO 09-04-07	STATE OF ILLINOIS	HMA SURFACED PAVEMENT	TYLE.	SILEIS NO.
N N	PLOT SCALE = 100.0000 ' / in.	CHECKED -	REVISED - K. ENG 10-27-08	DEPARTMENT OF TRANSPORTATION	HIMA SURFACED PAVEIMENT	BD400-04 (BD-22)	CONTRACT NO.
E	PLOT DATE = 11/18/2022	DATE - 10-25-94	REVISED - K. SMITH 11-18-22		SCALE: NONE SHEET 1 OF 1 SHEETS STA. TO STA.		AID PROJECT

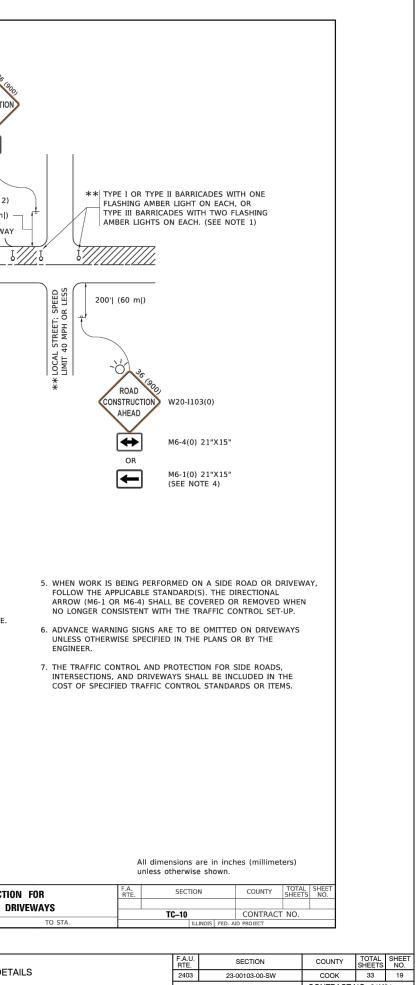
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#### ALL DIMENSIONS ARE IN INCHES (MILLIMETERS) UNLESS OTHERWISE SHOWN.

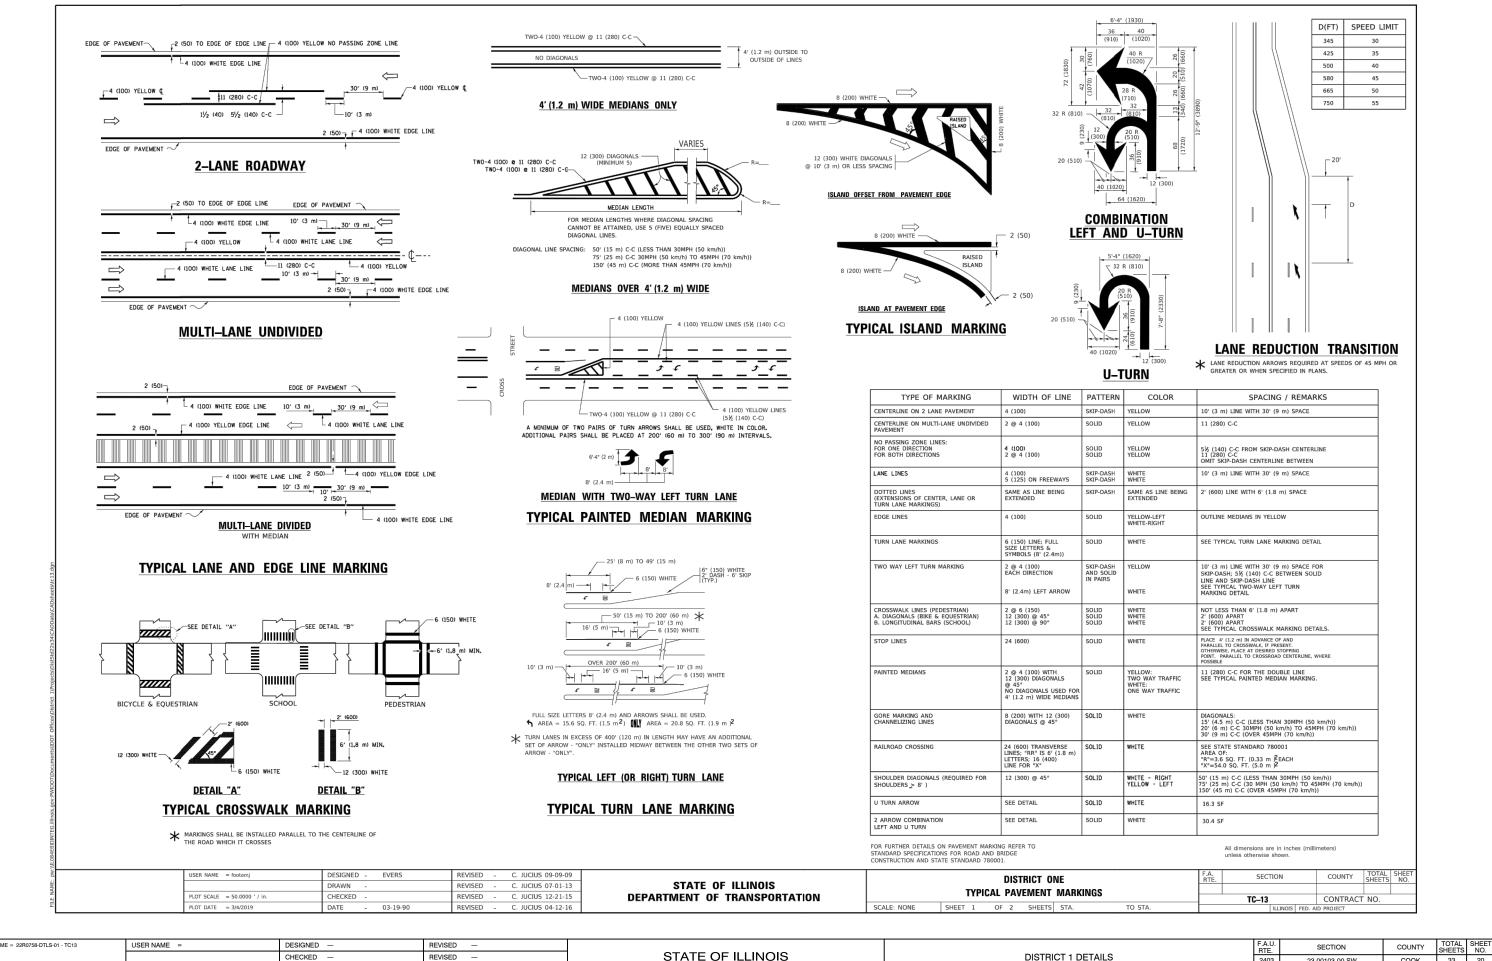
DIVTG. lining.gor-PWDOTDocuments/DOT OfficeoBistrict 1,ProjectaDiststd22044(cADbabe)CADsheetskc10.dgn						<ul> <li>SHOWN ON THE DRAWING AN</li> <li>a) ONE "ROAD CONSTRUCTI MOUNTED ON IT APPROXI</li> <li>b) THE CLOSED PORTION OF BLOCKING WITH TYPE I, T THE CROSS SECTION OF "</li> <li>2. SIDE ROAD WITH A SPEED LIN AS SHOWN ON THE DRAWING</li> <li>a) ONE "ROAD CONSTRUCTION FLASHER MOUNTED ON IT OF THE MAIN ROUTE.</li> <li>THE CLOSED PORTION OF</li> <li>b) BLOCKING WITH TYPE III OF THE CLOSED PORTION OF</li> <li>b) BLOCKING WITH TYPE III OF THE CLOSED PORTION</li> <li>3. CONES MAY BE SUBSTITUTED SPACING DURING DAY OPERATIN IN HEIGHT.</li> </ul>	MIT OF 40 MPH (60 km/h) OR LESS AS ID AS DIRECTED BY THE ENGINEER: ON AHEAD SIGN 36 x 36 (900x900) WITH A FLASHER IMATELY 200' (60 m) IN ADVANCE OF THE MAIN ROUTE. THE MAIN ROUTE SHALL BE PROTECTED BY TYPE II OR TYPE III BARRICADES, 1/3 OF THE CLOSED PORTION. MIT GREATER THAN 40 MPH (60 km/h) & AND AS DIRECTED BY THE ENGINEER: ON AHEAD" SIGN 48 x 48 (1.2 m x 1.2 m) WITH A T APPROXIMATELY 500' (150 m) IN ADVANCE THE MAIN ROUTE SHALL BE PROTECTED BY TYPE II OR TYPE III BARRICADES, 1/3 OF THE CLOSED PORTION. MIT GREATER THAN 40 MPH (60 km/h) & AND AS DIRECTED BY THE ENGINEER: ON AHEAD" SIGN 48 x 48 (1.2 m x 1.2 m) WITH A T APPROXIMATELY 500' (150 m) IN ADVANCE
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