STATE OF ILLINOIS DEPARTMENT OF TRANSPORTATION

F.A. SECTION COUNTY TOTAL SHEET NO. 2023 LS YARD PARKING COOK 15 1 | MUNOS CONTRACT NO. 62W01

D-91-078-24


FOR INDEX OF SHEETS, SEE SHEET NO. 2

IMPROVEMENT IS LOCATED IN: THE CITY OF CHICAGO

PROPOSED HIGHWAY PLANS

MS 3100B AUGUSTA BOULEVARD
LANDSCAPE MAINTENANCE YARD (1260 AUGUSTA BLVD)
SECTION: 2023 LS YARD PARKING
PARKING LOT IMPROVEMENT
COOK COUNTY

C-91-087-24

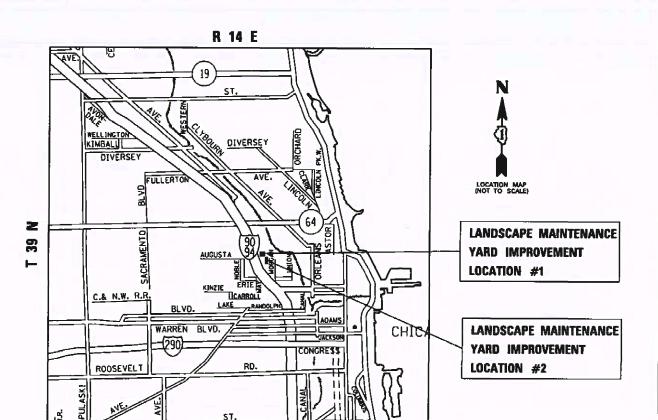

WEST CHICAGO CITY TOWNSHIP

AD DAVIGLAS

STAPPENSON

MENTERAGO

PODRE

NO MARE

NO MA

STATE OF ILLINOIS
DEPARTMENT OF TRANSPORTATION

SUBMITTED FEB 9 24

REGIONAL ENGINEER

March 22, 2024

ENGINEER OF DESIGN AND ENVIRONMENT

March 22, 2024

DIRECTOR OF HIGHWAYS PROJECT IMPLEMENTATION

PRINTED BY THE AUTHORITY OF THE STATE OF ILLINOIS

0 100° 200° 300° — 1° = 100° 0 10° 20° 30° — 1° = 10° 0 50° 100° — 1° = 50° 0 50° — 1° = 30° 0 50° — 1° = 30° 0 50° — 1° = 20°

FULL SIZE PLANS HAVE BEEN PREPARED USING STANDARD ENGINEERING SCALES. REDUCED SIZED PLANS WILL NOT CONFORM TO STANDARD SCALES. IN MAKING MEASUREMENTS ON REDUCED PLANS, THE ABOVE SCALES MAY BE USED.

J.U.L.I.E.

0

JOINT UTILITY LOCATION INFORMATION FOR EXCAVATORS 1-800-892-0123 OR 811

PROJECT ENGINEER: DAN WILGREEN (847) 705-4240 PROJECT MANAGER: FAWAD AQUEEL

CONTRACT NO. 62W01

INDEX OF SHEETS

DISTRICT ONE TYPICAL PAVEMENT MARKINGS (TC-13)

15

STATE STANDARDS


SHEET NO.	DESCRIPTION	STANDARD NO.	DESCRIPTION
1	COVER SHEET	000001-08	TYPICAL SYMBOLS, ABBREVIATIONS AND PATTERNS
2	INDEX OF SHEETS, STATE STANDARDS, GENERAL NOTES & HMA MIXTURE REQUIREMENTS	604001-05	FRAME AND LIDS 1
3	GENERAL LOCATION MAP	606001-08	CONCRETE CURB TYPE B AND COMBINATION CONCRETE CURB
4-5	SUMMARY OF QUANTITIES		AND GUTTER
6	TYPICAL SECTIONS	701001-02	OFF-RD OPERATIONS, 2L, 2W, MORE THAN 15' (4.5 m) AWAY
7-8	EXISTING SITE PLAN	701006-05	OFF-RD OPERATIONS, 2L, 2W, 15' (4.5 m) TO 24" (600 mm) FROM PAVEMENT EDGE
9-10	PROPOSED SITE PLAN	701301-04	LANE CLOSURE, 2L, 2W, SHORT TIME OPERATIONS
11-12	PROPOSED GRADING PLAN	701501-06	URBAN LANE CLOSURE, 2L,2W, UNDIVIDED
13	PROPOSED PAVEMENT PLAN	701901-09	TRAFFIC CONTROL DEVICES
14	DRIVEWAY DETAILS - DISTANCE BETWEEN R.O.W. AND FACE OF CURB & EDGE OF SHOULDER >= 15' (4.5 M) (BD-01)	729001-01	APPLICATIONS OF TYPES A & B METAL POSTS FOR SIGNS AND MARKERS)

GENERAL NOTES

- THE CONTRACTOR WILL NOT BE ALLOWED TO SET UP A YARD OR FIELD OFFICE ON STATE PROPERTY WITHOUT WRITTEN PERMISSION FROM THE DEPARTMENT.
- 2. LOCATION OF COMBINATION CONCRETE CURB AND GUTTER REMOVAL AND REPLACEMENT [OR COMBINATION CURB AND GUTTER (THE TYPE SPECIFICED ON THE PLANS)], WILL BE DETERMINED IN THE FIELD BY THE ENGINEER.
- 2. THE CONTRACTOR SHALL COORDINATE CONSTRUCTION ACTIVITIES WITH THE LANDSCAPE MAINTENANCE YARD TEAM SECTION TECHNICIAN JEROME BEANE AT 773-486-1957 OR 1958 OR AT JEROME.BEANE@ILLINOIS.GOV
- 4. IT SHALL BE THE CONTRACTOR'S RESPONSIBILITY TO VERIFY ALL DIMENSIONS AND CONDITIONS EXISTING IN THE FIELD PRIOR TO CONSTRUCTION AND ORDERING OF MATERIALS.
- 5. FRAMES AND GRATES ADJUSTMENT OF PRIVATE UTILITIES WITHIN THE LIMITS OF THE IMPROVEMENTS SHALL BE DONE BY THEIR RESPECTIVE OWNERS AND ARE NOT PART OF THIS CONTRACT
- 6. EXISTING BROKEN FRAMES AND LIDS SHALL BE REMOVED AND DISPOSED OF BY THE CONTRACTOR AND SHALL BE REPLACED AS DIRECTED BY THE ENGINEER. REPLACEMENT FRAMES AND LIDS WILL BE PAID FOR ACCORDING TO ARTICLE 109.04 OF THE STANDARD SPECIFICATIONS UNLESS A SEPARATE PAY ITEM HAS BEEN PROVIDED.
- 7. THE RE MUST CONTACT THE LANDSCAPE MAINTENANCE YARD TEAM SECTION TECHNICIAN JEROME BEANE AT 773-486-1957 OR 1958 OR AT JEROME.BEANE@ILLINOIS.GOV TO RELOCATE ANY EXISTING ITEMS PRESENT AT THE CONSTUCTION LOCATION.
- THE CONTRACTOR SHALL USE CARE IN GRADING OR EXCAVATING NEAR ANY AND ALL EXISTING ITEMS THAT WILL NOT BE REMOVED INCLUDING PREVIOUSLY SEEDED AREAS. ANY DAMAGE DONE TO EXISTING ITEMS BY THE CONTRACTOR SHALL BE REPAIRED AT THE CONTRACTOR'S OWN EXPENSE TO THE SATISFACTION OF THE ENGINEER.
- 9. ANY LOOSE MATERIAL DEPOSITED IN THE FLOW LINE OF CURB OR DRAINAGE STRUCTURES, WHICH OBSTRUCTS THE NATURAL FLOW OF WATER, SHALL BE REMOVED AT THE CLOSE OF EACH WORKING DAY. PRIOR TO ACCEPTANCE OF THE IMPROVEMENT, ALL DRAINAGE STRUCTURES SHALL BE FREE OF DIRT AND DEBRIS. THIS WORK WILL NOT BE PAID FOR SEPARATELY BUT SHALL BE CONSIDERED AS INCIDENTAL.

MODEL: \$MODELNAMES FILE NAME: \$FILELS



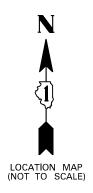

LANDSCAPE MAINTENANCE YARD IMPROVEMENT LOCATION #1

LANDSCAPE MAINTENANCE YARD IMPROVEMENT LOCATION #2


USER NAME = Rana, Kalo	DESIGNED -	REVISED -	
	DRAWN -	REVISED -	
PLOT SCALE = 100.0000 / in.	CHECKED -	REVISED -	
PLOT DATE = 2/9/2024	DATE -	REVISED -	

STATE OF ILLINOIS **DEPARTMENT OF TRANSPORTATION** LANDSCAPE MAINTENANCE YARD (AUGUSTA BLVD) **GENERAL LOCATION MAP** CONTRACT NO. 62W01 OF 1 SHEETS STA.


	SUMMARY OF QUANTITIES				CONSTRUC	CTION TYPE	CODE			SHMMA	RY OF QUANTITIES				CC	ONSTRUCTIO	N TYPE CO	ODE
CODE NO	ITEM	UNIT	TOTAL QUANTITIES	100% STATE					CODE NO		ITEM	UNIT	TOTAL QUANTITIES	100% STATE				
				0044										0044				
20200100	EARTH EXCAVATION	CU YD	1596	1596					44000500	COMBINATION	CURB AND GUTTER REMOVAL	FOOT	10	10				
21101615	TOPSOIL FURNISH AND PLACE, 4"	SO YD	162	162					60250200	CATCH BASINS	TO BE ADJUSTED	EACH	3	3				
25200110	SODDING, SALT TOLERANT	SO YD	162	162					60603800	COMBINATION	CONCRETE CURB AND GUTTER,	FOOT	837	837				
										TYPE B-6.12								
25200200	SUPPLEMENTAL WATERING	UNIT	21. 7	21. 7														
28000510	INLET FILTERS	EACH	5	5					66400505	CHAIN LINK F	ENCE. 8'	FOOT	135	1 35				
									* 66900200	NON-SPECIAL	WASTE DISPOSAL	CU YD	1596	1596				
31101400	SUBBASE GRANULAR MATERIAL, TYPE B 6"	SO YD	7181	7181														
									* 66900530	SOIL DISPOSA	AL ANALYSIS	EACH	4	4				
40600275	BITUMINOUS MATERIALS (PRIME COAT)	POUND	15388	15388														
									* 66901001	REGULATED SL	UBSTANCES PRE-CONSTRUCTION	L SUM	1	1				
40600290	BITUMINOUS MATERIALS (TACK COAT)	POUND	1539	1539						PLAN								
40603085	HOT-MIX ASPHALT BINDER COURSE, IL-19.0.	TON	1149	1149					* 66901003	DECINATED CI	JBSTANCES FINAL CONSTRUCTION	L SUM	,	,				
10603083	N70	101	1173	1179					* 66301003	REPORT	DESTANCES FINAL CONSTRUCTION	L SUM	1	1				
										ing. on i								
40604062	HOT-MIX ASPHALT SURFACE COURSE, IL-9.5.	TON	575	575					* 66901006	REGULATED SU	UBSTANCES MONITORING	CAL DA	10	10				
	MIX "D", N70																	
									67100100	MOBILIZATION	ı	L SUM	1	1				
42001300	PROTECTIVE COAT	SO YD	321	321														
									70102620	TRAFFIC CONT	ROL AND PROTECTION,	L SUM	1	1				
42300600	PORTLAND CEMENT CONCRETE DRIVEWAY	SQ YD	312	312						STANDARD 701	501							
	PAVEMENT, 10 INCH																	
									* 72000100	SIGN PANEL -	· TYPE 1	SO FT	2	2				
44000100	PAVEMENT REMOVAL	SO YD	7181	7181														
									* 72900100	METAL POST -	· IYPE A	FOOT	11	11				
44000300	* SPECIALTY ITEMS	FOOT	734	734														
FILE NAME =	USER NAME = Rana.Kalo DE	ESIGNED -		REVISED -							I ANDCCADE MAINTEN	ANCE VARR	/AUGUSTA D		F.A.	SECTI	ON	COUNTY TOTAL SHEETS
pw:\\Ildot-pw.bentley.com		HECKED -		REVISED - REVISED - REVISED -				TATE OF ENT OF T	ILLINOIS RANSPORTA	TION	LANDSCAPE MAINTENA SUMMARY SCALE: SHEET NO. OF	Y OF QUANT	ITIES	LVU)		2023 LS YAR	D PARKING	CONTRACT NO. 62

	SUMMARY OF QUANTITIES				C	ONSTRUCTIO	ON TYPE CODE			SUMMA	RY OF QUANTITIES				CC	INSTRUCTION TYPE	CODE	
CODE NO	ITEM	UNIT	TOTAL QUANTITIES	100% STATE 0044					CODE NO		ITEM	UNIT	TOTAL QUANTITIES	100% STATE 0044				
78000100	THERMOPLASTIC PAVEMENT MARKING -	SO FT	5	5														+
	LETTERS AND SYMBOLS																	
78000200	THERMOPLASTIC PAVEMENT MARKING - LINE	FOOT	143	143														
	4"																	_
X4400501	COMBINATION CURB AND GUTTER REMOVAL AND	FOOT	40	40														
	REPLACEMENT LESS THAN OR EQUAL TO 10																	
	FEET																	
																		_
X4400503	COMBINATION CURB AND GUTTER REMOVAL AND	FOOT	20	20														\perp
	REPLACEMENT GREATER THAN 10 FEET																	_
x5537800	STORM SEWERS TO BE CLEANED 12"	FOOT	100	100														+
x6640300	CHAIN LINK FENCE REMOVAL	FOOT	135	1 35														
W. 700 40 7	FUOLUETRY C. F.I. D. OFFICE TARRED A COLU	041 140																+
X6700407	ENGINEER'S FIELD OFFICE, TYPE A (D1)	CAL MO	6	6														
Z0013798	CONSTRUCTION LAYOUT	L SUM	1	1														
Z0018500	DRAINAGE STRUCTURES TO BE CLEANED	EACH	5	5														_
																		1
																		+
																		+
																		-
	* SPECIALTY ITEMS																	
ILE NAME =		SIGNED -		REVISED		<u> </u>									l F A			TOTAL
	PWIDOT\Documents\DOT Offices\District \Projects\DIO7824\CADData\Design\DIO7824\sh\-S\DQ\district			REVISED	-		S	TATE OF IL	LINOIS			NTENANCE YARD		LVD)	F.A RTE.	SECTION 2023 LS YARD PARKING	COUNTY S	TOTAL SHEETS 15
		ECKED -		REVISED	-		DEPARTM	FNT OF TR	ANSPORTA	TION	SUN	IMARY OF QUANT	ITIES			FOED TO THEM PARKING	CONTRACT	


AUGUSTA BLVD MAINTENANCE YARD

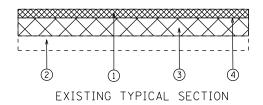

AUGUSTA BLVD MAINTENANCE YARD

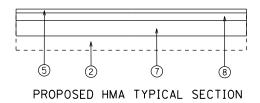

AUGUSTA BLVD MAINTENANCE YARD

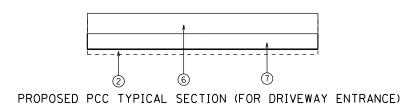

LEGEND

- 1 EXISTING HMA PAVEMENT (3"-5" TYP)
- 2 EXISTING SUBGRADE
- 3 PROPOSED SUBGRADE REMOVAL (EARTH EXCAVATION)
- (4) PROPOSED PAVEMENT REMOVAL (FULL DEPTH)
- (5) HOT-MIX ASPHALT SURFACE COURSE, MIX "D", N70 (IL-9.5), 1 1/2"
- 6 PROPOSED PCC DRIVEWAY PAVEMENT, 10"
- 7 PROPOSED SUBBASE GRANULAR MATERIAL TYPE B. 6"
- 8 PROPOSED HOT-MIX ASPHALT BINDER COURSE, IL-19.0, N70, 3"

NOTES

PROPOSED HMA AND PCC SECTIONS DO NOT HAVE THE SAME TOTAL DEPTH OF EXCAVATION. PLEASE BE AWARE OF ELEVATIONS WHILE EXCAVATING.

HOT-MIX ASPHALT MIXTURE REQUIREMENTS		QUALITY MANAGEMENT							
MIXTURE TYPE	AIR VOIDS(%) @ N _{DES}	PROGRAM (QMP)							
PAVEMENT RECONSTRUCTION									
HOT-MIX ASPHALT SURFACE COURSE, MIX "D", N70 (IL-9.5), 11/2"	4% @ 70 GYR	QC/QA							
HOT-MIX ASPHALT BINDER COURSE, IL-19.0, N70, 3"	4% @ 70 GYR	QC/QA							
QMP DESIGNATION: QUALITY CONTROL/QUALITY ASSURANCE(QA/QC); QUALITY CONTROL FOR PERFORMANCE(QCP);									


MIXTURE NOTES:


SCALE:

- 1. THE UNIT WEIGHT USED TO CALCULATE ALL HMA SURFACE MIXTURE QUANTITIES IS 112 LBS/SQ YD/IN.
- 2. THE "AC TYPE" FOR POLYMERIZED HMA MIXES SHALL BE "SBS/SBR PG 76-22" AND FOR NON-POLYMERIZED HMA THE "AC TYPE" SHALL BE "PG 64-22" UNLESS MODIFIED BY RECLAIMED MATERIALS SPECIFICATIONS.

USER NAME = \$USER\$	DESIGNED -	REVISED -
	DRAWN -	REVISED -
PLOT SCALE = \$SCALE\$	CHECKED -	REVISED -
PLOT DATE = SDATES	DATE -	REVISED -


LAND	SCAPE MA	AINTEN <i>A</i>	NCE YA	RD (AUG	USTA BLVD)	F.A. RTE	SECTION	COUNTY	TOTAL SHEETS	SHEET NO.
		TVDIC	AL SECT	IUNIS.		2023 LS YARD PARKING	COOK	15	6	
		11110	AL SLUI	IONS			CONTRACT	NO. 62	2W01	
SHEET 1 OF 1 SHEETS STA.					TO STA.		ILLINOIS FED. A	D PROJECT		

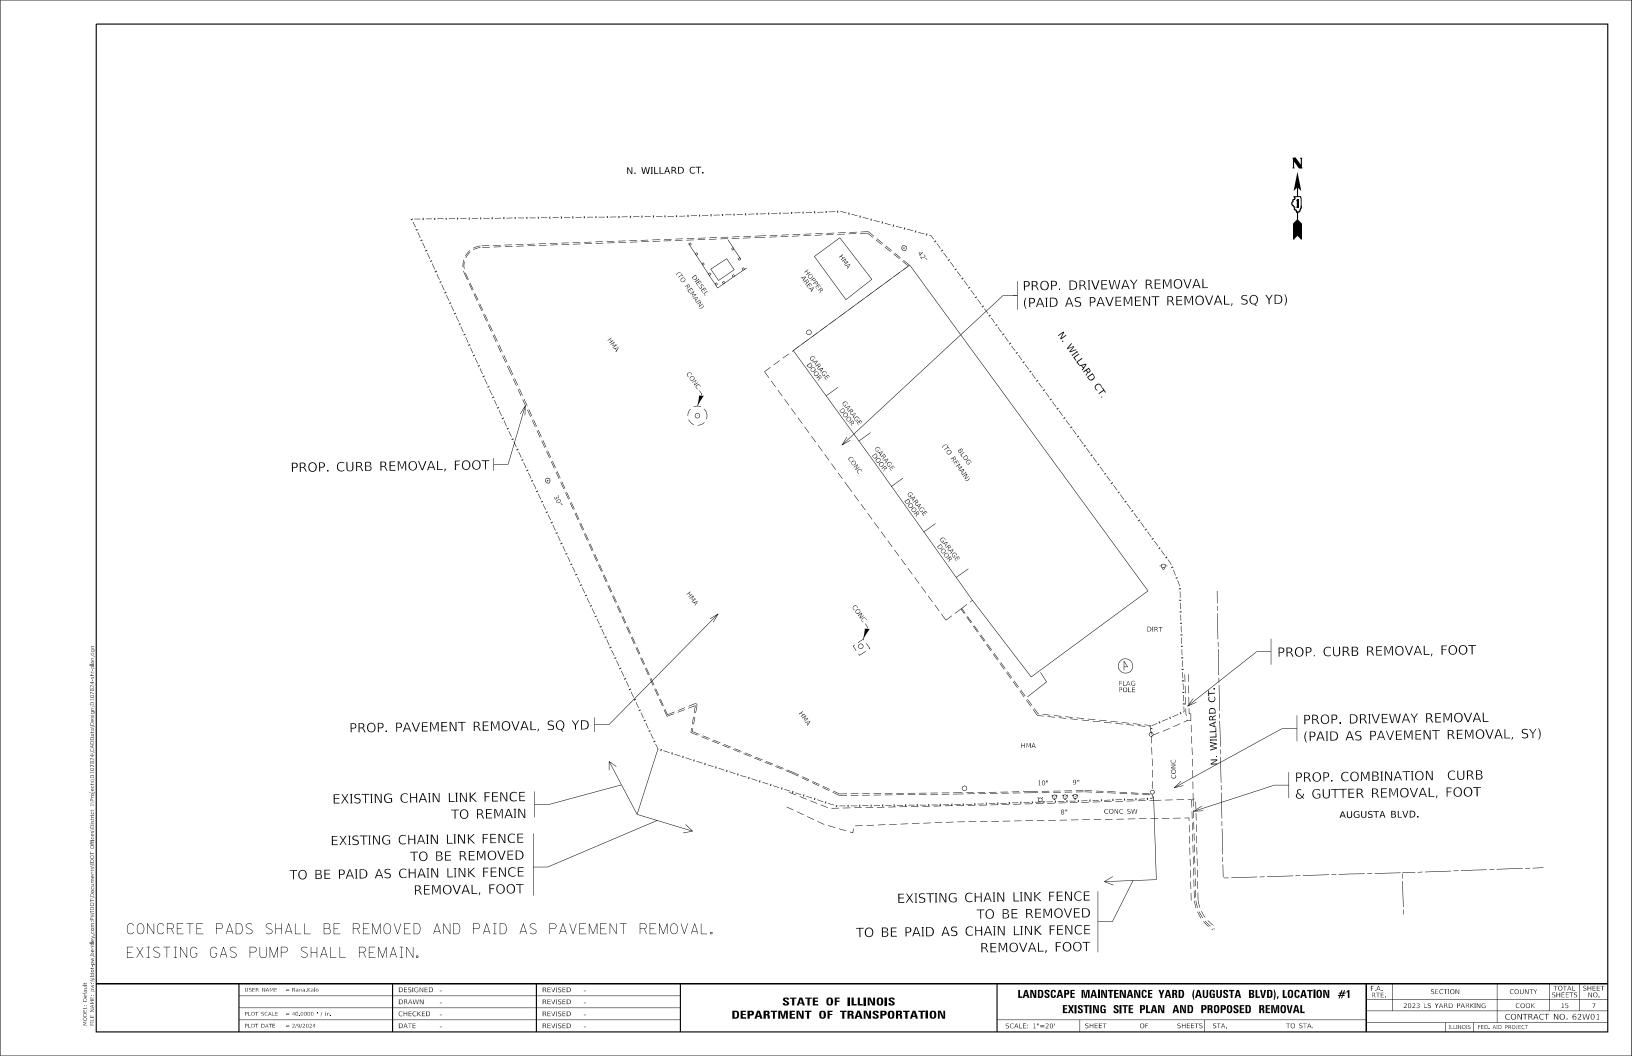


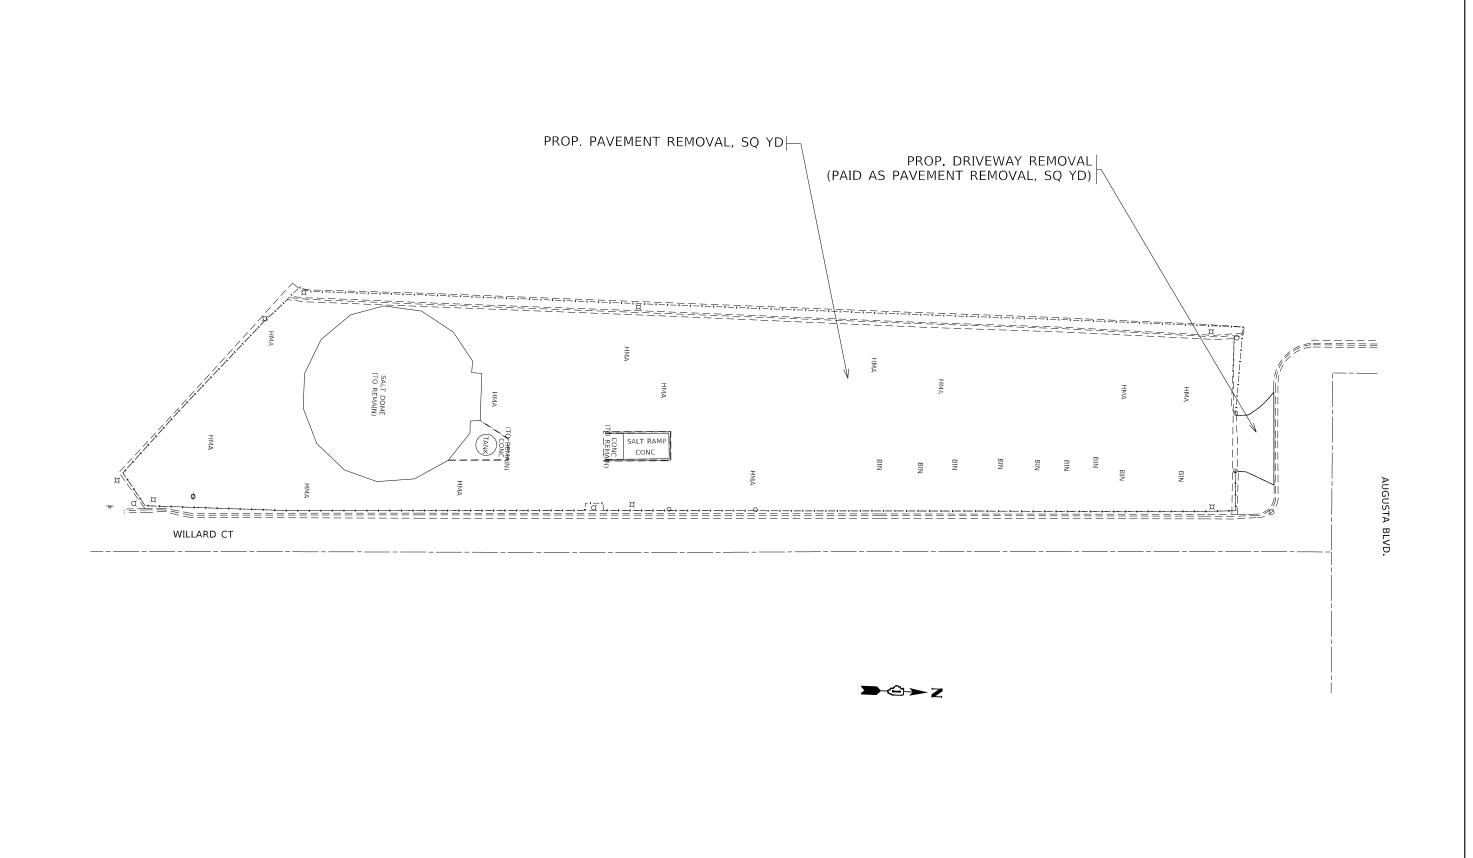

STATE OF ILLINOIS DEPARTMENT OF TRANSPORTATION LANDSCAPE MAINTENANCE YARD (AUGUSTA BLVD), LOCATION #2

EXISTING SITE PLAN AND PROPOSED REMOVAL

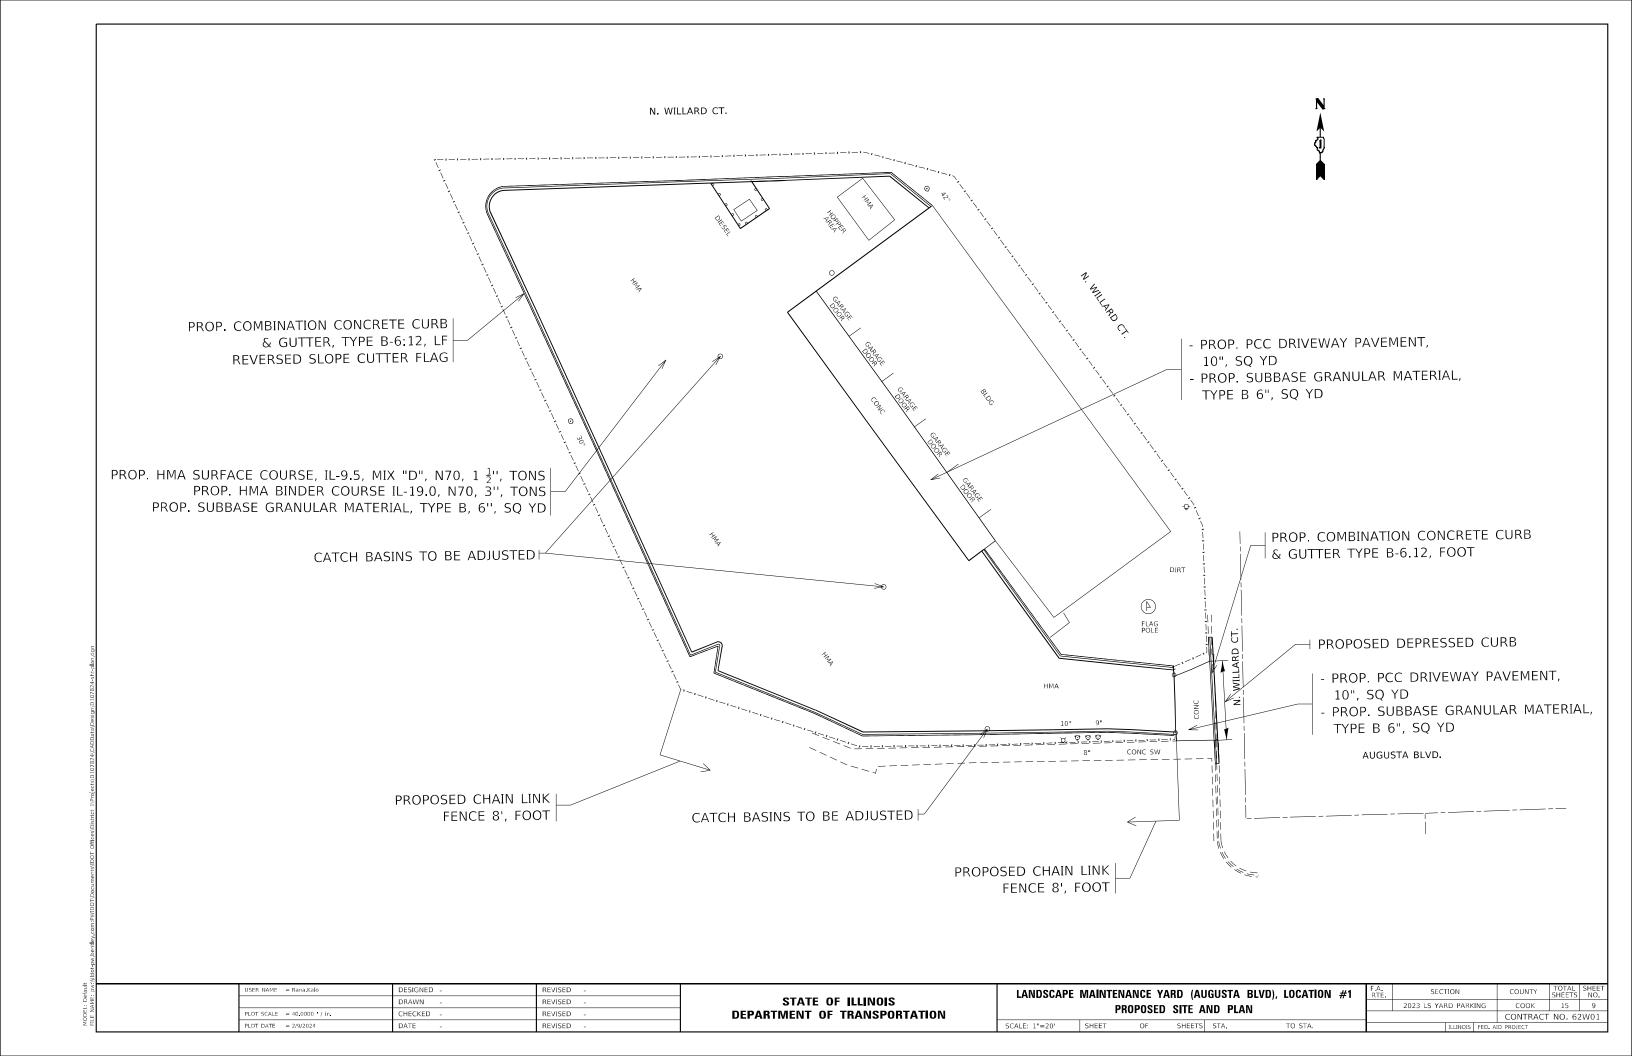


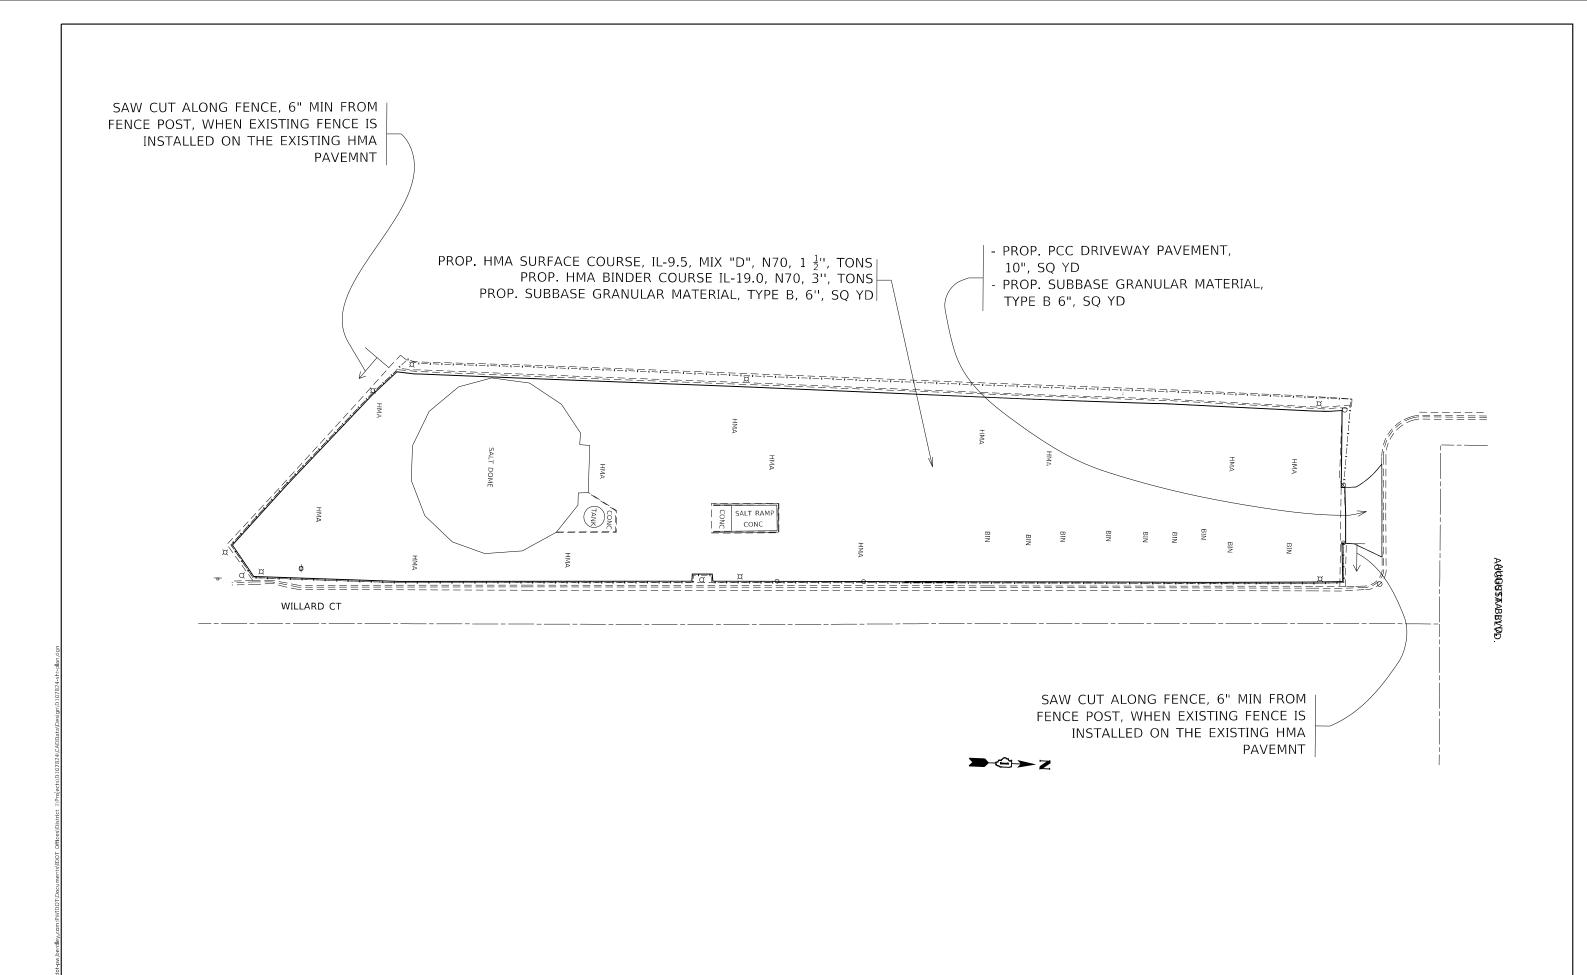

USER NAME = Rana Kalo	DESIGNED -	REVISED -
	DRAWN -	REVISED -
PLOT SCALE = 40.0000 / in.	CHECKED -	REVISED -
PLOT DATE = 2/9/2024	DATE -	REVISED -


STATE OF ILLINOIS
DEPARTMENT OF TRANSPORTATION

LANDSCAPE MAINTENANCE YARD (AUGUSTA BLVD), LOCATION #2	F.A. RTE	SECTION
PROPOSED SITE AND PLAN		2023 LS YARD PARKING
THO OCCU SHE AND TEAN		

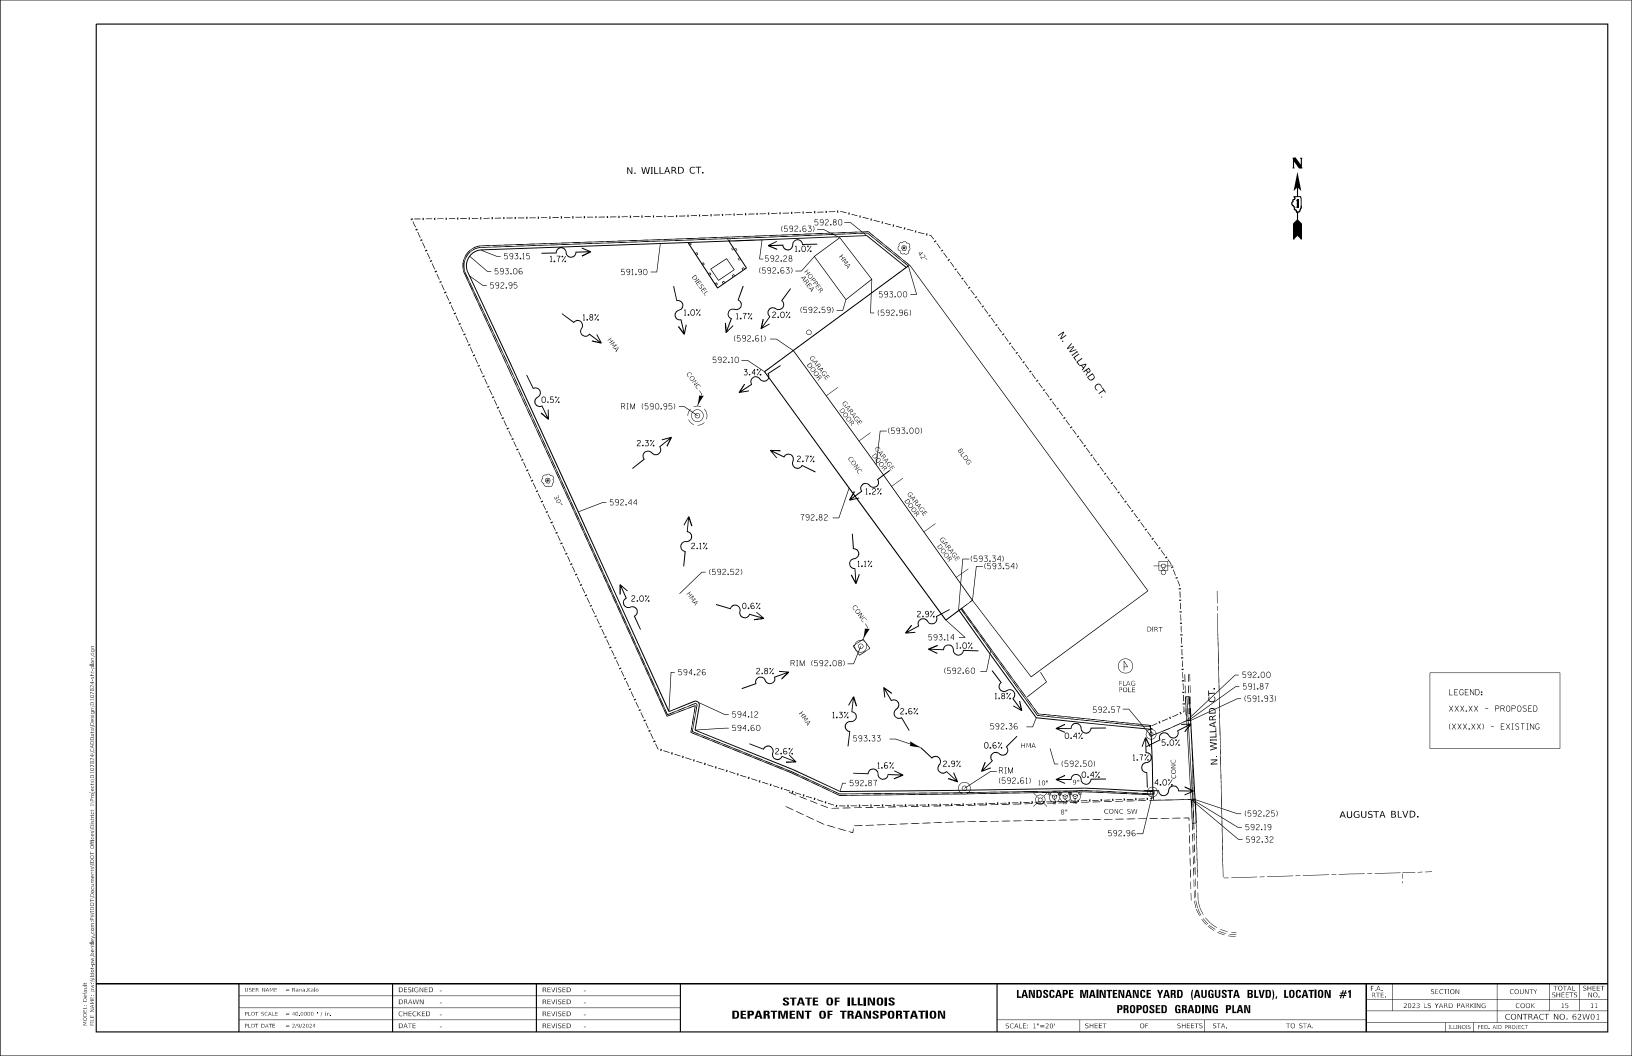

(XXX.XX) - EXISTING JSER NAME = Rana, Kalo DESIGNED -REVISED -SECTION LANDSCAPE MAINTENANCE YARD (AUGUSTA BLVD), LOCATION #2 COUNTY SHEETS NO.


COOK 15 12 STATE OF ILLINOIS DRAWN -REVISED -2023 LS YARD PARKING PROPOSED GRADING PLAN **DEPARTMENT OF TRANSPORTATION** CHECKED -REVISED -CONTRACT NO. 62W01 DATE SCALE: 1"=20' SHEET OF SHEETS STA.

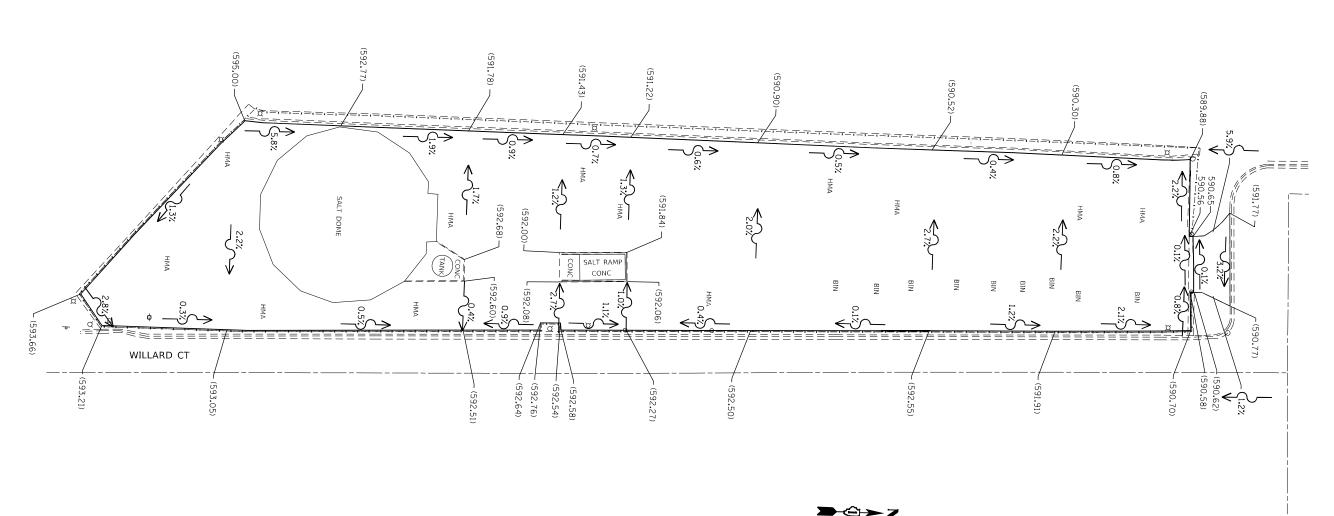


AUGUSTA BLVD.

LEGEND:


XXX.XX - PROPOSED

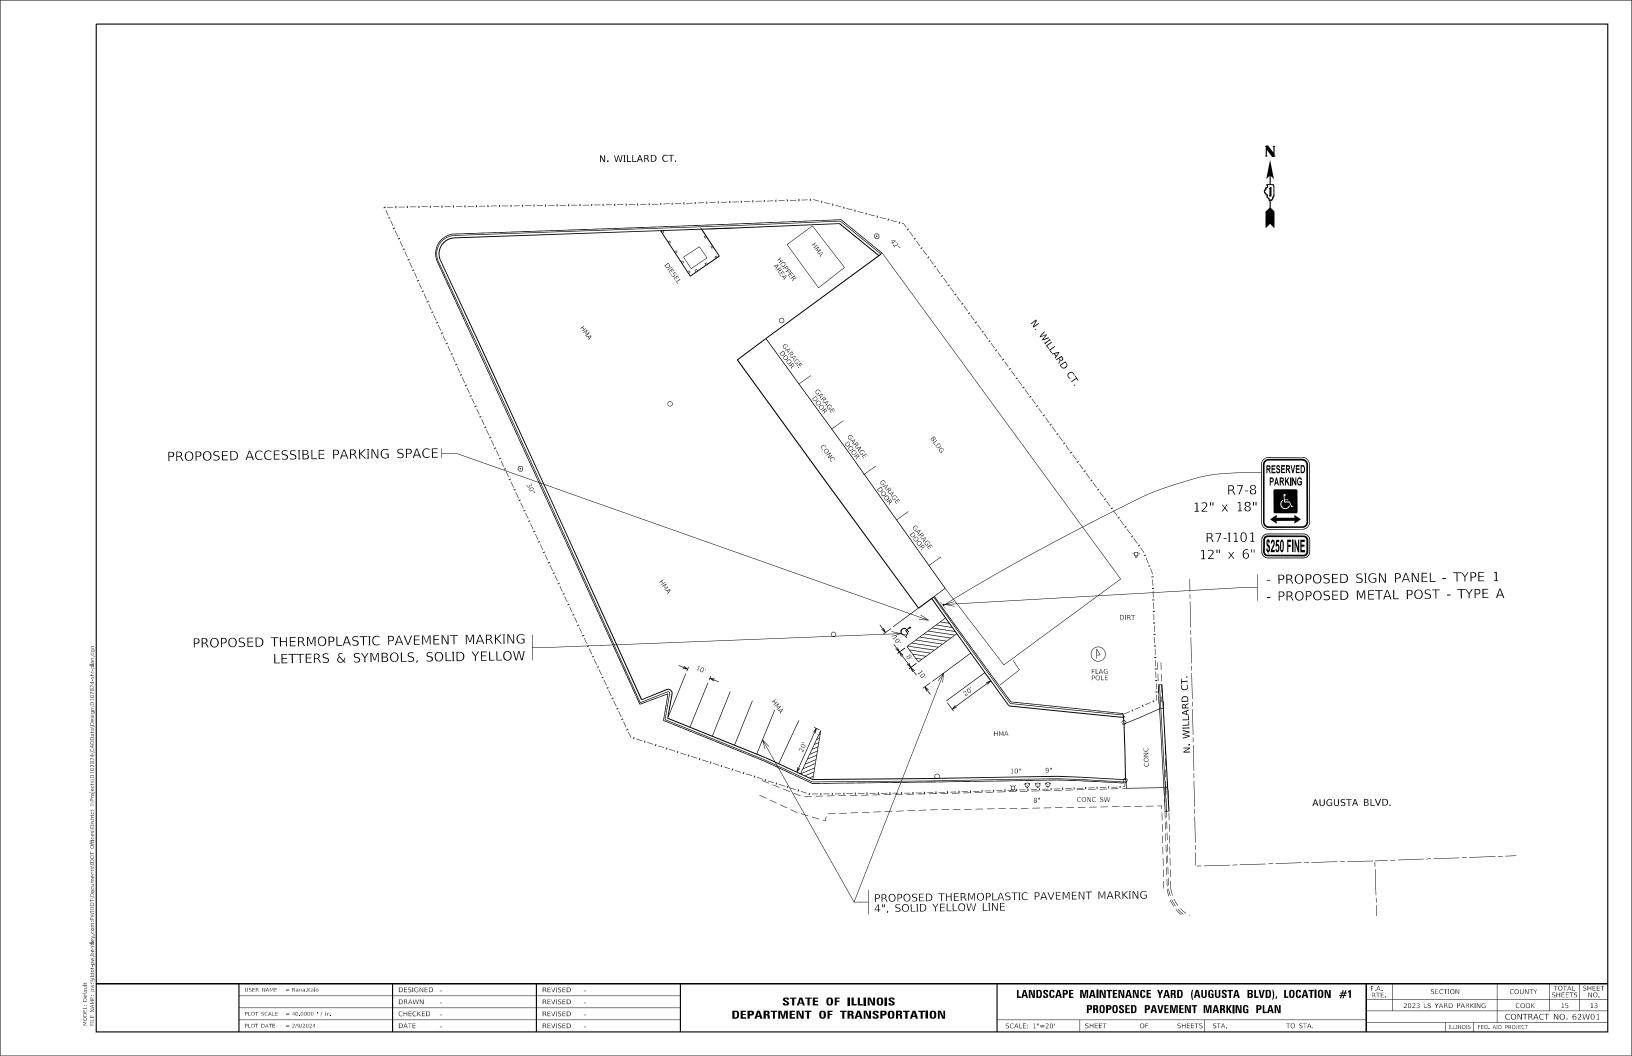



WITH CONCRETE CURB, TYPE B

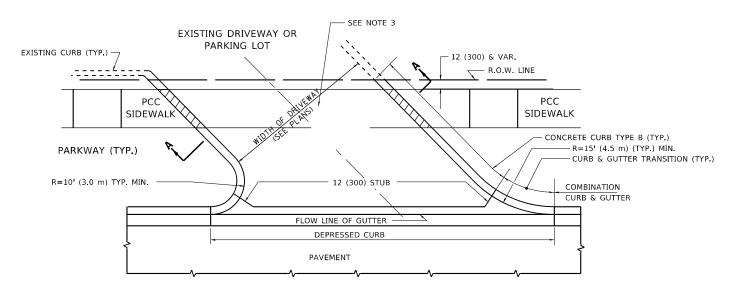

WITH CONCRETE CURB, TYPE B

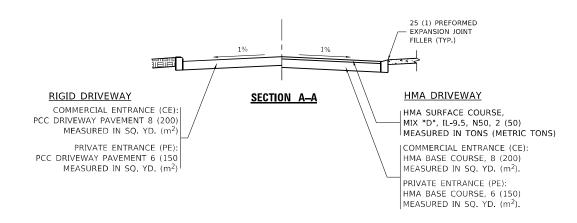

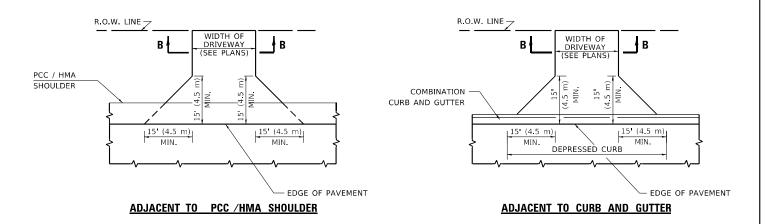

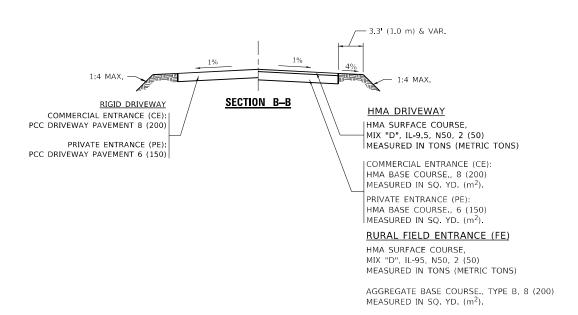

GENERAL NOTES

- DRIVEWAY SLOPES, LOCATIONS, & GEOMETRIC LAYOUT SHALL BE IN ACCORDANCE WITH THE LATEST EDITION OF THE "HANDBOOK FOR POLICY ON PERMITS FOR ACCESS DRIVEWAYS TO STATE HIGHWAYS". FOR FURTHER LAYOUT REQUIREMENTS, REFER TO ILLUSTRATIONS IN THE PERMIT HANDBOOK. DRIVEWAYS SHALL BE REPLACED IN KIND, UNLESS OTHERWISE NOTED ON THE PLANS.
- COMMERCIAL DRIVEWAYS SHALL BE CONSTRUCTED WITH CONCRETE CURB, TYPE B RETURNS EXCEPT WHEN THE SIDEWALK EDGE IS 4 FEET (1.2 METERS) OR LESS FROM THE BACK OF CURB, CONSTRUCT A FLARE DRIVEWAY WITHOUT CURB.


SCALE: NONE

ALL DIMENSIONS ARE IN INCHES (MILLIMETERS) UNLESS OTHERWISE NOTED.

USER NAME = Rana Kalo	DESIGNED - R. SHAH	REVISED - R. BORO 06-11-08
	DRAWN -	REVISED - R. BORO 09-06-11
PLOT SCALE = 100.0000 / in.	CHECKED -	REVISED - K. SMITH 08-28-19
PLOT DATE = 2/9/2024	DATE 11-04-95	REVISED K SMITH 11-18-22

STATE OF ILLINOIS
DEPARTMENT OF TRANSPORTATION

DRIV	EWAY DETA	AILS -	– DISTAN	CE BETWEEN	N R.O.W.	F.A. RTE	SECTION	COUNTY	TOTAL SHEETS	SHEET NO.
AND E	ACE OF CITE	2R &.	EDGE OF	CHUIII DEB	> 15'(4.5m)		2023 LS YARD PARKING	соок	15	14
AND I	AUL UI UUI	טו עו	LDGL OI	SHOOLDEH	<u> </u>	В	D400-01 (BD-01)	CONTRACT NO. 62W01		
IONE	SHEET 1	OF 1	SHEETS	STA	TO STA		TUTMOTE FED. A	D DROJECT		$\overline{}$

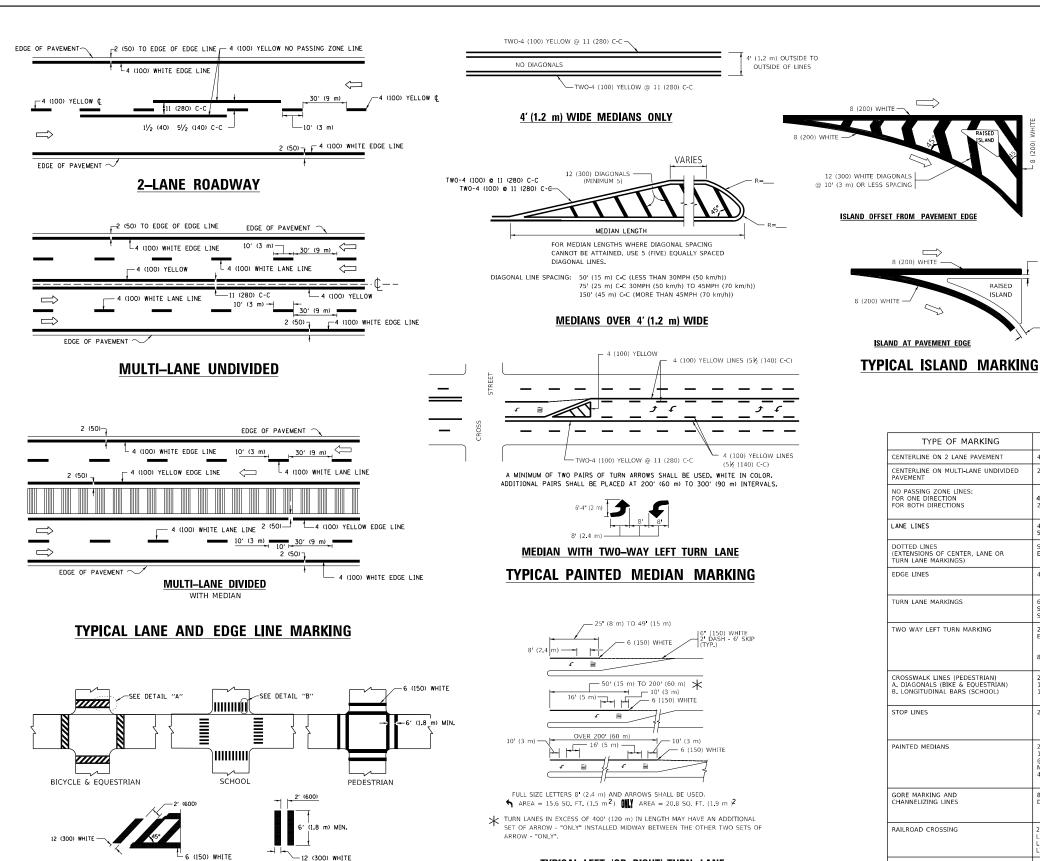

TYPICAL LEFT (OR RIGHT) TURN LANE

TYPICAL TURN LANE MARKING

JSER NAME = Rana.Kalo EVERS DESIGNED -C. JUCIUS 09-09-09 DRAWN REVISED C. JUCIUS 07-01-13 HECKED REVISED

DETAIL "B"

DATE

DETAIL "A"

TYPICAL CROSSWALK MARKING

* MARKINGS SHALL BE INSTALLED PARALLEL TO THE CENTERLINE OF

STATE OF ILLINOIS **DEPARTMENT OF TRANSPORTATION**

	FOR FURTHER DETAILS ON PAVEMENT MARKING REFER TO STANDARD SPECIFICATIONS FOR ROAD AND BRIDGE CONSTRUCTION AND STATE STANDARD 780001.		All dimensions are in inches (milliounless otherwise shown.	meters)		
	DISTRICT ONE	F.A. RTE	SECTION	COUNTY	TOTAL SHEETS	SHEET NO.
-	TYPICAL PAVEMENT MARKINGS		2023 LS YARD PARKING	COOK	15	15
١	TITIOAL LAVENENT WANKINGS		TC-13	CONTRACT	NO. 62	W01
- 1	SCALE: NONE SHEET 1 OF 2 SHEETS STA. TO STA.		ILLINOIS FED. AI	D PROJECT		

6'-4" (1930) 36 40 (910) (1020) 6 2 10 10 10 10 10 10 10 10 10 10 10 10 10	D(FT) SPEED LIMIT 345 30 425 35 500 40 580 45 665 50 750 55
20 (510) COMBINATION LEFT AND U—TURN	
20 (510) 20 (51	LANE REDUCTION TRANSITION LANE REDUCTION ARROWS REQUIRED AT SPEEDS OF 45 MPH OR GREATER OR WHEN SPECIFIED IN PLANS.
	CDACING / DEMARKS

TYPE OF MARKING	WIDTH OF LINE	PATTERN	COLOR	SPACING / REMARKS
CENTERLINE ON 2 LANE PAVEMENT	4 (100)	SKIP-DASH	YELLOW	10' (3 m) LINE WITH 30' (9 m) SPACE
CENTERLINE ON MULTI-LANE UNDIVIDED PAVEMENT	2 @ 4 (100)	SOLID	YELLOW	11 (280) C-C
NO PASSING ZONE LINES: FOR ONE DIRECTION FOR BOTH DIRECTIONS	4 (100) 2 @ 4 (100)	SOLID SOLID	YELLOW YELLOW	5½ (140) C-C FROM SKIP-DASH CENTERLINE 11 (280) C-C OMIT SKIP-DASH CENTERLINE BETWEEN
LANE LINES	4 (100) 5 (125) ON FREEWAYS	SKIP-DASH SKIP-DASH	WHITE WHITE	10' (3 m) LINE WITH 30' (9 m) SPACE
DOTTED LINES (EXTENSIONS OF CENTER, LANE OR TURN LANE MARKINGS)	SAME AS LINE BEING EXTENDED	SKIP-DASH	SAME AS LINE BEING EXTENDED	2' (600) LINE WITH 6' (1.8 m) SPACE
EDGE LINES	4 (100)	SOLID	YELLOW-LEFT WHITE-RIGHT	OUTLINE MEDIANS IN YELLOW
TURN LANE MARKINGS	6 (150) LINE; FULL SIZE LETTERS & SYMBOLS (8' (2.4m))	SOLID	WHITE	SEE TYPICAL TURN LANE MARKING DETAIL
TWO WAY LEFT TURN MARKING	2 @ 4 (100) EACH DIRECTION 8' (2.4m) LEFT ARROW	SKIP-DASH AND SOLID IN PAIRS	YELLOW	10' (3 m) LINE WITH 30' (9 m) SPACE FOR SKIP-DASH: 5½ (140) C-C BETWEEN SOLID LINE AND SKIP-DASH LINE SEE TYPICAL TWO-WAY LEFT TURN MARKING DETAIL
CROSSWALK LINES (PEDESTRIAN) A. DIAGONALS (BIKE & EQUESTRIAN) B. LONGITUDINAL BARS (SCHOOL)	2 @ 6 (150) 12 (300) @ 45° 12 (300) @ 90°	SOLID SOLID SOLID	WHITE WHITE WHITE	NOT LESS THAN 6' (1.8 m) APART 2' (600) APART 2' (600) APART SEE TYPICAL CROSSWALK MARKING DETAILS.
STOP LINES	24 (600)	SOLID	WHITE	PLACE 4' (1.2 m) IN ADVANCE OF AND PARALLEL TO CROSSWALK, IF PRESENT, OTHERWISE, PLACE AT DESIRED STOPPING POINT. PARALLEL TO CROSSROAD CENTERLINE, WHERE POSSIBLE
PAINTED MEDIANS	2 @ 4 (100) WITH 12 (300) DIAGONALS @ 45° NO DIAGONALS USED FOR 4' (1.2 m) WIDE MEDIANS	SOLID	YELLOW: TWO WAY TRAFFIC WHITE: ONE WAY TRAFFIC	11 (280) C-C FOR THE DOUBLE LINE SEE TYPICAL PAINTED MEDIAN MARKING.
GORE MARKING AND CHANNELIZING LINES	8 (200) WITH 12 (300) DIAGONALS @ 45°	SOLID	WHITE	DIAGONALS: 15' (4.5 m) C-C (LESS THAN 30MPH (50 km/h)) 20' (6 m) C-C 30MPH (50 km/h) TO 45MPH (70 km/h)) 30' (9 m) C-C (OVER 45MPH (70 km/h))
RAILROAD CROSSING	24 (600) TRANSVERSE LINES: "RR" IS 6' (1.8 m) LETTERS; 16 (400) LINE FOR "X"	SOLID	WHITE	SEE STATE STANDARD 780001 AREA OF: "R"=3.6 SQ. FT. (0.33 m PEACH "X"=54.0 SQ. FT. (5.0 m)2
SHOULDER DIAGONALS (REQUIRED FOR SHOULDERS > 8')	12 (300) @ 45°	SOLID	WHITE - RIGHT YELLOW - LEFT	50' (15 m) C-C (LESS THAN 30MPH (50 km/h)) 75' (25 m) C-C (30 MPH (50 km/h) TO 45MPH (70 km/h)) 150' (45 m) C-C (OVER 45MPH (70 km/h))
U TURN ARROW	SEE DETAIL	SOLID	WHITE	16.3 SF
2 ARROW COMBINATION LEFT AND U TURN	SEE DETAIL	SOLID	WHITE	30.4 SF

8 (200) WHITE -

— 2 (50)

2 (50)

RAISED