


STATE OF ILLINOIS

# **PLANS FOR PROPOSED**

SECTION 12-00147-11-CH **PROJECT AJKB(163)** WILL COUNTY

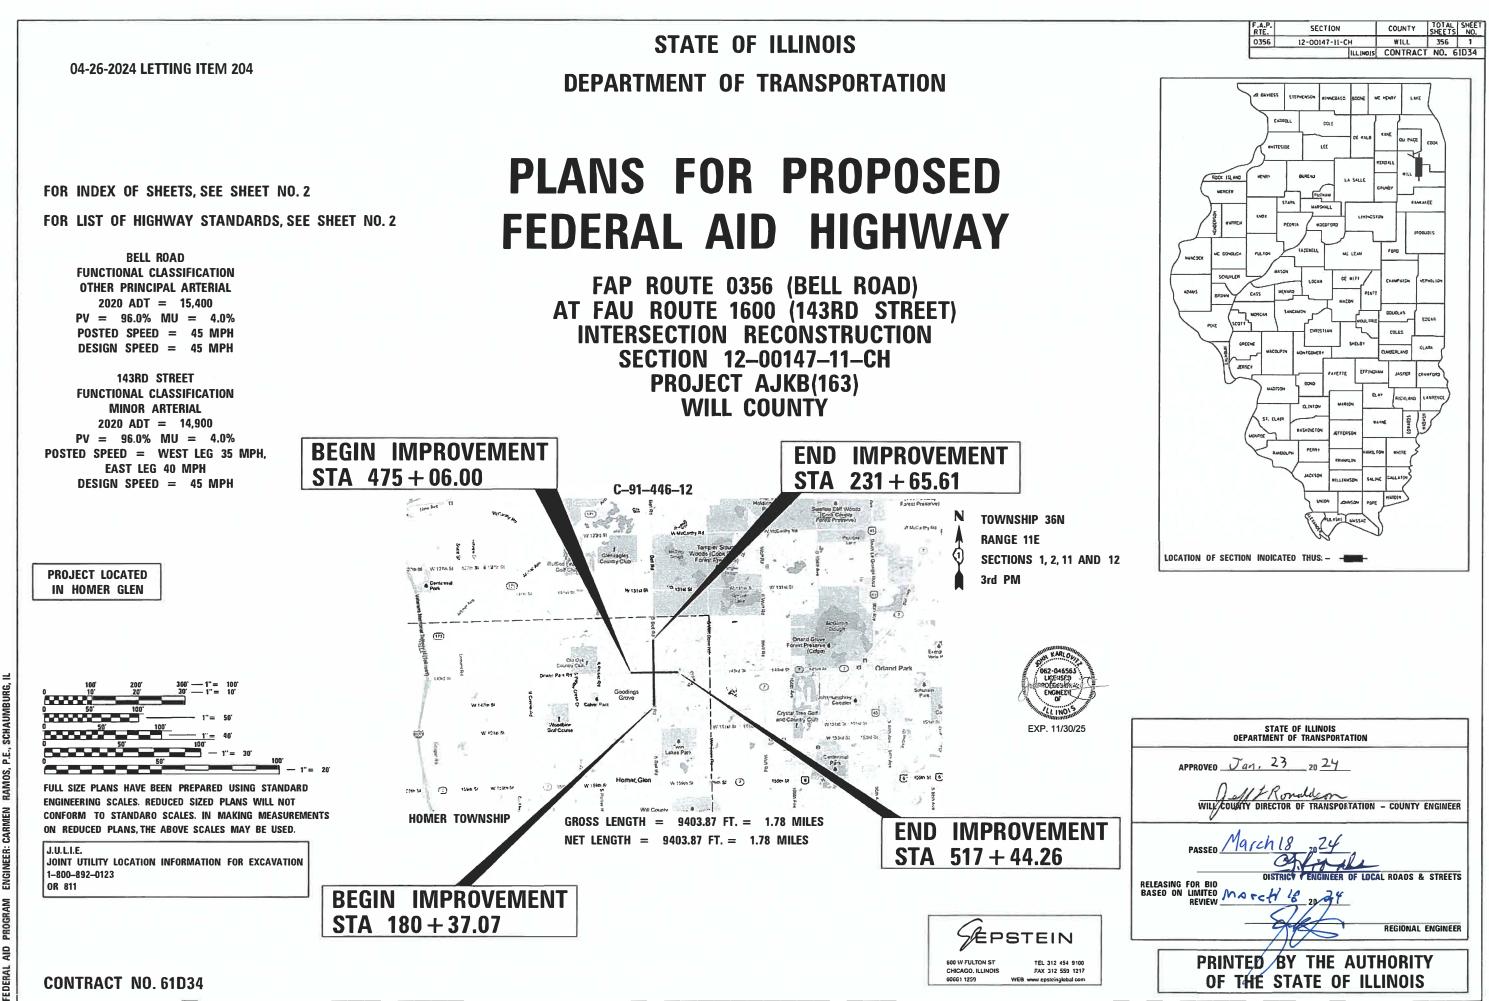

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# **UTILITIES AND AGENCIES INVOLVED:**

NAPERVILLE, IL 60563 1000 COMMERCE DRIVE 1000 INTERNATIONALE PARKWAY 14400 W 151ST STREET JASON JARVIS IC-22 ARTERIAL ROAD INFORM	1 LINCOLN CENTERCOMCAST CABLE 688 INDUSTRIAL DRIVE 0AKBROOK TERRACE, IL 60181 NICK TULEJA 440-796-8979 NICHOLAS.TULEJA@ComEd.COMADESTA A G4S COMPANY 565 WILLOWBROOK CENTRE PKWY 565 WILLOWBROOK CENTRE PKWY 565 WILLOWBROOK CENTRE PKWY BOB SULLIVAN BOB SULLIVAN BOB SULLIVAN BOB SULLIVAN BOB SULLIVAN@AUS.COMNORTHERN BORDER PIPELINE S27 N. LIBERTY STREET 827 N. LIBERTY STREET 200 E. RANDOLPH ST. SUITE 5100 CHICAGO, IL 60601 WILLOWRROK, IL 60521 BD-08 BD-	DRIVEWAY DETAILS - DISTANCE DRIVEWAY DETAILS DISTANCE BE DETAIL OF STORM SEWER CONNE DETAILS FOR FRAMES AND LIDS MANHOLE WITH RESTRICTOR PLA' TRAFFIC CONTROL AND PROTECT TYPICAL APPLICATIONS RAISED DISTRICT ONE TYPICAL PAVEMEN SHORT TERM PAVEMENT MARKING ARTERIAL ROAD INFORMATION SI DRIVEWAY ENTRANCE SIGNING
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**DISTRICT ONE DETAILS** 

**HIGHWAY STANDARDS** 

### **COMMITMENTS**

TREES 3" IN DIAMETER OR GREATER SHALL NOT BE CLEARED FROM APRIL 1ST THROUGH SEPTEMBER 30TH OF ANY GIVEN YEAR.

FILE NAME =	DESIGNED - CS	REVISED -	(A		UTILITY CONTACTS, INDEX OF SHEETS,	F.A.P. SECTION	COUNTY TOTAL SHEET SHEETS NO.
\WillCo-sht001-index.dgn	DRAWN - CS	REVISED -		STATE OF ILLINOIS	DISTRICT ONE DETAILS AND HIGHWAY STANDARDS	0356 12-00147-11-CH	WILL 356 2
PLOT TIME = 9:56:35 AM	CHECKED - JK	REVISED -	600 W FULTON ST TEL 312 454 9100	DEPARTMENT OF TRANSPORTATION	DISTRICT ONE DETAILS AND HIGHWAT STANDARDS		CONTRACT NO. 61D34
PLOT DATE = 3/18/2024	DATE - 03/18/2024	REVISED -	CHICAGO, ILLINOIS FAX 312 559 1217 60661-1259 WEB www.epsteinglobal.com		SCALE: N/A SHEET 1 OF 1 SHEETS STA. N/A TO STA. N/A	(ILL INOIS FED.	AID PROJECT

TANCE BETWEEN R.O.W. AND FACE OF CURB & EDGE OF SHOULDER >= 15' (4.5m) ANCE BETWEEN ROW AND FACE OF CURB < 15' (4.5m) CONNECTION TO EXISTING SEWER LIDS ADJUSTMENT WITH MILLING OR PLATE RAISED REFLECTIVE PAVEMENT MARKERS (SNOW-PLOW RESISTANT) PAVEMENT MARKINGS MARKING LETTERS AND SYMBOLS TION SIGN

L SYSTEMS FOR SIDEWALKS SIDEWALKS CROSSINGS PIPE CULVERTS 15" (375 MM) THRU 84" (2100 MM) DIAMETER ETE FLARED END SECTION 4' DIAMETER 6' DIAMETER 7' DIAMETER 8' DIAMETER 9' DIAMETER 10' DIAMETER ETE FLAT SLAB TOP COMBINATION CONCRETE CURB AND GUTTER **EDIANS** TYPE 2 2W, MORE THAN 15' (4.5 M) AWAY 2W, 15' (4.5 M) TO 24'' (600 MM) FROM PAVEMENT EDGE TILANE, 15' (4.5 M) TO 24" (600 MM) FROM PAVEMENT EDGE TILANE, MORE THAN 15' (4.5 M) AWAY ONLY, FOR SPEEDS >= 45 MPH EMENT WIDENING, FOR SPEEDS >= 45 MPH INTERMITTENT OR MOVING OPER., FOR SPEEDS <= 40 MPH W, UNDIVIDED ILANE, 1W OR 2W WITH NONTRAVERSABLE MEDIAN ILANE, 2W, WITH BIDIRECTIONAL LEFT TURN LANE E, MULTILANE, 2W WITH MOUNTABLE MEDIAN ILANE INTERSECTION SWALK CLOSURE [LS IS. ARKERS AND DELINEATORS **JPPORT** ON DIAGRAMS AND PHASE SEQUENCES PPLY (UPS) & BONDING AND POLE 16' THROUGH 55' AND POLE 56' THROUGH 75' ARM ASSEMBLY AND POLE 16' THROUGH 55' RM ASSEMBLY AND POLE 56' THROUGH 75' ILS

AND FLASHING BEACON INSTALLATION DETAILS

## **GENERAL NOTES**

- 1. BEFORE STARTING ANY EXCAVATION, THE CONTRACTOR SHALL CALL JOINT UTILITY LOCATION INFORMATION FOR EXCAVATION (J.U.L.I.E.) AT 1-800-892-0123 OR 811 FOR FIELD LOCATIONS OF BURIED UTILITIES (48 HOURS NOTIFICATION IS REQUIRED).
- 2. 10 FT TRANSITIONS SHALL BE USED TO MATCH PROPOSED ITEMS OF WORK TO EXISTING ITEMS IN THE FIELD, UNLESS OTHERWISE SHOWN.
- 3. THE CONTRACTOR SHALL COORDINATE CONSTRUCTION ACTIVITIES WITH UTILITY COMPANIES, WILL COUNTY, VILLAGE OF HOMER GLEN AND HOMER TOWNSHIP.
- 4. THE CONTRACTOR WILL NOT BE ALLOWED TO SET UP A YARD OR FIELD OFFICE, OR STORE EQUIPMENT/MATERIALS ON COUNTY PROPERTY WITHOUT WRITTEN PERMISSION FROM THE DEPARTMENT.
- 5. ALL ELEVATIONS REFER TO NAVD88 DATUM.
- 6. FOR STABILIZATION, ALL TYPE III BARRICADES SHALL REQUIRE A MINIMUM OF FOUR SANDBAGS PER BARRICADE.
- 7. THE CONTRACTOR SHALL TAKE CARE TO MAINTAIN POSITIVE SEWER FLOW AT ALL TIMES.
- 8. ALL STORM SEWER PIPE LENGTHS ARE MEASURED FROM CENTER OF STRUCTURE TO CENTER OF STRUCTURE. BEFORE ORDERING STORM SEWERS, CATCH BASINS, PIPE CULVERTS, PIPE DRAINS, AND MANHOLES, THE CONTRACTOR SHALL CONTACT THE ENGINEER AS TO THE EXACT LENGTH AND QUANTITY REQUIRED.
- 9. ALL EXISTING RAISED REFLECTIVE PAVEMENT MARKERS SHALL BE REMOVED AND ADEQUATELY BACKFILLED (NO COLD PATCH) PRIOR TO PLACING THE ASPHALT BINDER AND SURFACE COURSE.
- 10. ALL COUNTY ROW MONUMENTATION (BOUNDARY CORNERS) SHALL BE ACCORDING TO ARTICLE 1.7.13 OF THE PERMIT REGULATIONS UTILIZING THE "WILL COUNTY DEPARTMENT OF HIGHWAYS (WCDH) MONUMENTATION STANDARD".
- 11. EXCAVATION AND PAVEMENT WIDENING ON BOTH SIDES OF THE PAVEMENT AT ANY ONE LOCATION AT THE SAME TIME WILL NOT BE PERMITTED PER ARTICLE 701.08.
- 12. PORTABLE/CHANGEABLE ELECTRONIC MESSAGE BOARDS SHALL BE USED IN ADVANCE OF THE PROJECT AT THE BEGINNING AND END ACCORDING TO IDOT STANDARDS AND SHALL BE IN PLACE A MINIMUM OF ONE WEEK PRIOR TO COMMENCING THE WORK AND REMAIN THROUGHOUT THE ROADWAY CONSTRUCTION WORK.
- 13. ALL CONSTRUCTION MATERIALS WITHIN THE COUNTY ROW MUST BE IDOT CERTIFIED. DOCUMENTATION OF MATERIAL CERTIFICATION SHALL BE SUBMITTED PRIOR TO ENGINEER APPROVAL. ALL CONSTRUCTION MATERIAL NEEDING INSPECTION SHALL BE DONE ACCORDING TO THE LATEST IDOT PROJECT AND PROCEDURES GUIDE.
- 14. A PROOF ROLL OF THE SUBGRADE IS REQUIRED PRIOR TO PLACING THE AGGREGATE SUBGRADE AND MUST BE OBSERVED BY A CERTIFIED TESTING COMPANY. THE ENGINEER AND COUNTY MUST BE NOTIFIED A MINIMUM OF 48 HOURS PRIOR TO PERFORMING THE PROOF ROLL.
- 15. ALL CONSTRUCTION TO BE ACCORDING TO I.D.O.T. DESIGN AND STANDARD SPECIFICATIONS, MUST ADHERE TO THE WILL COUNTY DIVISION OF TRANSPORTATION PERMIT REGULATIONS AND ACCESS CONTROL REGULATIONS, AND SHALL FOLLOW THE LATEST WILL COUNTY STORM WATER MANAGEMENT ORDINANCE AND WILL COUNTY WATER RESOURCE ORDINANCE AT ALL TIMES.
- 16. BACKFILLING STORM SEWER CONSTRUCTED UNDER THE ROADWAY SHALL BE DONE WITH CONTROLLED LOW-STRENGTH MATERIAL. USE OF TRENCH BACKFILL AS SPECIFIED UNDER ART. 550.07(B,C) OF THE STANDARD SPECIFICATIONS SHALL NOT BE ALLOWED.
- 17. SAW CUTTING WILL BE REQUIRED FOR ALL REMOVAL ITEMS LISTED IN SECTION 440 OF THE STANDARD SPECIFICATIONS, SHOWN IN THE PLANS, AND AS DIRECTED BY THE ENGINEER.
- 18. BACKFILLING STORM SEWER CONSTRUCTED UNDER THE ROAD SHALL BE DONE WITH CLSM. USE OF TRENCH BACKFILL AS SPECIFIED UNDER ART. 550.07(b,c) OF THE SSRBC SHALL NOT BE ALLOWED.

- 19. THE CONTRACTOR IS REQUIRED TO COMPLY WITH THE NATIONAL POLLUTANT DISCHARGE ELIMINATION SYSTEM (NPDES) PERMIT NO. ILR 10 ISSUED BY THE ILLINOIS ENVIRONMENTAL PROTECTION AGENCY (IEPA) FOR STORMWATER DISCHARGES AND CONSTRUCTION SITE ACTIVITIES.
- 20. THE FOLLOWING RATES OF APPLICATION HAVE BEEN USED IN CALCULATING PLAN QUANTITIES:

N.	ROGEN FERTILIZER NUTRIENT	B/ACRE
	SPHORUS FERTILIZER NUTRIENT	
	ASSIUM FERTILIZER NUTRIENT	

- 21. ALL REFERENCES TO "STANDARD SPECIFICATIONS" IN THESE NOTES SHALL BE INTERPRETED TO MEAN "STANDARD SPECIFICATIONS FOR ROAD AND BRIDGE CONSTRUCTION" ADOPTED BY THE ILLINOIS DEPARTMENT OF TRANSPORTATION JANUARY 1, 2022. ALL WORK TO BE COMPLETED IN ACCORDANCE WITH THE STANDARD SPECIFICATIONS.
- 22. THE AGGREGATE GRADATION FOR THE AGGREGATE SUBGRADE IMPROVEMENT 12" LOWER LIFT SHALL BE CS 1 OR RR 1.
- 23. THE WILL COUNTY DIVISION OF TRANSPORTATION MUST BE NOTIFIED A MINIMUM OF SEVEN (7) WORKING DAYS IN ADVANCE OF ANY CONSTRUCTION WITHIN THE RIGHT-OF-WAY.
- 24. RECORD DRAWINGS SHALL BE PREPARED IN ACCORDANCE WITH WCDOT REQUIREMENTS AND SHALL BE SUBMITTED IN ELECTRONIC FORMAT.
- 25. THE CONTRACTOR SHALL TAKE CARE IN REMOVING OR EXCAVATING NEAR ALL EXISTING ITEMS TO REMAIN.
- 26. THE CONTRACTOR SHALL IDENTIFY WORK THAT CAN BE COMPLETED PRIOR TO COMPLETION OF UTILITY RELOCATION ACTIVITIES AND SUBMIT A WRITTEN WORK PLAN TO THE ENGINEER FOR REVIEW AND APPROVAL. IT IS EXPECTED THAT CERTAIN AREAS WITHIN THE LIMITS OF IMPROVEMENT WILL BE AVAILABLE WHERE WORK CAN BE PERFORMED BEFORE MAY 1, 2025 AND THAT THE CONTRACTOR SHALL CONSTRUCT ALL PRE-STAGE IMPROVEMENTS THAT DO NOT CONFLICT WITH UTILITY RELOCATION ACTIVITIES AS SOON AS PRACTICAL FOLLOWING THE EXECUTION OF THE CONTRACT. THE CONTRACTOR SHALL PERFORM THIS WORK UPON RECEIPT OF WRITTEN APPROVAL BY THE ENGINEER. THE CONTRACTOR SHALL NOT COMPLETE ANY PRE-STAGE WORK THAT IS IMPACTED BY UTILITY RELOCATIONS STARTING PRIOR TO MAY 1, 2025. NO ADJUSTMENT TO THE CONTRACT COMPLETION DATE WILL BE MADE SHOULD THE CONTRACTOR PERFORM OTHER WORK PRIOR TO THE COMPLETION OF UTILITY RELOCATIONS. NO EXTENSION OF THE CONTRACT COMPLETION DATE WILL BE MADE SHOULD THE CONTRACTOR ELECT TO NOT PERFORM OTHER WORK PRIOR TO MAY 1, 2025.
- 27. CONTRACTOR SHALL TAKE PRECAUTION BY PRESERVING EXISTING TREES WITHIN THE RIGHT OF WAY. IF ANY DAMAGE OCCURS, TREES SHALL BE REPLACED IN KIND PER ARTICLE 201.07. REPAIR OR REPLACEMENT OF EXISTING PLANT MATERIAL REQUIREMENTS STATED HEREIN.
- 28. ANY AGGREGATE SUBGRADE IMPROVEMENT CONTAMINATED AND/OR DAMAGED BY THE CONTRACTOR'S VEHICLES AND/OR EQUIPMENT IS TO BE REMOVED AND REPLACED AS DIRECTED BY THE ENGINEER AT CONTRACTOR EXPENSE.

FILE NAME =	DESIGNED -	REVISED -				F.A.P. RTF.	SECTION CO	DUNTY TOTAL SHEET
\WillCo-sht001-genn	ote.dgn DRAWN -	REVISED -	- YEPSTEIN	STATE OF ILLINOIS	GENERAL NOTES	0356 12	2-00147-11-CH	WILL 356 3
PLOT TIME = 3:53:25	PM CHECKED -	REVISED -	600 W FULTON ST TEL 312 454 9100	DEPARTMENT OF TRANSPORTATION			CO	NTRACT NO. 61D34
PLOT DATE = 2/14/2	024 DATE - 02/14/2024	REVISED -	CHICAGO, ILLINOIS FAX 312 559 1217 60661-1259 WEB www.epsteinglobel.com		SCALE: N/A SHEET 1 OF 1 SHEETS STA. N/A TO STA. N/A		ILLINOIS FED. AID PRO	

20200100       EARTH EXCAVATION         20201200       REMOVAL AND DISPOSAL OF UNSUITABLE MATERIAL         20201200       REMOVAL AND DISPOSAL OF UNSUITABLE MATERIAL         20800150       TRENCH BACKFILL         20800150       TRENCH BACKFILL         21001000       GEOTECHNICAL FABRIC FOR GROUND STABILIZATION         21101615       TOPSOIL FURNISH AND PLACE, 4"         25000400       NITROGEN FERTILIZER NUTRIENT         25000500       PHOSPHORUS FERTILIZER NUTRIENT         25000500       POTASSIUM FERTILIZER NUTRIENT         25100125       MULCH, METHOD 3         25200110       SODDING, SALT TOLERANT	UNIT UNIT CU YD CU YD CU YD CU YD SQ YD SQ YD SQ YD POUND	TOTAL QUANTITY 1,939 41115 16619 7,382 8223 8223 35,904 445	80% FED / 20% LOCAL ROADWAY 0003 URBAN 1,939 41,115 16,619 7,382 8,223 8,223 35,904 445	80% FED / 20% LOCAL TRAFFIC SIGNALS 0021 URBAN	80% FED / 20% LOCAL RETAINING WALL 0044 URBAN	80%
NO.       ITEM         20101700       SUPPLEMENTAL WATERING         20200100       EARTH EXCAVATION         20201200       EARTH EXCAVATION         20201200       REMOVAL AND DISPOSAL OF UNSUITABLE MATERIAL         20800150       TRENCH BACKFILL         20101000       GEOTECHNICAL FABRIC FOR GROUND STABILIZATION         21001000       PHOSPHORUS FERTILIZER NUTRIENT         25000500       PHOSPHORUS FERTILIZER NUTRIENT         25000600       POTASSIUM FERTILIZER NUTRIENT         25000100       SODDING, SALT TOLERANT         25000110       SODDING, SALT TOLERANT	UNIT CU YD CU YD CU YD CU YD SQ YD SQ YD SQ YD	QUANTITY	0003 URBAN 1,939 41,115 16,619 7,382 8,223 8,223 35,904	0021	0044	
NO.       ITEM         20101700       SUPPLEMENTAL WATERING         20200100       EARTH EXCAVATION         20201200       EARTH EXCAVATION         20201200       REMOVAL AND DISPOSAL OF UNSUITABLE MATERIAL         20800150       TRENCH BACKFILL         20101000       GEOTECHNICAL FABRIC FOR GROUND STABILIZATION         21001000       GEOTECHNICAL FABRIC FOR GROUND STABILIZATION         21101615       TOPSOIL FURNISH AND PLACE, 4"         25000400       NITROGEN FERTILIZER NUTRIENT         25000500       PHOSPHORUS FERTILIZER NUTRIENT         25000600       POTASSIUM FERTILIZER NUTRIENT         25000600       POTASSIUM FERTILIZER NUTRIENT         25000600       SODDING, SALT TOLERANT         25200110       SODDING, SALT TOLERANT	UNIT CU YD CU YD CU YD CU YD SQ YD SQ YD SQ YD	QUANTITY	URBAN 1,939 41,115 16,619 7,382 8,223 35,904		<b>1</b>	
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20201200 REMOVAL AND DISPOSAL OF UNSUITABLE MATERIAL 20800150 TRENCH BACKFILL 20800150 TRENCH BACKFILL 20800150 GEOTECHNICAL FABRIC FOR GROUND STABILIZATION 21101615 TOPSOIL FURNISH AND PLACE, 4" 25000400 NITROGEN FERTILIZER NUTRIENT 25000500 PHOSPHORUS FERTILIZER NUTRIENT 25000600 POTASSIUM FERTILIZER NUTRIENT 25000600 POTASSIUM FERTILIZER NUTRIENT 25100125 MULCH, METHOD 3 25200110 SODDING, SALT TOLERANT	CU YD CU YD SQ YD SQ YD POUND	16619 7,382 8223 35,904	16,619 7,382 8,223 35,904			
20800150 TRENCH BACKFILL 20800150 TRENCH BACKFILL 21001000 GEOTECHNICAL FABRIC FOR GROUND STABILIZATION 21101615 TOPSOIL FURNISH AND PLACE, 4" 25000400 NITROGEN FERTILIZER NUTRIENT 25000500 PHOSPHORUS FERTILIZER NUTRIENT 25000600 POTASSIUM FERTILIZER NUTRIENT 25100125 MULCH, METHOD 3 25200110 SODDING, SALT TOLERANT	CU YD SQ YD SQ YD POUND	7,382 8223 35,904	7,382 8,223 35,904			
20800150 TRENCH BACKFILL 20800150 TRENCH BACKFILL 21001000 GEOTECHNICAL FABRIC FOR GROUND STABILIZATION 21101615 TOPSOIL FURNISH AND PLACE, 4" 25000400 NITROGEN FERTILIZER NUTRIENT 25000500 PHOSPHORUS FERTILIZER NUTRIENT 25000600 POTASSIUM FERTILIZER NUTRIENT 25100125 MULCH, METHOD 3 25200110 SODDING, SALT TOLERANT	CU YD SQ YD SQ YD POUND	7,382 8223 35,904	7,382 8,223 35,904			
21001000 GEOTECHNICAL FABRIC FOR GROUND STABILIZATION 21101615 TOPSOIL FURNISH AND PLACE, 4" 25000400 NITROGEN FERTILIZER NUTRIENT 25000500 PHOSPHORUS FERTILIZER NUTRIENT 25000600 POTASSIUM FERTILIZER NUTRIENT 25000600 POTASSIUM FERTILIZER NUTRIENT 25100125 MULCH, METHOD 3 25200110 SODDING, SALT TOLERANT	SQ YD SQ YD POUND	8223	8,223 35,904			
21101615 TOPSOIL FURNISH AND PLACE, 4" 25000400 NITROGEN FERTILIZER NUTRIENT 25000500 PHOSPHORUS FERTILIZER NUTRIENT 25000600 POTASSIUM FERTILIZER NUTRIENT 25100125 MULCH, METHOD 3 25200110 SODDING, SALT TOLERANT	SQ YD POUND	35,904	8,223 35,904			
21101615 TOPSOIL FURNISH AND PLACE, 4" 25000400 NITROGEN FERTILIZER NUTRIENT 25000500 PHOSPHORUS FERTILIZER NUTRIENT 25000600 POTASSIUM FERTILIZER NUTRIENT 25100125 MULCH, METHOD 3 25200110 SODDING, SALT TOLERANT	SQ YD POUND	35,904	35,904			
25000400 NITROGEN FERTILIZER NUTRIENT 25000500 PHOSPHORUS FERTILIZER NUTRIENT 25000600 POTASSIUM FERTILIZER NUTRIENT 25100125 MULCH, METHOD 3 25200110 SODDING, SALT TOLERANT	POUND					
25000400 NITROGEN FERTILIZER NUTRIENT 25000500 PHOSPHORUS FERTILIZER NUTRIENT 25000600 POTASSIUM FERTILIZER NUTRIENT 25100125 MULCH, METHOD 3 25200110 SODDING, SALT TOLERANT	POUND					
25000500 PHOSPHORUS FERTILIZER NUTRIENT 25000600 POTASSIUM FERTILIZER NUTRIENT 25100125 MULCH, METHOD 3 25200110 SODDING, SALT TOLERANT		445	445			
25000500 PHOSPHORUS FERTILIZER NUTRIENT 25000600 POTASSIUM FERTILIZER NUTRIENT 25100125 MULCH, METHOD 3 25200110 SODDING, SALT TOLERANT		445	445			
25000600 POTASSIUM FERTILIZER NUTRIENT 25100125 MULCH, METHOD 3 25200110 SODDING, SALT TOLERANT	POUND			1		
25000600 POTASSIUM FERTILIZER NUTRIENT 25100125 MULCH, METHOD 3 25200110 SODDING, SALT TOLERANT	POUND	445	4.45			
25100125 MULCH, METHOD 3 25200110 SODDING, SALT TOLERANT		445	445			
25100125 MULCH, METHOD 3 25200110 SODDING, SALT TOLERANT	POUND	445	445		· · · · ·	
25200110 SODDING, SALT TOLERANT						
	ACRE	7.5	7.5			
	SQ YD	35,904	35,904	· · · · · · · · · · · · · · · · · · ·	· · · ·	
						· · · ·
	POUND	2,225	2,225			
28000305 TEMPORARY DITCH CHECKS	FOOT	920	920			
28000400 PERIMETER EROSION BARRIER		1 42 000	13,069			
	FOOT	13,069				L <u></u>

 FILE NAME =
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 ...WullCo-sh0801-S00.dgn
 DRAWN CS
 REVISED 

 PLOT TIME = 2457/22 PM
 CHECKED JK
 REVISED 

 PLOT TIME = 3/4/2824
 DATE 03/04/2024
 REVISED

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SUMMARY OF QUANT SCALE: N.T.S. SHEET 1 OF 19 SHEETS ST

% FED / 20% LOCAL TRAINEES	100% LOCAL NON-
0042	PARTICIPATING
URBAN	ITEM
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		F.A.P. RTE.	SECTION	COUNTY	TOTAL	SHEET NO.
NTITIES		0356	12-00147-11-CH	WILL	356	4
				CONTRAC	T NO. 6	1D34
TA, NZA	TO STA, N/A		ILL INOIS FED.	NO PROJECT		
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CODE			TOTAL	80% FED / 20% LOCAL ROADWAY 0003	80% FED / 20% LOCAL TRAFFIC SIGNALS	80% FED / 20% LOCAL RETAINING WALL	. 80% F
NO.	ITEM	UNIT	QUANTITY		0021 URBAN	0044 URBAN	
				URDAN	URBAN	URDAN	+
28000510	INLET FILTERS	EACH	222	222	· · · · · · · · · · · · · · · · · · ·		
28100107	STONE RIPRAP, CLASS A4	SQ YD	80	80		· · · · · · · · · · · · · · · · · · ·	
							<u> </u>
30300001	AGGREGATE SUBGRADE IMPROVEMENT	CU YD	4111	4,111		· · · · · · · · · · · · · · · · · · ·	
30300112	AGGREGATE SUBGRADE IMPROVEMENT 12"	SQ YD	74534	74,534			
35101600	AGGREGATE BASE COURSE, TYPE B 4"	SQ YD	6212	6,212			
35102400	AGGREGATE BASE COURSE, TYPE B 12"	SQ YD	4680	4,680			+
40600290	BITUMINOUS MATERIALS (TACK COAT)	POUND	50043	50,043			
10600400	MIXTURE FOR CRACKS, JOINTS, AND FLANGEWAYS	TON	4	. 4			-
40603080	HOT-MIX ASPHALT BINDER COURSE, IL-19.0, N50	TON	2470	2,470	· · · · · · · · · · · · · · · · · · ·		
				· · · · · · · · · · · · · · · · · · ·			
40603085	HOT-MIX ASPHALT BINDER COURSE, IL-19.0, N70	TON	3445	3,445			
40603200	POLYMERIZED HOT-MIX ASPHALT BINDER COURSE, IL-4.75, N50	TON	805	805		``````````````````````````````````````	-
40604060	HOT-MIX ASPHALT SURFACE COURSE, IL-9.5, MIX "D", N50	TON	547	547			<u> </u>
40604062	HOT-MIX ASPHALT SURFACE COURSE, IL-9.5, MIX "D", N70	TON	2504	2,504			
				·			
40701951	HOT-MIX ASPHALT PAVEMENT (FULL-DEPTH), 13 1/2"	SQ YD	53617	53,617			-

FILE NAME =	DESIGNED - CS	REVISED -	<u>(a</u> )	1		F.A.P. SECTION	COUNTY TOTAL SHEET
\WillCorsht002-S00.dgn	DRAWN - CS	REVISED -	FPSTEIN	STATE OF ILLINOIS	SUMMARY OF QUANTITIES	0356 12-00147-11-CH	WILL 356 5
PLOT TIME = 1:46:43 PM	CHECKED - JK	REVISED -	600 W FULTON ST TEL 312 454 9100	DEPARTMENT OF TRANSPORTATION			CONTRACT NO. 61034
PLOT DATE = 2/28/2024	DATE - 02/28/2024	REVISED -	GREAGO, KLINOIS FAX 512 658 1217 63661-1250 WEIL www.equileingktiel.com		SCALE: N.T.S. SHEET Z OF 19 SHEETS STA, N/A TO STA. N/A	PLLINOIS FED.	ALD PROJECT

FED / 20% LOCAL	100% LOCAL
TRAINEES	NON-
0042	PARTICIPATING
URBAN	ITEM
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	- <u>_</u>			80% FED / 20% LOCAL ROADWAY	80% FED / 20% LOCAL TRAFFIC SIGNALS	80% FED / 20% LOCAL RETAINING WALL	80%
CODE			TOTAL	0003	0021	0044	
NO.	ITEM	UNIT	QUANTITY	URBAN	URBAN	URBAN	
							1
42400200	PORTLAND CEMENT CONCRETE SIDEWALK 5 INCH	SQ FT	49939	49,939			
42400410	PORTLAND CEMENT CONCRETE SIDEWALK 8 INCH	SQ FT	5988	5,988			<u> </u>
42400800	DETECTABLE WARNINGS	SQ FT	226	226			
44000100	PAVEMENT REMOVAL	SQ YD	43,506	43,506			
44000160	HOT-MIX ASPHALT SURFACE REMOVAL, 2 3/4"	SQ YD	19,159	19,159			
44000200	DRIVEWAY PAVEMENT REMOVAL	SQ YD	8,842	8,842			
<del></del>	· · · · · · · · · · · · · · · · · · ·						
44000500	COMBINATION CURB AND GUTTER REMOVAL	FOOT	17,823	17,823			<u> </u>
44000600	SIDEWALK REMOVAL	SQ FT	6,091	6,091			
					· · ·		
44003100	MEDIAN REMOVAL	SQ FT	2,403	2,403			
44201796	CLASS D PATCHES, TYPE IV, 12 INCH	SQ YD	421	421			-
48203041	HOT-MIX ASPHALT SHOULDERS, 11"	SQ YD	194	194			
				<u>.</u>			
50200100	STRUCTURE EXCAVATION	CU YD	1831			1,831	
50300225	CONCRETE STRUCTURES	CU YD	309.5			309.5	-
50800205	REINFORCEMENT BARS, EPOXY COATED	POUND	28030			28,030	

FILE NAME =	DESIGNED - CS	REVISED -				F.A.P. SECTION COUNTY SHEETS
\WillCo-sht003-500.dgn	DRAWN - CS	REVISED -	J YEPSTEIN	STATE OF ILLINOIS	SUMMARY OF QUANTITIES	D356 12-00147-11-CH WILL 356
PLOT TIME = 1:47:08 PM	CHECKED - JK	REVISED -	BOD W FULTON ST TEL 512 454 \$100	DEPARTMENT OF TRANSPORTATION		CONTRACT NO. 6
PLOT DATE = 2/28/2024	DATE - 02/28/2024	REVISED -	CIECAGO, KLEWOLS FAX 312 558 1217 E0581-1259 WEB www.spikergithal.com		SCALE: N.T.S. SHEET 3 OF 19 SHEETS STA, N/A TO STA, N/A	ILLINDIS FED. AID PROJECT

FED / 20% LOCAL	100% LOCAL
TRAINEES	NON-
0042	PARTICIPATING
URBAN	ITEM
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					<u> </u>	DISTRUCTION CODE	1
CODE			TOTAL	ROADWAY 0003	80% FED / 20% LOCAL TRAFFIC SIGNALS 0021	RETAINING WALL 0044	. 80% F
NO.	ІТЕМ	UNIT	QUANTITY	URBAN	URBAN	URBAN	
							_
52200020	TEMPORARY SOIL RETENTION SYSTEM	SQ FT	1584			1,584	
52200800	SEGMENTAL CONCRETE BLOCK WALL	SQ FT	4370			4,370	
54213657	PRECAST REINFORCED CONCRETE FLARED END SECTIONS 12"	EACH	1	1			
54213669	PRECAST REINFORCED CONCRETE FLARED END SECTIONS 24"	EACH	2	2			
							1
5424A030	PIPE CULVERTS, CLASS A, TYPE 4 30" (TEMPORARY)	FOOT	70	70			
<b></b>							
54248510	CONCRETE COLLAR	CU YD	2	2			<u> </u>
550A0050	STORM SEWERS, CLASS A, TYPE 1 12"	FOOT	1291	1,291			
550A0070	STORM SEWERS, CLASS A, TYPE 1 15"	FOOT	284	284			
550A0090	STORM SEWERS, CLASS A, TYPE 1 18"	FOOT	937	937			
550A0120	STORM SEWERS, CLASS A, TYPE 1 24"	FOOT	586	586			
550A0140	STORM SEWERS, CLASS A, TYPE 1 30"	FOOT	30	30			
						9-788750-880-78875-8895-8895-8895-8895-8895-8895-889	
550A0200	STORM SEWERS, CLASS A, TYPE 1 54"	FOOT	580	580			
							<u> </u>
550A0340	STORM SEWERS, CLASS A, TYPE 2 12"	FOOT	5383	5,383			
· · · · · · · · · · · · · · · · · · ·							

FILE NAME =	DESIGNED - CS	REVISED -				F.A.P. SECTION	COUNTY TOTAL SHEET
\W:)1Co+sht084+SDD.dgn	DRAWN - CS	REVISED -		STATE OF ILLINOIS	SUMMARY OF QUANTITIES	0356 I2-00147-11-CH	WILL 356 7
PLOT TIME = 2:57:49 PM	CHECKED - JK	REVISED -	100 W FULTON ST TEL 312 454 8100	DEPARTMENT OF TRANSPORTATION			CONTRACT NO. 61D34
PLOT DATE = 3/4/2024	DATE - 03/04/2024	REVISED -	CHICAGO, ELENOIS FAX 312 535 1217 80/81-1259 WE9		SCALE: N.T.S. SHEET 4 OF 19 SHEETS STA, N/A TO STA, N/A	ILL INDIS FED.	AID PROJECT

FED / 20% LOCAL	100% LOCAL
TRAINEES 0042	NON- PARTICIPATING
URBAN	ITEM
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						DISTRUCTION CODE	т
CODE	17784		TOTAL	ROADWAY 0003	80% FED / 20% LOCAL TRAFFIC SIGNALS 0021	RETAINING WALL 0044	80% FE
NO,	ITEM		QUANTITY	URBAN	URBAN	URBAN	
550A0360	STORM SEWERS, CLASS A, TYPE 2 15"	FOOT	394	394			
<u></u>		******		· · ·			1
550A0380	STORM SEWERS, CLASS A, TYPE 2 18"	FOOT	953	953			
550A0410	STORM SEWERS, CLASS A, TYPE 2 24"	FOOT	1003	1,003			
				.,			
550A0430	STORM SEWERS, CLASS A, TYPE 2 30"	FOOT	1360	1,360			
550A0450	STORM SEWERS, CLASS A, TYPE 2 36"	FOOT	690	690			
		<u></u>					_
550A0470	STORM SEWERS, CLASS A, TYPE 2 42"	FOOT	655	655			
550A1050		FOOT	100	400			
	STORM SEWERS, CLASS A, TYPE 4 36"	FOOT	109	109			
550A4100	STORM SEWERS, CLASS A, TYPE 1 EQUIVALENT ROUND-SIZE 24"	FOOT	247	247			-
550A4500	STORM SEWERS, CLASS A, TYPE 1 EQUIVALENT ROUND-SIZE 36"	FOOT	417	417			
							-
55100300	STORM SEWER REMOVAL 8"	FOOT	52	52		-	
						-	_
55100400	STORM SEWER REMOVAL 10"	FOOT	38	38			
55100500	STORM SEWER REMOVAL 12"	FOOT	3084	3,084			
<u></u>							
55100700	STORM SEWER REMOVAL 15"	FOOT	1532	1,532			
							1
55100900	STORM SEWER REMOVAL 18"	FOOT	1488	1,488	· · · · · · · · · · · · · · · · · · ·	-	

FILE NAME =	DESIGNED - CS	REVISED -				F.A.P. SECTION COUNTY SHEETS ND.
\WillCo-sht005-S00.dgn	DRAWN - CS	REVISED -		STATE OF ILLINOIS	SUMMARY OF QUANTITIES	0356 12-00147-11-CH WJLL 356 6
PLOT T(ME = 2:58:16 PM	CHECKED - JK	REVISED -	SOD W FUR TON ST TEL 312 454 \$100	DEPARTMENT OF TRANSPORTATION		CONTRACT NO. 61034
PLOT DATE = 3/4/2024	DATE - 03/04/2024	REVISED -	CHECAGO, KLEVOZA FAX 312 538 1317 KSE01-1320 WEB www.esetwingk.bel.com		SCALE: N.T.S. SHEET 5 OF 19 SHEETS STA. N/A TO STA, N/A	ILLINOIS FED. AID PROJECT

ED / 20% LOCAL       100% LOCAL         TRAINEES       NON-         0042       PARTICIPATING         ITEM       ITEM         IRBAN       ITEM         IRBAN		
TRAINEES NON- 0042 PARTICIPATING		
TRAINEES NON- 0042 PARTICIPATING	ED / 20% LOCAL	100% LOCAL
0042 PARTICIPATING	TRAINEES	E CONTRACTOR OF THE OWNER OF THE
		PARTICIPATING
	URBAN	ITEM
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					CC	ONSTRUCTION CODE	
			1	80% FED / 20% LOCAL		80% FED / 20% LOCAL	
CODE			TOTAL	ROADWAY	TRAFFIC SIGNALS	RETAINING WALL	
NO.	ITEM	LINUT	TOTAL	0003	0021	0044	
NO.		UNIT	QUANTITY	URBAN	URBAN	URBAN	
55101200	STORM SEWER REMOVAL 24"	FOOT	734	734			
55101400	STORM SEWER REMOVAL 30"	FOOT	917	917			
55101600	STORM SEWER REMOVAL 36"	FOOT	809	809			
58600101	GRANULAR BACKFILL FOR STRUCTURES	CU YD	281			281	
59100100	GEOCOMPOSITE WALL DRAIN	SQYD	211			211	<u> </u>
59300100	CONTROLLED LOW-STRENGTH MATERIAL	CU YD	7126	7,126			
60108204	PIPE UNDERDRAINS, TYPE 2, 4"	FOOT	4159	4,159			
60146304	PIPE UNDERDRAINS FOR STRUCTURES 4"	FOOT	1049			1,049	
		FOOT	1043			1,043	
60201110	CATCH BASINS, TYPE A, 4'-DIAMETER, TYPE 11V FRAME AND GRATE	EACH	21	21			-
·····							
60201340	CATCH BASINS, TYPE A, 4'-DIAMETER, TYPE 24 FRAME AND GRATE	EACH	53	53			
60207605	CATCH BASINS, TYPE C, TYPE 8 GRATE	EACH	21	21			
60208240	CATCH BASINS, TYPE C, TYPE 24 FRAME AND GRATE	EACH	32	32			
							_
60218300	MANHOLES, TYPE A, 4'-DIAMETER, TYPE 1 FRAME, OPEN LID	EACH	3	3			<b>_</b>
60218400	MANHOLES, TYPE A, 4'-DIAMETER, TYPE 1 FRAME, CLOSED LID	EACH	5	5			-
				-			+

FILE NAME =	DESIGNED - CS	REVISED -	(a		*	F.A.P. SECTION COUNTY SHEET NO.
	DRAWN - CS	REVISED -		STATE OF ILLINOIS	SUMMARY OF QUANTITIES	0356 12-00147-11-CH WILL 356 9
PLOT TIME = 2:58:45 PM	CHECKED - JK	REVISEO -	500 W FURTON ST 1EL 312 454 \$100	DEPARTMENT OF TRANSPORTATION		CONTRACT NO. 61D34
PLOT DATE = 3/4/2024	DATE - 03/04/2024	REVISED -	CIRCAGO, ELEVOIS FAX 312 559 1217 82601-1259 WTB www.systempted.com		SCALE: N.T.S. SHEET 6 OF 19 SHEETS STA, N/A TO STA, N/A	ILLINOIS FED. AID PROJECT

FED / 20% LOCAL	100% LOCAL	
TRAINEES 0042	NON- PARTICIPATING	
URBAN	ITEM	
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CODE NO.	ITEM	UNIT	TOTAL QUANTITY	80% FED / 20 % LOCAL ROADWAY 0003 URBAN	80% FED / 20 % LOCAL TRAFFIC SIGNALS 0021 URBAN	80% FED / 20 % LOCAL RETAINING WALL 0044 URBAN	. 80% FI
							1
60221100	MANHOLES, TYPE A, 5'-DIAMETER, TYPE 1 FRAME, CLOSED LID	EACH	20	20	· · · · · · · · · · · · · · · · · · ·		
60223800	MANHOLES, TYPE A, 6'-DIAMETER, TYPE 1 FRAME, CLOSED LID	EACH	15	15			
60224446	MANHOLES, TYPE A, 7'-DIAMETER, TYPE 1 FRAME, CLOSED LID	EACH	4	4			
60224459	MANHOLES, TYPE A, 8'-DIAMETER, TYPE 1 FRAME, CLOSED LID	EACH	5	5			
60224469	MANHOLES, TYPE A, 9'-DIAMETER, TYPE 1 FRAME, CLOSED LID	EACH	8	8			
50224470	MANHOLES, TYPE A, 9'-DIAMETER, TYPE 1 FRAME, OPEN LID	EACH	2	2			-
30224494	MANHOLES, TYPE A, 10'-DIAMETER, TYPE 1 FRAME, OPEN LID	EACH	4	4			
50236825	INLETS, TYPE A, TYPE 11V FRAME AND GRATE	EACH	8	8			
60237470	INLETS, TYPE A, TYPE 24 FRAME AND GRATE	EACH	47	47			
60240301	INLETS, TYPE B, TYPE 8 GRATE	EACH	3	3			
60253100	CATCH BASINS TO BE RECONSTRUCTED WITH NEW TYPE 1 FRAME, CLOSED LID	EACH	1				
60300105	FRAMES AND GRATES TO BE ADJUSTED	EACH	3	3			
30300305	FRAMES AND LIDS TO BE ADJUSTED	EACH	3	3			
							<u> </u>
60500040	REMOVING MANHOLES	EACH	18	18			<u> </u>

FILE NAME =	DESIGNED - CS	REVISED -	G			F.A.P. SECTION	COUNTY TOTAL SHEET
\WillCo-sht007-S00.dgn	DRAWN - CS	REVISED -	AEPSTEIN	STATE OF ILLINOIS	SUMMARY OF QUANTITIES	0355 12-00147-11-CH	WILL 356 IO
PLOT TIME = 3:53:38 PM	CHECKED - JK	REVISED -	BOD W FLATION ET TEL 312 454 \$100	DEPARTMENT OF TRANSPORTATION		0336 12-00141-11-04	CONTRACT NO. 61D34
PLOT DATE = 2/14/2024	DATE - 02/14/2024	REVISED -	C-REAGO, ELINOIS FAX 313 558 1217 62651-1258 WES www.exelvingicbul.com		SCALE: N.T.S. SHEET 7 OF 19 SHEETS STA. N/A TO STA. N/A	ILLINDIS FED.	AID PROJECT

ED / 20 % LOCAL	100% LOCAL
TRAINEES	NON-
0042	PARTICIPATING
URBAN	ITEM

							ONSTRUCTION CODE	
	CODE			TOTAL	ROADWAY 0003	80% FED / 20% LOCAL TRAFFIC SIGNALS 0021	80% FED / 20% LOCAL RETAINING WALL 0040	80%
┢	NO.	JTEM	UNIT	QUANTITY	URBAN	URBAN	URBAN	
6	0500050	REMOVING CATCH BASINS						
ľ			EACH	23	23			
6	0500060	REMOVING INLETS	EACH	51	51			
	·····							
6	0603800	COMBINATION CONCRETE CURB AND GUTTER, TYPE B-6.12	FOOT	5672	5,672			
						· · · · · · · · · · · · · · · · · · ·	· ·	
6(	0605000	COMBINATION CONCRETE CURB AND GUTTER, TYPE B-6.24	FOOT	19215	19,215			·····
60	0608300	COMBINATION CONCRETE CURB AND GUTTER, TYPE M-2.12	FOOT	4660	4,660			
				<u> </u>				
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60	0618300	CONCRETE MEDIAN SURFACE, 4 INCH	SQ FT	17940	17,940			
							· · · · · · · · · · · · · · · · · · ·	
60	0618740	CONCRETE MEDIAN, TYPE M-2.12	SQ FT	4149	4,149	· · · · · · · · · · · · · · · · · · ·	······································	
60	0619600	CONCRETE MEDIAN, TYPE SB-6.12	SQ FT	13697	13,697			
		· · · · · · · · · · · · · · · · · · ·			10,001			
60	0624600	CORRUGATED MEDIAN	SQ FT	1912	1,912			
	200004							Particula
	000001	STEEL PLATE BEAM GUARDRAIL, TYPE A, 6 FOOT POSTS	FOOT	416	416			
63	100045	TRAFFIC BARRIER TERMINAL, TYPE 2	EACH	6	6			
63	100167	TRAFFIC BARRIER TERMINAL, TYPE 1 (SPECIAL) TANGENT	EACH	1	1			
63	200310	GUARDRAIL REMOVAL	FOOT	39	. 39			
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SUMMARY OF QUAN SCALE: N.T.S. SHEET 8 OF 19 SHEETS ST

FED / 20% LOCAL TRAINEES 0042	100% LOCAL NON- PARTICIPATING	-		
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	F.A.P. RTE.	SECTION	COUNTY	TOTAL S
TIES	0356	12-00147-11-CH	WILL	356

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CODE			TOTAL	80% FED / 20% LOCAL ROADWAY 0003	TRAFFIC SIGNALS	RETAINING WALL	. 80'
NO.	ІТЕМ	UNIT	QUANTITY	URBAN	0021 URBAN	0040 URBAN	<u> </u>
							T
66900200	NON-SPECIAL WASTE DISPOSAL	CU YD	9730	9,730	, <u>, , , , , , , , , , , , , , , , , , </u>		
66900205	SPECIAL WASTE DISPOSAL	CU YD	100	100		<u> </u>	
							╞
66900210	HAZARDOUS WASTE DISPOSAL	CU YD	100	100			-
66900400	SPECIAL WASTE GROUNDWATER DISPOSAL	GALLON	1500	1,500			
66900425	HAZARDOUS WASTE GROUNDWATER DISPOSAL	GALLON	100	100			
					***	· · · · · · · · · · · · · · · · · · ·	
6900530	SOIL DISPOSAL ANALYSIS	EACH	12	12			
6900575	VOCS GROUNDWATER ANALYSIS	EACH	5	5			<u> </u>
						y a gantas ant	
6901001	REGULATED SUBSTANCES PRE-CONSTRUCTION PLAN	LSUM	1	1		,,,,,,,	
6901003	REGULATED SUBSTANCES FINAL CONSTRUCTION REPORT	L SUM	1	1			╞
6901006	REGULATED SUBSTANCES MONITORING	CAL DA	350	350			
7100100	MOBILIZATION						
		LSUM	. 1	1			
0103815	TRAFFIC CONTROL SURVEILLANCE	CAL DA	580	580			
0107025	CHANGEABLE MESSAGE SIGN	CAL DA	76	76			
0300100	SHORT TERM PAVEMENT MARKING	FOOT	2,791	2,791			
			2,191				
	ALTY ITEMS	I		•			

FIL	LE NAME =	DESIGNED - CS	REVISED ~			
\	WillCo-shi009-500.dgn	DRAWN - CS	REVISED -		STATE OF ILLINOIS	
PL	.QT TIME = 12:31:07 PM	CHECKED - JK	REVISED -		DEPARTMENT OF TRANSPORTATION	SUMMARY OF QUANTIT
PL	OT DATE = 3/12/2024	DATE - 03/12/2024	REVISED -	CreckSQ, KLNOIS FAX 312 523 1217 60051-1359 WEB www.schingkink.com	DEFARIMENT OF INAMSPORTATION	SCALE: N.T.S. SHEET 9 OF 19 SHEFTS STA

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% FED / 20% LOCAL	1	LOCAL				
TRAINEES 0042		) <mark>N-</mark> IPATING				
URBAN		EM	-			
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1716/2 <sup>4</sup> 0700/54		·				
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NTITIES		F.A.P. RTE.	SECTION	COUNTY	TOTAL	
	1174	0356	12-00147-11-CH	WILL CONTRACT	356 NO.6	12 1034
STA. N/A TO STA.	N/A		ILLINOIS FED. A	D PROJECT		

					CC	DNSTRUCTION CODE	
				80% FED / 20 % LOCAL ROADWAY	80% FED / 20 % LOCAL TRAFFIC SIGNALS	80% FED / 20 % LOCAL RETAINING WALL	. 80%
CODE			TOTAL	0003	0021	0044	
NO.	iTEM		QUANTITY	URBAN	URBAN	URBAN	
	·						
70300150	SHORT TERM PAVEMENT MARKING REMOVAL	SQ FT	2,791	2,791			
70300211	TEMPORARY PAVEMENT MARKING LETTERS AND SYMBOLS - PAINT	SQ FT	4,115	4,115			-
70000004							
70300221	TEMPORARY PAVEMENT MARKING - LINE 4"- PAINT	FOOT	166,514	166,514			<u> </u>
70300241	TEMPORARY PAVEMENT MARKING - LINE 6"- PAINT	FOOT	15126	15,126			
70300261	TEMPORARY PAVEMENT MARKING - LINE 12"- PAINT	FOOT	8,579	8,579			
70207400							
70307100	TEMPORARY PAVEMENT MARKING LETTERS AND SYMBOLS - TYPE IV TAPE	SQ FT	949	949		· · · · · · · · · · · · · · · · · · ·	
70307120	TEMPORARY PAVEMENT MARKING - LINE 4" - TYPE IV TAPE	FOOT	64,526	64,526			
70307130	TEMPORARY PAVEMENT MARKING - LINE 6" - TYPE IV TAPE	FOOT	2865	2,865			
			2000	2,000		• • • • • • • • • • • • • • • • • • •	
70307160	TEMPORARY PAVEMENT MARKING - LINE 12"- TYPE IV TAPE	FOOT	3,803	3,803	······································		
72000100	SIGN PANEL - TYPE 1	SQ FT	452	332	120		
			+32				<u> </u>
2400100	REMOVE SIGN PANEL ASSEMBLY - TYPE A	EACH	20	20			
2400200	REMOVE SIGN PANEL ASSEMBLY - TYPE B						
		EACH	3	3			<u> </u>
2400500	RELOCATE SIGN PANEL ASSEMBLY - TYPE A	EACH	8	8			
2800100	TELESCOPING STEEL SIGN SUPPORT		054	DE 4			<b>_</b>
		FOOT	854	854			
DTES SPECI	ALTY ITEMS		.1				L

 FILE NAME :
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 DRAWN - CS
 REVISED 

 ...Will/Co-sh/00/Ggn
 DRAWN - CS
 REVISED 

 PLOT TIME : 3/53/44 PM
 CHECKED - JK
 REVISED 

 PLOT TIME : 3/53/44 PM
 CHECKED - JK
 REVISED 

 PLOT OATE : 2/14/2024
 DATE - 02/14/2024
 REVISED

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ED / 20 % LOCAL	100% LOCAL	
TRAINEES	NON-	
0042	PARTICIPATING	
URBAN	ITEM	
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	F.A.P. RTE.	SECTION	COUNTY	TOTAL	SHEET NO.
ITITIES	0356	12-00147-11-CH	WILL	356	13
			CONTRAC	T NO. 6	1D34
TA. N/A TO STA. N/A		ILLINOIS FED. A	ID PROJECT		

CODE NO.	· · · · · · · · · · · · · · · · · · ·			1	÷	•	
				80% FED / 20 % LOCAL			. 80% F
NO.			TOTAL	ROADWAY 0003	TRAFFIC SIGNALS	RETAINING WALL	<u> </u>
	ITEM	UNIT	QUANTITY		0021 URBAN	0044 URBAN	
8000100	THERMOPLASTIC PAVEMENT MARKING - LETTERS AND SYMBOLS		0.000				
	THE NUMBER OF THE REAL AND STUDIES	SQ FT	2,292	2,292			
3000200	THERMOPLASTIC PAVEMENT MARKING - LINE 4"	FOOT	63,159	63,159		· · · · · · · · · · · · · · · · · · ·	<u> </u>
	· ·		00,100				
8000400	THERMOPLASTIC PAVEMENT MARKING - LINE 6"	FOOT	11,407	11,407			
					· · · ·		
8000500	THERMOPLASTIC PAVEMENT MARKING - LINE 8"	FOOT	970	970			
	· .						1
3000600	THERMOPLASTIC PAVEMENT MARKING - LINE 12"	FOOT	2,920	2,920			
			-		• •		
3000650	THERMOPLASTIC PAVEMENT MARKING - LINE 24"	FOOT	805	805 -			<u> </u>
008200					*		<u> </u>
	POLYUREA PAVEMENT MARKING TYPE I - LETTERS AND SYMBOLS	SQ FT	3,600	3,600		-	<u> </u>
100100	RAISED REFLECTIVE PAVEMENT MARKER	EACH	1,178	1,178		•	
8300201	PAVEMENT MARKING REMOVAL - GRINDING	SQ FT	90,344	90,344		· · · · · · · · · · · · · · · · · · ·	- 
	· · ·	·		· · ·			
8300202	PAVEMENT MARKING REMOVAL - WATER BLASTING	SQ FT	20,685	20,685			<u> </u>
						, <u></u>	
0400200	ELECTRIC UTILITY SERVICE CONNECTION	L SUM	1		1		
					···		
0500010	SERVICE INSTALLATION - GROUND MOUNTED	EACH	3		3		ļ
1028200	UNDERGROUND CONDUIT, GALVANIZED STEEL, 2" DIA.	FOOT	0.500				<u> </u>
		FOOT	6,562		6,562		
1028220	UNDERGROUND CONDUIT, GALVANIZED STEEL, 3" DIA.	FOOT	533		533	а уттатиски <u>принати и г</u>	
						an commonwer	<u> </u>
TES SPECIA	ALTY ITEMS	1	L				L

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\WillCo-sht811-S00.dgn	DRAWN - CS	REVISED -		STATE OF ILLINOIS	
PLOT TIME = 3:53:46 PM	CHECKED - JK	REVISED -	TOW FULION ST TEL 312 454 5100	DEPARTMENT OF TRANSPORTATION	SUMMARY OF QUAN
PLOT DATE = 2/14/2824	DATE - 02/14/2024	REVISED -	CHECAGO, RESPONSE FAX, 312 553 1217 COCC1-1235 VICS www.ap.tel.spictul.on	DEFAITMENT OF MANSI ONTATION	SCALE: N.T.S. SHEET IL OF 19 SHEETS S
					State interest officer it of 15 State 15 5

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TRAINEES	NON-
0044	PARTICIPATING
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	F.A RTI	ч.Р. ГЕ.	SECTION	COUNTY	TOTAL SHEETS	SHEET NO.		
SUMMARY OF QUANTITIES	03	56	12-00147-11-CH	WILL	356	14		
				CONTRACT	NO. 6	1D34		
IL OF 19 SHEETS STA. N/A	TO STA. N/A	ILLINDIS FED. AID PROJECT						

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		CONSTRUCTION CODE							
[			[	80% FED / 20% LOCAL ROADWAY	80% FED / 20% LOCAL TRAFFIC SIGNALS	80% FED / 20% LOCAL RETAINING WALL	80% FED / 20% LOCAL TRAINEES	100% LOCAL	
CODE			TOTAL	0003	0021	0044		NON-	
NO.	ITEM							PARTICIPATING	
	I) CLIVE	UNIT	QUANTITY	URBAN	URBAN	URBAN	URBAN	ITEM	
81028240	UNDERGROUND CONDUIT, GALVANIZED STEEL, 4" DIA	FOOT	2,488		2,488			-	
<u> </u>			-,	· · · · ·	2,100				
81400100	HANDHOLE	EACH	23		23		······		
						······································			
81400200	HEAVY-DUTY HANDHOLE	EACH	10		10				
	· · · · · · · · · · · · · · · · · · ·								
81400300	DOUBLE HANDHOLE	EACH	7		7				
		<b></b>							
81603010	UNIT DUCT, 600V, 2-1C NO.10, 1/C NO.10 GROUND, (XLP-TYPE USE), 3/4" DIA POLYETHYLENE	FOOT	363		363				
	UNIT DUCT, 600V, 4-1C NO.10, 1/C NO.10 GROUND, (XLP-TYPE USE), 3/4" DIA								
81603022	POLYETHYLENE	FOOT	1521		1,521				
				· · · · · · · · · · · · · · · · · · ·					
81702417	ELECTRIC CABLE IN CONDUIT, 600V (XLP-TYPE USE) 3-1/C NO. 6, 1/C NO. 6 GROUND	FOOT	114		114				
			· ·	· · · · · · · · · · · · · · · · · · ·					
81702500	ELECTRIC CABLE IN CONDUIT, 600V (XLP-TYPE USE) 4/C NO. 6	FOOT	122		122				
ĺ						·····			
82110009	LUMINAIRE, LED, ROADWAY, OUTPUT DESIGNATION I						·		
02110009	LOWINARE, LED, ROADWAR, OUTPUT DESIGNATION I	EACH	20		20		· ·		
83060440	LIGHT POLE, GALVANIZED STEEL, 45 FT. M.H., 12 FT. MAST ARM	EACH	1						
		EACH			1	1			
· ·									
84200600	REMOVAL OF LIGHTING UNIT, NO SALVAGE	EACH	2	2 .					
		LAON	2	Ζ 、			-		
				,					
84200804	REMOVAL OF POLE FOUNDATION	EACH	2	2			<u> </u>		
					· ·				
85000200	MAINTENANCE OF EXISTING TRAFFIC SIGNAL INSTALLATION	EACH	2		2				
							· · · · · · · · · · · · · · · · · · ·		
86000100	MASTER CONTROLLER	EACH	1		1				
					· · · · · · · · · · · · · · · · · · ·				
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OTES SPECT	IALTY ITEMS								

FILE NAME =	DESIGNED - CS	REVISED ~						F.A.P.	SECTION	COUNTY	TOTAL S	HEET
	DRAWN - CS	REVISED -		STATE OF ILLINOIS		SUMMARY OF QUANTITIES		RTE.		-1	SHEETS	<u>NO.</u>
PLOT TIME = 3:53:48 PM	CHECKED - JK	REVISED -		DEPARTMENT OF TRANSPORTATION		SOMMANT OF QUANTITIES		0356	12-00147-11-CH	WILL	356	15
PLOT DATE + 2/14/2024	DATE - 02/14/2024	BEVISED -	100 1/1 FULTON 5 F TEL 312 454 5100 CHICAGO, BLINGHS FAX 212 517 1217	· · CONTRAC	T NO. 610	<u>134</u>
				SCALE: N.T.S.	SHEET 12 OF 19 SHEETS STA. N/A	TO STA. N/A		ILLINDIS FED. AID PROJECT				

		·			80% FED / 20 % LOCAL	80% FED / 20 % LOCAL	NSTRUCTION CODE 80% FED / 20 % LOCAL	80% FED / 20 % LOCAL	100% LOCAL	
	CODE NO.	ITEM	UNIT	TOTAL QUANTITY	ROADWAY 0003 URBAN	TRAFFIC SIGNALS 0021 URBAN	RETAINING WALL 0044 URBAN	TRAINEES 0042 URBAN	NON- PARTICIPATING ITEM	
	86400100	TRANSCEIVER - FIBER OPTIC	EACH	3		3				
	87300925	ELECTRIC CABLE IN CONDUIT, TRACER, NO. 14 1C	FOOT	4668		4,668				
	87301215	ELECTRIC CABLE IN CONDUIT, SIGNAL NO. 14 2C	FOOT	1516		1,516				
	87301225	ELECTRIC CABLE IN CONDUIT, SIGNAL NO. 14 3C	FOOT	5892		5,892	· · · · · · · · · · · · · · · · · · ·			
	87301245	ELECTRIC CABLE IN CONDUIT, SIGNAL NO. 14 5C	FOOT	12028		12,028				
-	87301255	ELECTRIC CABLE IN CONDUIT, SIGNAL NO. 14 7C	FOOT	3121		3,121				
-	87301305	ELECTRIC CABLE IN CONDUIT, LEAD-IN, NO. 14 1 PAIR	FOOT	12853		12,853				
	87301900	ELECTRIC CABLE IN CONDUIT, EQUIPMENT GROUNDING CONDUCTOR, NO. 6 1C	FOOT	1954		1,954				
	87501200	TRAFFIC SIGNAL POST, 16 FT.	EACH	5		5				
	87700180	STEEL MAST ARM ASSEMBLY AND POLE, 28 FT.	EACH	2		2				·
	87700230	STEEL MAST ARM ASSEMBLY AND POLE, 38 FT.	EACH	1		1				
	87702870	STEEL COMBINATION MAST ARM ASSEMBLY AND POLE 28 FT.	EACH	1		1				
	87702930	STEEL COMBINATION MAST ARM ASSEMBLY AND POLE 40 FT.	EACH	1		1				
	87702960	STEEL COMBINATION MAST ARM ASSEMBLY AND POLE 46 FT.	EACH	1		1				
EN	OTES SPECI	ALTY ITEMS	-,							
9л РН 124	0/	ESIGNED         CS         REVISED         -           RAWN         -         CS         REVISED         -           MECKED         -         JK         REVISED         -           ATE         -         02/14/2024         REVISED         -			E OF ILLINOIS OF TRANSPORTATIO	101	SUMMARY OF	QUANTITIES	F.A.P. SEC1 RTE. SEC1 0356 12-0014	

\W;)]Co-sht0l3-500.dgn	DRAWN - CS	REVISED -	S EPSTEIN	STATE OF ILLINOIS	1	SUMMARY OF QUAN
PLOT TIME * 3:53:51 PH	CHECKED - JK	REVISED -	EDD W FURTOW ST 1EL 312 434 9100	DEPARTMENT OF TRANSPORTATION	1	SOMMART OF QUAN
PLOT DATE = 2/14/2024	DATE - 02/14/2024	REVISED -	OBCAGO, REPROIS FAX 312 518 1217 CDCC1-1258 WES www.scrawyichal.com		SCALE: N.T.S.	SHEET 13 OF 19 SHEETS ST

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					CO	ONSTRUCTION CODE	
CODE NO.	ITEM	UNIT	TOTAL	80% FED / 20% LOCAL ROADWAY 0003 URBAN	80% FED / 20% LOCAL TRAFFIC SIGNALS 0021 URBAN	80% FED / 20% LOCAL RETAINING WALL 0040 URBAN	80
							┢
87702985	STEEL COMBINATION MAST ARM ASSEMBLY AND POLE 52 FT.	EACH	1	••••••••••••••••••••••••••••••••••••••	1		
87800100	CONCRETE FOUNDATION, TYPE A	FOOT	64		64		
87800150	CONCRETE FOUNDATION, TYPE C	FOOT	12		12		
87800400	CONCRETE FOUNDATION, TYPE E 30-INCH DIAMETER	FOOT	30		30		
37800415	CONCRETE FOUNDATION, TYPE E 36-INCH DIAMETER	FOOT	131		131		
37800420	CONCRETE FOUNDATION, TYPE E 42-INCH DIAMETER	FOOT	84		84		
		-					╞
37900200	DRILL EXISTING HANDHOLE	EACH	1	·····	1		
8030020	SIGNAL HEAD, LED, 1-FACE, 3-SECTION, MAST-ARM MOUNTED	EACH	34		34		
8030050	SIGNAL HEAD, LED, 1-FACE, 3-SECTION, BRACKET MOUNTED	EACH	11		11		
8030100	SIGNAL HEAD, LED, 1-FACE, 5-SECTION, BRACKET MOUNTED	EACH	8		8	•	
8030110	SIGNAL HEAD, LED, 1-FACE, 5-SECTION, MAST-ARM MOUNTED	EACH	6		6	•	
				10-1		·	, 
8102717	PEDESTRIAN SIGNAL HEAD, LED, 1-FACE, BRACKET MOUNTED WITH COUNTDOWN TIMER	EACH	. 14		. 14		
8200210	TRAFFIC SIGNAL BACKPLATE, LOUVERED, ALUMINUM	EACH	38		38		
8500100	INDUCTIVE LOOP DETECTOR	EACH	60				
		EACH	63		63		

FILE NAME =	DESIGNED - CS	REVISED -			
\WillCo-sht8t4-500.dgn	DRAWN - CS	REVISED -		STATE OF ILLINOIS	
PLDT TIME # 18:54:55 AM	CHECKED - JK	REVISED -	820 WFULTON ST TEL STZ 464 STOS	DEPARTMENT OF TRANSPORTATION	SUMMARY OF QUA
PLOT DATE # 3/12/2024	DATE - 03/12/2024	REVISED -	CHECADO, REINOIS FAX \$12 533 1217 60081-1239 WED www.epstwigtshaltown	DECAMMENT OF MANSFORTATION	SCALE: N.T.S. SHEET 14 OF 19 SHEETS

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% FED / 20% LOCAL	. 100%	LOCAL			
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0042 URBAN		ipating Em			
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		F.A.P. RTE.	SECTION	COUNTY	TOTAL SHI SHEETS N
TITIES		0356	12-00147-11-CH	WILL CONTRACT	356 1 NO. 6103
A. N/A TO STA.	N/A		ILLINDIS FED.	AID PROJECT	

		· · · · · · · · · · · · · · · · · · ·		:			DISTRUCTION CODE	
	CODE				ROADWAY	80% FED / 20% LOCAL TRAFFIC SIGNALS	80% FED / 20% LOCAL RETAINING WALL	80% FED
	NO.	ITEM	UNIT	TOTAL QUANTITY	0003 URBAN	0021 URBAN	0040 URBAN	
	· · · · · · · · · · · · · · · · · · ·							
*	88600100	DETECTOR LOOP, TYPE I	FOOT	3022		3,022		
*	88700200	LIGHT DETECTOR	EACH	9		*		
						9	and a state of the	
÷	88700300	LIGHT DETECTOR AMPLIFIER	EACH	3		3		
÷	89000100		-		-			
		TEMPORARY TRAFFIC SIGNAL INSTALLATION	EACH	5		5	·····	
*	89501400	RELOCATE EXISTING EMERGENCY VEHICLE PRIORITY SYSTEM, DETECTOR UNIT	EACH	2		2		
*								
×	89502375	REMOVE EXISTING TRAFFIC SIGNAL EQUIPMENT	EACH	4		4		
*	89502380	REMOVE EXISTING HANDHOLE	EACH	27		27	· · · · · · · · · · · · · · · · · · ·	
			-		· · · · · · · · · · · · · · · · · · ·			
×	89502382	REMOVE EXISTING DOUBLE HANDHOLE	EACH	5		5		
*	89502385	REMOVE EXISTING CONCRETE FOUNDATION	EACH	32				
				52		32		
	LR443200	STRIP REFLECTIVE CRACK CONTROL TREATMENT	FOOT	4809	4,809			
*	X0324085							
-		EMERGENCY VEHICLE PRIORITY SYSTEM LINE SENSOR CABLE, NO. 20 3/C	FOOT	3077		3,077		
								<b></b>
*	(1400107	FULL-ACTUATED CONTROLLER AND TYPE SUPER P CABINET	EACH	3		3		
*	(1400353	STEEL COMBINATION MAST ARM ASSEMBLY AND POLE 48 FT. WITH DUAL 15 FT.					-	•
ľ		LIGHTING ARM AT 40 FT. MOUNTING HEIGHT	EACH	1		1		
L	DTES SPECIA							

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 03/12/2024
 FILE NAME + REVISEO -GEPSTEIN ...\WillCo-sht815-500.dgn PLOT TIME + 11:19:32 AK REVISED -REVISED -REVISED -STATE OF ILLINOIS DEPARTMENT OF TRANSPORTATION SUMMARY OF QUANTITIES CONTRACT ILL 212 454 2122 CONTRACT (ALL 212 454 2122 CONTRACT (ALL 212 454 2122 CONTRACT) (ALL 212 454 2122 PLOT DATE + 3/12/2024 SCALE: N.T.S. SHEET 15 OF 19 SHEETS STA. N/

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D / 20% LOCAL	100%	LOCAL			
RAINEES 0042	N PARTIC	ION- CIPATING	<b></b>		
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		F.A.P. RTE.	SECTION	COUNTY	TOTAL SHEET SHEETS NO.
S		RTE. 0356	12-00)47-1)-CH	WILL	SHEETS NO. 356 18 T NO. 61D34
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					CC	DNSTRUCTION CODE	- <u></u>
CODE NO.	ITEM	UNIT	TOTAL QUANTITY	ROADWAY 0003	80% FED / 20% LOCAL TRAFFIC SIGNALS 0021 URBAN	80% FED / 20% LOCAL RETAINING WALL 0040 URBAN	80%
				-	OTBAN	URBAN	-
X1400355	STEEL COMBINATION MAST ARM ASSEMBLY AND POLE 54 FT. WITH DUAL 15 FT. LIGHTING ARM AT 40 FT. MOUNTING HEIGHT	EACH	1		1		
X1400367	PEDESTRIAN SIGNAL POST, 10 FT.	EACH	3		3		
	· · · · · · · · · · · · · · · · · · ·				, 		<u> </u>
X1400378	PEDESTRIAN SIGNAL POST, 5 FT.	EACH	1	<u></u>	1	-	<u> </u>
X1400506	STEEL COMBINATION MAST ARM ASSEMBLY AND POLE 64 FT. WITH DUAL 15 FT.	EACH	2				
	LIGHTING ARM AT 40 FT. MOUNTING HEIGHT		2		2	*	<u> </u>
X4021000	TEMPORARY ACCESS (PRIVATE ENTRANCE)	EACH	14	14			ļ
X4022000	TEMPORARY ACCESS (COMMERCIAL ENTRANCE)	EACH	34	34	·····	· · · · · · · · · · · · · · · · · · ·	
	-		34	34			ļ
X4024100	TEMPORARY ACCESS (WINTERIZE)	SQ YD	4,680	4,680			
	·						
×5030282	FORM LINER TEXTURED SURFACE (SPECIAL)	SQ FT	2354			2,354	
(5220102	RETAINING WALL REMOVAL	FOOT	527			527	
				·····			
(5537800	STORM SEWERS TO BE CLEANED 12"	FOOT	75				
(5538200	STORM SEWERS TO BE CLEANED 24"	FOOT	152				
					·		
(5538400	STORM SEWERS TO BE CLEANED 30"	FOOT	52				
5538600	STORM SEWERS TO BE CLEANED 36"	FOOT	155				
6020094	MANHOLES, TYPE A, 6'-DIAMETER, TYPE 1 FRAME, CLOSED LID, RESTRICTOR PLATE	EACH	4	4		· · · · · · · · · · · · · · · · · · ·	

FILE NAME =	DESIGNED - CS	REVISED -							
\WillCo-sht016-S00.dgn	DRAWN - CS	REVISED -	FPSTEIN	STATE OF ILLINOIS		F.A.P. S	SECTION	COUNTY TOTAL SHEET SHEETS NO.	<u>٦</u>
PLOT TIME = 3:85:49 PM	CHECKEO - JK	RÉVISED -	400 WFULTON ST TEL 312 454 5100	DEPARTMENT OF TRANSPORTATION	SUMMARY OF QUANTITIES	0356 12-0	00147-11-CH	WILL 356 19	-
PLOT DATE = 3/12/2024	DATE - 03/12/2024	REVISED -	CHRACO, REINOLS FAX, 312 558 1217 R0101-1230 WEB www.mataingk.bel.com		SCALE: N.T.S. SHEET 16 OF 19 SHEETS STA. N/A TO STA. N/			CONTRACT NO. 61D34	<u> </u>
					SCALE: N.I.S. SHEET 16 OF 19 SHEETS STA. N/A TO STA. N/	<u>A</u>	ILLINOIS FED. AD I	PROJECT	1

ED / 20% LOCAL	100% LOC	CAL
TRAINEES	NON-	
0042	PARTICIPA	
URBAN	ITEM	
· · · ·		
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	75	
	152	
-		
	52	
	****	
	155	
	<u> </u>	
	F.A.F RTE.	<u>` </u>

					C(	DNSTRUCTION CODE	-1
CODE				80% FED / 20% LOCAL ROADWAY	80% FED / 20% LOCAL TRAFFIC SIGNALS	80% FED / 20% LOCAL RETAINING WALL	80%
NO.	1754		TOTAL	0003	0021	0040	1
	ITEM	UNIT	QUANTITY	URBAN	URBAN	URBAN	
X6020102							
	MANHOLES, TYPE A, 9-DIAMETER, TYPE 1 FRAME, CLOSED LID, RESTRICTOR PLATE	EACH	5	5			
X6060714	CONCRETE MEDIAN (SPECIAL)	SQ FT	14513	14,513			
X6066010	HOT-MIX ASPHALT MEDIAN	SQ FT	37572	37,572			<u> </u>
X6640525	CHAIN LINK FENCE, 4' ATTACHED TO STRUCTURE	FOOT	508			508	<b> </b>
						508	
X6700410	ENGINEER'S FIELD OFFICE, TYPE A (SPECIAL)	CAL MO	19	19			
·							
x7010216	TRAFFIC CONTROL AND PROTECTION, (SPECIAL)	L SUM	1	1		· · ·	
(8250091	COMBINATION LIGHTING CONTROLLER			· · · · · · · · · · · · · · · · · · ·			
(8620200	UNINTERRUPTABLE POWER SUPPLY (SPECIAL)	EACH	3		3		ļ
8710024		EACH	3		3		
	FIBER OPTIC CABLE IN CONDUIT, NO. 62.5/125, MM12F SM24F	FOOT	4668		4,668	•	
(8760200	ACCESSIBLE PEDESTRIAN SIGNALS	EACH	15		15		
8770142	STEEL COMBINATION MAST ARM ASSEMBLY AND POLE 50 FT. (SPECIAL)	EACH	1		1		
8770151	STEEL COMBINATION MAST ARM ASSEMBLY AND POLE 55 FT. (SPECIAL)	EACH	1		1		
8770156				· · · · · · · · · · · · · · · · · · ·			
	STEEL COMBINATION MAST ARM ASSEMBLY AND POLE, 56 FT. (SPECIAL)	EACH	1		1		
8775042	STEEL COMBINATION MAST ARM ASSEMBLY AND POLE, 42 FT WITH DUAL 15 FT LIGHTING ARMS AT 40 FT MOUNTING HEIGHT	EACH	1.		1		ļ
				mmu	1		<u> </u>
8780012	CONCRETE FOUNDATION, TYPE A 12-INCH DIAMETER	FOOT	8		8		
8900100	TEMPORARY TRAFFIC SIGNAL INSTALLATION (SPECIAL)	EACH	1		1		
							·

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	FILE NAME =	DESIGNED - CS	REVISED -			
	\WullCo-sht817-500.dgn	DRAWN - CS	REVISED -	FPSTEIN	STATE OF ILLINOIS	· · · · · · · · · · · · · · · · · · ·
	PLOT TIME = 3:25:51 PM	CHECKED - JK	REVISED -	100 WFALTON ET TEL 912 454 1100	DEPARTMENT OF TRANSPORTATION	SUMMARY OF QUANTITI
-	PLOT DATE = 3/12/2024	DATE - 03/12/2024	REVISEO -	CHEAGO, ELINOIS FAX 313 334 1217 10181-1250 WEB www.apiteirgichat.com	DEFARTMENT OF TRANSFORTATION	SCALE: N.T.S. SHEET 17 OF 19 SHEETS STA.
						SUALE: N.T.S. SHEET 17 OF 19 SHEETS STA.

		7	
0% FED / 20% LOCAL TRAINEES	100% LOCAL	4	
0042	NON- PARTICIPATING		
URBAN	ITEM		
·		· .	
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1872 - marce		-	
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	F.A.P. RTE.	SECTION	ſ
NTITIES	0356	12-00147-11-CH	
STA, N/A TO STA. N	1/A	ILL INDIS FED. A	C D PA

					<u> </u>		
CODE			TOTAL	80% FED / 20 % LOCAL ROADWAY 0003	80% FED / 20 % LOCAL TRAFFIC SIGNALS 0021	80% FED / 20 % LOCAL RETAINING WALL 0044	. 80%
NO.	ITEM	UNIT	QUANTITY	URBAN	URBAN	URBAN	
						UNDAN	
X008117	STORMWATER TREATMENT UNIT	EACH	1	1			
X009608	UNDERGROUND STORAGE CHAMBER	EACH	2	2			
			Ì				<u> </u>
X009609	STORMWATER TREATMENT UNIT, TYPE 2	EACH	1	1			
X009610	STORMWATER TREATMENT UNIT, TYPE 3	EACH	1	1			
							_
X009611		EACH	1	1		· · · · · · · · · · · · · · · · · · ·	-
(X009612	STORMWATER TREATMENT UNIT, TYPE 5	EACH	1	1			
20013798		L SUM	1	1			<u> </u>
0018500	DRAINAGE STRUCTURES TO BE CLEANED	EACH	15				<u></u>
							-
20030850	TEMPORARY INFORMATION SIGNING	SQ FT	96	96			
20033056	OPTIMIZE TRAFFIC SIGNAL SYSTEM	EACH	1		1		- <b> </b>
20056608	STORM SEWER (WATER MAIN REQUIREMENTS) 12 INCH	FOOT	50	50			
20056614	STORM SEWER (WATER MAIN REQUIREMENTS) 21 INCH	FOOT	300	300		· · · · · · · · · · · · · · · · · · ·	
20056616	STORM SEWER (WATER MAIN REQUIREMENTS) 24 INCH	FOOT	203	203			
20056644	STORM SEWERS, TYPE 1, WATER MAIN QUALITY PIPE, 8"	FOOT	33	33			
							-

.

FILE NAME =	DESIGNED - CS	REVISED -				F.A.P. SECTION COUNTY TOTAL SHEET
\WillCo-sht818-S00.dgn	DRAWN - CS	REVISED -		STATE OF ILLINOIS DEPARTMENT OF TRANSPORTATION	SUMMARY OF QUANTITIES	0356 12-00147-11-CH WILL 356 21
PLOT TIME = 3:54:01 PM	CHECKED - JK	REVISED -	803 W FULTON ST TEL 312 454 8120			CONTRACT NO. 61D34
PLOT DATE = 2/14/2024	DATE - 02/14/2024	REVISED -	D-BCAGO, ELINOIS FAX 312 559 1217 80681-1259 WEB www.exatingt.bal.orm		SCALE: N.T.S. SHEET 18 OF 19 SHEETS STA, N/A TO S	A. N/A ILLINDIS FED. AID PROJECT


	[	F.A.P. RTE.	]		
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			_		
URBAN	ITE	EM .			
TRAINEES 0042	1	N-			
FED / 20 % LOCAL	100% L	.OCA	L		
FED / 20 % LOCAL	1		L		

						CC	DNSTRUCTION CODE	
					80% FED / 20% LOCAL	80% FED / 20% LOCAL	80% FED / 20% LOCAL	80% FED
	CODE		,		ROADWAY	TRAFFIC SIGNALS	RETAINING WALL	TR/
	NO.			TOTAL	0003	0021	0040	(
	140.	ITEM	UNIT	QUANTITY	URBAN	URBAN	URBAN	U
	Z0062456		SQ YD	3,007	3,007		,	
		-						
	Z0064505	SECTION CORNER MARKERS	EACH	2	2			
*	Z0073510	TEMPORARY TRAFFIC SIGNAL TIMING			·			
			EACH	5		5		
	Z0076600	TRAINEES	HOUR	1,500				
				1,000				1
	Z0076604	TRAINEES TRAINING PROGRAM GRADUATE	HOUR	1,500	ff			
	· · · · · · · · · · · · · · · · · · ·							1
×	20077700	WOOD FENCE TO BE REMOVED AND RE-ERECTED	FOOT	100	100	<u> </u>		- <u></u> .

	FILE NAME =	DESIGNED - CS	REVISED -			r					
- 1	-	ORAWN - CS	REVISED -		STATE OF ILLINOIS						
- 1		CHECKED - JK	REVISED -	100 W (ALTERIET TC. 818 464 8112	DEPARTMENT OF TRANSPORTATION				JUMMA	KY UF	QUANTITIE
L	PLOT DATE @ 3/12/2024	DATE - 03/12/2024	REVISED -	OrtiCAGO, BLINNES FAX 512 531 1317 62841-1239 WEB www.applefebat.com		SCALE:	N.T.S.	SHEET 1	9 OF	19 SHEE	ETS STA. N
						*******	*****				


	•
D / 20% LOCAL	100% LOCAL
RAINEES 0042 URBAN	NON- PARTICIPATING ITEM
1,500	
1,500	

······					
	RTE. SECTION		COUNTY	SHEETS	SHEET NO.
TITIES	0356	12-00147-11-CH	WILL	356	22
			CONTRACT	NO. 6	JD34
A, N/A TO STA, N/A		ILLINGIS FED. AT	D PROJECT		

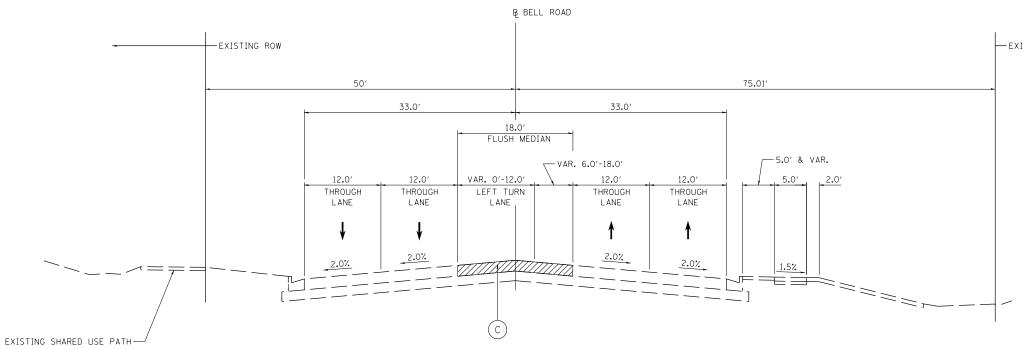

**EXISTING TYPICAL SECTION** 

STA 180+37.07 TO 187+25.00, BELL ROAD

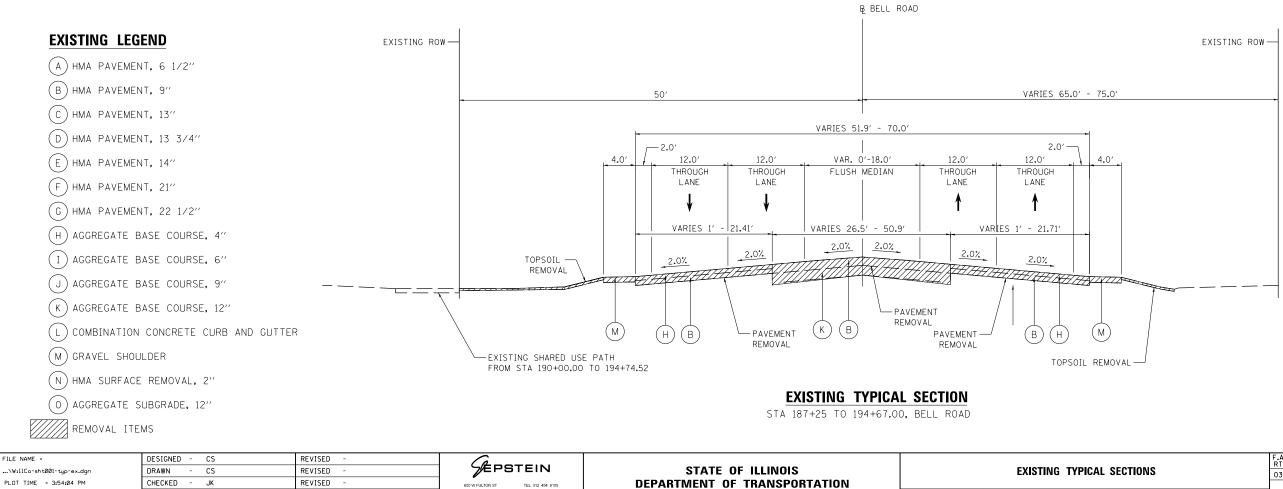

600 W FULTON ST CHICAGO, ILLINOIS

PLOT DATE = 2/14/2024

- 02/14/2024


REVISED

DATE

TEL 312 454 9100 FAX 312 559 1217

		F.A.P. RTE.	SECTION	COUNTY TOTAL SHE SHEETS NO		SHEET NO.	
EXISTING	TYPICAL SECTIONS		0356	12-00147-11-CH	WILL	356	23
	I				CONTRACT	NO. 6	1D34
SCALE: N.T.S. SHEET 1 OF 12 SHEETS STA. N/A TO STA. N/A ILLINOIS FED. AID PROJECT							

- EXISTING ROW

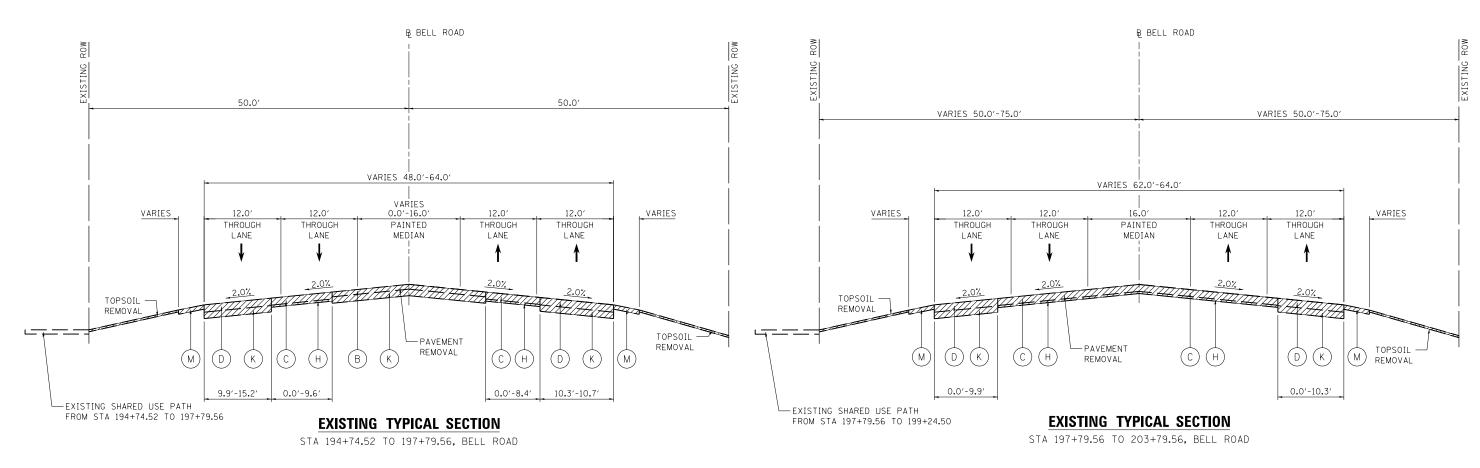


## EXISTING LEGEND

- (A) HMA PAVEMENT, 6 1/2" (B) HMA PAVEMENT, 9" (C) HMA PAVEMENT, 13" (D) HMA PAVEMENT, 13 3/4" (E) HMA PAVEMENT, 14" (F) HMA PAVEMENT, 21" (G) HMA PAVEMENT, 22 1/2" (H) AGGREGATE BASE COURSE, 4" (I) AGGREGATE BASE COURSE, 6" (J) AGGREGATE BASE COURSE, 9" (K) AGGREGATE BASE COURSE, 12" (L) COMBINATION CONCRETE CURB AND GUTTER
- (M) GRAVEL SHOULDER


(N) HMA SURFACE REMOVAL, 2"

(0) AGGREGATE SUBGRADE, 12"

REMOVAL ITEMS

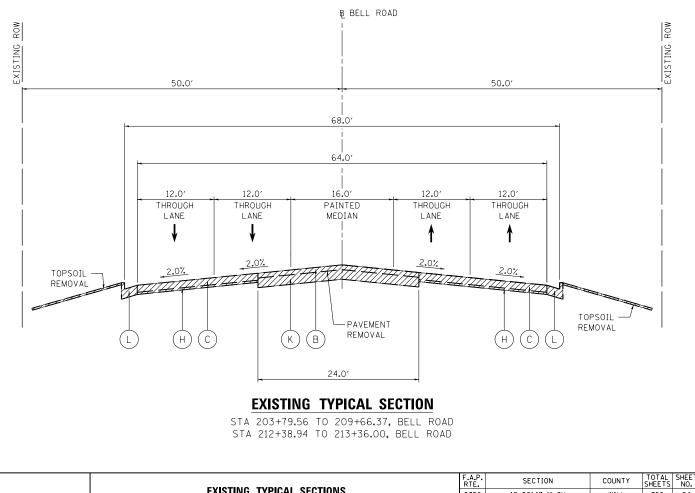



FILE NAME	=	DESIGNED - CS	REVISED -	GEDOTEIN					F.A.P. RTE.	SECTION	COUNTY TOTAL SHEET SHEETS NO.
\WillCo-st	nt002-typ-ex.dgn	DRAWN - CS	REVISED -	FPSTEIN	STATE OF ILLINOIS		EXISTING TYPICAL SECTIONS			12-00147-11-CH	WILL 356 24
PLOT TIME	= 3:54:05 PM	CHECKED - JK	REVISED -	600 W FULTON ST TEL 312 454 9100 CHICAGO, ILLINOIS FAX 312 559 1217						-	CONTRACT NO. 61D34
PLOT DATE	= 2/14/2024	DATE - 02/14/2024	REVISED -	CHICAGO, ILLINOIS PAX 312 559 1217 60661-1259 WEB www.epsteinglobal.com	SCA	SCALE: N.T.S.	SHEET 2 OF 12 SHEETS STA. N/A	A TO STA. N/A		ILLINOIS FED. AI	ID PROJECT

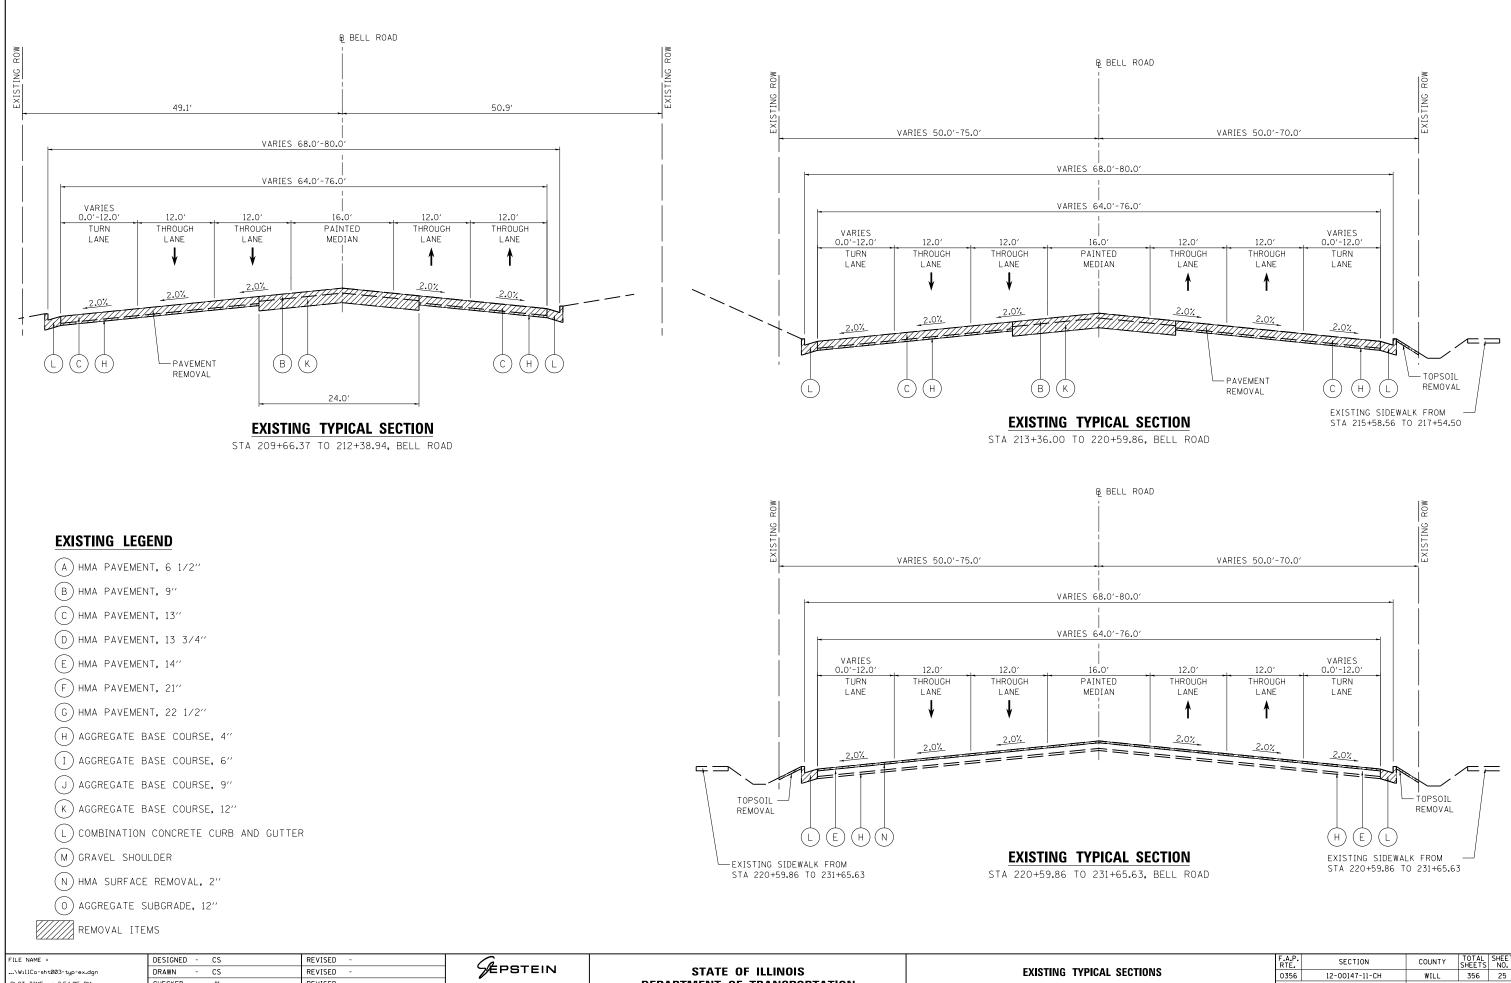

FILE NAME =	DESIGNED - CS	REVISED -				
\WillCo-sht003-typ-ex.dgn	DRAWN - CS	REVISED -	S EPSTEIN	STATE OF ILLINOIS		EXISTING TYPICAL S
PLOT TIME = 3:54:05 PM	CHECKED - JK	REVISED -	600 W FULTON ST TEL 312 454 9100	DEPARTMENT OF TRANSPORTATION		
PLOT DATE = 2/14/2024	DATE - 02/14/2024	REVISED -	CHICAGO, ILLINOIS FAX 312 559 1217 60661-1259 WEB www.epstelnglobel.com		SCALE: N.T.S.	SHEET 3 OF 12 SHEETS

CONTRACT NO. 61D34 STA. N/A TO STA. N/A TULINOIS FED ATD PROJECT

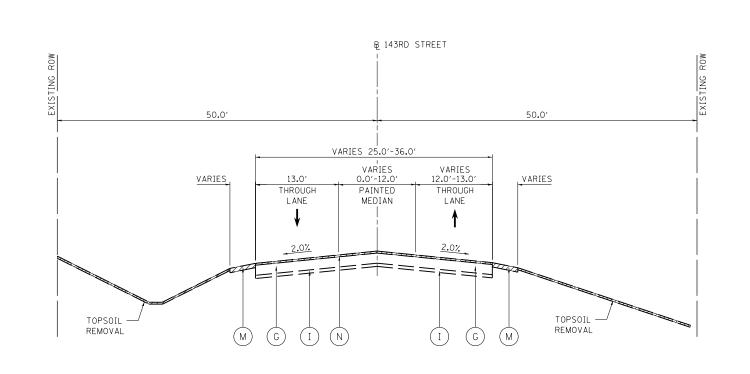

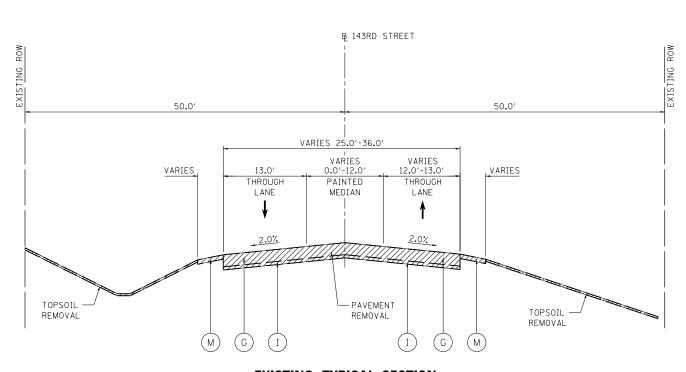


**EXISTING TYPICAL SECTION** STA 475+06 TO 477+91.44, 143RD STREET






FILE NAME =	DESIGNED - CS	REVISED -	(A			F.A.P.	SECTION	COUNTY TOTAL SHEET
\WillCo-sht004-typ-ex.dgn	DRAWN - CS	REVISED -		STATE OF ILLINOIS	EXISTING TYPICAL SECTIONS	0356	12-00147-11-CH	WILL 356 26
PLOT TIME = 3:54:05 PM	CHECKED - JK	REVISED -	600 W FULTON ST TEL 312 454 9100	DEPARTMENT OF TRANSPORTATION				CONTRACT NO. 61D34
PLOT DATE = 2/14/2024	DATE - 02/14/2024	REVISED -	CHICAGO, ILLINOIS FAX 312 559 1217 60661-1259 WEB www.epsteinglobel.com		SCALE: N.T.S. SHEET 4 OF 12 SHEETS STA. N/A TO STA. N/A		ILLINOIS FED. A	NID PROJECT



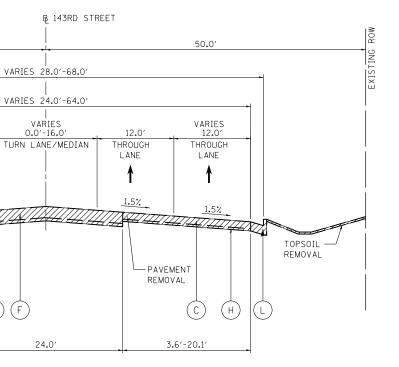


# **EXISTING TYPICAL SECTION**

STA 488+60.00 TO 498+50.00, 143RD STREET STA 501+25.00 TO 504+51.23, 143RD STREET

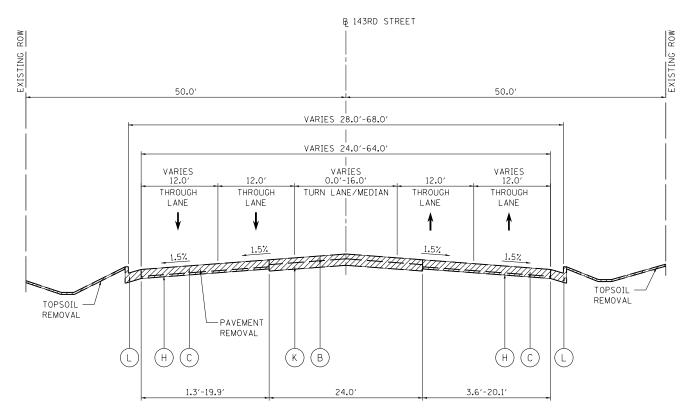

EXISTING TYPICAL SECTION STA 498+50.01 TO 499+69.55, 143RD STREET STA 500+32.41 TO 501+25.00, 143RD STREET

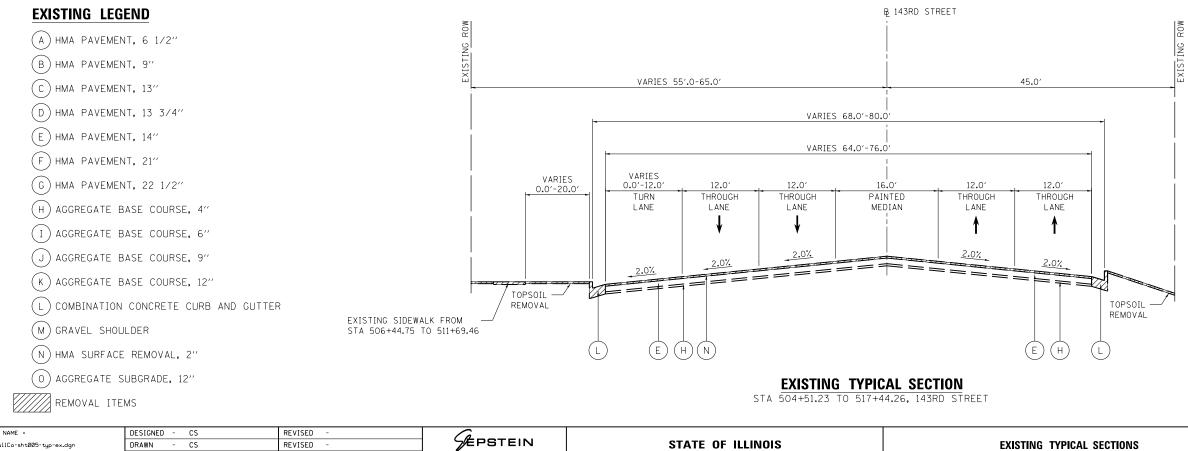

FILE NAME =	DESIGNED - CS	REVISED -	(A					F.A.P.	SECTION	COUNTY TOTAL SHEET
\WillCo-sht005-typ-ex.dgn	DRAWN - CS	REVISED -	SEPSTEIN	STATE OF ILLINOIS DEPARTMENT OF TRANSPORTATION		EXISTING TYPICAL SECTIONS			12-00147-11-CH	WILL 356 27
PLOT TIME = 3:54:06 PM	CHECKED - JK	REVISED -	600 W FULTON ST TEL 312 454 9100		DEPARTMENT OF TRANSPORTATION				0336	
PLOT DATE = 2/14/2024	DATE - 02/14/2024	REVISED -	CHICAGO, ILLINOIS FAX 312 559 1217 60661-1259 WEB www.epsteinglobel.com		SCALE: N.T.S.	SHEET 5 OF 12 SHEETS STA. N/A	TO STA. N/A		ILLINOIS FED. A	ID PROJECT

MIXTURE TYPE	AIR VOIDS @ Ndes	QUALITY MANAGEMENT PROGRAM (QMP)
PAVEMENT RESURFACING		
HOT-MIX ASPHALT SURFACE COURSE, IL-9.5, MIX "D", NTO, 2"	4% @ 70 GYR.	LR 1030-2
POLYMERIZED HOT-MIX ASPHALT BINDER COURSE, IL-4.75, N50, 3/4"	3.5% @ 50 GYR.	LR 1030-2
PAVEMENT WIDENING		
HOT-MIX ASPHALT SURFACE COURSE, IL-9.5, MIX "D", N70, 2"	4% @ 70 GYR.	LR 1030-2
HOT-MIX ASPHALT BINDER COURSE, IL-19.0 N70, 11 1/2"	4% @ 70 GYR.	LR 1030-2
HMA SHOULDER 11''		
HOT-MIX ASPHALT SURFACE COURSE, IL-9.5, MIX "D", N70, 2"	4% @ 70 GYR.	LR 1030-2
HOT-MIX ASPHALT BINDER COURSE, IL-19.0, N70, 9"	4% @ 70 GYR.	LR 1030-2
HOT-MIX ASPHALT PAVEMENT (FULL DEPTH), 13 1/2"		
HOT-MIX ASPHALT SURFACE COURSE, IL-9.5, MIX "D", N70, 2"	4% @ 70 GYR.	LR 1030-2
HOT-MIX ASPHALT BINDER COURSE, IL-19.0, N70, 11 1/2"	4% @ 70 GYR.	LR 1030-2
HOT-MIX ASPHALT MEDIAN		
HOT-MIX ASPHALT SURFACE COURSE, IL-9.5, MIX "D", N70, 2"	4% @ 70 GYR.	LR 1030-2
HOT-MIX ASPHALT BINDER COURSE, IL-19.0, N70, 11 1/2"	4% @ 70 GYR.	LR 1030-2
PATCHING		
CLASS D PATCHES (HMA BINDER IL-19.0, N70)	4% @ 70 GYR.	LR 1030-2
DRIVEWAYS - COMMERCIAL ENTRANCE / SHARED USE	PATH RECON	NSTRUCTION
HOT-MIX ASPHALT SURFACE COURSE, IL-9.5, MIX "D", N50, 2"	4% @ 50 GYR.	LR 1030-2
HOT-MIX ASPHALT BINDER COURSE, IL-19.0, N50, 11 1/2"	4% @ 50 GYR.	LR 1030-2
DRIVEWAYS - PRIVATE ENTRANCE		
HOT-MIX ASPHALT SURFACE COURSE, IL-9.5, MIX "D", N50, 2 1/2"	4% @ 50 GYR.	LR 1030-2
TEMPORARY PAVEMENT	•	
HOT-MIX ASPHALT SURFACE COURSE, IL-9.5, MIX "D", N70, 2"	4% @ 70 GYR.	LR 1030-2
HOT-MIX ASPHALT BINDER COURSE, IL-19.0, N70, 7"	4% @ 70 GYR.	LR 1030-2
WINTERIZED TEMPORARY ACCESS		
HOT-MIX ASPHALT SURFACE COURSE, IL-9.5, MIX "D", N50, 2"	4% @ 70 GYR.	LR 1030-2

1. THE UNIT WEIGHT USED TO CALCULATE ALL HMA SURFACE MIXTURE QUANTITIES IS 112 LBS/SO YD/IN.

2. THE "AC TYPE" FOR POLYMERIZED HMA MIXES SHALL BE "SBS/SBR PG 76-22" AND FOR NON-POLYMERIZED HMA THE "AC TYPE" SHALL BE "PG 64-22" UNLESS MODIFIED BY RECLAIMED MATERIALS SPECIFICATIONS.

3. ALL POTHOLES AND OTHER AREAS NEEDING REPAIR IN THE EXISTING PAVEMENT MUST BE COMPLETED BY THE CONTRACTOR USING PATCHING AS DIRECTED BY THE ENGINEER PRIOR TO PLACEMENT OF THE SURFACE COURSE.


### NOTES:

1. PAVEMENT RECONSTRUCTION STARTS AT STA 187+25.00

- PCC TEMPORARY PAVEMENT SHALL CONSIST OF CLASS PV CONCRETE MEETING THE REQUIREMENTS OF ART. 1020 OF THE STANDARD SPECIFICATIONS; THICKNESS SHALL BE 8".
- 3. TEMPORARY PCC PAVEMENT DOES NOT REQUIRE DOWEL BARS.

FILE NAME =	DESIGNED - CS	REVISED -						
\WillCo-sht006-typ-pr.dgn	DRAWN - CS	REVISED -	FPSTEIN	STATE OF ILLINOIS		PROPOSE	ED TYPIC/	AL S
PLOT TIME = 3:54:06 PM	CHECKED - JK	REVISED -	600 W FULTON ST TEL 312 454 9100	DEPARTMENT OF TRANSPORTATION				
PLOT DATE = 2/14/2024	DATE - 02/14/2024	REVISED -	CHICAGO, ILLINOIS FAX 312 559 1217 60661-1259 WEB www.epsteinglobel.com		SCALE: N.T.S.	SHEET 6 OF	12 SHEET	TS S


AL SECTIONS		F	F.A.P. RTE.	SECT	ION		COUNTY	TOTAL SHEETS	SHEET NO.	
				0356	12-0014	7-11-CH		WILL	356	28
_								CONTRACT	NO. 6	1D34
S	STA. N/A	TO STA. N/	4			ILLINOIS FEE	D. AID F	PROJECT		

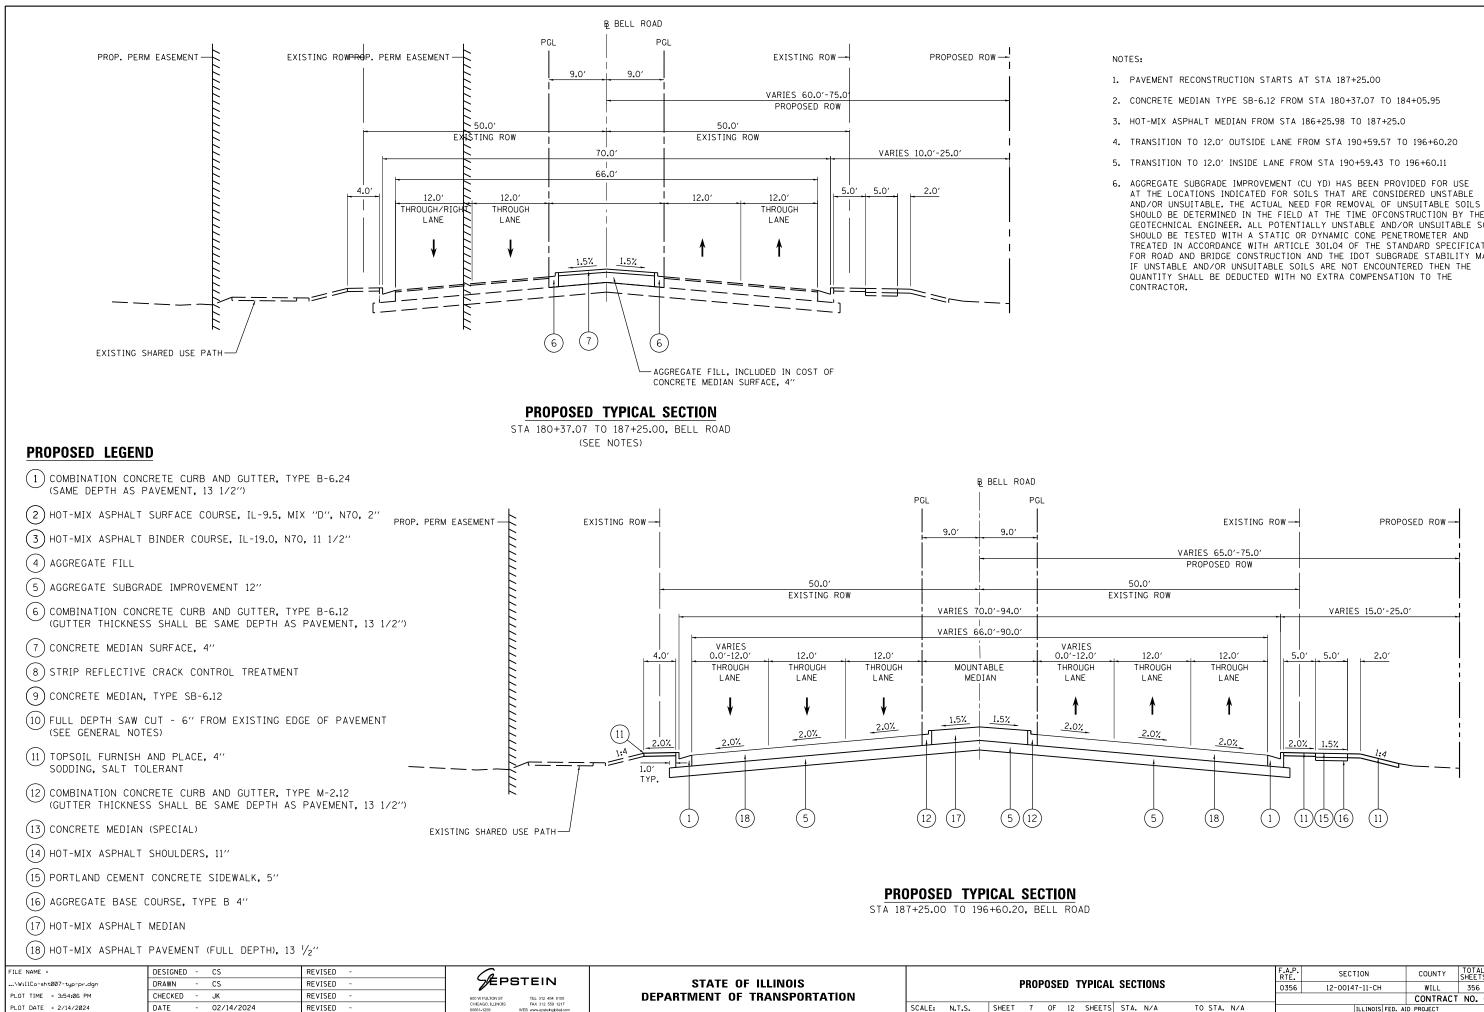

DATE

- SHOULD BE DETERMINED IN THE FIELD AT THE TIME OFCONSTRUCTION BY THE GEOTECHNICAL ENGINEER. ALL POTENTIALLY UNSTABLE AND/OR UNSUITABLE SOILS TREATED IN ACCORDANCE WITH ARTICLE 301.04 OF THE STANDARD SPECIFICATIONS FOR ROAD AND BRIDGE CONSTRUCTION AND THE IDOT SUBGRADE STABILITY MANUAL.


		F.A.P. RTE.	SECTION	COUNTY	TOTAL SHEETS	SHEET NO.	
AL	SECTION	S	0356	12-00147-11-CH	WILL	356	29
					CONTRACT	NO. 6	1D34
ΤS	STA. N/A	TO STA. N/A		ILLINOIS FED. AI	D PROJECT		

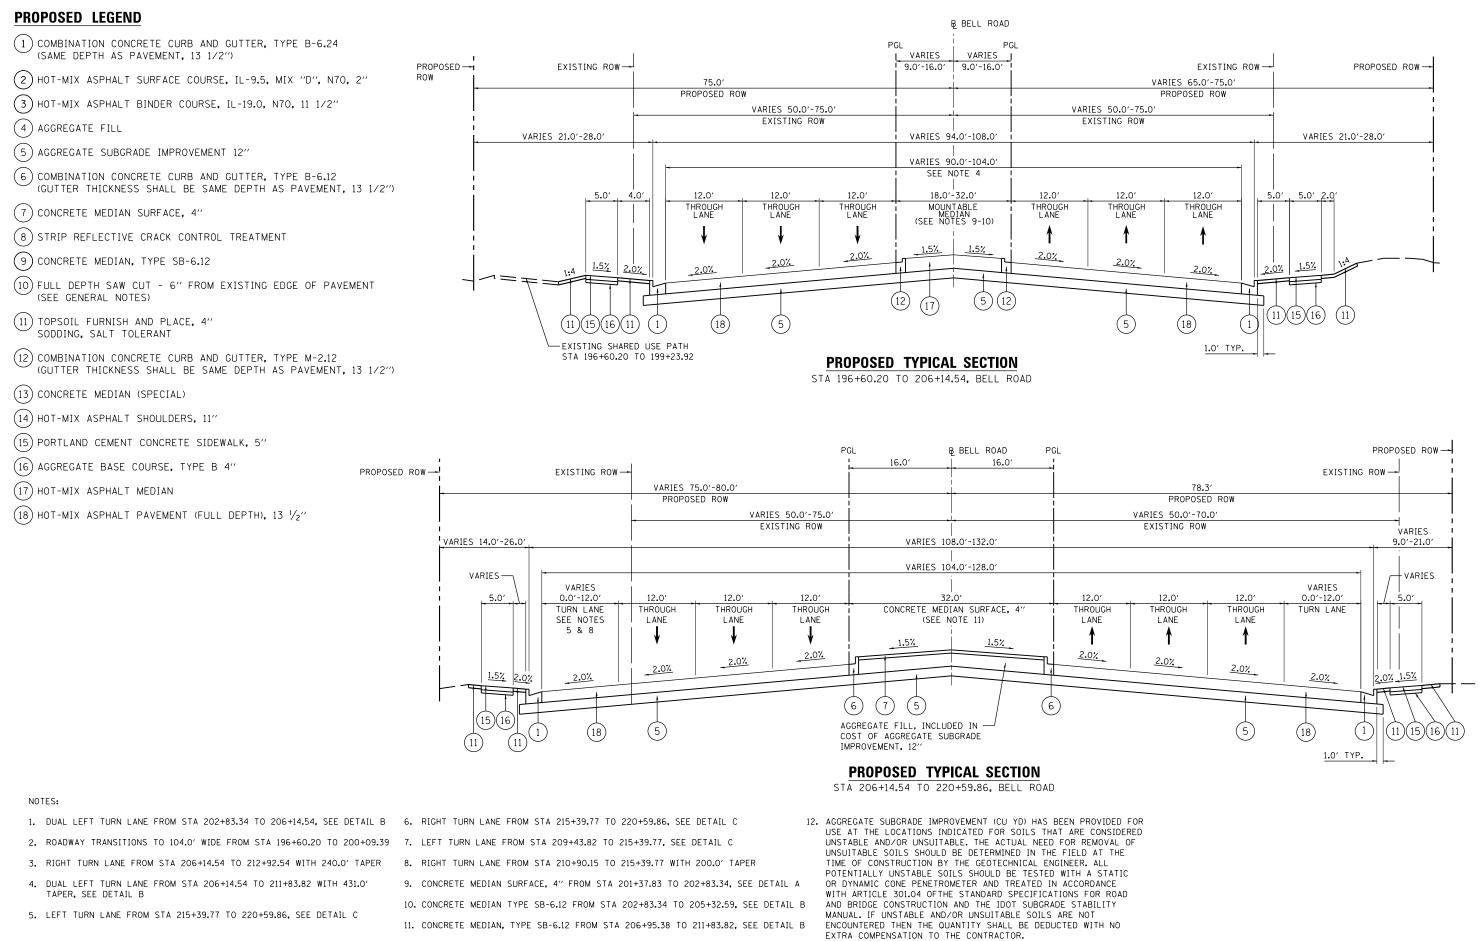

FILE NAME =	DESIGNED - CS	REVISED -					
\WillCo-sht008-typ-pr.dgn	DRAWN - CS	REVISED -	S EPSTEIN	STATE OF ILLINOIS		PROPOSED	TYPICAL
PLOT TIME = 3:54:07 PM	CHECKED - JK	REVISED -	600 W FULTON ST TEL 312 454 9100	DEPARTMENT OF TRANSPORTATION			
PLOT DATE = 2/14/2024	DATE - 02/14/2024	REVISED -	CHICAGO, ILLINOIS FAX 312 559 1217 60661-1259 WEB www.epsteinglobel.com		SCALE: N.T.S.	SHEET 8 OF 12	2 SHEETS

TOTAL SHEET EAP

RTE.	SECTIO	N	COUNTY	SHEETS	NO.
0356	12-00147-1	11-CH	WILL	356	30
			CONTRACT	NO. 6	1D34
	ILL	INOIS FED.	AID PROJECT		
	RTE.	RTE. SECTIO	RTE. SECTION 0356 12-00147-11-CH	RTE.         SECTION         COUNTY           0356         12-00147-11-CH         WILL	RTE.         SECTION         COUNTY         SHEETS           0356         12-00147-11-CH         WILL         356           CONTRACT         NO. 6

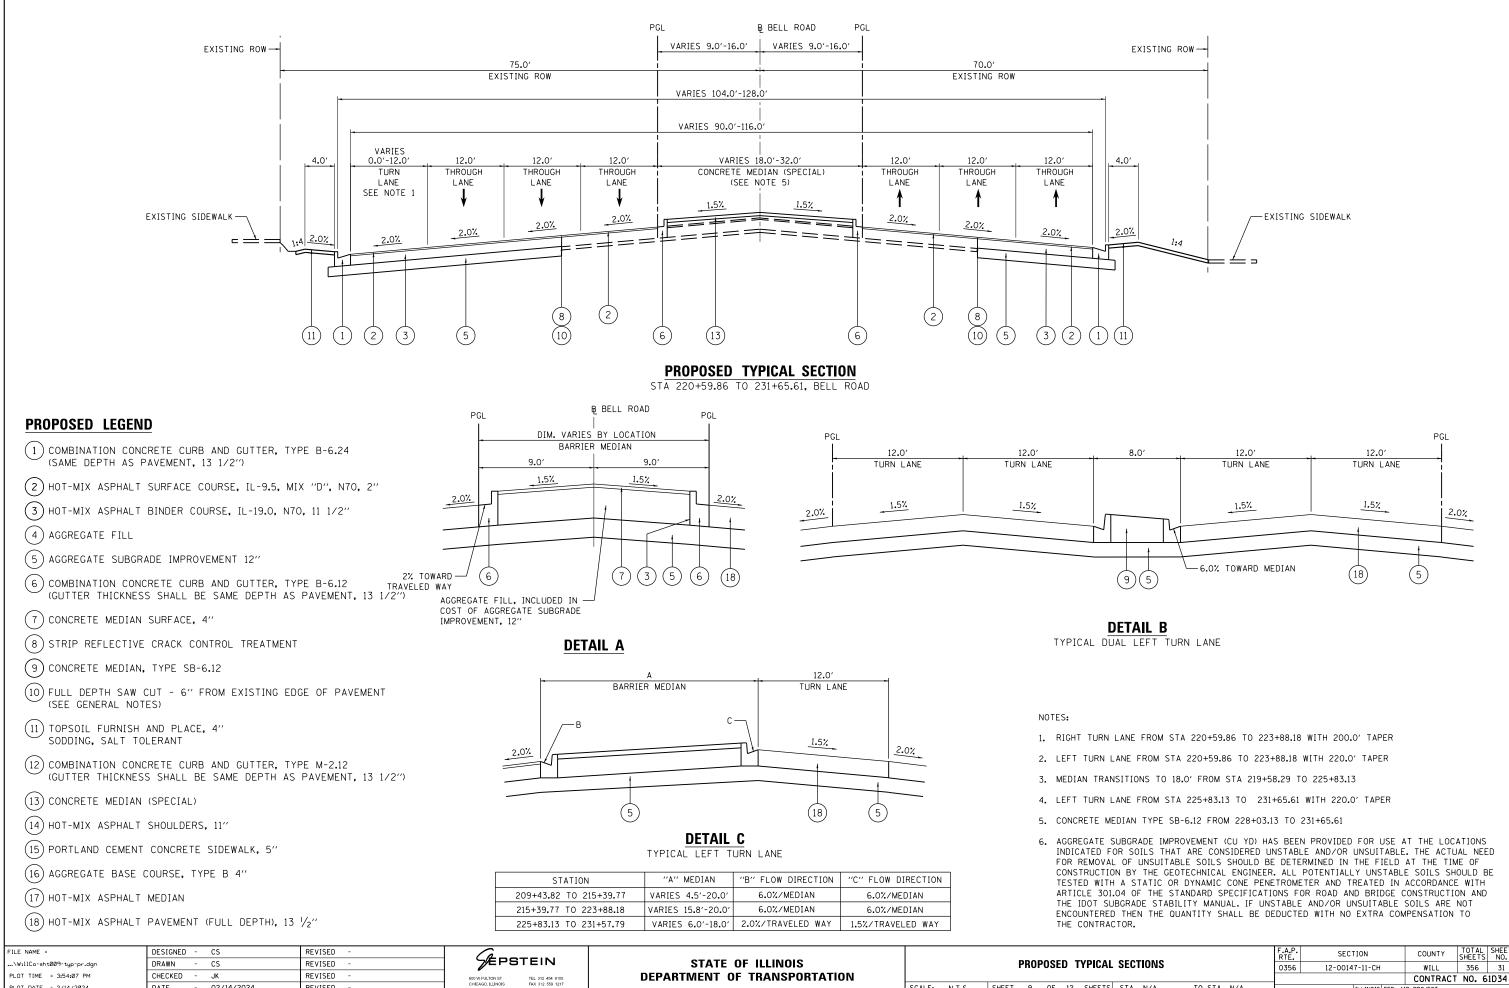

CHICAGO, ILLINOIS


PLOT DATE = 2/14/2024

- 02/14/2024

REVISED

DATE

						05050000		F.A.P. RTE.	SECTION	COUNTY	TOTAL SHEETS	SHEET NO.
		PH	OPOS	ED I	YPICAL	SECTIONS		0356	12-00147-11-CH	WILL	356	31
								_		CONTRACT	NO. 6	1D34
SCALE:	N.T.S.	SHEET	9 OF	12	SHEETS	STA. N/A	TO STA. N/A		ILLINOIS FED. A	ID PROJECT		

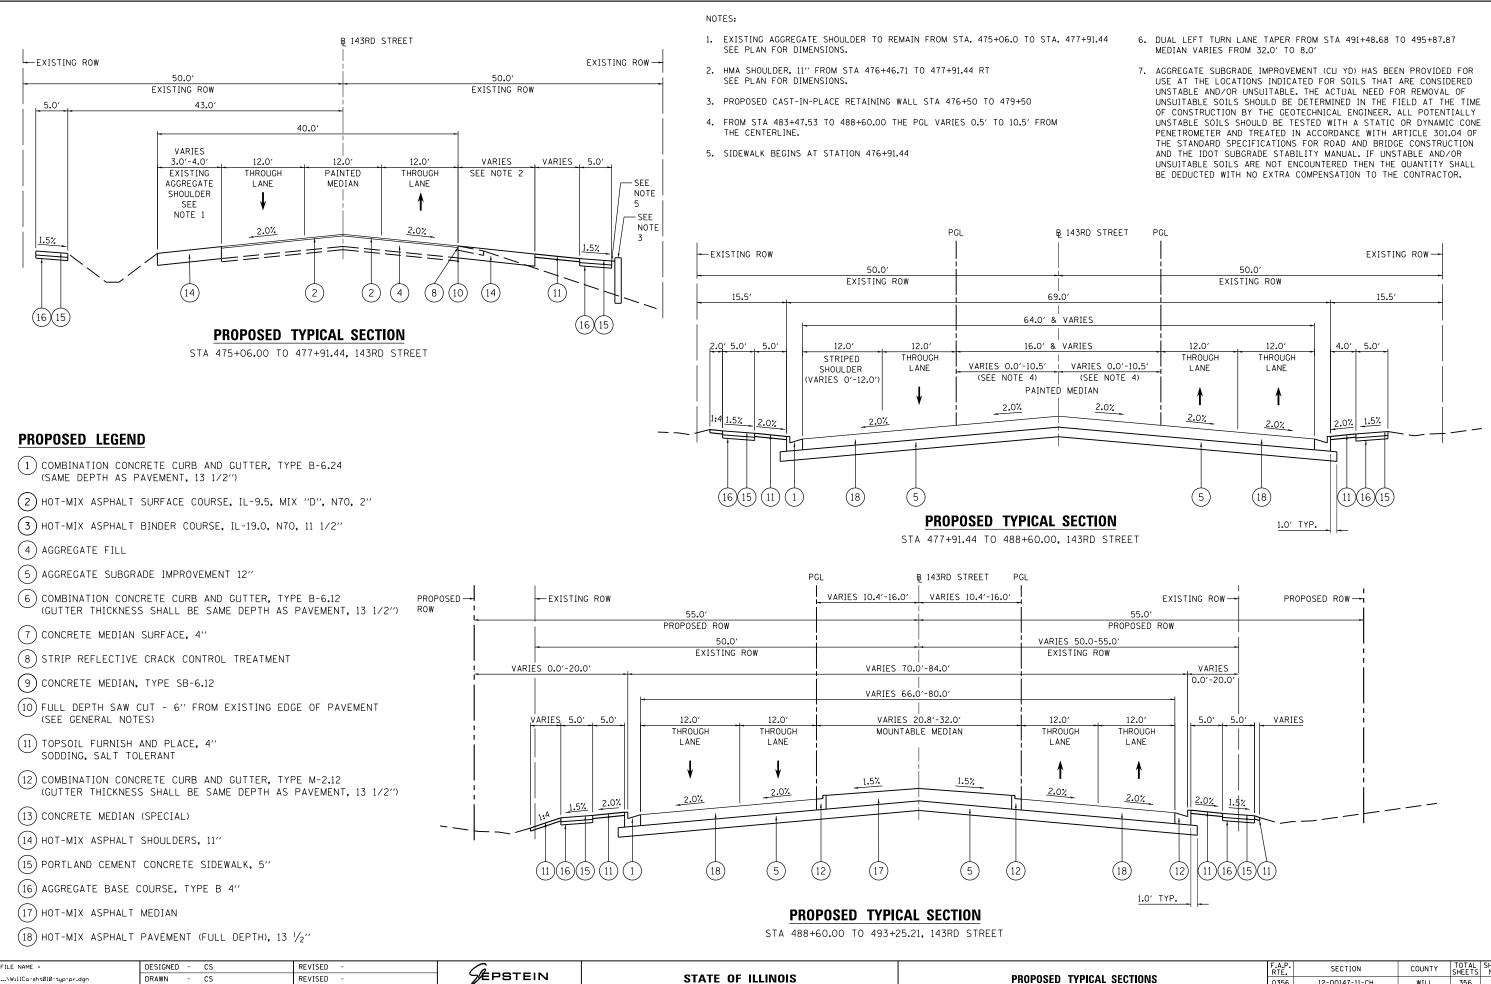

REVISED **DEPARTMENT OF TRANSPORTATION** TEL 312 454 910 FAX 312 559 121 CHICAGO, ILLINOIS SCALE: N.T.S. SHEET 10 OF 12 SHEET - 02/14/2024 REVISED

PLOT TIME = 3:54:07 PM

PLOT DATE = 2/14/2024

CHECKED


DATE

- JK

				F.A.P. RTE.	SECTION	COUNTY	TOTAL SHEETS	SHEET NO.
AL	SECT	IONS		0356	12-00147-11-CH	WILL	356	32
						CONTRACT	NO. 6	1D34
TS	STA.	N/A	TO STA. N/A		ILLINOIS FED. A	D PROJECT		

### NOTES:

- 1. DUAL LEFT TURN LANE FROM STA 495+87.87 TO 498+83.50 SEE DETAIL B
- 2. RIGHT TURN LANE FROM STA 500+00.97 TO 507+72.36 WITH 220.0' TAPER
- 3. DUAL LEFT TURN LANE FROM STA 501+18.00 TO 504+51.23 WITH 422.0' TAPER SEE DETAIL B
- 4. OUTSIDE LANE TRANSITIONS TO 12.0' FROM STA 500+00.97 TO 503+61.24
- 5. AGGREGATE SUBGRADE IMPROVEMENT (CU YD) HAS BEEN PROVIDED FOR USE AT THE LOCATIONS INDICATED FOR SOILS THAT ARE CONSIDERED UNSTABLE AND/OR UNSUITABLE. THE ACTUAL NEED FOR REMOVAL OF UNSUITABLE SOILS SHOULD BE DETERMINED IN THE FIELD AT THE TIME OF CONSTRUCTION BY THE GEOTECHNICAL ENGINEER. ALL POTENTIALLY UNSTABLE SOILS SHOULD BE TESTED WITH A STATIC OR DYNAMIC CONE PENETROMETER AND TREATED IN ACCORDANCE WITH ARTICLE 301.04 OF THE STANDARD SPECIFICATIONS FOR ROAD AND BRIDGE CONSTRUCTION AND THE IDOT SUBGRADE STABILITY MANUAL. IF UNSTABLE AND/OR UNSUITABLE SOILS ARE NOT ENCOUNTERED THEN THE QUANTITY SHALL BE DEDUCTED WITH NO EXTRA COMPENSATION TO THE CONTRACTOR.

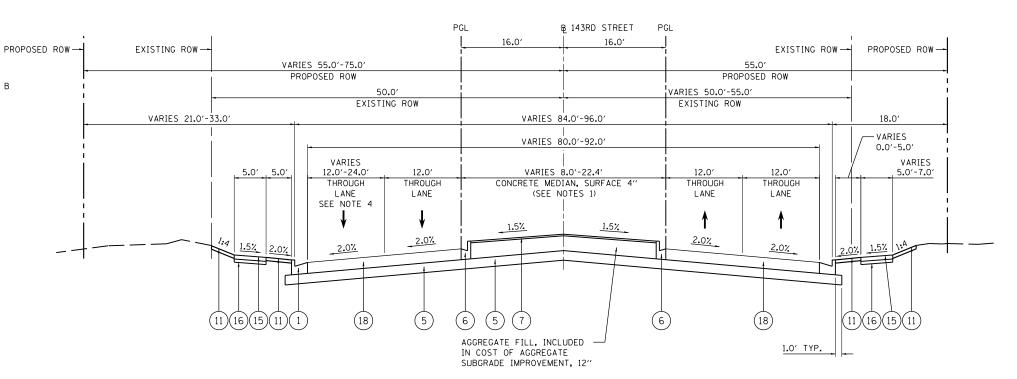


### **PROPOSED LEGEND**

- (1) COMBINATION CONCRETE CURB AND GUTTER, TYPE B-6.24 (SAME DEPTH AS PAVEMENT, 13 1/2")
- (2) HOT-MIX ASPHALT SURFACE COURSE, IL-9.5, MIX "D", N70, 2"
- (3) HOT-MIX ASPHALT BINDER COURSE, IL-19.0, N70, 11 1/2"
- (4) AGGREGATE FILL
- (5) AGGREGATE SUBGRADE IMPROVEMENT 12"
- (6) COMBINATION CONCRETE CURB AND GUTTER, TYPE B-6.12 (GUTTER THICKNESS SHALL BE SAME DEPTH AS PAVEMENT, 13 1/2")
- (7) CONCRETE MEDIAN SURFACE, 4"
- (8) STRIP REFLECTIVE CRACK CONTROL TREATMENT
- (9) CONCRETE MEDIAN, TYPE SB-6.12
- (10) FULL DEPTH SAW CUT 6" FROM EXISTING EDGE OF PAVEMENT (SEE GENERAL NOTES)
- (11) TOPSOIL FURNISH AND PLACE, 4" SODDING, SALT TOLERANT
- (12) COMBINATION CONCRETE CURB AND GUTTER, TYPE M-2.12 (GUTTER THICKNESS SHALL BE SAME DEPTH AS PAVEMENT, 13 1/2")
- (13) CONCRETE MEDIAN (SPECIAL)
- (14) HOT-MIX ASPHALT SHOULDERS, 11"
- (15) PORTLAND CEMENT CONCRETE SIDEWALK, 5"
- (16) AGGREGATE BASE COURSE, TYPE B 4"
- (17) HOT-MIX ASPHALT MEDIAN
- (18) HOT-MIX ASPHALT PAVEMENT (FULL DEPTH), 13 1/2"

**PROPOSED TYPICAL SECTION** 


STA 493+25.21 TO 500+00.97, 143RD STREET

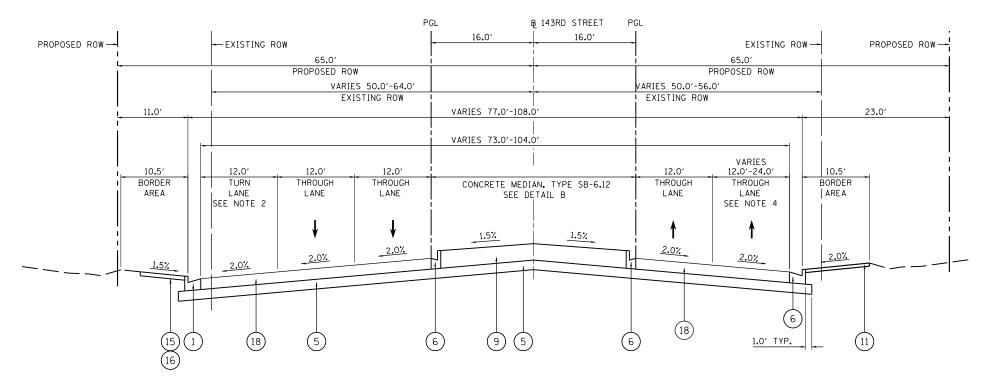

## **PROPOSED TYPICAL SECTION**

STA 500+00.97 TO 504+51.23, 143RD STREET

FILE NAME =	DESIGNED - CS	REVISED -	GEDOTEIN				F.A.P. RTE.	SECTION	COUNTY TOTAL SHEET SHEETS NO.
\WillCo-sht0ll-typ-pr.dgn	DRAWN - CS	REVISED -		STATE OF ILLINOIS	PROPOSED TYPICAL SECTIONS		0356	12-00147-11-CH	WILL 356 33
PLOT TIME = 3:54:08 PM	CHECKED - JK	REVISED -	600 W FULTON ST TEL 312 454 9100	DEPARTMENT OF TRANSPORTATION					CONTRACT NO. 61D34
PLOT DATE = 2/14/2024	DATE - 02/14/2024	REVISED -	CHICAGO, ILLINOIS FAX 312 559 1217 60661-1259 WEB www.epsteinglobel.com		SCALE: N.T.S. SHEET 11 OF 12 SHEETS STA. N/A	TO STA. N/A		ILLINOIS FED. /	AID PROJECT

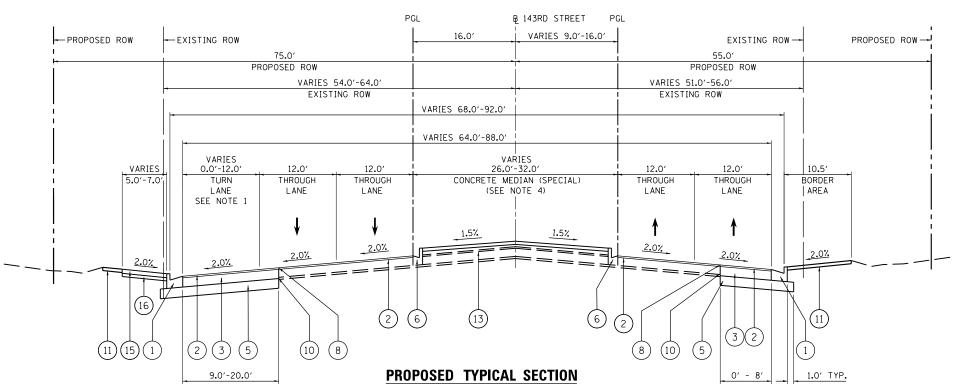


STA 504+51.23 TO 511+62.53, 143RD STREET

# **PROPOSED LEGEND**

(1) COMBINATION CONCRETE CURB AND GUTTER, TYPE B-6.24 (SAME DEPTH AS PAVEMENT, 13 1/2")

- (2) HOT-MIX ASPHALT SURFACE COURSE, IL-9.5, MIX "D", N70, 2"
- (3) HOT-MIX ASPHALT BINDER COURSE, IL-19.0, N70, 11 1/2"
- (4) AGGREGATE FILL
- (5) AGGREGATE SUBGRADE IMPROVEMENT 12"
- 6 COMBINATION CONCRETE CURB AND GUTTER, TYPE B-6.12 (GUTTER THICKNESS SHALL BE SAME DEPTH AS PAVEMENT, 13 1/2")
- (7) CONCRETE MEDIAN SURFACE, 4"
- (8) STRIP REFLECTIVE CRACK CONTROL TREATMENT
- (9) CONCRETE MEDIAN, TYPE SB-6.12
- 10 FULL DEPTH SAW CUT 6" FROM EXISTING EDGE OF PAVEMENT (SEE GENERAL NOTES)
- (11) TOPSOIL FURNISH AND PLACE, 4" SODDING, SALT TOLERANT
- (12) COMBINATION CONCRETE CURB AND GUTTER, TYPE M-2.12 (GUTTER THICKNESS SHALL BE SAME DEPTH AS PAVEMENT, 13 1/2")
- (13) CONCRETE MEDIAN (SPECIAL)
- (14) HOT-MIX ASPHALT SHOULDERS, 11"
- (15) PORTLAND CEMENT CONCRETE SIDEWALK, 5"
- (16) AGGREGATE BASE COURSE, TYPE B 4"
- (17) HOT-MIX ASPHALT MEDIAN
- (18) HOT-MIX ASPHALT PAVEMENT (FULL DEPTH), 13 1/2"

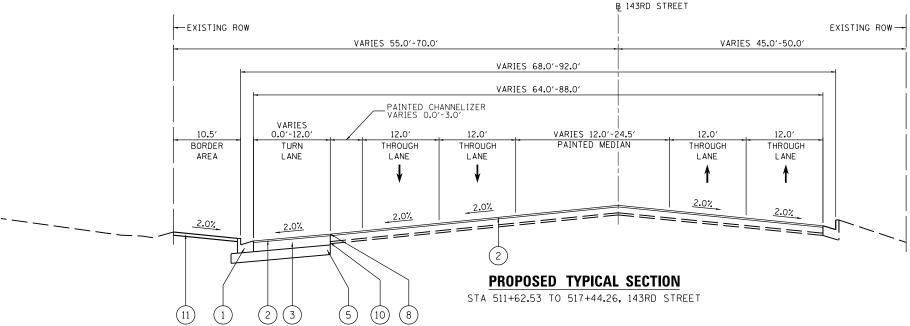

NOTES:

- 1. RIGHT TURN LANE FROM 512+75.03 TO 513+13.19
- 2. RIGHT TURN LANE FROM STA 504+50.01 TO 509+91.38 WITH 220.0' TAPER
- 3. DUAL LEFT TURN LANE FROM STA 504+50.01 TO 508+72.09 WITH 422.0' TAPER SEE DETAIL B
- 4. HOT-MIX ASPHALT MEDIAN FROM STA 507+00.00 TO 509+90.00, SEE DETAIL
- 5. LEFT TURN LANE FROM STA 507+00.00 TO 509+90.00

EXTRA COMPENSATION TO THE CONTRACTOR.

FILE NAME =	DESIGNED - CS	REVISED -	(Anner 1)				F.A.P.	SECTION	COUNTY	TOTAL SHEET SHEETS NO.
\WillCo-sht012-typ-pr.dgn	DRAWN - CS	REVISED -		STATE OF ILLINOIS	PROPOSED TYPICAL SECTIONS		0356	12-00147-11-CH	WILL	356 34
PLOT TIME = 3:54:08 PM	CHECKED - JK	REVISED -	600 W FULTON ST TEL 312 454 9100	DEPARTMENT OF TRANSPORTATION					-	T NO. 61D34
PLOT DATE = 2/14/2024	DATE - 02/14/2024	REVISED -	CHICAGO, ILLINOIS FAX 312 559 1217 60661-1259 WEB www.epsteinglobal.com		SCALE: N.T.S. SHEET 12 OF 12 SHEETS STA. N/A	TO STA. N/A		ILLINOIS FED. 4	-	

6. AGGREGATE SUBGRADE IMPROVEMENT (CU YD) HAS BEEN PROVIDED FOR USE AT THE LOCATIONS INDICATED FOR SOILS THAT ARE CONSIDERED UNSTABLE AND/OR UNSUITABLE. THE ACTUAL NEED FOR REMOVAL OF UNSUITABLE SOILS SHOULD BE DETERMINED IN THE FIELD AT THE TIME OF CONSTRUCTION BY THE GEOTECHNICAL ENGINEER. ALL POTENTIALLY UNSTABLE SOILS SHOULD BE TESTED WITH A STATIC OR DYNAMIC CONE PENETROMETER AND TREATED IN ACCORDANCE WITH ARTICLE 301.04 OF THE STANDARD SPECIFICATIONS FOR ROAD AND BRIDGE CONSTRUCTION AND THE IDOT SUBGRADE STABILITY MANUAL. IF UNSTABLE AND/OR UNSUITABLE SOILS ARE NOT ENCOUNTERED THEN THE QUANTITY SHALL BE DEDUCTED WITH NO

			1	1	ENTRANCE	ES	r		1				EARTHWORK			
	SIDE	TYPE	AGGREGATE BASE COURSE, TYPE B 12" (SQ YD)			HOT-MIX ASPHALT SURFACE COURSE, IL-9.5, MIX "D", N50 2 1/2" (TON)		AGGREGATE BASE COURSE, TYPE B 4" (SQ YD)		TEMPORARY ACCESS (COMMERCIAL ENTRANCE) (EACH)	LOCATION	CUT	FILL ADJUSTED FOR SHRINKAGE	SUITABLE CUT	TOPSOIL	BALANG
			(35102400)	(40603080)	(40604060)	(40604060)		(35101600)	(X4021000)	(X4022000)	BELL ROAD	21,755	6,729	13,624	8,131	6,89
82+68.62	RT	PE							1		143RD STREET	18,114	2,418	13,737	4,377	11,31
83+19.79	RT	PE							1		MEIJER/JEWEL-OSCO ENTRANCES	1,244	229	1,244	10.500	1,01
83+81.88	RT	PE							1		TOTAL	41,115	9,376	28,605	12,508	19,2
86+60.63	RT	PE							1							
86+89.23	LT	PE							1							
37+79.94	RT	PE	94			13			1							
38+21.38	RT	PE	93			13			1							
88+81.20	LT	CE	224	144	25					1						
89+93.85	RT	PE	90			13			1							
90+81.12	RT	PE	123			17			1							
91+84.97	RT	PE	81	101		11			1							
94+43.58	LT	CE	188	121	21					1						
94+72.35	RT	PE	184			26			2							
95+36.18 96+69.52	RT	PE PE	71			10			1							
90+09.52 99+44.01	RT	CE	89	57	10	10	273	30		1						
9+44.01 9+44.51	LT RT	CE	138	89	15		273	29		1						
2+22.63	RT	CE	98	63	11		239	29		1						
)3+75.95	RT	CE	98	63	11		192	23		1						
04+00.00		CE					92	10		•						
04+74.18		CE	- 187	121	21		641	71	-	2						
09+09.72	RT	CE	54	35	6		171	19		1						
9+50.14	LT	CE	69	45	8		309	34		1						
9+91.78	RT	CE	111	72	12					1						
9+01.39	LT	CE	155	100	17		236	26		1						
4+99.19	LT	CE	154	99	17					1						
25+00.86	RT	CE	156	101	17					1						
9+79.49	RT	CE	42	27	5		185	21		1						
80+56.61	RT	CE	175	113	20		184	20		1						
3+64.58	LT	CE	102	65	11		198	22		1						
5+43.95	RT	CE	35	22	4		154	17		1						
5+66.63 6+36.10	LT LT	CE CE	153	98	17		660	73		2						
0+90.63		CE	68	44	8		228	25		1						
1+79.61	RT	CE	36	23	4		190	21		1						
3+07.59		CE	100	64	11		205	23		1						
3+20.51	RT	CE	180	116	20		243	27		1						
6+50.00	LT	CE	220	142	25		315	35		1						
8+04.69	RT	CE	110	71	12		350	39		1						
2+05.24	RT	CE	- 444	286	50					2						
3+00.00	RT	CE			50					2						
2+85.47	LT	CE	78	50	9		309	34		1						
6+16.03	LT	CE	136	88	15		371	41		1						
7+32.02	LT	PE	109			15			1							
7+98.11	RT	CE	121	78	14					1		NOTES	s			
9+87.00	RT	CE	73	47	8					1			_			
11+34.12	RT	CE	41 4,680	26 <b>2,470</b>	5 <b>429</b>	118	5,988	663		1 33			ATE ENTRANCE (P REGATE BASE COU			

FILE NAME =	DESIGNED - CS	REVISED -						F.A.P. RTF.	SECTION	COUNTY	TOTAL SHEET SHEETS NO.
\WillCo-sht001-schedule.dgn	DRAWN - CS	REVISED -	<i>Y</i> EPSTEIN	STATE OF ILLINOIS		SCHEDULE OF QUANTITIES		0356	12-00147-11-CH	WILL	356 35
PLOT TIME = 3:54:08 PM	CHECKED - JK	REVISED -	600 W FULTON ST TEL 312 454 9100	DEPARTMENT OF TRANSPORTATION						_	CT NO. 61D34
PLOT DATE = 2/14/2024	DATE - 02/14/2024	REVISED -	CHICAGO, ILLINOIS FAX 312 559 1217 60661-1259 WEB www.epsteinglobel.com		SCALE: N/A	SHEET 1 OF 3 SHEETS STA. N/A	TO STA. N/A		ILLINOIS FED.	AID PROJECT	

- 2. COMMERCIAL ENTRANCE (CE) PAVEMENT SECTION: AGGREGATE BASE COURSE, TYPE B 12" HOT-MIX ASPHALT BINDER COURSE, IL-19.0, N50, 11 1/2" HOT-MIX ASPHALT SURFACE COURSE, IL-9.5, MIX "D", N50, 2"
- 3. FOR ENTRANCES AND TREE REMOVAL LOCATIONS REFER TO REMOVAL PLANS.
- 4. TRAFFIC SIGNAL SCHEDULES CAN BE FOUND ON TRAFFIC SIGNAL PLANS.
- 5. TEMPORARY PAVEMENT MARKING SCHEDULE CAN BE FOUND ON SUGGESTED STAGES OF CONSTRUCTION AND TRAFFIC CONTROL GENERAL NOTES.

EF	ROSION C	ONTROL - TABLE 1	
T	EMPORAF	RY DITCH CHECKS	
LOCA	TION		
STATION	SIDE	DESCRIPTION	FOOT
187+45	LT	EXISTING DITCH	10
188+45	LT	EXISTING DITCH	10
187+26	LT	PROPOSED DITCH	10
188+01	LT	PROPOSED DITCH	10
188+01	RT	PROPOSED DITCH	10
189+01	RT	PROPOSED DITCH	10
189+26	LT	PROPOSED DITCH	10
189+45	LT	EXISTING DITCH	10
190+01	LT	PROPOSED DITCH	10
191+01	LT	PROPOSED DITCH	10
191+12	RT	EXISTING DITCH	10
191+26	RT	PROPOSED DITCH	10
192+01	LT	PROPOSED DITCH	10
192+07	RT	EXISTING DITCH	10
192+26	RT	PROPOSED DITCH	10
192+99		EXISTING DITCH	10
192+99	RT		10
193+01	LT	PROPOSED DITCH	10
193+01	RT	PROPOSED DITCH	10
193+01	RT	EXISTING DITCH	10
			10
194+01		PROPOSED DITCH	10
194+99 194+99	LT RT	EXISTING DITCH	10
195+01		PROPOSED DITCH	10
195+99	LT	EXISTING DITCH	10
196+00	RT	EXISTING DITCH	10
196+01	LT	PROPOSED DITCH	10
196+99	LT	EXISTING DITCH	10
197+00	RT	EXISTING DITCH	10
197+01	LT	PROPOSED DITCH	10
197+99	LT	EXISTING DITCH	10
198+01	LT	PROPOSED DITCH	10
198+30	RT	EXISTING DITCH	10
199+01	LT	PROPOSED DITCH	10
200+01	LT	PROPOSED DITCH	10
201+01	LT	PROPOSED DITCH	10
202+03	LT	EXISTING DITCH	10
203+01	LT	PROPOSED DITCH	10
221+02	RT	PROPOSED DITCH	10
222+02	RT	PROPOSED DITCH	10
223+02	LT	PROPOSED DITCH	10
223+02	RT	PROPOSED DITCH	10
224+02	LT	PROPOSED DITCH	10
224+02	RT	PROPOSED DITCH	

		NTROL - TABLE 2	
		Y DITCH CHECKS	
		DESCRIPTION	FOOT
STATION	SIDE	PROPOSED DITCH	10
228+01	RT RT		10
229+01 230+01	RT	PROPOSED DITCH PROPOSED DITCH	10
230+01	RT	PROPOSED DITCH	10
474+81		EXISTING DITCH	10
475+75	LT	EXISTING DITCH	10
478+07	LT	EXISTING DITCH	10
479+07	LT	EXISTING DITCH	10
480+06	LT	EXISTING DITCH	10
481+06	LT	EXISTING DITCH	10
482+06	LT	EXISTING DITCH	10
482+15	RT	EXISTING DITCH	10
483+16	RT	EXISTING DITCH	10
484+15	RT	EXISTING DITCH	10
485+06	LT	EXISTING DITCH	10
485+16	RT	EXISTING DITCH	10
486+65	RT	EXISTING DITCH	10
		PROPOSED DITCH	10
487+01			
487+16	RT	EXISTING DITCH	10
487+56	LT	EXISTING DITCH	10
487+66	RT	EXISTING DITCH	10
488+01	LT	PROPOSED DITCH	10
488+06	LT	EXISTING DITCH	10
488+16	RT	EXISTING DITCH	10
488+56	LT	EXISTING DITCH	10
488+66	RT	EXISTING DITCH	10
489+01	LT	PROPOSED DITCH	10
489+06	LT	EXISTING DITCH	10
489+16	RT	EXISTING DITCH	10
489+56	LT	EXISTING DITCH	10
489+66	RT	EXISTING DITCH	10
490+01	LT	PROPOSED DITCH	10
490+16	RT	EXISTING DITCH	10
490+66	RT	EXISTING DITCH	10
491+16	RT	EXISTING DITCH	10
505+02	RT	PROPOSED DITCH	10
506+02	RT	PROPOSED DITCH	10
507+02	RT	PROPOSED DITCH	10
508+01	LT	PROPOSED DITCH	10
508+73	RT	EXISTING DITCH	10
509+01	LT	PROPOSED DITCH	10
509+24	RT	EXISTING DITCH	10
510+01	LT	PROPOSED DITCH	10
514+01	LT	PROPOSED DITCH	10
515+01	LT	PROPOSED DITCH	10
516+01	LT	PROPOSED DITCH	10
517+01	LT	PROPOSED DITCH	10
517+69	LT	EXISTING DITCH	10
TOTAL			920

	EROSIC	ON CONTROL - TABLE 4	
		INLET FILTERS	
LOCA STATION	SIDE	DESCRIPTION	EACH
18+68	LT	EXISTING CATCH BASIN	1
18+70	RT	EXISTING CATCH BASIN	1
19+11	RT	EXISTING CATCH BASIN	1
19+15	LT	PROPOSED CATCH BASIN	2
19+23	LT	PROPOSED CATCH BASIN	1
21+82	LT	EXISTING CATCH BASIN	1
21+82	LT	PROPOSED CATCH BASIN	1
21+84	RT	PROPOSED CATCH BASIN	1
22+81	RT	PROPOSED CATCH BASIN	1
22+85	LT	PROPOSED CATCH BASIN	1
186+42	LT	EXISTING CATCH BASIN	1
186+84	RT	EXISTING CATCH BASIN	1
187+39	LT	PROPOSED CATCH BASIN	1
187+50	RT	PROPOSED CATCH BASIN	1
188+37	LT	EXISTING CATCH BASIN	1
188+37	LT	PROPOSED CATCH BASIN	1
188+54	RT	EXISTING CATCH BASIN	1
188+54	RT	PROPOSED CATCH BASIN	1
189+10	LT	PROPOSED CATCH BASIN	1
191+49	RT	PROPOSED CATCH BASIN	1
191+50	LT	PROPOSED CATCH BASIN	1
192+79	RT	PROPOSED CATCH BASIN	1
192+80	LT	PROPOSED CATCH BASIN	1
194+03	RT	PROPOSED CATCH BASIN	1
194+08	LT	PROPOSED CATCH BASIN	1
194+99	RT	PROPOSED CATCH BASIN	1
195+00	LT	PROPOSED CATCH BASIN	1
196+33	RT	PROPOSED CATCH BASIN	1
196+35	LT	PROPOSED CATCH BASIN	1
197+56	LT	PROPOSED CATCH BASIN	1
197+57	RT	PROPOSED CATCH BASIN	1
198+74	RT	PROPOSED CATCH BASIN	1
198+76	LT	PROPOSED CATCH BASIN	1
200+14	RT	PROPOSED CATCH BASIN	1
200+16	LT	PROPOSED CATCH BASIN	1
201+25	RT	PROPOSED CATCH BASIN	1
201+26	LT	PROPOSED CATCH BASIN	1
201+64	RT	EXISTING CATCH BASIN	1
201+64	LT	EXISTING CATCH BASIN	1
201+68	RT	EXISTING CATCH BASIN	1
201+68	LT	EXISTING CATCH BASIN	1
201+71	RT	PROPOSED CATCH BASIN	1
201+72	RT	PROPOSED CATCH BASIN	1
201+72	LT	PROPOSED CATCH BASIN	1
201+73	LT	PROPOSED CATCH BASIN	1
201+89	RT	PROPOSED CATCH BASIN	1
201+90	RT	PROPOSED CATCH BASIN	1
201+90	LT	PROPOSED CATCH BASIN	1
I			

# <u>NOTES</u>

1. FOR EROSION CONTROL QUANTITIES REFER TO EROSION CONTROL PLANS.

FILE NAME =	DESIGNED - CS	REVISED -	GEPSTEIN				F.A.P. RTE.	SECTION	COUNTY	TOTAL SHEET SHEETS NO.
\WillCo-sht002-schedule.dgn	DRAWN - CS	REVISED -		STATE OF ILLINOIS	SCHEDULE OF QUANTITIES		0356	12-00147-11-CH	WILL	356 36
PLOT TIME = 3:54:10 PM	CHECKED - JK	REVISED -	600 W FULTON ST TEL 312 454 9100 CHICAGO, ILLINOIS FAX 312 559 1217	DEPARTMENT OF TRANSPORTATION			_		CONTRACT	NO. 61D34
PLOT DATE = 2/14/2024	DATE - 02/14/2024	REVISED -	60661-1259 WEB www.epsteinglobal.com		SCALE: N/A SHEET 2 OF 3 SHEETS STA. N/A	TO STA. N/A		ILLINOIS FED. 4	AID PROJECT	

	FROSIO	N CONTROL - TABLE 5	
		NLET FILTERS	
LOCA	TION		EACU
STATION	SIDE	DESCRIPTION	EACH
201+91	LT	PROPOSED CATCH BASIN	1
202+80	RT	PROPOSED CATCH BASIN	1
202+81	LT	PROPOSED CATCH BASIN	1
202+86	LT	PROPOSED CATCH BASIN	1
204+19	RT	PROPOSED CATCH BASIN	1
204+20	LT	PROPOSED CATCH BASIN	1
204+21	LT	PROPOSED CATCH BASIN	1
206+59	LT	EXISTING CATCH BASIN	1
208+15	RT	PROPOSED CATCH BASIN	1
208+15	RT	PROPOSED CATCH BASIN	1
208+15	LT	PROPOSED CATCH BASIN	1
208+65	RT	PROPOSED CATCH BASIN	1
208+90	LT	PROPOSED CATCH BASIN	1
209+75	LT	PROPOSED CATCH BASIN	1
209+79	RT	EXISTING CATCH BASIN	1
210+12	RT	PROPOSED CATCH BASIN	1
210+13	RT	PROPOSED CATCH BASIN	1
210+13	LT	PROPOSED CATCH BASIN	1
211+77	RT	PROPOSED CATCH BASIN	1
211+77	LT	PROPOSED CATCH BASIN	1
211+77	RT	EXISTING CATCH BASIN	1
211+78		PROPOSED CATCH BASIN	1
213+28		EXISTING CATCH BASIN	1
213+30	RT	EXISTING CATCH BASIN	1
213+35	RT	PROPOSED CATCH BASIN	1
213+36	RT	PROPOSED CATCH BASIN	1
213+36	LT	PROPOSED CATCH BASIN	1
213+36	LT	PROPOSED CATCH BASIN	1
214+63	RT	PROPOSED CATCH BASIN	1
214+64		PROPOSED CATCH BASIN	1
215+03	RT	EXISTING CATCH BASIN	1
215+05	LT	EXISTING CATCH BASIN	1
216+07		EXISTING CATCH BASIN	1
217+00	RT	PROPOSED CATCH BASIN	1
217+00		PROPOSED CATCH BASIN	1
217+55	RT	EXISTING CATCH BASIN	1
218+60	RT	PROPOSED CATCH BASIN	1
218+60	RT	PROPOSED CATCH BASIN	1
218+60		PROPOSED CATCH BASIN	1
218+60		PROPOSED CATCH BASIN	1
218+81		EXISTING CATCH BASIN	1
218+83		PROPOSED CATCH BASIN	1
219+20		PROPOSED CATCH BASIN	1
219+41		EXISTING CATCH BASIN	1
220+15	RT	PROPOSED CATCH BASIN	1
220+15		PROPOSED CATCH BASIN	1
220+56	RT	EXISTING CATCH BASIN	1
221+15		PROPOSED CATCH BASIN	1
221+15		PROPOSED CATCH BASIN	
221+15	RT	PROPOSED CATCH BASIN	1
221+15	RT	PROPOSED CATCH BASIN	1
221+33		PROPOSED CATCH BASIN	1
221+55	LT	PROPOSED CATCH BASIN	1
221+55	RT	PROPOSED CATCH BASIN	
221+55	LT	PROPOSED CATCH BASIN	1
221+56 221+95	RT LT	PROPOSED CATCH BASIN PROPOSED CATCH BASIN	1
	LT		1
222+03		EXISTING CATCH BASIN	1
222+08	LT	EXISTING CATCH BASIN	1
222+09 222+16	RT RT	EXISTING CATCH BASIN	1
222+16	LT	PROPOSED CATCH BASIN	1
222700	LI		


LOCA STATION	TION SIDE	DESCRIPTION	EACH
222+55	RT	PROPOSED CATCH BASIN	1
223+10	RT	PROPOSED CATCH BASIN	1
223+10	LT	PROPOSED CATCH BASIN	1
224+78	RT	EXISTING CATCH BASIN	1
224+70	LT	PROPOSED CATCH BASIN	1
			-
224+87	RT	PROPOSED CATCH BASIN	1
225+13	LT	PROPOSED CATCH BASIN	1
225+15	RT	PROPOSED CATCH BASIN	1
225+40	LT	PROPOSED CATCH BASIN	1
226+38	RT	EXISTING CATCH BASIN	1
226+39	LT	EXISTING CATCH BASIN	1
226+50	RT	PROPOSED CATCH BASIN	1
226+50	LT	PROPOSED CATCH BASIN	1
226+50	RT	PROPOSED CATCH BASIN	1
			-
227+11		PROPOSED CATCH BASIN	1
228+89	RT	EXISTING CATCH BASIN	1
228+90	LT	EXISTING CATCH BASIN	1
229+00	RT	PROPOSED CATCH BASIN	1
229+00	LT	PROPOSED CATCH BASIN	1
229+47	LT	PROPOSED CATCH BASIN	1
231+38	LT	EXISTING CATCH BASIN	1
231+30	RT	EXISTING CATCH BASIN	1
			-
231+45	RT	PROPOSED CATCH BASIN	1
231+45	LT	PROPOSED CATCH BASIN	1
231+45	LT	PROPOSED CATCH BASIN	1
478+00	LT	PROPOSED CATCH BASIN	1
478+00	RT	PROPOSED CATCH BASIN	1
479+40	LT	PROPOSED CATCH BASIN	1
479+40	RT	PROPOSED CATCH BASIN	1
480+90	RT	PROPOSED CATCH BASIN	1
			-
480+90	LT	PROPOSED CATCH BASIN	1
482+40	LT	PROPOSED CATCH BASIN	1
482+40	RT	PROPOSED CATCH BASIN	1
484+10	LT	PROPOSED CATCH BASIN	1
484+10	RT	PROPOSED CATCH BASIN	1
484+90	LT	PROPOSED CATCH BASIN	1
484+90	RT	PROPOSED CATCH BASIN	1
486+80	RT	PROPOSED CATCH BASIN	1
	LT	PROPOSED CATCH BASIN	
486+80			
488+00	RT	PROPOSED CATCH BASIN	1
488+00	LT	PROPOSED CATCH BASIN	1
489+40	RT	PROPOSED CATCH BASIN	1
489+40	LT	PROPOSED CATCH BASIN	1
490+19	LT	EXISTING CATCH BASIN	1
492+40	LT	PROPOSED CATCH BASIN	1
492+40	RT	PROPOSED CATCH BASIN	1
492+57	LT	EXISTING CATCH BASIN	1
492+58	RT	EXISTING CATCH BASIN	1
493+60		PROPOSED CATCH BASIN	1
493+60	RT	PROPOSED CATCH BASIN	1
494+80	LT	PROPOSED CATCH BASIN	1
494+80	RT	PROPOSED CATCH BASIN	1
495+48	LT	EXISTING CATCH BASIN	1
495+55	 LT	PROPOSED CATCH BASIN	1
495+55	RT	EXISTING CATCH BASIN	1
			-
496+00	RT	PROPOSED CATCH BASIN	1
496+00	LT	PROPOSED CATCH BASIN	1
496+25	LT	PROPOSED CATCH BASIN	1
490-23		IDDODOOFD OATOU DAGINI	1
496+95	LT	PROPOSED CATCH BASIN	
	LI RT	PROPOSED CATCH BASIN	1

	ERUSI	ON CONTROL - TABLE 7 INLET FILTERS	
LOCA			
STATION	SIDE	DESCRIPTION	EAC
497+25	LT	existing catch basin	1
497+28	RT	existing catch basin	1
497+65	LT	proposed catch basin	1
498+60	RT	proposed catch basin	1
498+60	LT	proposed catch basin	1
499+46	LT	existing catch basin	1
501+90	LT	existing catch basin	1
502+26	LT	proposed catch basin	1
502+26	RT	proposed catch basin	1
502+26	RT	proposed catch basin	1
503+36	LT	existing catch basin	1
503+36	RT	existing catch basin	1
503+66	LT	proposed catch basin	1
503+66	RT	proposed catch basin	1
503+80	RT	proposed catch basin	
505+50	LT	existing catch basin	
505+50	RT	existing catch basin	
505+60	LT	proposed catch basin	
505+61	RT	proposed catch basin	1
505+61	RT	proposed catch basin	1
505+61	RT	1 1	1
506+03		proposed catch basin	
		proposed catch basin	
506+31		proposed catch basin	1
507+50	LT	existing catch basin	1
507+56		proposed catch basin	1
507+56	RT	proposed catch basin	1
507+56	RT	proposed catch basin	1
508+25	RT	existing catch basin	1
508+51	LT	proposed catch basin	1
509+51	RT	existing catch basin	1
509+51	RT	proposed catch basin	1
509+51	LT	existing catch basin	1
509+91	LT	proposed catch basin	1
510+14	LT	existing catch basin	1
510+22	RT	existing catch basin	1
511+11	RT	existing catch basin	1
511+16	LT	proposed catch basin	1
511+81	LT	existing catch basin	1
511+88	LT	proposed catch basin	1
512+59	LT	proposed catch basin	1
512+63	LT	existing catch basin	1
512+67	RT	existing catch basin	1
513+15	LT	existing catch basin	1
513+26	LT	proposed catch basin	1
514+26	LT	proposed catch basin	1
514+57	RT	existing catch basin	1
514+57	LT	existing catch basin	
515+26	LT	proposed catch basin	
516+36		proposed catch basin	1
517+31		proposed catch basin	1
311.01	<u> </u>	In shore outen pasin	

FILE NAME =	DESIGNED - CS	REVISED -					F.A.P.	SECTION	COUNTY	TOTAL	SHEET
\WillCo-sht003-schedule.dgn	DRAWN - CS	REVISED -		STATE OF ILLINOIS	SCHEDULE OF QUANTITIES		0356	12-00147-11-CH	WILL	356	37
PLOT TIME = 3:54:12 PM	CHECKED - JK	REVISED -	600 W FULTON ST TEL 312 454 9100	DEPARTMENT OF TRANSPORTATION				CONTRAC	T NO. 6	51D34	
PLOT DATE = 2/14/2024	DATE - 02/14/2024	REVISED -	CHICAGO, ILLINOIS FAX 312 559 1217 60661-1259 WEB www.epsteinglobel.com		SCALE: N/A SHEET 3 OF 3 SHEETS STA. N/A	TO STA. N/A		ILLINOIS FED. AID PROJECT			

## <u>NOTES</u>

1. FOR EROSION CONTROL QUANTITIES REFER TO EROSION CONTROL PLANS.

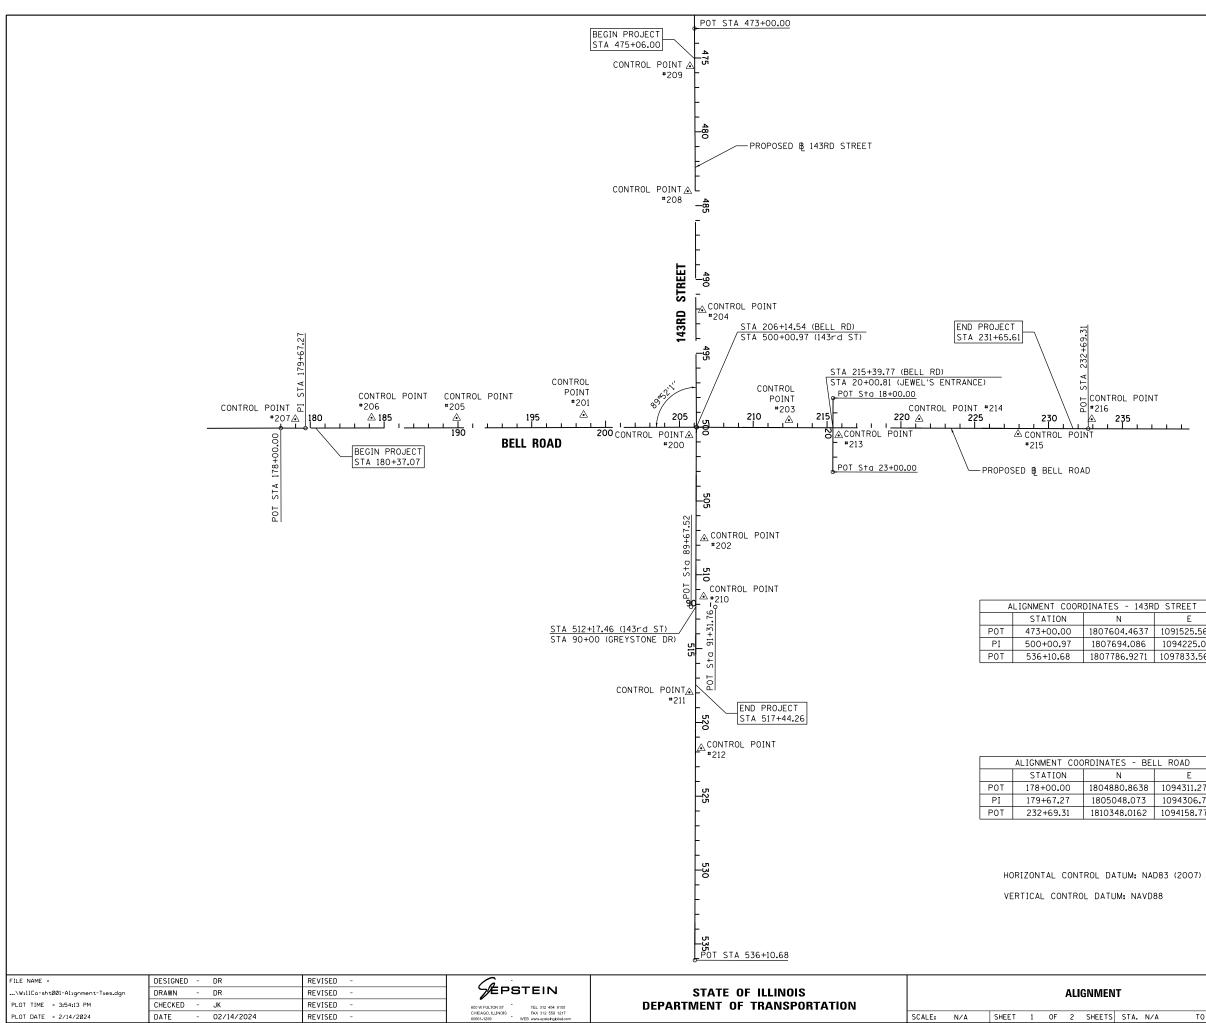

F.A.P. RTE.	SECTION			SHEET NO.		
0356	12-00147-11-CH	WILL	356	38		
				1D34		
ILLINOIS FED. AID PROJECT						
	RTE.	RTE.         SECTION           0356         12-00147-11-CH	RTE.         SECTION         COUNT           0356         12-00147-11-CH         WILL           CONTRACT	RTE.         SECTION         COUNT         SHEETS           0356         12-00147-11-CH         WILL         356           CONTRACT         NO.         6		

SEE SHEET 39 FOR BENCHMARK INFORMATION.


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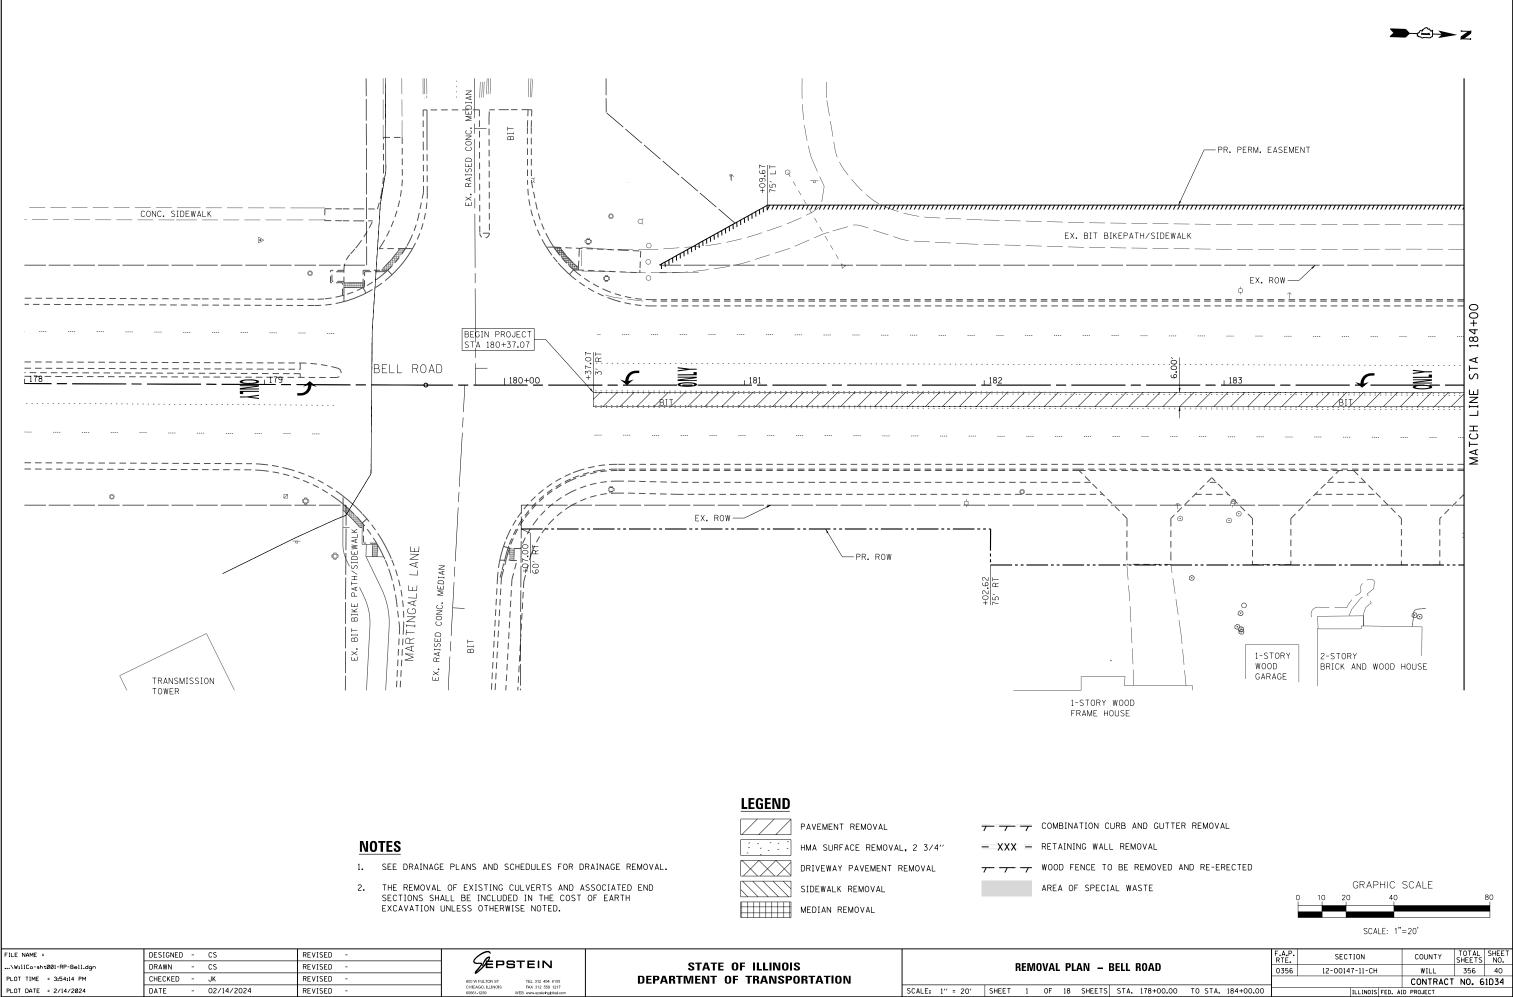
TES - BELL ROAD							
Ν	E						
880.8638	1094311.2793						
5048.073	1094306.758						
348.0162	1094158.7752						

ES - 143R	D STREET
N	E
604.4637	1091525.5684
7694.086	1094225.056
7786.9271	1097833.5646

235


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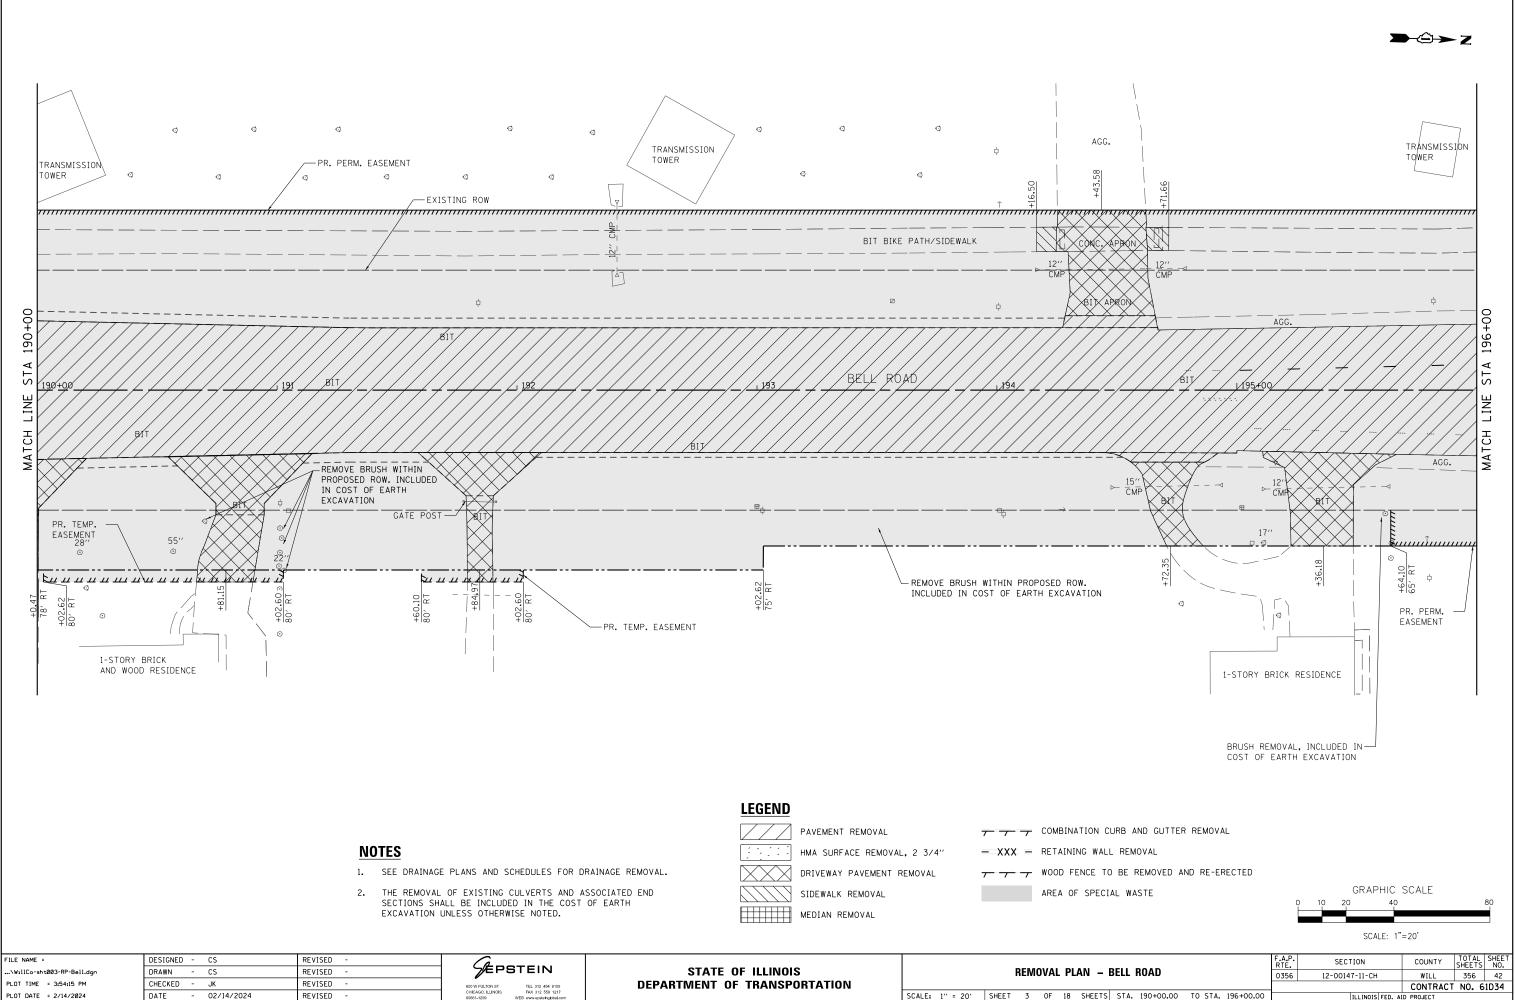


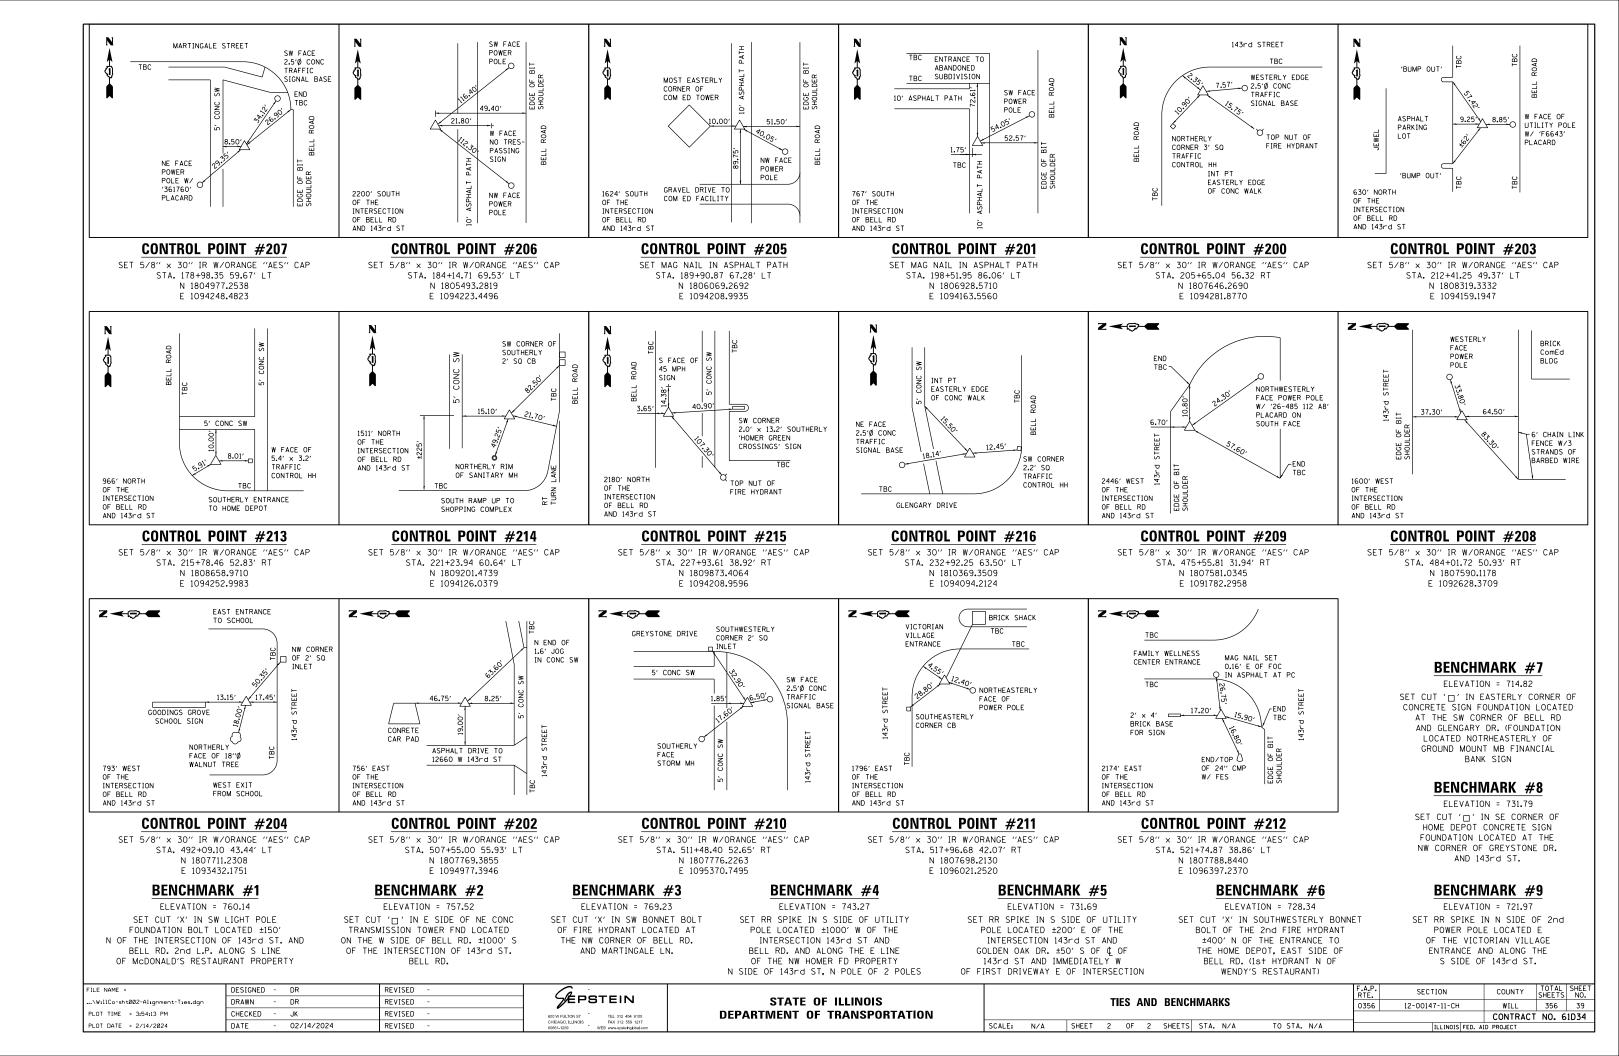


DATE


						CONTRACT	NO.
S	STA.	178+00.00	TO STA.	184+00.00	ILLINOIS FED. AI	D PROJECT	



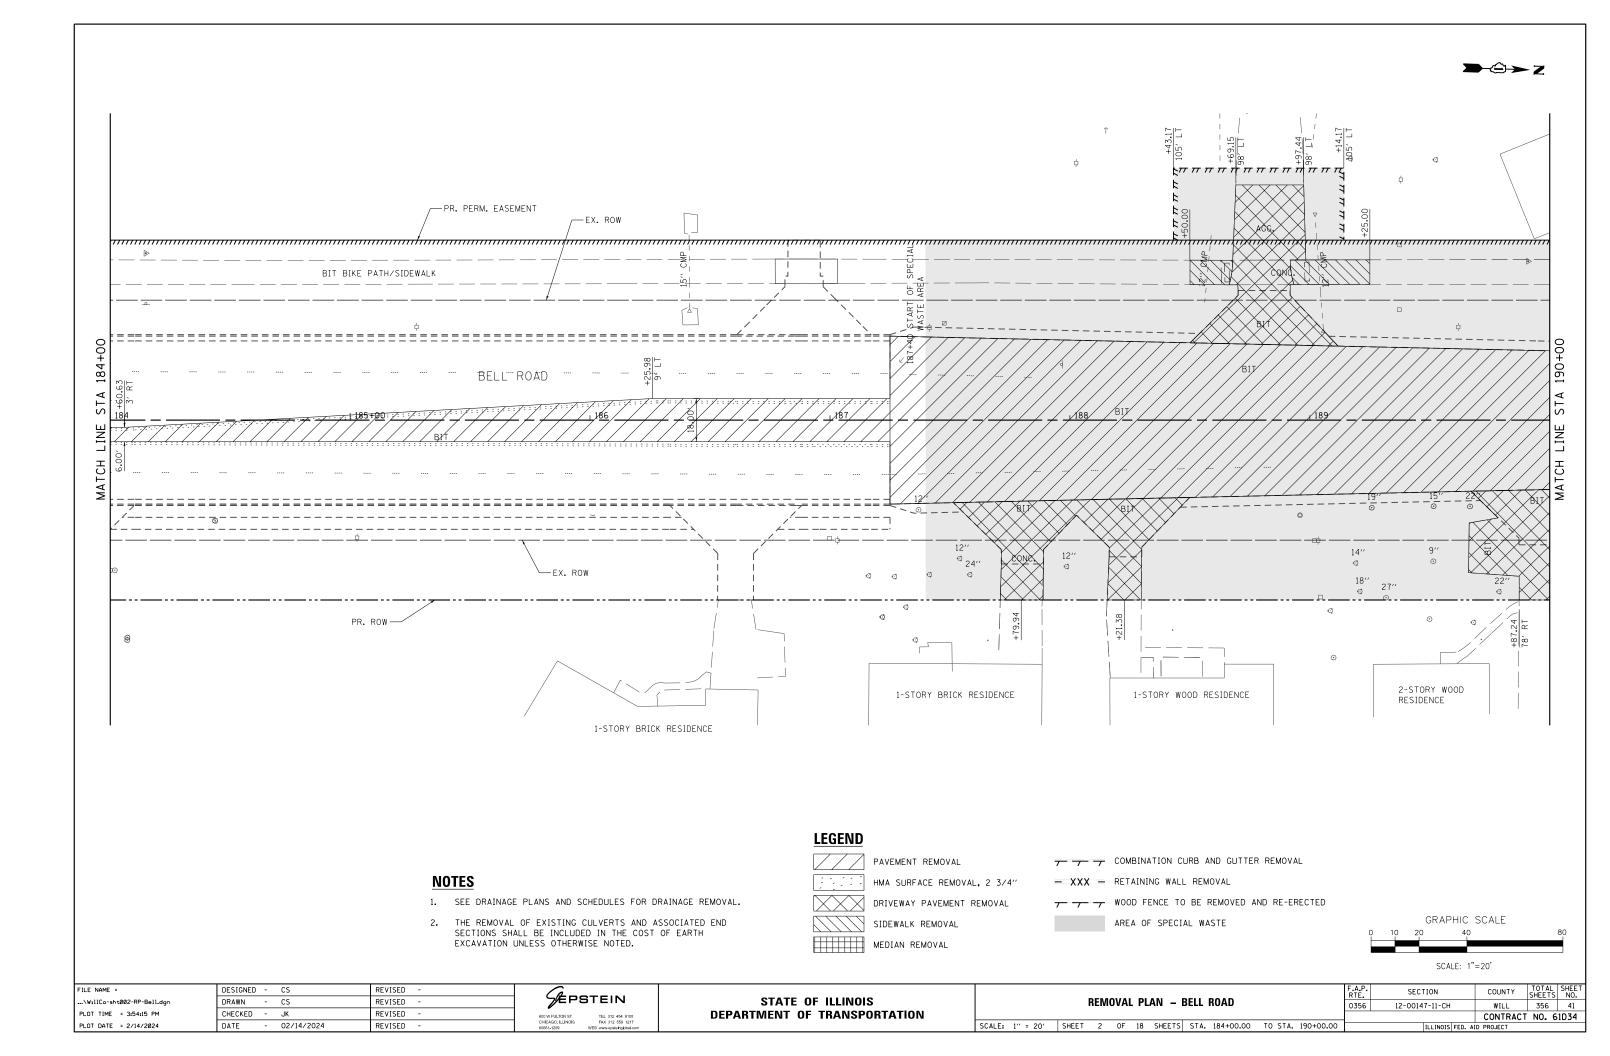


SCALE: 1" = 20' SHEET 3 OF 18 SHEETS STA. 190+00.00 TO STA. 196+00.00 ILLINOIS FED. AID PROJECT

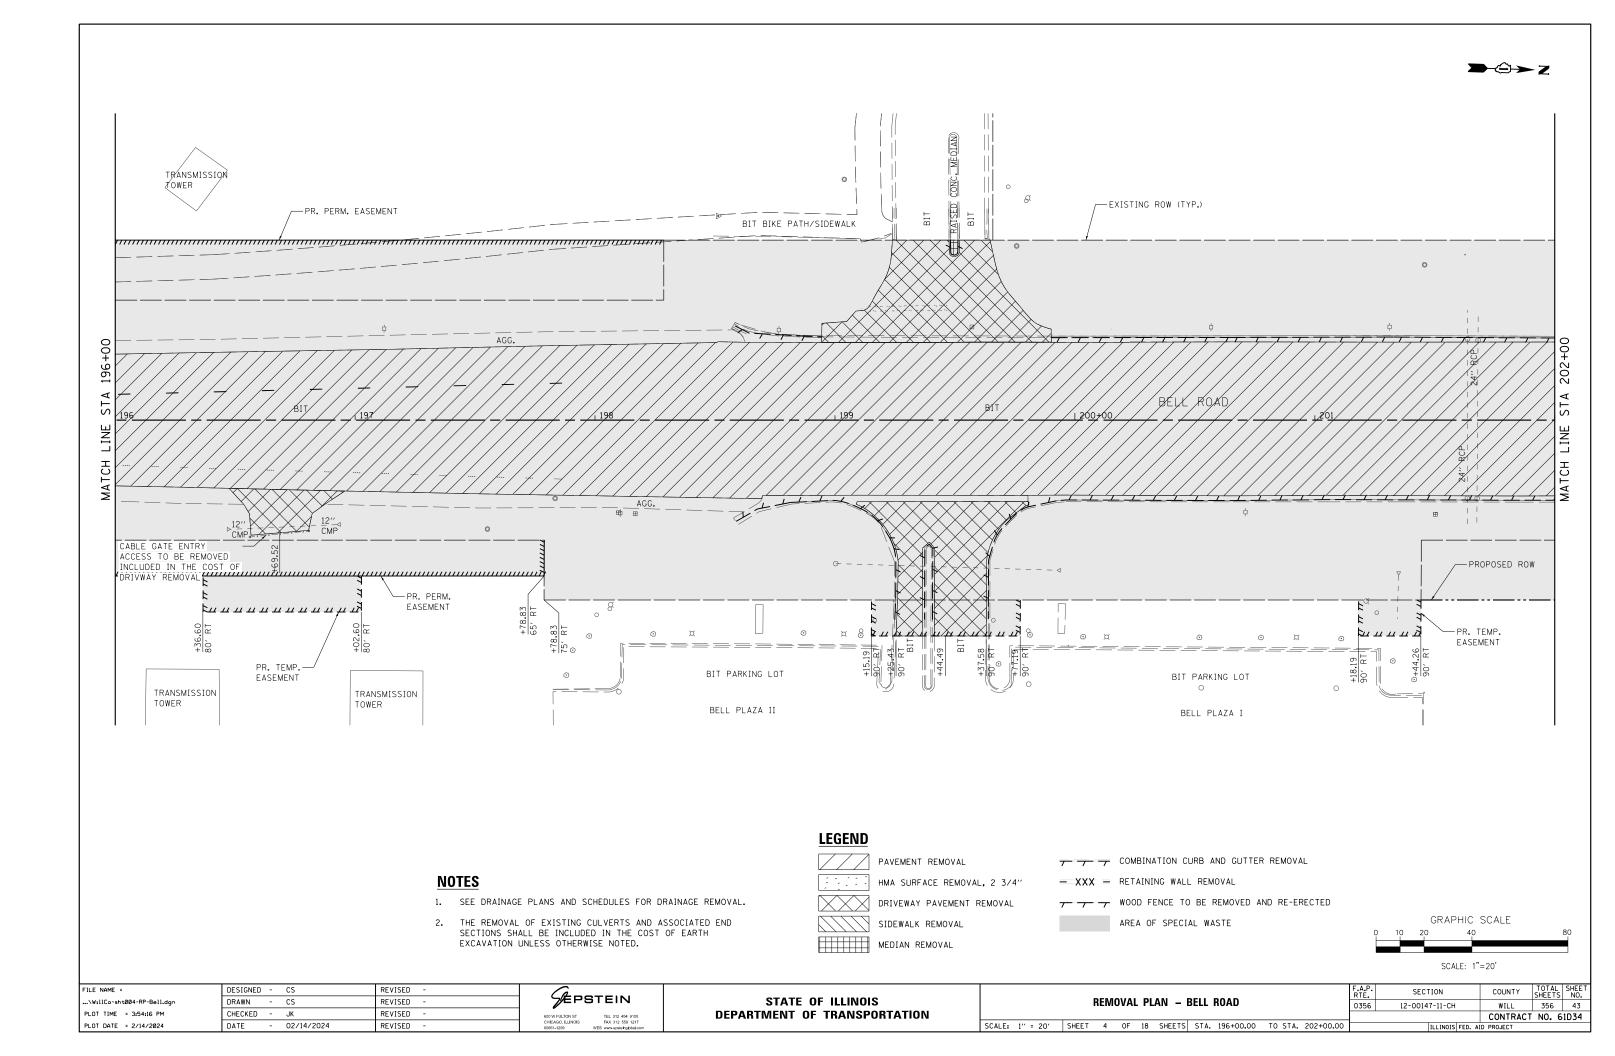


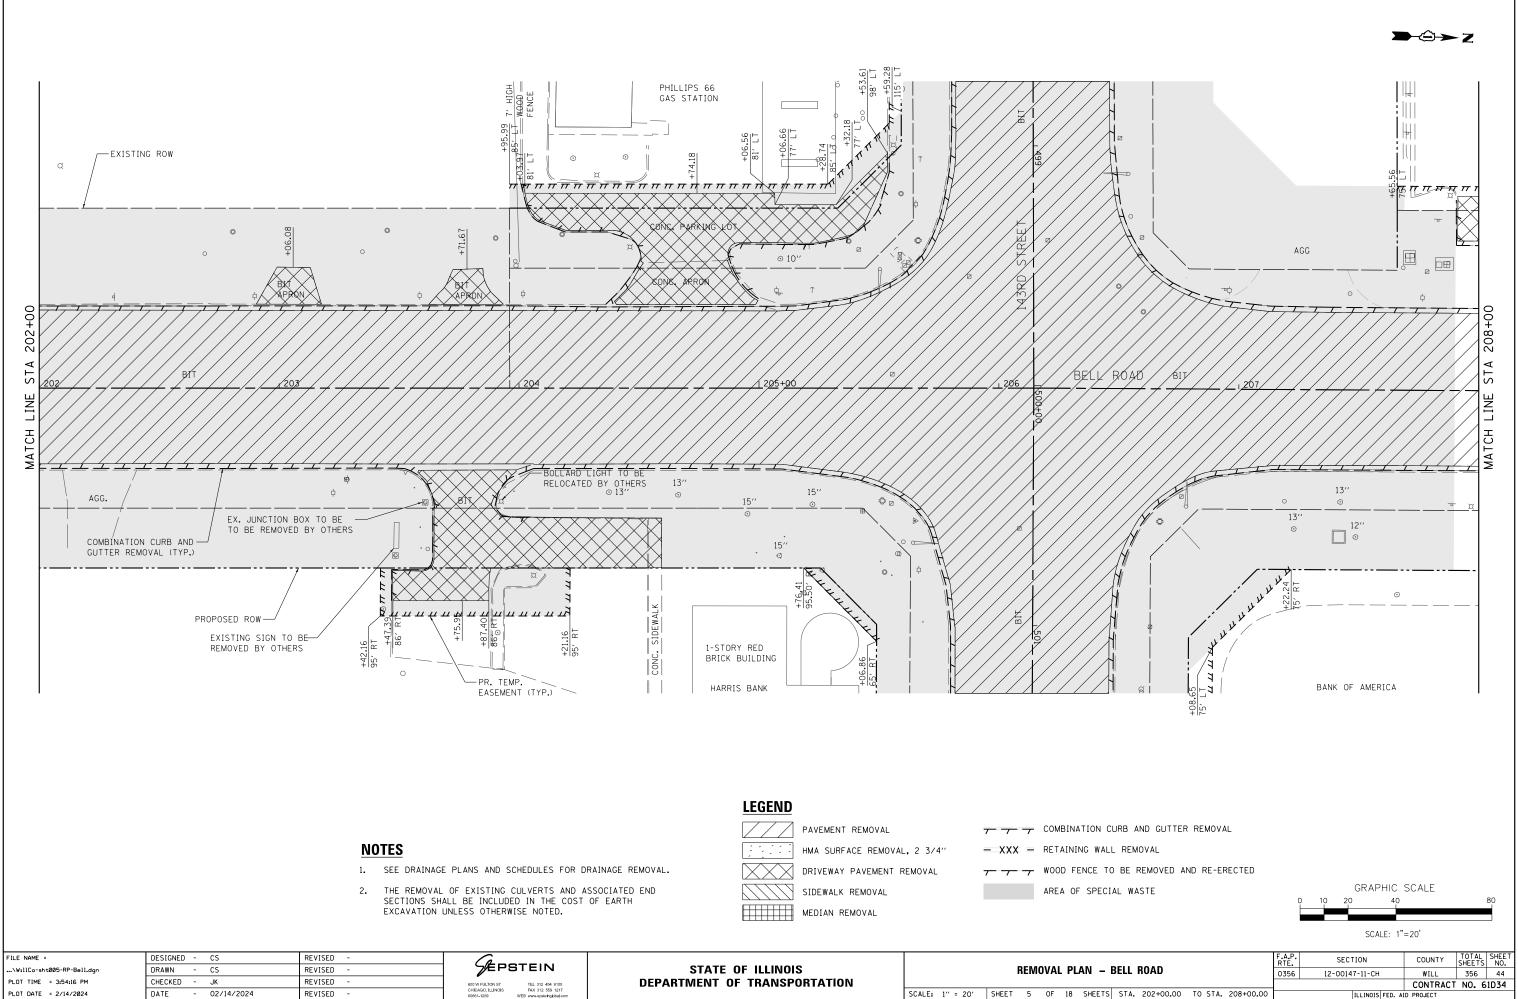


ILLINOIS FED. AID PROJECT

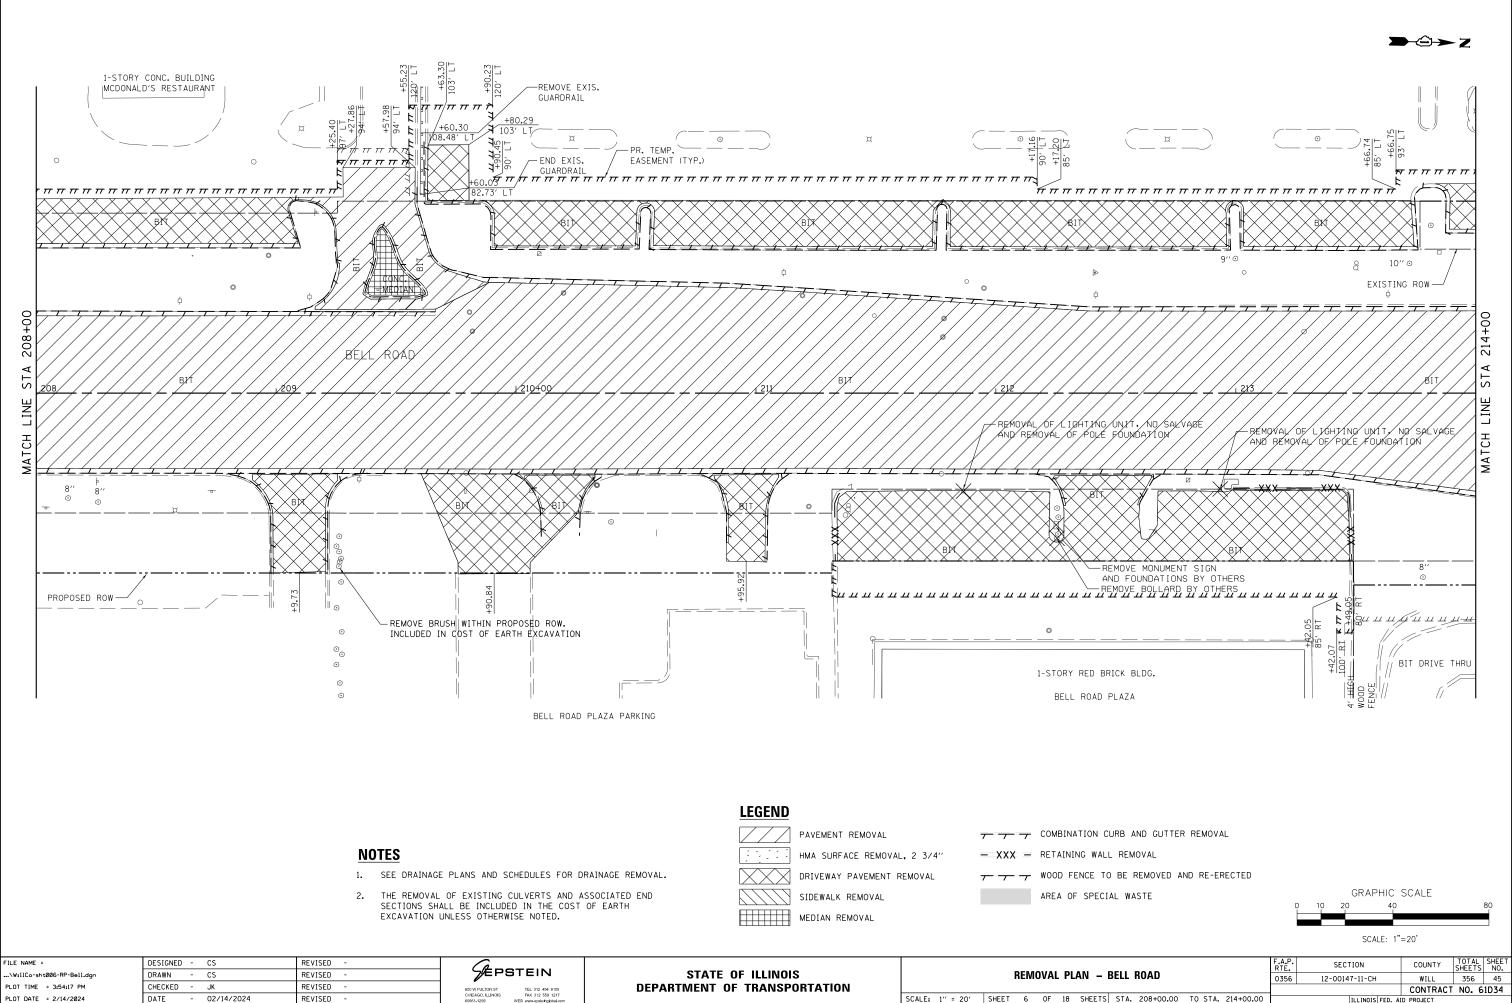

SCALE: 1" = 20' SHEET 6 OF 18 SHEETS STA. 208+00.00 TO STA. 214+00.00 ILLINOIS FED. AID PROJECT

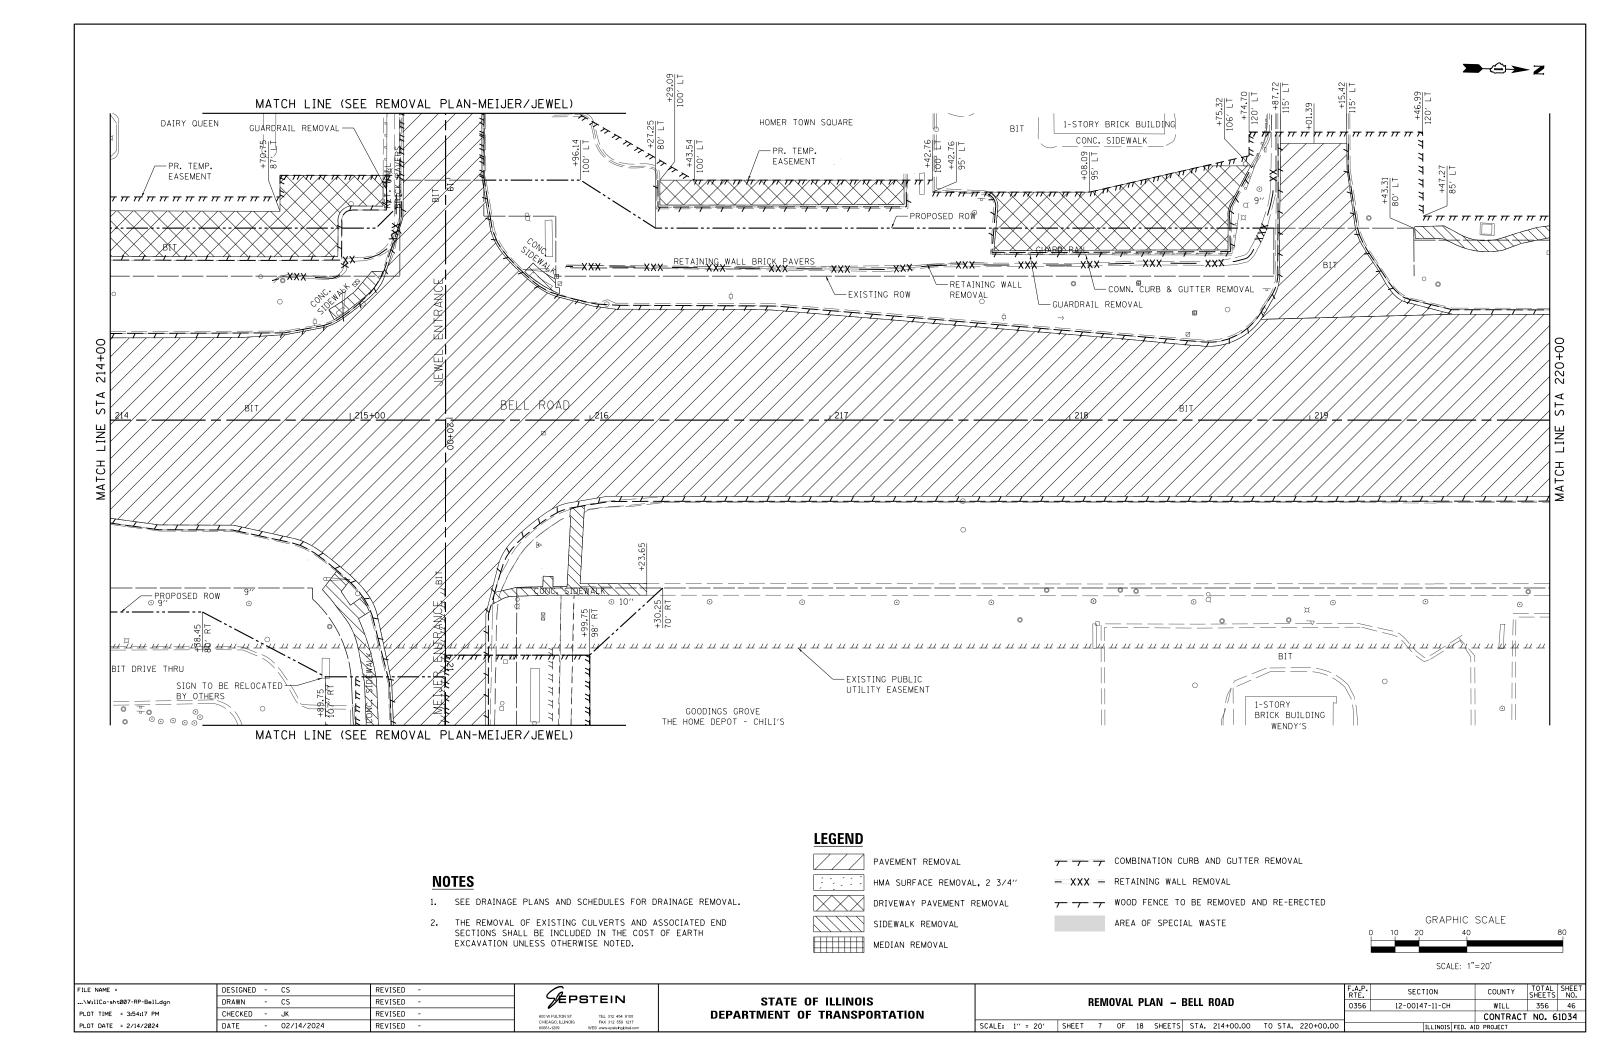


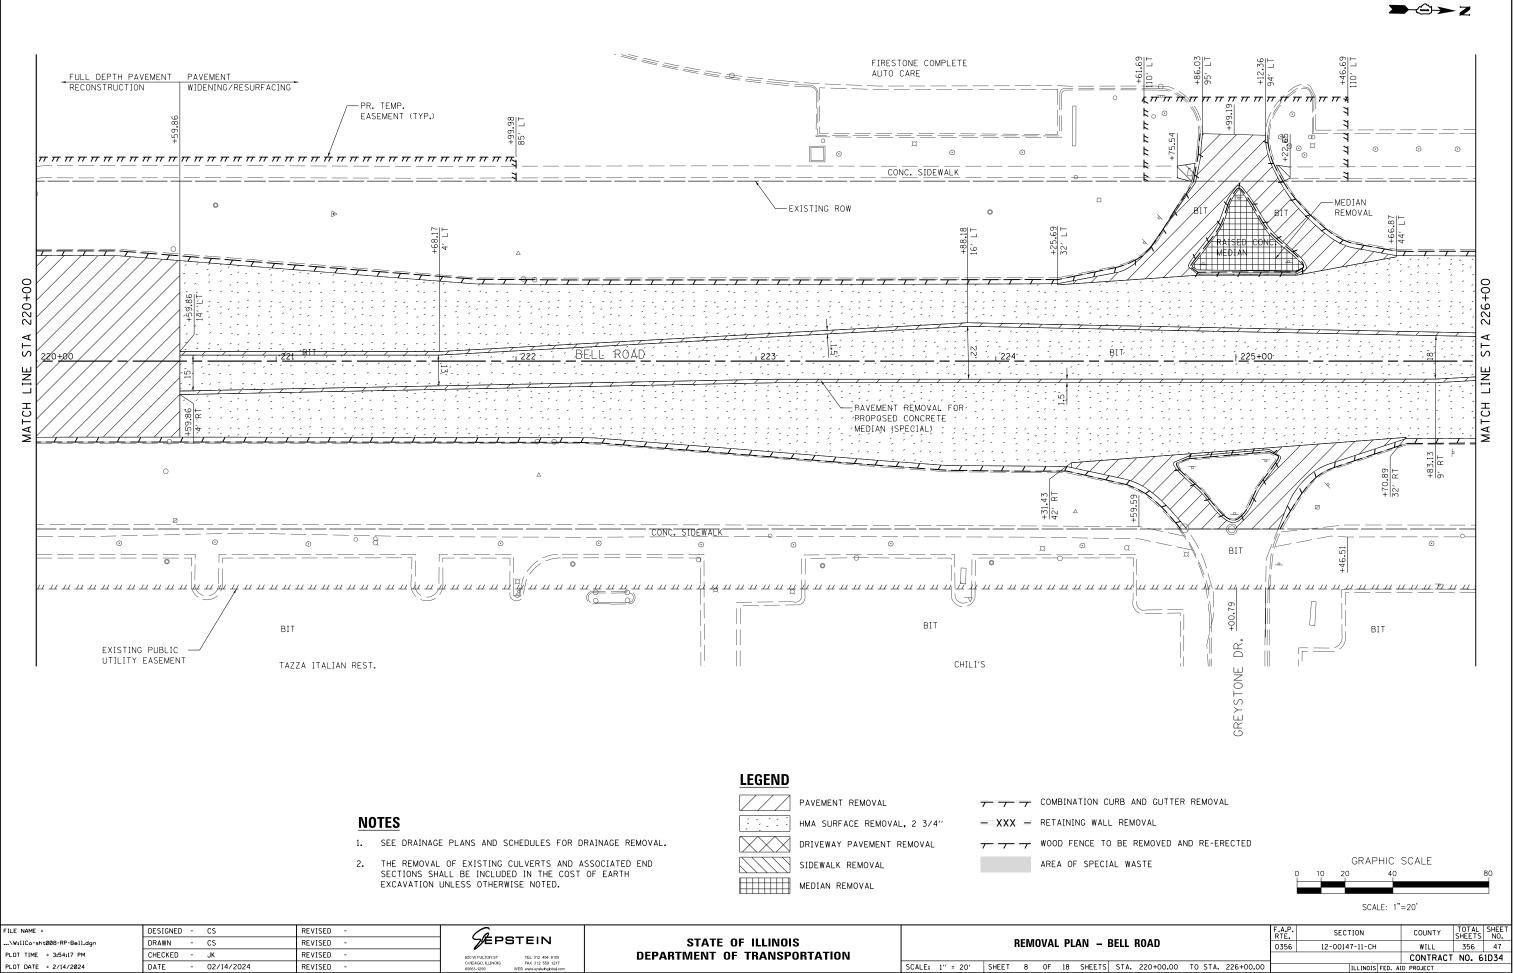



DATE


REVISED


					0356	12-0014	(-11-CH		WILL	356		4
									CONTRACT	NO.	61	iD3
ETS	STA.	220+00.00	TO STA.	226+00.00			ILLINOIS	FED. A	ID PROJECT			

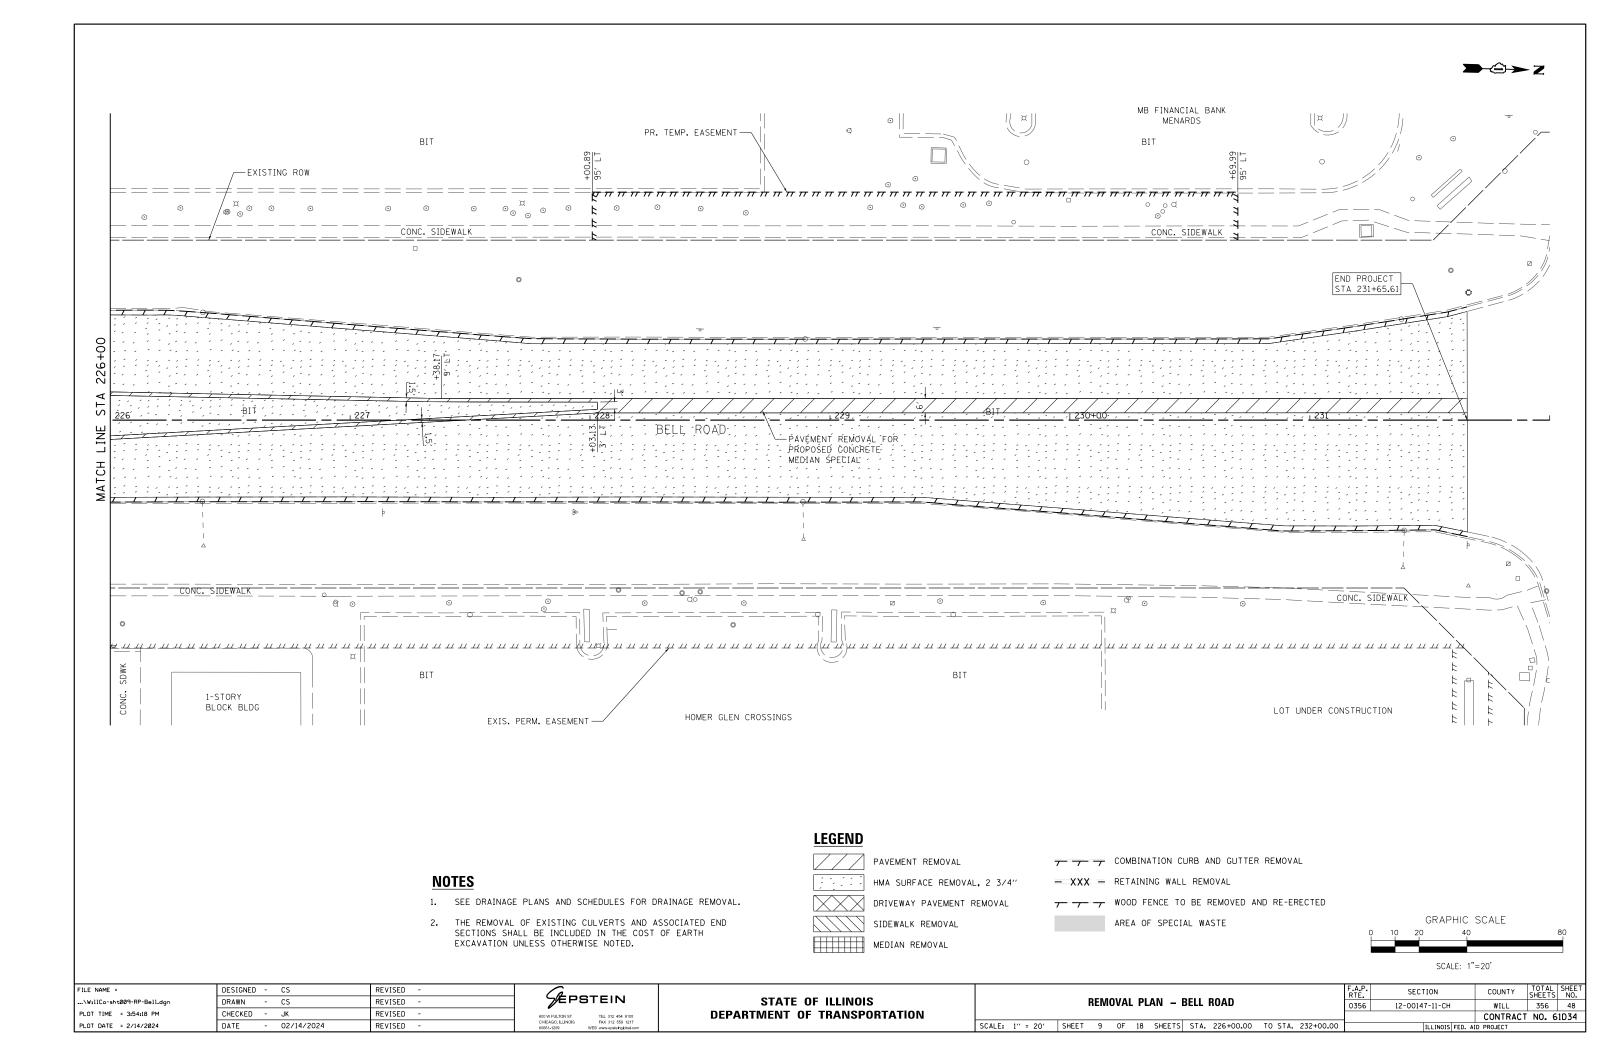


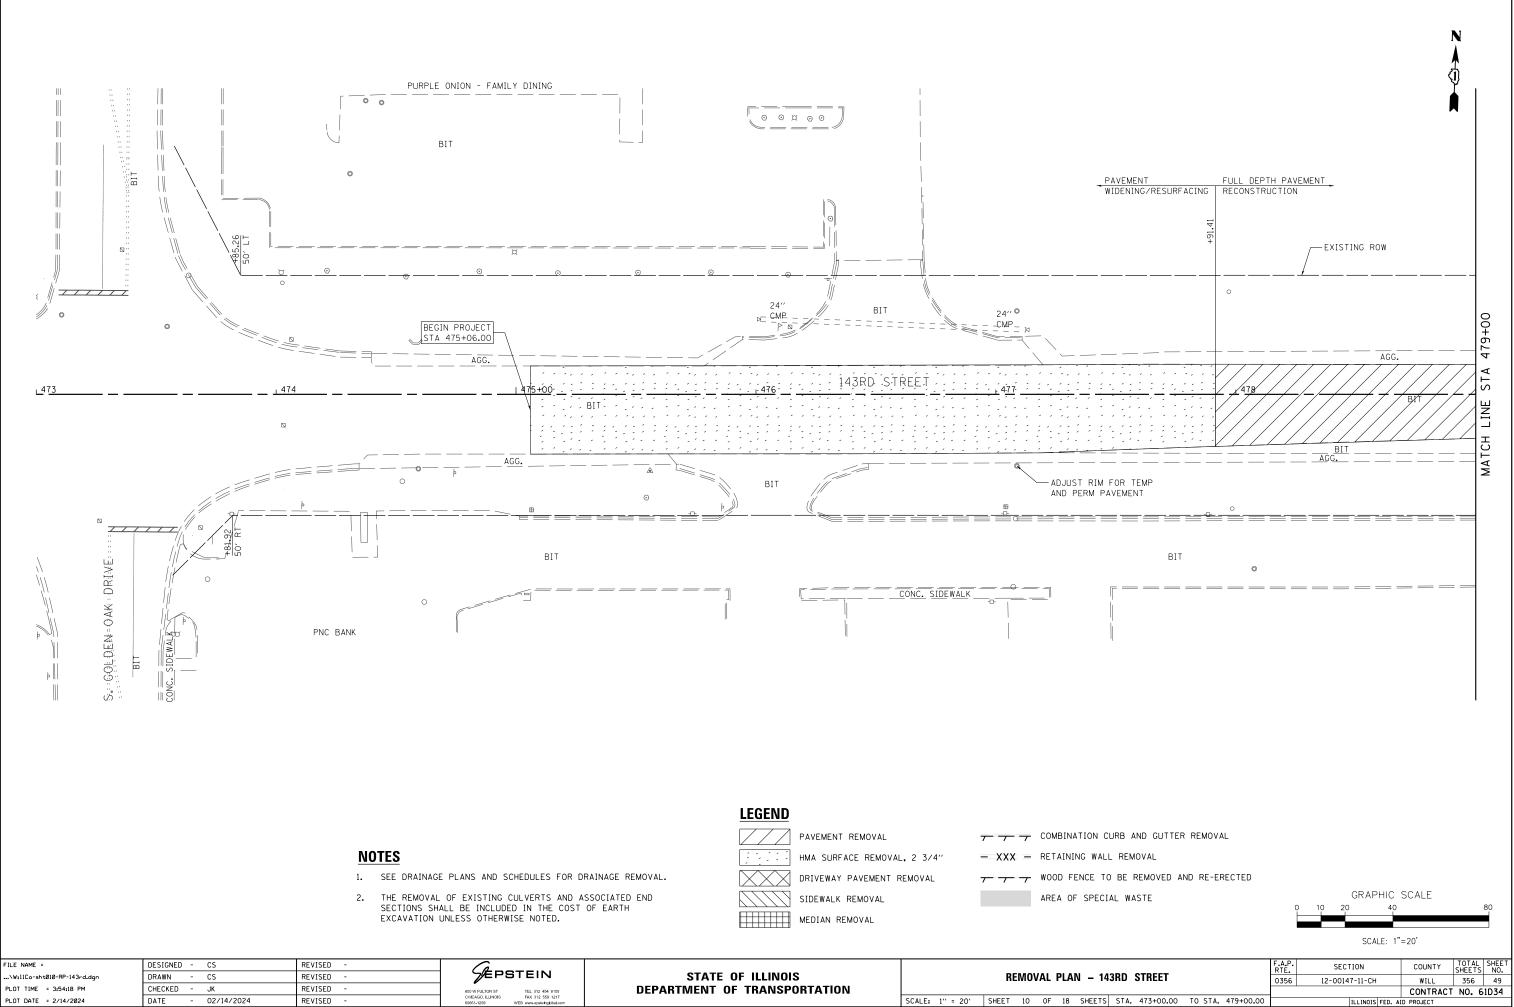


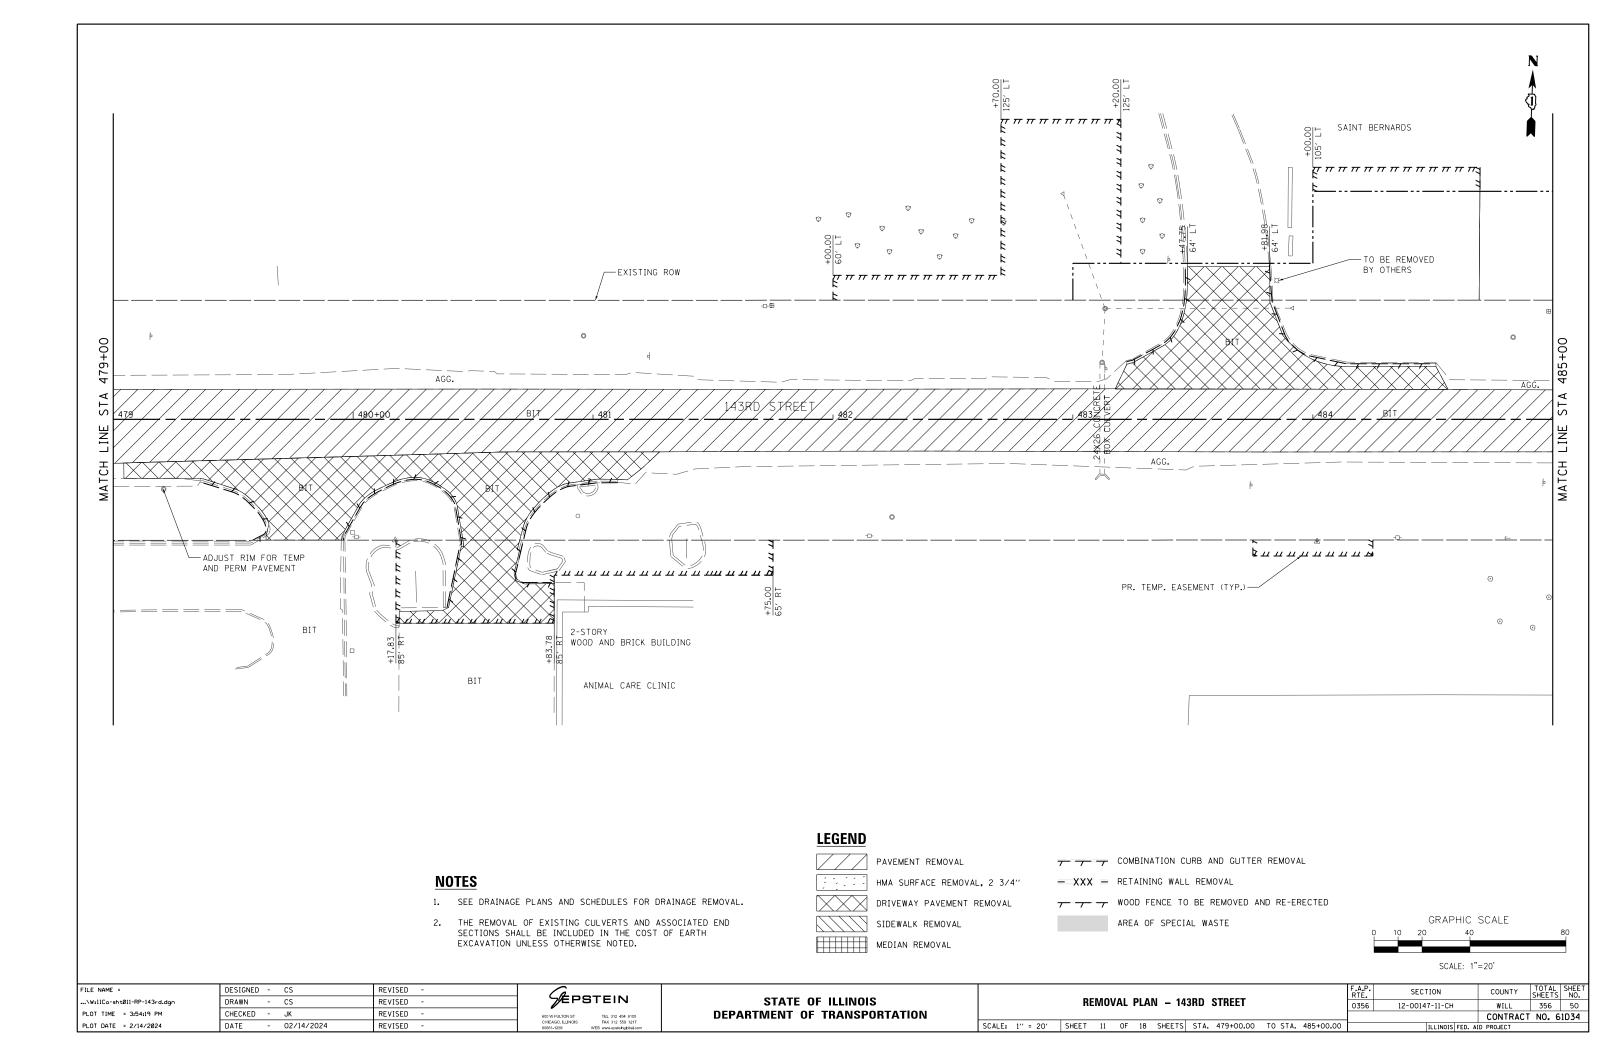

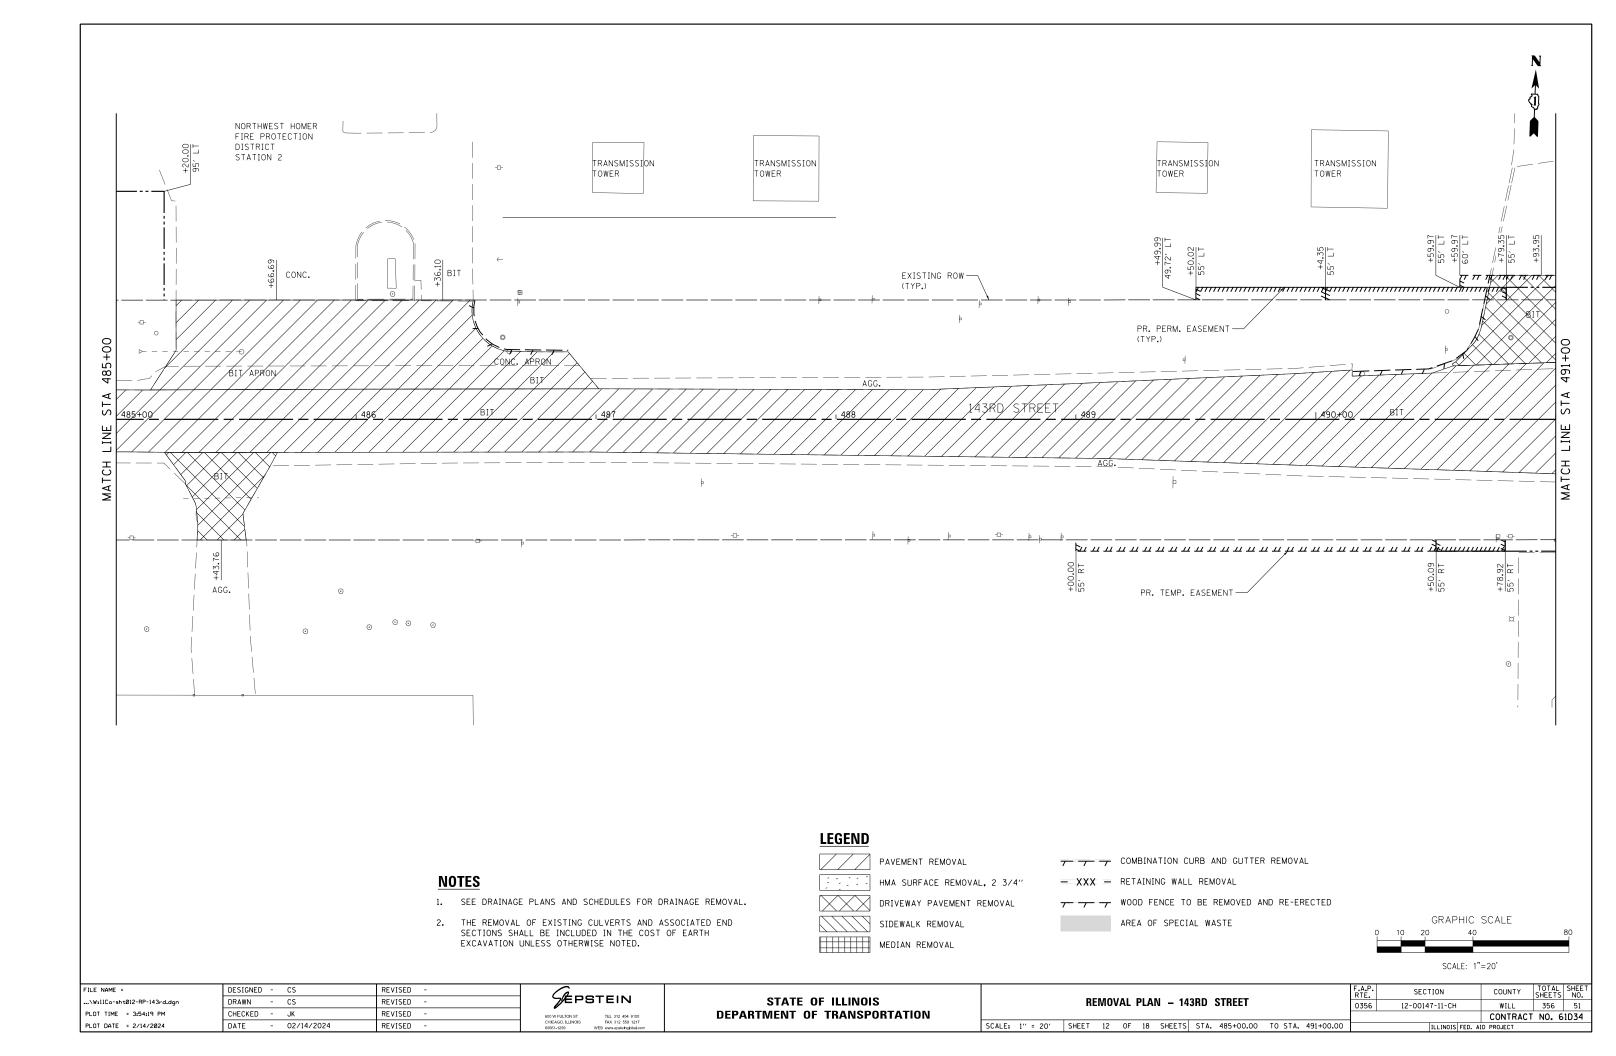

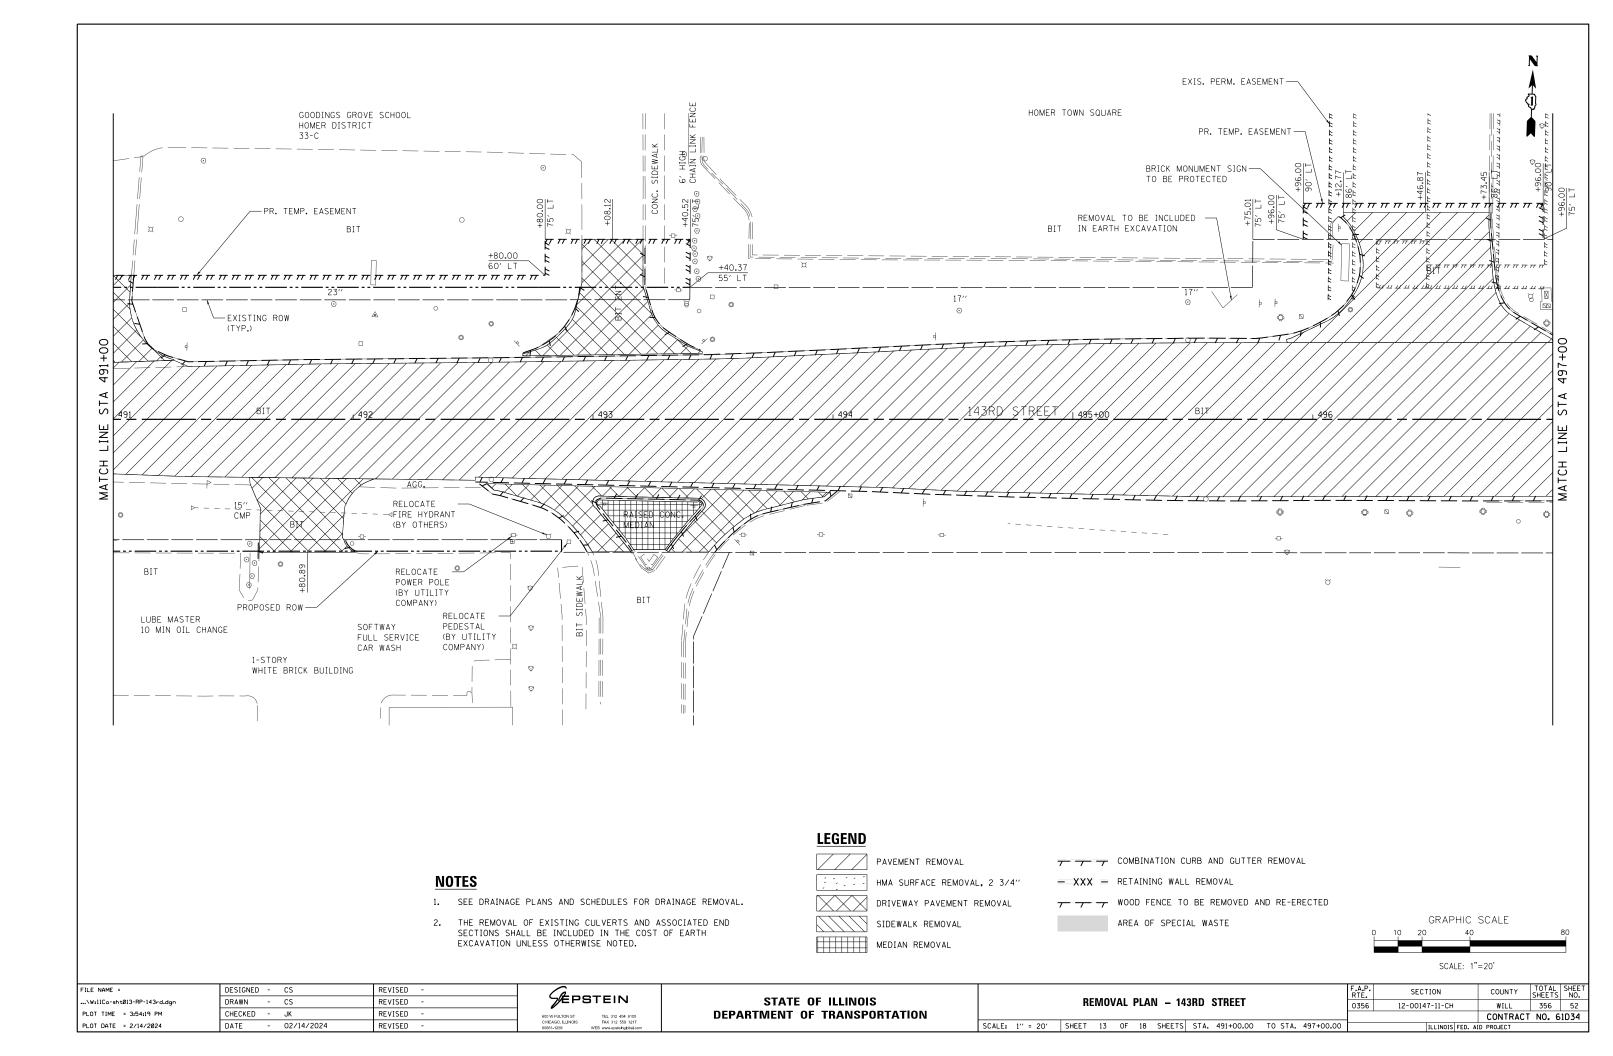


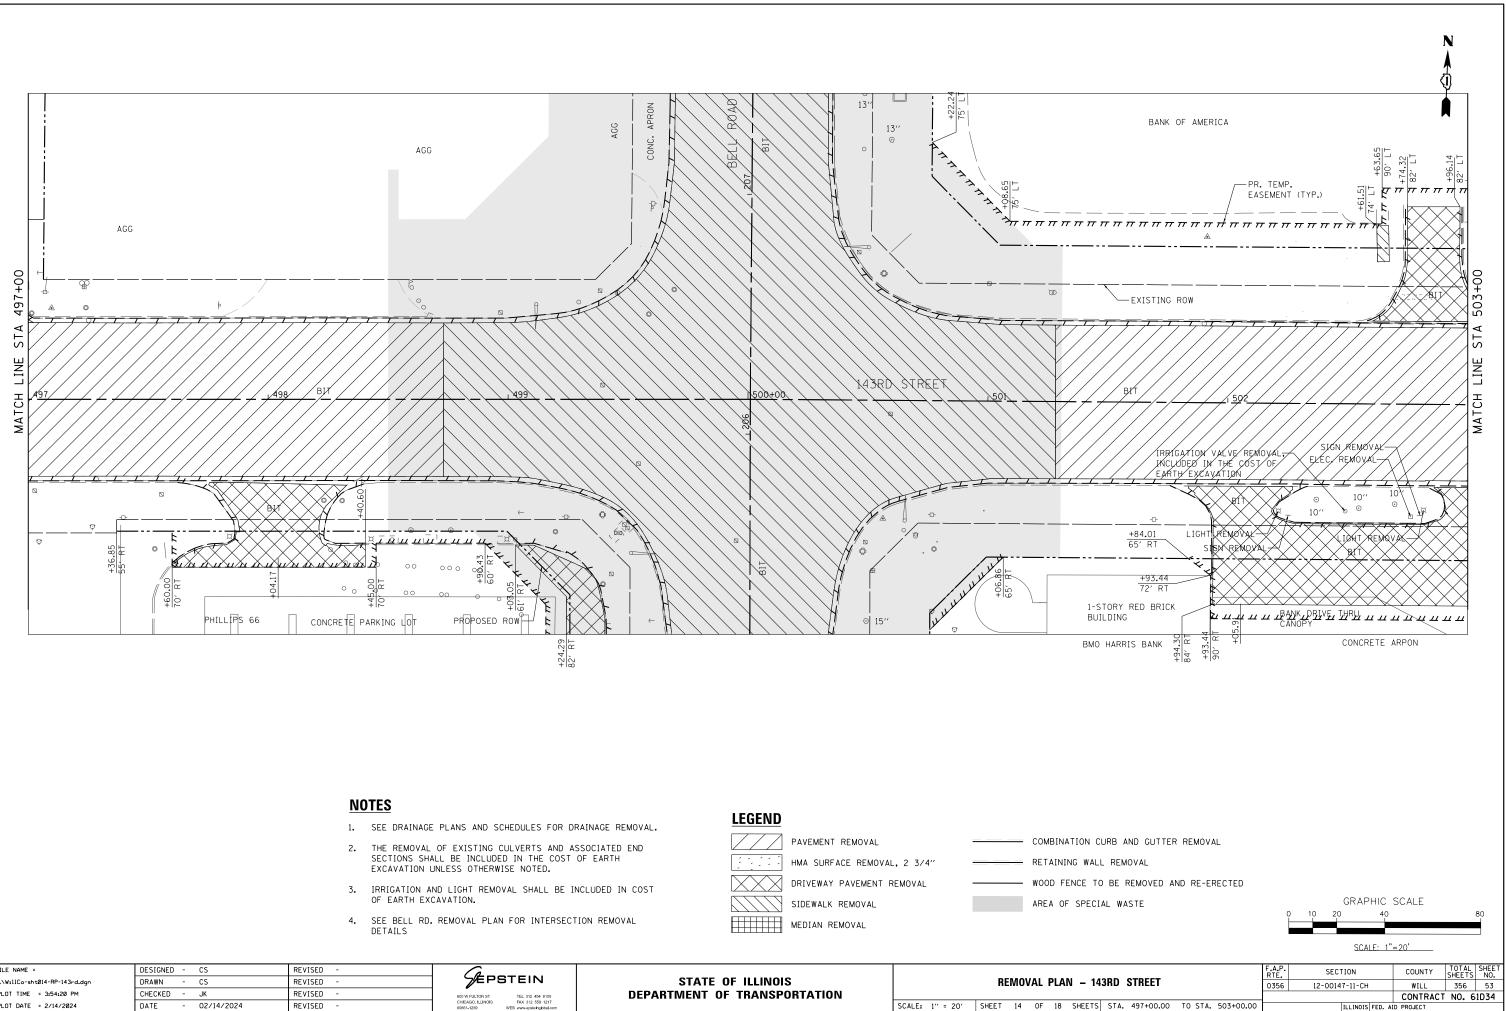

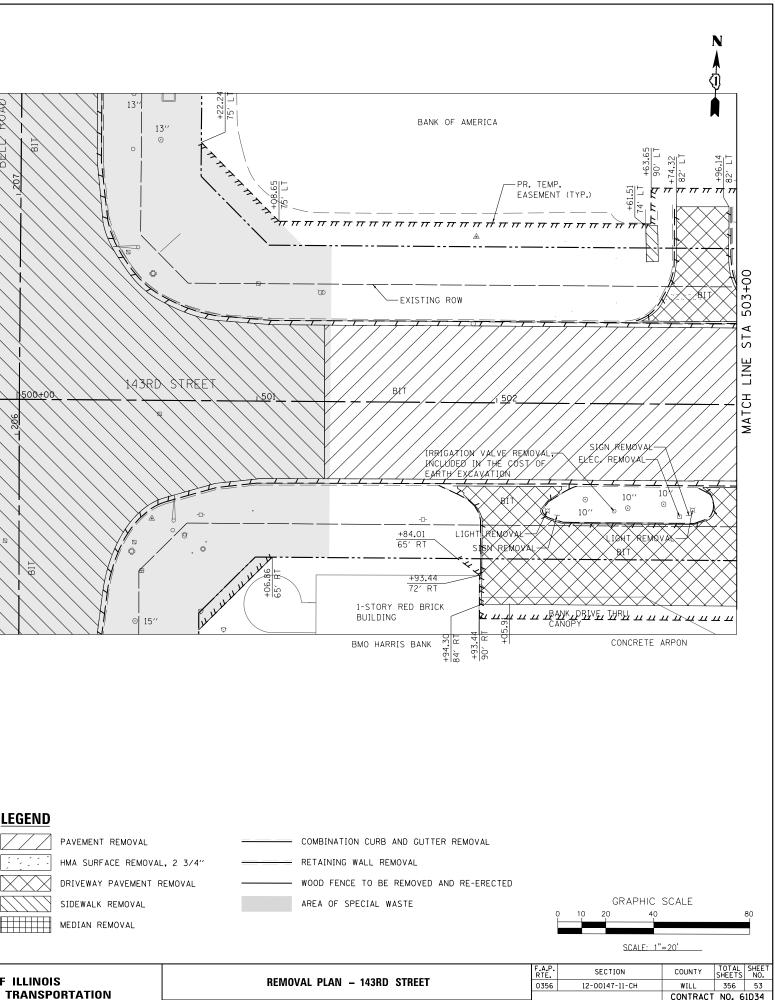



ILLINOIS FED. AID PROJECT

FILE NAME =	DESIGNED - CS	REVISED -			
\WillCo-sht014-RP-143rd	Ldgn DRAWN - CS	REVISED -		STATE OF ILLINOIS	REMOVAL PLAN – 14
PLOT TIME = 3:54:20 PM	CHECKED - JK	REVISED -	600 W FULTON ST TEL 312 454 9100	DEPARTMENT OF TRANSPORTATION	
PLOT DATE = 2/14/2024	DATE - 02/14/2024	REVISED -	CHICAGO, ILLINOIS FAX 312 559 1217 60661-1259 WEB www.epsteinglobel.com		SCALE: 1" = 20' SHEET 14 OF 18 SHEETS

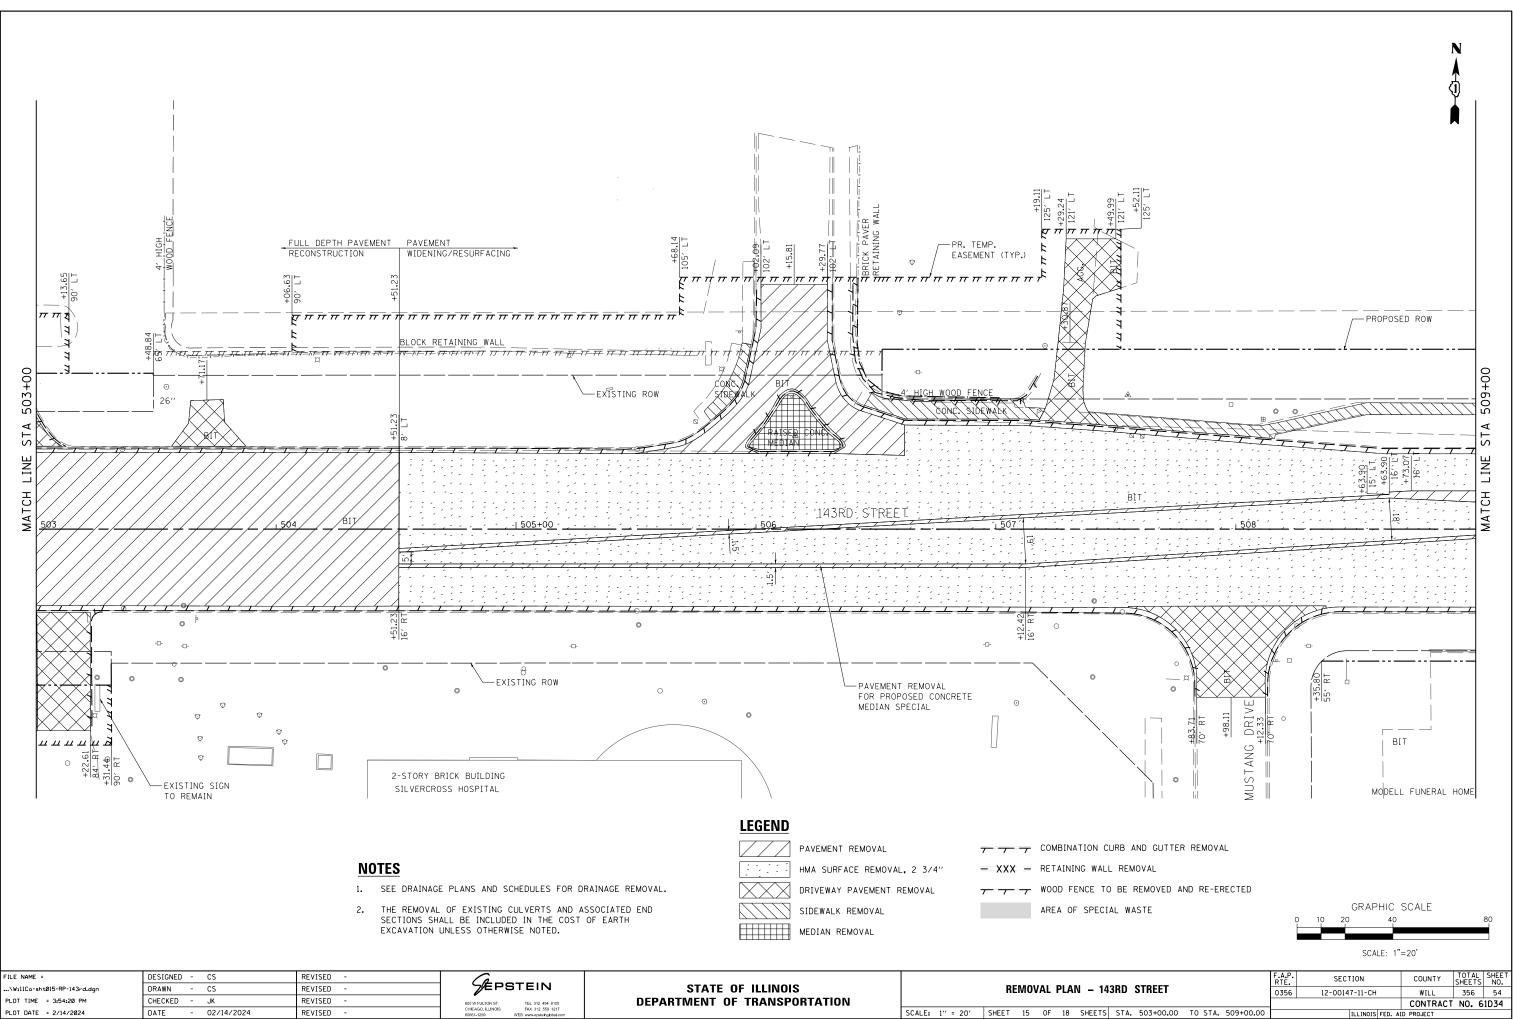

SCALE: 1" = 20' SHEET 15 OF 18 SHEETS STA. 503+00.00 TO STA. 509+00.00 ILLINOIS FED. AID PROJECT

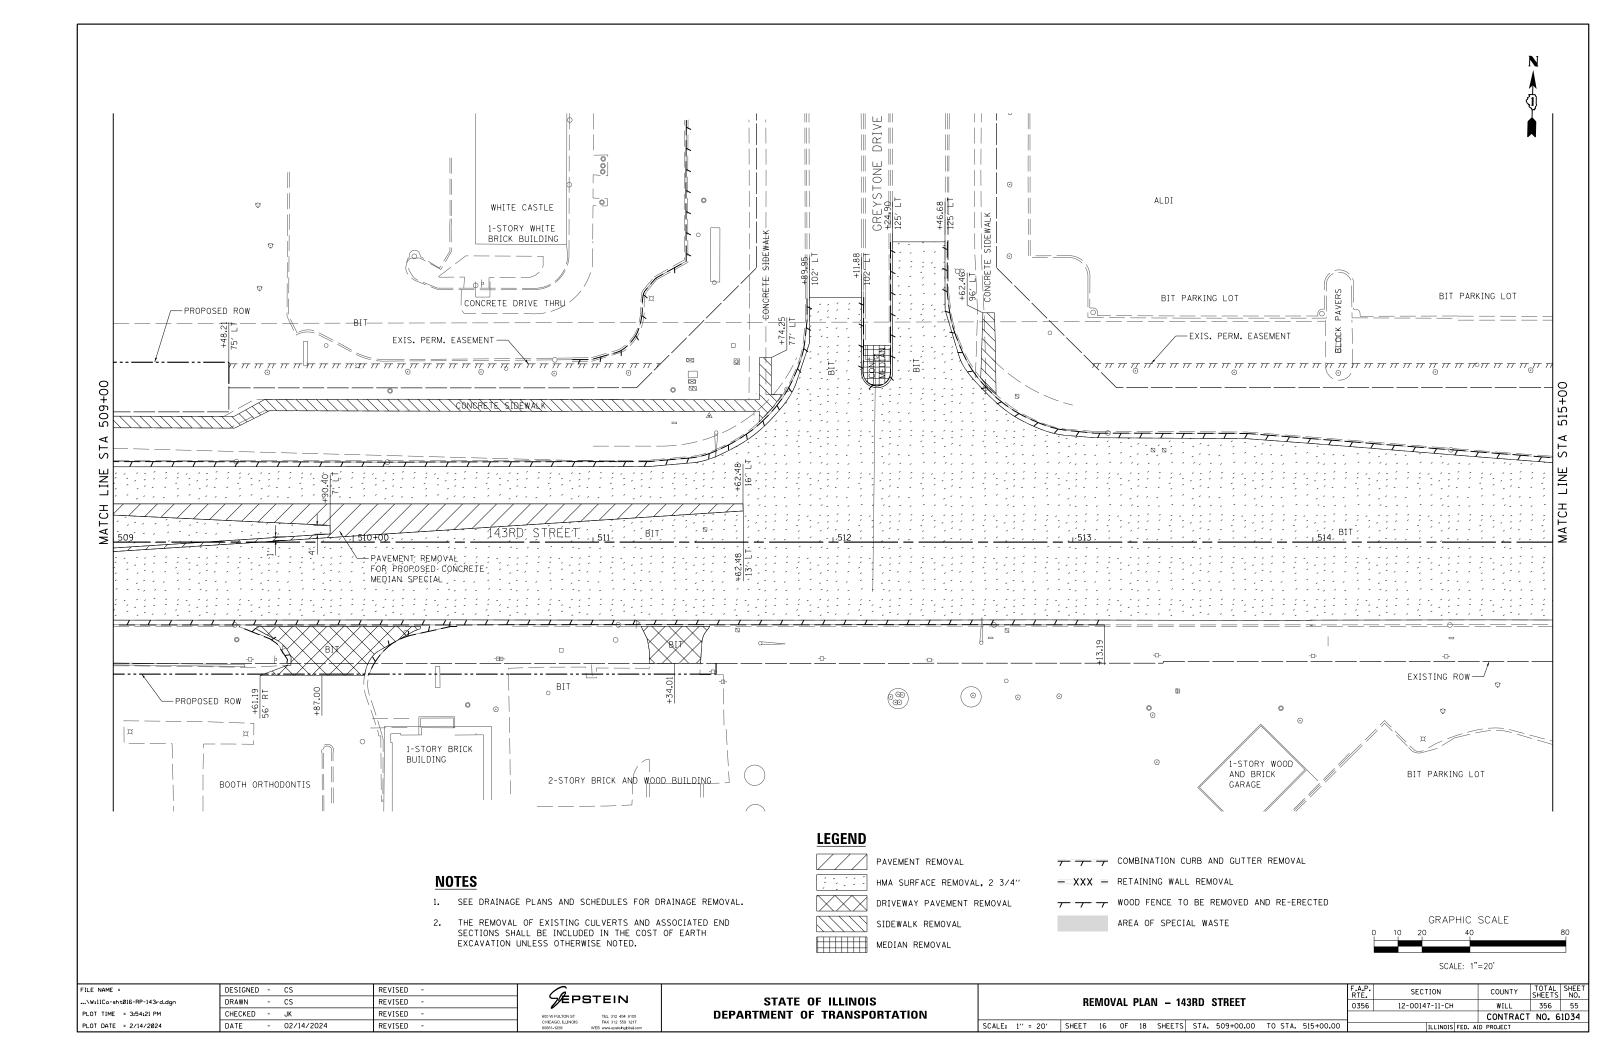


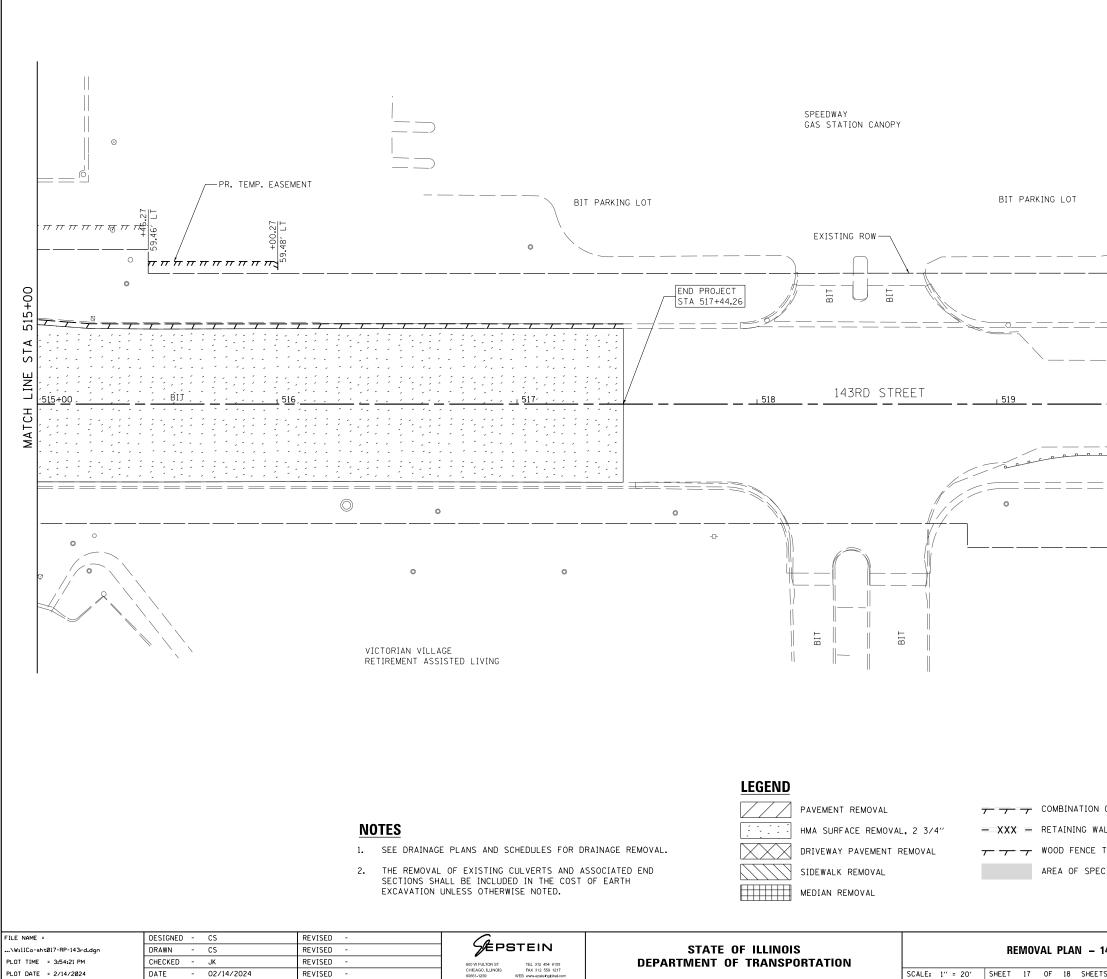


PLOT DATE = 2/14/2024


REVISED


								ا ر ح		
								ORY BRICK DING		
	BIT PARI	KING LOT			-0-					
			AGG		⊧ 		·		<u> </u>	
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	0	<u></u>	AGG						 	
<b>,</b> 2 3/4"	- xxx -	RETAINING WALL	JRB AND GUTTER . REMOVAL BE REMOVED AN							
		AREA OF SPECI	AL WASTE		0	GR /	APHIC 40	SCALE		80
					F.A.P		CALE: 1":		ΤΟΤΔΙ	
SCALE: 1'' = 20'	REMO	OF 18 SHEETS		T0 STA. 521+00.00	F.A.P. RTE. 0356	SECTION 12-00147-11-	CH DIS FED. AI	WILL CONTRACT	356	56
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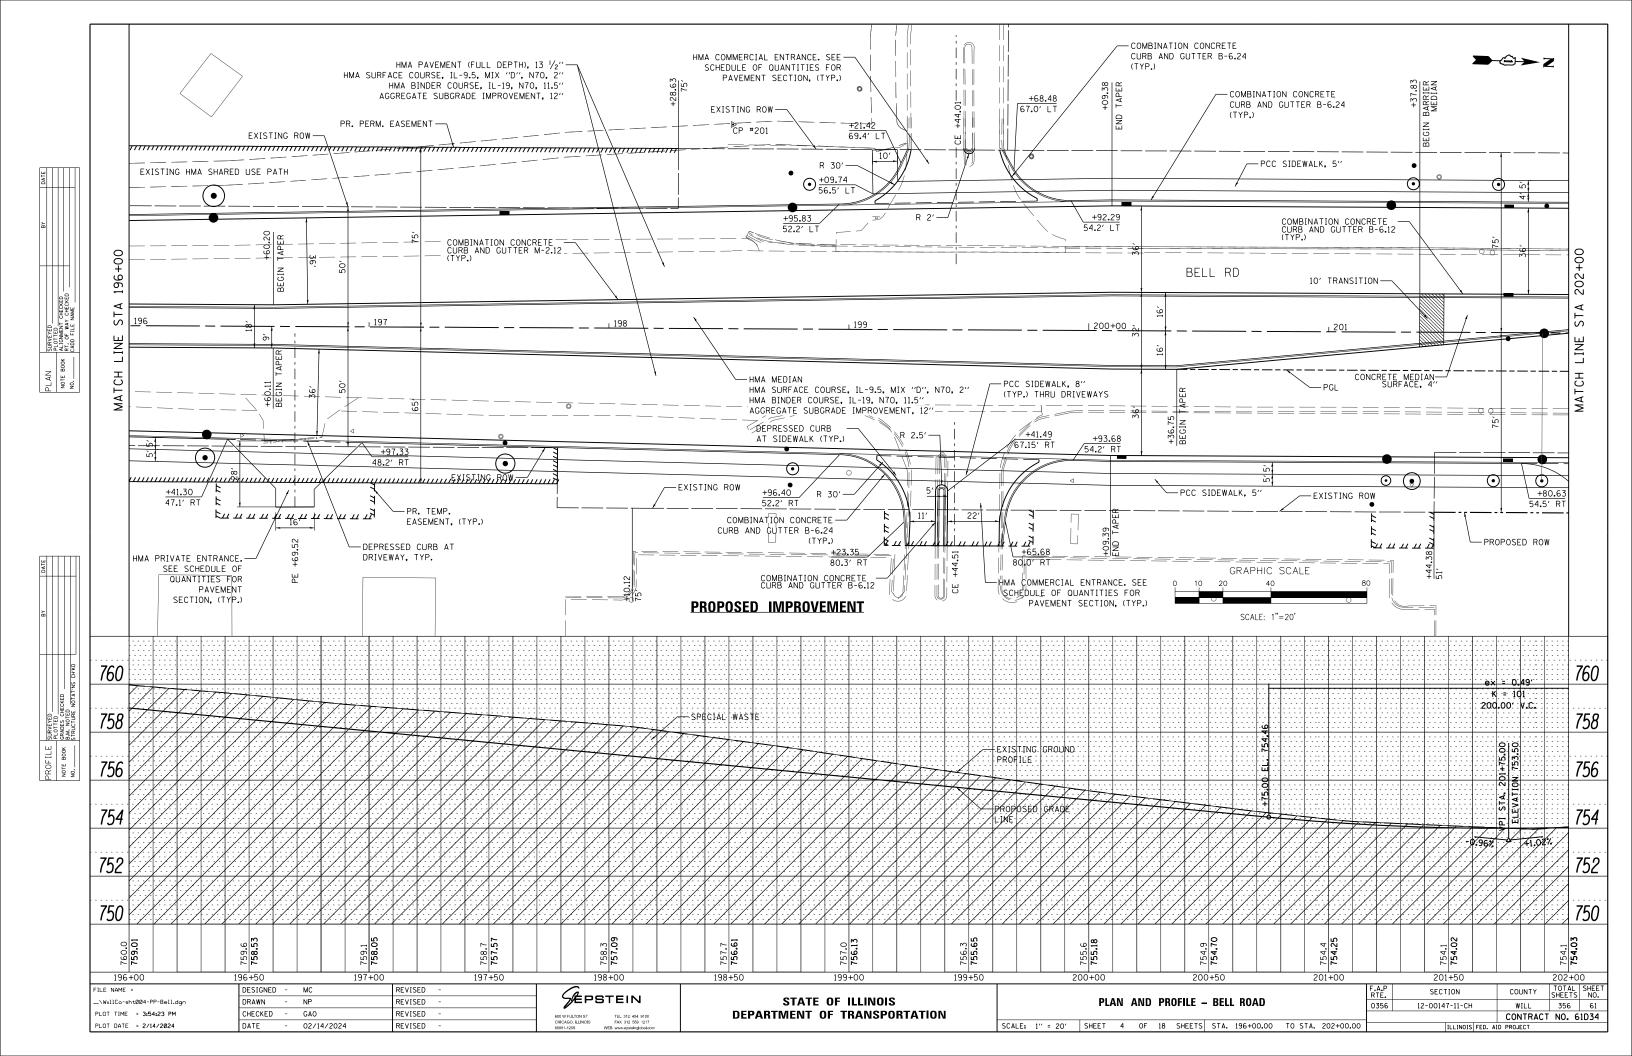


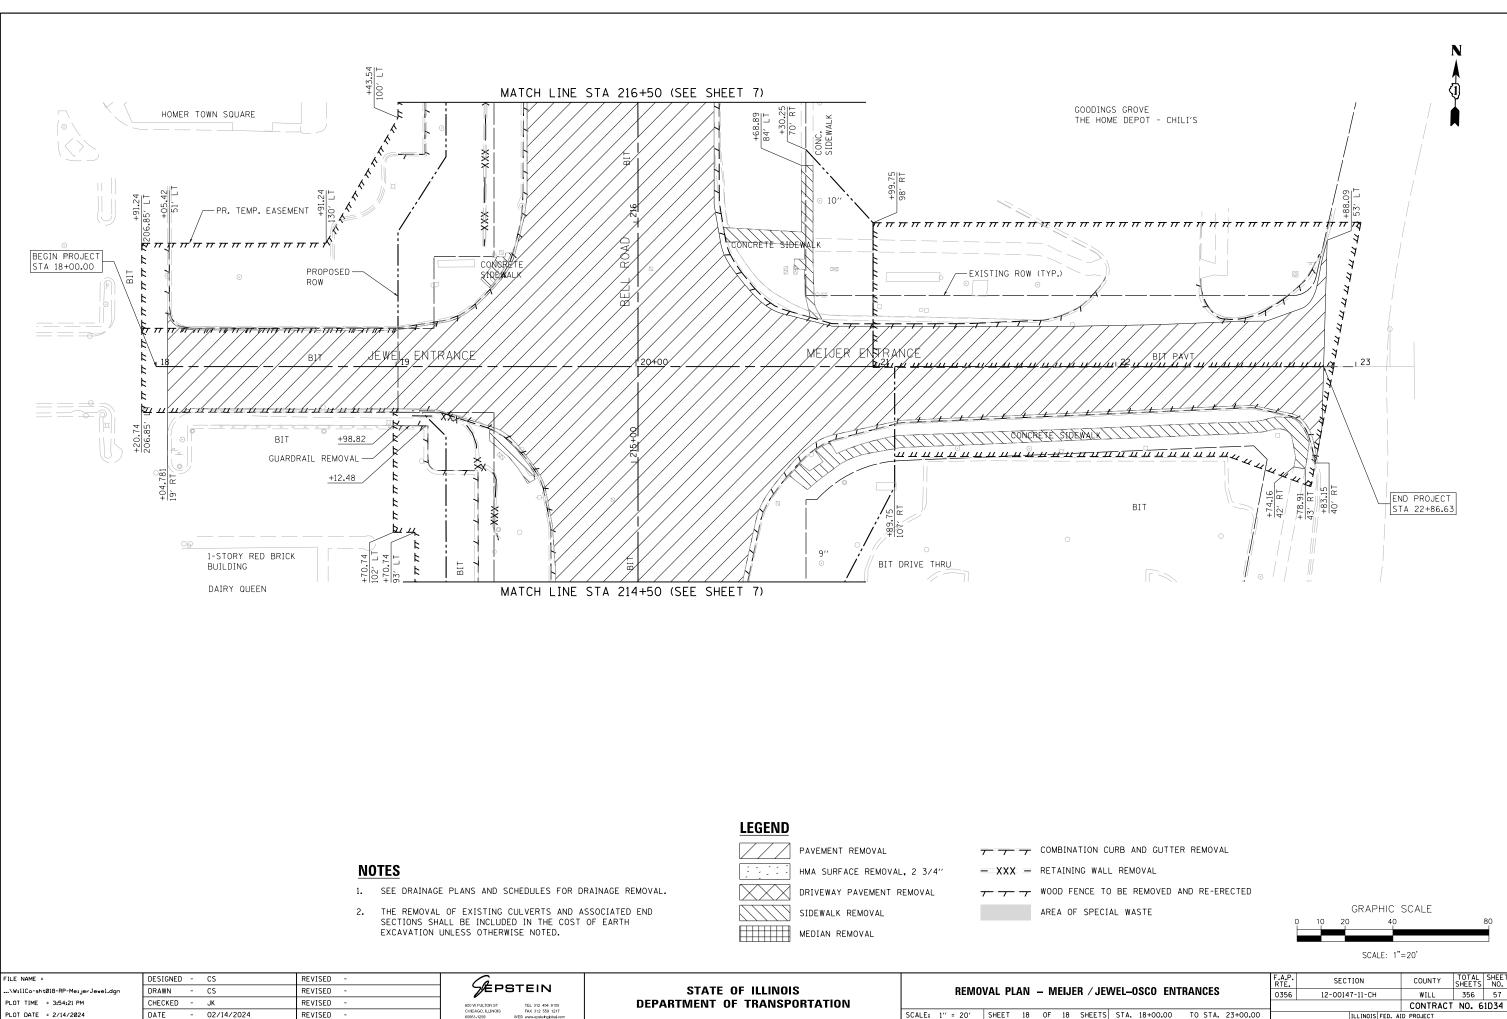
SCALE: 1" = 20' SHEET 18 OF 18 SHEETS STA. 18+00.00 TO STA. 23+00.00 ILLINOIS FED. AID PROJECT




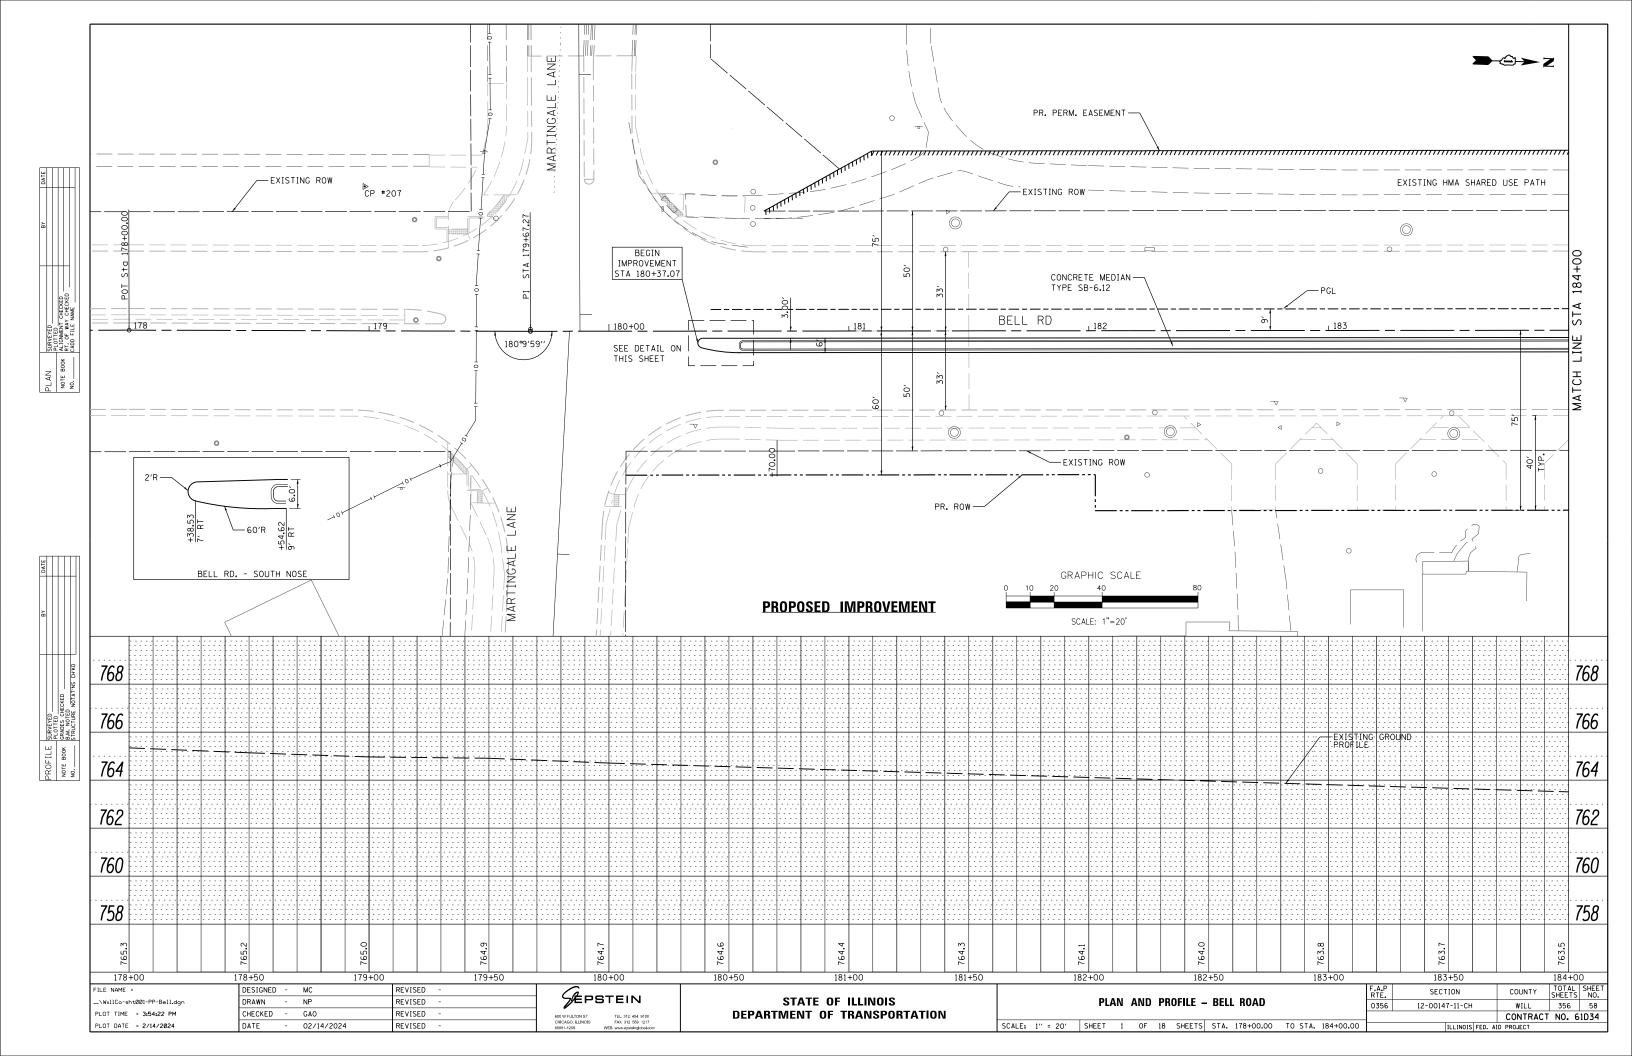


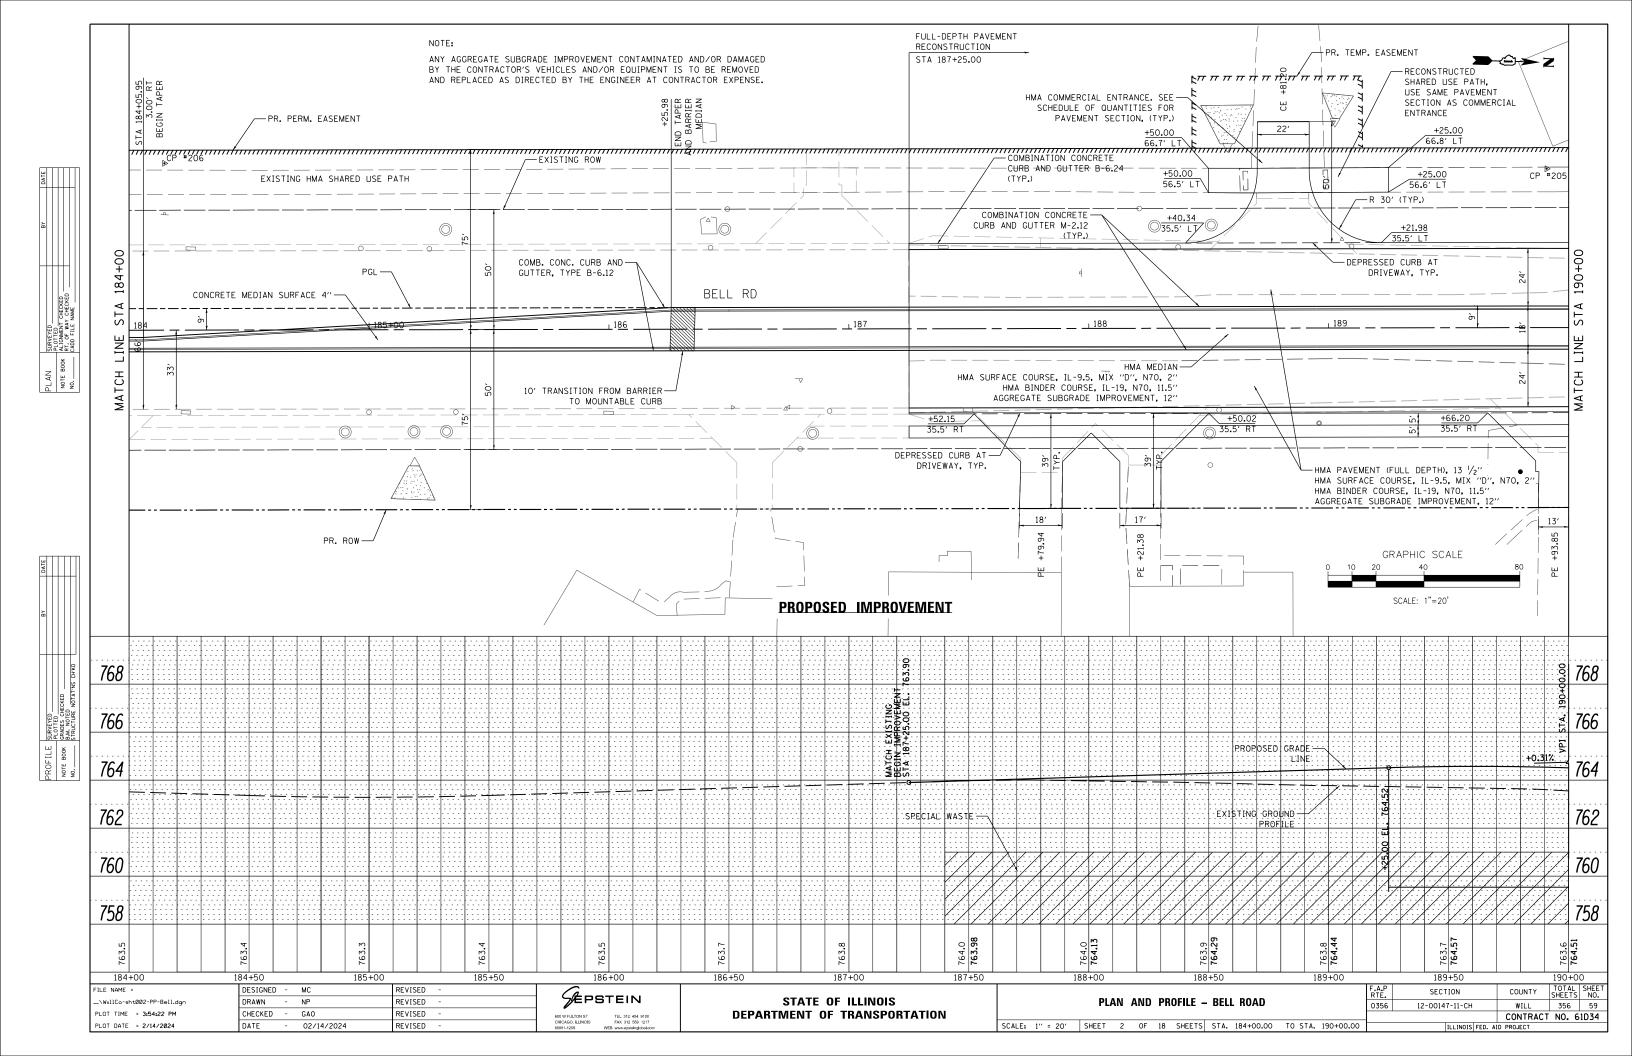


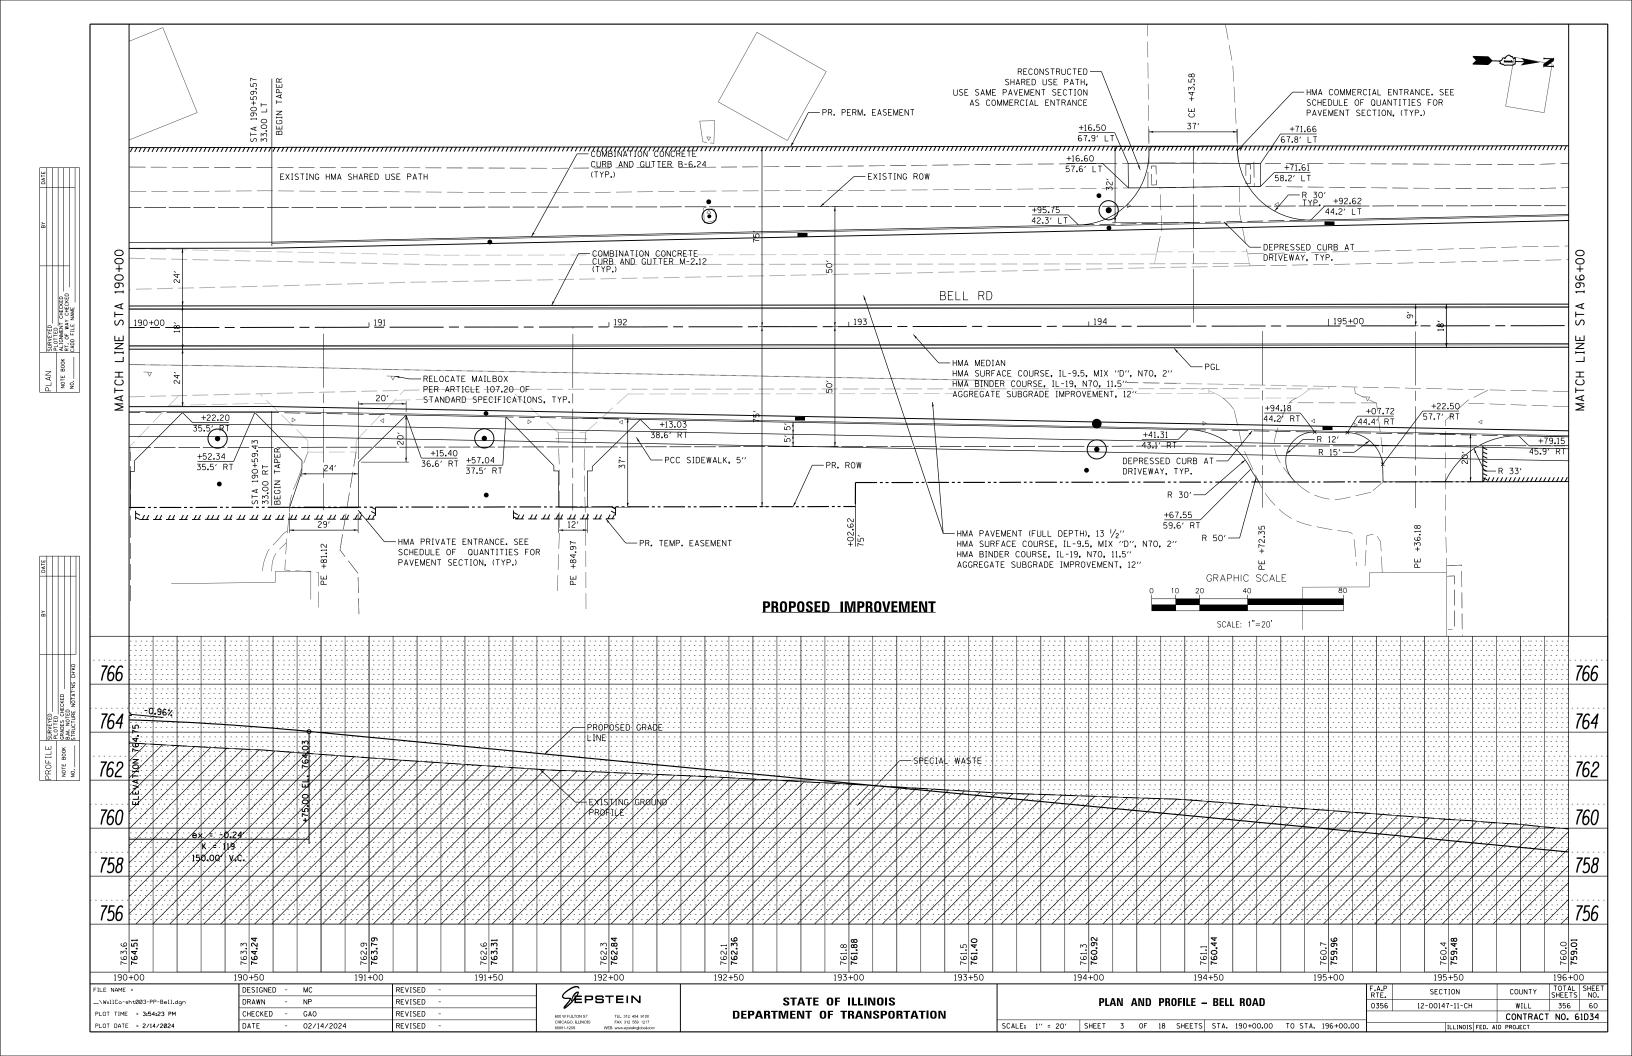


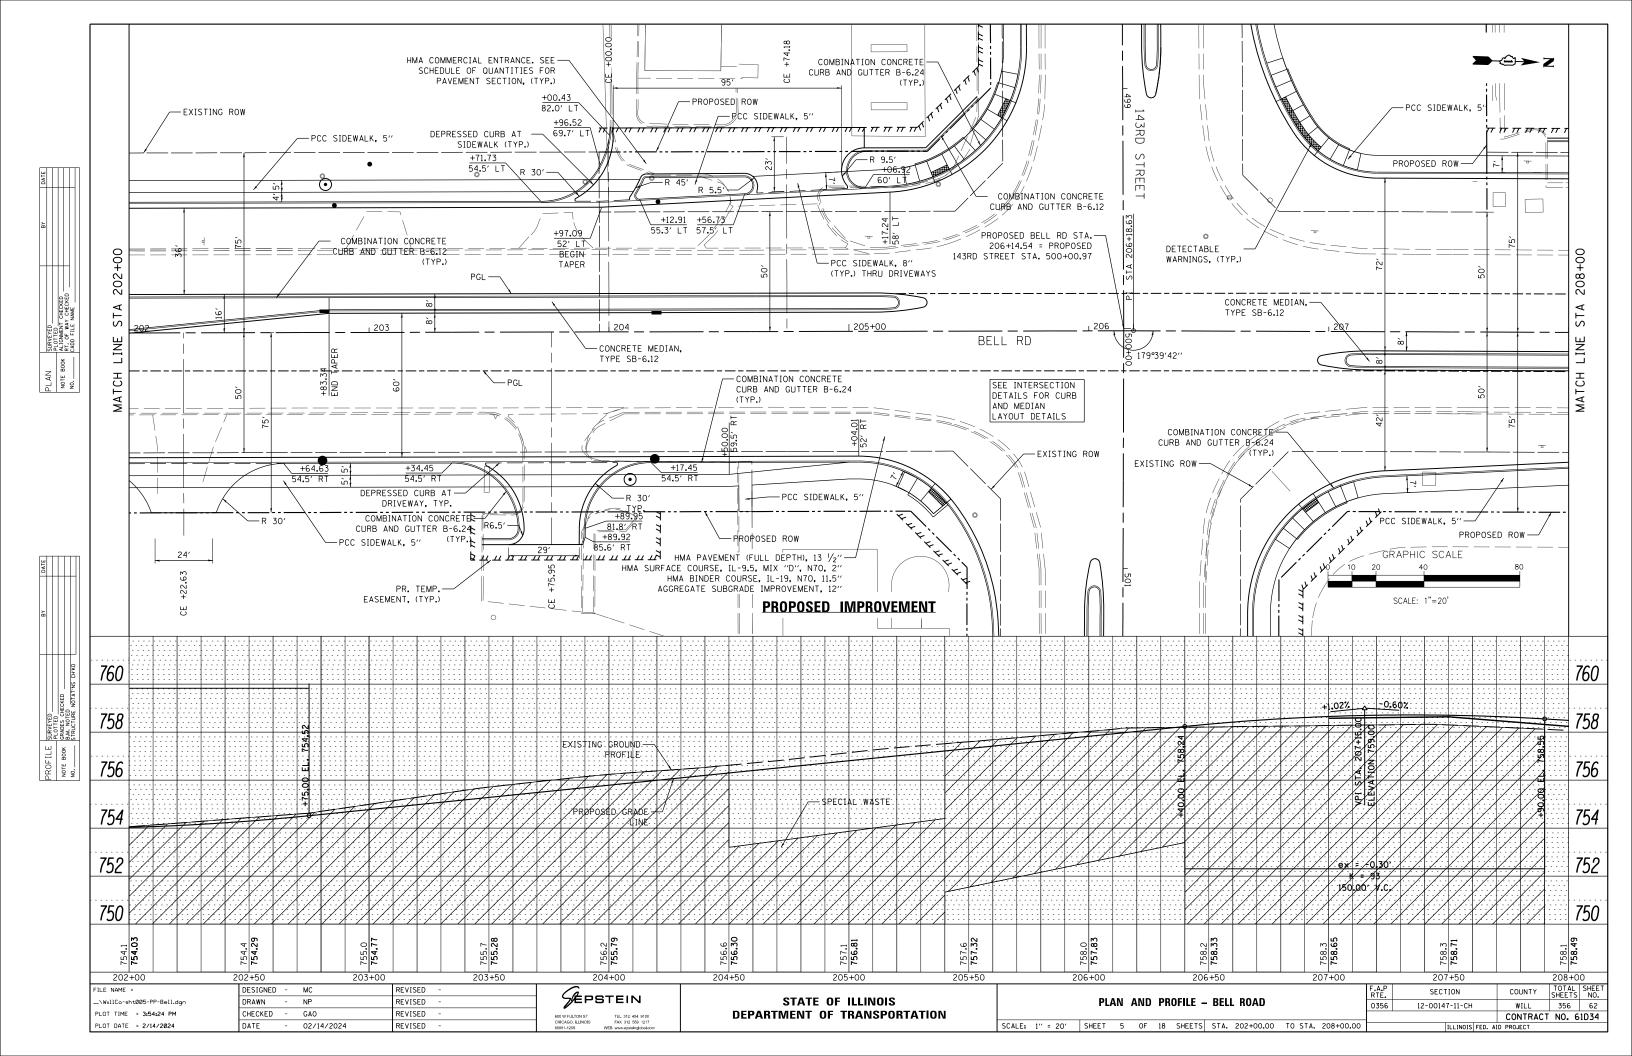


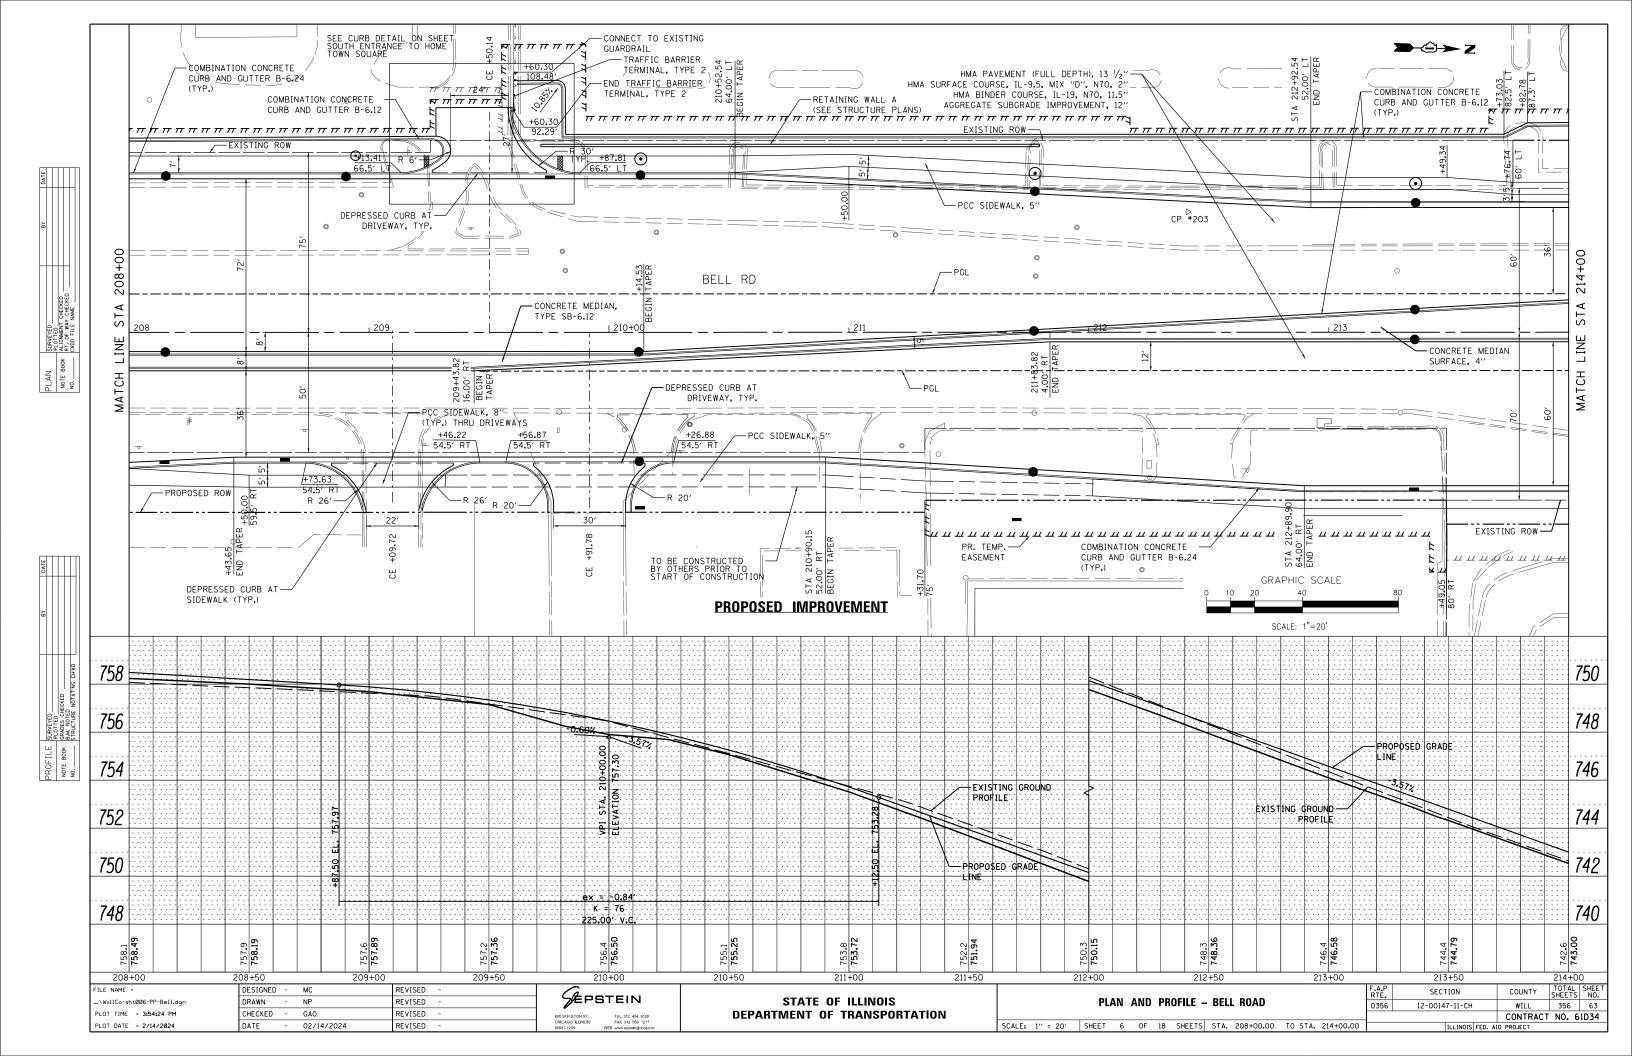


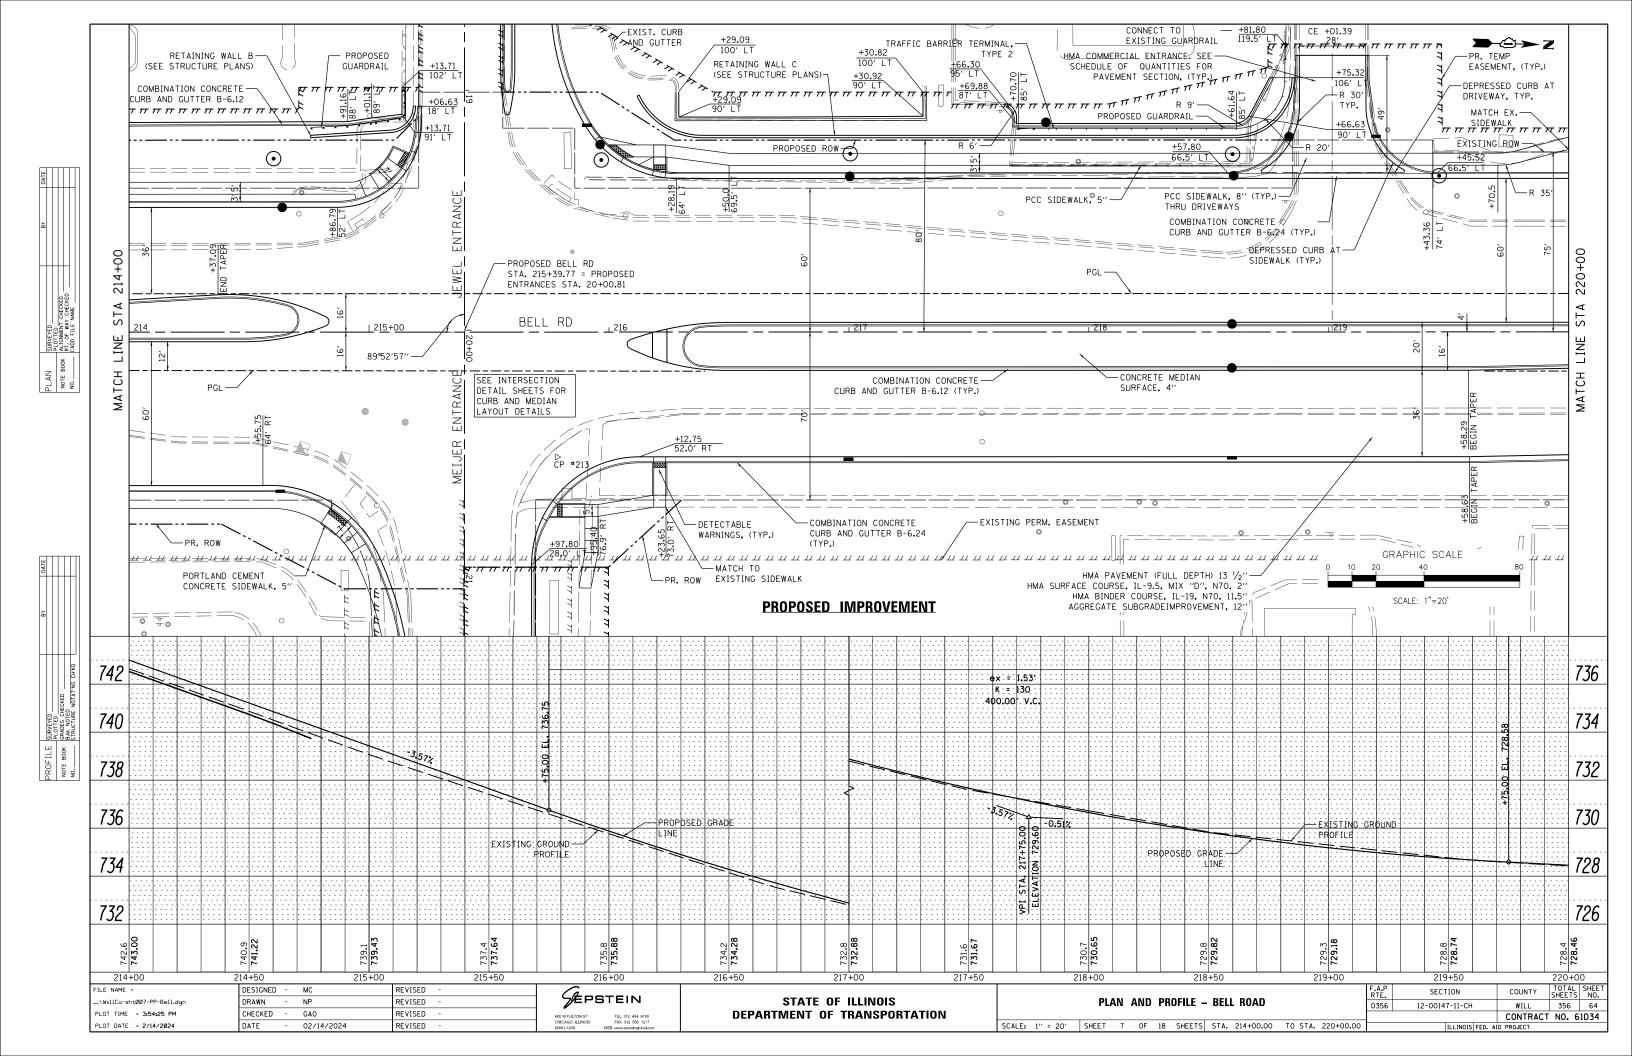


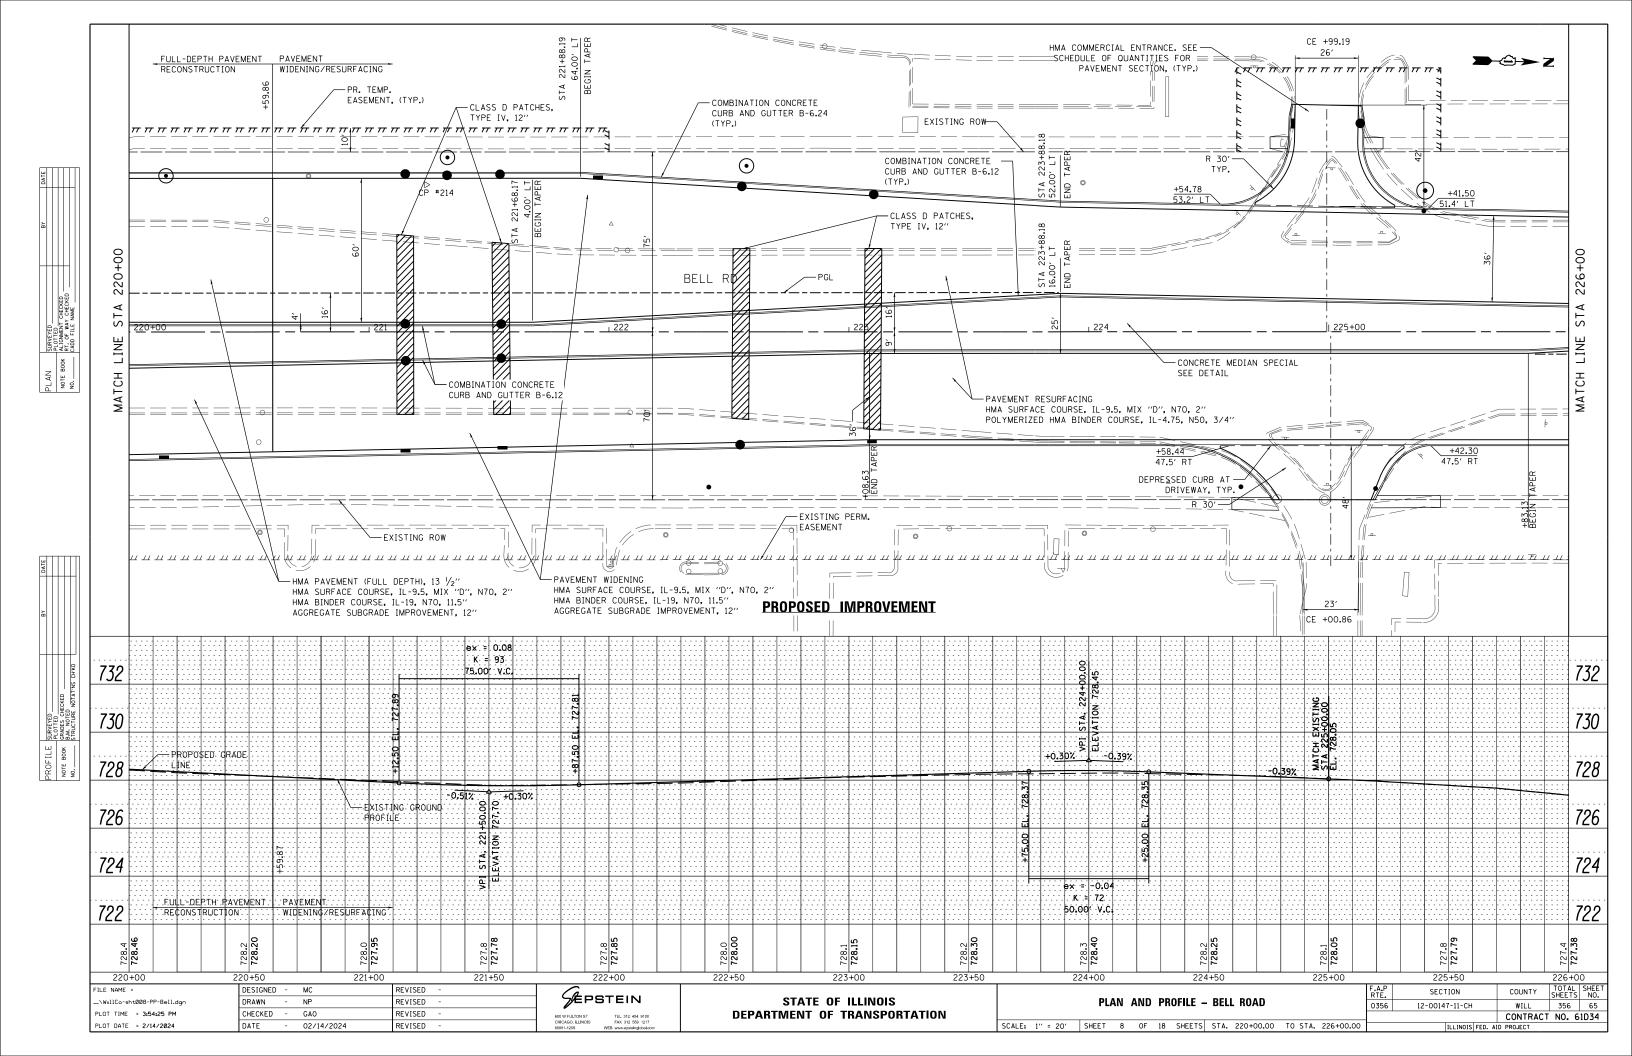


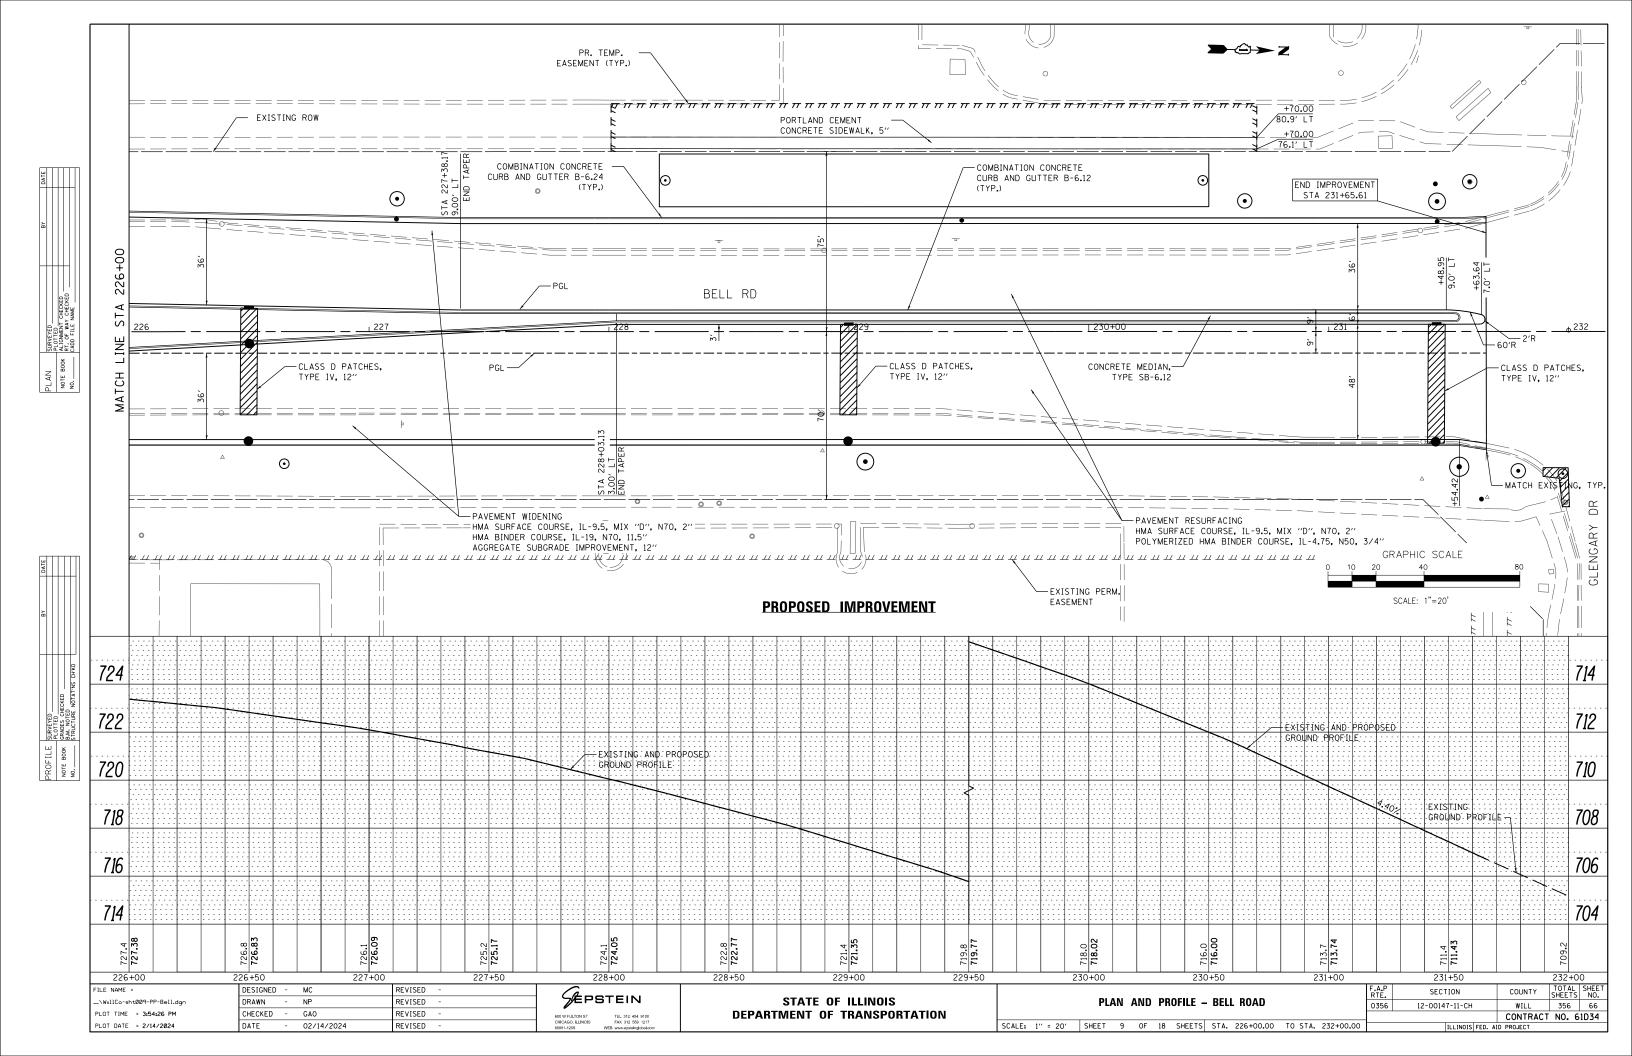


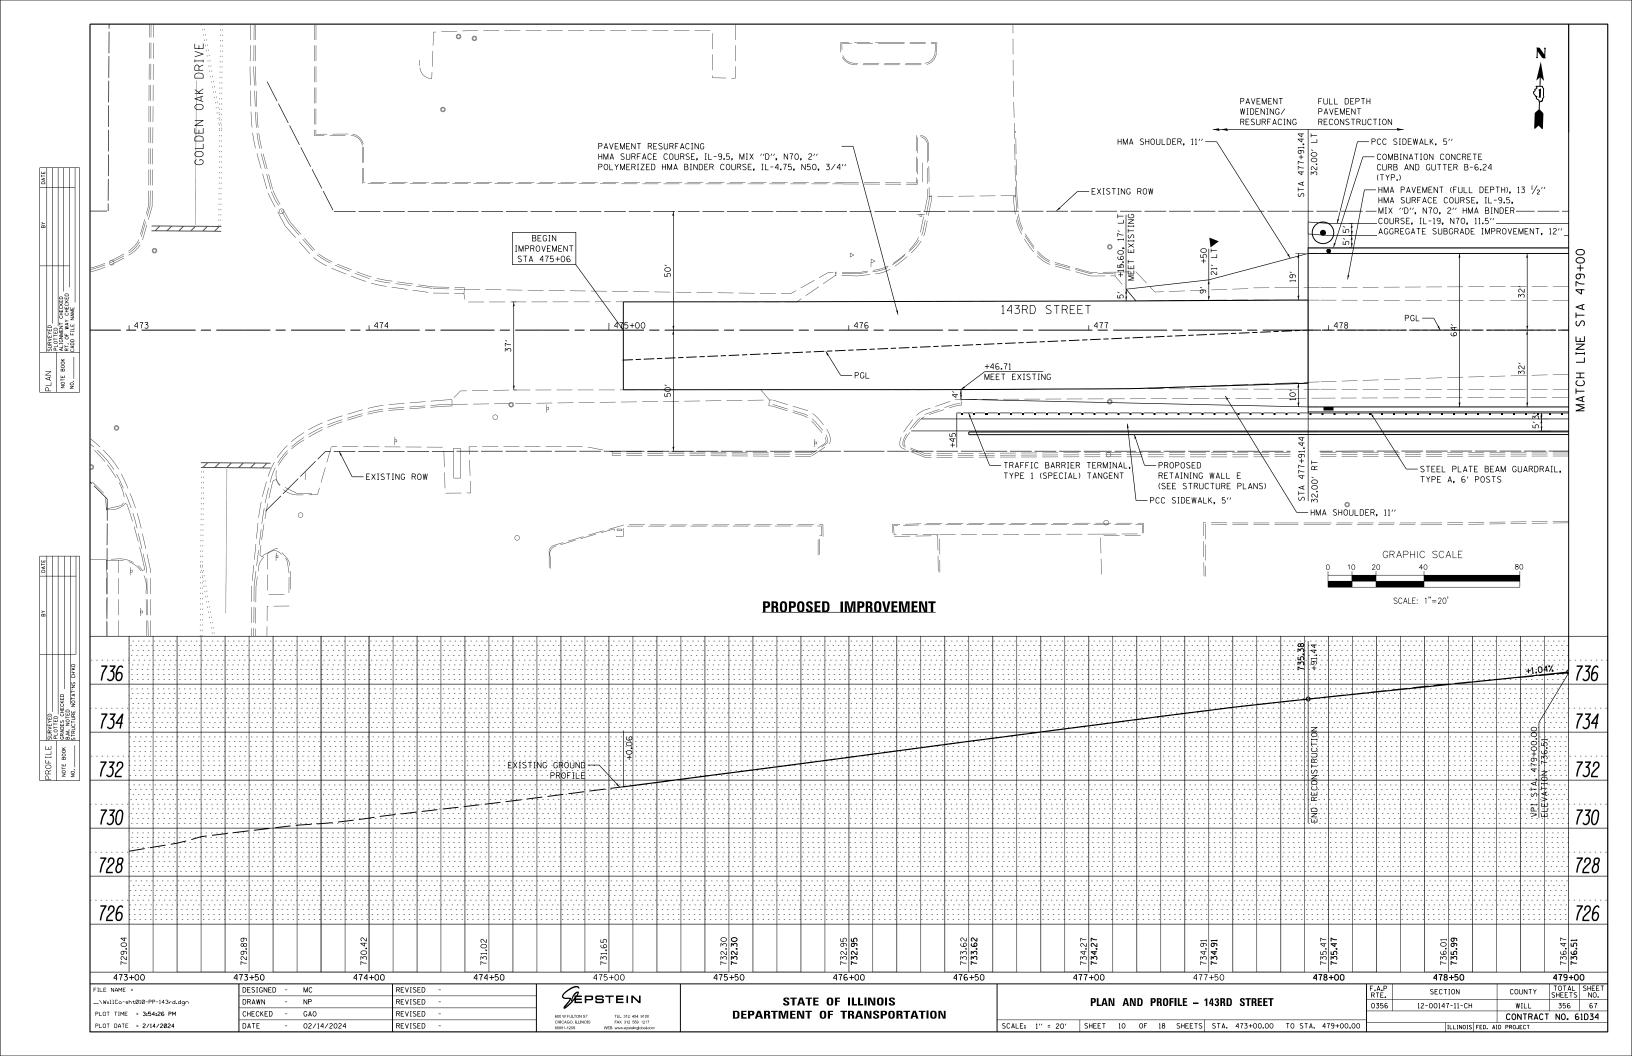


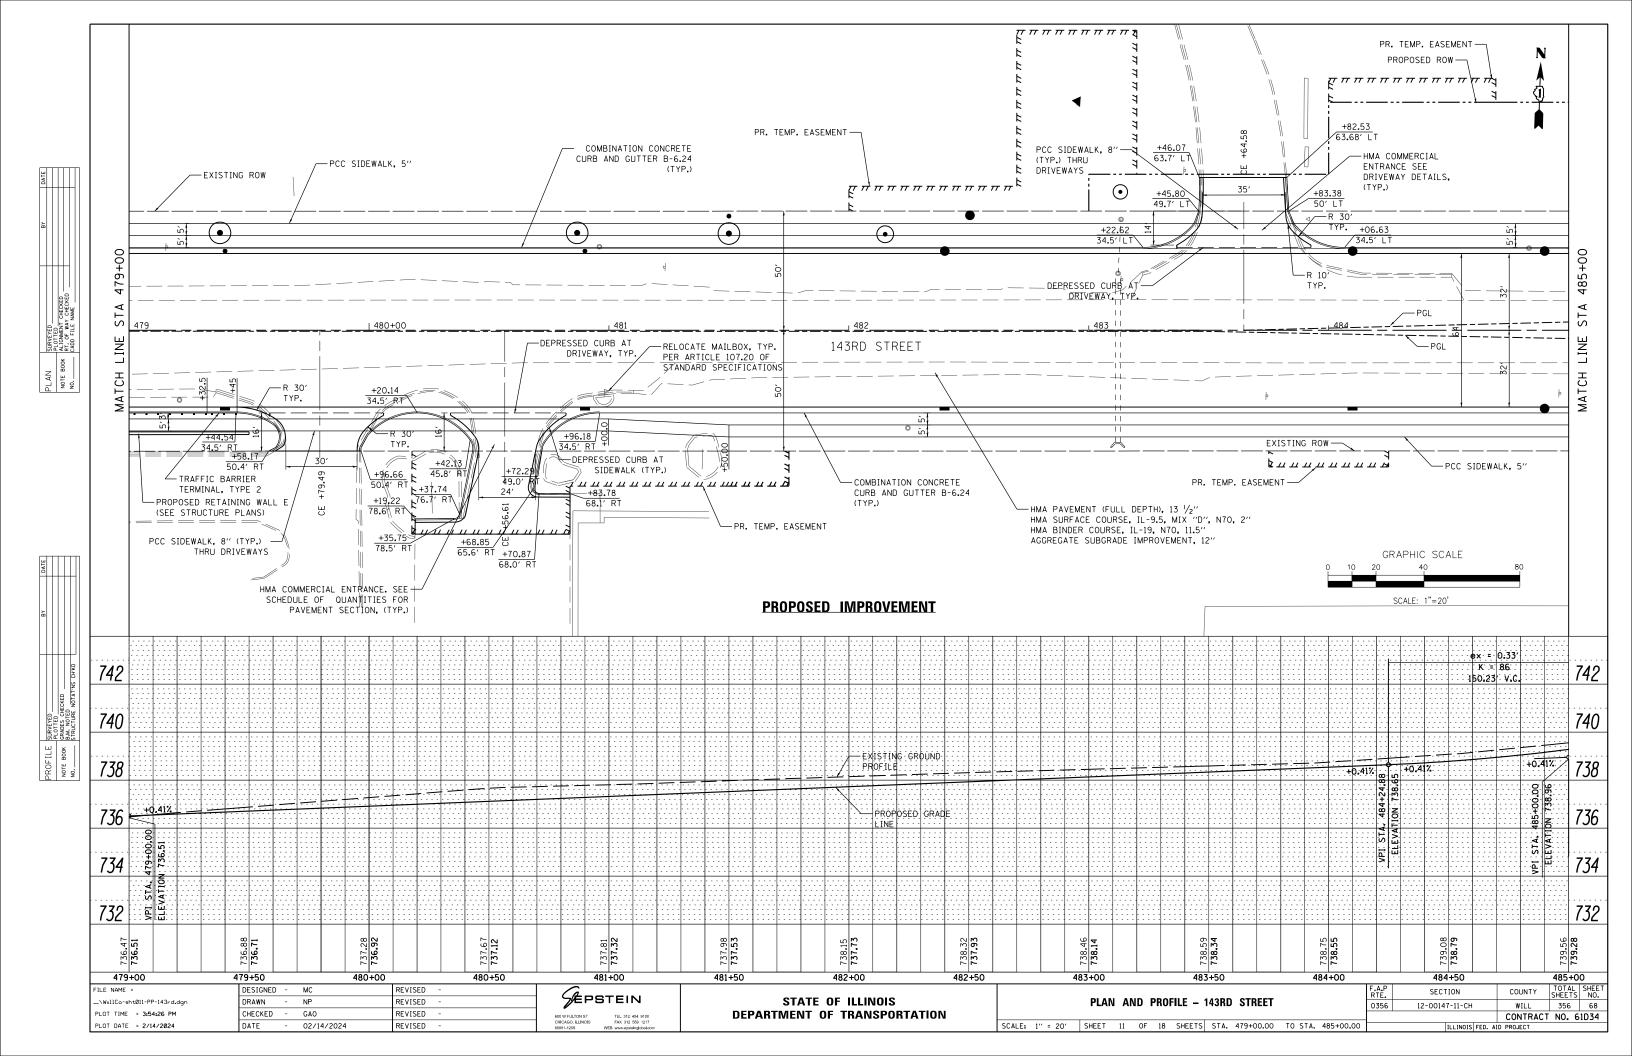


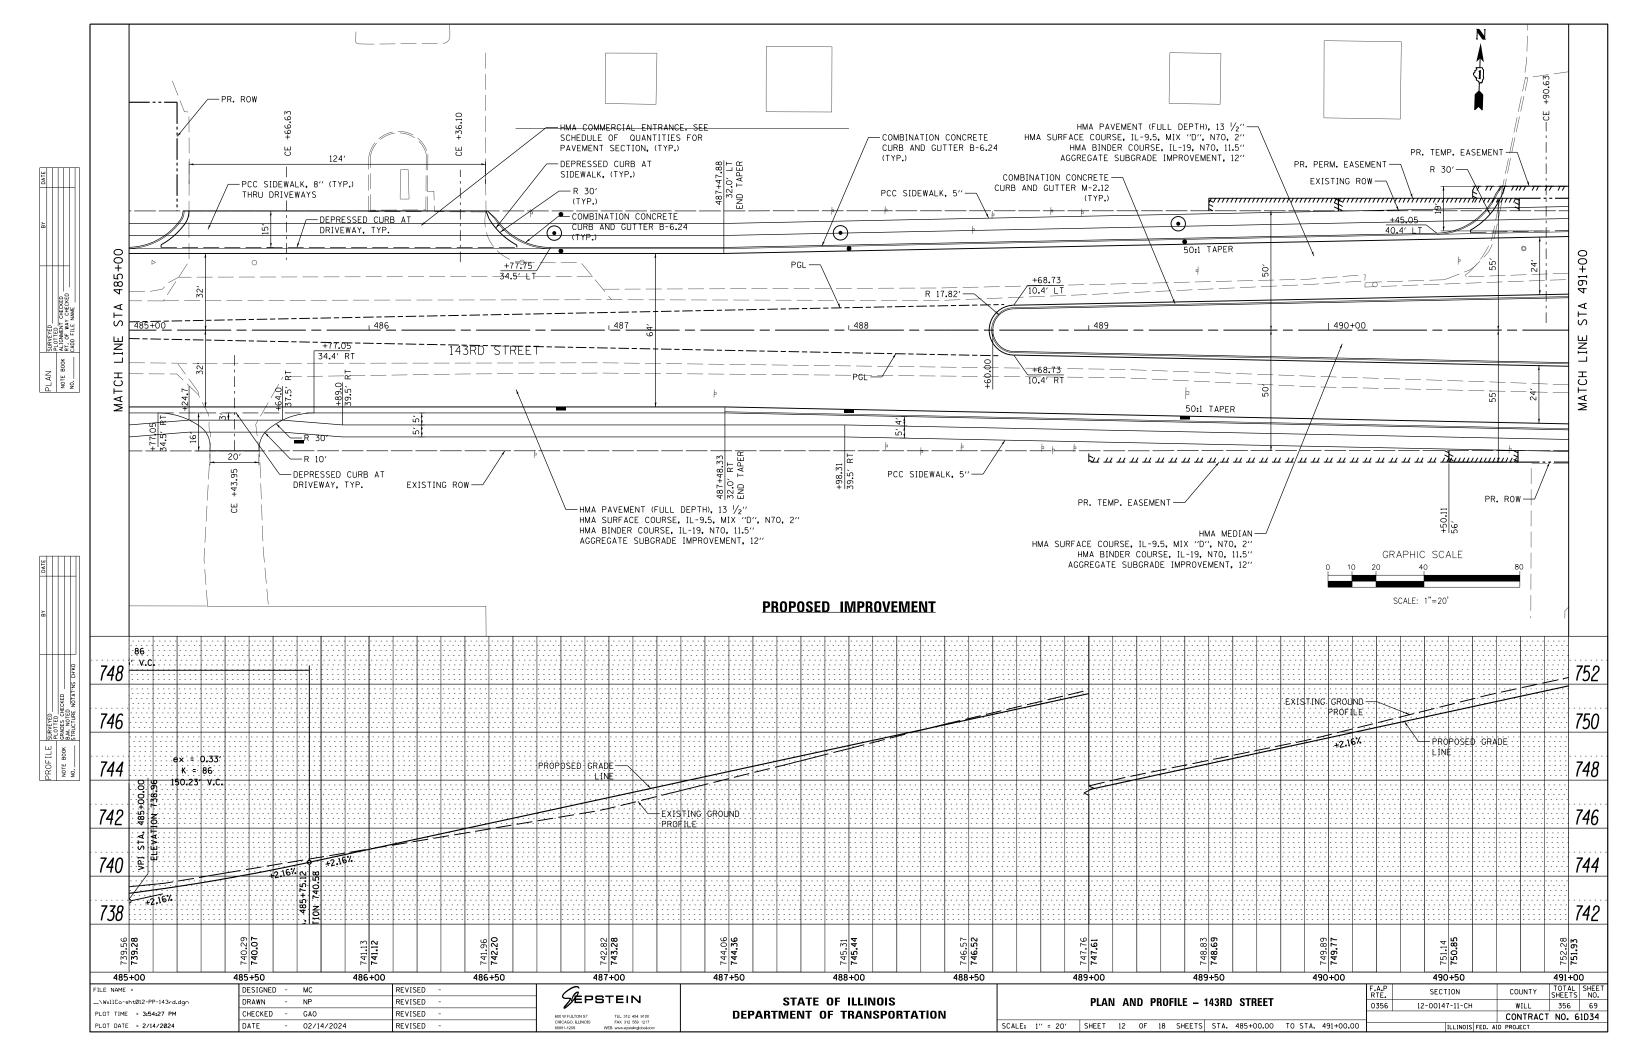


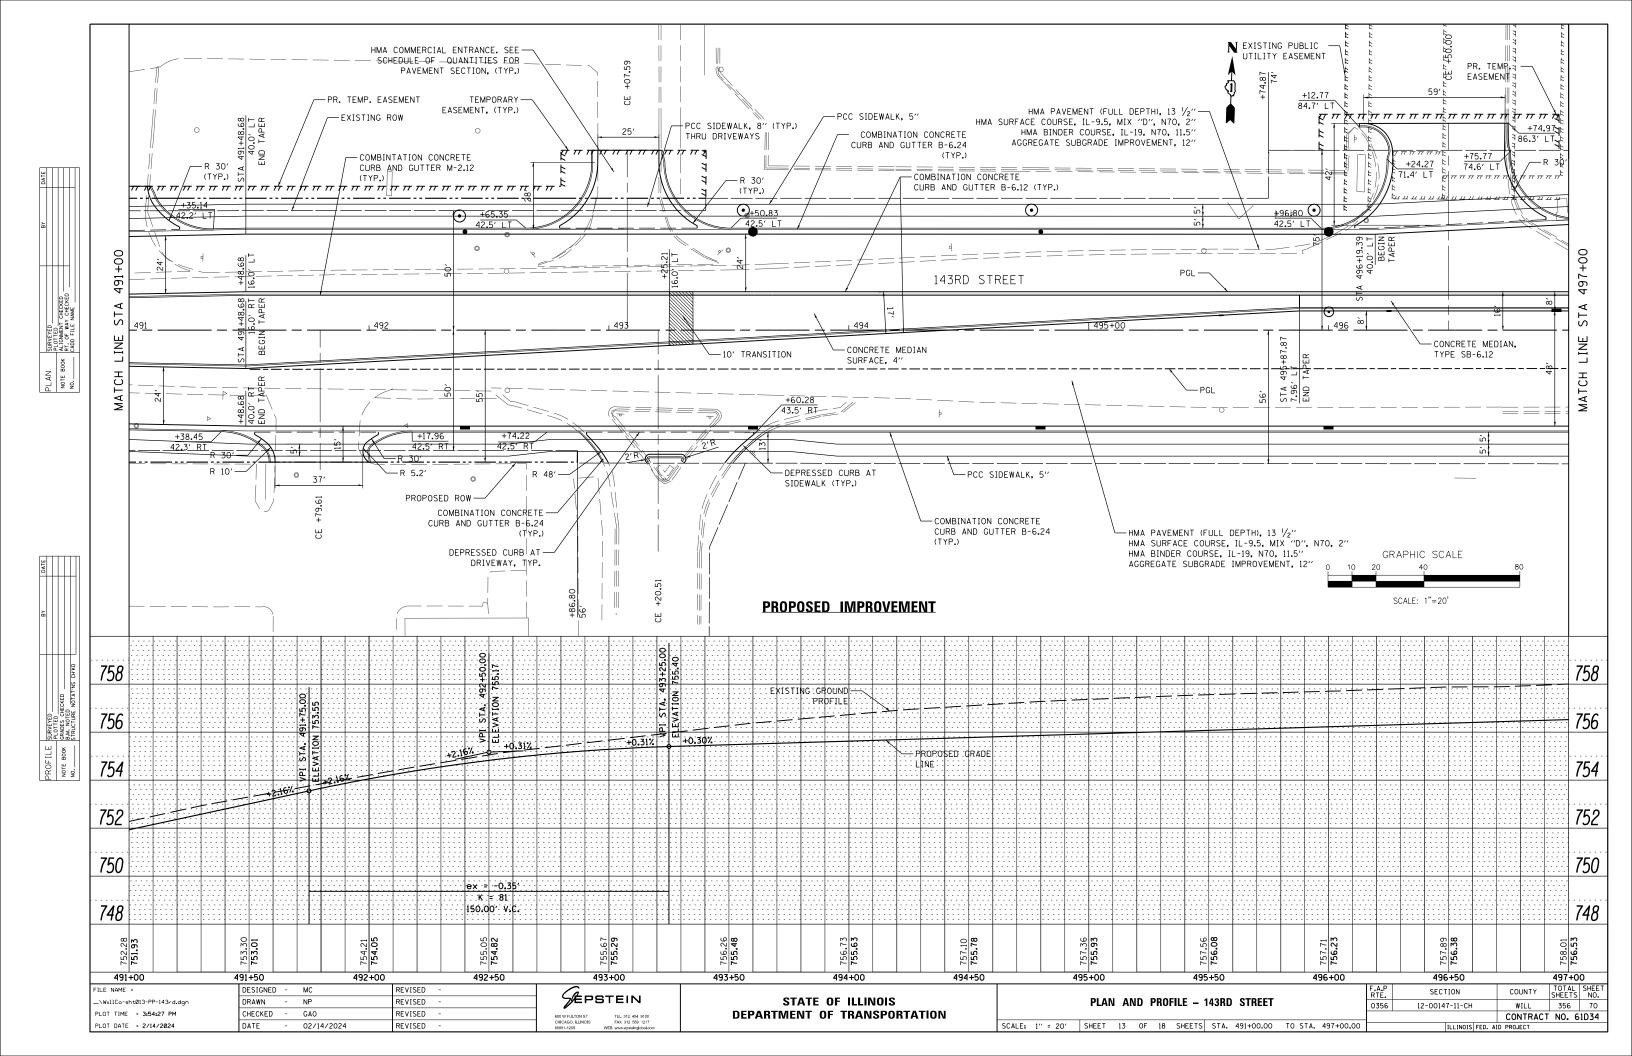

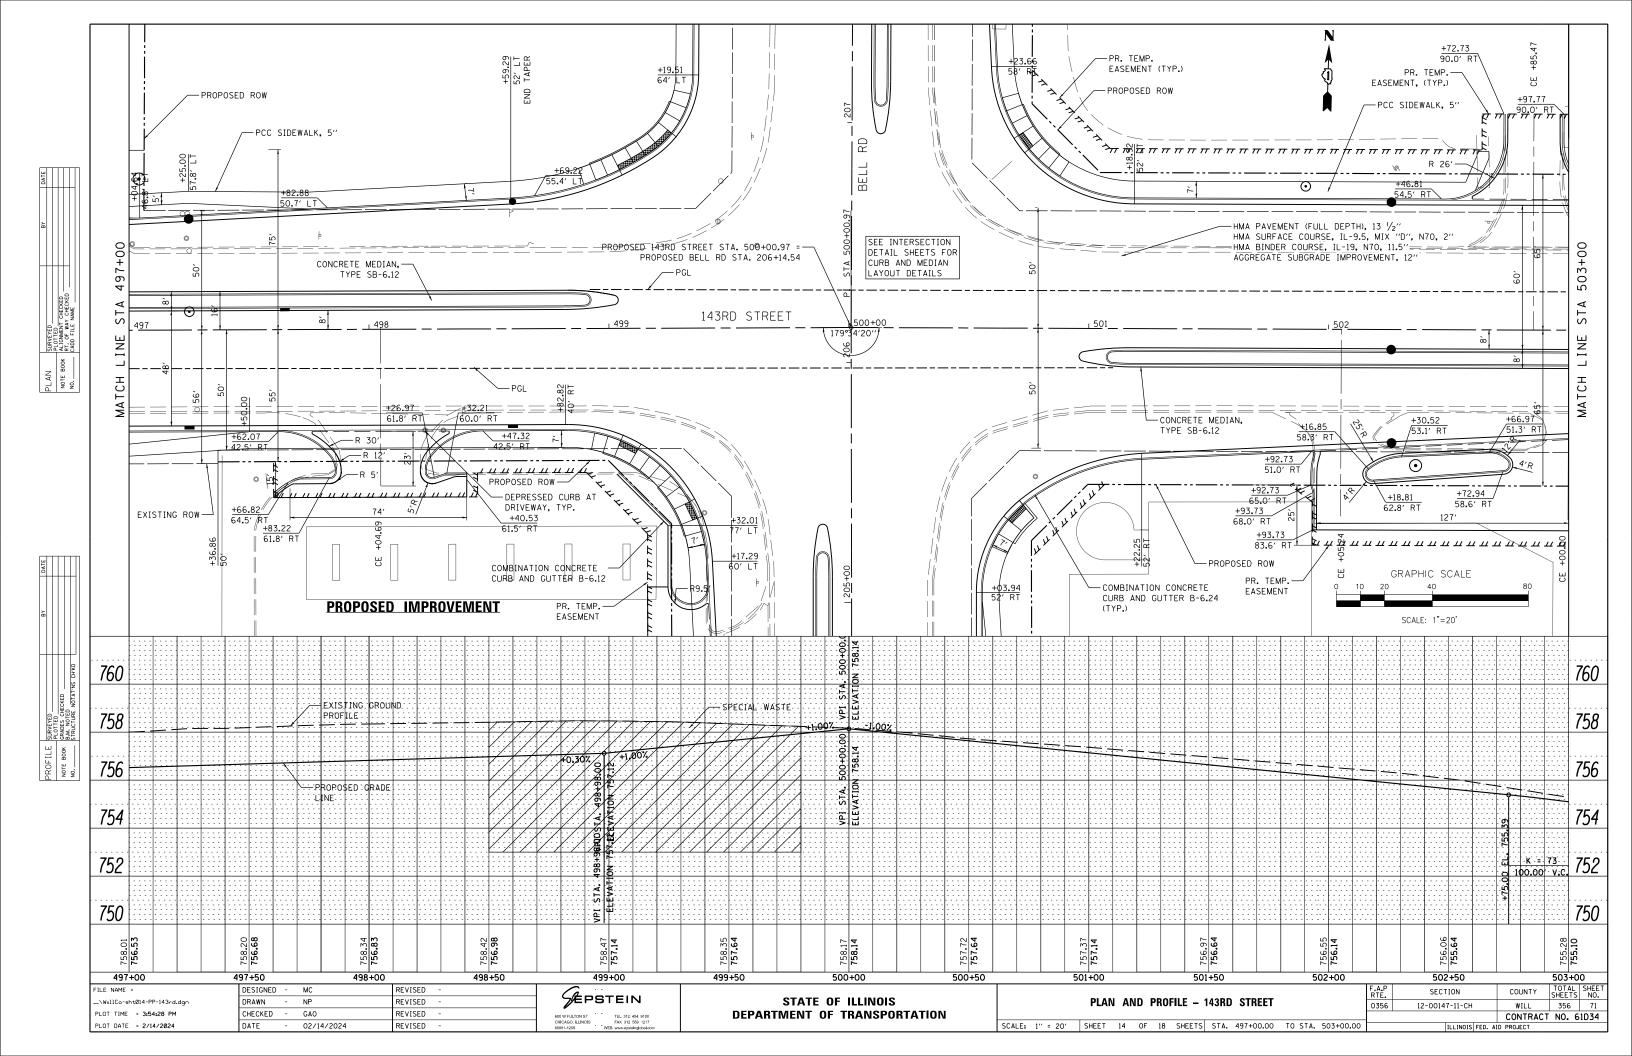


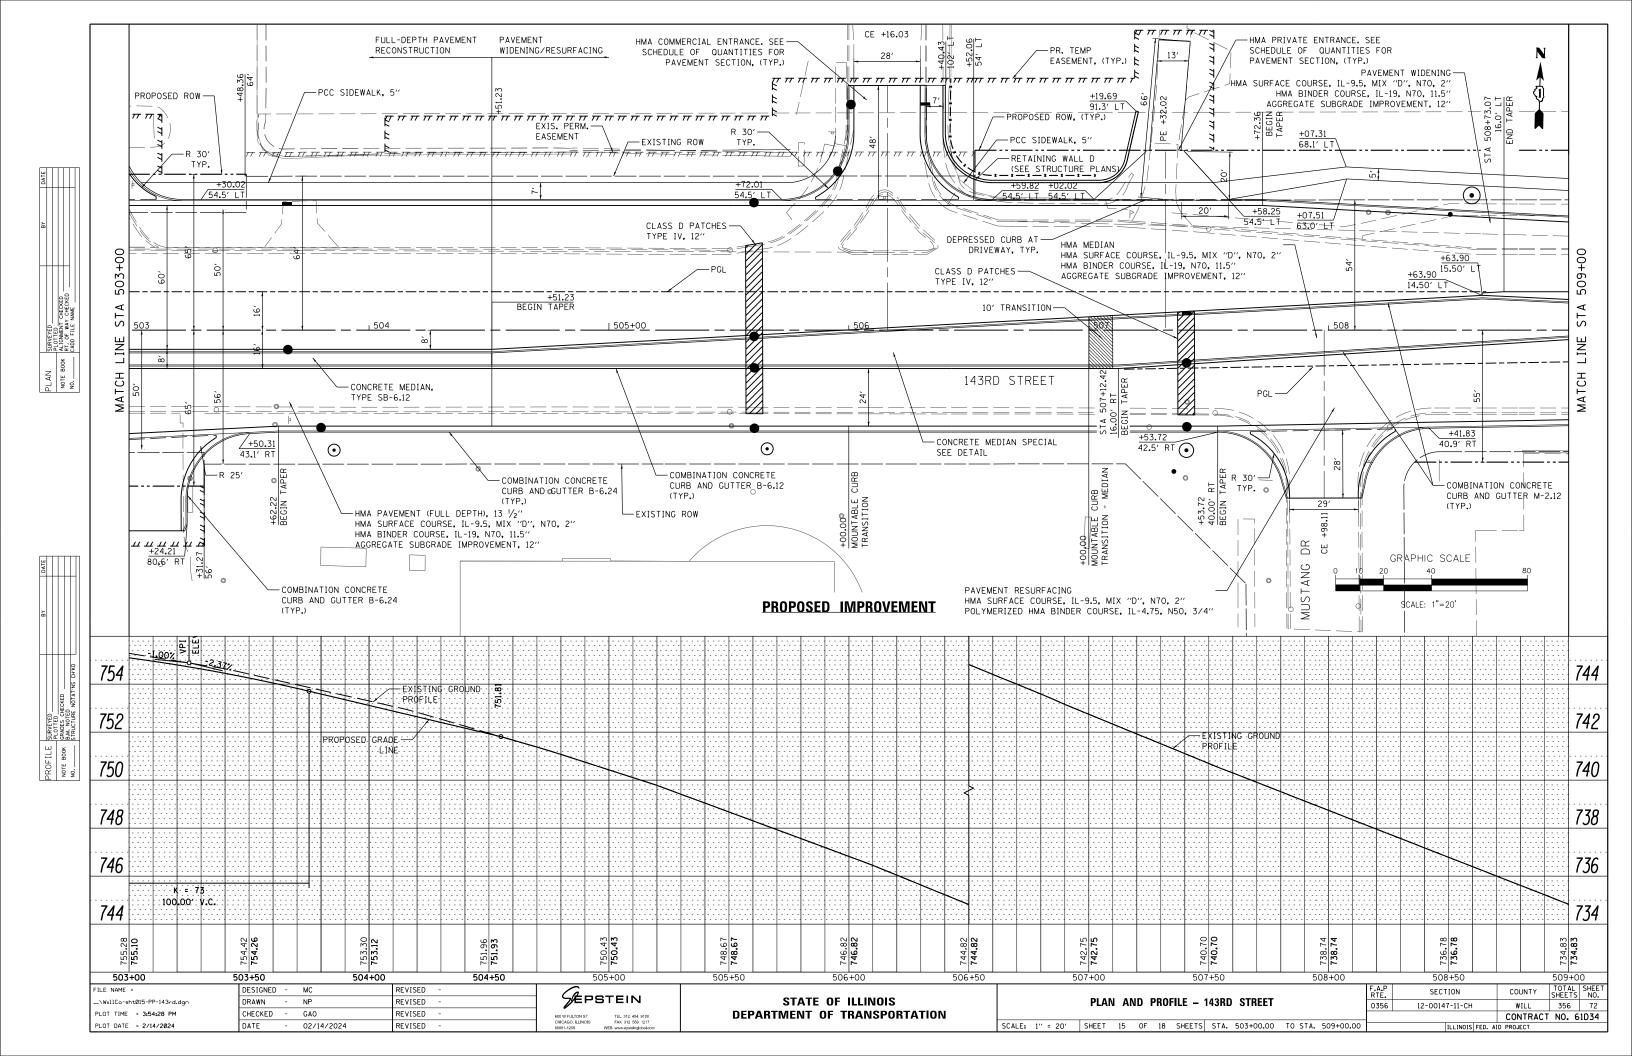

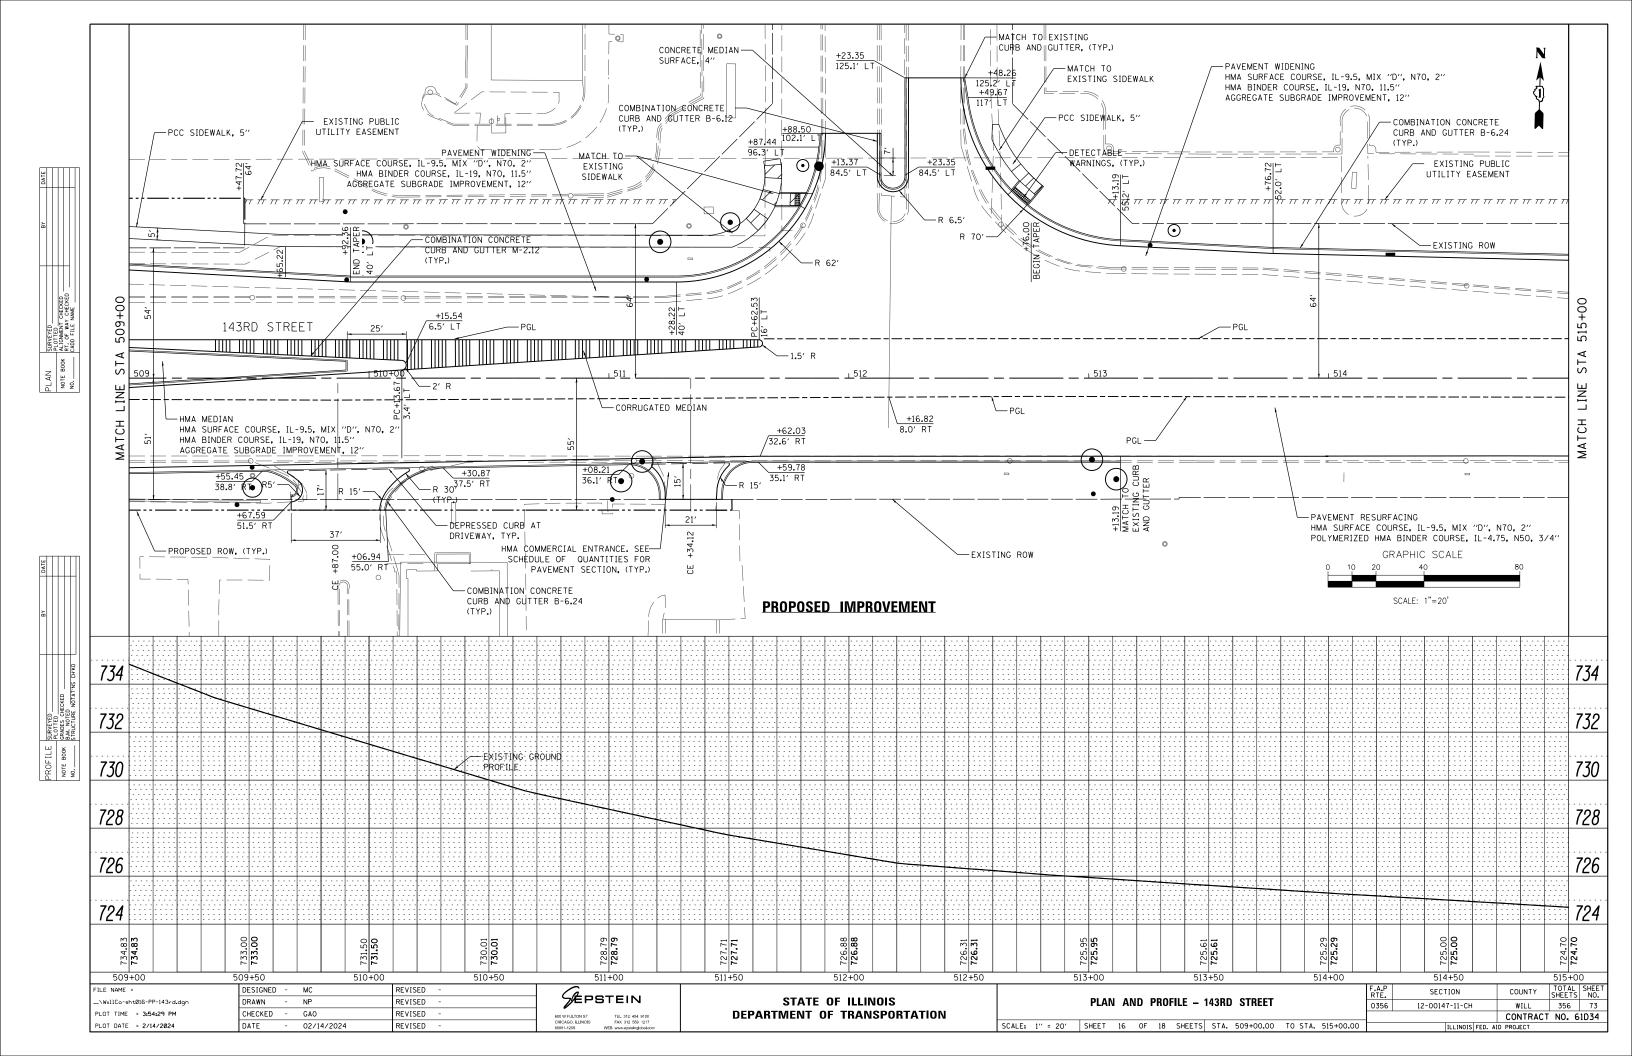

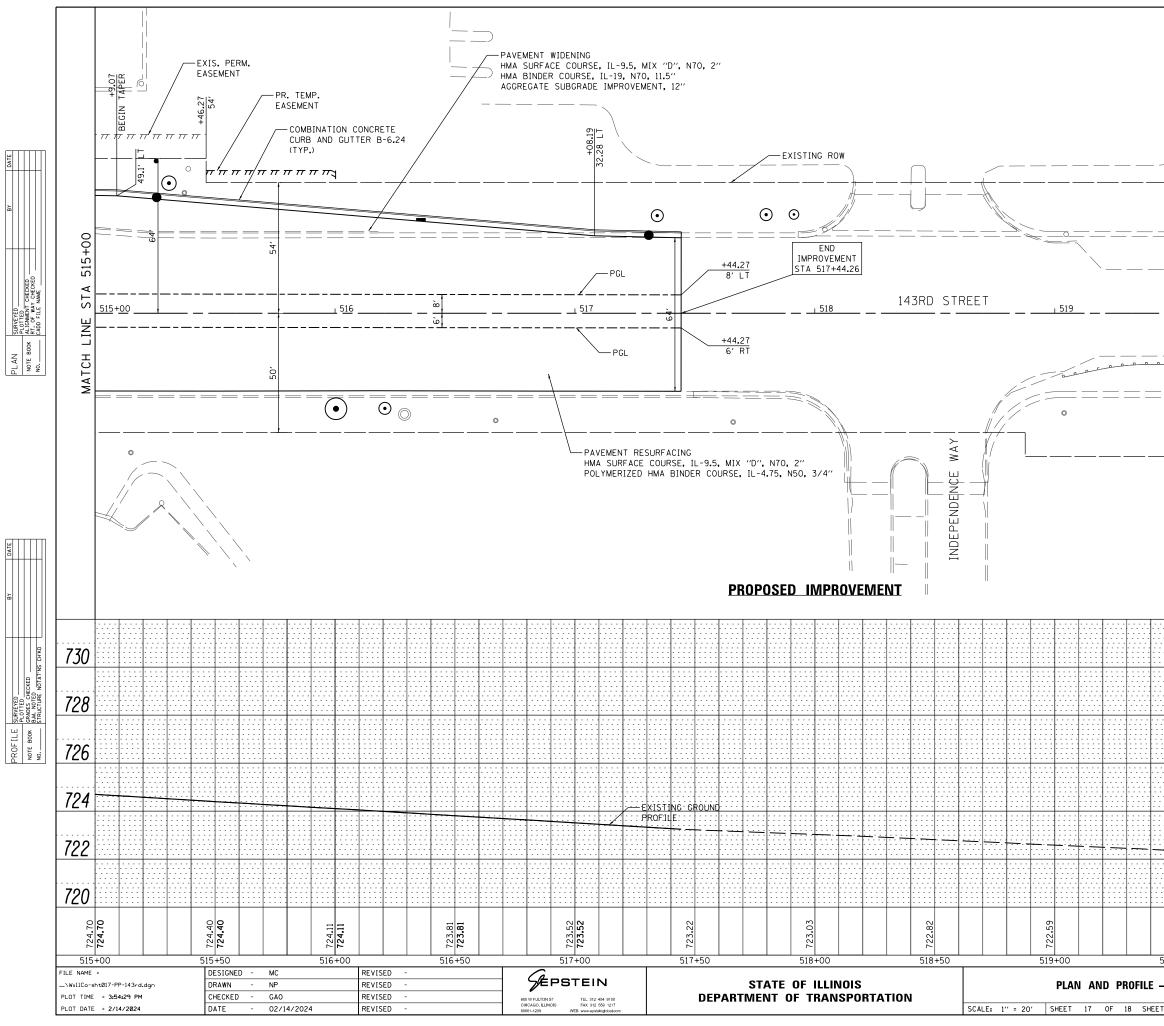

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		SCALE:			
					730
				$+ \cdots + \cdots +$	
					726
					726 724 722
722.35	722.07		721.68		724

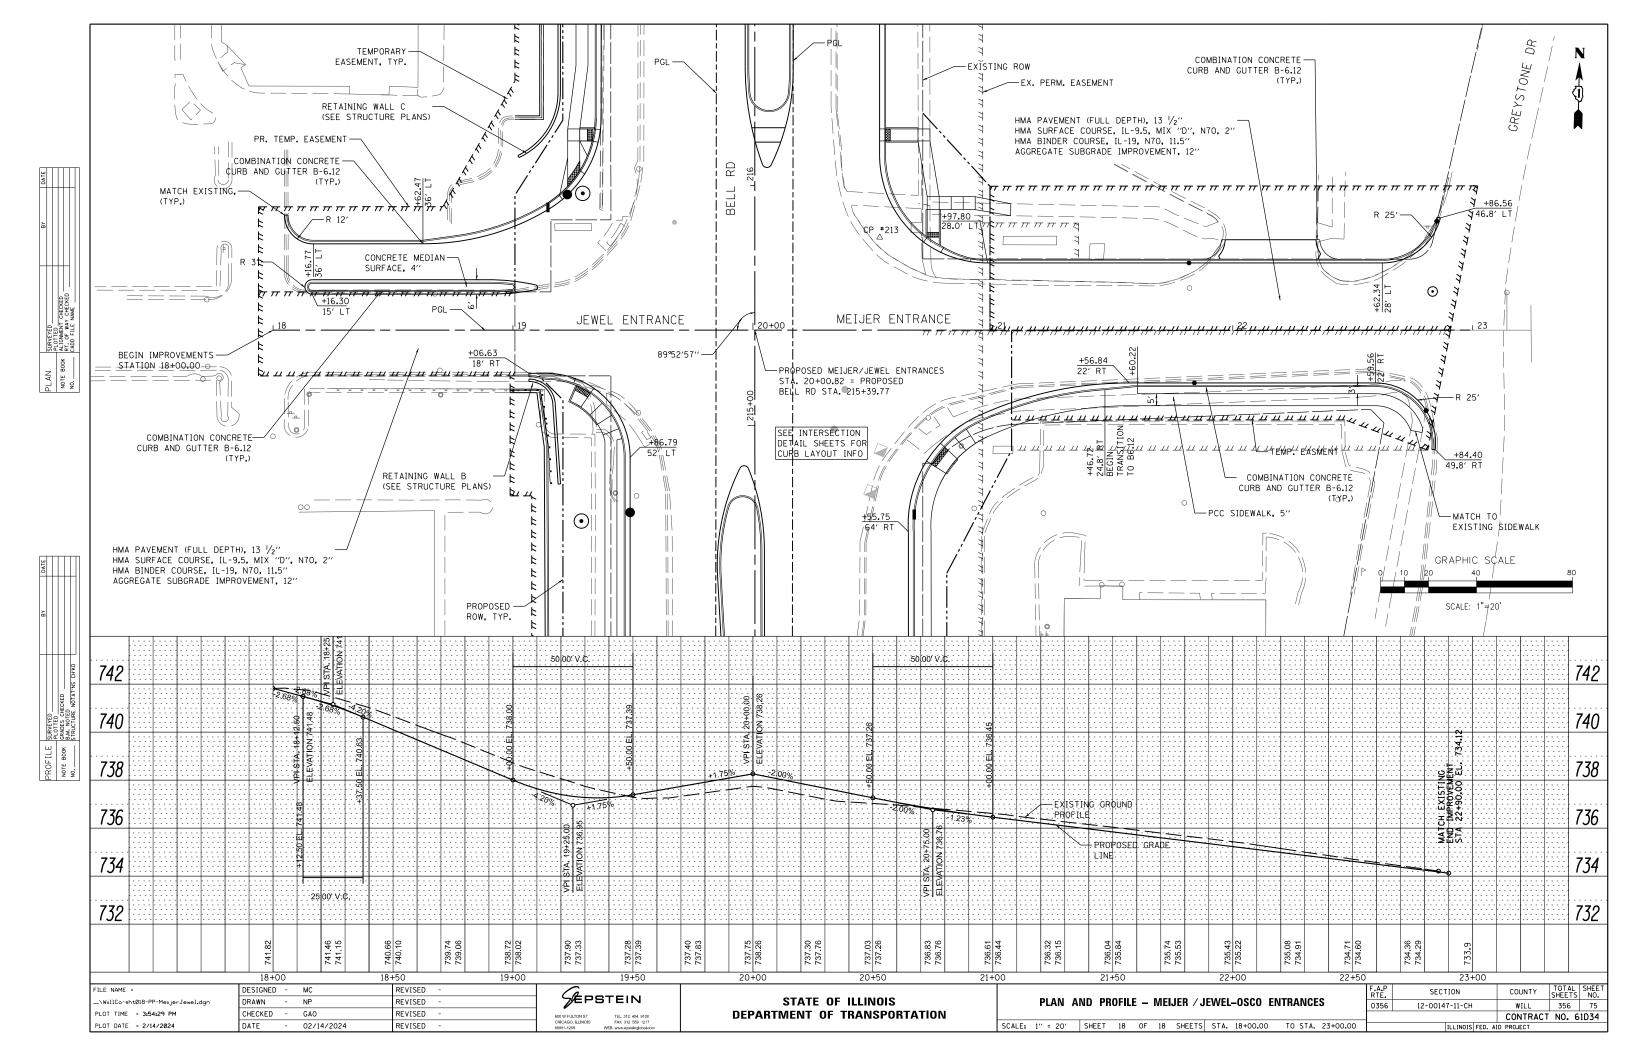

# SUGGESTED STAGE OF CONSTRUCTION & TRAFFIC CONTROL

THE FOLLOWING SEQUENCE OF TRAFFIC CONTROL IS SUGGESTED. VARIATIONS MAY BE MADE, WITH THE APPROVAL OF THE ENGINEER, IF THE PREVAILING SITE CONDITIONS AT THE TIME OF CONSTRUCTION ALLOW. CONTRACTOR SHALL MAINTAIN TWO-WAY TRAFFIC FLOW ON BELL RD AND 143RD STREET AT ALL TIMES.

FOR EACH STAGE OF CONSTRUCTION, PROVIDE TRAFFIC CONTROL AS SHOWN ON THE SUGGESTED STAGES OF CONSTRUCTION & TRAFFIC CONTROL PLANS. COORDINATE INSTALLATION OF TEMPORARY PAVEMENT AND OTHER TRAFFIC CONTROL DEVICES WITH THE EXISTING TRAFFIC PATTERNS AT THE LIMITS OF THE PROJECT.

## PRE-STAGE (NOT SHOWN IN PLANS)

- 1. CONSTRUCT TEMPORARY PAVEMENT WIDENING ADJACENT TO EXISTING SOUTH EOP FROM STA. 476+47 TO 489+38 ALONG 143RD STREET. EXISTING CULVERT TO BE TEMPORARLY EXTENDED AT STA 483+12. RT.
- 2. EXTEND & CONSTRUCT THE SOUTH STORM SEWER SYSTEM ON 143RD STREET AND THE EAST STORM SEWER SYSTEM ON BELL ROAD. USE DAILY SINGLE LANE CLOSURES TO INSTALL DRAINAGE ACROSS 143RD ST AND BELL RD.
- 3. UTILIZE IDOT STANDARD 701326, 701426, 701427, AND 701606 FOR TEMPORARY LANE CLOSURE AND TEMPORARY PAVEMENT WIDENING.
- 4. REMOVE EXISTING TRAFFIC SIGNALS AT BELL RD/143RD ST, BELL RD/MEIJER/JEWEL ENTRANCE, 143RD ST./JEWEL ENTRANCE AND 143RD ST/GREYSTONE. CONSTRUCT TEMPORARY SIGNALS AT SAME LOCATIONS (CONSULT TRAFFIC SIGNAL PLANS).

## STAGE 1

- 1. REMOVE EXISTING PAVEMENT MARKINGS & RAISED PAVEMENT MARKERS IN CONFLICT WITH STAGE 1 STRIPING. PLACE TEMPORARY STRIPING & ADVANCED SIGNS TO INDICATE SHIFTED LANES ON BELL RD AND 143RD ST.
- 2. ESTABLISH TWO-WAY TRAFFIC ALONG EAST SIDE OF BELL RD; LANE SHIFTS OCCUR SOUTH OF MARTINGALE LN AND NORTH OF GLENGARY DR. ESTABLISH TWO-WAY TRAFFIC ALONG SOUTH SIDE OF 143RD ST; ESTABLISH TWO-WAY TRAFFIC ALONG THE EAST SIDE OF GREYSTONE. LANE SHIFTS OCCUR EAST OF GOLDEN OAK DR AND EAST OF INDEPENDENCE WAY.
- 3. COMPLETE EROSION CONTROL, INCLUDING SILT FENCE INSTALLATIONS, INLET PROTECTION, AND SEDIMENT CONTROL MEASURES.
- 4. DEMOLISH EXISTING STORM SEWER SYSTEM, PAVEMENT, CURB & GUTTER. AND OTHER APPURTENANCES WITHIN WORK ZONE. CONSULT REMOVAL PLANS.
- 5. COMPLETE PROPOSED STORM SEWER SYSTEM ALONG THE WEST PART OF BELL RD; BEGIN AT NORTH PART OF 143RD ST. CONSULT DRAINAGE PLANS.
- 6. COMPLETE RETAINING WALLS A, B & C ALONG BELL RD.
- 7. COMPLETE PAVEMENT WIDENING & RECONSTRUCTION, DRIVEWAY RECONSTRUCTION, MAILBOX RELOCATION AND GRADING OF THE WEST PART OF BELL RD; BEGIN NORTH PART OF 143RD ST. CONSULT ROADWAY PLANS.

### STAGE 2

- 1. REMOVE EXISTING PAVEMENT MARKINGS & RAISED PAVEMENT MARKERS IN CONFLICT WITH STAGE 2 STRIPING. PLACE TEMPORARY STRIPING & ADJUST ADVANCED SIGNS TO INDICATE SHIFTED LANES ON BELL RD AND 143RD ST.
- 2. ESTABLISH TWO-WAY TRAFFIC ALONG WEST SIDE OF BELL RD (NEW PAVEMENT); LANE SHIFTS OCCUR SOUTH OF MARTINGALE LN AND NORTH OF GLENGARY DR. MAINTAIN TWO-WAY TRAFFIC ALONG SOUTH SIDE OF 143RD ST: ESTABLISH TWO-WAY TRAFFIC ALONG THE WEST SIDE OF GREYSTONE. LANE SHIFTS OCCUR EAST OF GOLDEN OAK DR AND EAST OF INDEPENDENCE WAY, ADJUST TEMP TRAFFIC SIGNALS.
- 3. INSTALL ANY NEW EROSION CONTROL MEASURES, INCLUDING SILT FENCE INSTALLATIONS. INLET PROTECTION. AND SEDIMENT CONTROL MEASURES.
- 4. DEMOLISH EXISTING STORM SEWER SYSTEM, PAVEMENT, CURB & GUTTER, AND OTHER APPURTENANCES WITHIN WORK ZONE. CONSULT REMOVAL PLANS.
- 5. COMPLETE PROPOSED STORM SEWER SYSTEM ALONG THE NORTH PART OF 143RD ST AND EAST PART OF BELL RD. CONSULT DRAINAGE PLANS.
- 6. COMPLETE RETAINING WALL D,E, AND F ALONG BELL RD. AND 143RD ST. SEE STRUCTURAL PLANS.
- 7. COMPLETE PAVEMENT WIDENING & RECONSTRUCTION, DRIVEWAY RECONSTRUCTION, MAILBOX RELOCATION AND GRADING OF THE NORTH PART OF 143RD ST AND EAST PART OF BELL RD. CONSULT ROADWAY PLANS.

## STAGE 3

- 1. REMOVE EXISTING PAVEMENT MARKINGS & RAISED PAVEMENT MARKERS IN CONFLICT WITH STAGE 3 STRIPING. PLACE TEMPORARY STRIPING & ADJUST ADVANCED SIGNS TO INDICATE SHIFTED LANES ON BELL RD & 143RD ST.
- 2. ESTABLISH TWO-WAY TRAFFIC ALONG EAST SIDE OF BELL RD (NEW PAVEMENT): LANE SHIFTS OCCUR SOUTH OF MARTINGALE LN AND NORTH OF GLENGARY DR. ESTABLISH TWO-WAY TRAFFIC ALONG NORTH SIDE OF 143RD ST (NEW PAVEMENT); LANE SHIFTS OCCUR EAST OF GOLDEN OAK DR AND EAST OF INDEPENDENCE WAY. ADJUST TEMP TRAFFIC SIGNALS.
- 3. INSTALL ANY NEW EROSION CONTROL MEASURES, INCLUDING SILT FENCE INSTALLATIONS, INLET PROTECTION, AND SEDIMENT CONTROL MEASURES.
- 4. DEMOLISH EXISTING STORM SEWER SYSTEM, PAVEMENT, CURB & GUTTER, AND OTHER APPURTENANCES WITHIN WORK ZONE. CONSULT REMOVAL PLANS.
- 5. COMPLETE RETAINING WALL E ALONG 143RD STREET. CONSULT STRUCTURAL PLANS.
- 6. COMPLETE PROPOSED STORM SEWER SYSTEM ALONG THE SOUTH PART OF 143RD ST. CONSULT DRAINAGE PLANS.
- 7. COMPLETE PAVEMENT WIDENING & RECONSTRUCTION, DRIVEWAY RECONSTRUCTION, MAILBOX RELOCATION AND GRADING OF THE SOUTH PART OF 143RD ST AND CENTER OF BELL RD AT MEIJER/JEWEL ENTRANCE. CONSULT ROADWAY PLANS.

### STAGE 4a

- 1. REMOVE EXISTING PAVEMENT MARKINGS IN CONFLICT WITH STAGE 4A STRIPING. PLACE TEMP STRIPING & ADJUST ADVANCED SIGNS TO INDICATE SHIFTED LANES ON BELL RD AND 143RD ST. ADJUST TEMP TRAFFIC SIGNALS.
- 2. ESTABLISH TWO-WAY TRAFFIC ALONG WEST SIDE OF BELL RD (NEW PAVEMENT). LANE SHIFTS OCCUR NORTH OF MARTINGALE LN AND SOUTH OF GLENGARY DR.
- 3. ESTABLISH TWO-WAY TRAFFIC ALONG FAR SIDES OF 143RD ST (NEW PAVEMENT). CLOSE MEDIAN FOR WORK ZONE. LANE SHIFTS OCCUR EAST OF GOLDEN OAK DR AND EAST OF INDEPENDENCE WAY.
- 4. INSTALL ANY NEW EROSION CONTROL MEASURES, INCLUDING SILT FENCE INSTALLATIONS, INLET PROTECTION, AND SEDIMENT CONTROL MEASURES.
- 5. DEMOLISH EXISTING PAVEMENT, CURB & GUTTER, AND OTHER APPURTENANCES WITHIN WORK ZONE. CONSULT REMOVAL PLANS.
- 6. COMPLETE PROPOSED STORM SEWER SYSTEM ALONG THE MEDIAN OF 143RD ST. CONSULT DRAINAGE PLANS.
- 7. COMPLETE PAVEMENT RECONSTRUCTION AT BELL RD/143RD ST INTERSECTION, AND AT BELL RD/MEIJER/JEWEL INTERSECTION. BEGIN MEDIAN CONSTRUCTION OF 143RD ST. CONSULT ROADWAY PLANS.

### STAGE 4b

- 1. REMOVE EXISTING PAVEMENT MARKINGS IN CONFLICT WITH STAGE 4B STRIPING. PLACE TEMP STRIPING & ADJUST ADVANCED SIGNS TO INDICATE SHIFTED LANES ON BELL RD AND 143RD ST. ADJUST TEMP TRAFFIC SIGNALS.
- 2. ESTABLISH TWO-WAY TRAFFIC ALONG FAR SIDES OF BELL RD (NEW PAVEMENT). CLOSE MEDIAN FOR WORK ZONE. LANE SHIFTS OCCUR NORTH OF MARTINGALE IN AND SOUTH OF GLENGARY DR.
- 3. MAINTAIN TWO-WAY TRAFFIC ALONG FAR SIDES OF 143RD ST (NEW PAVEMENT). OPEN TWO LANES IN EACH DIRECTION WHERE DEPICTED IN PLANS.
- 4. DEMOLISH EXISTING PAVEMENT, CURB & GUTTER, AND OTHER APPURTENANCES WITHIN WORK ZONE. CONSULT REMOVAL PLANS.
- 5. COMPLETE PROPOSED STORM SEWER SYSTEM ALONG THE MEDIAN OF BELL RD. CONSULT DRAINAGE PLANS.
- 6. COMPLETE MEDIAN CONSTRUCTION OF 143RD ST & BELL RD.
- 7. BEGIN INSTALLATION OF PERMANENT TRAFFIC SIGNALS.

## STAGE 5 (NOT SHOWN IN PLANS)

- 1. USE DAILY LANE CLOSURES TO COMPLETE HMA SURFACE COURSE. UTILIZE IDOT STANDARD 701201 FOR MAINTENANCE OF TRAFFIC. INSTALL MINIMUM OF 2 UNEVEN LANE SIGNS IN EACH DIRECTION.
- 2. COMPLETE INSTALLATION OF PERMANENT TRAFFIC SIGNALS.
- 3. INSTALL PERMANENT STRIPING/SIGNING.
- 4. INSTALL FINAL LANDSCAPING.

# **MAINTENENCE OF TRAFFIC GENERAL NOTES**


- 1. ANY DROP OFF GREATER THAN THREE INCHES WITHIN EIGHT FEET OF 15. THE CONTRACTOR SHALL BE REQUIRED TO REMOVE ALL EXISTING THE TRAVELED WAY, SHALL BE PROTECTED BY TYPE II BARRICADES PAVEMENT MARKINGS WHICH CONFLICT WITH EACH TRAFFIC CONTROL (OR DRUMS) EQUIPPED WITH MONO-DIRECTIONAL STEADY-BURN LIGHTS STAGE, AND SHALL BE PAID AS PAVEMENT MARKING REMOVAL. SPACED AT 25 FOOT CENTERS. BARRICADES THAT MUST BE PLACED IN EXCAVATED AREAS SHALL HAVE LEG EXTENSIONS INSTALLED SUCH 16. ALL TEMPORARY PAVEMENT MARKINGS SHOWING DETERIORATION AFTER THAT THE TOP OF THE BARRICADE IS IN COMPLIANCE WITH THE 7 DAYS SHALL BE REPLACED BY THE CONTRACTOR AS DIRECTED BY HEIGHT REQUIREMENTS OF THE IDOT HIGHWAY STANDARD. THE ENGINEER. SUFFICIENT QUANTITIES FOR 1 PLACEMENT AND 3
- REPLACEMENTS HAVE BEEN PROVIDED FOR EACH STAGE. ALL MARKINGS 2. ARROW BOARDS WILL BE REQUIRED WHEN IMPLEMENTING ALL LANE THAT REQUIRE REPLACEMENT PRIOR TO 7 DAYS OF SERVICE OR CLOSURES. ALL ARROW BOARDS SHALL HAVE SOLAR POWER REPLACEMENT AFTER THE THIRD REPLACEMENT SHALL BE REPLACED CAPABILITY. BY THE CONTRACTOR AT THEIR OWN EXPENSE.
- PRIOR TO THE START OF CONSTRUCTION, REQUIRED TRAFFIC CONTROL 3. 17. DRUMS OR TYPE II BARRICADES AND VERTICAL PANELS SHALL BE EQUIPPED WITH MONODIRECTIONAL STEADY BURN LIGHTS AND SHALL DEVICES SHALL BE IN PLACE. BE PLACED AT 50' INTERVALS ALONG THE PROPOSED CONSTRUCTION IDOT TRAFFIC CONTROL STANDARDS LISTED BY REFERENCE ON SHEET WORK ZONE, AT 25' INTERVALS IN CURVES, AND AT 25' INTERVALS IN 4. TAPER SECTIONS AS INDICATED ON THE PLANS OR AS DIRECTED BY 2 SHALL BE USED AS GUIDES IN IMPLEMENTING THE TRAFFIC THE ENGINEER. TYPE II BARRICADES THAT HAVE A MINIMUM CONTROL, INCLUDING SIGN LOCATIONS, FOR THIS PROJECT. REFLECTORIZED AREA OF 288 SQUARE INCHES AND ARE 2' IN WIDTH THE CONTRACTOR SHALL MAINTAIN ACCESS TO ALL PROPERTIES SHALL BE USED IN ALL STAGES OF CONSTRUCTION.
- 5. DURING CONSTRUCTION OPERATIONS.
- 18. THE FURNISHING, INSTALLATION AND RELOCATION OF ALL TRAFFIC DEPICTED TRAFFIC CONTROL IS A MINIMUM REQUIREMENT, AND OTHER SIGNS SHALL BE IN ACCORDANCE WITH THE MANUAL ON UNIFORM 6. WORK OR SIGNING MAY BE REQUIRED AS PER THE INSTRUCTION OF TRAFFIC CONTROL DEVICES FOR STREETS AND HIGHWAYS (MUTCD), ILLINOIS SUPPLEMENT TO THE MUTCD, IDOT SPECIAL PROVISIONS, THE ENGINEER IN CHARGE. THE COST INCURRED TO COMPLY WILL BE INCLUDED IN THE PAY ITEMS "TRAFFIC CONTROL AND PROTECTION, IDOT HIGHWAY STANDARDS, IDOT STANDARD SPECIFICATIONS, CONTRACT SPECIFICATIONS, AND AS DIRECTED BY THE ENGINEER. THIS (SPECIAL)". WORK SHALL BE INCLUDED IN THE COST FOR TRAFFIC CONTROL AND 7. PROTECTION (SPECIAL).
- THE CONTRACTOR SHALL PROVIDE THE ENGINEER WITH THE NAMES AND PHONE NUMBERS OF THEIR REPRESENTATIVES ON THE CONSTRUCTION SITE PRIOR TO THE START OF WORK.
- THE CONTRACTOR SHALL BE RESPONSIBLE FOR THE FIELD LOCATION 8. OF ALL DETOUR AND CONSTRUCTION SIGNING. THE CONTRACTOR MAY REQUEST THE ENGINEER TO FIELD VERIFY THE POSITIONS OF ANY SIGNS.
- THE CONTRACTOR SHALL MAINTAIN A MINIMUM OF ONE 11' THRU-LANE 9. IN EACH DIRECTION FOR TWO-WAY TRAFFIC FLOW (UNLESS OTHERWISE SPECIFIED) ON 143RD STREET AND BELL ROAD AT ALL TIMES. A MINIMUM OF 4' SHALL BE MAINTAINED AT ALL TIMES BETWEEN TRAFFIC AND CONSTRUCTION UNLESS OTHERWISE NOTED IN THE PLANS.
- 22. THE CONTRACTOR SHALL BE RESPONSIBLE FOR PROVIDING AND THE CONTRACTOR SHALL MAINTAIN TRAFFIC IN ACCORDANCE WITH MAINTAINING ALL BARRIERS, LABOR, SIGNS AND TRAFFIC CONTROL 10. IDOT SPECIAL PROVISIONS, IDOT HIGHWAY STANDARDS, IDOT DEVICES NECESSARY FOR THE MAINTENANCE OF TRAFFIC UNLESS STANDARD SPECIFICATIONS, PLAN SPECIFICATIONS, AND AS DIRECTED NOTED OTHERWISE IN THE SPECIAL PROVISIONS. BY THE ENGINEER.
- 23. ALL TRAFFIC CONTROL DEVICES SHALL BE REMOVED. COVERED OR PORTABLE/CHANGEABLE ELECTRONIC MESSAGE BOARDS SHOWN TO BE TURNED AWAY FROM THE TRAFFIC IMMEDIATELY WHEN THEY ARE NO 11. USED 7 DAYS IN ADVANCE AND THROUGHOUT THE DURATION OF THE LONGER NECESSARY. WHEN A SIGN IS COVERED, THE POST SHALL HAVE A REFLECTIVE 3" X 6" DELINEATOR INSTALLED. PROJECT.
- 12. THE CONTRACTOR SHALL CONTACT THE WILL COUNTY DIVISION OF 24. IMMEDIATELY AFTER THE COMPLETION OF CONSTRUCTION. THE TRANSPORTATION 7 WORKING DAYS PRIOR TO THE PLACEMENT OF ANY CONTRACTOR SHALL RESTORE ALL PERMANENT PAVEMENT MARKINGS, TEMPORARY TRAFFIC CONTROL DEVICES. SIGNS, AND OTHER TRAFFIC CONTROL DEVICES THAT WERE COVERED, REMOVED, DAMAGED, OR OTHERWISE AFFECTED BY CONSTRUCTION.
- 13. STAGED CONSTRUCTION SHALL NOT COMMENCE UNTIL ALL CONFLICTING SIGNS, PAVEMENT MARKINGS, AND TRAFFIC CONTROL 25. CONTRACTOR SHALL MAINTAIN ACCESS TO ALL DRIVEWAYS THAT DEVICES HAVE BEEN REMOVED OR COVERED AND TEMPORARY TRAFFIC CROSS WORK ZONES. CONTROL MEASURES HAVE BEEN PLACED TO THE SATISFACTION OF 26. EXCAVATION AND PAVEMENT WIDENING ON BOTH SIDES OF THE THE ENGINEER.
- PAVEMENT AT ANY ONE LOCATION AT THE SAME TIME WILL NOT BE 14. WORKERS SIGNS (W21-1a(0)-48) SHALL BE TAKEN DOWN OR COVERED PERMITTED PER ARTICLE 701.08 OF THE IDOT SPECS. WHEN WORKERS WILL NOT BE PRESENT FOR MORE THAN AN HOUR.

ITEM	UNIT	PRE-STAGE	STAGE 1	STAGE 2	STAGE 3	STAGE 4A	STAGE 4B	TOTAL
MARKING (70300100)	FOOT						2,791	2,791
ORT TERM PAVEMENT MARKING (70300100)         ORT TERM PAVEMENT MARKING REMOVAL (70300150)         MPORARY PAVEMENT MARKING         TTERS AND SYMBOLS - PAINT (70300211)         MP PVT MK L 4 PNT (70300221)         MP PVT MK L 6 PNT (70300241)         MP PVT MK L 12 PNT (70300261)         IP PVT MK L 4 TA TAPE (70307120)							2,791	2,791
	SQ FT		728	630	645	1,129	983	4,115
(70300221)	FOOT		38,842	38,530	36,972	28,839	23,331	166,514
(70300241)	FOOT		2,501	2,556	1,964	1,1503,917	4,188	15,126
T (70300261)	FOOT		2,192	1,891	1,804	1,504	1,188	8,579
PE (70307120)	FOOT		15,225	16,271	17,244	8,420	7,366	64,526
AP (70307160)	FOOT		1,141	1,116	993	318	235	3,803
MOVAL - WATER BLASTING (78300202)	SQ FT		20,685					20,685
(Z0062456)	SQ YD	3,007						3,007
MOVAL - GRINDING (78300201)	SQ FT		21,574	21,493	21,088	14,424	11,765	90,344
			FFIC CONTI				COUNTY	TOTAL SHEET SHEETS NO. 356 76
SCALE: N.T.S. SHEET 1 OF 28	SHEETS ST	4. N/A	TO STA. N/	A	CONTRACT NO. 61D			
	MARKING (70300100) MARKING REMOVAL (70300150) MARKING - PAINT (70300211) (70300221) (70300241) T (70300261) PE (70307120) AP (70307160) MOVAL - WATER BLASTING (78300202) (20062456) MOVAL - GRINDING (78300201) SUGGESTED STAGES OF CON GENI	MARKING (70300100)         FOOT           MARKING REMOVAL (70300150)         S0 FT           MARKING         S0 FT           - PAINT (70300211)         S0 FT           (70300221)         FOOT           (70300241)         FOOT           T (70300261)         FOOT           PE (70307120)         FOOT           AP (70307160)         FOOT           MOVAL - WATER BLASTING (78300202)         S0 FT           (20062456)         S0 YD           MOVAL - GRINDING (78300201)         S0 FT           SUGGESTED STAGES OF CONSTRUCTION           GENERAL NOTE	MARKING (70300100)         FOOT           MARKING REMOVAL (70300150)         SQ FT           MARKING         SQ FT           - PAINT (70300211)         SQ FT           (70300221)         FOOT           (70300241)         FOOT           T (70300261)         FOOT           PE (70307120)         FOOT           AP (70307160)         FOOT           MOVAL - WATER BLASTING (78300202)         SQ FT           (20062456)         SQ YD           MOVAL - GRINDING (78300201)         SQ FT           SUGGESTED STAGES OF CONSTRUCTION AND TRAI	MARKING (70300100)         FOOT           MARKING REMOVAL (70300150)         SQ FT           MARKING - PAINT (70300211)         SQ FT           (70300221)         FOOT           (70300221)         FOOT           (70300241)         FOOT           T (70300261)         FOOT           PE (70307120)         FOOT           AP (70307160)         FOOT           MATER BLASTING (78300202)         SQ FT           (20062456)         SQ YD           MOVAL - GRINDING (78300201)         SQ FT           SUGGESTED STAGES OF CONSTRUCTION AND TRAFFIC CONTI	MARKING (70300100)         FOOT         Image: Construction and traffic control           MARKING (70300100)         S0 FT         Image: Construction and traffic control         630           MARKING - PAINT (70300211)         S0 FT         728         630           (70300221)         F00T         38,842         38,530           (70300241)         F00T         2,501         2,556           T (70300261)         F00T         2,192         1,891           PE (70307120)         F00T         15,225         16,271           AP (70307160)         F00T         1,141         1,116           MOVAL - WATER BLASTING (78300202)         S0 FT         20,685         1           SUGGESTED STAGES OF CONSTRUCTION AND TRAFFIC CONTROL GENERAL NOTES         Fring of the second s	MARKING (70300100)         FOOT         Image: Construction and traffic control         Image: Construction and traffic control contrent         Image: Contrent <tht< td=""><td>MARKING (70300100)         F00T         Image: construction of the second second</td><td>MARKING (70300100)         FOOT         Image: Solar state st</td></tht<>	MARKING (70300100)         F00T         Image: construction of the second	MARKING (70300100)         FOOT         Image: Solar state st


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PLOT DATE = 2/14/2024	DATE - 02/14/2024	REVISED -	CHICAGO, ILLINOIS FAX 312 559 1217 60661-1259 WEB www.epsteinglobel.com		SCALE: N.T.S.	SHEET 1 OF 28 SHEE

- 19. ALL CONFLICTING TRAFFIC SIGNS SHALL BE COVERED AS DIRECTED BY THE ENGINEER. THIS WORK SHALL BE INCLUDED IN THE COST OF TRAFFIC CONTROL AND PROTECTION (SPECIAL).
- 20. THE CONTRACTOR SHALL PROVIDE ADVANCE NOTICE CONSTRUCTION SIGNING. SIGNS SHALL BE ERECTED ONE WEEK IN ADVANCE OF THE START OF CONSTRUCTION AND SHALL BE REMOVED OR COVERED WHEN PROTECTION IS NOT REQUIRED.
- 21. THE CONTRACTOR SHALL BE RESPONSIBLE FOR ENSURING EXISTING AND/OR PROPOSED DRAINAGE AND ROADWAY LIGHTING ARE MAINTAINED DURING THE DURATION OF THE PROJECT.


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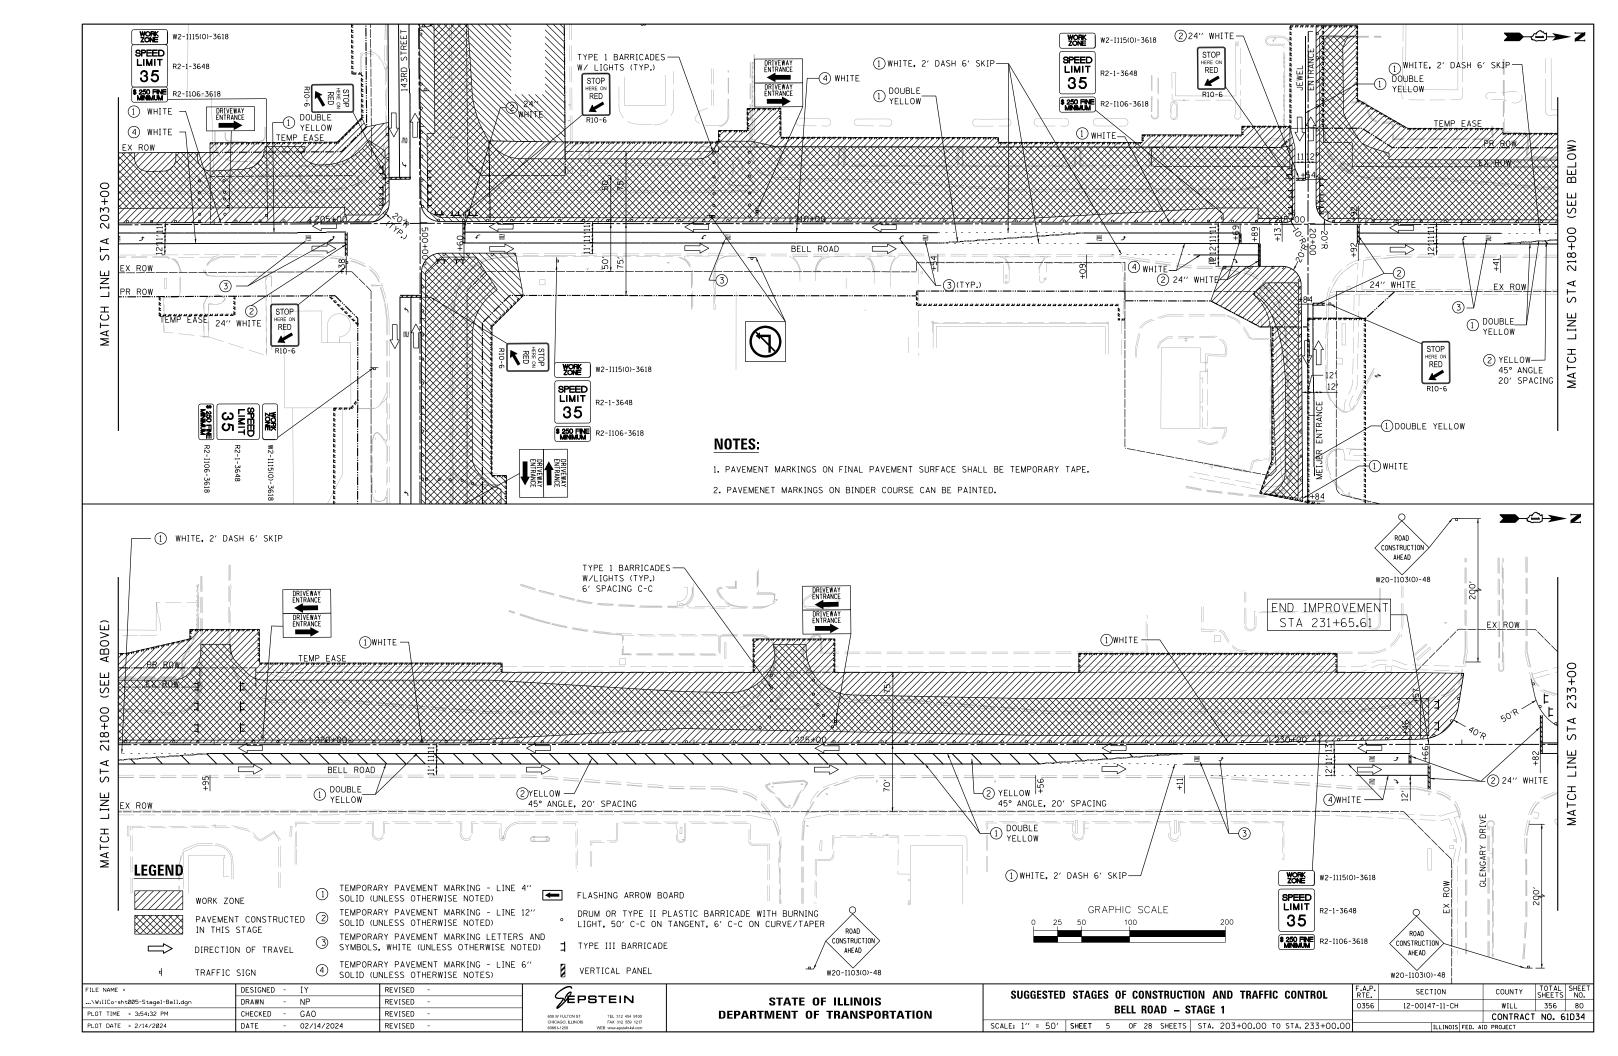


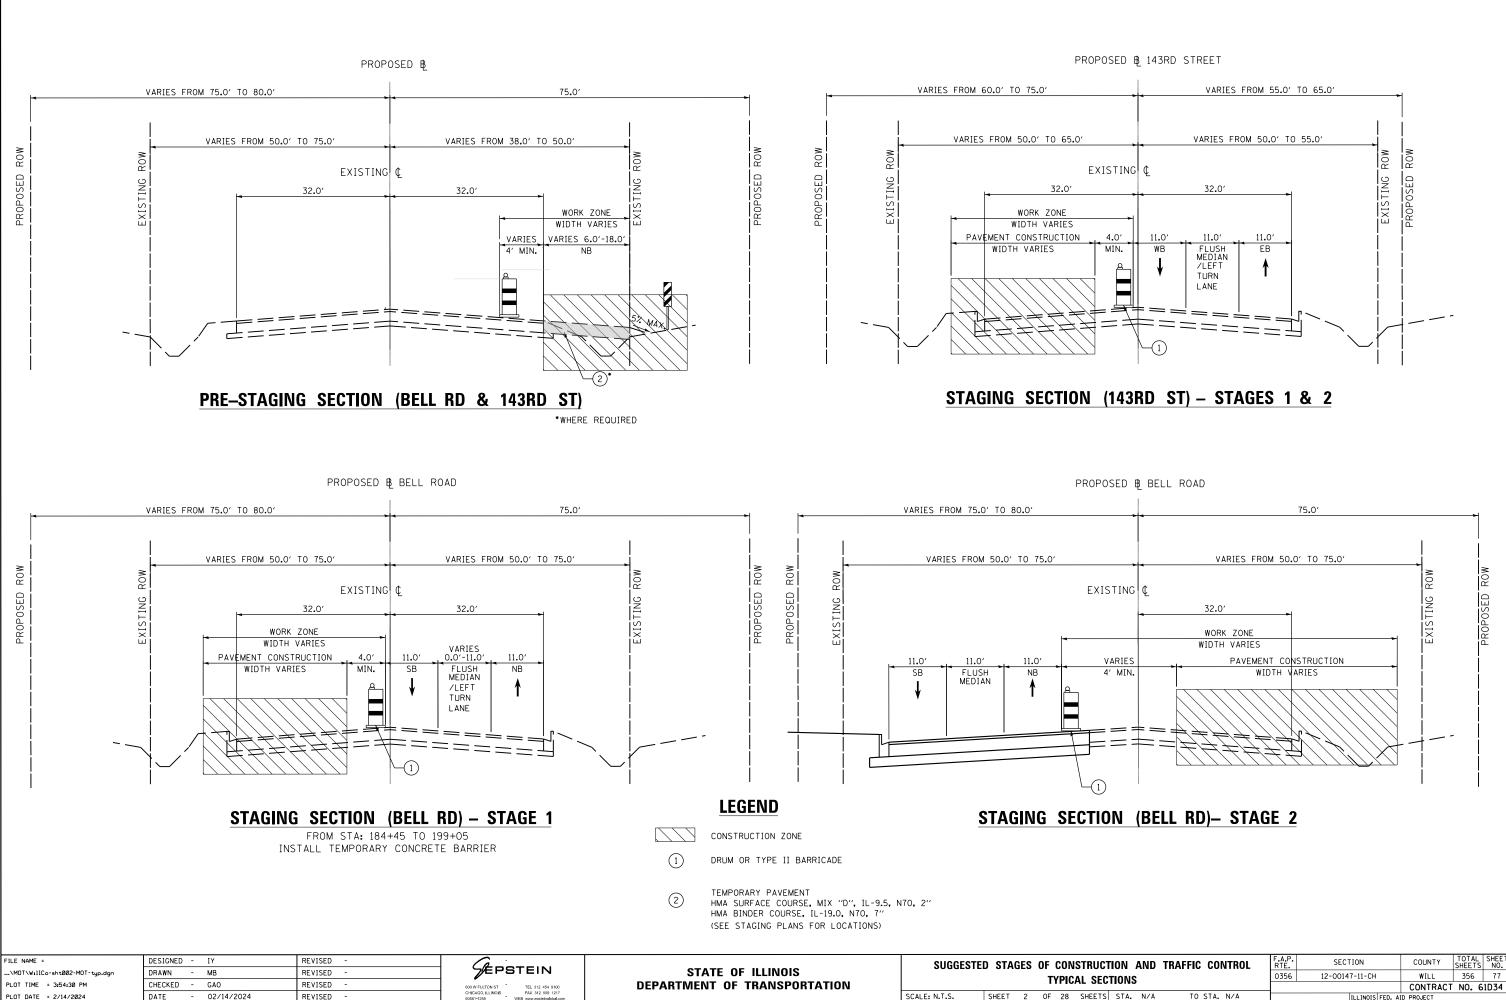
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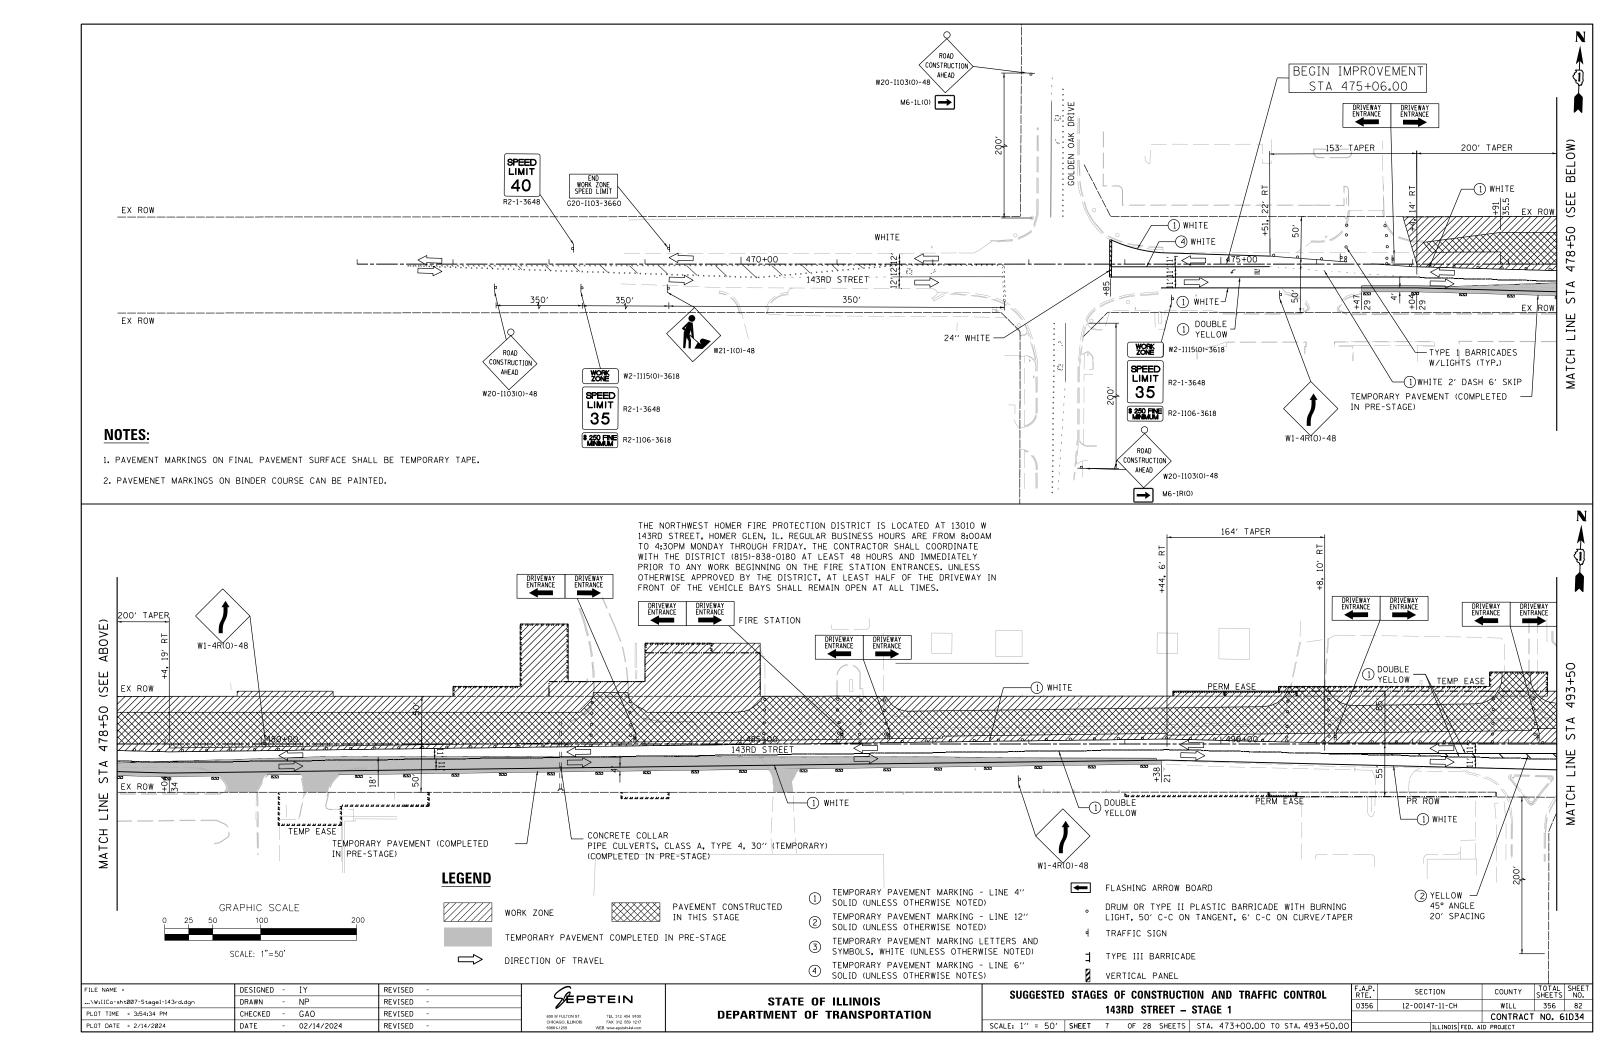



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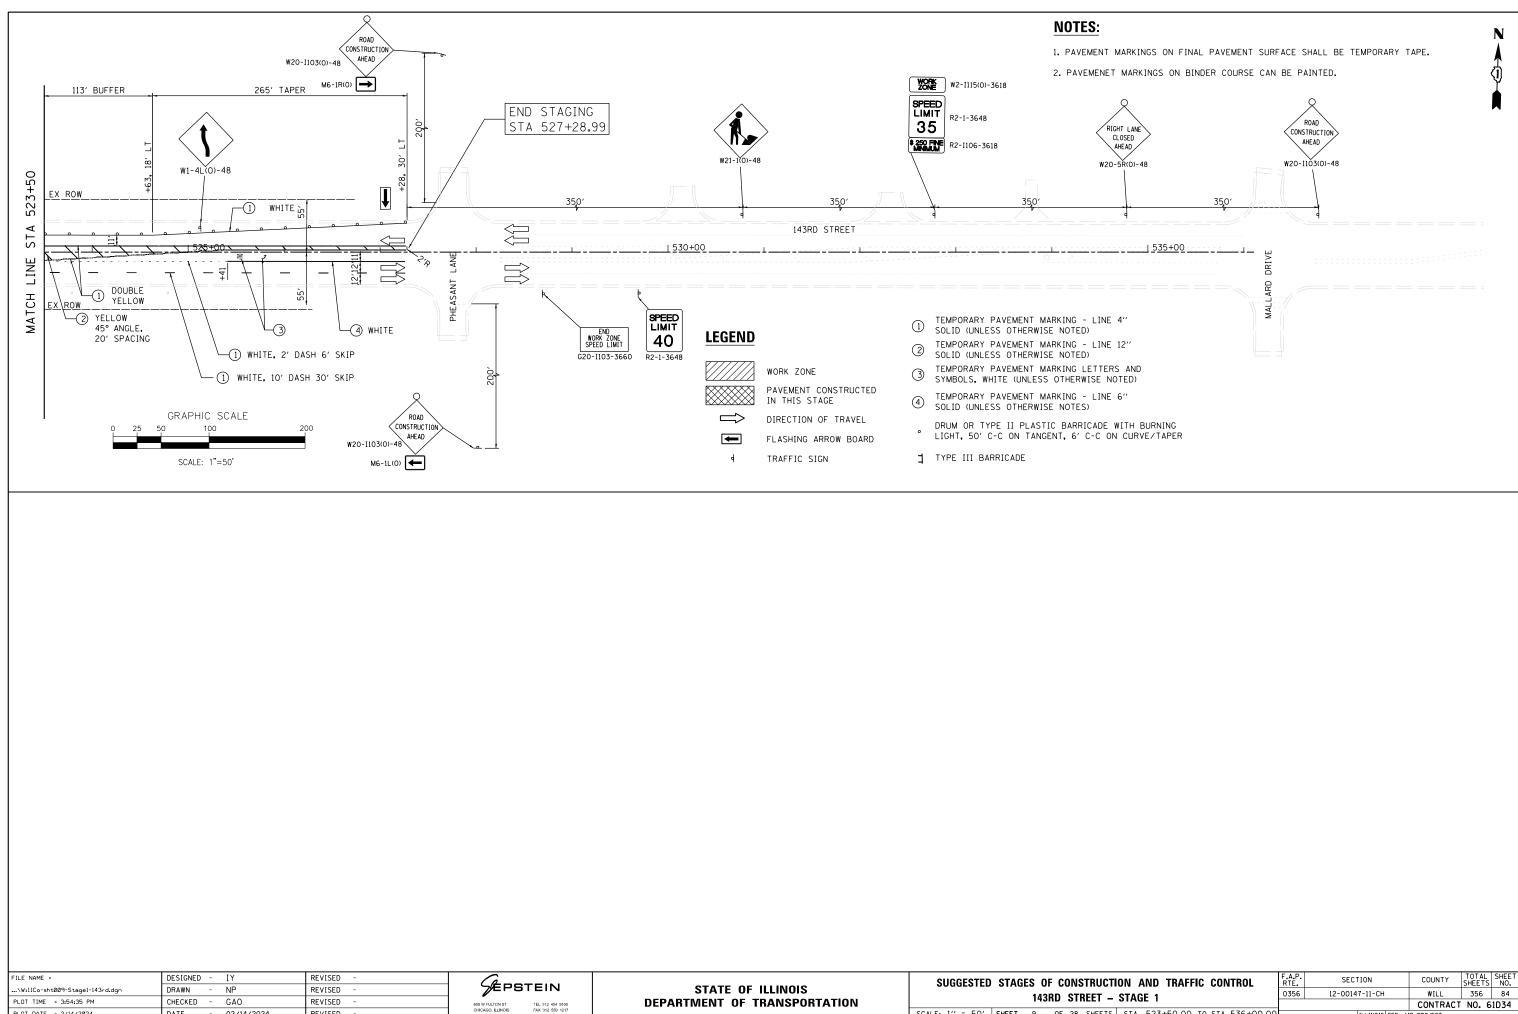
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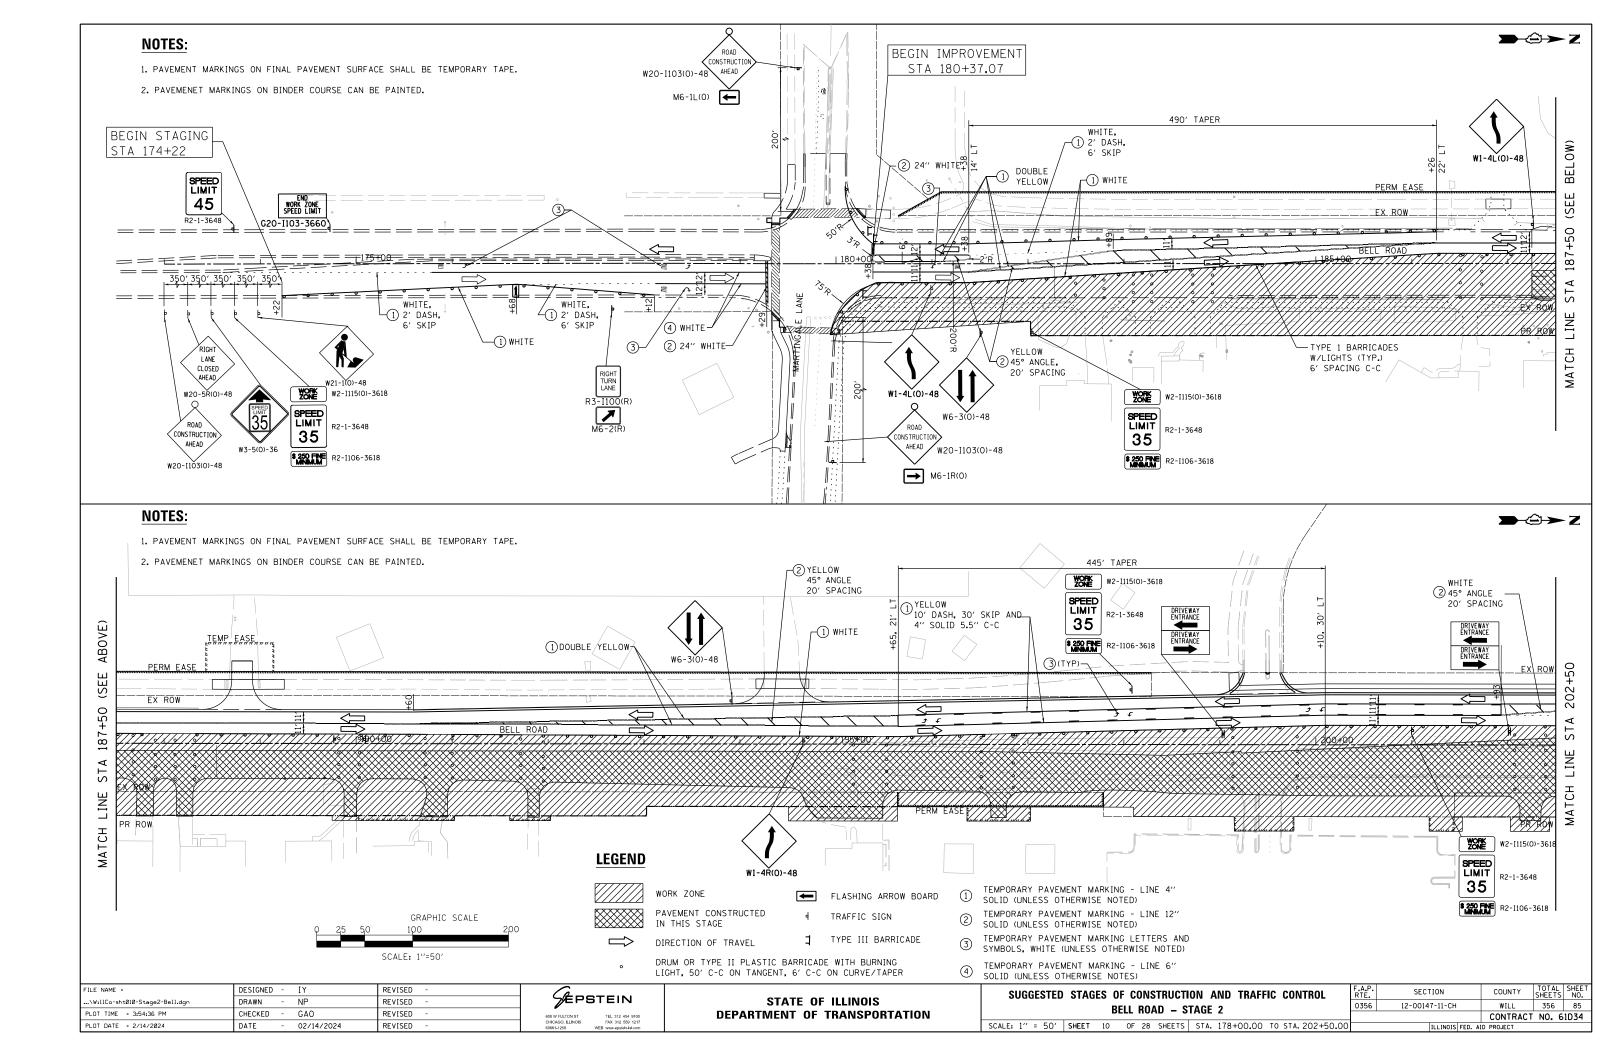


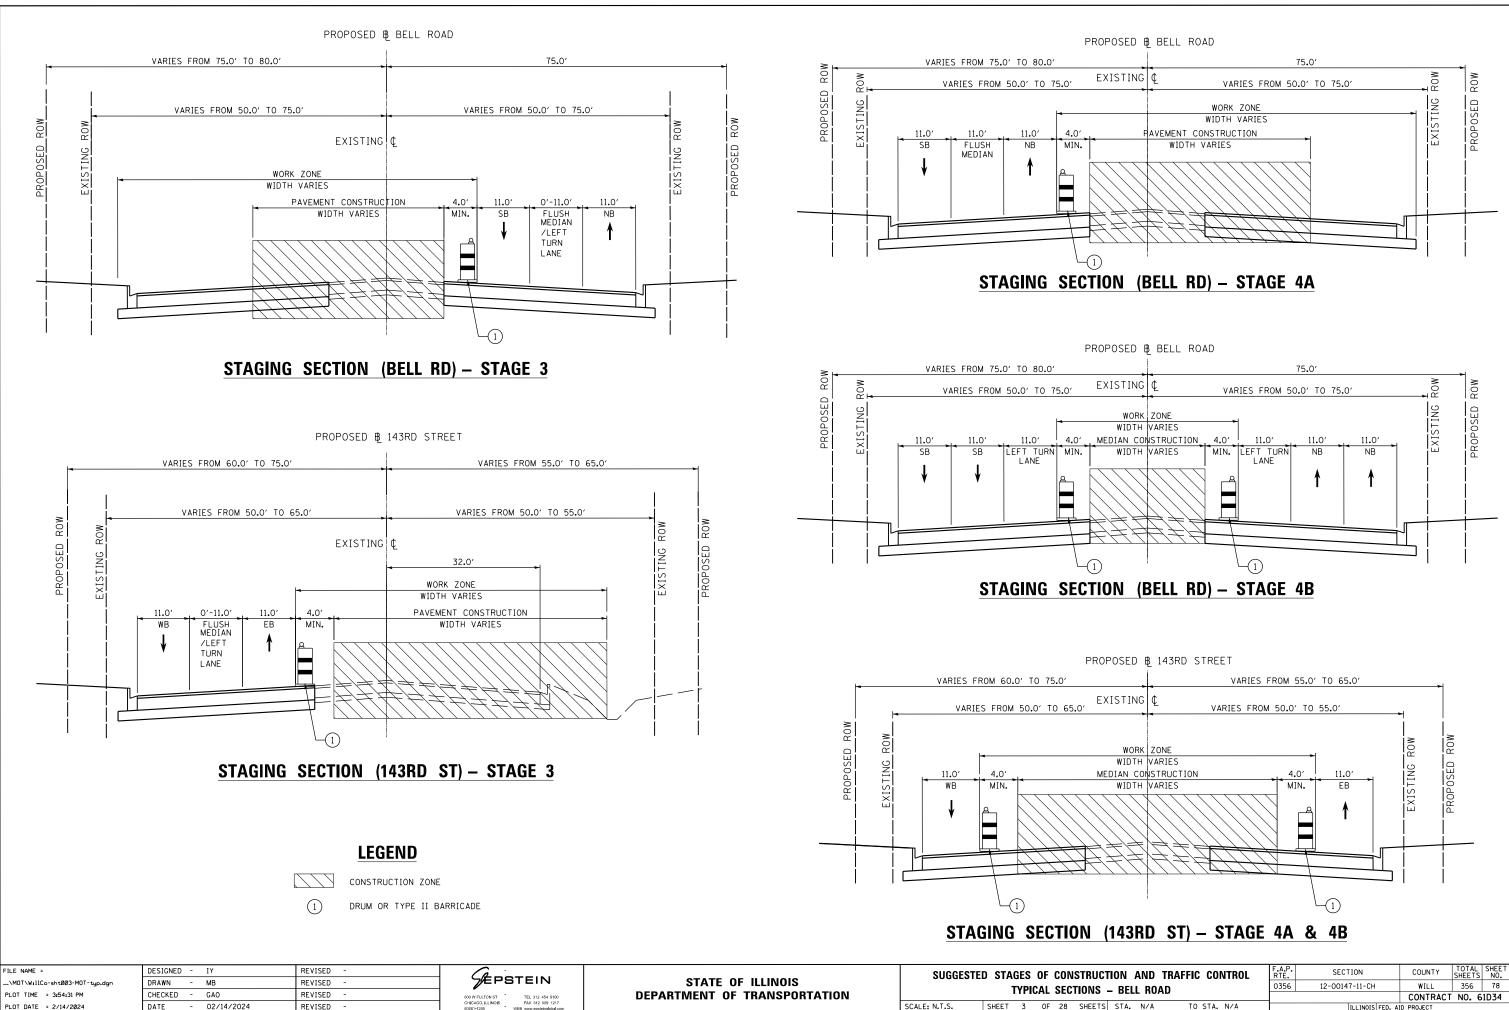
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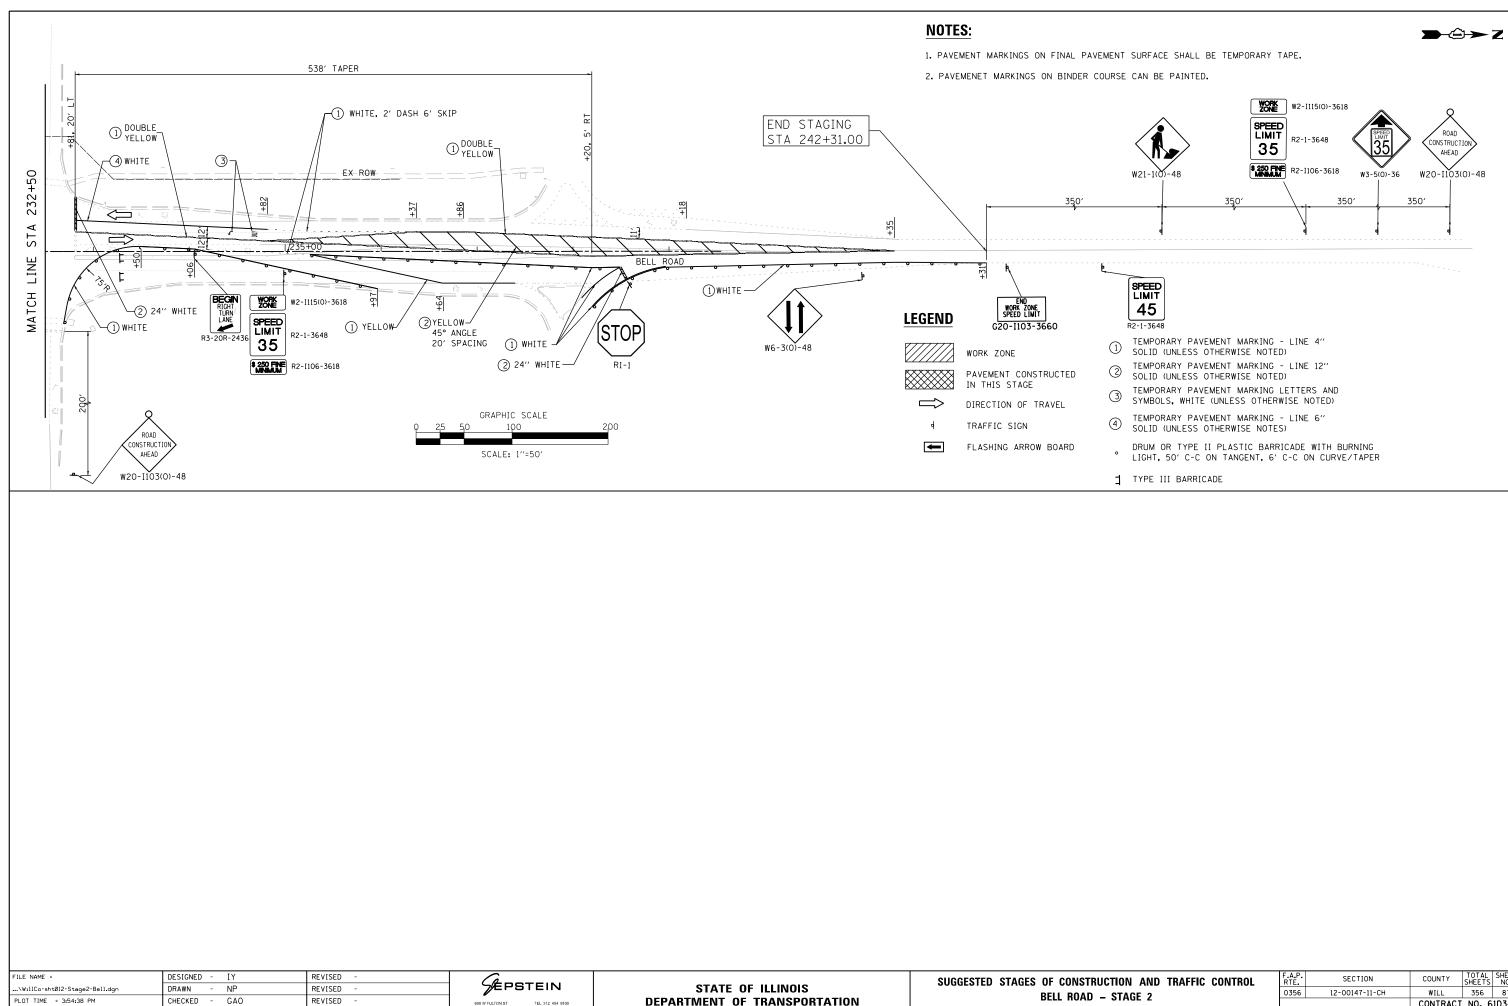
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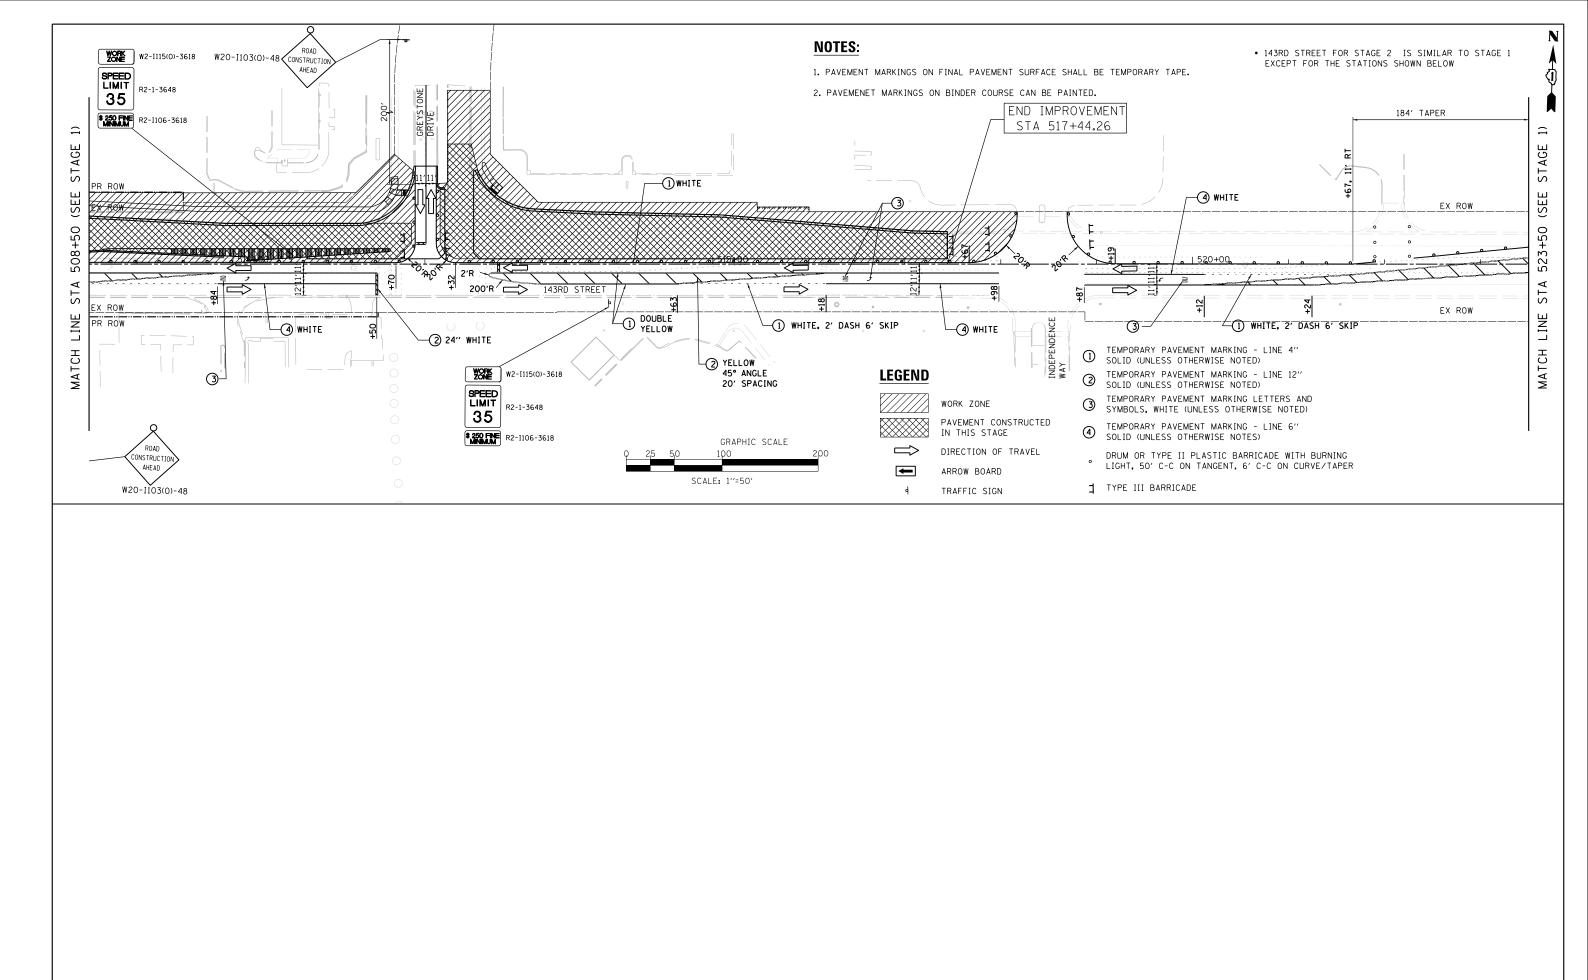
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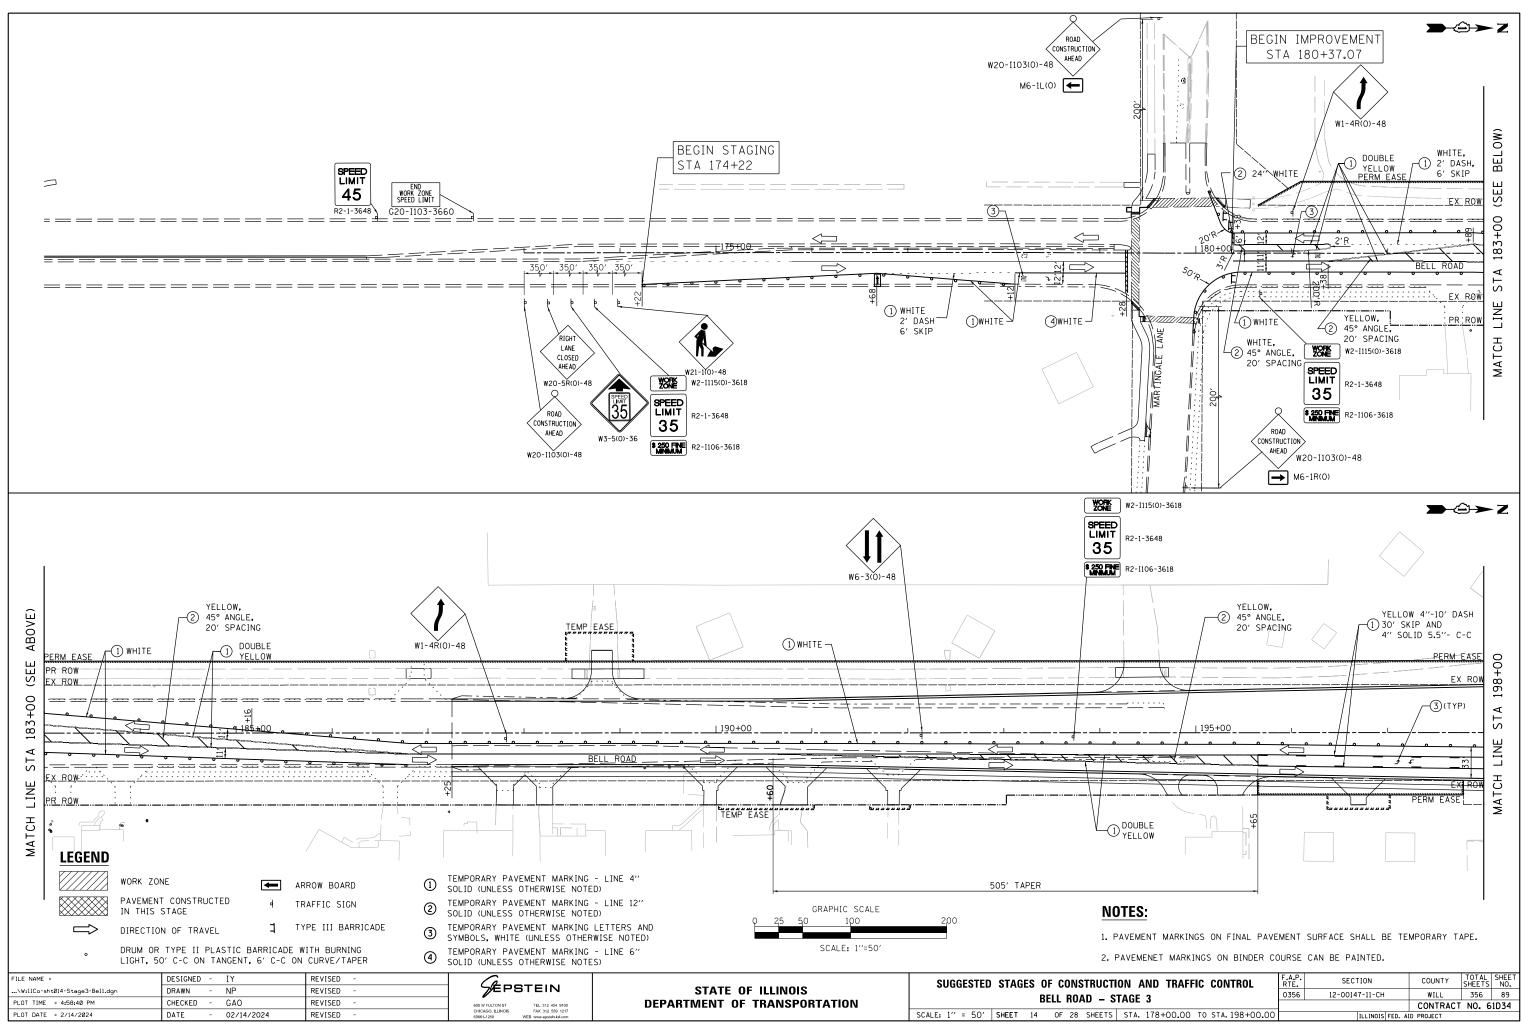
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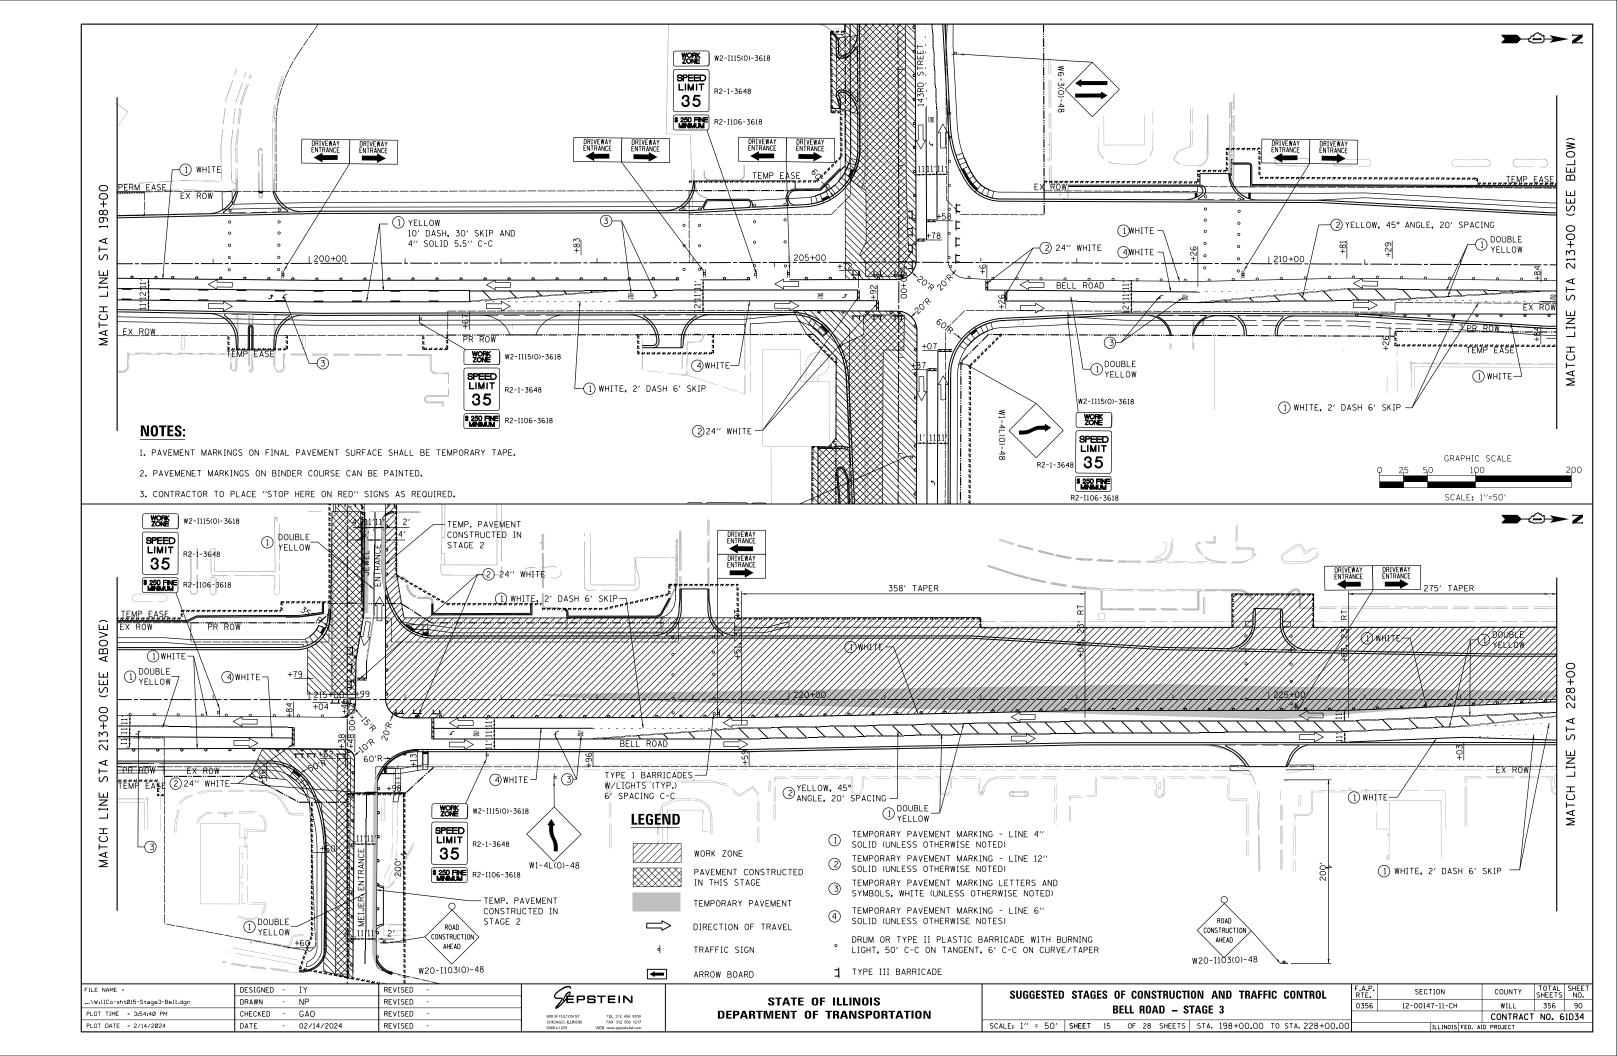
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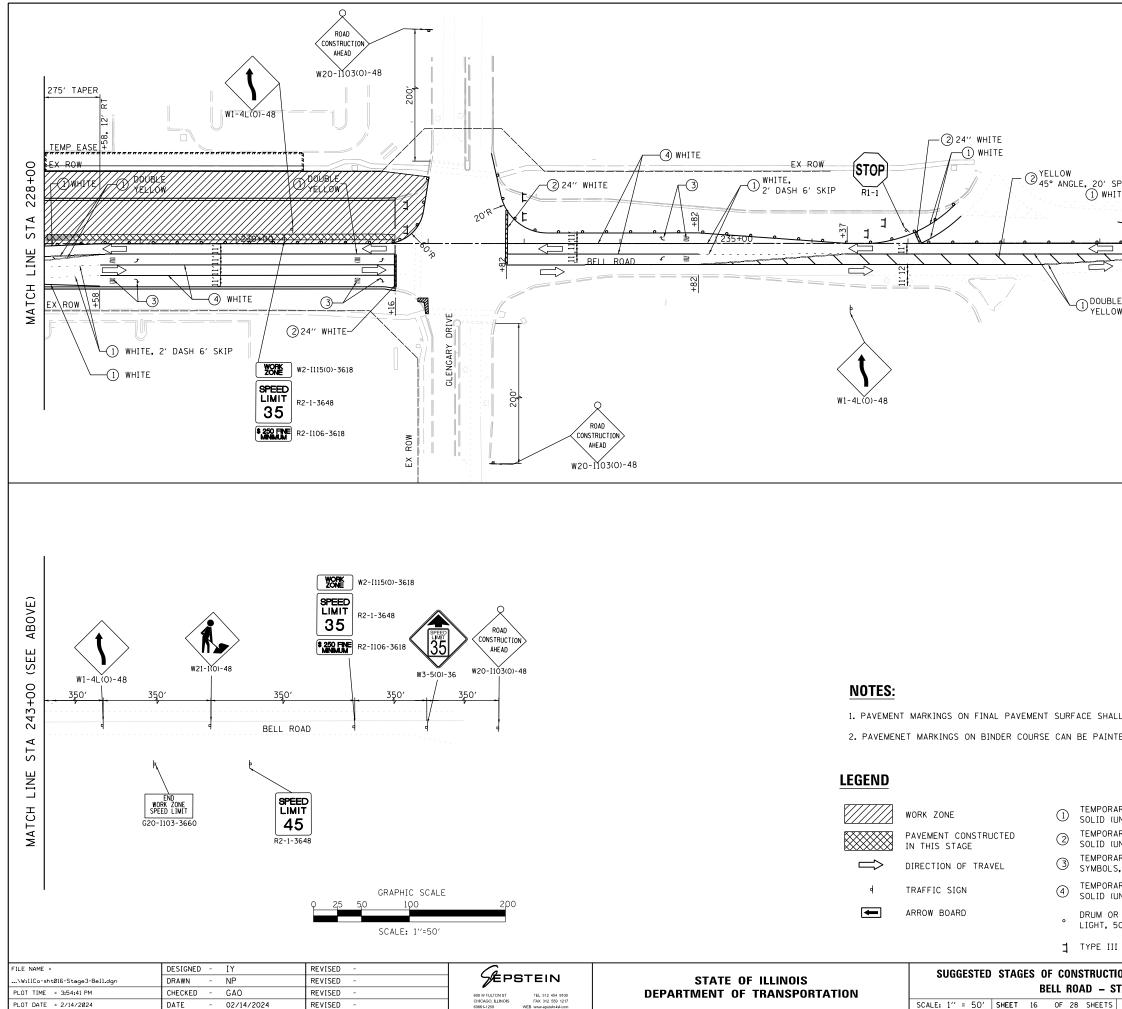


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\WillCo-sht0l3-Stage2-143rd.dgn	DRAWN - NP	REVISED -		STATE OF ILLINOIS	143RD STREET – STAGE 2	0356	12-00147-11-CH	WILL 35	6 88
PLOT TIME = 3:54:38 PM	CHECKED - GAO	REVISED -	600 W FULTON ST TEL 312 454 9100 CHICAGO, ILLINOIS FAX 312 559 1217	DEPARTMENT OF TRANSPORTATION		_		CONTRACT NO	. 61D34
PLOT DATE = 2/14/2024	DATE - 02/14/2024	REVISED -	60661-1259 WEB www.epstein-isl.com		SCALE: 1" = 50' SHEET 13 OF 28 SHEETS STA. 493+00.00 TO STA. 523+00.0	10	ILLINOIS FED. AI	ID PROJECT	

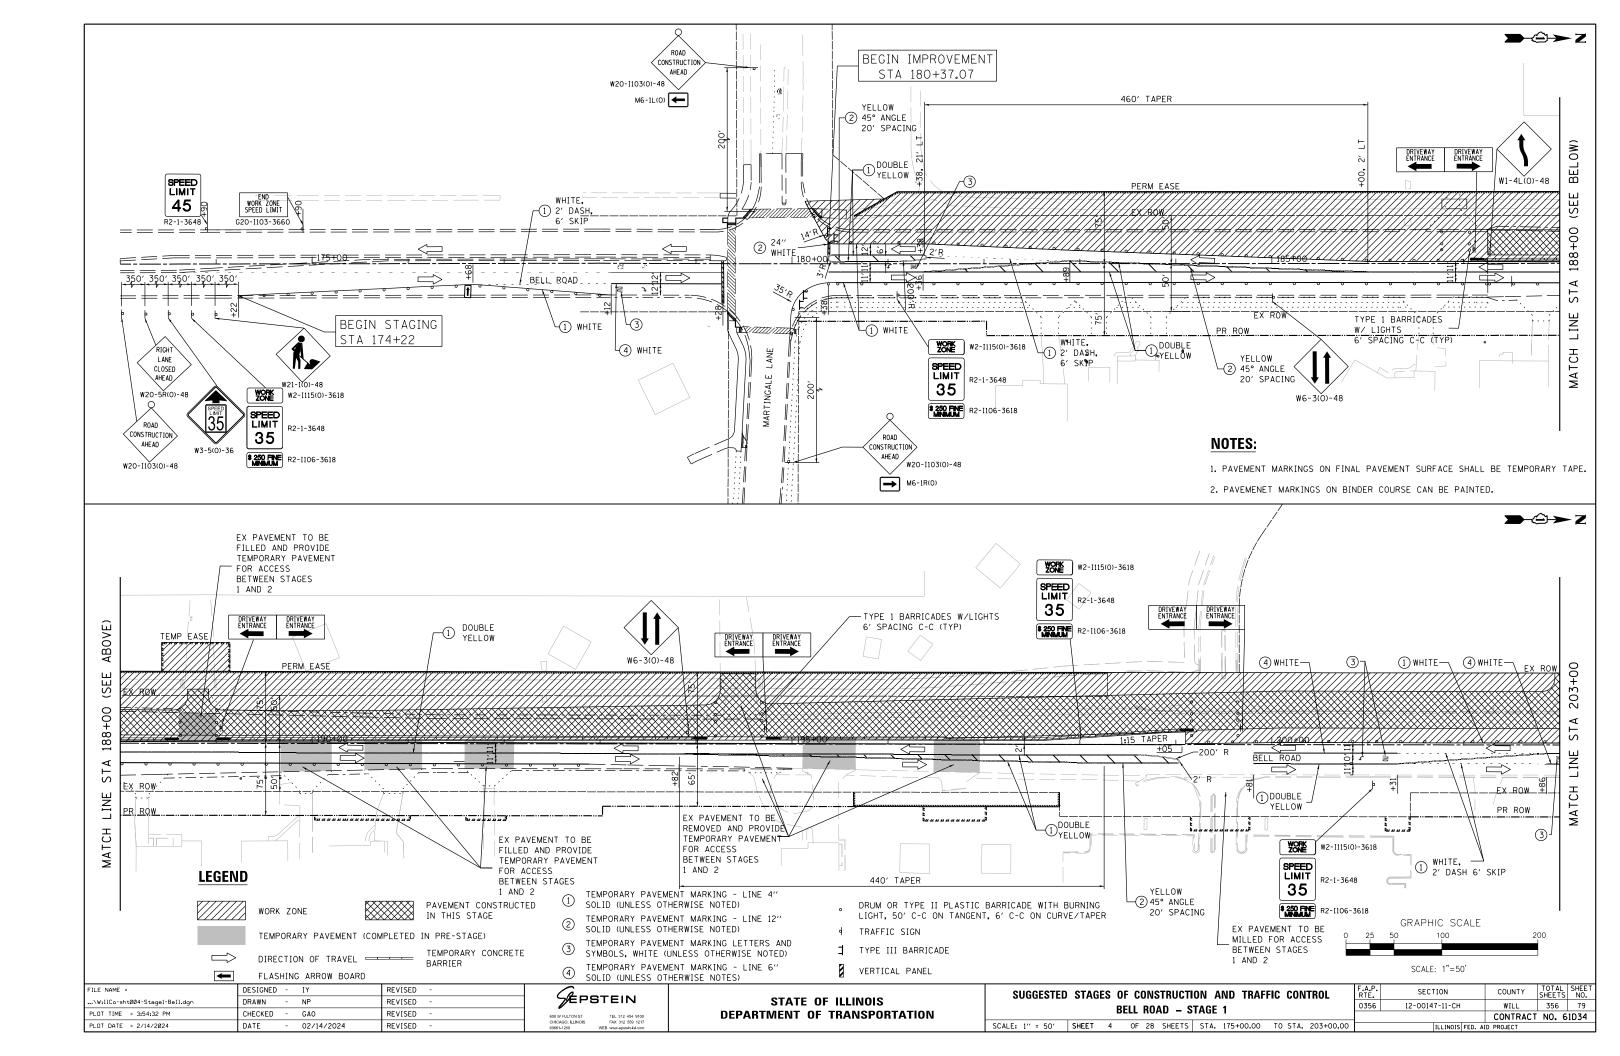

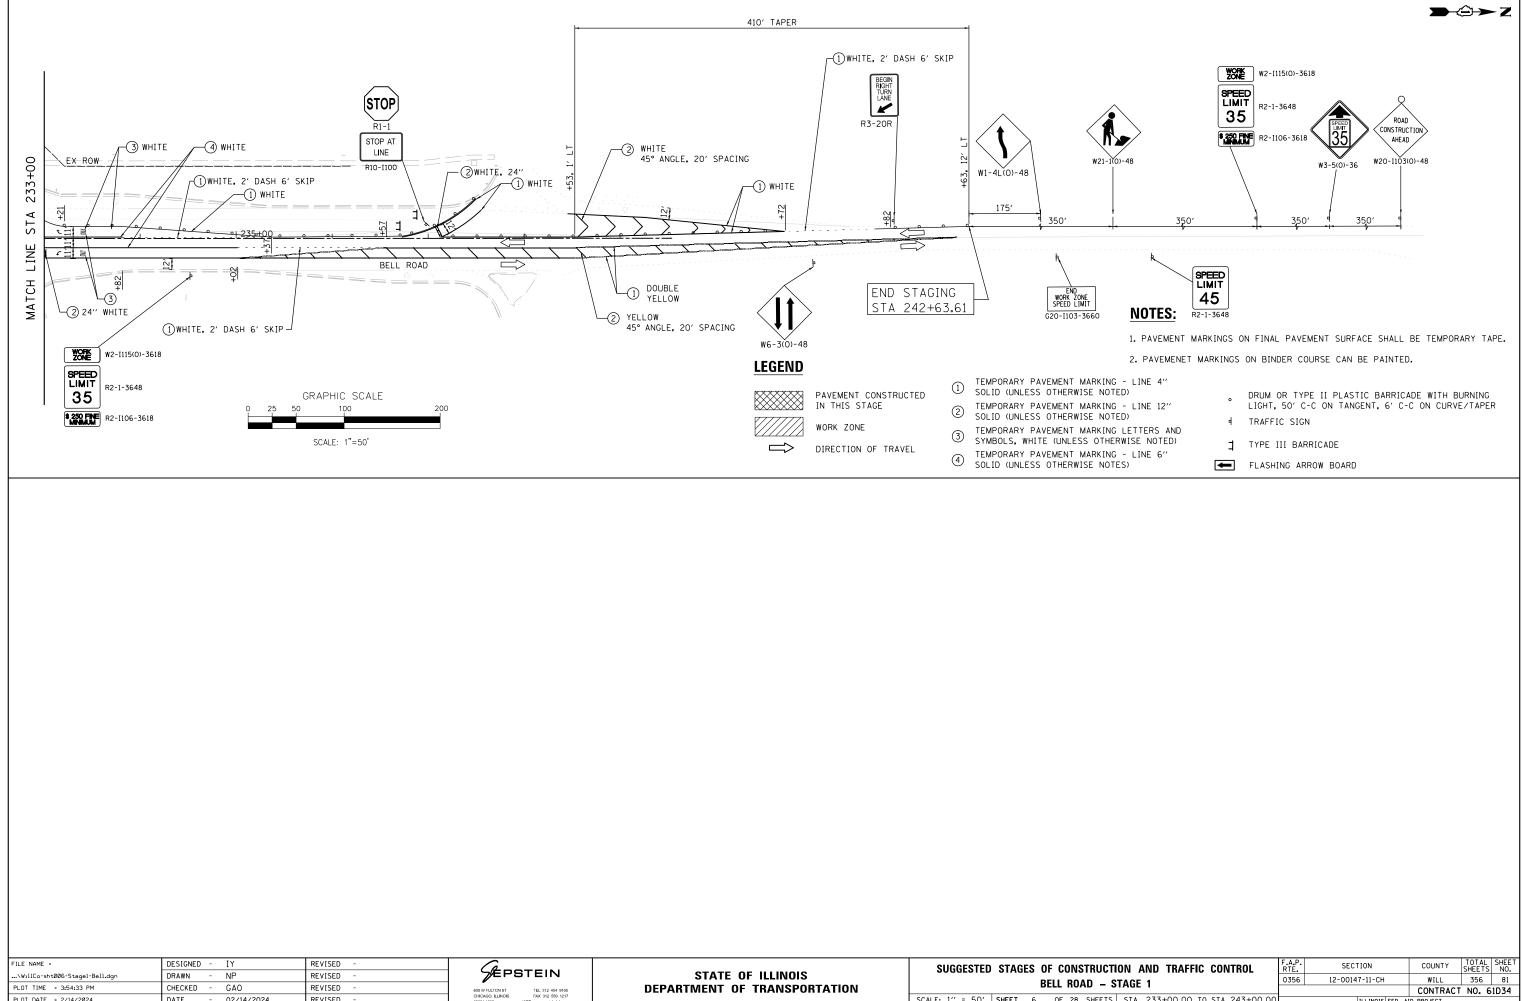
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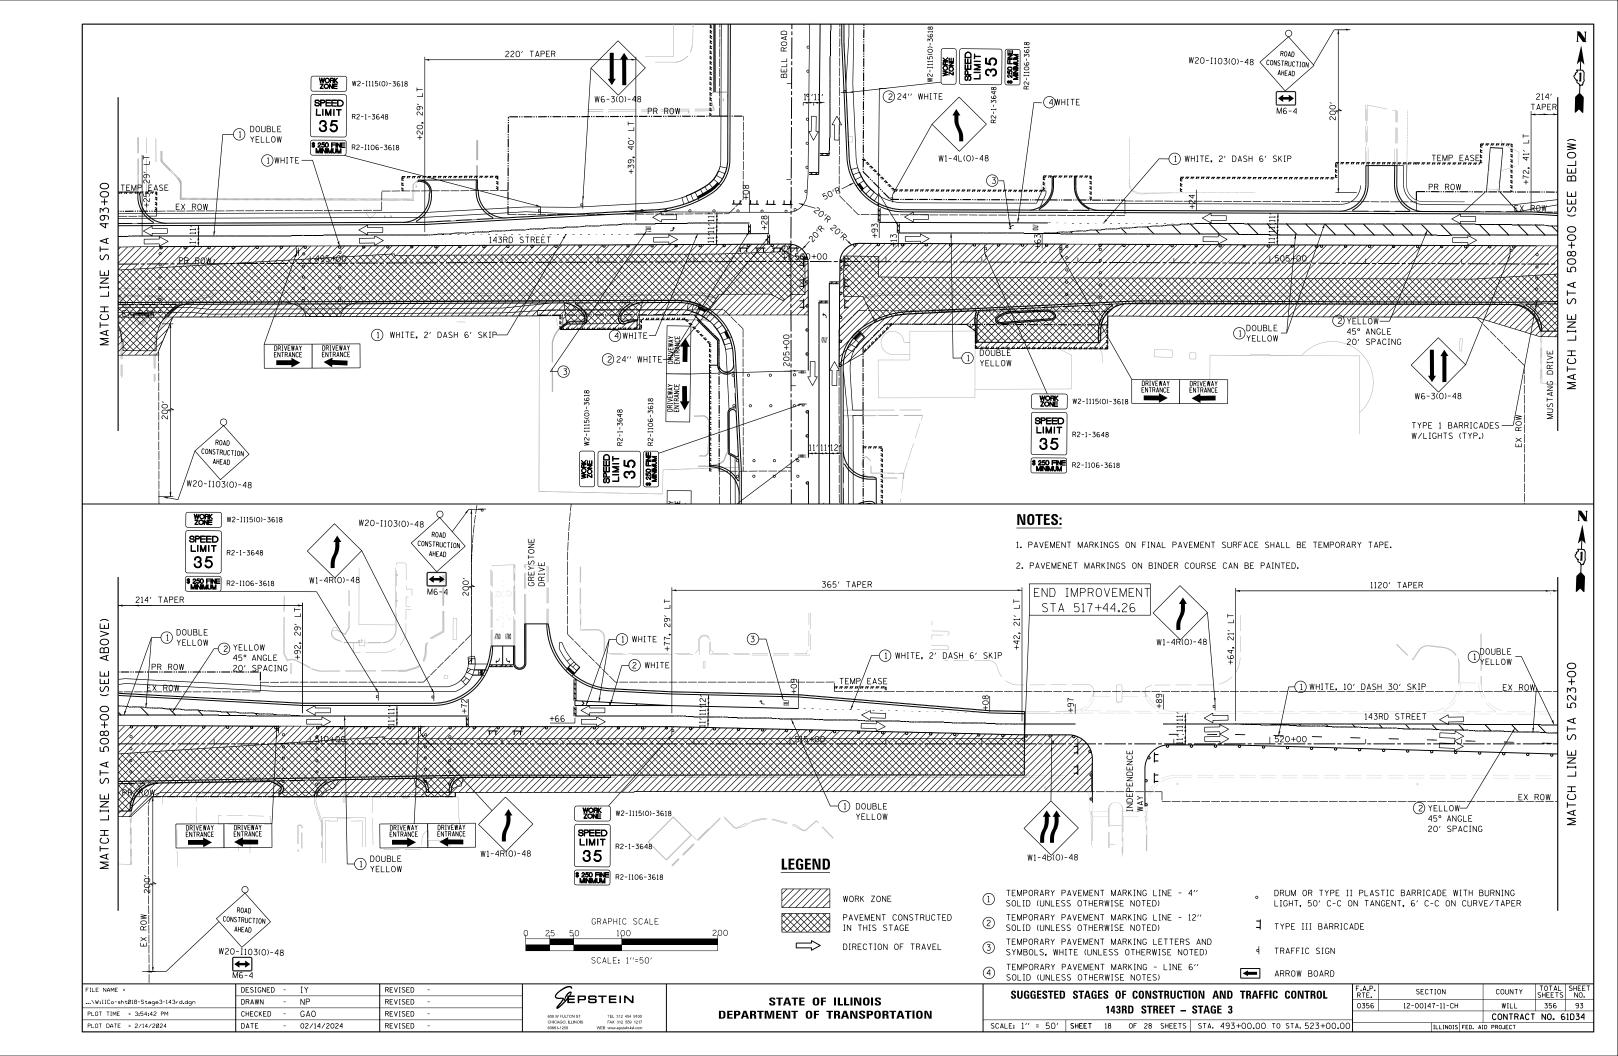


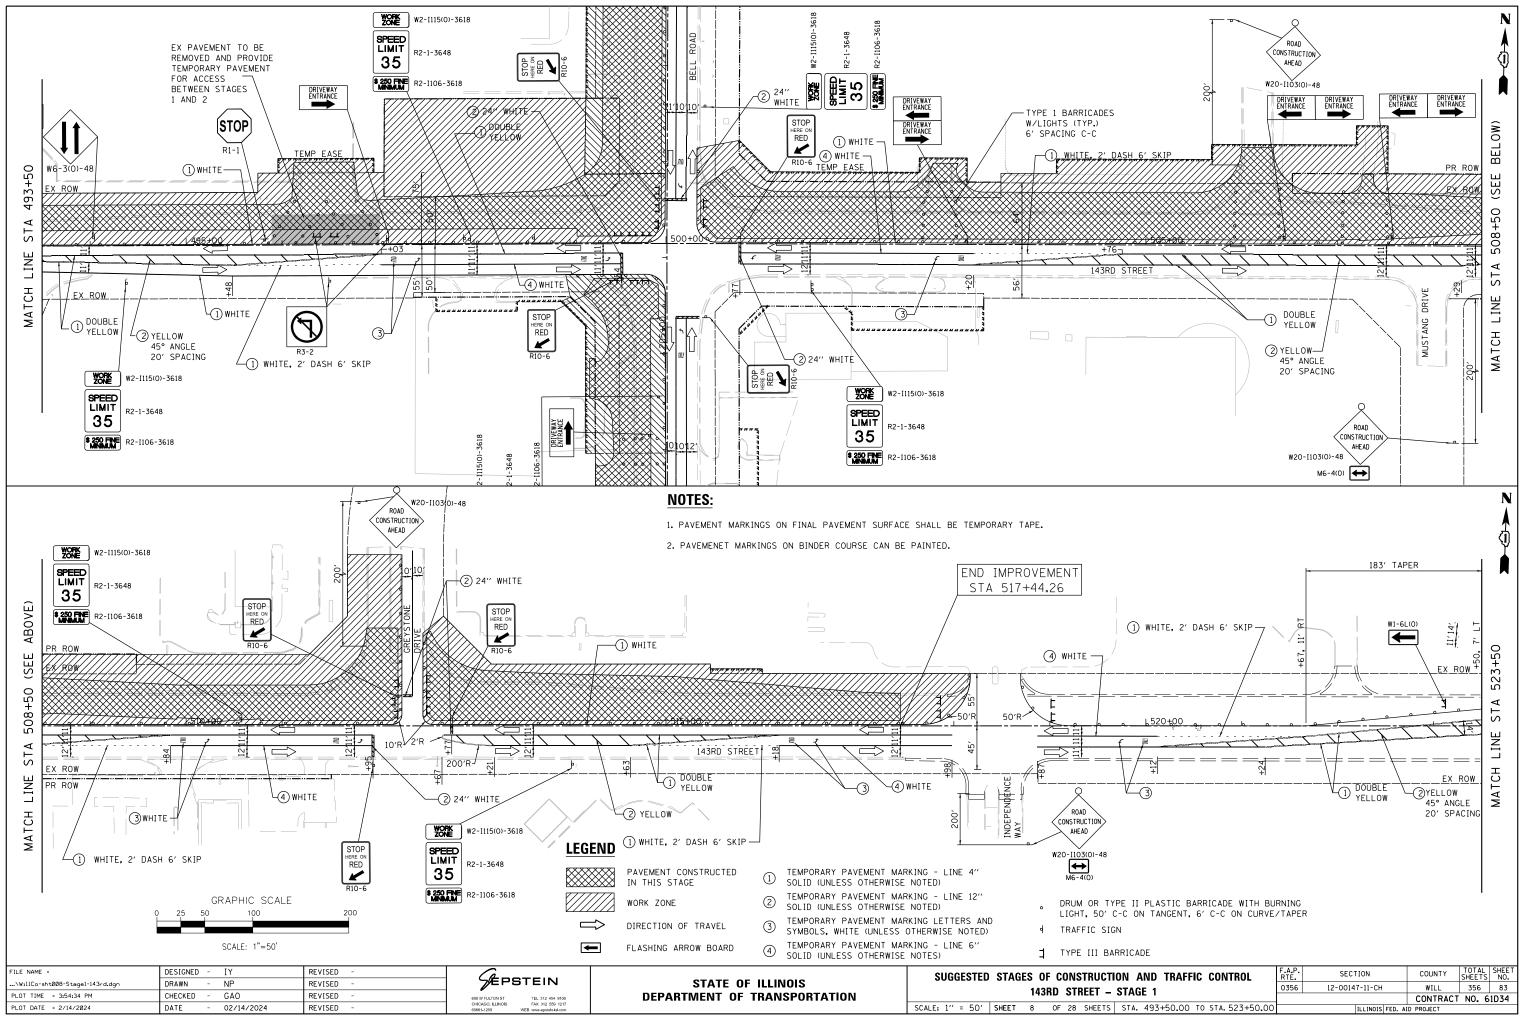


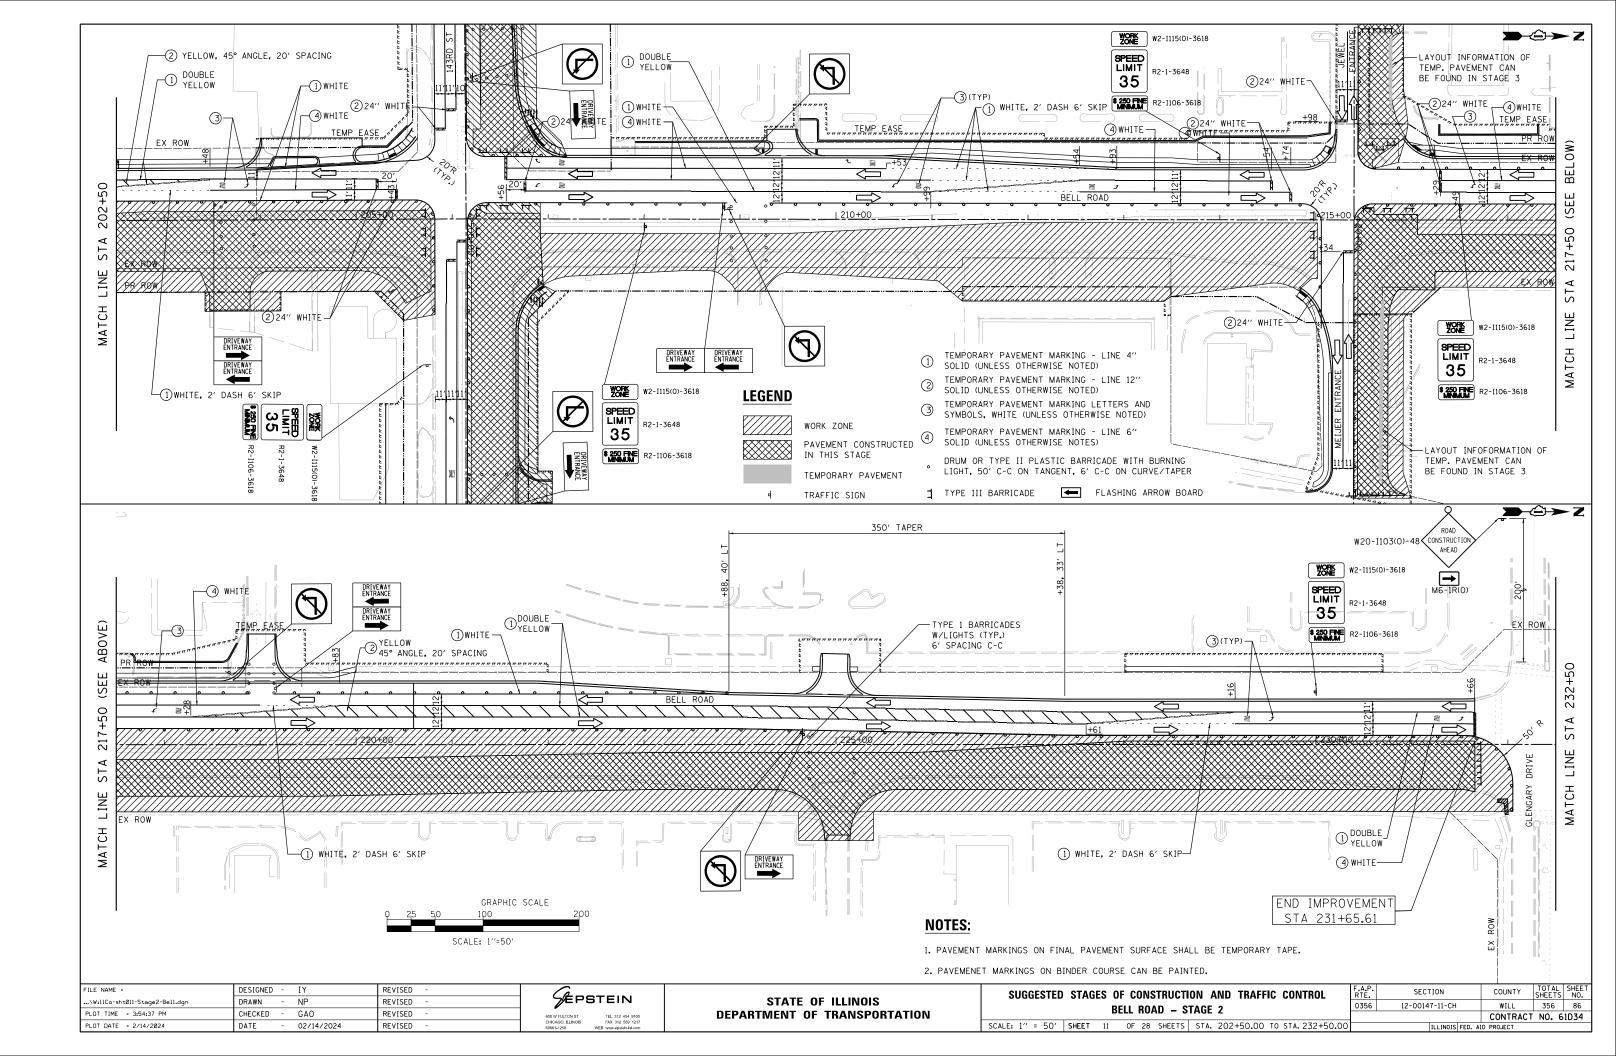
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				<b>_</b>	→Z
HALL BE TEMPORARY TAPE.					
INTED.					
ORARY PAVEMENT MARKING - LINE 4" ) (UNLESS OTHERWISE NOTED) ORARY PAVEMENT MARKING - LINE 12" ) (UNLESS OTHERWISE NOTED) ORARY PAVEMENT MARKING LETTERS AN OLS, WHITE (UNLESS OTHERWISE NOTED ORARY PAVEMENT MARKING - LINE 6" ) (UNLESS OTHERWISE NOTES) OR TYPE II PLASTIC BARRICADE WITH ", 50' C-C ON TANGENT, 6' C-C ON CU III BARRICADE	)   BURNIN				
CTION AND TRAFFIC CONTROL - Stage 3	F.A.P. RTE. 0356	SECTION	сн	COUNTY	TOTAL SHEET SHEETS NO. 356 91
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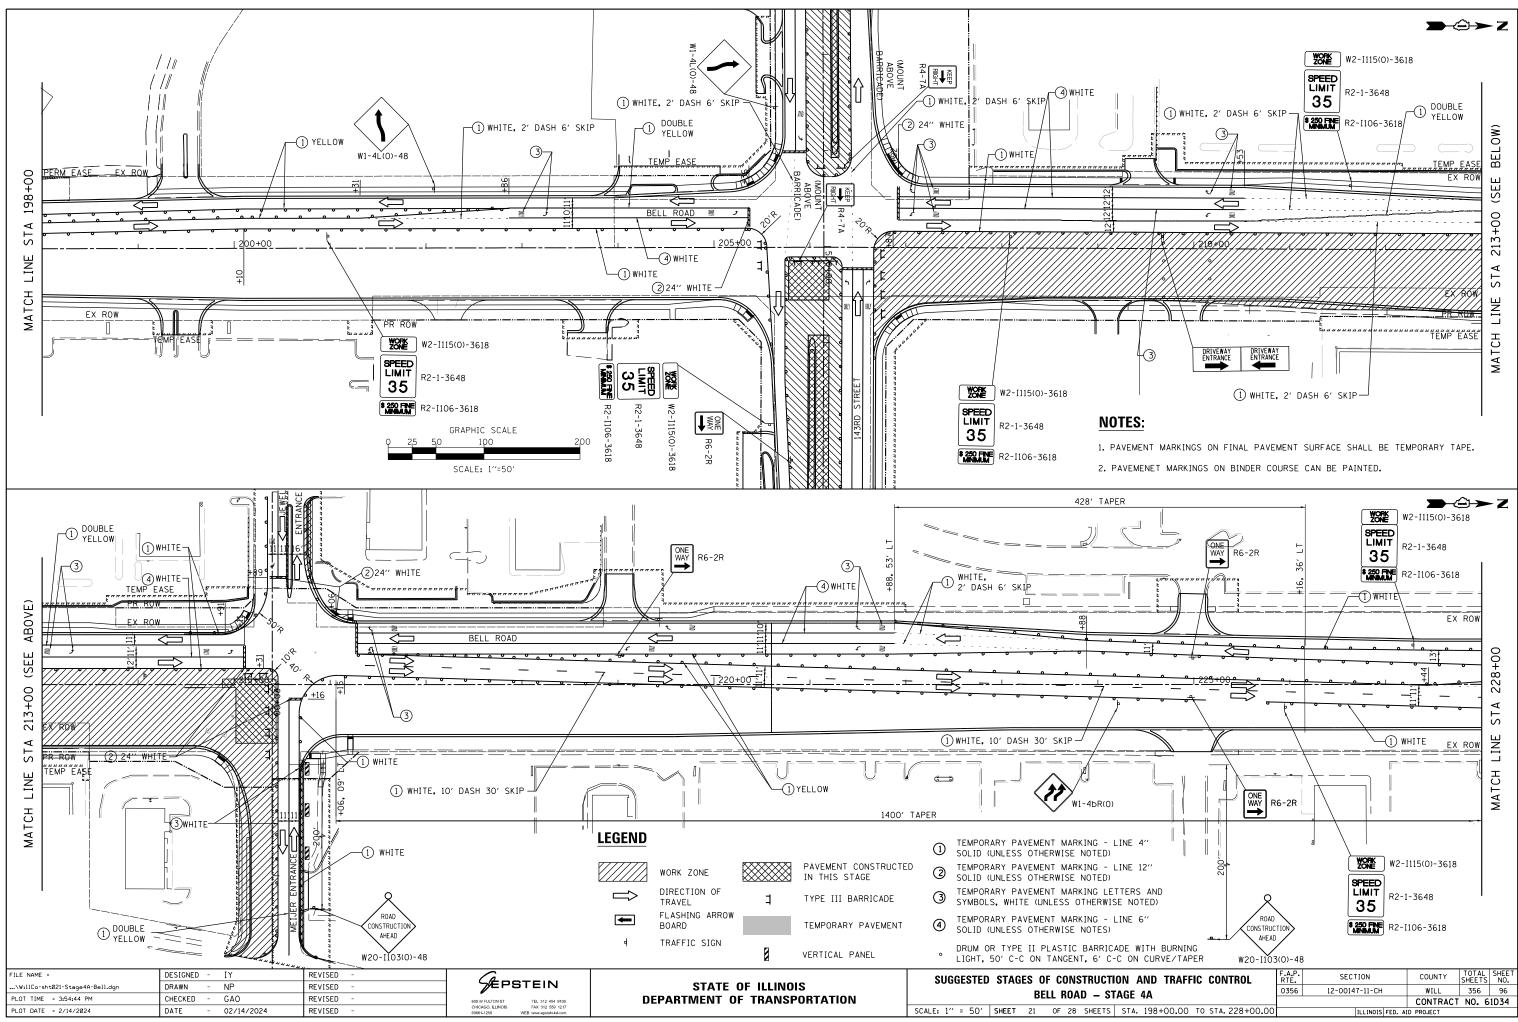
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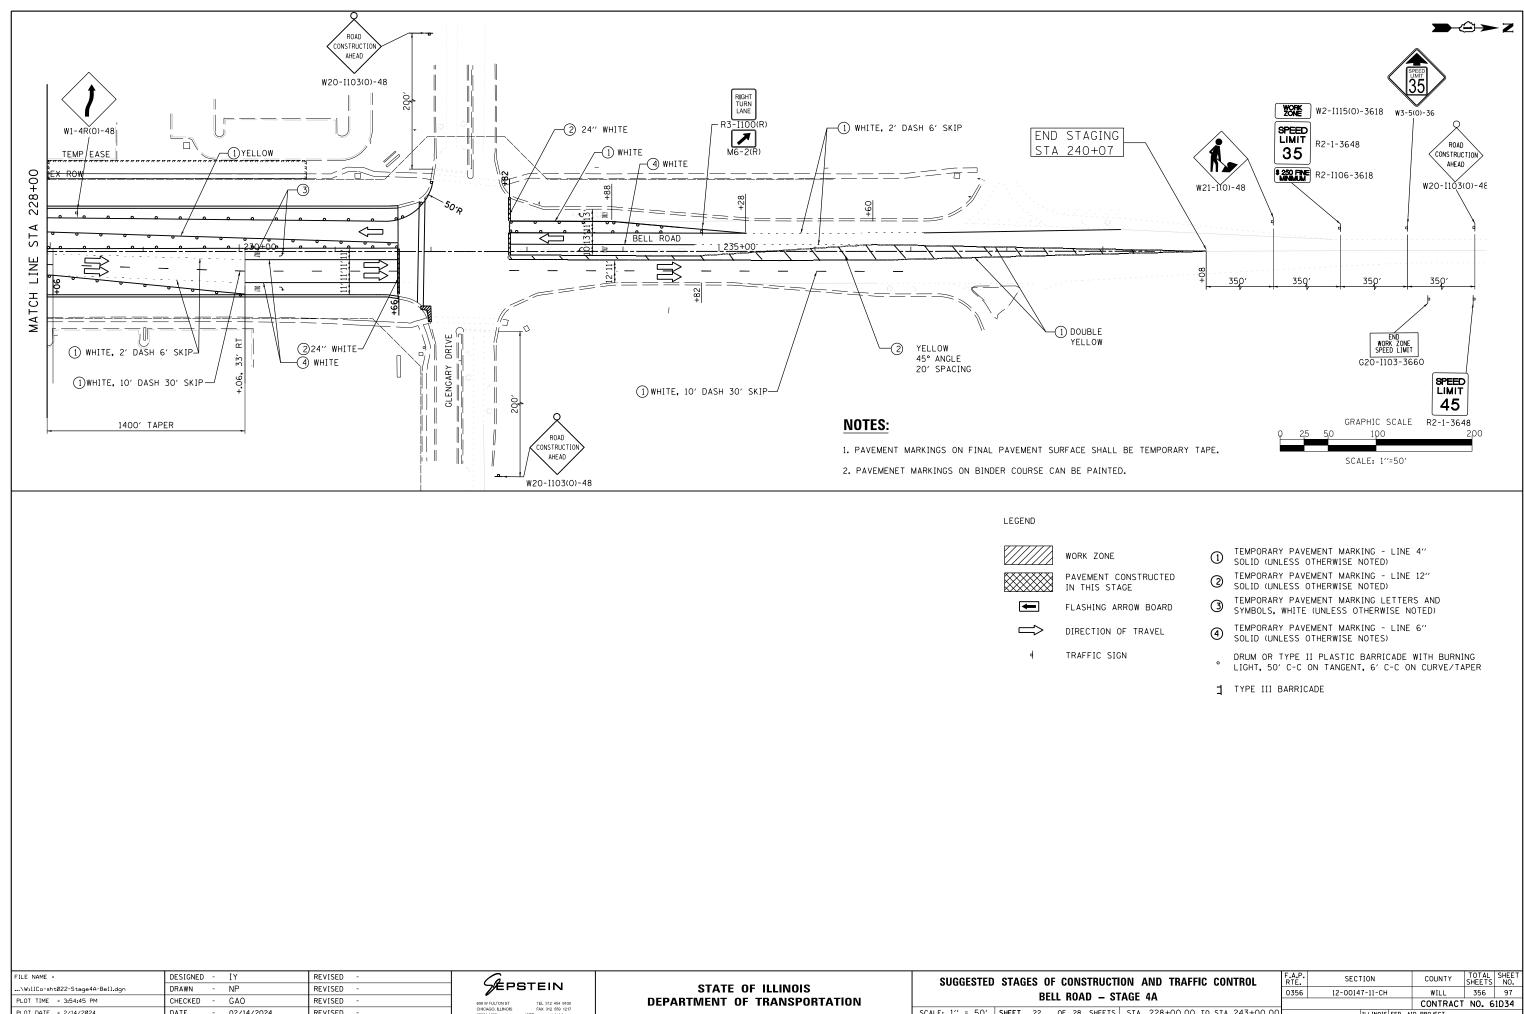






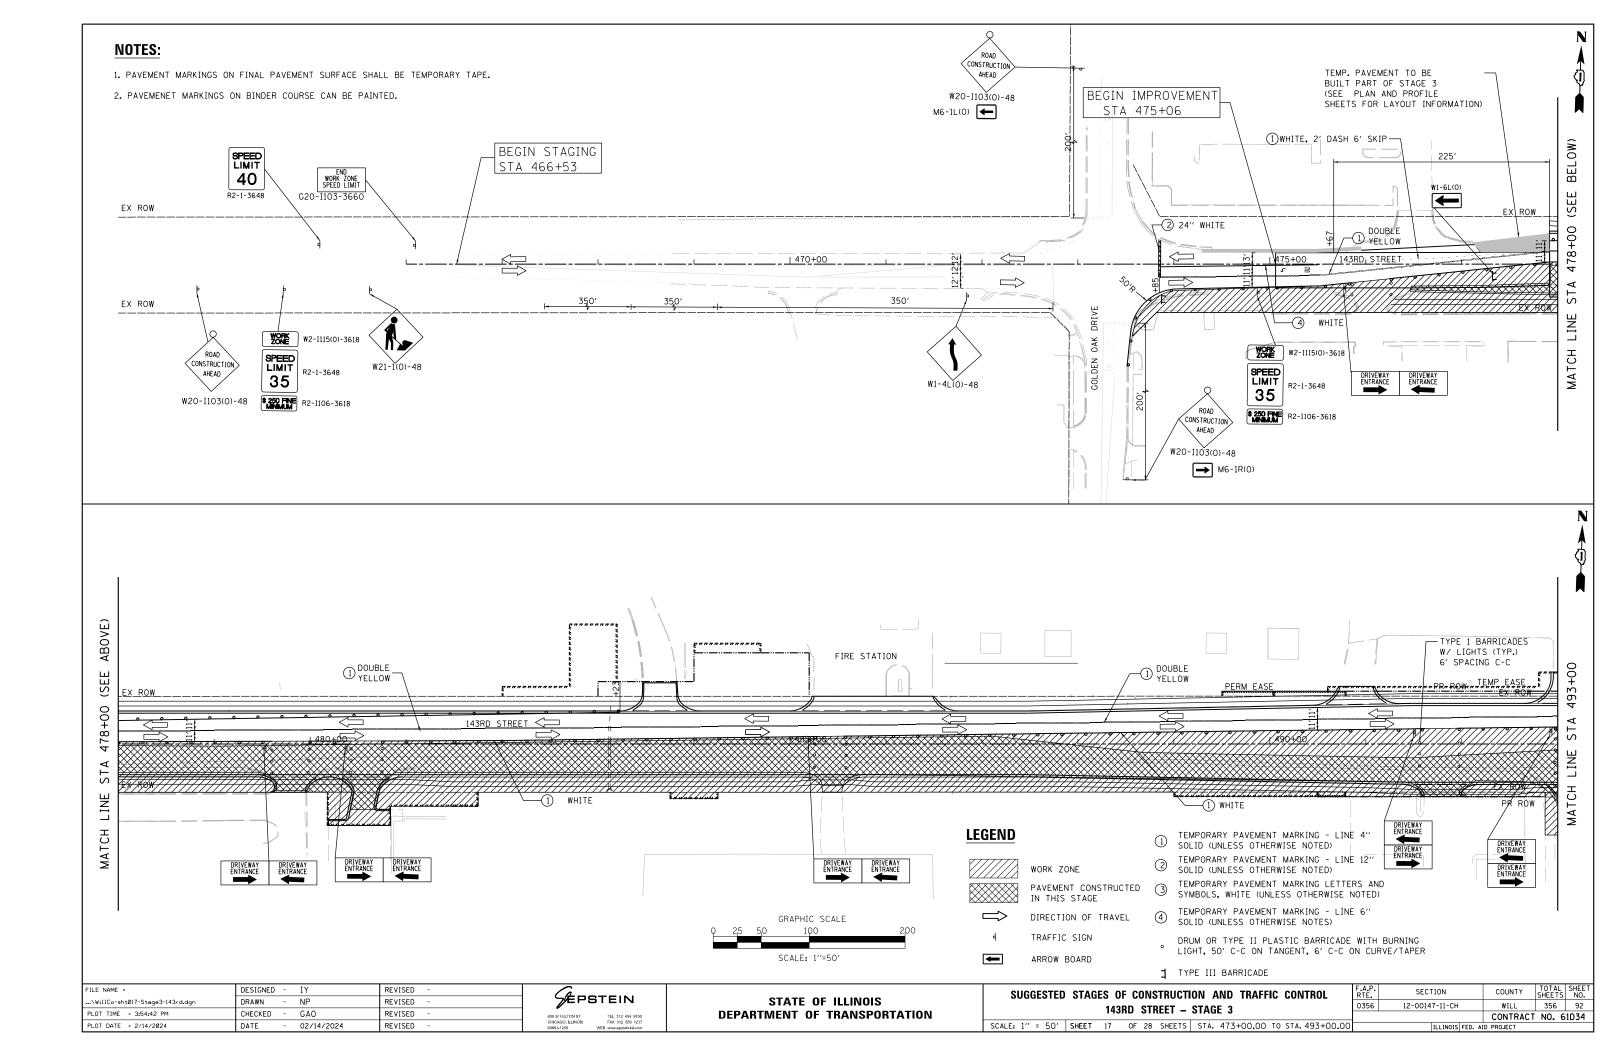
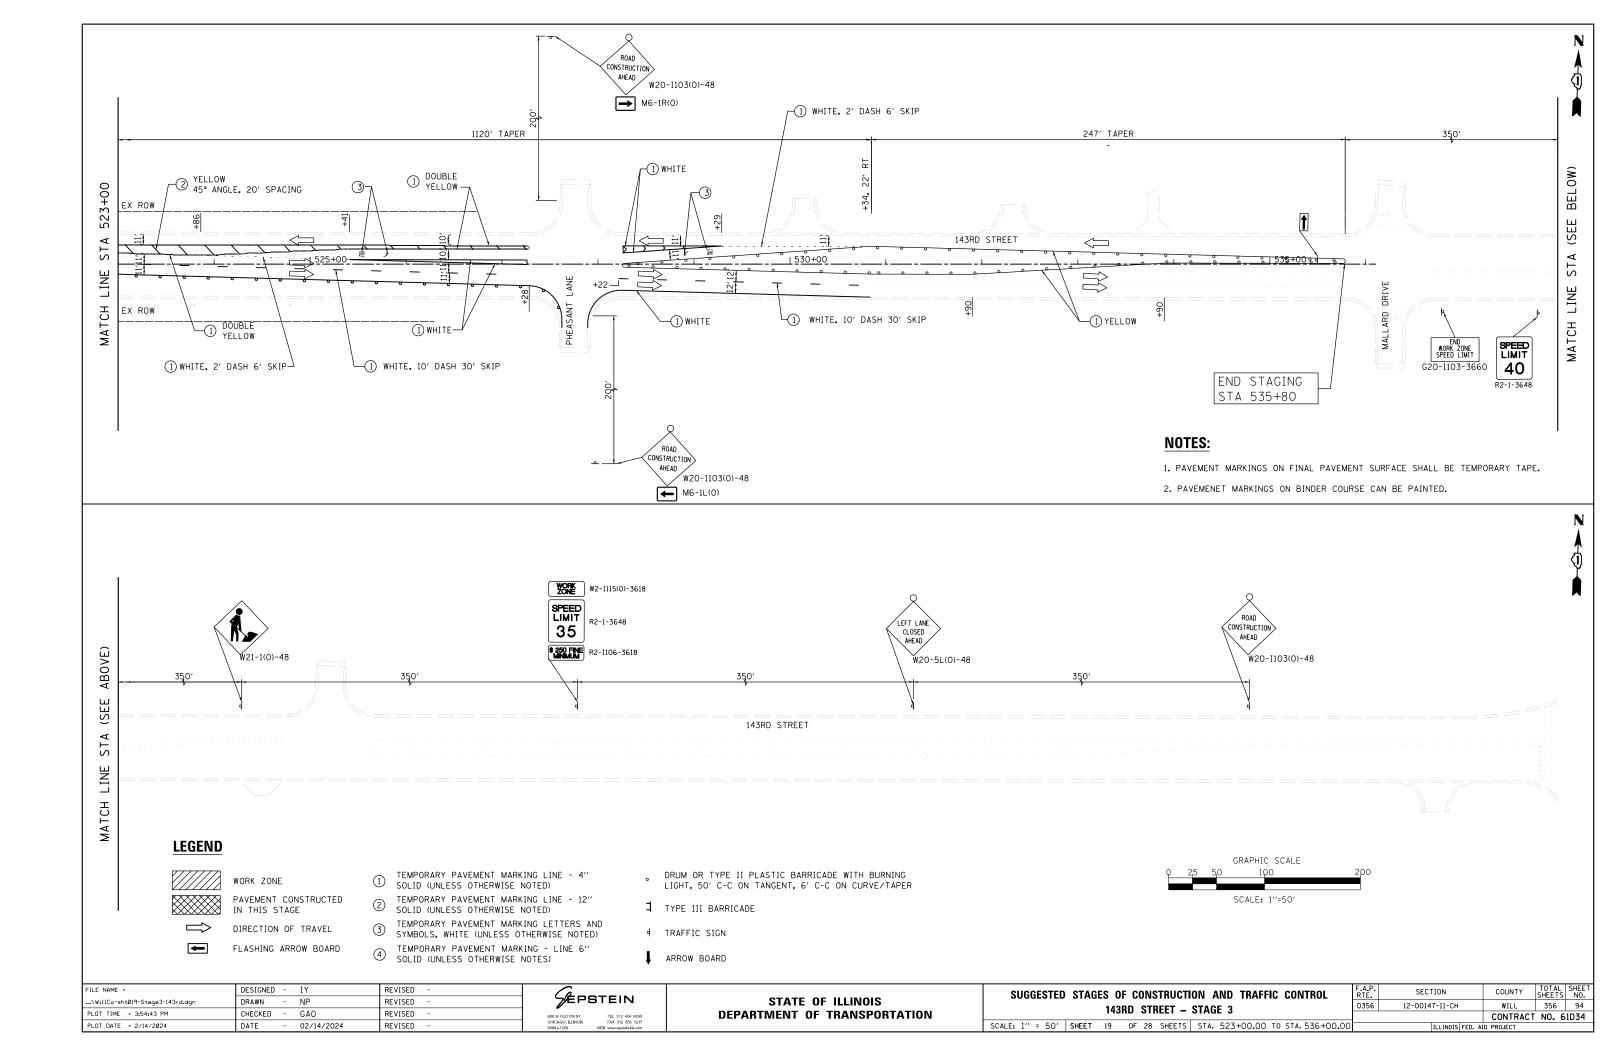
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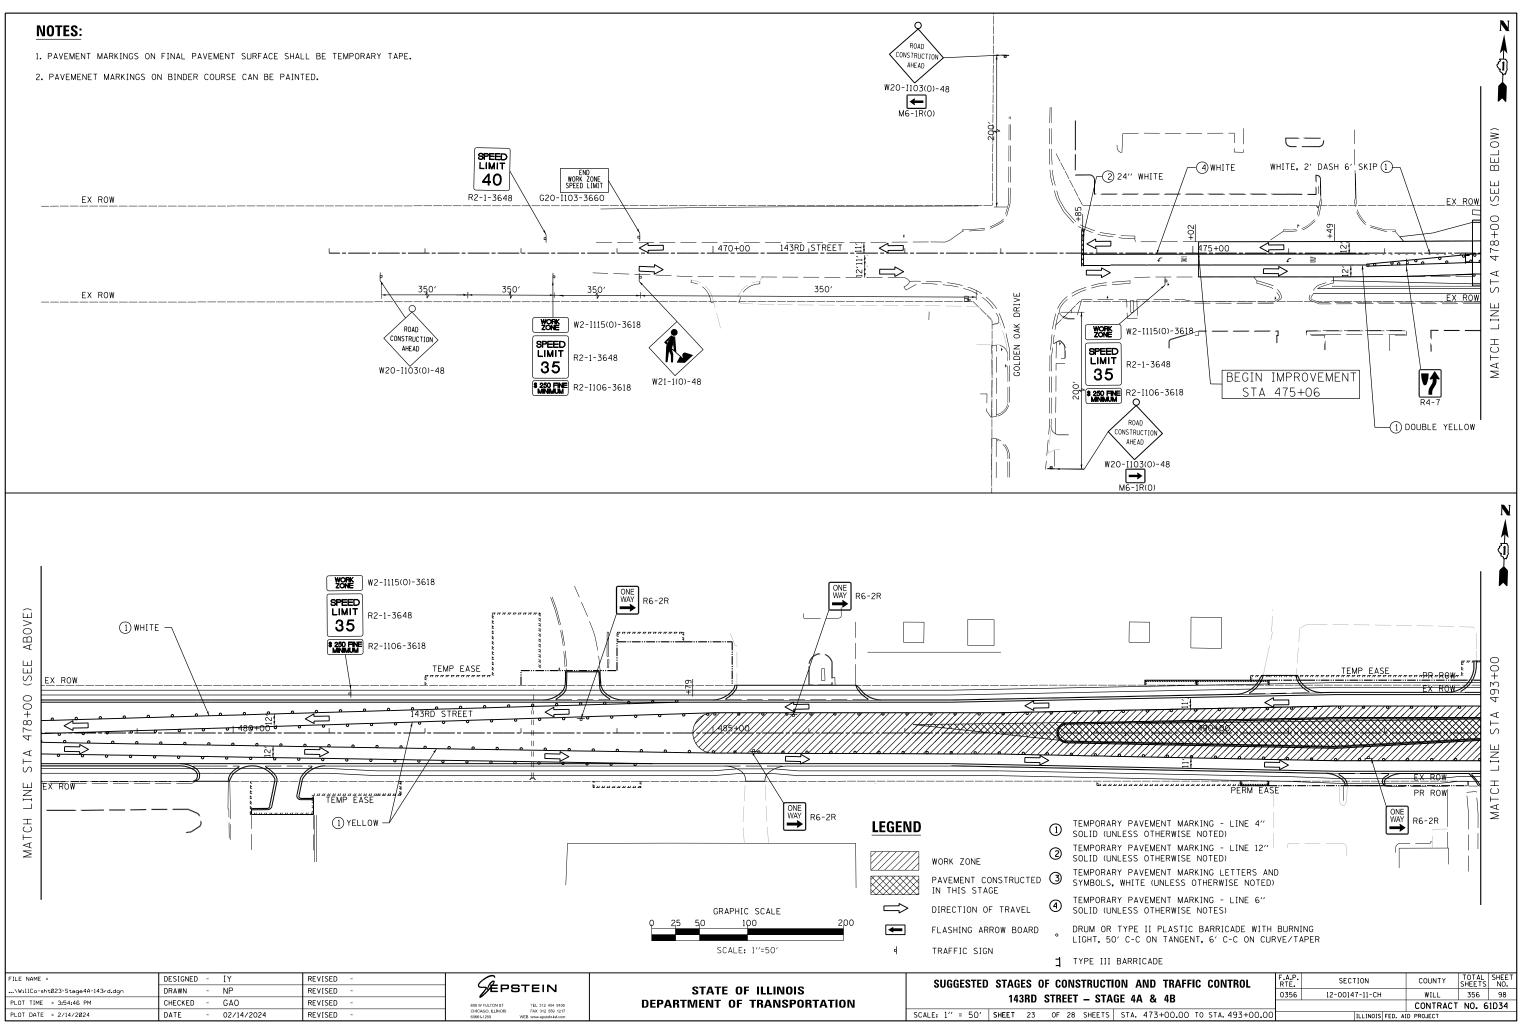
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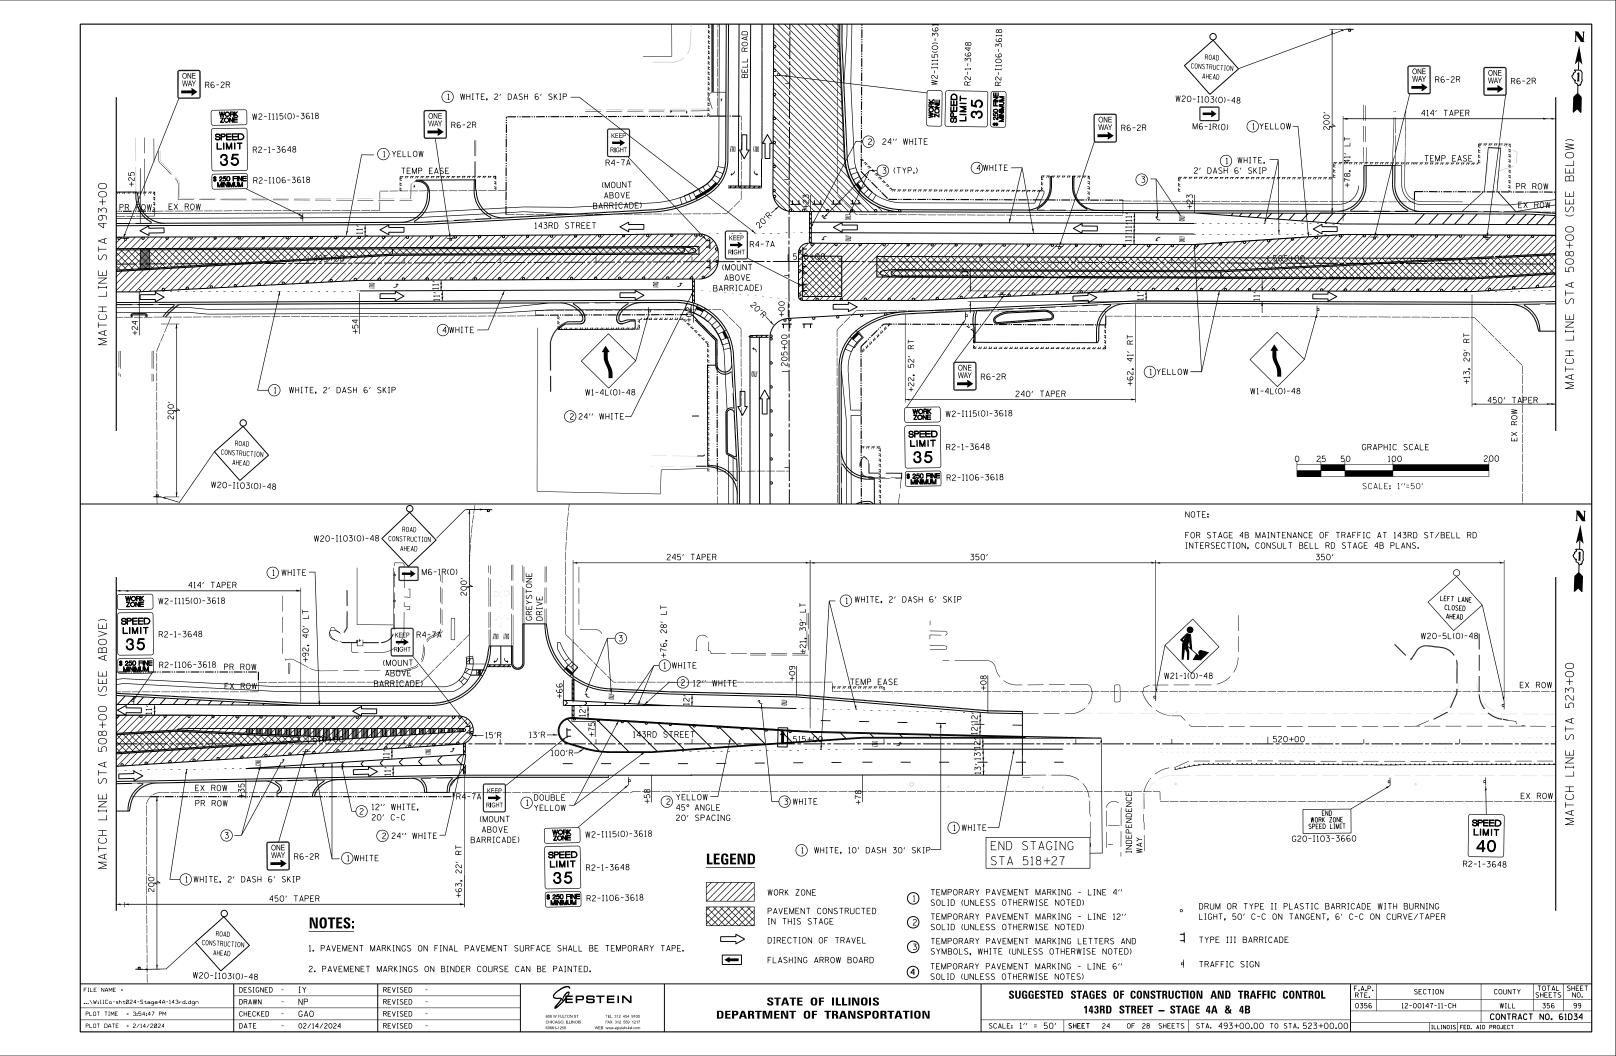
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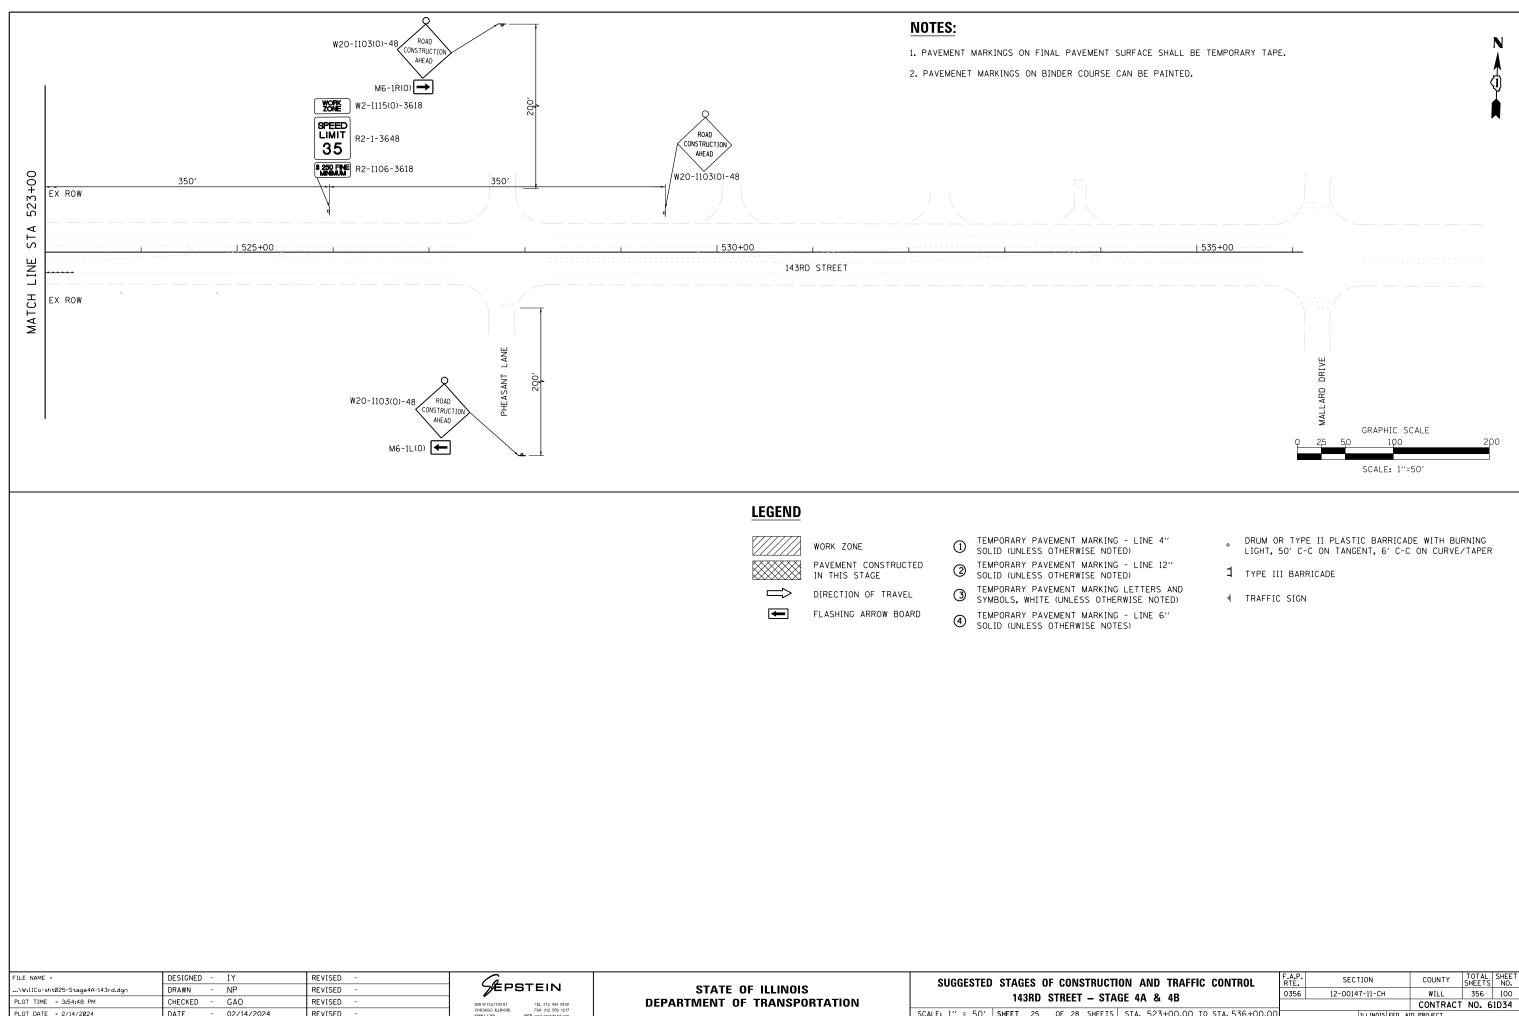
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TION AND TRAFFIC CONTROL	F.A.P. RTE.	SECTION	COUNTY	TOTAL SHEETS	SHEET NO.		
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S STA. 228+00.00 TO STA. 243+00.00	ILLINOIS FED. AID PROJECT						

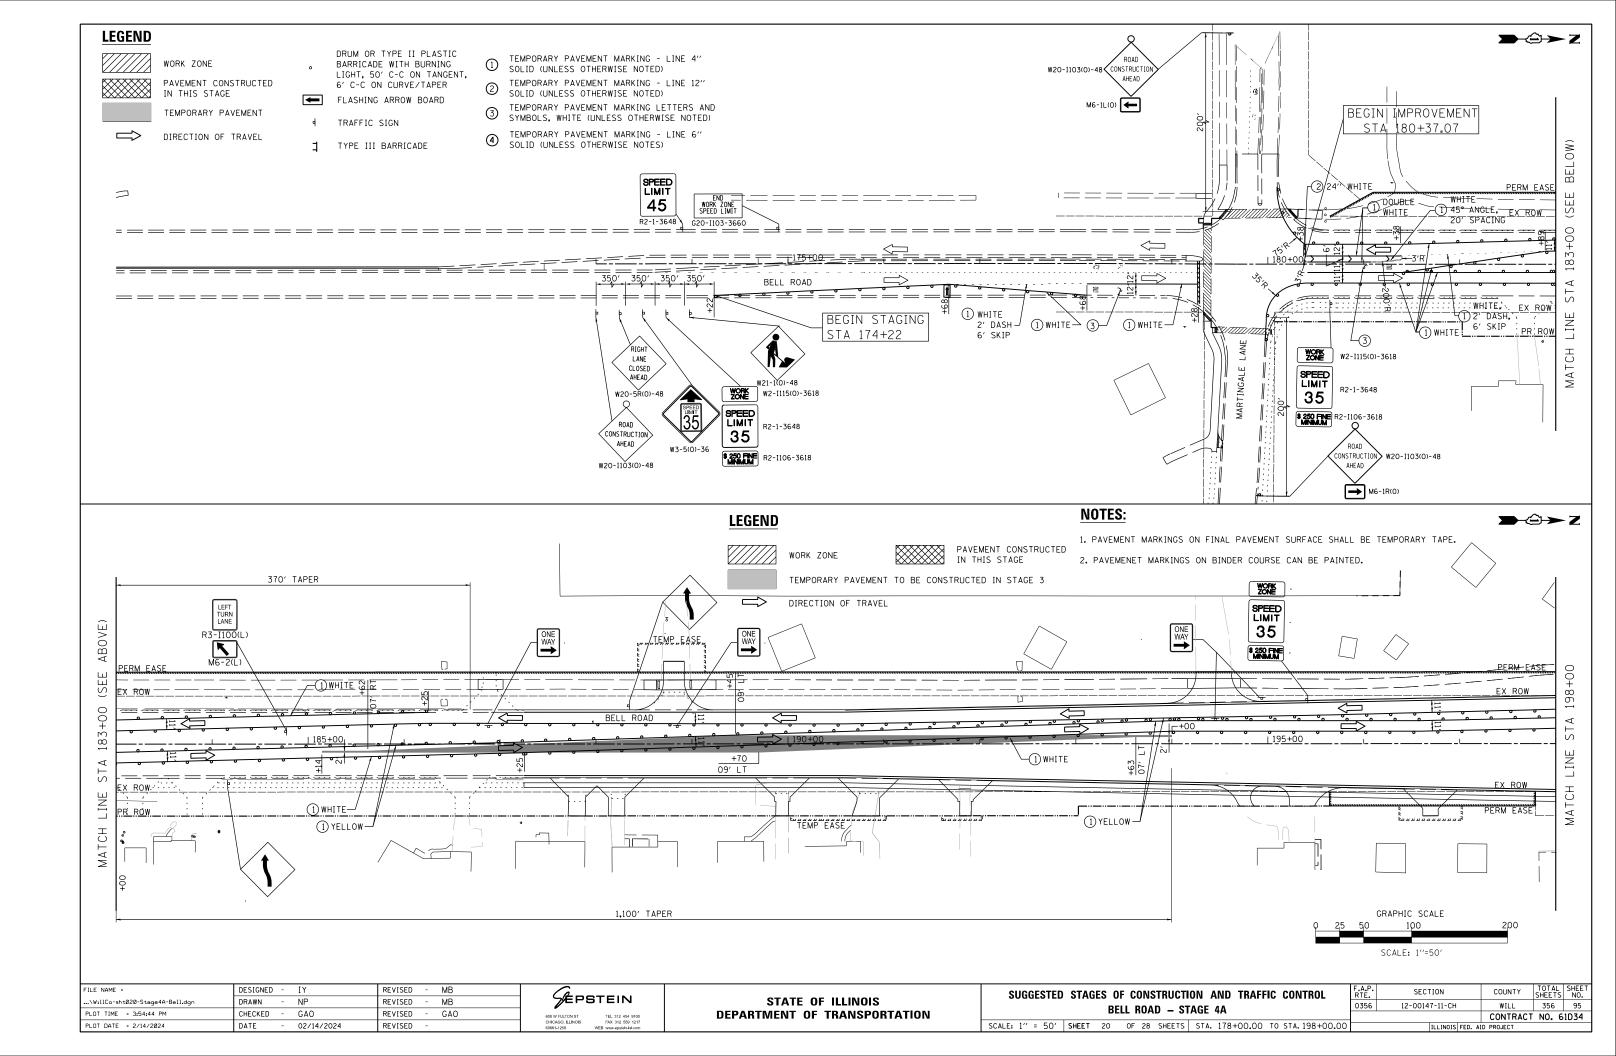





PLOT DATE = 2/14/2024

- 02/14/2024

DATE

SUGGESTED STAGES OF CONSTRUCTION AND TRAFFIC CONTROL	F.A.P. RTE.	SECTION	COUNTY	TOTAL SHEETS	SHEET NO.
143RD STREET – STAGE 4A & 4B		12-00147-11-CH	WILL	356	100
			CONTRACT	NO. 6	1D34
SCALE: 1" = 50' SHEET 25 OF 28 SHEETS STA. 523+00.00 TO STA. 536+00.00	ILLINOIS FED. AID PROJECT				