


F.A.U. ROUTE	SECTION	COUNTY	TOTAL SHEETS	SHEET NUMBER
9415	02-00055-00-RP	RANDOLPH	35	1
CITY OF CHESTER		PROJECT NO. M-5014(008)		
CONTRACT NO. 97274		JOB NO. C98-304-06		
FEDERAL AID PROJECT				

INDEX OF SHEETS

SHEET NO	DESCRIPTION
1	TITLE AND COVER SHEET, INDEX OF SHEETS AND LIST OF HIGHWAY STANDARDS
2	SUMMARY OF QUANTITIES, STRUCTURAL DESIGN DATA, EARTHWORK SCHEDULE, MIXTURE REQUIREMENTS, HOT-MIX ASPHALT PROJECT AND TRAFFIC CONTROL AND DETOUR ROUTE PLAN
2A	EXISTING TYPICAL ROADWAY SECTIONS
2B	PROPOSED TYPICAL ROADWAY SECTIONS
3	MISCELLANEOUS SCHEDULES
4	MISCELLANEOUS SCHEDULES AND PAVEMENT JOINT DETAILS
5-6	MISCELLANEOUS DETAILS
7-10	EXISTING SITE PLAN, REMOVAL PLAN & CENTERLINE CONTROL MONUMENTATION
11	STORM SEWER PLAN
12-15	PLAN AND PROFILES
16	SIGNAGE AND PAVEMENT MARKING PLAN
17	STORM WATER POLLUTION PREVENTION PLAN
18-35	CROSS SECTIONS


STATE OF ILLINOIS
DEPARTMENT OF TRANSPORTATION
DIVISION OF HIGHWAYS
PLANS FOR PROPOSED
FEDERAL - AID URBAN PROJECT
CITY OF CHESTER
 F.A.U. ROUTE 9415
 SECTION 02-00055-00-RP
 RANDOLPH COUNTY
 JOB NO. C98-304-06
 PROJECT NO. M-5014(008)
 CONTRACT NO. 97274

IMPROVEMENTS TO BUENA VISTA STREET

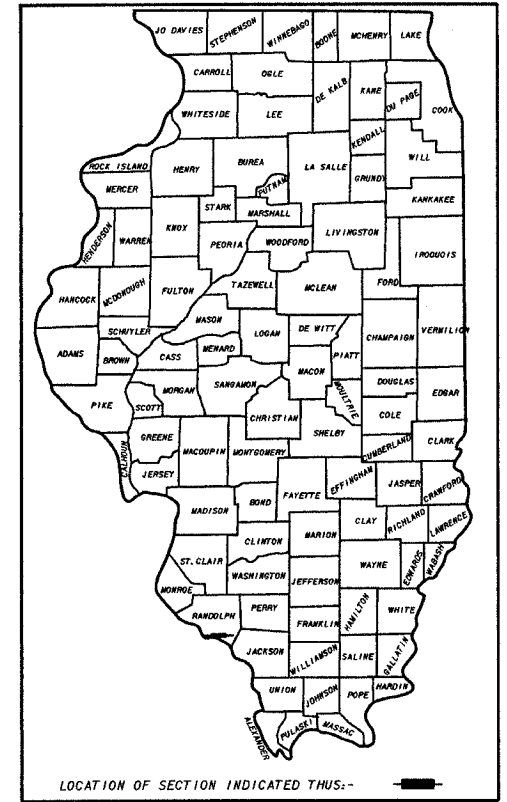

LIST OF HIGHWAY STANDARDS


HIGHWAY STANDARD NO.	TITLE
280001-03	TEMPORARY EROSION CONTROL SYSTEMS
420001-06	PAVEMENT JOINTS
424001-04	CURB RAMPS FOR SIDEWALKS
542546	FLUSH INLET BOX FOR MEDIAN
602301-01	INLET, TYPE A
602701-01	MANHOLE STEPS
604066-01	FRAME AND LID TYPE 15
606001-03	CONCRETE CURB TYPE B AND COMBINATION CONCRETE CURB AND GUTTER
635006-02	REFLECTORS AND TERMINAL MARKER PLACEMENT
702001-06	TRAFFIC CONTROL DEVICES
720011	METAL POSTS FOR SIGNS, MARKERS AND DELINEATORS
729001	APPLICATIONS OF TYPE A & B METAL POSTS (FOR SIGNS & MARKERS)
780001-01	TYPICAL PAVEMENT MARKINGS
B.L.R. 21-6	TYPICAL APPLICATION FOR TRAFFIC CONTROL DEVICES FOR CONSTRUCTION ON RURAL LOCAL HIGHWAYS
B.L.R. 22-4	TYPICAL APPLICATION FOR TRAFFIC CONTROL DEVICES FOR CONSTRUCTION ON RURAL LOCAL HIGHWAYS (TWO-LANE TWO WAY) (TWO-LANE TWO WAY RURAL TRAFFIC) (ROAD CLOSED TO THRU TRAFFIC)

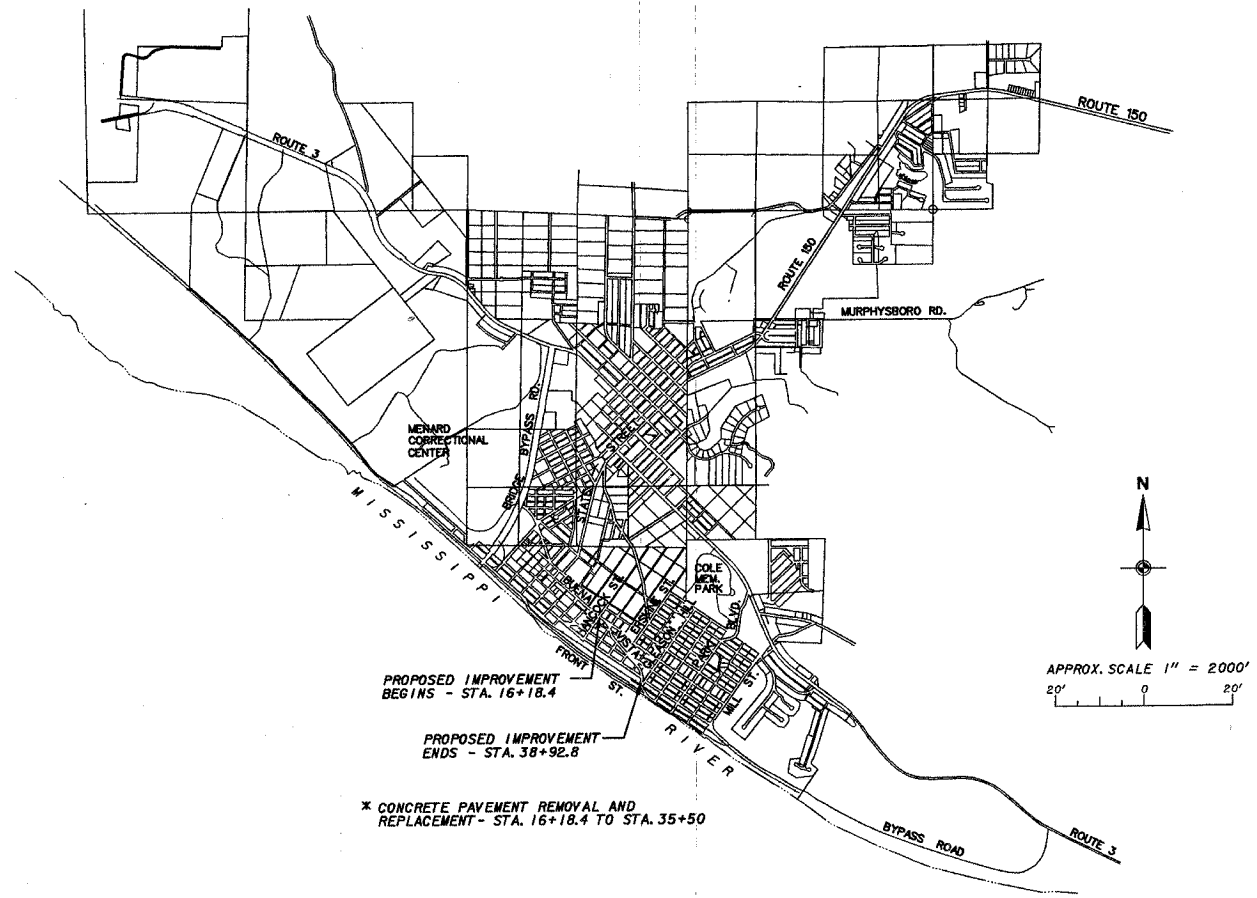

CITY OF CHESTER

GROSS LENGTH OF PROJECT	0.431 MI. = 2,274.4 FT.
OMISSIONS *	0.065 MI. = 342.8 FT.
NET LENGTH OF PROJECT *	0.366 MI. = 1,931.6 FT.

J.U.L.I.E 1-800-892-0123
 UTILITIES ON PROJECT
 CITY OF CHESTER - GAS, WATER, SEWER
 AMEREN IP COMPANY, SPARTA, IL. - ELECTRIC
 VERIZON, MARION, IL. - TELEPHONE
 NEW WAVES COMMUNICATIONS, SPARTA, IL. - CABLE T.V.

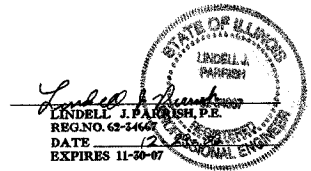

DESIGN DESIGNATION
 ROADWAY CLASSIFICATION - URBAN COLLECTOR
 DESIGN A.D.T. - 2,000
 DESIGN SPEED - 30 MPH

STATE OF ILLINOIS DEPARTMENT OF TRANSPORTATION	
APPROVED	<u>December 29</u> 2006 <i>Marty Berj</i> MARTY BERJ - MAYOR CITY OF CHESTER
PASSED	<u>January 30</u> 2007 <i>Jennifer L. Obertino</i> JENNIFER L. OBERTINO - DISTRICT 8 ENGINEER OF LOCAL ROADS & STREETS
RELEASING FOR BID BASED ON LIMITED REVIEW	<u>Jan 31</u> 2007 <i>Mary C. Lame</i> MARY C. LAME, P.E. - DEPUTY DIRECTOR OF HIGHWAYS REGION FIVE ENGINEER

SCALE AS SHOWN	J. T. BLANKINSHIP AND ASSOCIATES CONSULTING ENGINEERS	BOOK 513-JJ
DATE	401 S. 17TH STREET	FILE NO. E-8179
OCT. 2006	MURPHYSBORO, ILLINOIS	SHEET NO. 1 OF 35