


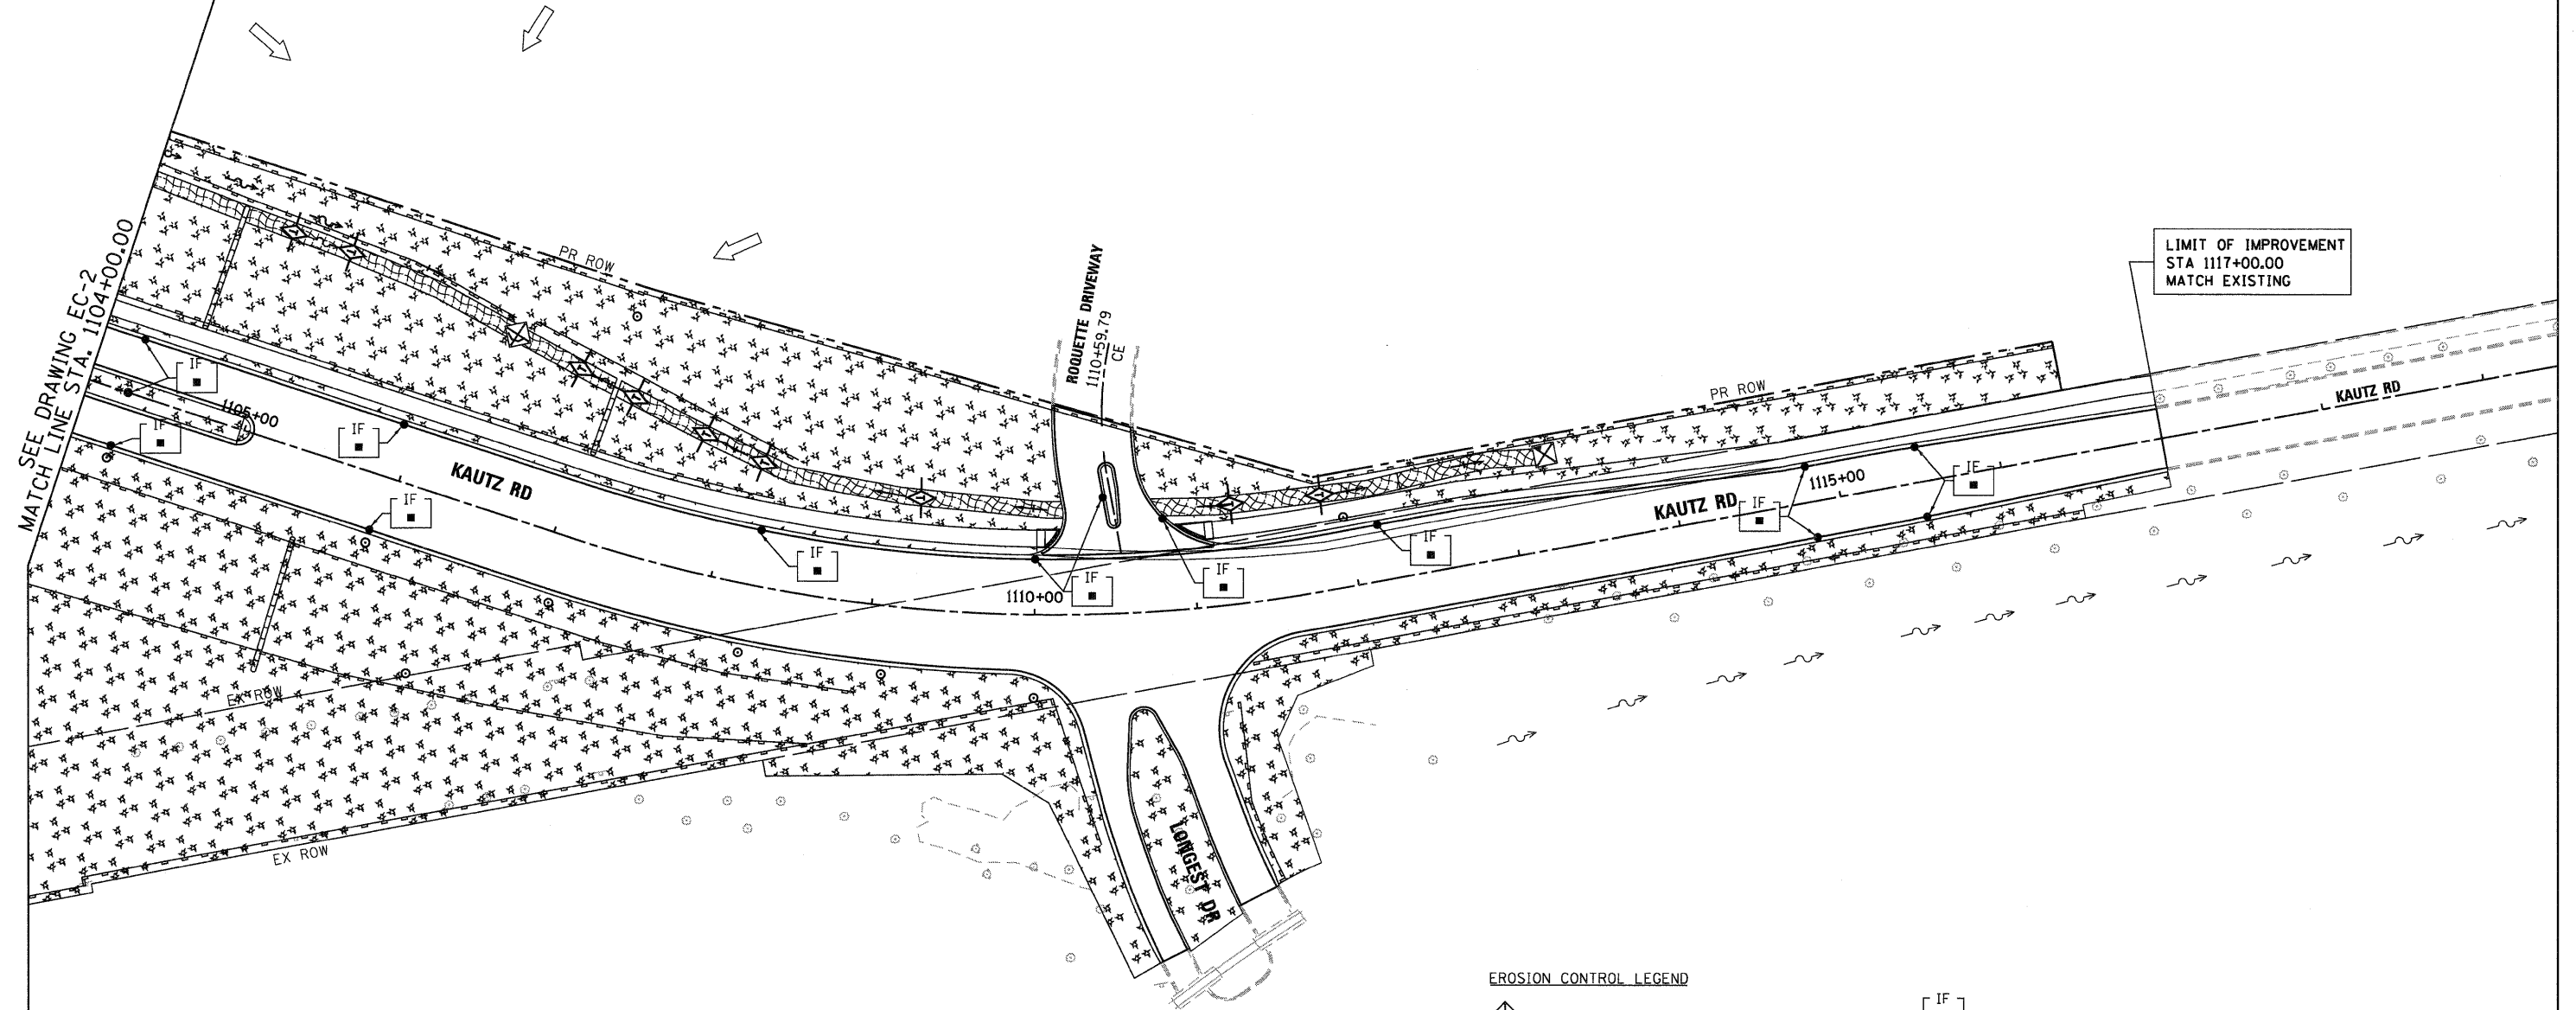


NOTES:

1. "SEDIMENT TRAP" SHALL BE SIZED FOR 1/2 ACRE STORAGE. SEE DETAIL SHEET ED-1 FOR DETAILS.
2. PERIMETER EROSION BARRIER HAS BEEN OFFSET FOR CLARITY.



EROSION CONTROL LEGEND

- | | | | |
|--|---|--|--|
| | INLET AND PIPE PROTECTION | | INLET FILTER |
| | TEMPORARY DITCH CHECK | | EROSION CONTROL TEMPORARY PIPE SLOPE DRAIN |
| | PERIMETER EROSION BARRIER | | SEDIMENT TRAP |
| | TEMPORARY EROSION CONTROL SEEDING AND MULCH METHOD 2 | | DITCH FLOW |
| | TEMPORARY EROSION CONTROL SEEDING AND EROSION CONTROL BLANKET | | SWALE |
| | | | DRAINAGE SUMMIT |

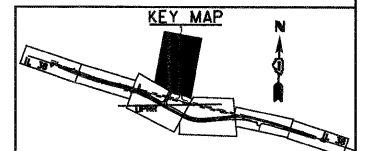

McDonough Associates Inc.
 Engineers / Architects
 130 East Randolph Street Chicago, Illinois 60601

FILE NAME = 0168122-SHT-ER0515.dgn	USER NAME = ErroG	DESIGNED - JCL	REVISED -
PLOT SCALE = 1:50	CHECKED - E.JG	DRAWN - JCL	REVISED -
PLOT DATE = 12/9/2011	DATE - 12/09/11		REVISED -

**STATE OF ILLINOIS
DEPARTMENT OF TRANSPORTATION**

EROSION AND SEDIMENT CONTROL PLAN

SCALE: 1"=50' SHEET NO. 5 OF 5 SHEETS STA. 1104+00 TO STA. END

F.A.P. RTE.	SECTION	COUNTY	TOTAL SHEETS	SHEET NO.
347	LY (HB & VB)	DUPAGE/KANE	421	65
	EC-5			CONTRACT NO. 60122
FED. ROAD DIST. NO. 1 ILLINOIS FED. AID PROJECT				