04-27-12 LETTING ITEM 013


FOR INDEX OF SHEETS, SEE SHEET NO. 2 FOR TRAFFIC DATA, SEE SHEET NO. 4

IMPROVEMENTS LOCATED IN THE VILLAGE OF LAKE BARRINGTON AND CITY OF HIGHLAND PARK

STATE OF ILLINOIS
DEPARTMENT OF TRANSPORTATION
DIVISION OF HIGHWAYS


PROPOSED HIGHWAY PLANS

VARIOUS ROUTES
SECTION: 2011–222–I
VARIOUS LOCATIONS IN LAKE COUNTY
SCOUR COUNTERMEASURES
LAKE COUNTY
C-91–225–12

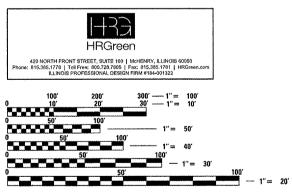

FULL SIZE PLANS HAVE BEEN PREPARED USING STANDARD ENGINEERING SCALES. REDUCED SIZED PLANS WILL NOT CONFORM TO STANDARD SCALES. IN MAKING MEASUREMENTS ON REDUCED PLANS, THE ABOVE SCALES MAY BE USED.

J.U.L.I.E.
JOINT UTILITY LOCATION INFORMATION FOR EXCAVATION
1-800-892-0123
OR 811

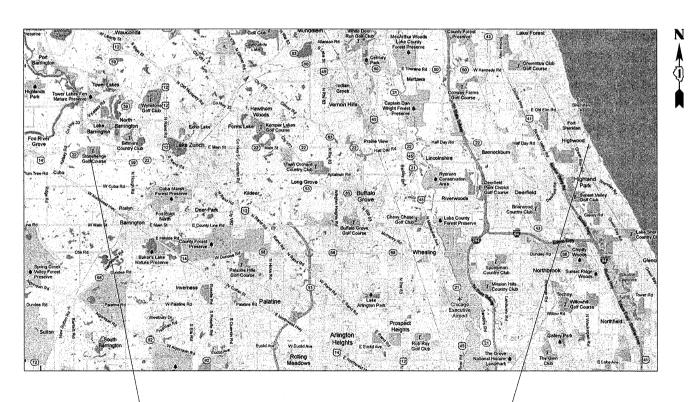

LOCATION 2: S.N. 049-0081, SHERIDAN ROAD

OVER BOYINGTON RAVINE

LOCATION 1: S.N. 049-0079, ILLINOIS ROUTE 22

D-91-225-12



STATE OF ILLINOIS
DEPARTMENT OF TRANSPORTATION
DIVISION OF HIGHWAYS

SUBMITTED FERUARY 1/20 12

DEPUTY DIRECTOR OF HIGHWAYS, REGION ENGINEER

MARCH 23 20 12

SUBMITTED FOR DESIGN AND ENVIRONMENT

LATER 23 20 12

LATER DIRECTOR OF HIGHWAYS, CHIEF ENGINEER

PROFESSIONAL ENGINEER'S SIGN & SEAL

Christophe, M. Hoothe

EXPIRES: 11 - 30 - 13

PRINTED BY THE AUTHORITY OF THE STATE OF ILLINOIS

CONTRACT NO. 60R83

PLAN PREPARATION ENGINEER: KEN ENG: (847) 705-4247

INDEX OF SHEETS

COVER SHEET 2 INDEX OF SHEETS, LIST OF STATE STANDARDS, AND GENERAL NOTES 3 SUMMARY OF QUANTITIES

LOCATION MAP

5-6 SCOUR COUNTERMEASURES - IL ROUTE 22 OVER FLINT CREEK 7-8 SCOUR COUNTERMEASURES - SHERIDAN ROAD OVER BOYINGTON RAVINE

9-11 CROSS SECTIONS SCOUR COUNTERMEASURES - IL ROUTE 22 AND SHERIDAN ROAD

12-16 DETAILS

LIST OF STATE STANDARDS

TRAFFIC CONTROL DEVICES

STANDARD NO.	DESCRIPTION
701006- 03	OFF-RD OPERATIONS, 2L, 2W, 15' TO 24" FROM PAVEMENT EDGE
701201- 04	LANE CLOSURE, 2L, 2W, DAY ONLY, FOR SPEEDS >= 45 MPH
701501- 06	URBAN LANE CLOUSRE, 2L, 2W, UNDIVIDED
701701- <i>08</i>	URBAN LANE CLOSURE, MULTILANE INTERSECTION
701801- <i>05</i>	LANE CLOSURE MULTILANE 1W OR 2W CROSSWALK OR SIDEWALK CLOSUR

COMMITMENTS

701901-02

USER NAME = JGuerr:	DESIGNED	-	C. HARTKE	REVISED	-
	DRAWN	-	S. PERNAL	REVISED	•
PLOT SCALE =	CHECKED	-	T. HAMILTON	REVISED	-
PLOT DATE = 2/15/2012	DATE	-	2/15/12	REVISED	-

STATE OF ILLINOIS **DEPARTMENT OF TRANSPORTATION**

SCALE:

GENERAL NOTES

- 1. BEFORE STARTING ANY EXCAVATION, THE CONTRACTOR SHALL CALL "UULIE" (JOINT UTILITY LOCATION INFORMATION FOR EXCAVATION) AT 8-1-1 OR (800) 892-0123 FOR FIELD LOCATIONS OF BURIED ELECTRIC, TELEPHONE, AND GAS FACILITIES (48 HOUR NOTIFICATION IS REQUIRED).
- 2. THE CONTRACTOR WILL NOT BE ALLOWED TO SET UP A YARD OR FIELD OFFICE ON STATE PROPERTY WITHOUT WRITTEN PERMISSION FROM THE DEPARTMENT.
- 3. EXCAVATION INTO THE STREAM BED FOR STONE RIPRAP INSTALLATION SHALL NOT BE DEEPER THAN THE BOTTOM OF THE FOOTING ON THE PIER OR ABUTMENT TO BE PROTECTED.
- 4. DEBRIS REMOVAL, IF ENCOUNTERED, SHALL BE INCLUDED IN THE COST OF THE STONE RIPRAP.
- 5. IT SHALL BE THE CONTRACTORS RESPONSIBILITY TO VERIFY ALL DIMENSIONS & CONDITIONS EXISTING IN THE FIELD PRIOR TO CONSTRUCTION ORDERING OF MATERIAL.
- 6. THE CONTRACTOR SHALL CONTACT THE DISTRICT ONE ARTERIAL TRAFFIC CONTROL SUPERVISOR AT (847) 705-4470 A MINIMUM OF 72 HOURS IN ADVANCE OF BEGINNING WORK.
- 7. ALL AREAS (INCLUDING WETLAND AREAS) OUTSIDE THE LIMITS OF RIPRAP PLACEMENT AND/OR EXCAVATION WHICH ARE DISTURBED (WHERE EXISTING SOIL CONTOURS HAVE BEEN ALTERED AND/OR EXISTING VEGETATION HAD BEEN DESTROYED BY THE CONTRACTORS OPERATIONS) SHALL BE RESTORED BY REGRADING TO THE ORIGINAL CONTOURS AND/OR SEEDING WITH SEEDING, CLASS 4, AND MULCHING WITH EROSION CONTROL BLANKETS. PLACE TEMPORARY SEEDING AND TEMPORARY EROSION CONTROL BLANKETS AS NEEDED. THIS WORK WILL NOT BE PAID FOR SEPERATELY, BUT THE COSTS SHALL BE CONSIDERED INCLUDED IN THE CONTRACT UNIT PRICES FOR THE CONSTRUCTION ITEMS INVOLVED, AND NO ADDITIONAL COMPENSATION WILL BE ALLOWED.
- 8. THE CONTRACTOR IS ADVISED TO AVOID OR MINIMIZE ANY DISTURBANCE TO EXISTING VEGETATION OUTSIDE THE LIMITS OF RIPRAP PLACEMENT AND CHANNEL EXCAVATION.
- 9. THE CONTRACTOR MUST PROTECT PAVEMENT WHEN DUMPING RIPRAP ONTO PAVEMENT AND WILL BE RESPONSIBLE FOR RESTORING PAVEMENT MARKINGS.
- 10. ANY GUARDRAIL OR SIGNS DAMAGED BY THE CONTRACTORS OPERATIONS SHALL BE REPLACED IN KIND AT THE CONTRACTORS EXPENSE.
- 11. THE CONTRACTOR SHALL BE REQUIRED TO PROVIDE ACCESS TO ABUTTING PROPERTY AT ALL TIMES DURING THE CONSTURCTION OF THIS PROJECT.
- 12. DO NOT SCALE PLANS FOR CONSTRUCTION DIMENSIONS.
- 13. THE CONTRACTOR SHALL SUBMIT DEWATERING AND SEDIMENT CONTROL PLANS FOR EACH SITE TO THE ENGINEER FOR APPROVAL
- 14. THE CONTRACTOR SHALL CONTACT THE ENGINEER AFTER DEWATERING FOR FINAL RIPRAP OR SLOPE MATTRESS PLACEMENT.
- 15. NIGHT TIME CLOSURES WILL NOT BE REQUIRED FOR THIS PROJECT.
- 16. UNLESS OTHERWISE NOTED, EXCAVATION OF MATERIAL REQUIRED TO INSTALL STONE RIPRAP OR SLOPE MATTRESS SHALL BE INCLUDED IN THE ITEM BEING INSTALLED.
- 17. THIS PROJECT REQUIRES US ARMY CORPS OF ENGINEERS 404 PERMITS. THE PERMITS ISSUED TO THE DEPARTMENT DOES NOT COVER THE IN STREAM WORK BY THE CONTRACTOR. THEREFORE AFTER AWARD, THE CONTRACTOR WILL NEED TO SUBMIT THE WORK PLANS TO THE CORPS. THE CORPS WILL NOT BE PROVIDING AN APPROVAL UNLESS STATED OTHERWISE IN THE PERMIT AND IN STREAM WORK CAN COMMENCE AT THE CONTRACTORS DISCRETION. GUIDELINES ON ACCEPTABLE IN STREAM WORK TECHNIQUES CAN BE FOUND ON THE CORPS WEBSITE: HTTP:WWWLRC.USACE.ARMY.MIL/

TO STA.

SHEET NO. 1 OF 1 SHEETS STA.

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	SUMMARY OF QUANTITIES	URBAN	00)14	
CODE NO.	ITEM	UNIT	100% STATE TOTAL QUANTITY	LOCATION 1 IL RTE 22 LAKE CO	LOCATION 2 SHERIDAN RD LAKE CO
28100107	STONE RIPRAP, CLASS A4	SQ YD	405	155	250
28200200	FILTER FABRIC	SO YD	633	231	402
67000400	ENGINEER'S FIELD OFFICE, TYPE A	CAL MO	4	2	2
67100100	MOBILIZATION	L SUM	1	0.5	0.5
70100450	TRAFFIC CONTROL AND PROTECTION, STANDARD 701201	L SUM	1	1	
70102620	TRAFFIC CONTROL AND PROTECTION, STANDARD 701501	L SUM	1	0.5	0.5
70102635	TRAFFIC CONTROL AND PROTECTION, STANDARD 701701	L SUM	1		1
70102640	TRAFFIC CONTROL AND PROTECTION, STANDARD 701801	L SUM	1		1
X0301852	DEWATERING STRUCTURE NO. 1	EACH	1	1	
X0301853	DEWATERING STRUCTURE NO. 2	EACH	1		. 1
Z0030850	TEMPORARY INFORMATION SIGNING	SQ FT	128.5	51.4	77.1

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STATE OF ILLINOIS DEPARTMENT OF TRANSPORTATION

1		SUMMARY OF Q	F.A. RTE.	SECTION	COUNTY	TOTAL SHEETS	SHEET NO.		
ı					VAR.	2011-222-1	LAKE	16	3
1							CONTRACT	NO.	60R83
ı	SCALE: N/A SHEET NO	 1 OF 1 SHEETS 	STA.	TO STA.	FED. RO	DAD DIST. NO. ILLINOIS FED. A	D PROJECT	~~~~~	


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HRGreen

Henry Ln

TRAFFIC DATA SPEED LIMIT = 50 MPH 2009 ADT = 11,500

Stonehenge Golf Course

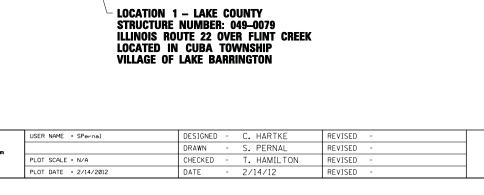

R. 9 E.

Signal Hill Rd

공 N Edgemond Ln

Signal Hill Rd

59

(59)

STATE OF ILLINOIS **DEPARTMENT OF TRANSPORTATION**

LOCATION MAP **SCOUR COUNTERMEASURES** SHEET NO. 1 OF 1 SHEETS STA.


TOTAL SHEET NO. SECTION VAR. LAKE CONTRACT NO. 60R83

TRAFFIC DATA
SPEED LIMIT = 30 MPH
2007 ADT = 2,450

Half Day Rd Moraine Park Exmoor Country Club Highland Park Country Club T. 43 Highland Park Central Rd Lincoln Place Park

R. 12 E.

LOCATION 2 – LAKE COUNTY
STRUCTURE NUMBER: 049–0081
SHERIDAN ROAD OVER BOYINGTON RAVINE
LOCATED IN DEERFIELD TOWNSHIP
CITY OF HIGHLAND PARK

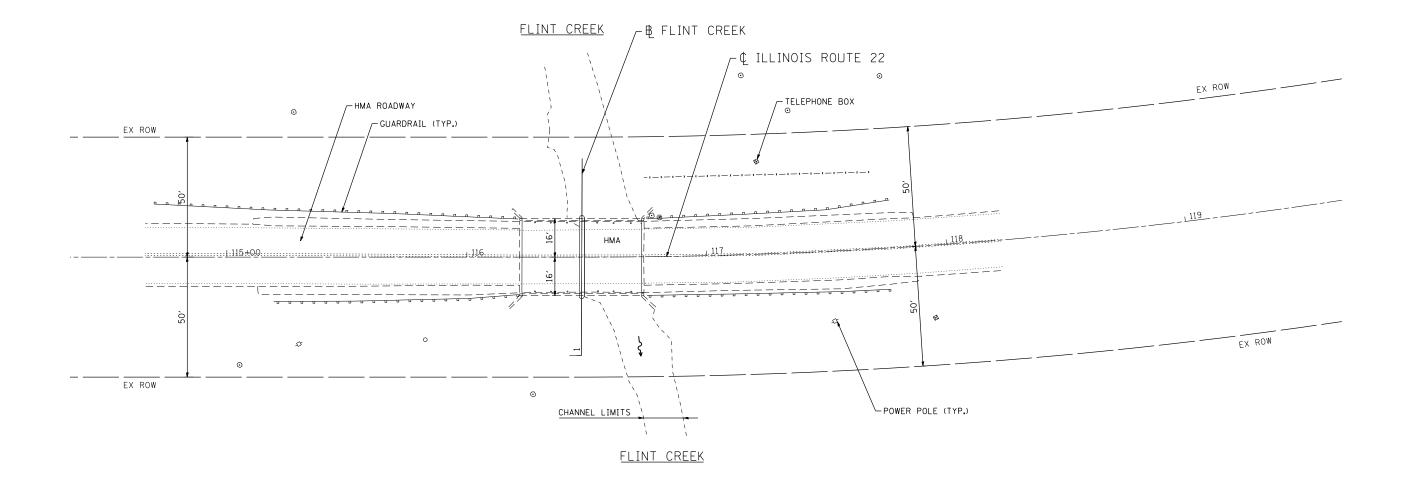


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| HR

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STONE RIPRAP, CLASS A4 (3' THICK)

CHISELED SQUARE ON TOP OF THE NE WING WALL ELEV. = 765.31 NAIL IN NORTH FACE OF POWER POLE APROXIMATLY 150 WEST OF BRIDGE (OFF NB SHOULDER) ELEV. = 761.88



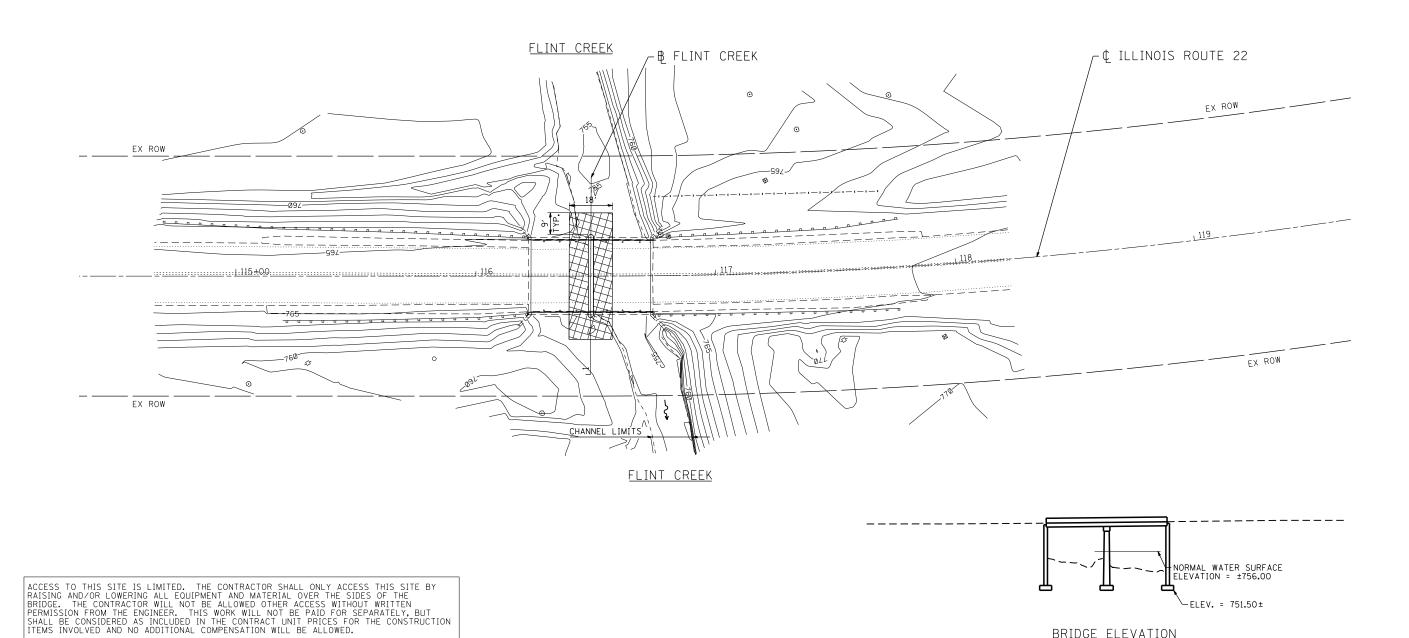

HRGreen

USER NAME = JGuerrı DESIGNED - C. HARTKE REVISED S. PERNAL DRAWN REVISED LOT SCALE = 1'=20' CHECKED T. HAMILTON REVISED 2/15/12 PLOT DATE = 2/15/2012 DATE REVISED

STATE OF ILLINOIS **DEPARTMENT OF TRANSPORTATION**

EROSION AND SEDIMENT CONTROL PLAN ILLINOIS ROUTE 22 OVER FLINT CREEK SCALE: 1"=20' SHEET NO. 2 OF 2 SHEETS STA. 1110+00 TO STA. 1113+00

BRIDGE ELEVATION NOT TO SCALE

> COUNTY TOTAL SHEET NO.
>
> LAKE 16 6
>
> CONTRACT NO. 60R83 SECTION VAR. 2011-222-I FED. ROAD DIST. NO. | ILLINOIS FED. AID PROJECT


HRGreen

USER NAME = JGuerrı DESIGNED - C. HARTKE REVISED - S. PERNAL DRAWN REVISED CHECKED - T. HAMILTON
DATE - 2/15/12 REVISED PLOT SCALE = 1'=20' PLOT DATE = 2/15/2012 REVISED


STATE OF ILLINOIS
DEPARTMENT OF TRANSPORTATION


SCALE: 1"=20' SHEET NO. 1 OF 2 SHEETS STA. 1302+00 TO STA. 1307+00 FED. ROAD DIST. NO. | ILLINOIS | FED. AID | PROJECT | FED. ROAD DIST. NO. | ILLINOIS | FED. AID | PROJECT | FED. AID | PROJECT | FED. ROAD DIST. NO. | ILLINOIS | FED. AID | PROJECT | FED. AID | PROJECT | FED. ROAD DIST. NO. | ILLINOIS | FED. AID | PROJECT | FED. ROAD DIST. NO. | ILLINOIS | FED. AID | PROJECT | FED. ROAD DIST. NO. | ILLINOIS | FED. AID | PROJECT | FED. ROAD DIST. NO. | ILLINOIS | FED. AID | PROJECT | FED. ROAD DIST. NO. | ILLINOIS | FED. AID | PROJECT | FED. ROAD DIST. NO. | ILLINOIS | FED. AID | PROJECT | FED. ROAD DIST. NO. | ILLINOIS | FED. AID | PROJECT | FED. ROAD DIST. NO. | ILLINOIS | FED. AID | PROJECT | FED. ROAD DIST. NO. | ILLINOIS | FED. AID | PROJECT | FED. ROAD DIST. NO. | ILLINOIS | FED. AID | PROJECT | FED. ROAD DIST. NO. | ILLINOIS | FED. AID | PROJECT | FED. ROAD DIST. NO. | ILLINOIS | FED. AID | PROJECT | FED. ROAD DIST. NO. | ILLINOIS | FED. AID | PROJECT | FED. ROAD DIST. NO. | ILLINOIS | FED. AID | PROJECT | FED. ROAD DIST. NO. | ILLINOIS | FED. AID | PROJECT | FED. ROAD DIST. NO. | ILLINOIS | FED. AID | PROJECT | FED. ROAD DIST. NO. | ILLINOIS | FED. AID | PROJECT | FED. ROAD DIST. NO. | ILLINOIS | FED. AID | PROJECT | FED. ROAD DIST. NO. | ILLINOIS | FED. ROAD D


	-B BOYINGTON RAVINE
MANHOLE, TYP. EX ROW Q O O O O O O O O O O O O O	EX. SANITARY SEWER SIDEWALK CONC 220+00 EX. ROW FIRE HYDRANT OFFIRE HYDRANT OFFIRE HYDRANT OFFIRE HYDRANT OFFIRE HYDRANT
LIGHT POLE, TYP. SIDEWALK HMA ROADWAY	
HMA RUADWAY	O O CHANNEL LIMITS 1 O O O O O
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ROAD CONSTRUCTIO AHEAD ROAD TYPE III BARRICADES WITH TWO FLASHING AMBER LIGHTS ON EACH. AHEAD TYPE I OR TYPE II BARRICADES WITH ONE FLASHING AMBER LIGHT ON EACH, OR TYPE III BARRICADES WITH TWO FLASHING 200'± (60 m±)-AMBER LIGHTS ON EACH. 21 (530) DRIVEWAY STREET: SPEED 40 MPH OR LESS km/h) 200'± (60 m±) (60 500°± (150 COLLECTOR LIMIT> 40 MPH (LOCAL LIMIT ' W20-1(0) SPEED CONSTRUCTION M6-4(0)-2115 CONSTRUCTION M6-1(0)-2115 AHEAD

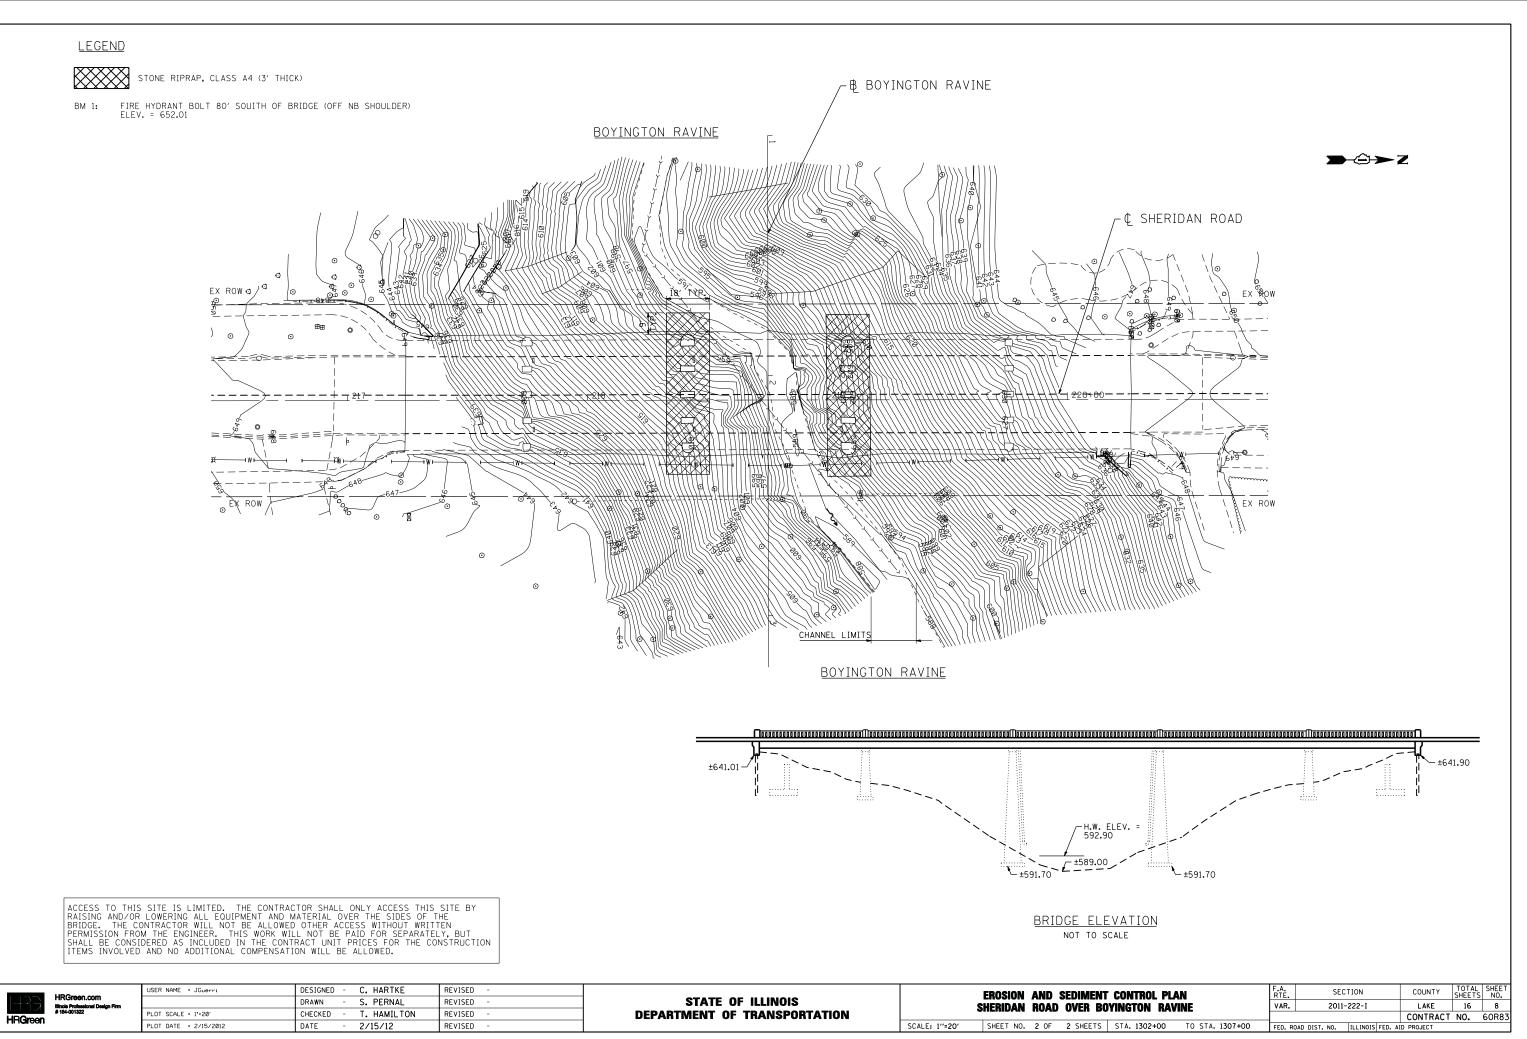TRAFFIC CONTROL AND PROTECTION FOR SIDE ROADS, INTERSECTIONS, AND DRIVEWAYS

NOTES:

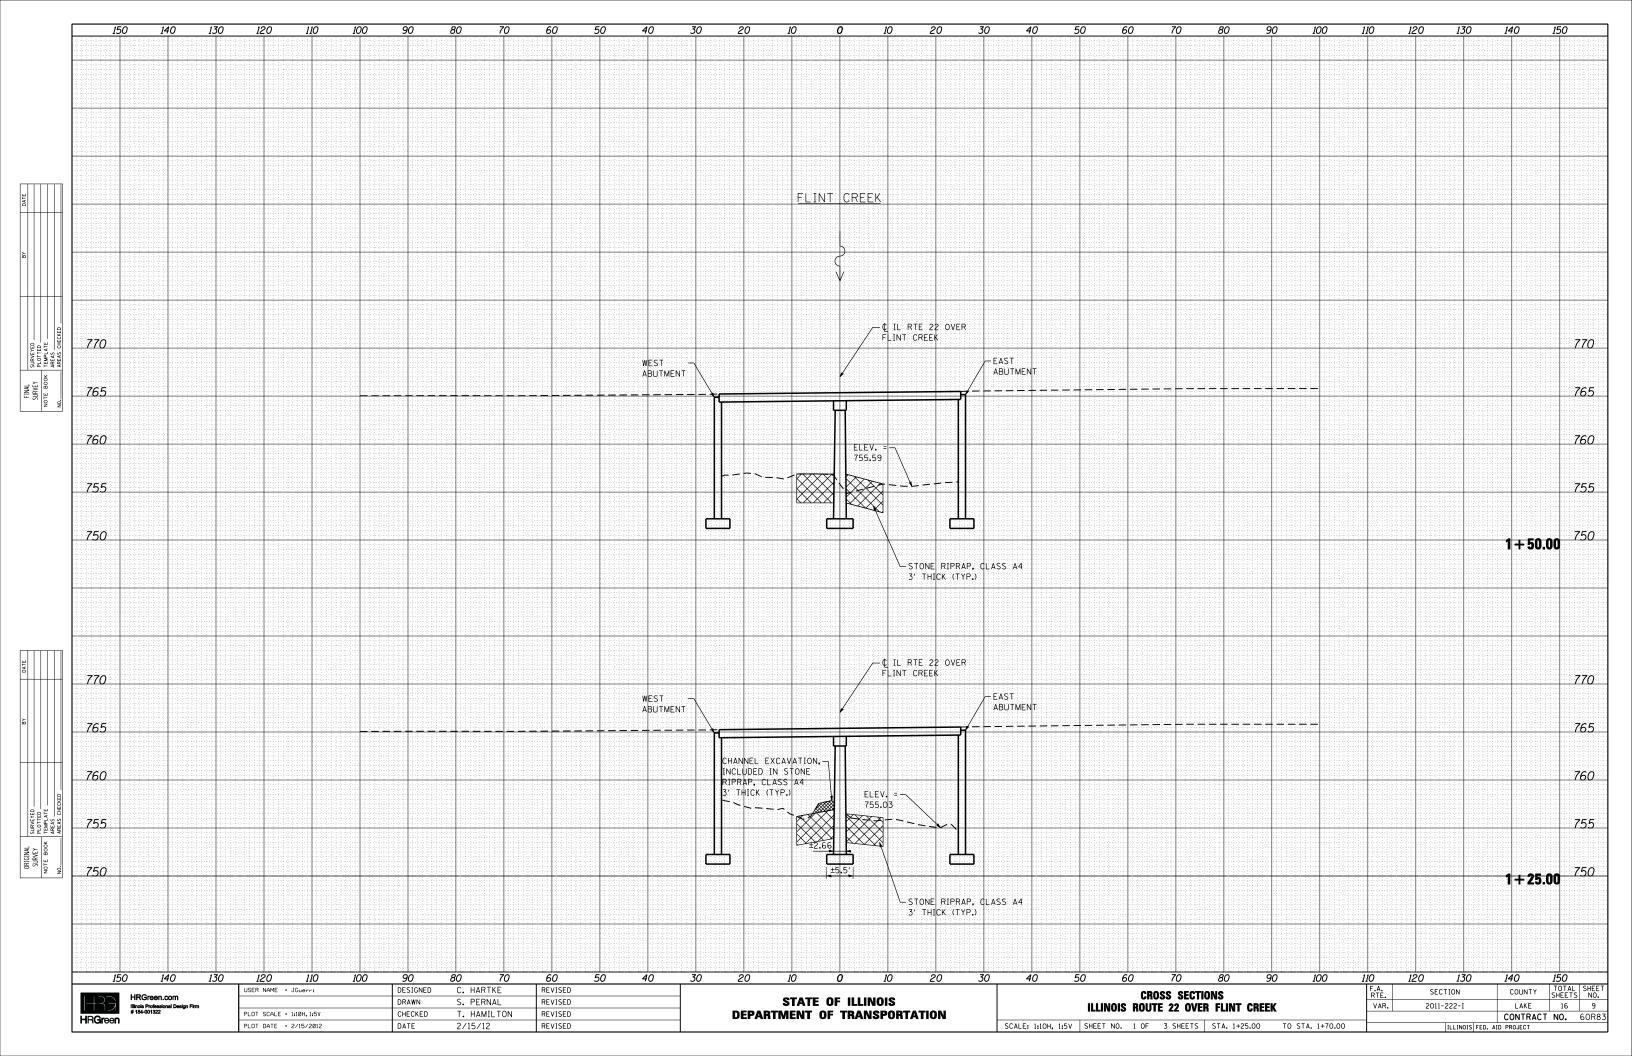- A. FOR NO LANE RESTRICTION ON THE SIDE ROAD OR DRIVEWAYS
- 1. SIDE ROAD WITH A SPEED LIMIT OF 40 MPH (60 km/b) OR LESS AS SHOWN ON THE DRAWING AND AS DIRECTED BY THE ENGINEER:
- OF THE MAIN ROLLTE.
- b) THE CLOSED PORTION OF THE MAIN ROUTE SHALL BE PROTECTED BY BLOCKING WITH TYPE I, TYPE II OR TYPE III BARRICADES, 1/3 OF THE CROSS SECTION OF THE CLOSED PORTION.
- 2. SIDE ROAD WITH A SPEED LIMIT GREATER THAN 40 MPH (60 km/h)
 AS SHOWN ON THE DRAWING AND AS DIRECTED BY THE ENGINEER:
- a) ONE ROAD CONSTRUCTION AHEAD SIGN 48 x 48 (1,2 m x 1,2 m) WITH A FI ASHER MOINTED ON 1T APPROXIMATELY 500' (150 m) IN ADVANCE OF THE MAIN ROUTE.
- b) THE CLOSED PORTION OF THE MAIN ROUTE SHALL BE PROTECTED BY BLOCKING WITH TYPE III BARRICADES, 1/2 OF THE CROSS SECTION OF THE CLOSED PORTION.
- WHEN THE SIDE ROAD LIES BETWEEN THE BEGINNING OF THE MAINLINE SIGNING AND THE WORK ZONE, A SINGLE HEADED ARROW (M6-1) SHALL BE USED IN LIEU OF THE DOUBLE HEADED ARROW (M6-4).

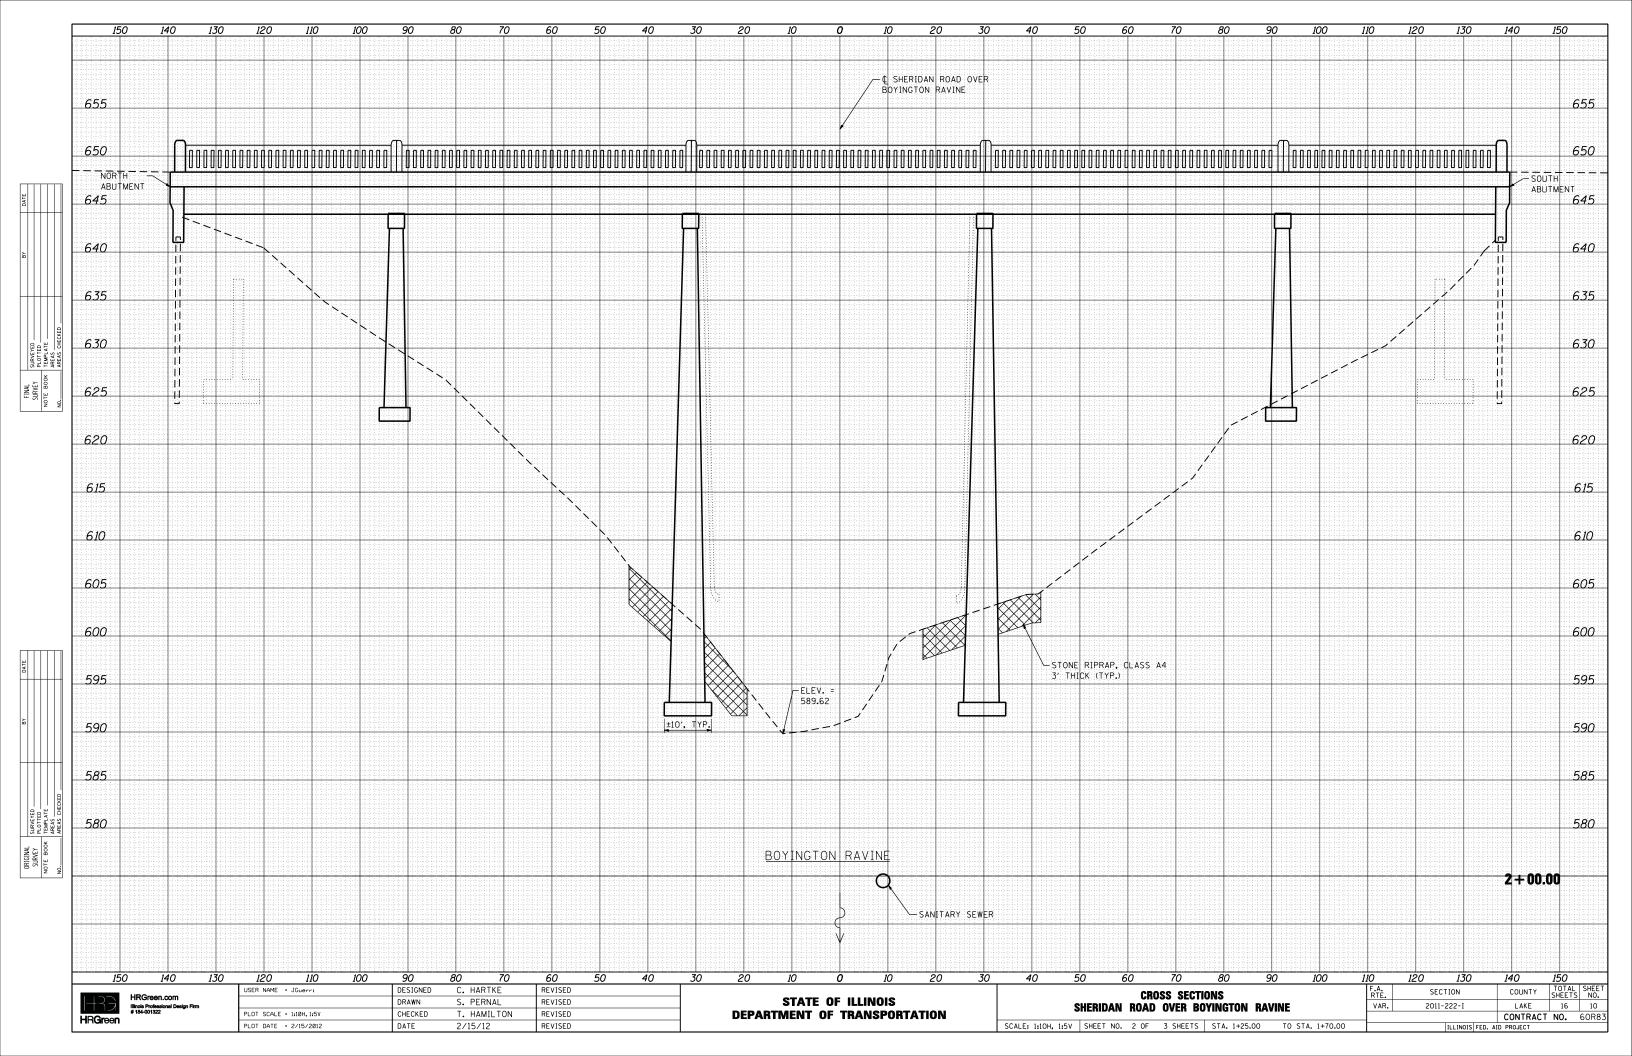SCALE: NONE

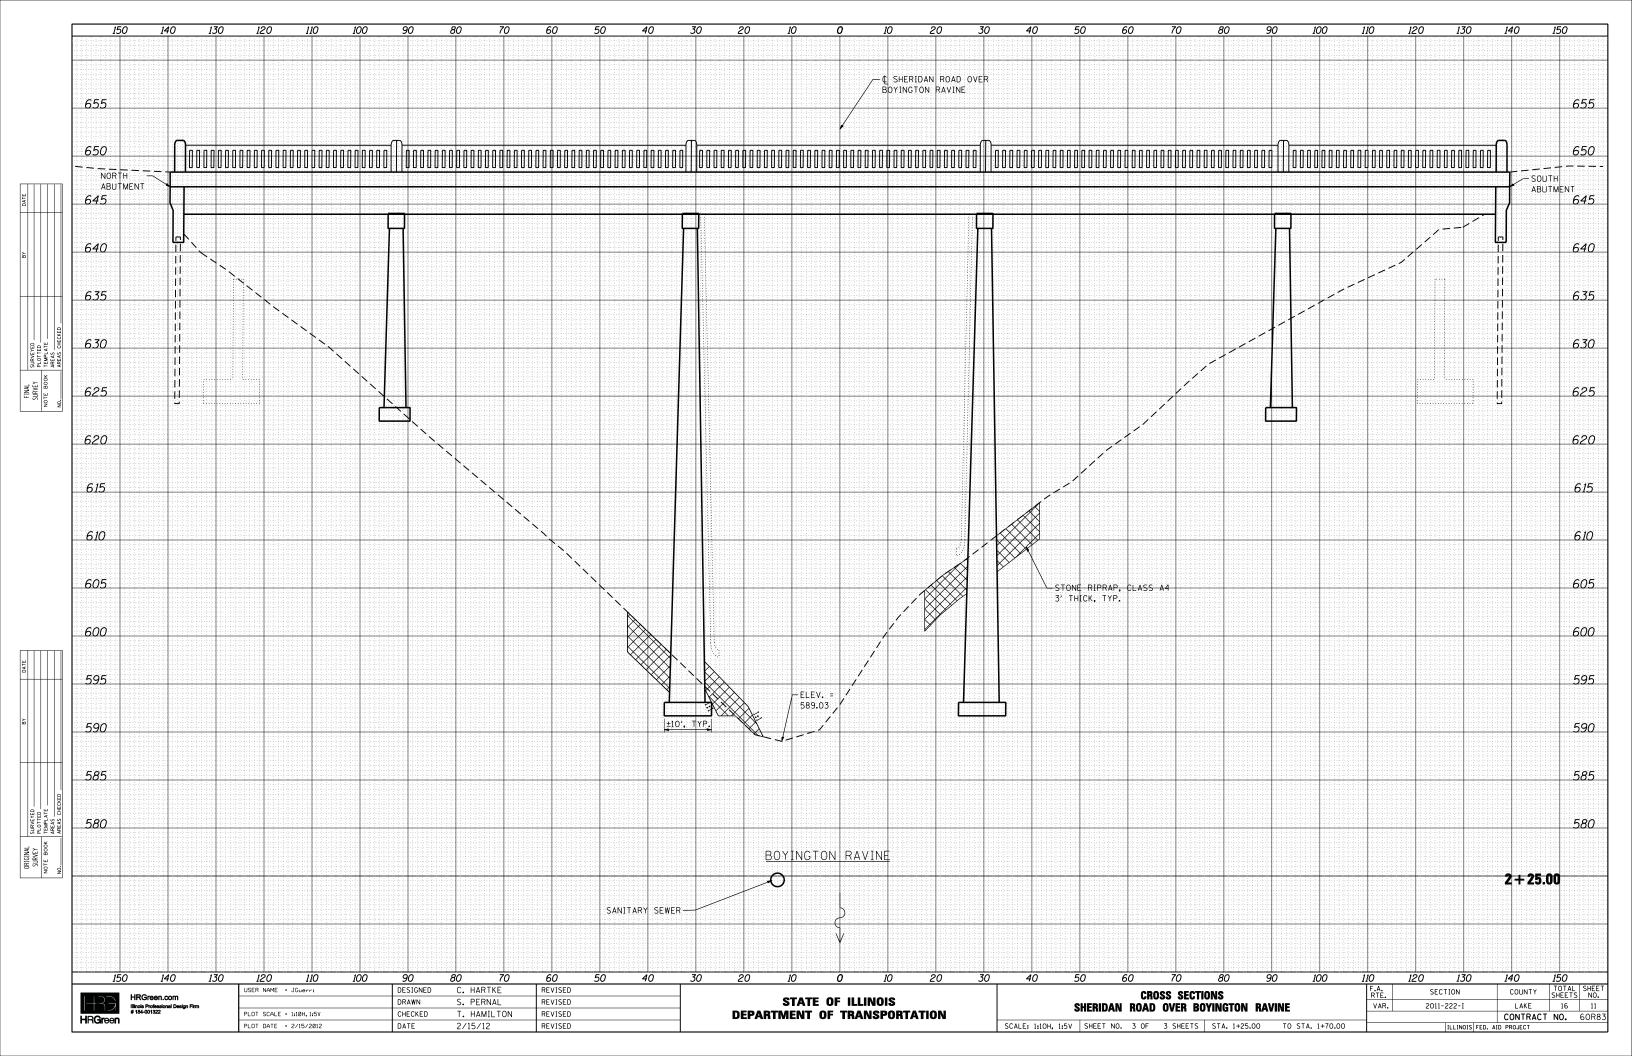- B. FOR A LANE CLOSURE ON A SIDE ROAD OR DRIVEWAY:
- USE APPLICABLE PORTIONS OF THE TYPICAL APPLICATION OF TRAFFIC CONTROL DEVICES (STD. 701501, STD. 701606 OR THE APPROPRIATE STANDARD). THE SPACING OF SIGNS AND BARRICADES SHALL BE ADJUSTED FOR FIELD CONDITIONS AS DIRECTED BY THE ENGINEER. THE DIRECTIONAL ARROW SHALL BE COVERED OR REMOVED WHEN NO LONGER CONSISTENT WITH THE SIDE ROAD LANE CLOSURE.
- C. ADVANCE WARNING SIGNS ARE TO BE OMITTED ON DRIVEWAY UNLESS OTHERWISE NOTED.
- D. THE TRAFFIC CONTROL AND PROTECTION FOR SIDE ROADS, INTERSECTIONS, AND DRIVEWAYS SHALL BE INCIDENTAL TO THE COST OF SPECIFIED TRAFFIC CONTROL STANDARDS OR ITEMS.

All dimensions are in millimeters (inches) unless otherwise shown.




	USER NAME = gaglianobt	DESIGNED	-	LHA	REVISED	-	J. OBERLE	10-18-95
		DRAWN	-		REVISED	-	A. HOUSEH	03-06-96
1	PLOT SCALE = 50.000 '/ IN.	CHECKED	-		REVISED	-	A. HOUSEH	10-15-96
	PLOT DATE = 1/4/2000	DATE	-	06-89	REVISED	- T.	RAMMACHE	R 01-06-0

STATI	E OF	ILLINOIS
DEPARTMENT	OF	TRANSPORTATION


	TRAFFIC CONTROL AND PROTECTION FOR SIDE ROADS, INTERSECTIONS, AND DRIVEWAYS				F.A RTE.	SECTION	COUNTY	TOTAL SHEETS	SHEET NO.	
					VAR.	2011-222-I	LAKE	16	12	
						TC-10	CONTRACT	NO.	60R8	
	SHEET NO.	1 OF	5 SHEETS	STA.	TO STA.	FFO. R	DAO DIST. NO. 1 THE INDIS FED. AT	D PROJECT		

HRGreen

USER NAME = gaglianobt DESIGNED REVISED - R. MIRS 09-15-97 DRAWN REVISED - R. MIRS 12-11-97 LOT SCALE = 50.000 '/ IN. CHECKED REVISED -T. RAMMACHER 02-02-9 LOT DATE = 1/4/2008 DATE REVISED - C. JUCIUS 01-31-07

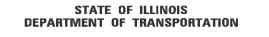

SECTION ARTERIAL ROAD VAR. 2011-222-I INFORMATION SIGN TC-22 CONTRACT NO. 60R8 SHEET NO. 2 OF 5 SHEETS STA. TO STA. FED. ROAD DIST. NO. 1 | ILLINOIS FED. AID PROJECT

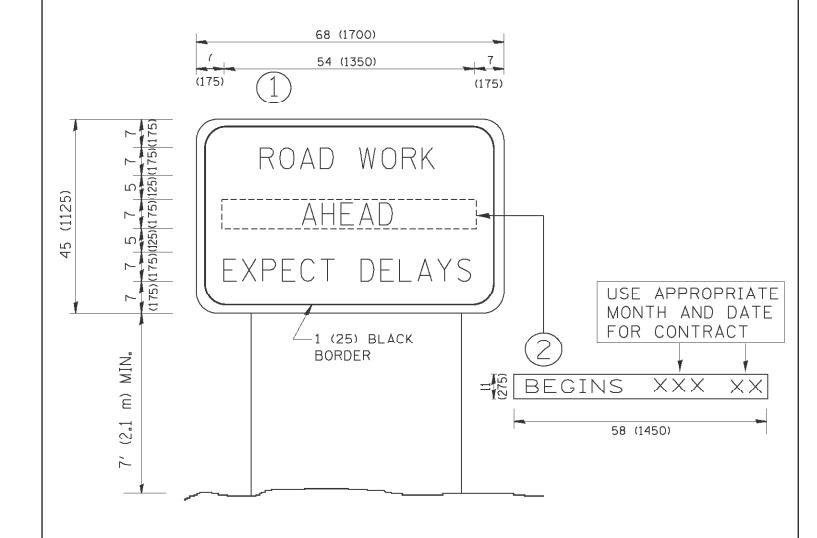

NOTES:

1. USE BLACK LETTERING ON ORANGE BACKGROUND.

SCALE: NONE

- 2. ERECT SIGNS IN ADVANCE OF THE LOCATION FOR THE "ROAD CONSTRUCTION AHEAD" SIGN AT LOCATIONS AS DIRECTED BY THE ENGINEER.
- 3. ERECT SIGN (1) WITH INSTALLED PANEL (2) ONE WEEK PRIOR TO THE START OF CONSTRUCTION.
- 4. REMOVE PANEL (2) SOON AFTER THE START OF CONSTRUCTION.
- 5. SEE SPECIAL PROVISION FOR "TEMPORARY INFORMATION SIGNING" FOR ADDITIONAL INFORMATION.
- 6. ONE SIGN ASSEMBLY EQUALS 25.70 SQ. FT. (2.3 SQ. M.)
- 7. SHALL BE PAID FOR AS TEMPORARY INFORMATION SIGNING.

ALL DIMENSIONS ARE IN INCHES (MILLIMETERS) UNLESS OTHERWISE SHOWN.

LAKE

16 13

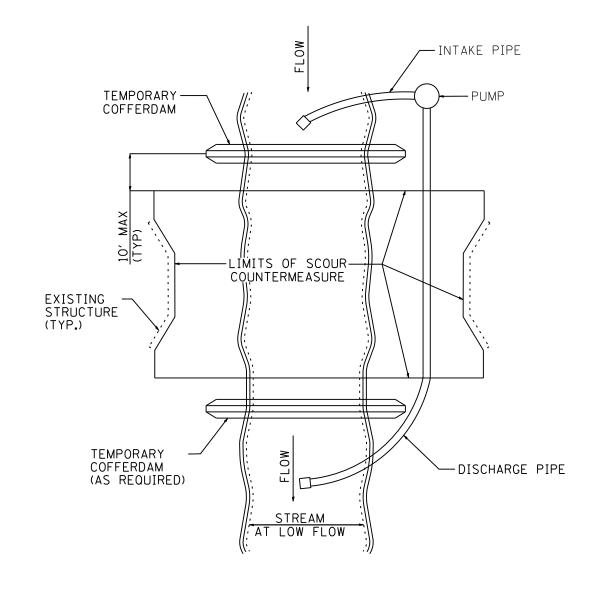


FIGURE D1. TEMPORARY COFFERDAM WITH PUMP BYPASS

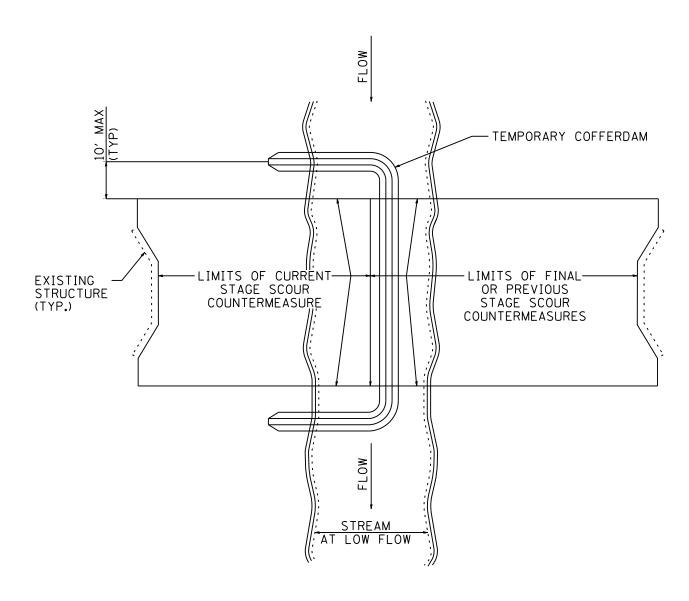


FIGURE D2. STAGED IN-STREAM COFFERDAM DIVISION


NOTE: DEWATERING SYSTEM DETAILS SHALL BE USED IN CONJUCTION WITH THE PROJECT SPECIAL PROVISIONS.

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PLOT SCALE = N/A	CHECKED -	REVISED -
PLOT DATE = 2/15/2012	DATE - 2/15/12	REVISED -

STATE OF ILLINOIS
DEPARTMENT OF TRANSPORTATION



DISPOSE OF SILT BY TRANSPORTING THE FILLED BAG TO DISPOSAL AREA. SLIT THE BAG, BLEND SILT INTO EXISTING TOPOGRAPHY, SEED AND MULCH

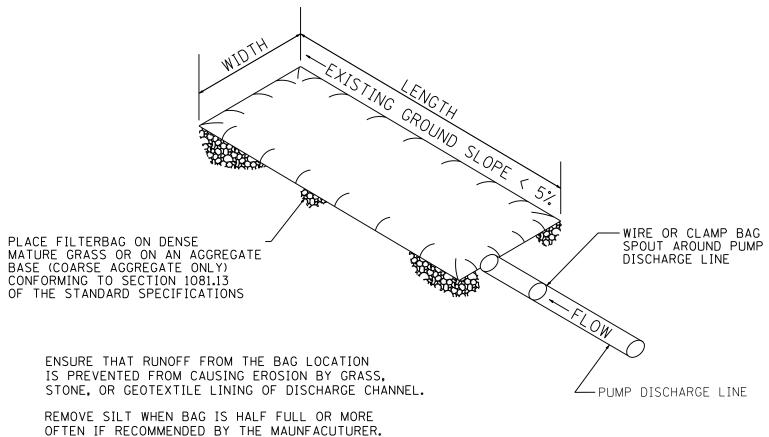MAINTAIN EXTRA FILTER BAGS ON SITE. REPLACE DAMAGED BAGS PROMPTLY.

TYPICAL FLOW RATE: 10 GPM x W x L

FIGURE S1. SEDIMENT FILTER BAG

NOTE: DEWATERING SYSTEM DETAILS SHALL BE USED IN CONJUCTION WITH THE PROJECT SPECIAL PROVISIONS.

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LE: Struct 22x3


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#184-001322

USER NAME = JGuerrı	DESIGNED -	REVISED -	
	DRAWN -	REVISED -	
PLOT SCALE = N/A	CHECKED -	REVISED -	
PLOT DATE = 2/15/2012	DATE - 2/15/12	REVISED -	


STATE	OF ILLINOIS
DEPARTMENT (OF TRANSPORTATION

SCALE: N/A

DEWATERING SYSTEM DETAILS		F.A. RTE.	SEC.	TION		COUNTY	TOTAL SHEETS				
					VAR.	2011-	222-I		LAKE	16	15
									CONTRACT	NO.	60R83
	SHEET NO. 4 OF	5 SHEETS	STA.	TO STA.	FED. RO	DAD DIST. NO.	ILLINOIS FE	ED. AIC	PROJECT		

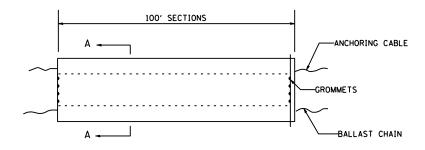

ELEVATION

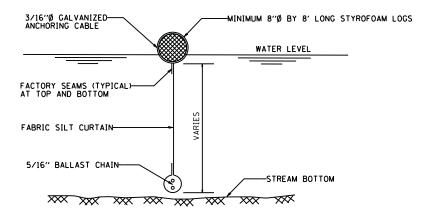


SECTION A-A

FLOTATION BOOM


NOTES:

- FLOTATION BOOM SHALL BE ANCHORED TO PREVENT DRIFT SHOREWARD OR DOWNSTREAM. ANCHORAGES SHALL BE INSTALLED ON BOTH SHORE AND STREAM SIDE.
- 2. SHORE ANCHORS SHALL CONSIST OF A POST WITH DEADMAN OR APPROVED EQUAL. STREAM ANCHORS SHALL BE SUFFICIENT SIZE TO STABILIZE THE BARRIER WITH NUMBER AND SPACING DEPENDENT ON WATERWAY VELOCITIES.
- 3. FABRIC SECTIONS SHALL BE CONNECTED END TO END WITH MINIMUM 5/8" DIAMETER POLYPROPYLENE ROPE
- 4. DESIGN OF BOOM AND ANCHORAGE SHALL BE IN ACCORANDANCE WITH MANUFACTURER'S RECOMENDATIONS. BOTTOM OF BOOM SHALL REACH BOTTOM OF WATERWAY USING ONE OR TWO VERTICAL SECTIONS AS REQUIRED.
- 5. MAINTENANCE SHALL BE PERFORMED AS NEEDED. CONTRACTOR SHALL REMOVE THE BOOM AT COMPLETION OF WORK IN A MANNER THAT WILL PREVENT SILTATION OF THE WATERWAY.

APPLICATION: FLOTATION BOOMS TO BE USED TO CONTROL EROSION, TURBIDITY AND DEBRIS WHEN WORKING IN WATERWAYS.

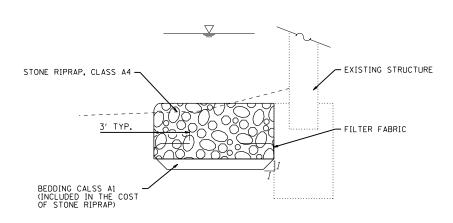

FILTER FABRIC/ RIPRAP DETAIL

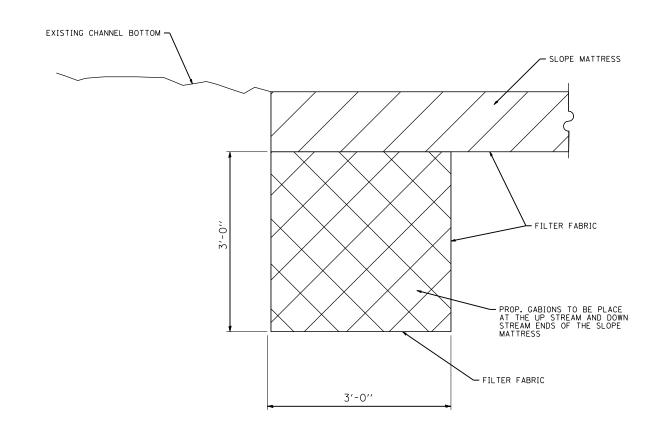

MATTRESS ANCHORING DETAIL

HRGreen	HRGreen.u Illinois Professio # 184-001322

USER NAME = JGuerrı	DESIGNED -	REVISED -
	DRAWN -	REVISED -
PLOT SCALE = N/A	CHECKED -	REVISED -
PLOT DATE = 2/15/2012	DATE - 2/15/12	REVISED -

STATE OF	ILLINOIS
DEPARTMENT OF	TRANSPORTATION

DETAILS				F.A. SECTION		COUNTY	TOTAL	SHEET NO.		
				VAR.	. 2011-222-I		LAKE	16	16	
								CONTRACT	NO.	60R83
SCALE: N/A	SHEET NO. 5 OF	5 SHEETS	STA.	TO STA.	FED. ROAD DIST. NO. ILLINOIS FED. AID PROJECT			AID PROJECT		