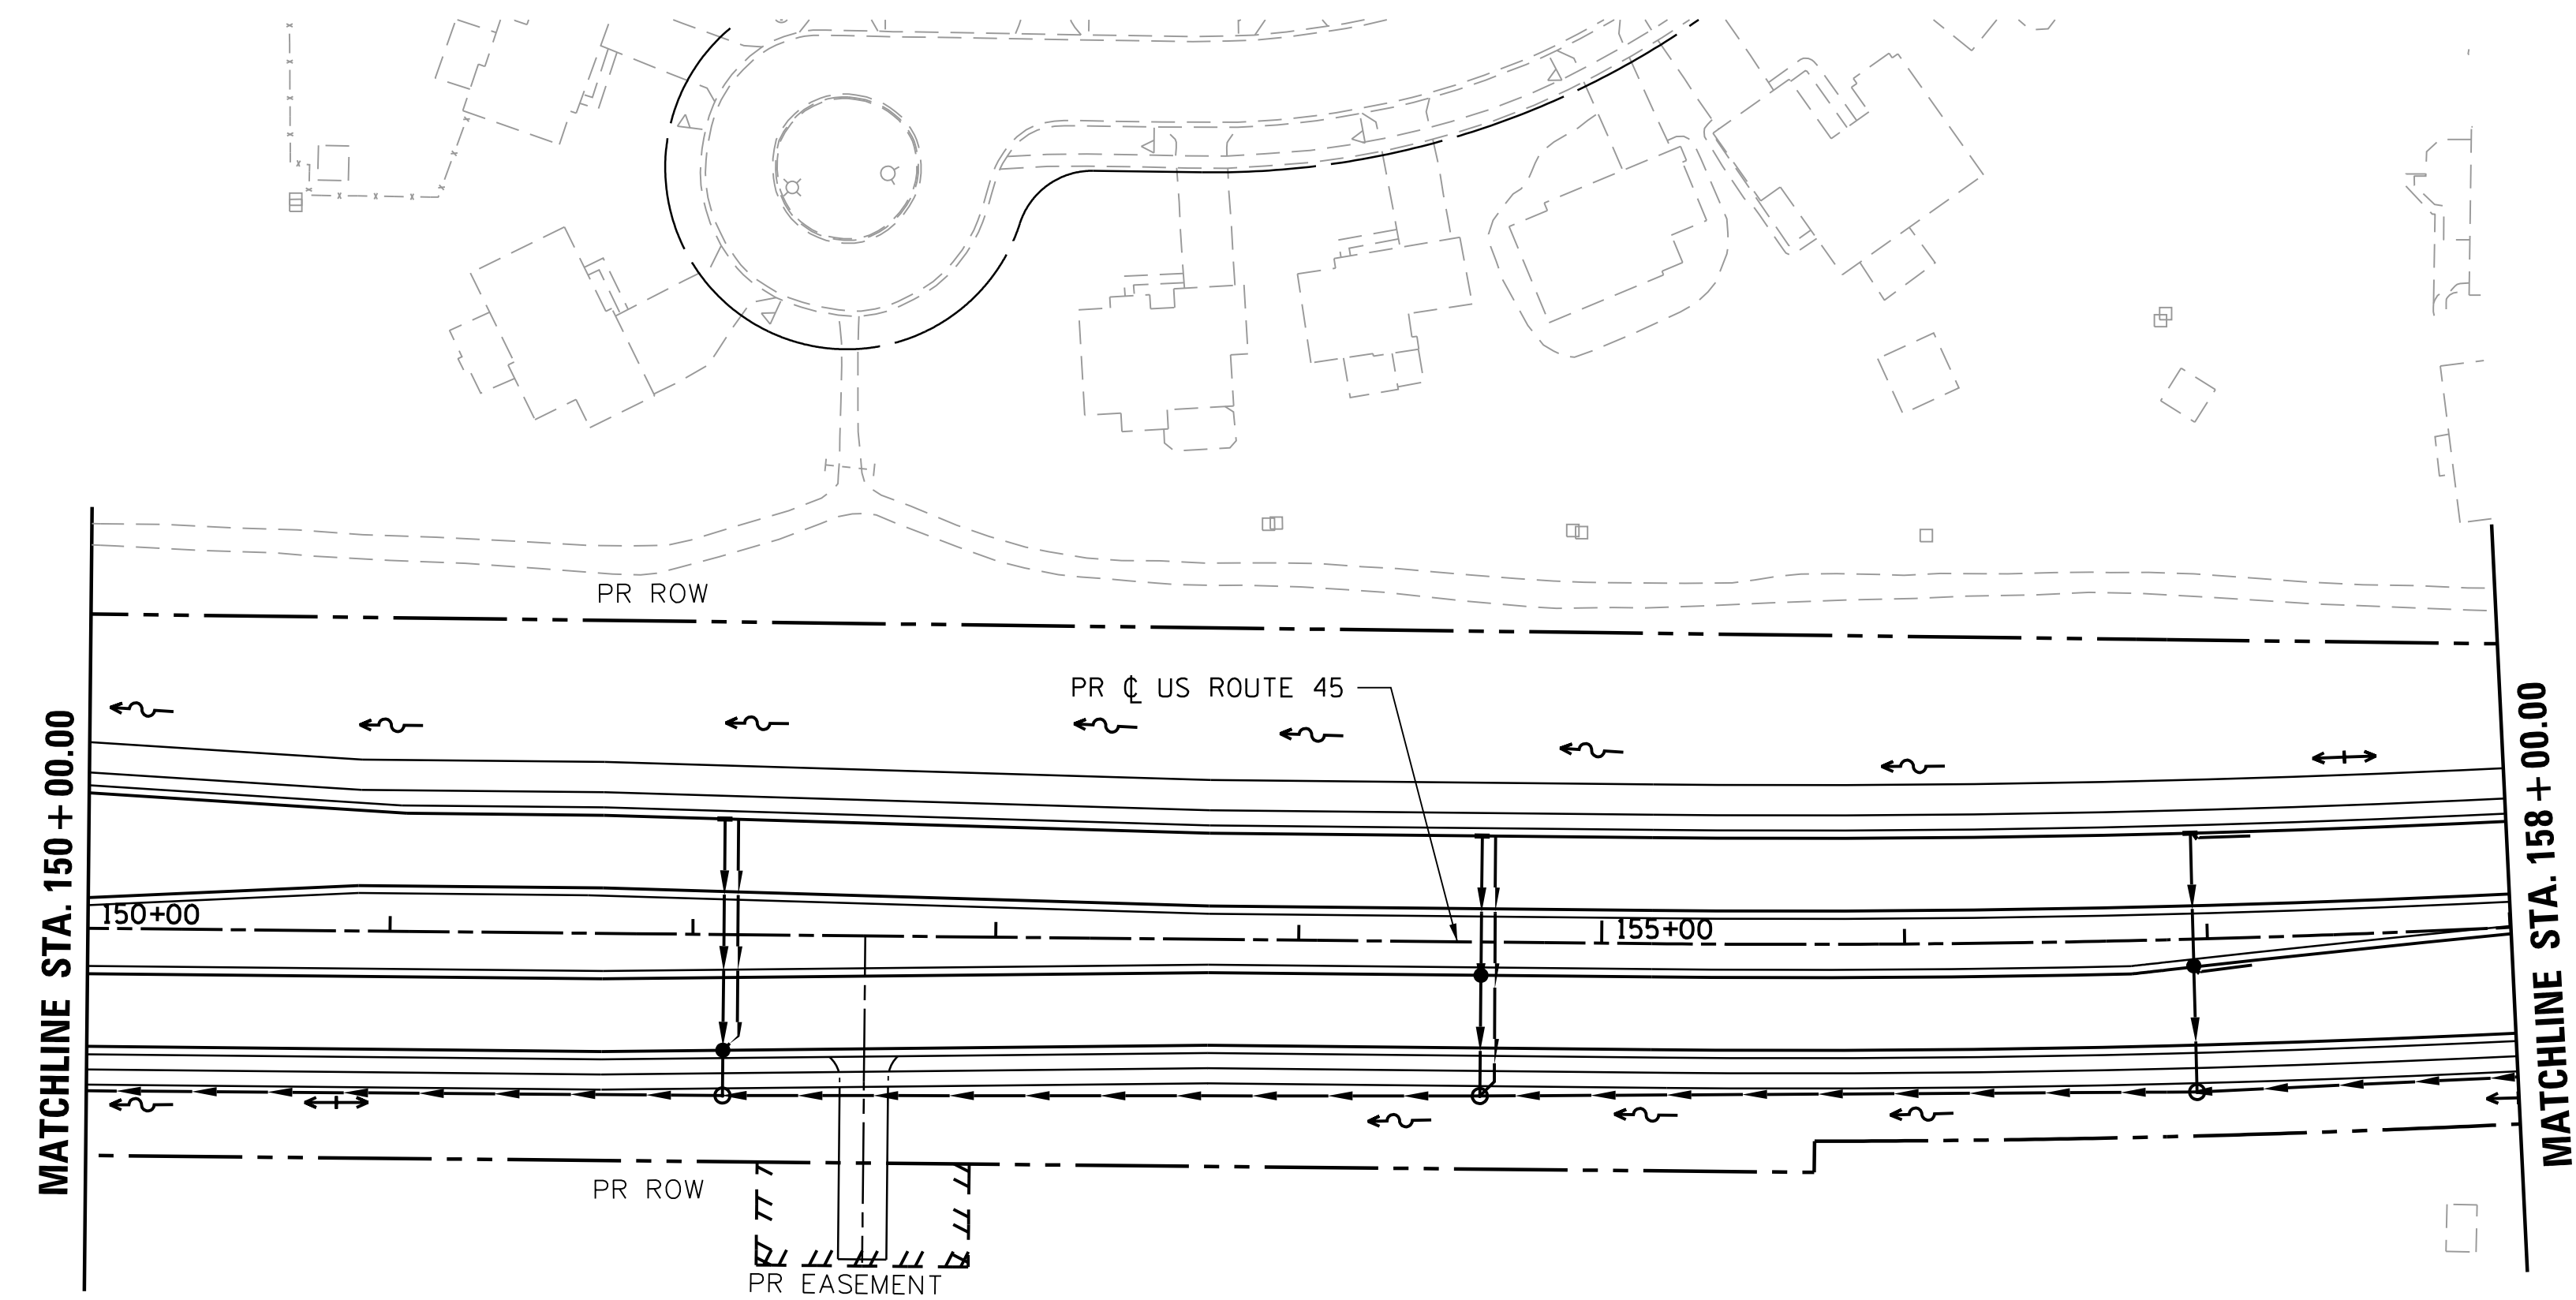
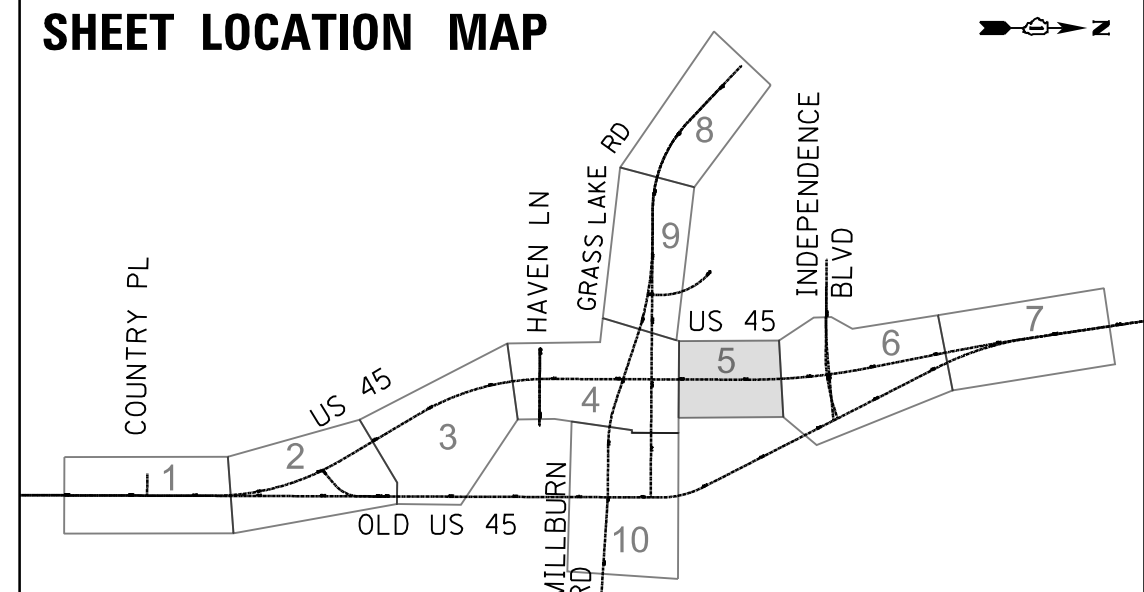
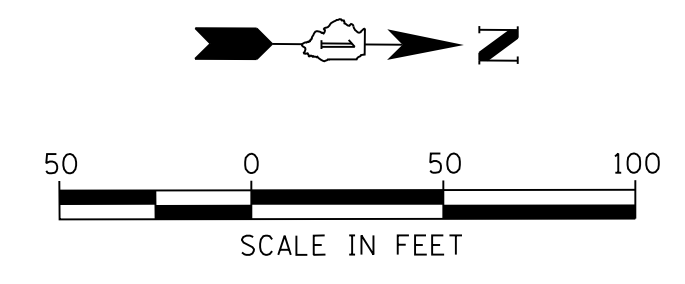


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	PLOTTED		
	CHECKED		
	ALIGNMENT		
	PROPOSED		
	ROAD FILE NAME		
	NO.		

PROFILE	SURVEYED	BY	DATE
	PLOTTED		
	GRADES CHECKED		
	STRUCTURE		
	NOT AT THIS OFFICE		
	NO.		

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- MAINTENANCE OF TRAFFIC LEGEND**
- WORK ZONE
 - TEMPORARY PAVEMENT
 - TEMPORARY PAVEMENT PLACED IN PREVIOUS STAGE
 - TRAFFIC FLOW
 - TYPE II BARRICADES OR DRUMS WITH BI-DIRECTIONAL STEADY BURN LIGHT AT 50' C-C (TYP.), 25' C-C IN CURVES AND RADII, AND 20' C-C IN TAPERS
 - DOUBLE VERTICAL PANEL WITH STEADY BURN BI-DIRECTIONAL LIGHT
 - FLAGGER WITH TRAFFIC CONTROL DEVICE
 - TYPE III BARRICADE
 - TEMPORARY CONCRETE BARRIER

- MAINTENANCE OF TRAFFIC PAVEMENT MARKING**
- ① TEMPORARY PAVEMENT MARKING, LINE 4" WHITE
 - ② TEMPORARY PAVEMENT MARKING, LINE 4" DOUBLE YELLOW AT 11" C-C
 - ③ TEMPORARY PAVEMENT MARKING, LINE 24" WHITE YELLOW AT 50' C-C
 - ④ TEMPORARY PAVEMENT MARKING, LINE 12" YELLOW AT 50' C-C
 - ⑤ TEMPORARY PAVEMENT MARKING, LINE 4", WHITE (10'-30' SKIP DASH)
 - ⑥ TEMPORARY PAVEMENT MARKING LETTERS AND SYMBOLS
 - ⑦ TEMPORARY PAVEMENT MARKING, LINE 4", WHITE (2'-6' SKIP DASH)
- MAINTENANCE OF TRAFFIC SIGNING**
- ⓧ REMOVE EXISTING SIGN
 - Ⓜ RELOCATE EXISTING SIGN
 - Ⓞ COVER EXISTING SIGN

USER NAME = 35361	DESIGNED MO	REVISED -
	DRAWN MO	REVISED
PLOT SCALE = 50.0000' / in.	CHECKED FZ	REVISED
PLOT DATE = 9/14/2017	DATE 02/02/2017	REVISED

**STATE OF ILLINOIS
DEPARTMENT OF TRANSPORTATION**

**MAINTENANCE OF TRAFFIC
STAGE 2**

SCALE: 1"=50' SHEET 5 OF 10 SHEETS STA. 150+00 TO STA. 158+00



F.A.P. RTE.	SECTION	COUNTY	TOTAL SHEETS	SHEET NO.
344	39 R	LAKE	510	102
CONTRACT NO. 60T75				

ILLINOIS FED. AID PROJECT

PLAN	SURVEYED	BY	DATE
	PLOTTED		
	CHECKED		
	AT		
	FILE NAME		

PROFILE	SURVEYED	BY	DATE
	PLOTTED		
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	AT		
	FILE NAME		

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MAINTENANCE OF TRAFFIC LEGEND

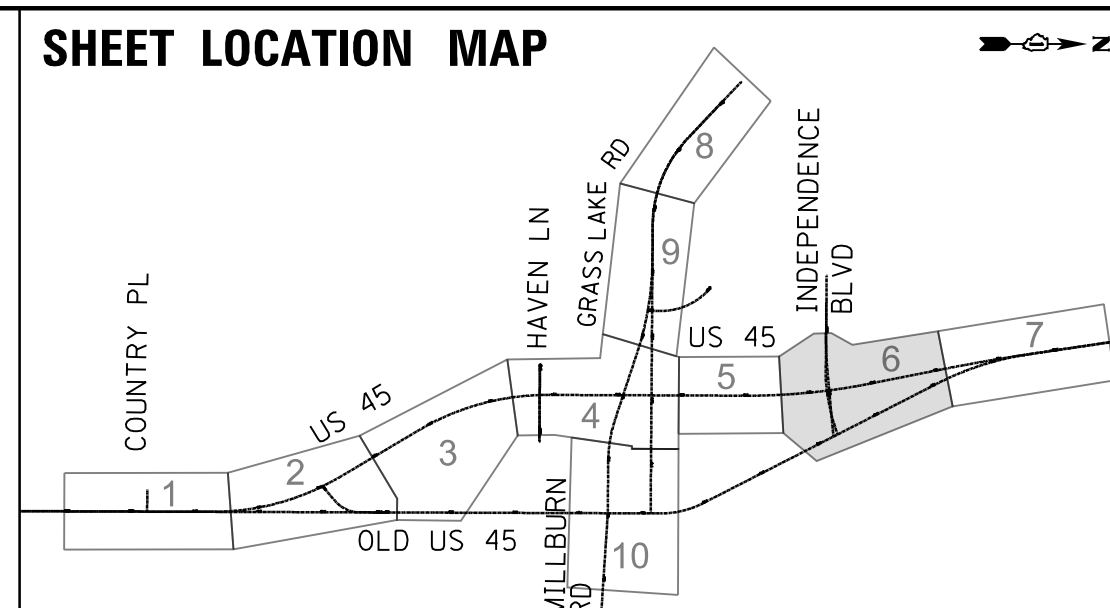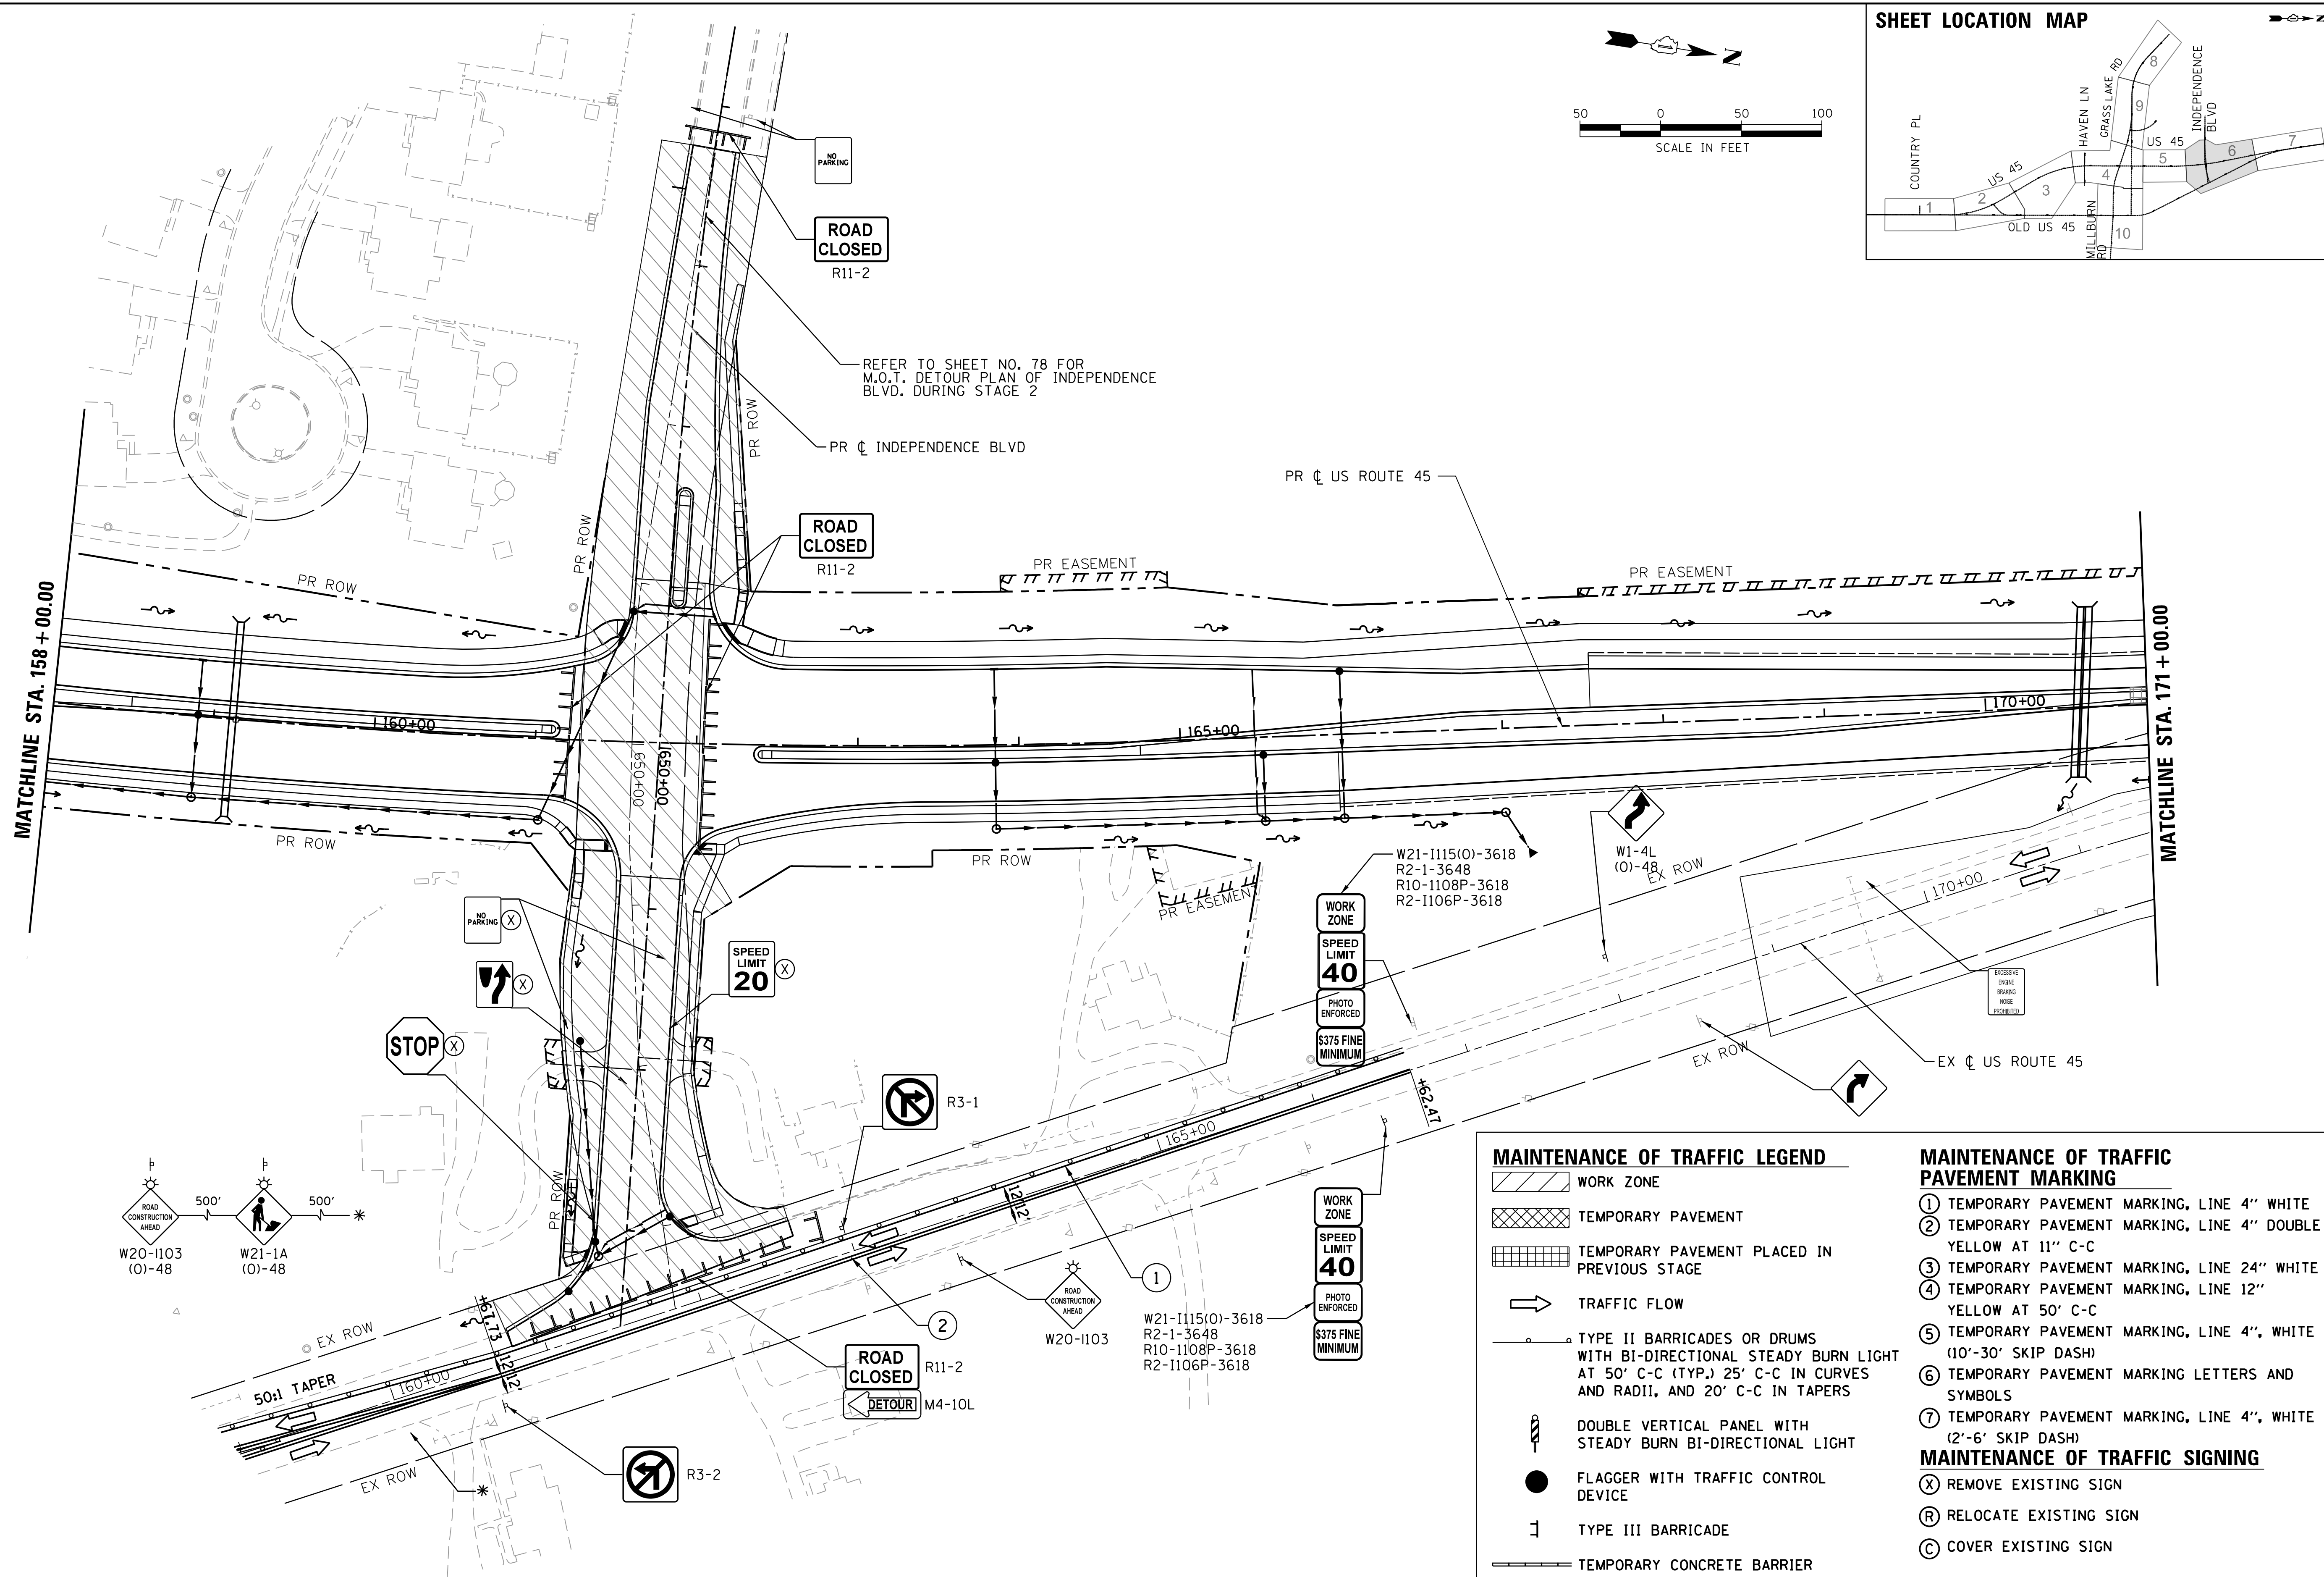- WORK ZONE
- TEMPORARY PAVEMENT
- TEMPORARY PAVEMENT PLACED IN PREVIOUS STAGE
- TRAFFIC FLOW
- TYPE II BARRICADES OR DRUMS WITH BI-DIRECTIONAL STEADY BURN LIGHT AT 50' C-C (TYP.), 25' C-C IN CURVES AND RADII, AND 20' C-C IN TAPERS
- DOUBLE VERTICAL PANEL WITH STEADY BURN BI-DIRECTIONAL LIGHT
- FLAGGER WITH TRAFFIC CONTROL DEVICE
- TYPE III BARRICADE
- TEMPORARY CONCRETE BARRIER

MAINTENANCE OF TRAFFIC PAVEMENT MARKING

- ① TEMPORARY PAVEMENT MARKING, LINE 4" WHITE
- ② TEMPORARY PAVEMENT MARKING, LINE 4" DOUBLE YELLOW AT 11" C-C
- ③ TEMPORARY PAVEMENT MARKING, LINE 24" WHITE
- ④ TEMPORARY PAVEMENT MARKING, LINE 12" YELLOW AT 50' C-C
- ⑤ TEMPORARY PAVEMENT MARKING, LINE 4", WHITE (10'-30' SKIP DASH)
- ⑥ TEMPORARY PAVEMENT MARKING LETTERS AND SYMBOLS
- ⑦ TEMPORARY PAVEMENT MARKING, LINE 4", WHITE (2'-6' SKIP DASH)

MAINTENANCE OF TRAFFIC SIGNING

- ⓧ REMOVE EXISTING SIGN
- Ⓡ RELOCATE EXISTING SIGN
- Ⓢ COVER EXISTING SIGN

USER NAME = 35361	DESIGNED MO	REVISED -
	DRAWN MO	REVISED -
PLOT SCALE = 50.0000' / 1"	CHECKED FZ	REVISED -
PLOT DATE = 9/14/2017	DATE 02/02/2017	REVISED -

STATE OF ILLINOIS
DEPARTMENT OF TRANSPORTATION

MAINTENANCE OF TRAFFIC
STAGE 2




SCALE: 1"=50' SHEET 6 OF 10 SHEETS STA. 158+00 TO STA. 171+00

F.A.P. RTE.	SECTION	COUNTY	TOTAL SHEETS	SHEET NO.
344	39 R	LAKE	510	103
				CONTRACT NO. 60T75
ILLINOIS FED. AID PROJECT				

PLAN	SURVEYED	BY	DATE
	PLOTTED		
	GRADES CHECKED		
	STRUCTURE NOTATIONS CHECKED		
	NOTE BOOK NO.		
	CADD FILE NAME		

PROFILE	SURVEYED	BY	DATE
	PLOTTED		
	GRADES CHECKED		
	STRUCTURE NOTATIONS CHECKED		
	NOTE BOOK NO.		
	CADD FILE NAME		

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NOTE: W21-1 AND/OR W20-7(0)-48 MUST BE REMOVED WHEN FLAGGER OR WORKER ARE NOT PRESENT FOR MORE THAN ONE HOUR

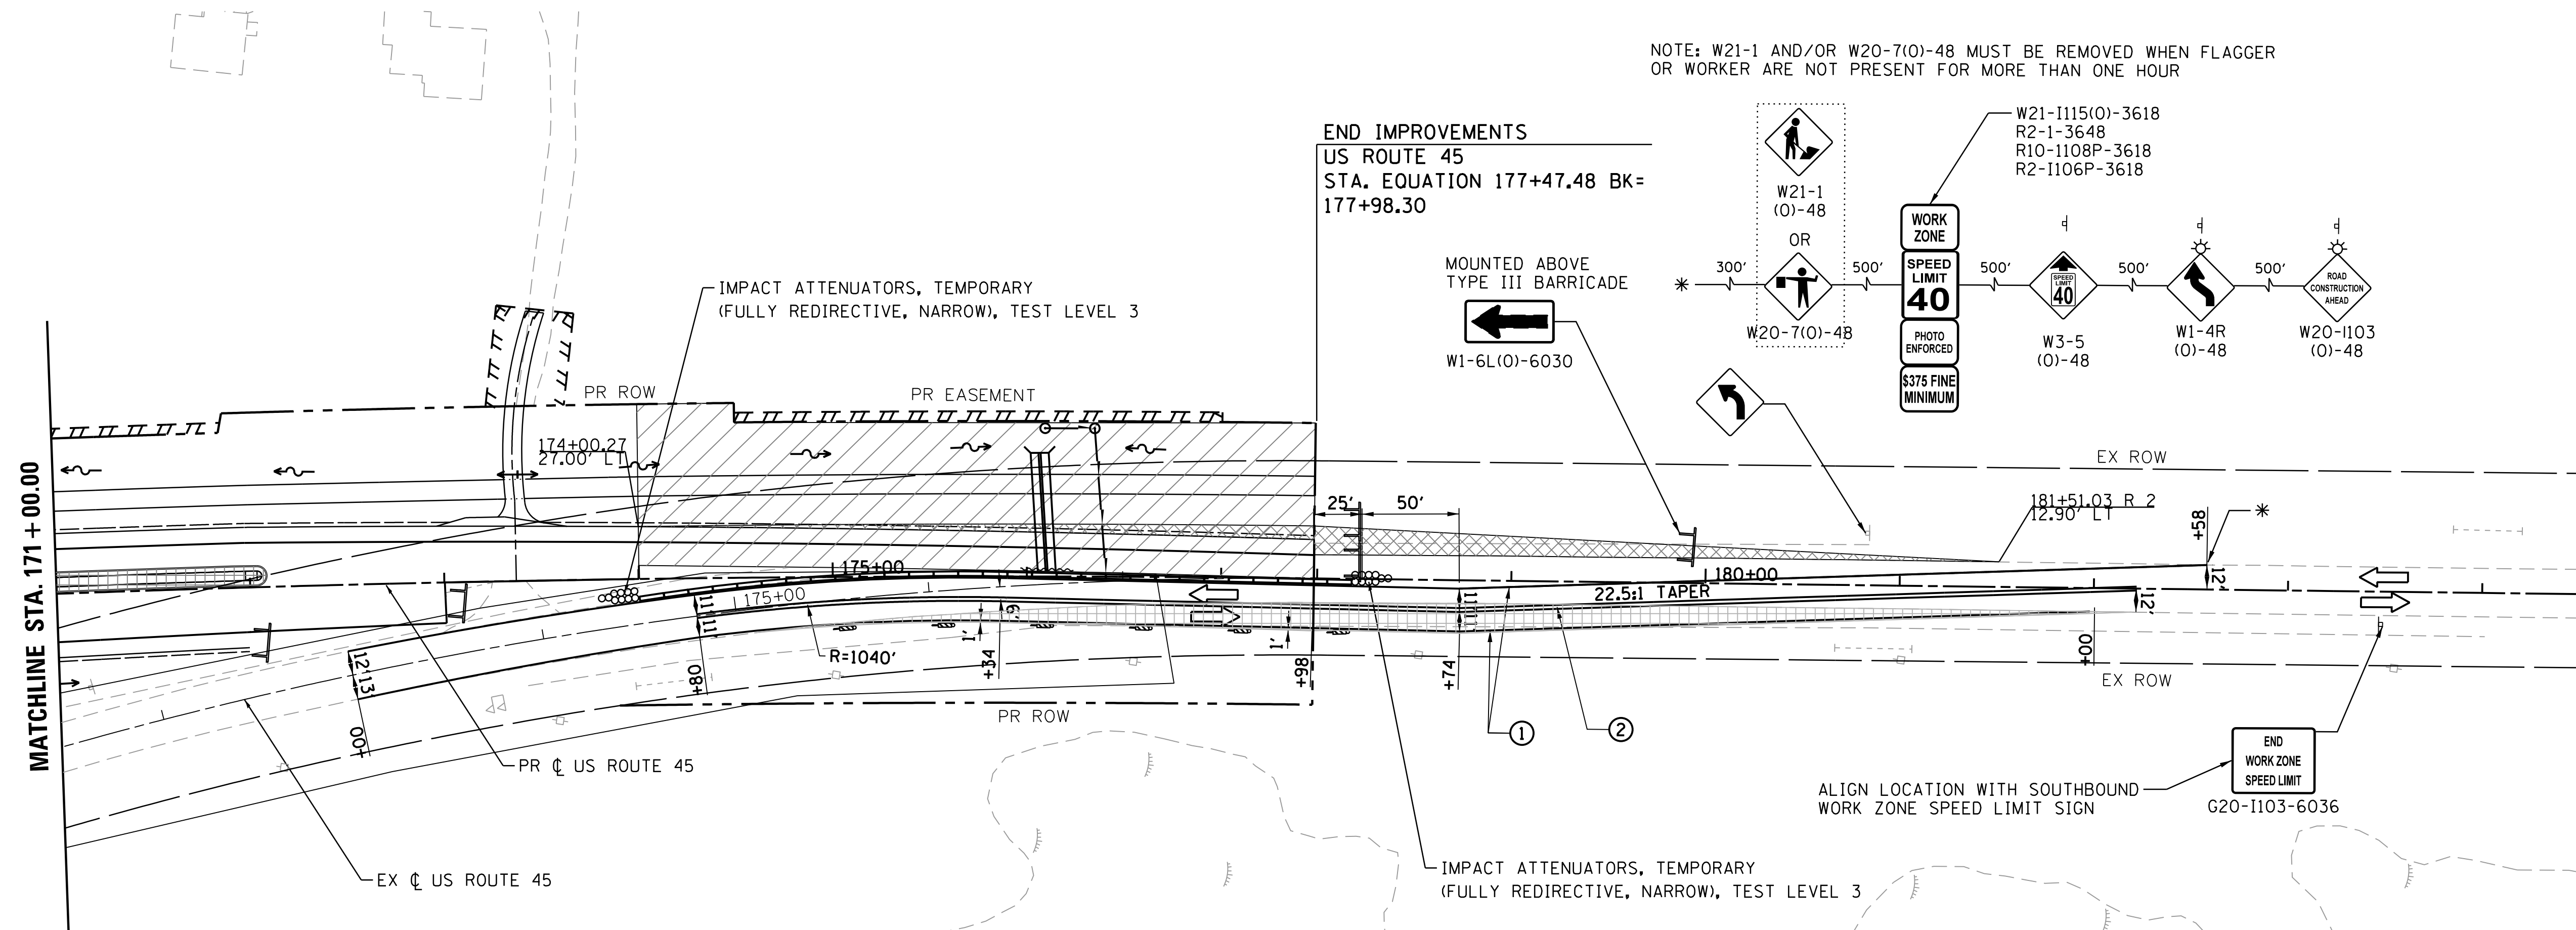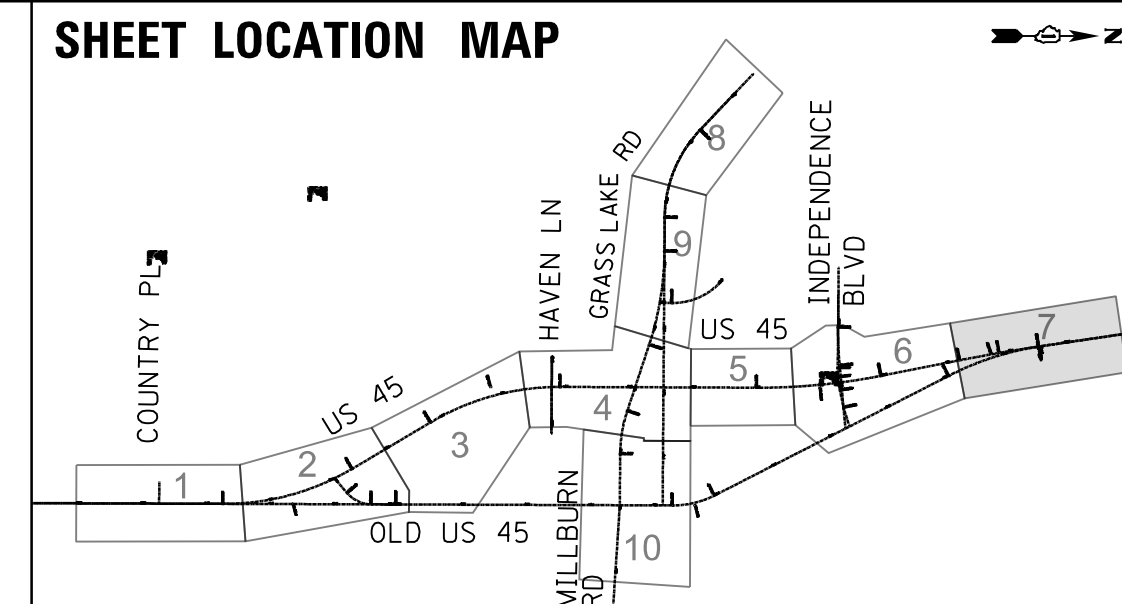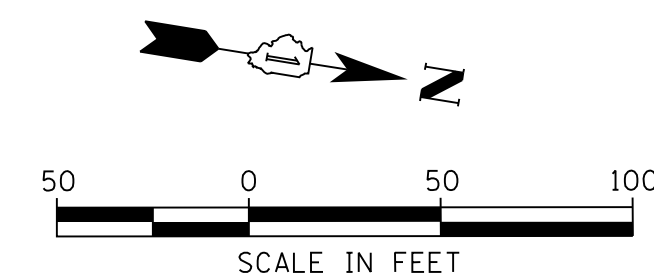END IMPROVEMENTS
US ROUTE 45
STA. EQUATION 177+47.48 BK=
177+98.30

MAINTENANCE OF TRAFFIC LEGEND

- WORK ZONE
- TEMPORARY PAVEMENT
- TEMPORARY PAVEMENT PLACED IN PREVIOUS STAGE
- TRAFFIC FLOW
- TYPE II BARRICADES OR DRUMS WITH BI-DIRECTIONAL STEADY BURN LIGHT AT 50' C-C (TYP), 25' C-C IN CURVES AND RADII, AND 20' C-C IN TAPERS
- DOUBLE VERTICAL PANEL WITH STEADY BURN BI-DIRECTIONAL LIGHT
- FLAGGER WITH TRAFFIC CONTROL DEVICE
- TYPE III BARRICADE
- TEMPORARY CONCRETE BARRIER

MAINTENANCE OF TRAFFIC PAVEMENT MARKING

- ① TEMPORARY PAVEMENT MARKING, LINE 4" WHITE
- ② TEMPORARY PAVEMENT MARKING, LINE 4" DOUBLE YELLOW AT 11" C-C
- ③ TEMPORARY PAVEMENT MARKING, LINE 24" WHITE
- ④ TEMPORARY PAVEMENT MARKING, LINE 12" YELLOW AT 50' C-C
- ⑤ TEMPORARY PAVEMENT MARKING, LINE 4", WHITE (10'-30' SKIP DASH)
- ⑥ TEMPORARY PAVEMENT MARKING LETTERS AND SYMBOLS
- ⑦ TEMPORARY PAVEMENT MARKING, LINE 4", WHITE (2'-6' SKIP DASH)

MAINTENANCE OF TRAFFIC SIGNING

- ⓧ REMOVE EXISTING SIGN
- Ⓡ RELOCATE EXISTING SIGN
- Ⓢ COVER EXISTING SIGN

USER NAME = 35361	DESIGNED MO	REVISED -
	DRAWN MO	REVISED
PLOT SCALE = 50.0000' / in.	CHECKED FZ	REVISED
PLOT DATE = 9/14/2017	DATE 02/02/2017	REVISED

STATE OF ILLINOIS
DEPARTMENT OF TRANSPORTATION

MAINTENANCE OF TRAFFIC
STAGE 2




SCALE: 1"=50' SHEET 7 OF 10 SHEETS STA. 171+00 TO STA. 178+00

F.A.P. RTE.	SECTION	COUNTY	TOTAL SHEETS	SHEET NO.
344	39 R	LAKE	510	104
CONTRACT NO. 60T75				
ILLINOIS FED. AID PROJECT				

PLAN	SURVEYED	BY	DATE
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	NOTE BOOK		
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	CHECKED		
	AT		
	FILE NAME		


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	PLOTTED		
	GRADES CHECKED		
	STRUCTURE		
	NOT AT THIS OFFICE		
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BEGIN MILLING & RESURFACE
GRASS LAKE ROAD
STA. 283+70.77

BEGIN RECONSTRUCTION
GRASS LAKE ROAD
STA. 287+45.77

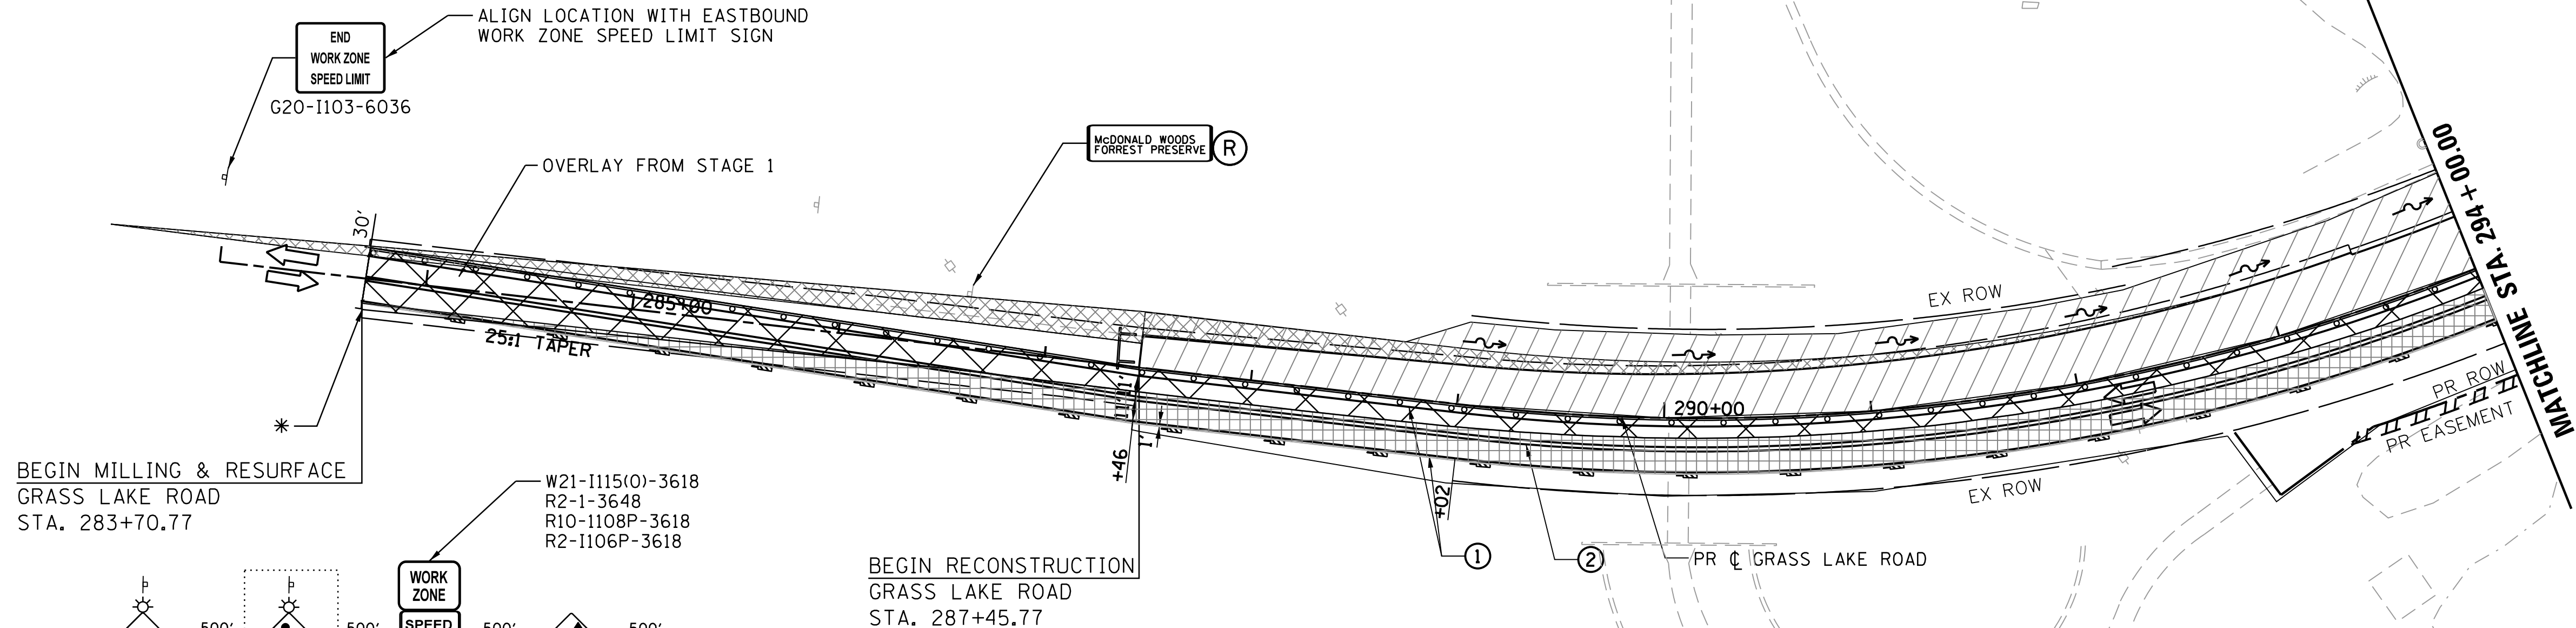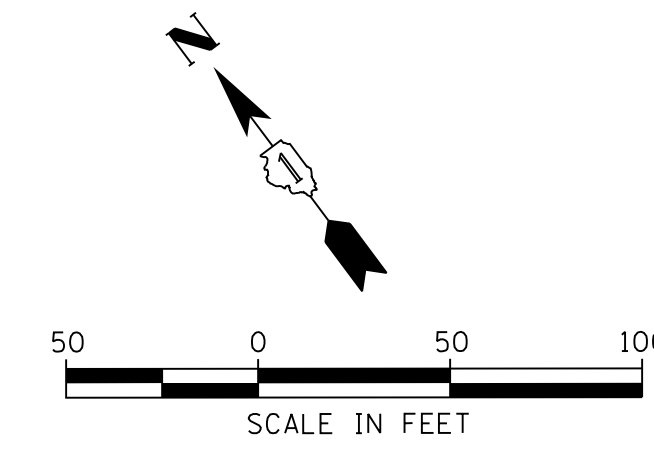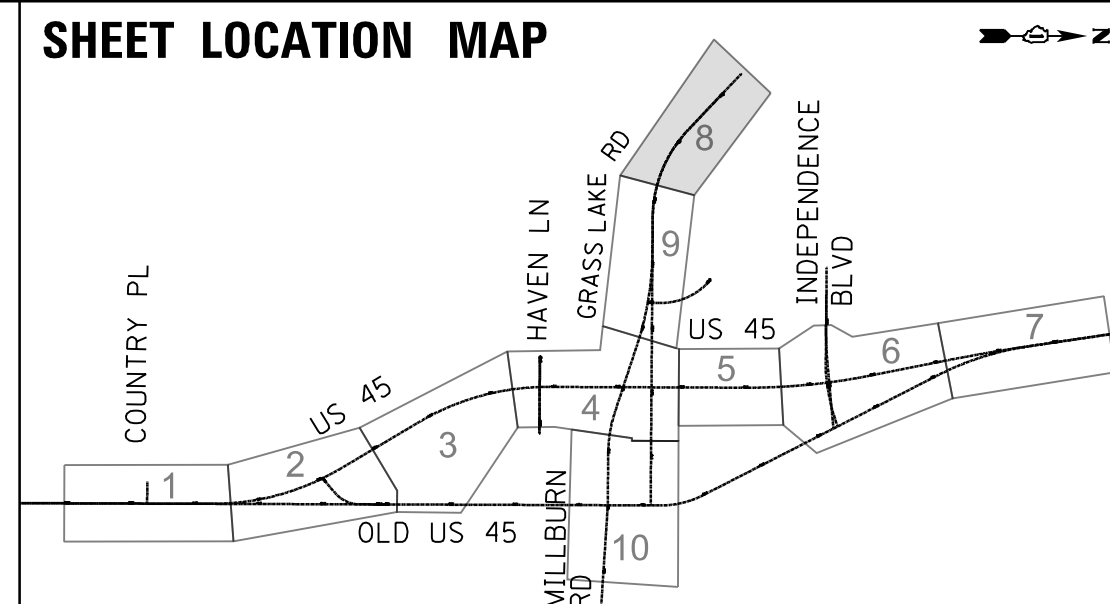

NOTE: W21-1 AND/OR W20-7(0)-48 MUST BE REMOVED WHEN FLAGGER OR WORKER ARE NOT PRESENT FOR MORE THAN ONE HOUR

MAINTENANCE OF TRAFFIC LEGEND

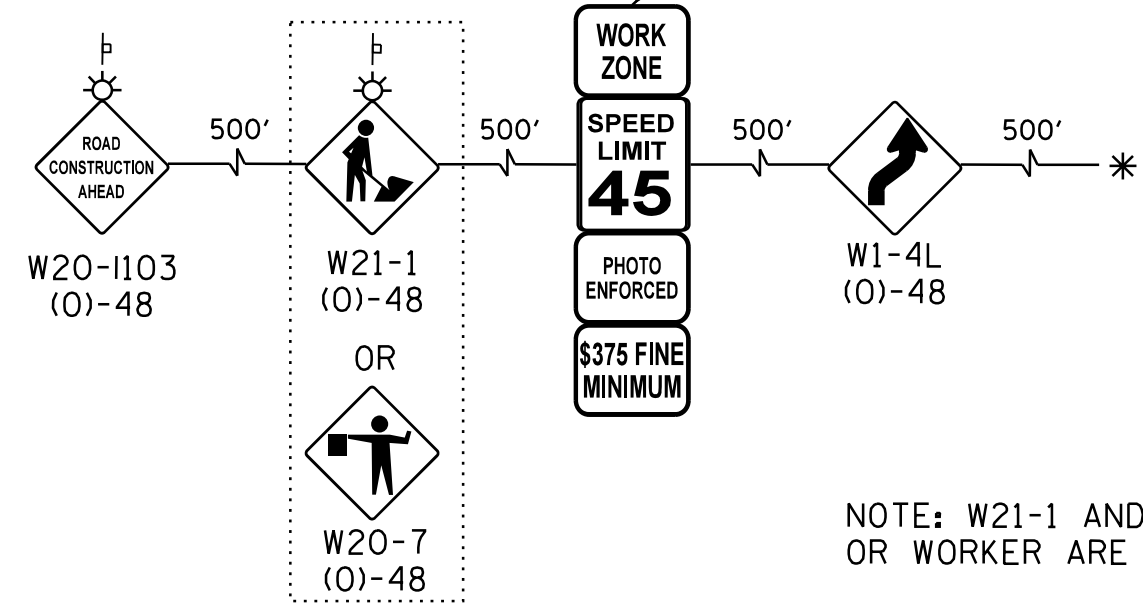- WORK ZONE
- TEMPORARY PAVEMENT
- TEMPORARY PAVEMENT PLACED IN PREVIOUS STAGE
- TRAFFIC FLOW
- TYPE II BARRICADES OR DRUMS WITH BI-DIRECTIONAL STEADY BURN LIGHT AT 50' C-C (TYP.) 25' C-C IN CURVES AND RADII, AND 20' C-C IN TAPERS
- DOUBLE VERTICAL PANEL WITH STEADY BURN BI-DIRECTIONAL LIGHT
- FLAGGER WITH TRAFFIC CONTROL DEVICE
- TYPE III BARRICADE
- TEMPORARY CONCRETE BARRIER

MAINTENANCE OF TRAFFIC PAVEMENT MARKING

- ① TEMPORARY PAVEMENT MARKING, LINE 4" WHITE
- ② TEMPORARY PAVEMENT MARKING, LINE 4" DOUBLE YELLOW AT 11" C-C
- ③ TEMPORARY PAVEMENT MARKING, LINE 24" WHITE
- ④ TEMPORARY PAVEMENT MARKING, LINE 12" YELLOW AT 50' C-C
- ⑤ TEMPORARY PAVEMENT MARKING, LINE 4", WHITE (10'-30' SKIP DASH)
- ⑥ TEMPORARY PAVEMENT MARKING LETTERS AND SYMBOLS
- ⑦ TEMPORARY PAVEMENT MARKING, LINE 4", WHITE (2'-6' SKIP DASH)

MAINTENANCE OF TRAFFIC SIGNING

- ⓧ REMOVE EXISTING SIGN
- Ⓡ RELOCATE EXISTING SIGN
- Ⓢ COVER EXISTING SIGN

USER NAME = 35361	DESIGNED MO	REVISED -
	DRAWN MO	REVISED
PLOT SCALE = 50.0000' / in.	CHECKED FZ	REVISED
PLOT DATE = 9/14/2017	DATE 02/02/2017	REVISED

STATE OF ILLINOIS
DEPARTMENT OF TRANSPORTATION

MAINTENANCE OF TRAFFIC
STAGE 2

SCALE: 1"=50' SHEET 8 OF 10 SHEETS STA. 287+50 TO STA. 294+00

F.A.P. RTE.	SECTION	COUNTY	TOTAL SHEETS	SHEET NO.
344	39 R	LAKE	510	105
				CONTRACT NO. 60T75
ILLINOIS FED. AID PROJECT				

MAINTENANCE OF TRAFFIC LEGEND



- WORK ZONE
- TEMPORARY PAVEMENT
- TEMPORARY PAVEMENT PLACED IN PREVIOUS STAGE
- TRAFFIC FLOW
- TYPE II BARRICADES OR DRUMS WITH BI-DIRECTIONAL STEADY BURN LIGHT AT 50' C-C (TYP.) 25' C-C IN CURVES AND RADII, AND 20' C-C IN TAPERS
- DOUBLE VERTICAL PANEL WITH STEADY BURN BI-DIRECTIONAL LIGHT
- FLAGGER WITH TRAFFIC CONTROL DEVICE
- TYPE III BARRICADE
- TEMPORARY CONCRETE BARRIER

MAINTENANCE OF TRAFFIC PAVEMENT MARKING

- ① TEMPORARY PAVEMENT MARKING, LINE 4" WHITE
- ② TEMPORARY PAVEMENT MARKING, LINE 4" DOUBLE YELLOW AT 11" C-C
- ③ TEMPORARY PAVEMENT MARKING, LINE 24" WHITE YELLOW AT 50' C-C
- ④ TEMPORARY PAVEMENT MARKING, LINE 12" YELLOW AT 50' C-C
- ⑤ TEMPORARY PAVEMENT MARKING, LINE 4", WHITE (10'-30' SKIP DASH)
- ⑥ TEMPORARY PAVEMENT MARKING LETTERS AND SYMBOLS
- ⑦ TEMPORARY PAVEMENT MARKING, LINE 4", WHITE (2'-6' SKIP DASH)

MAINTENANCE OF TRAFFIC SIGNING


- (X) REMOVE EXISTING SIGN
- (R) RELOCATE EXISTING SIGN
- (C) COVER EXISTING SIGN

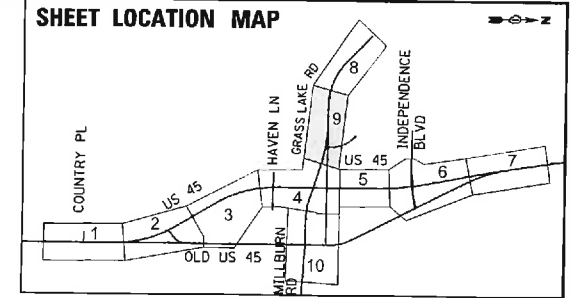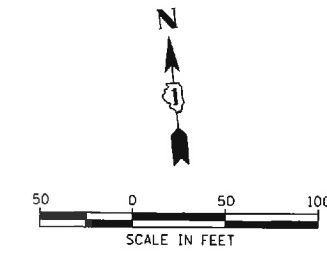

PLAN	DATE
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BY	
DATE	
NO.	
BY	
DATE	
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PROFILE	DATE
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USER NAME = 35361	DESIGNED MO	REVISED -
PLOT SCALE = 50.0000' / 1"	DRAWN MO	REVISED
PLOT DATE = 9/14/2017	CHECKED FZ	REVISED
	DATE 02/02/2017	REVISED

**STATE OF ILLINOIS
DEPARTMENT OF TRANSPORTATION**

**MAINTENANCE OF TRAFFIC
STAGE 2**



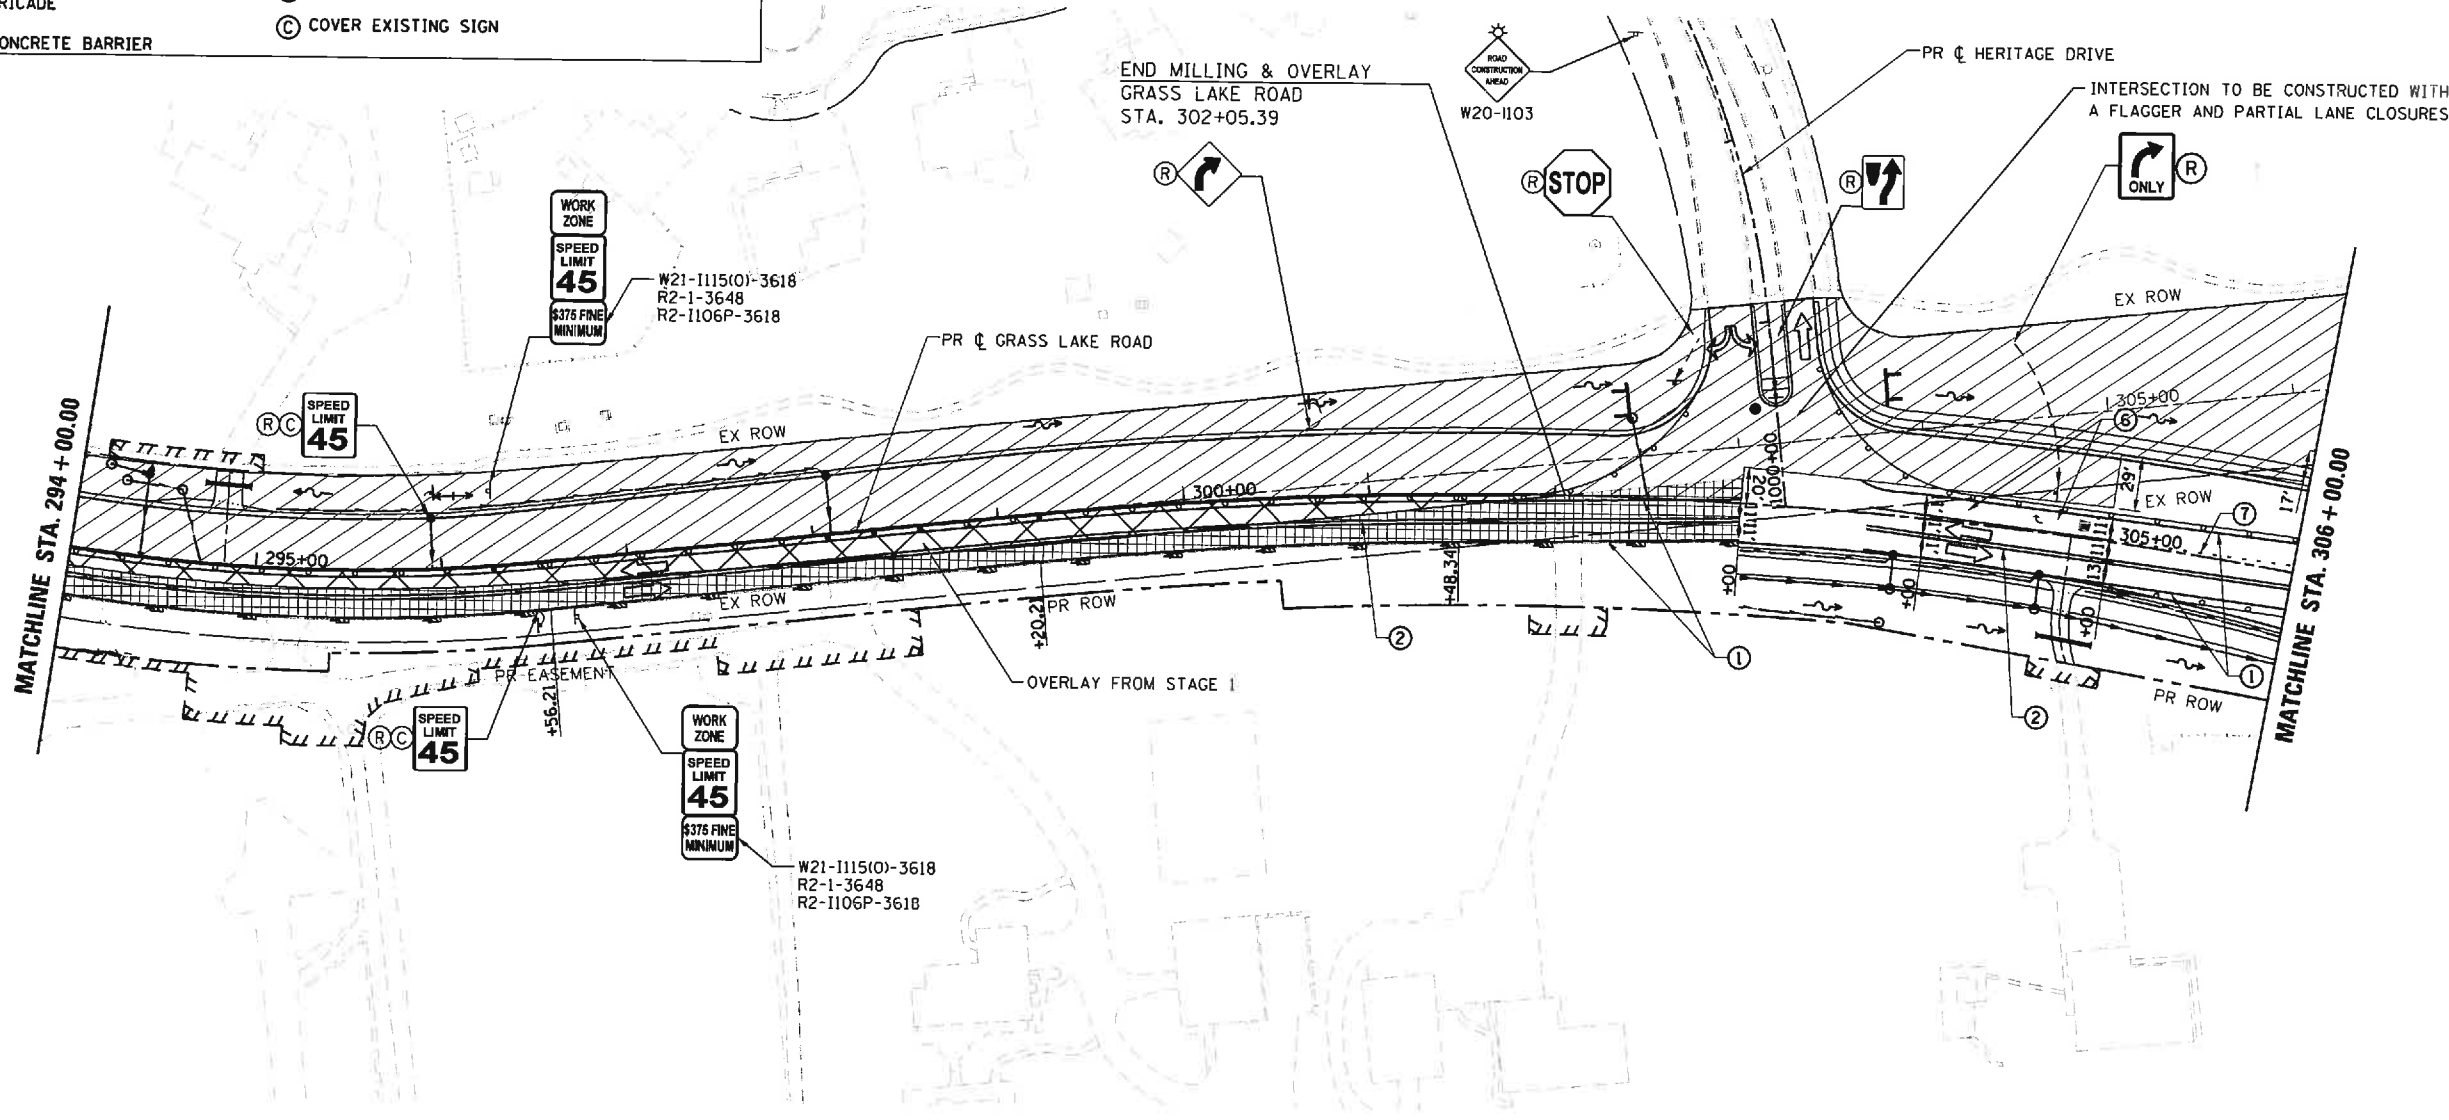
SCALE: 1"=50' SHEET 9 OF 10 SHEETS STA. 294+00 TO STA. 304+00

F.A.P. RTE. 344	SECTION 39 R	COUNTY LAKE	TOTAL SHEETS 510	SHEET NO. 106
				CONTRACT NO. 60175
ILLINOIS FED. AID PROJECT				

PLAN	SURVEYED	DATE
	PLOTTED	BY
	CHECKED	
	ATTEMPTED	
	FILE NAME	
	NO.	

PROFILE	SURVEYED	DATE
	PLOTTED	BY
	CHECKED	
	ATTEMPTED	
	FILE NAME	
	NO.	

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MAINTENANCE OF TRAFFIC LEGEND		MAINTENANCE OF TRAFFIC PAVEMENT MARKING	
	WORK ZONE		TEMPORARY PAVEMENT MARKING, LINE 4" WHITE
	TEMPORARY PAVEMENT		TEMPORARY PAVEMENT MARKING, LINE 4" DOUBLE YELLOW AT 11" C-C
	TEMPORARY PAVEMENT PLACED IN PREVIOUS STAGE		TEMPORARY PAVEMENT MARKING, LINE 24" WHITE
	TRAFFIC FLOW		TEMPORARY PAVEMENT MARKING, LINE 12" YELLOW AT 50' C-C
	TYPE II BARRICADES OR DRUMS WITH BI-DIRECTIONAL STEADY BURN LIGHT AT 50' C-C (TYP.), 25' C-C IN CURVES AND RADII, AND 20' C-C IN TAPERS		TEMPORARY PAVEMENT MARKING, LINE 4", WHITE (10'-30' SKIP DASH)
	DOUBLE VERTICAL PANEL WITH STEADY BURN BI-DIRECTIONAL LIGHT		TEMPORARY PAVEMENT MARKING LETTERS AND SYMBOLS
	FLAGGER WITH TRAFFIC CONTROL DEVICE		TEMPORARY PAVEMENT MARKING, LINE 4", WHITE (2'-6' SKIP DASH)
	TYPE III BARRICADE	MAINTENANCE OF TRAFFIC SIGNING	
	TEMPORARY CONCRETE BARRIER		REMOVE EXISTING SIGN
			RELOCATE EXISTING SIGN
			COVER EXISTING SIGN

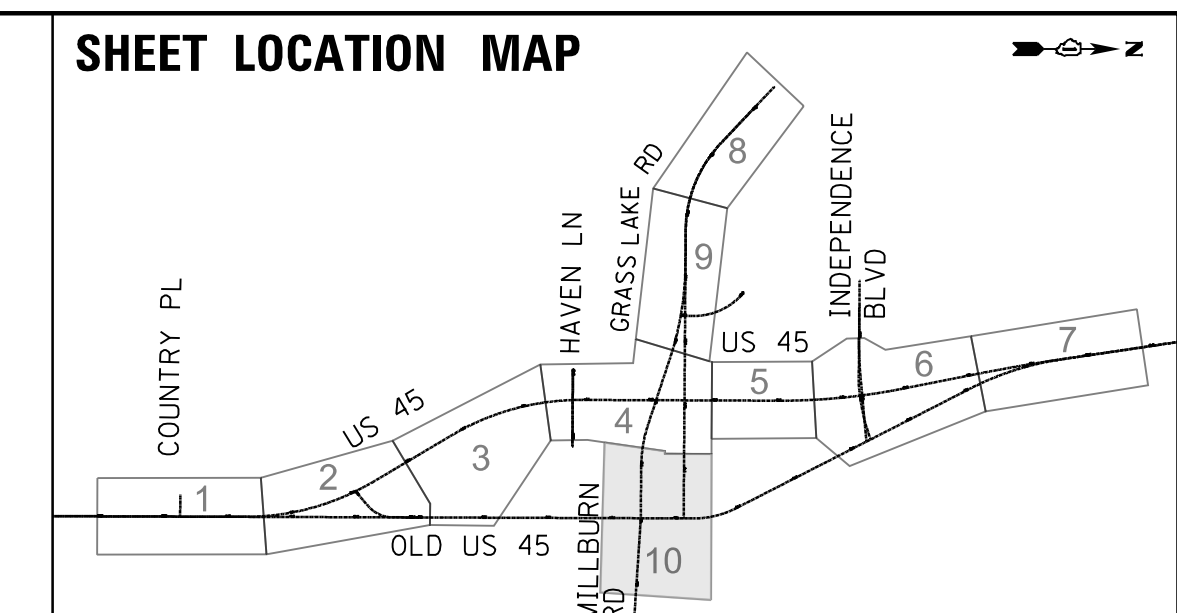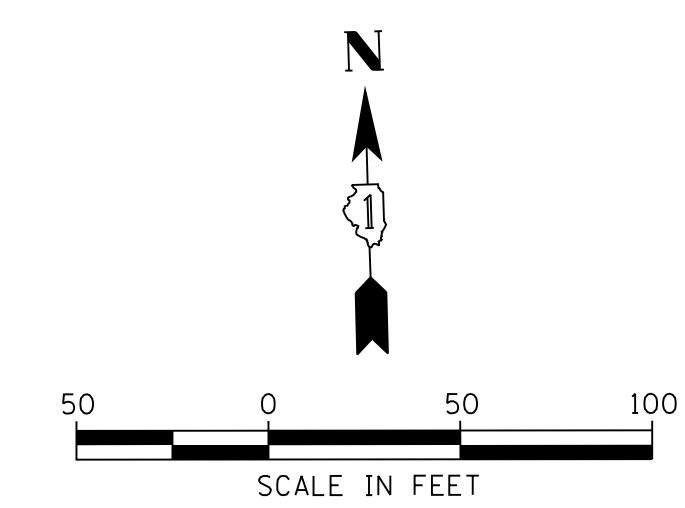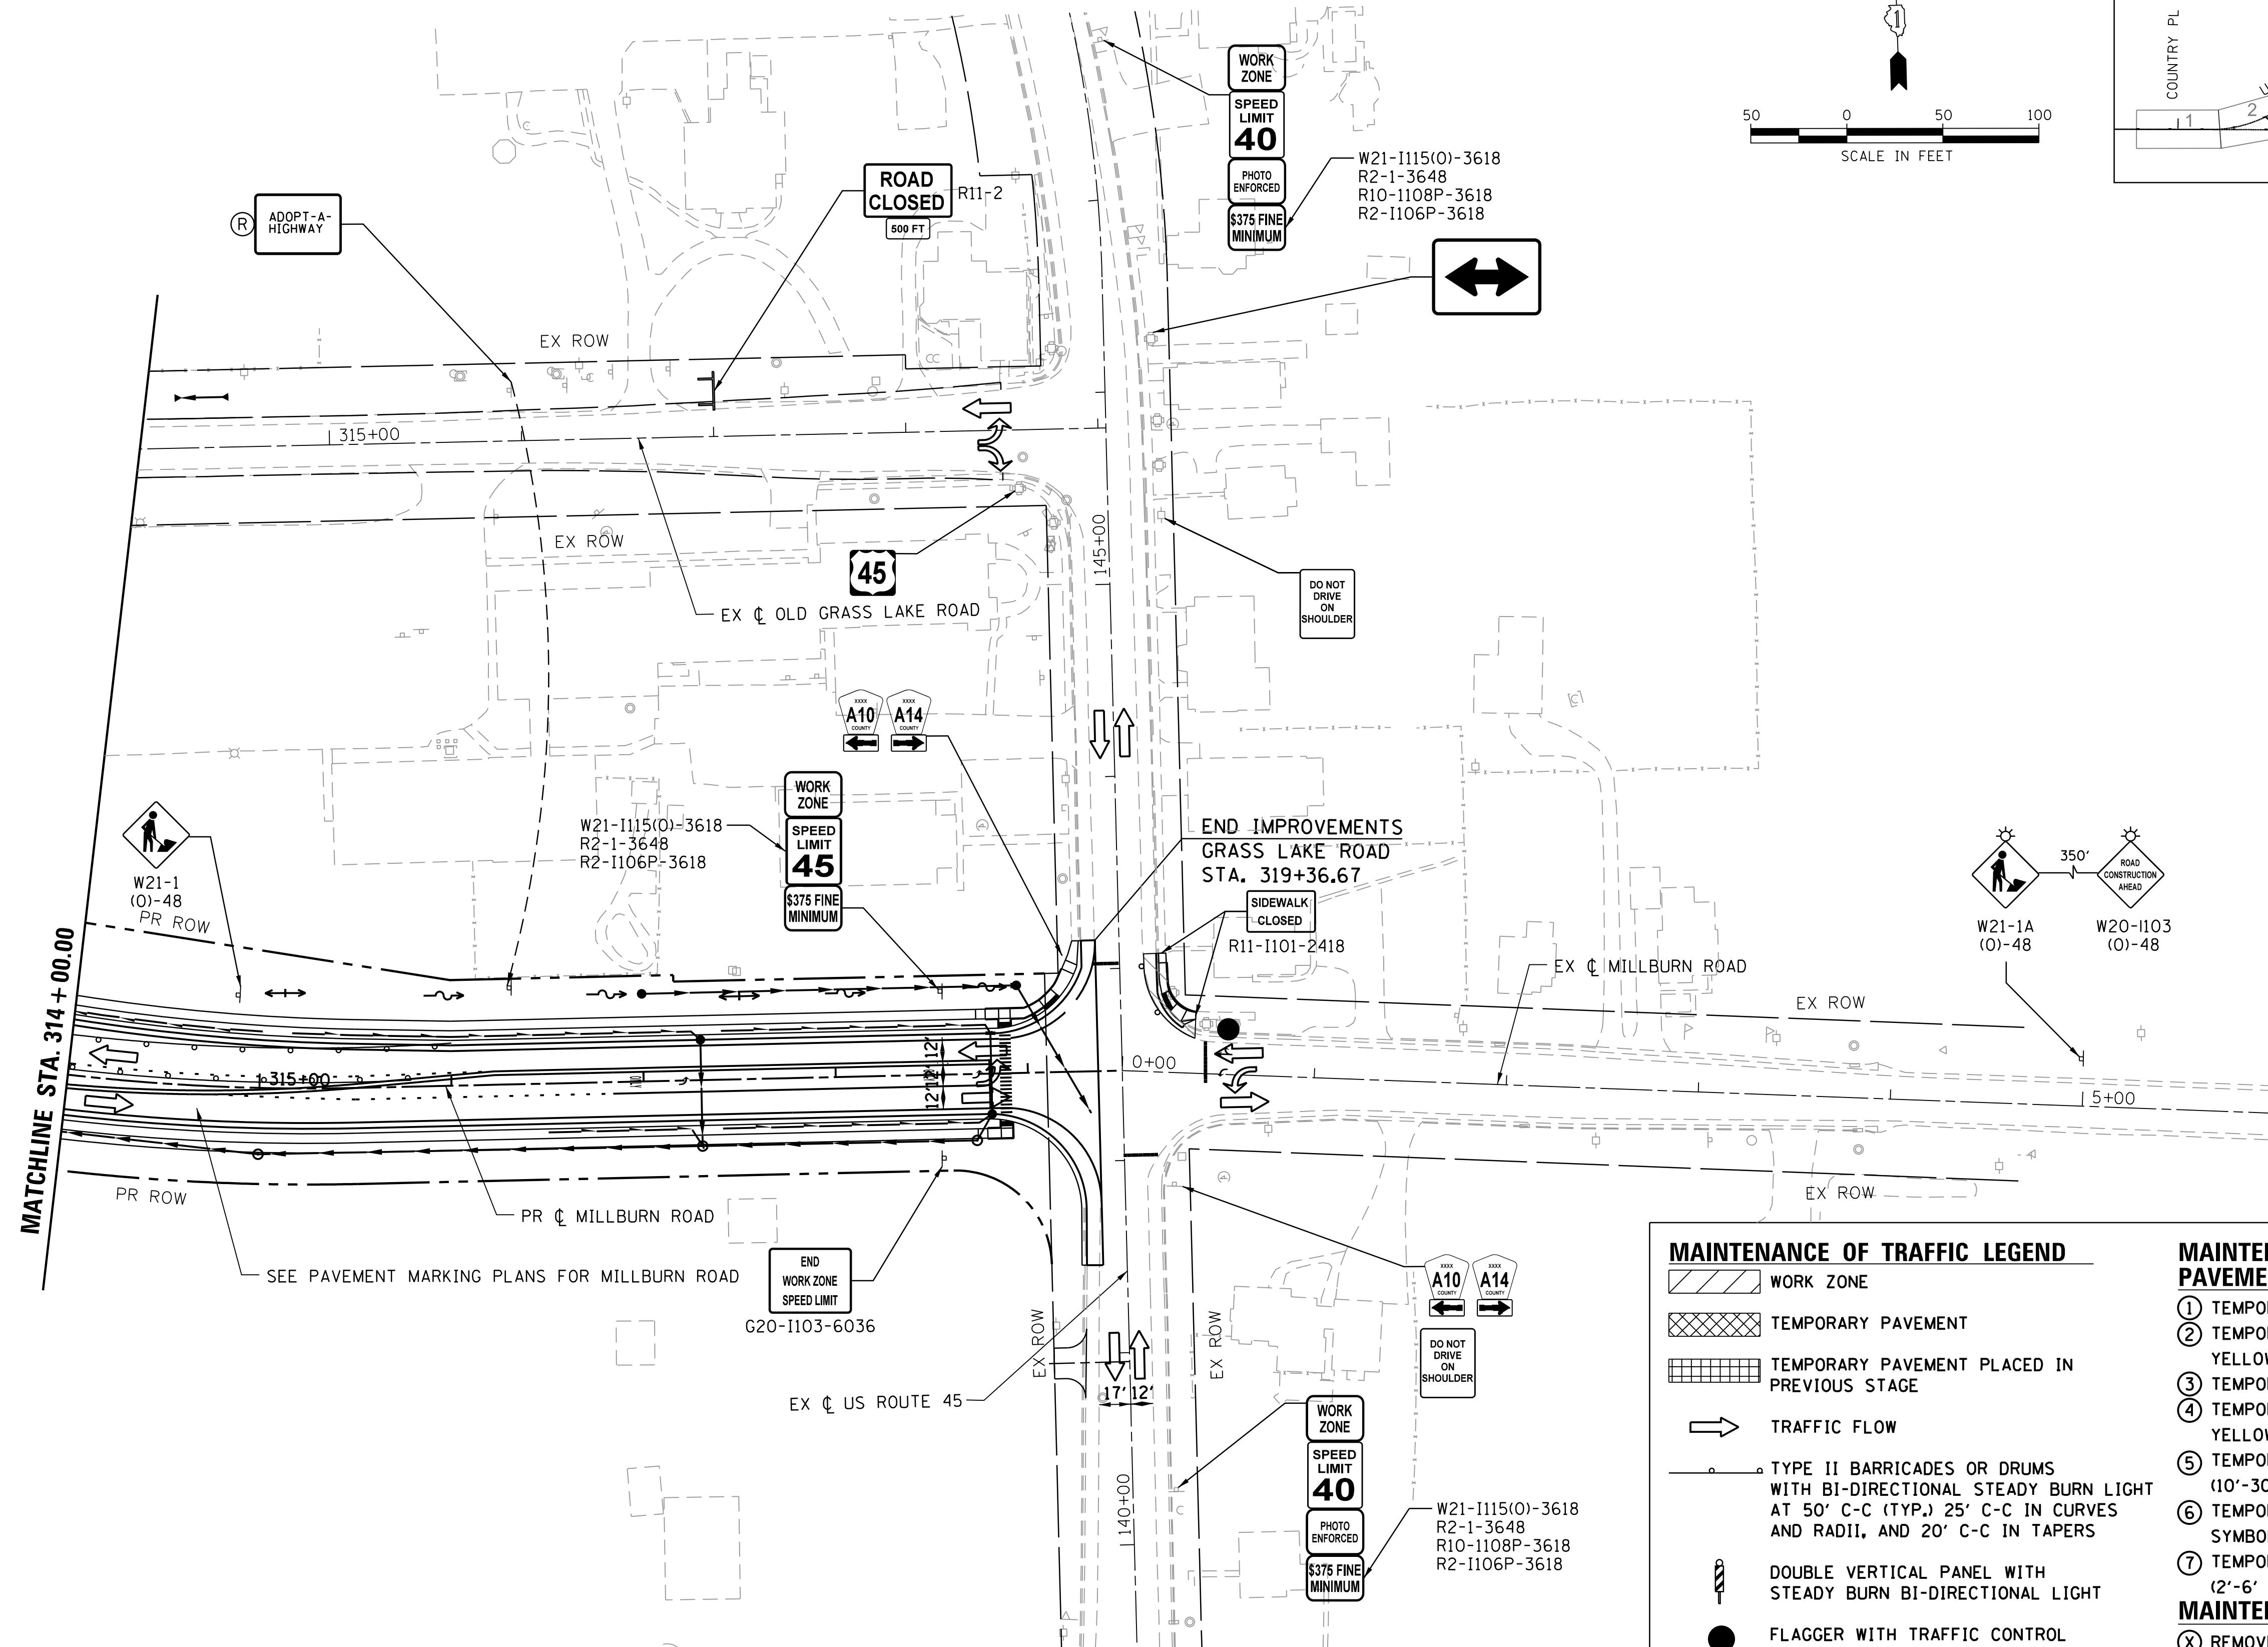USER NAME = 35361	DESIGNED MO	REVISED -
	DRAWN MO	REVISED
PLOT SCALE = 50.0000' / in.	CHECKED FZ	REVISED
PLOT DATE = 12/6/2017	DATE 02/02/2017	REVISED

**STATE OF ILLINOIS
DEPARTMENT OF TRANSPORTATION**





MAINTENANCE OF TRAFFIC STAGE 2	
SCALE: 1"=50'	SHEET 10 OF 10 SHEETS STA. 314+00 TO STA.

F.A.P. RTE.	SECTION	COUNTY	TOTAL SHEETS	SHEET NO.
344	39 R	LAKE	510	107
CONTRACT NO. 60T75			ILLINOIS FED. AID PROJECT	

PLAN	SURVEYED	BY	DATE
	PLOTTED		
	GRADES CHECKED		
	STRUCTURE NOTATIONS CHECKED		
	NOTE BOOK NO.		
	CADD FILE NAME		

PROFILE	SURVEYED	BY	DATE
	PLOTTED		
	GRADES CHECKED		
	STRUCTURE NOTATIONS CHECKED		
	NOTE BOOK NO.		
	CADD FILE NAME		

FILE NAME = p:\t\l\ed2\p\m\02\person\com\illinois\State Documents\US45 - 647965\48 - Design\CAD\Roadway\Sheets\160775_sht_1013.dgn

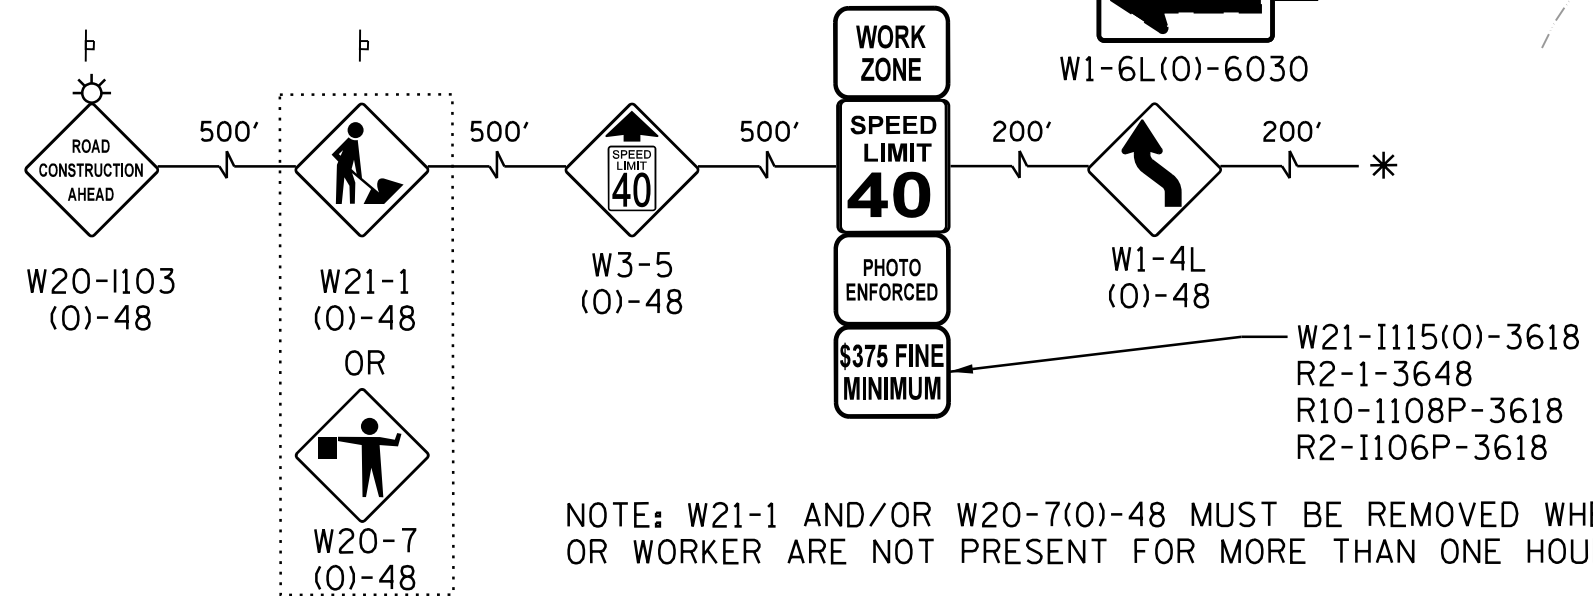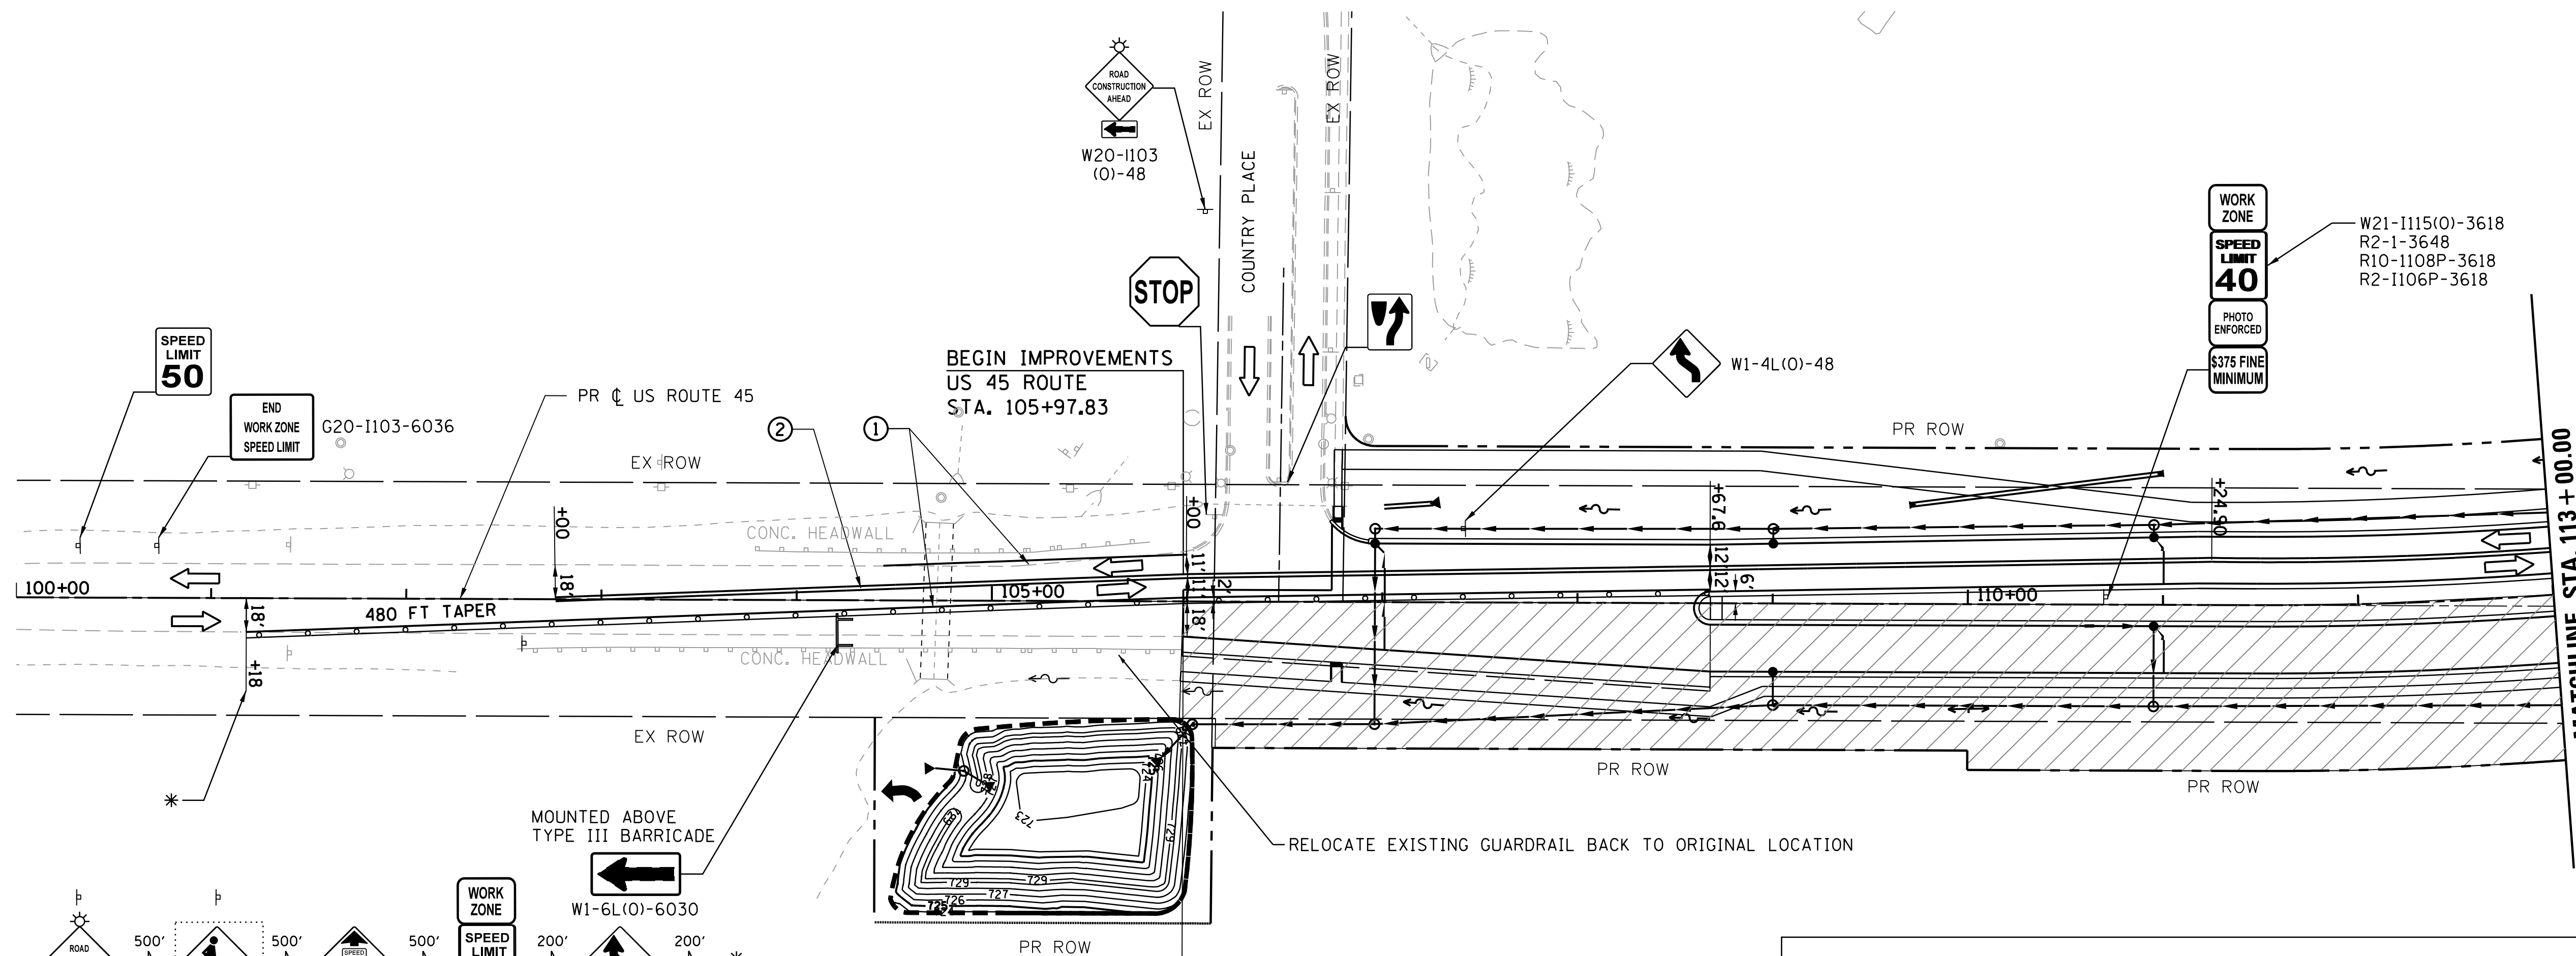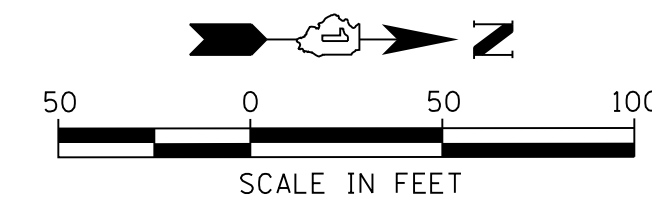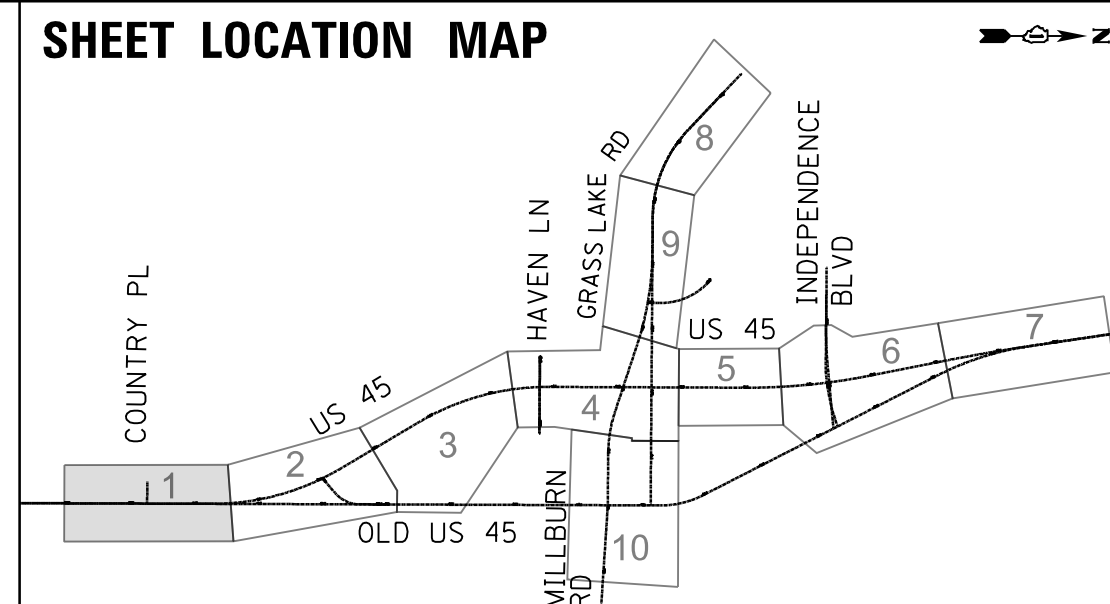

NOTE: W21-1 AND/OR W20-7(0)-48 MUST BE REMOVED WHEN FLAGGER OR WORKER ARE NOT PRESENT FOR MORE THAN ONE HOUR

MAINTENANCE OF TRAFFIC LEGEND

- WORK ZONE
- TEMPORARY PAVEMENT
- TEMPORARY PAVEMENT PLACED IN PREVIOUS STAGE
- TRAFFIC FLOW
- TYPE II BARRICADES OR DRUMS WITH BI-DIRECTIONAL STEADY BURN LIGHT AT 50' C-C (TYP.), 25' C-C IN CURVES AND RADII, AND 20' C-C IN TAPERS
- DOUBLE VERTICAL PANEL WITH STEADY BURN BI-DIRECTIONAL LIGHT
- FLAGGER WITH TRAFFIC CONTROL DEVICE
- TYPE III BARRICADE
- TEMPORARY CONCRETE BARRIER

MAINTENANCE OF TRAFFIC PAVEMENT MARKING

- ① TEMPORARY PAVEMENT MARKING, LINE 4" WHITE
- ② TEMPORARY PAVEMENT MARKING, LINE 4" DOUBLE YELLOW AT 11" C-C
- ③ TEMPORARY PAVEMENT MARKING, LINE 24" WHITE
- ④ TEMPORARY PAVEMENT MARKING, LINE 12" YELLOW AT 50' C-C
- ⑤ TEMPORARY PAVEMENT MARKING, LINE 4", WHITE (10'-30' SKIP DASH)
- ⑥ TEMPORARY PAVEMENT MARKING LETTERS AND SYMBOLS
- ⑦ TEMPORARY PAVEMENT MARKING, LINE 4", WHITE (2'-6' SKIP DASH)

MAINTENANCE OF TRAFFIC SIGNING

- ⓧ REMOVE EXISTING SIGN
- Ⓡ RELOCATE EXISTING SIGN
- Ⓢ COVER EXISTING SIGN

USER NAME = 35361	DESIGNED MO	REVISED -
	DRAWN MO	REVISED
PLOT SCALE = 50.0000' / in.	CHECKED FZ	REVISED
PLOT DATE = 9/14/2017	DATE 02/02/2017	REVISED

STATE OF ILLINOIS
DEPARTMENT OF TRANSPORTATION

MAINTENANCE OF TRAFFIC
STAGE 3

SCALE: 1"=50' SHEET 1 OF 10 SHEETS STA. 100+00 TO STA. 113+00

F.A.P. RTE.	SECTION	COUNTY	TOTAL SHEETS	SHEET NO.
344	39 R	LAKE	510	110
CONTRACT NO. 60775				
ILLINOIS FED. AID PROJECT				



MAINTENANCE OF TRAFFIC LEGEND

- WORK ZONE
- TEMPORARY PAVEMENT
- TEMPORARY PAVEMENT PLACED IN PREVIOUS STAGE
- TRAFFIC FLOW
- TYPE II BARRICADES OR DRUMS WITH BI-DIRECTIONAL STEADY BURN LIGHT AT 50' C-C (TYP.) 25' C-C IN CURVES AND RADII, AND 20' C-C IN TAPERS
- DOUBLE VERTICAL PANEL WITH STEADY BURN BI-DIRECTIONAL LIGHT
- FLAGGER WITH TRAFFIC CONTROL DEVICE
- TYPE III BARRICADE
- TEMPORARY CONCRETE BARRIER

MAINTENANCE OF TRAFFIC PAVEMENT MARKING

- ① TEMPORARY PAVEMENT MARKING, LINE 4" WHITE
 - ② TEMPORARY PAVEMENT MARKING, LINE 4" DOUBLE YELLOW AT 11" C-C
 - ③ TEMPORARY PAVEMENT MARKING, LINE 24" WHITE
 - ④ TEMPORARY PAVEMENT MARKING, LINE 12" YELLOW AT 50' C-C
 - ⑤ TEMPORARY PAVEMENT MARKING, LINE 4", WHITE (10'-30' SKIP DASH)
 - ⑥ TEMPORARY PAVEMENT MARKING LETTERS AND SYMBOLS
 - ⑦ TEMPORARY PAVEMENT MARKING, LINE 4", WHITE (2'-6' SKIP DASH)
- MAINTENANCE OF TRAFFIC SIGNING**
- (X) REMOVE EXISTING SIGN
 - (R) RELOCATE EXISTING SIGN
 - (C) COVER EXISTING SIGN


SHEET LOCATION MAP

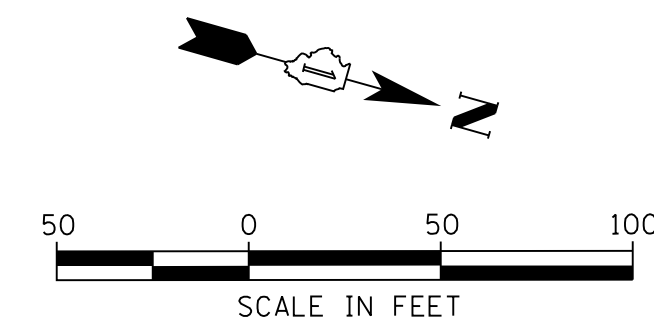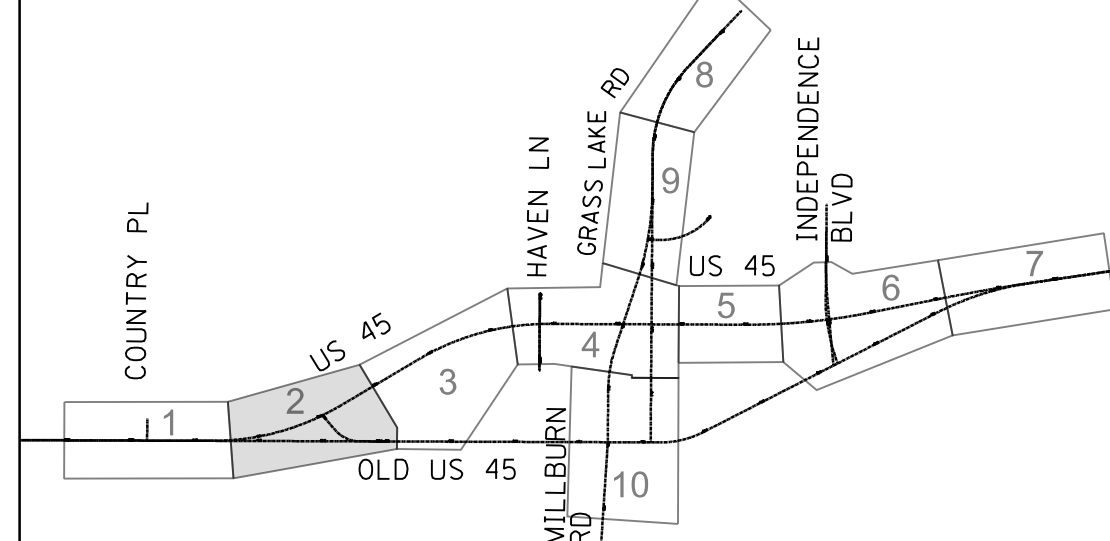

PLAN	SURVEYED	DATE
NOTE BOOK	PLOTTED	BY
NO.	CHECKED	
	DATE	
	FILE NAME	

PROFILE	SURVEYED	DATE
NOTE BOOK	GRADES CHECKED	BY
NO.	STRUCTURE	
	NOT AT THIS OFFICE	

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USER NAME = 35361	DESIGNED MO	REVISED -
	DRAWN MO	REVISED
PLOT SCALE = 50.0000' / in.	CHECKED FZ	REVISED
PLOT DATE = 9/14/2017	DATE 02/02/2017	REVISED

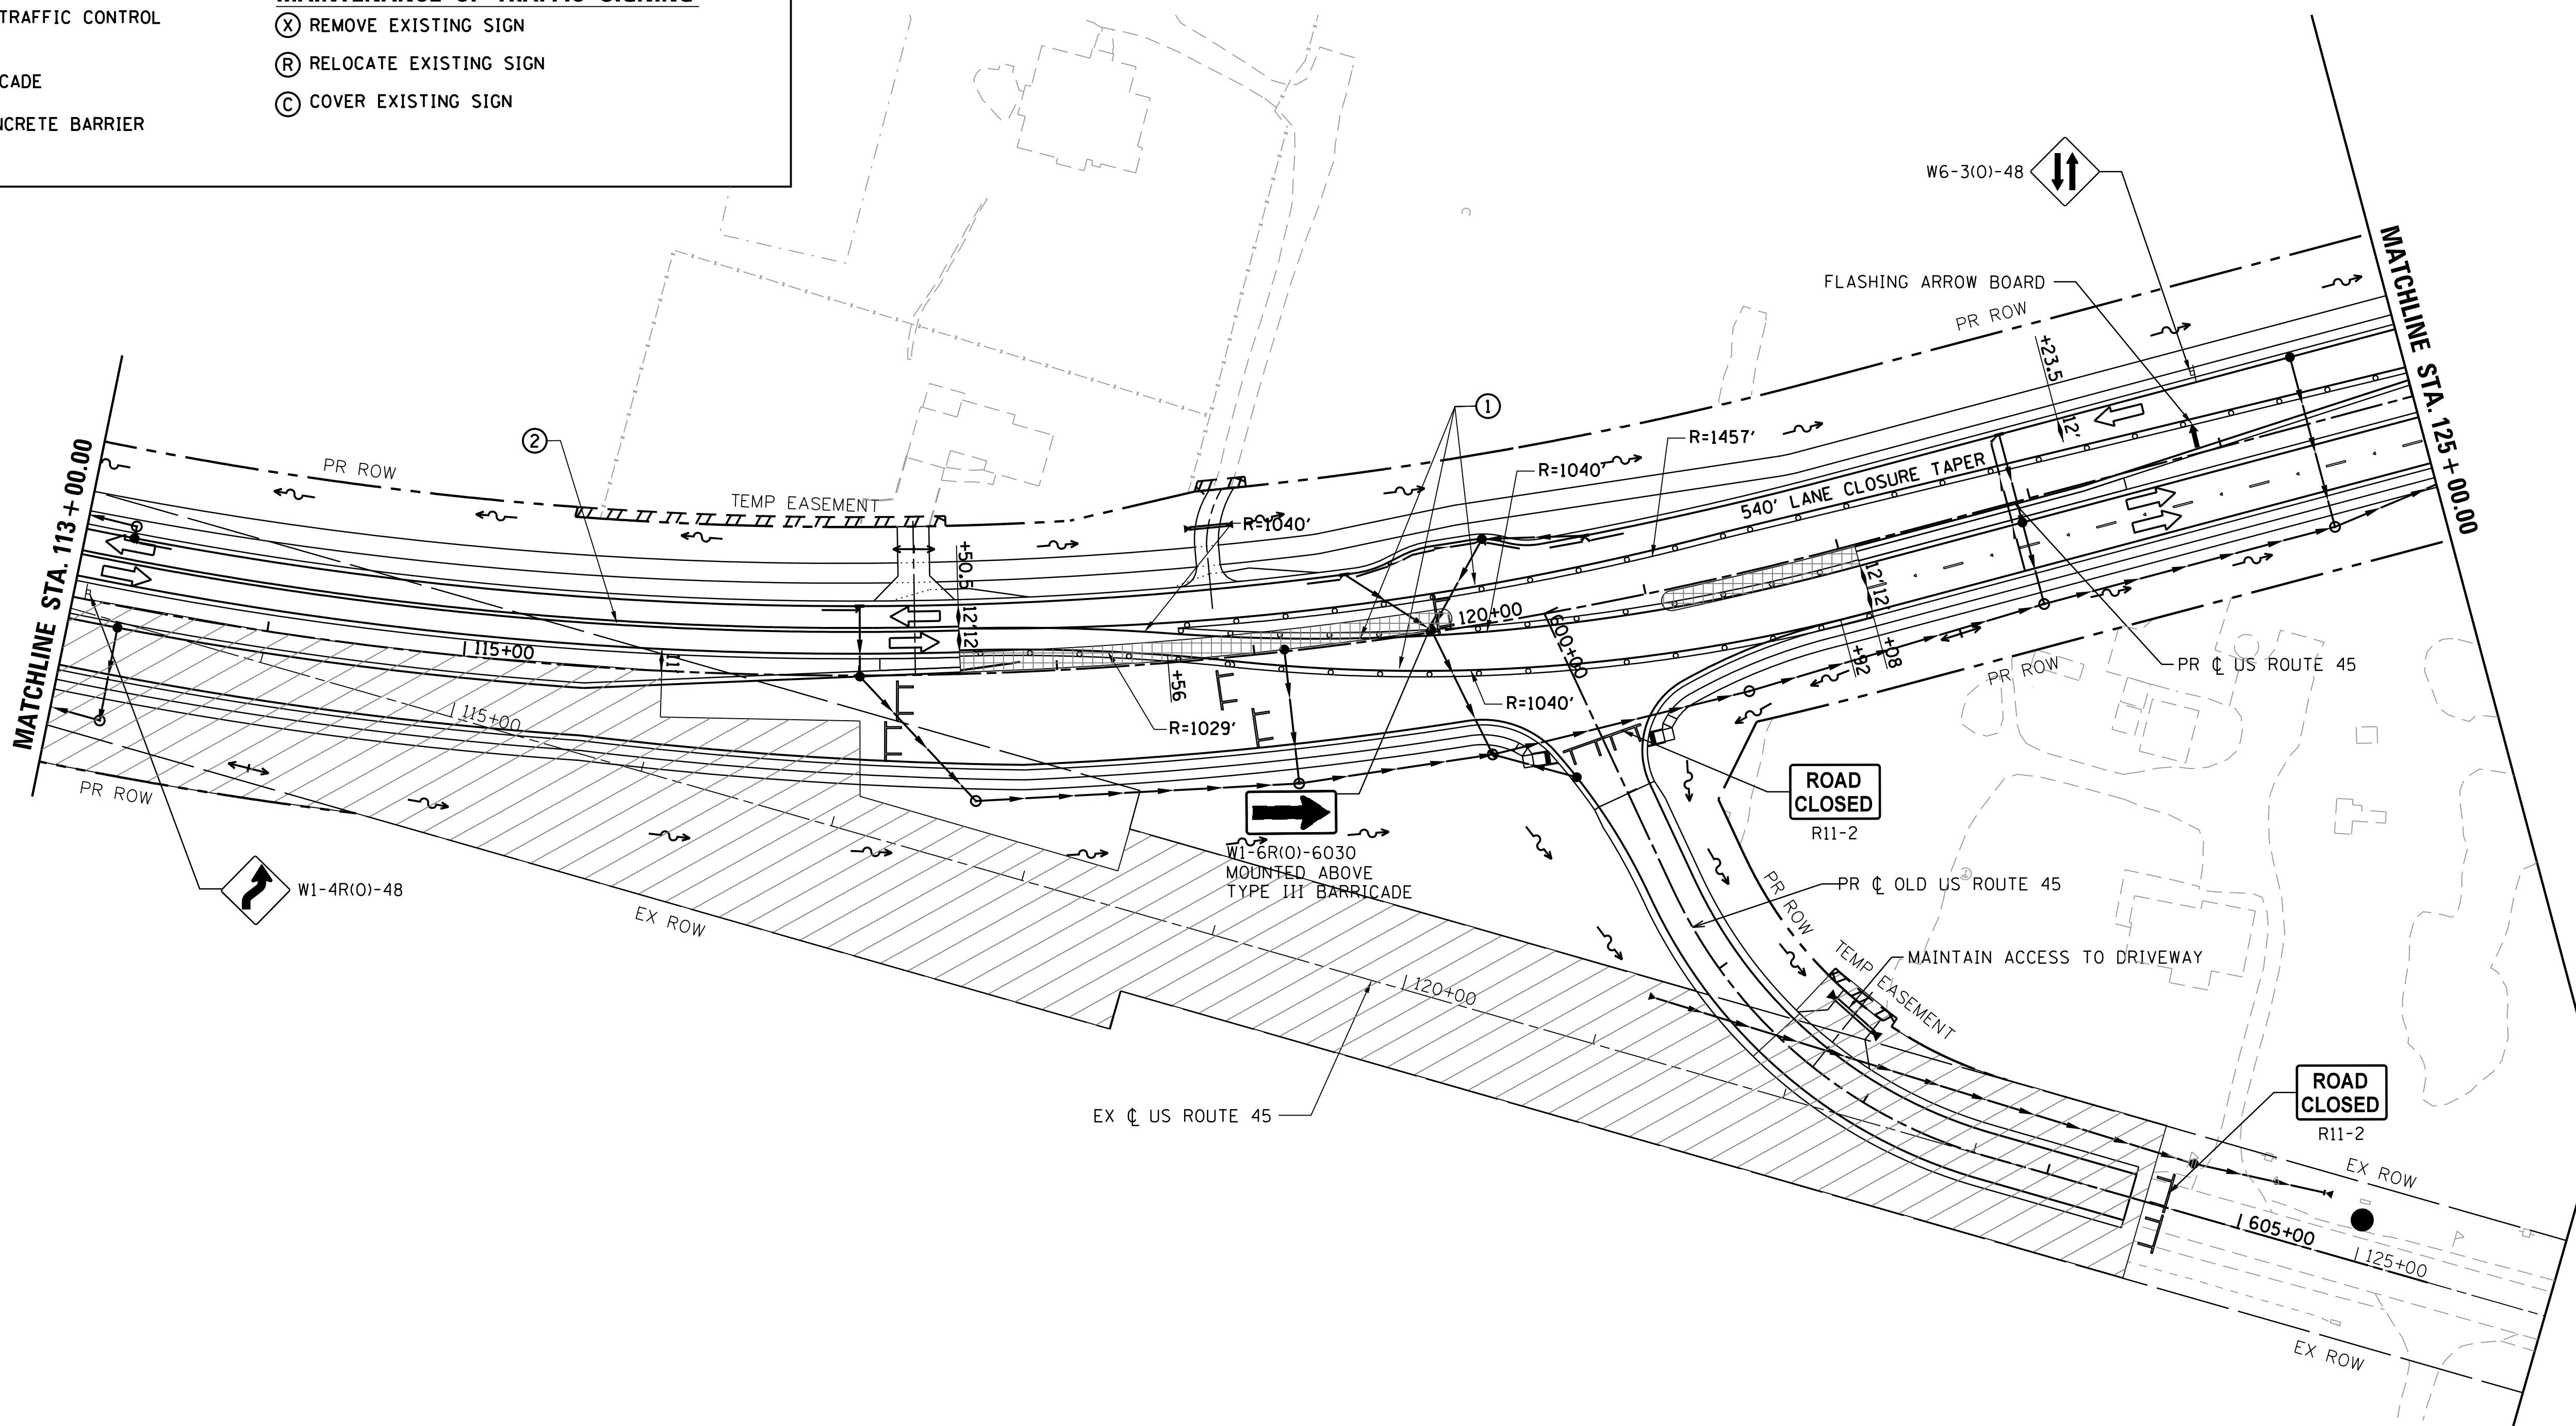**STATE OF ILLINOIS
DEPARTMENT OF TRANSPORTATION**

**MAINTENANCE OF TRAFFIC
STAGE 3**



SCALE: 1"=50' SHEET 2 OF 10 SHEETS STA. 113+00 TO STA. 125+00

F.A.P. RTE.	SECTION	COUNTY	TOTAL SHEETS	SHEET NO.
344	39 R	LAKE	510	111
CONTRACT NO. 60T75			ILLINOIS FED. AID PROJECT	

PLAN	SURVEYED	BY	DATE
	PLOTTED		
	CHECKED		
	ALIGNED		
	FILED		
	NO.		
	NO.		
	NO.		

PROFILE	SURVEYED	BY	DATE
	PLOTTED		
	CHECKED		
	GRADES		
	STRUCTURE		
	NOT AT THIS CHFD		
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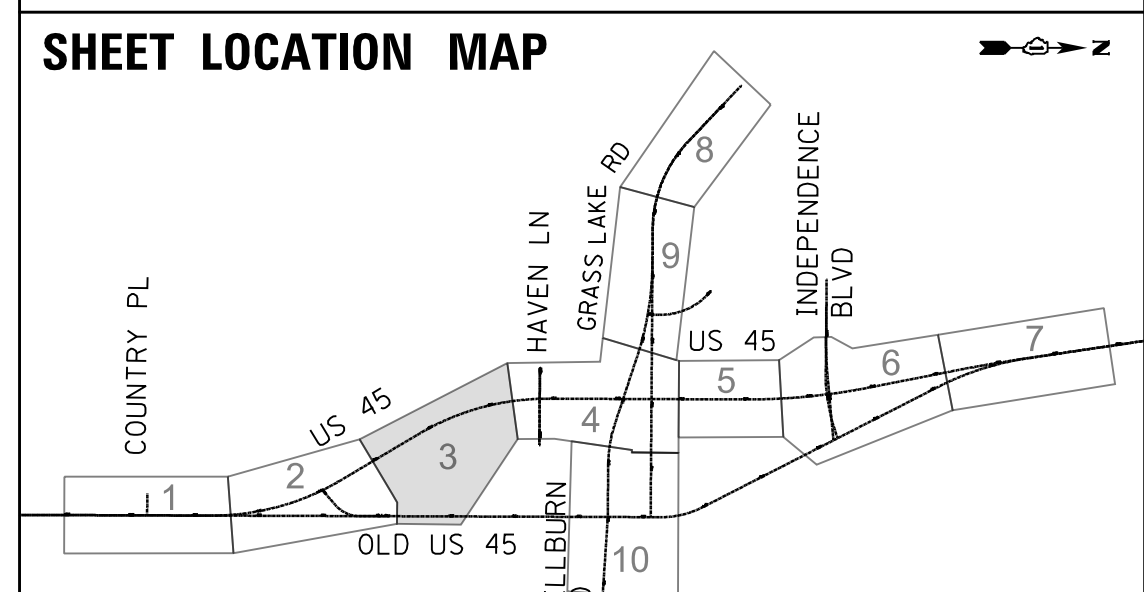
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MAINTENANCE OF TRAFFIC LEGEND

- WORK ZONE
- TEMPORARY PAVEMENT
- TEMPORARY PAVEMENT PLACED IN PREVIOUS STAGE
- TRAFFIC FLOW
- TYPE II BARRICADES OR DRUMS WITH BI-DIRECTIONAL STEADY BURN LIGHT AT 50' C-C (TYP.) 25' C-C IN CURVES AND RADII, AND 20' C-C IN TAPERS
- DOUBLE VERTICAL PANEL WITH STEADY BURN BI-DIRECTIONAL LIGHT
- FLAGGER WITH TRAFFIC CONTROL DEVICE
- TYPE III BARRICADE
- TEMPORARY CONCRETE BARRIER

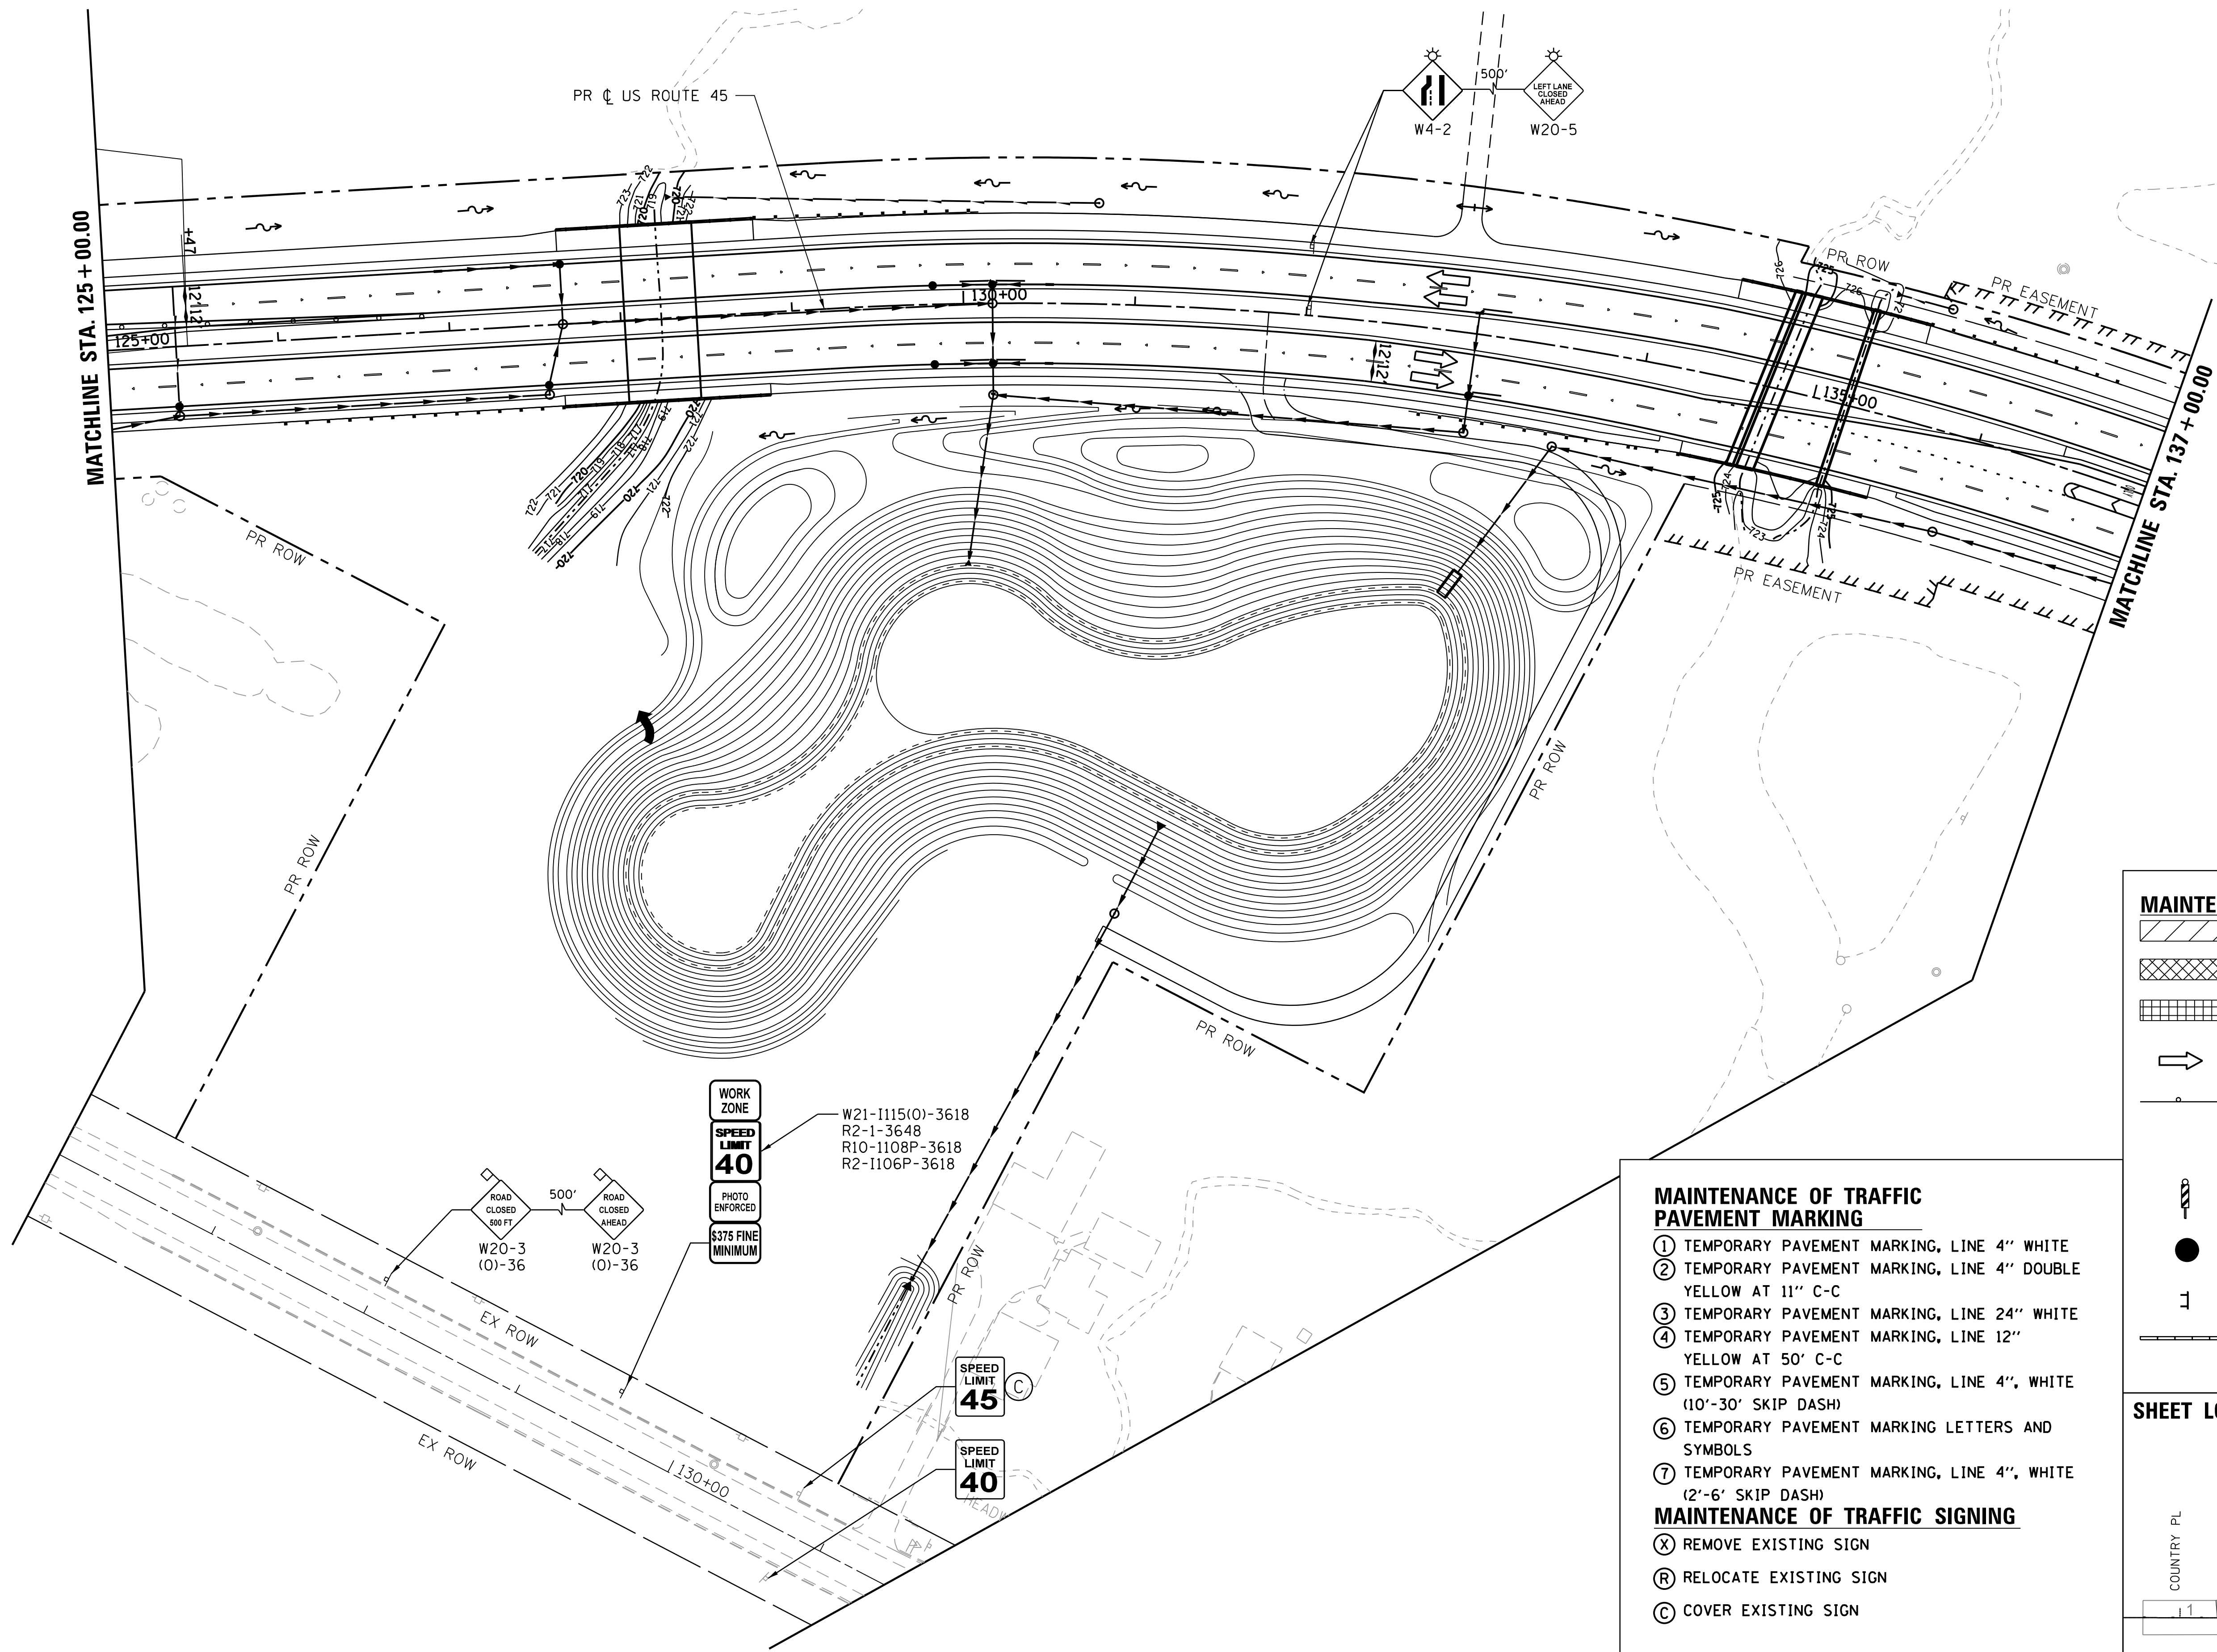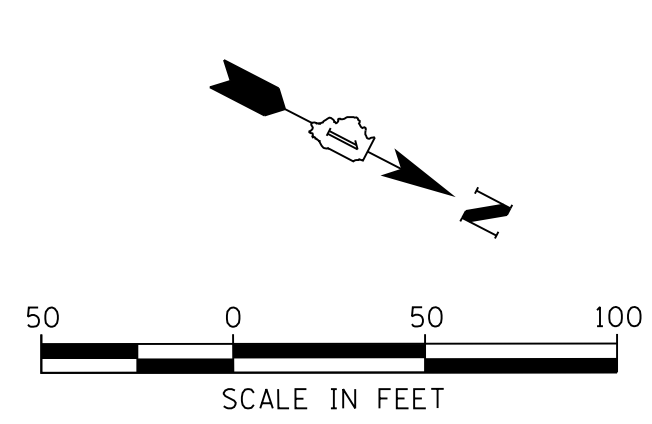- ### MAINTENANCE OF TRAFFIC PAVEMENT MARKING
- ① TEMPORARY PAVEMENT MARKING, LINE 4" WHITE
 - ② TEMPORARY PAVEMENT MARKING, LINE 4" DOUBLE YELLOW AT 11" C-C
 - ③ TEMPORARY PAVEMENT MARKING, LINE 24" WHITE
 - ④ TEMPORARY PAVEMENT MARKING, LINE 12" YELLOW AT 50' C-C
 - ⑤ TEMPORARY PAVEMENT MARKING, LINE 4", WHITE (10'-30' SKIP DASH)
 - ⑥ TEMPORARY PAVEMENT MARKING LETTERS AND SYMBOLS
 - ⑦ TEMPORARY PAVEMENT MARKING, LINE 4", WHITE (2'-6' SKIP DASH)
- ### MAINTENANCE OF TRAFFIC SIGNING
- (X) REMOVE EXISTING SIGN
 - (R) RELOCATE EXISTING SIGN
 - (C) COVER EXISTING SIGN



USER NAME = 35361	DESIGNED MO	REVISED -
	DRAWN MO	REVISED
PLOT SCALE = 50.0000' / in.	CHECKED FZ	REVISED
PLOT DATE = 9/14/2017	DATE 02/02/2017	REVISED

**STATE OF ILLINOIS
DEPARTMENT OF TRANSPORTATION**




MAINTENANCE OF TRAFFIC STAGE 3			
SCALE: 1"=50'	SHEET 3	OF 10 SHEETS	STA. 125+00 TO STA. 137+00

F.A.P. RTE. 344	SECTION 39 R	COUNTY LAKE	TOTAL SHEETS 510	SHEET NO. 112
CONTRACT NO. 60T75				
ILLINOIS FED. AID PROJECT				

PLAN	SURVEYED	BY	DATE
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	CADD FILE NAME		
	NO.		

PROFILE	SURVEYED	BY	DATE
	PLOTTED		
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	STRUCTURE		
	NOT AT THIS OFFICE		
	NO.		

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MAINTENANCE OF TRAFFIC LEGEND

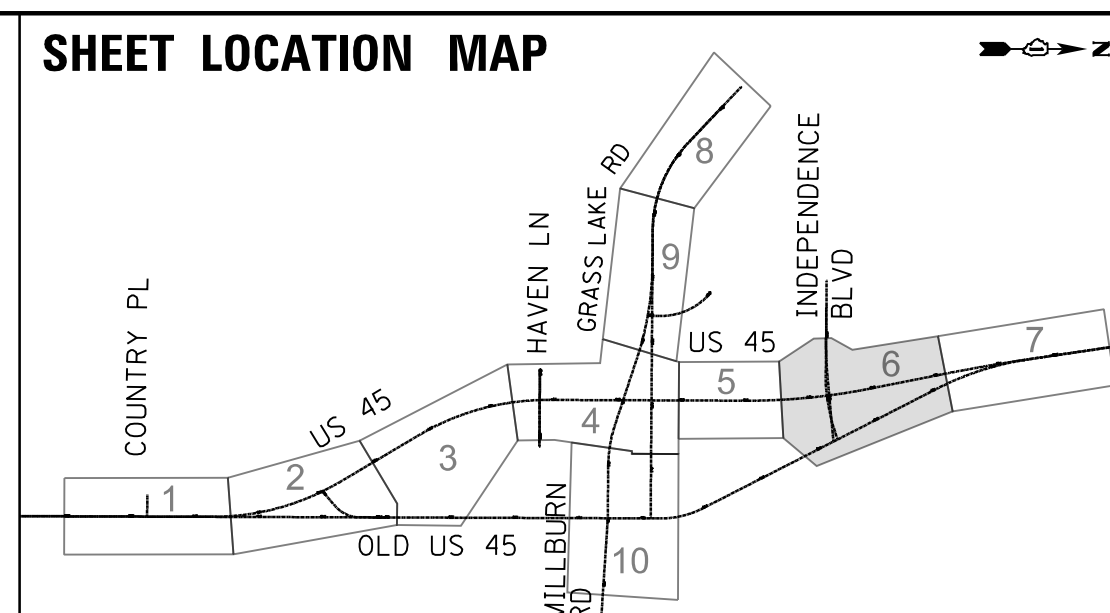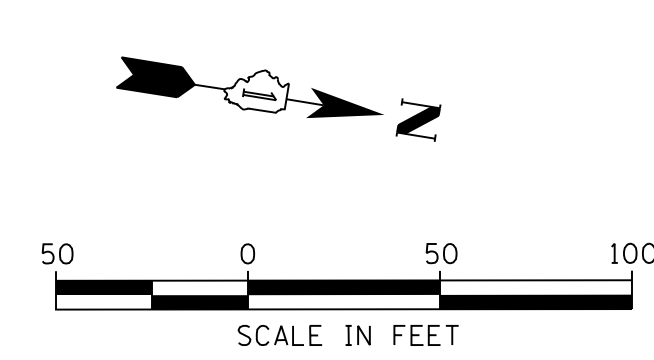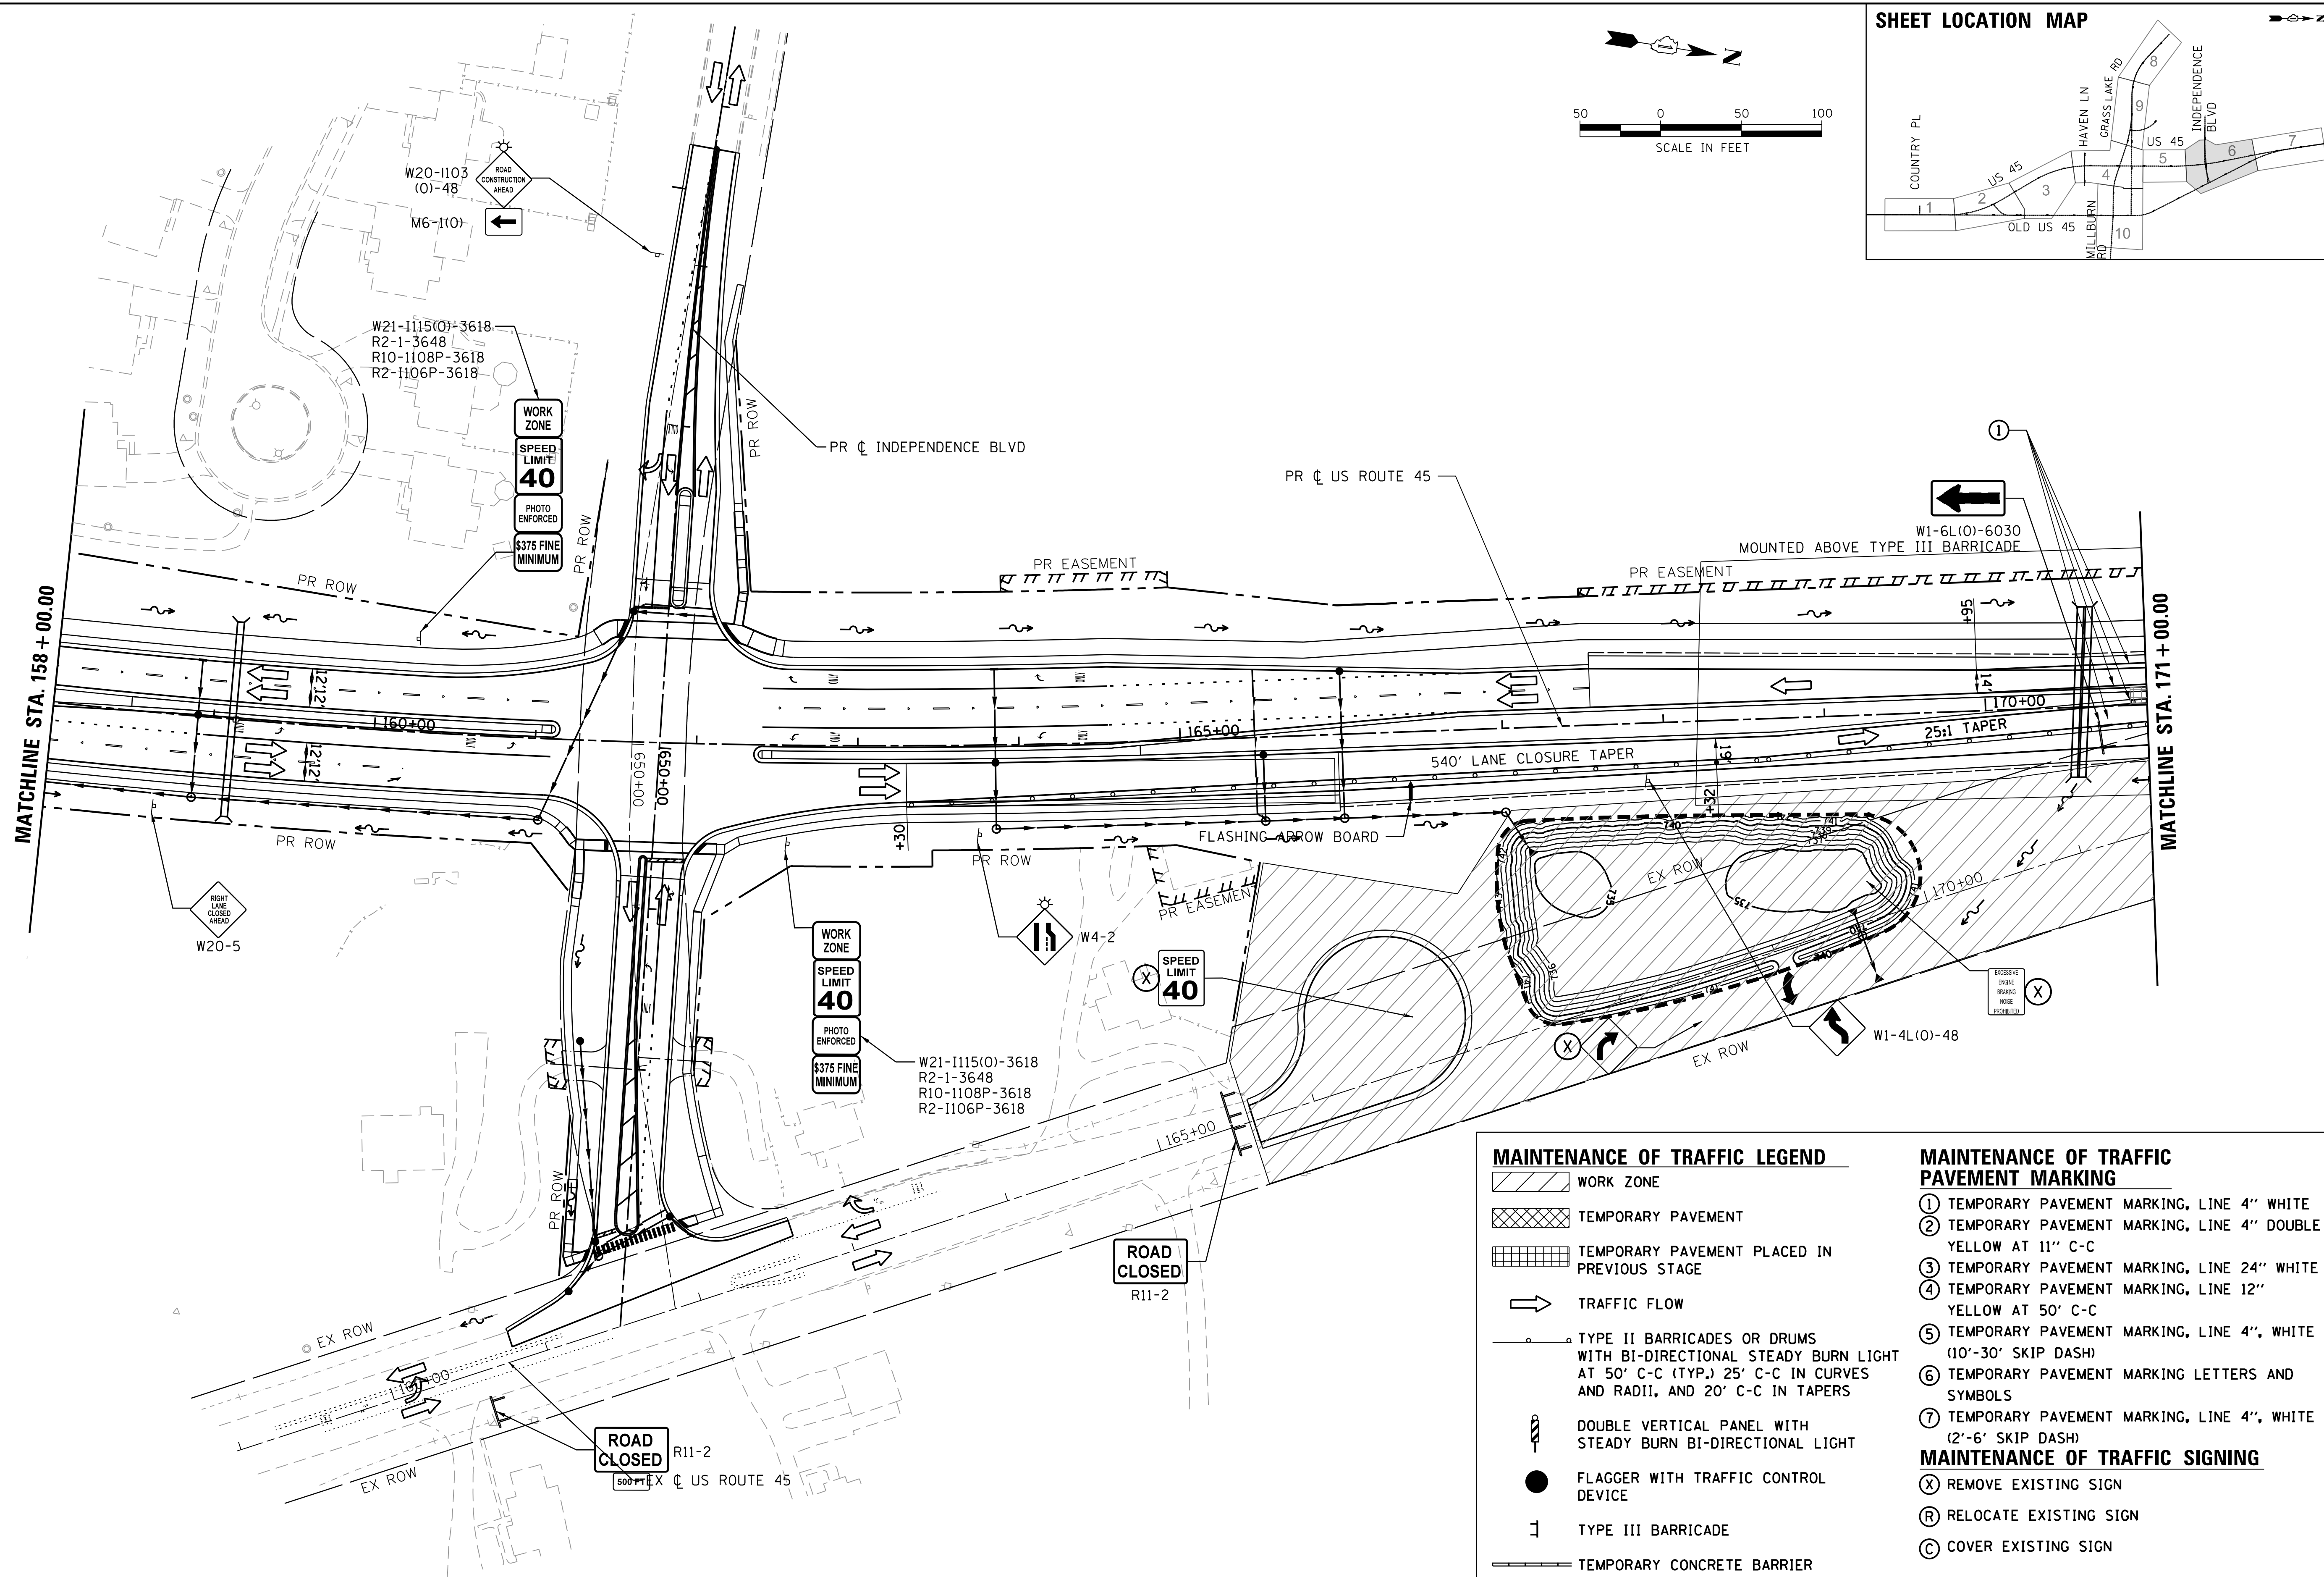- WORK ZONE
- TEMPORARY PAVEMENT
- TEMPORARY PAVEMENT PLACED IN PREVIOUS STAGE
- TRAFFIC FLOW
- TYPE II BARRICADES OR DRUMS WITH BI-DIRECTIONAL STEADY BURN LIGHT AT 50' C-C (TYP.), 25' C-C IN CURVES AND RADII, AND 20' C-C IN TAPERS
- DOUBLE VERTICAL PANEL WITH STEADY BURN BI-DIRECTIONAL LIGHT
- FLAGGER WITH TRAFFIC CONTROL DEVICE
- TYPE III BARRICADE
- TEMPORARY CONCRETE BARRIER

MAINTENANCE OF TRAFFIC PAVEMENT MARKING

- ① TEMPORARY PAVEMENT MARKING, LINE 4" WHITE
- ② TEMPORARY PAVEMENT MARKING, LINE 4" DOUBLE YELLOW AT 11" C-C
- ③ TEMPORARY PAVEMENT MARKING, LINE 24" WHITE
- ④ TEMPORARY PAVEMENT MARKING, LINE 12" YELLOW AT 50' C-C
- ⑤ TEMPORARY PAVEMENT MARKING, LINE 4", WHITE (10'-30' SKIP DASH)
- ⑥ TEMPORARY PAVEMENT MARKING LETTERS AND SYMBOLS
- ⑦ TEMPORARY PAVEMENT MARKING, LINE 4", WHITE (2'-6' SKIP DASH)

MAINTENANCE OF TRAFFIC SIGNING

- (X) REMOVE EXISTING SIGN
- (R) RELOCATE EXISTING SIGN
- (C) COVER EXISTING SIGN

USER NAME = 35361	DESIGNED MO	REVISED -
	DRAWN MO	REVISED
PLOT SCALE = 50.0000' / 1" =	CHECKED FZ	REVISED
PLOT DATE = 9/14/2017	DATE 02/02/2017	REVISED

**STATE OF ILLINOIS
DEPARTMENT OF TRANSPORTATION**

**MAINTENANCE OF TRAFFIC
STAGE 3**




SCALE: 1"=50' SHEET 6 OF 10 SHEETS STA. 158+00 TO STA. 171+00

F.A.P. RTE.	SECTION	COUNTY	TOTAL SHEETS	SHEET NO.
344	39 R	LAKE	510	115
CONTRACT NO. 60T75			ILLINOIS FED. AID PROJECT	


PLAN	SURVEYED	BY	DATE
	PLOTTED		
	GRADES CHECKED		
	STRUCTURE NOT AT THIS CHECK		
	NOTE BOOK NO.		
	CADD FILE NAME		

PROFILE	SURVEYED	BY	DATE
	PLOTTED		
	GRADES CHECKED		
	STRUCTURE NOT AT THIS CHECK		
	NOTE BOOK NO.		
	CADD FILE NAME		

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NOTE: W21-1 AND/OR W20-7(O)-48 MUST BE REMOVED WHEN FLAGGER OR WORKER ARE NOT PRESENT FOR MORE THAN ONE HOUR

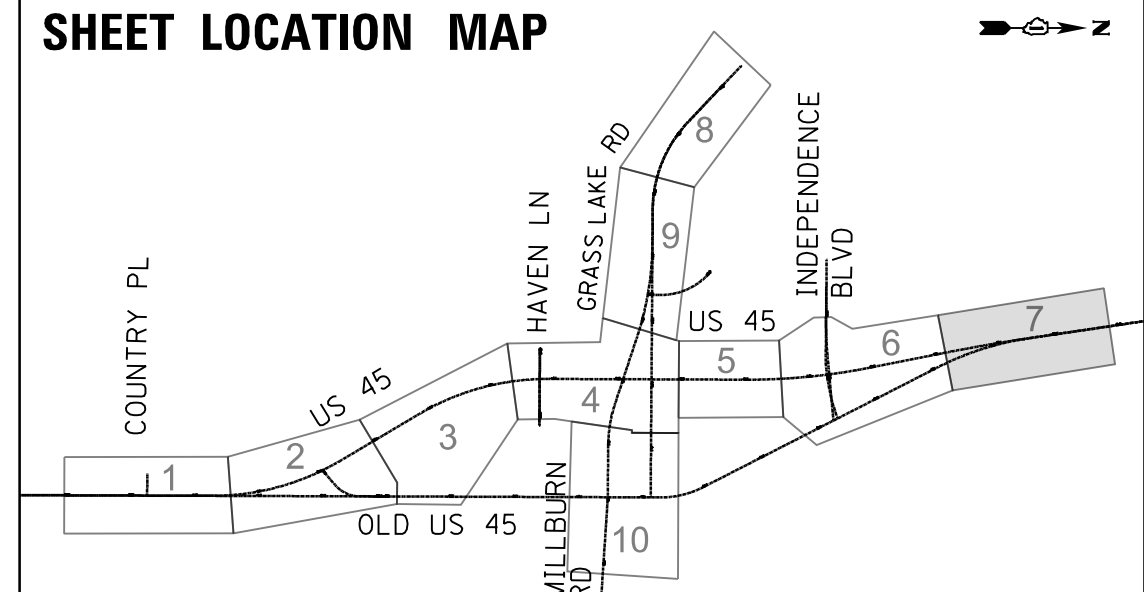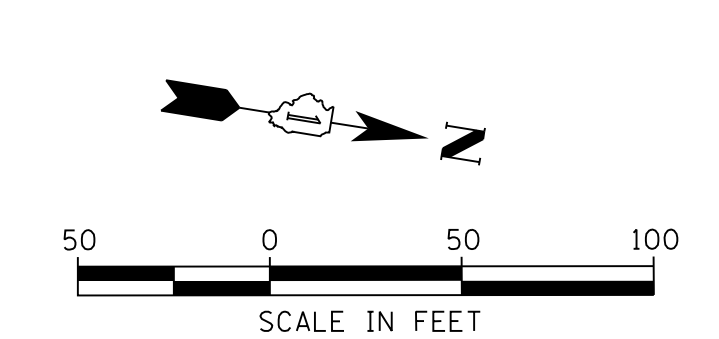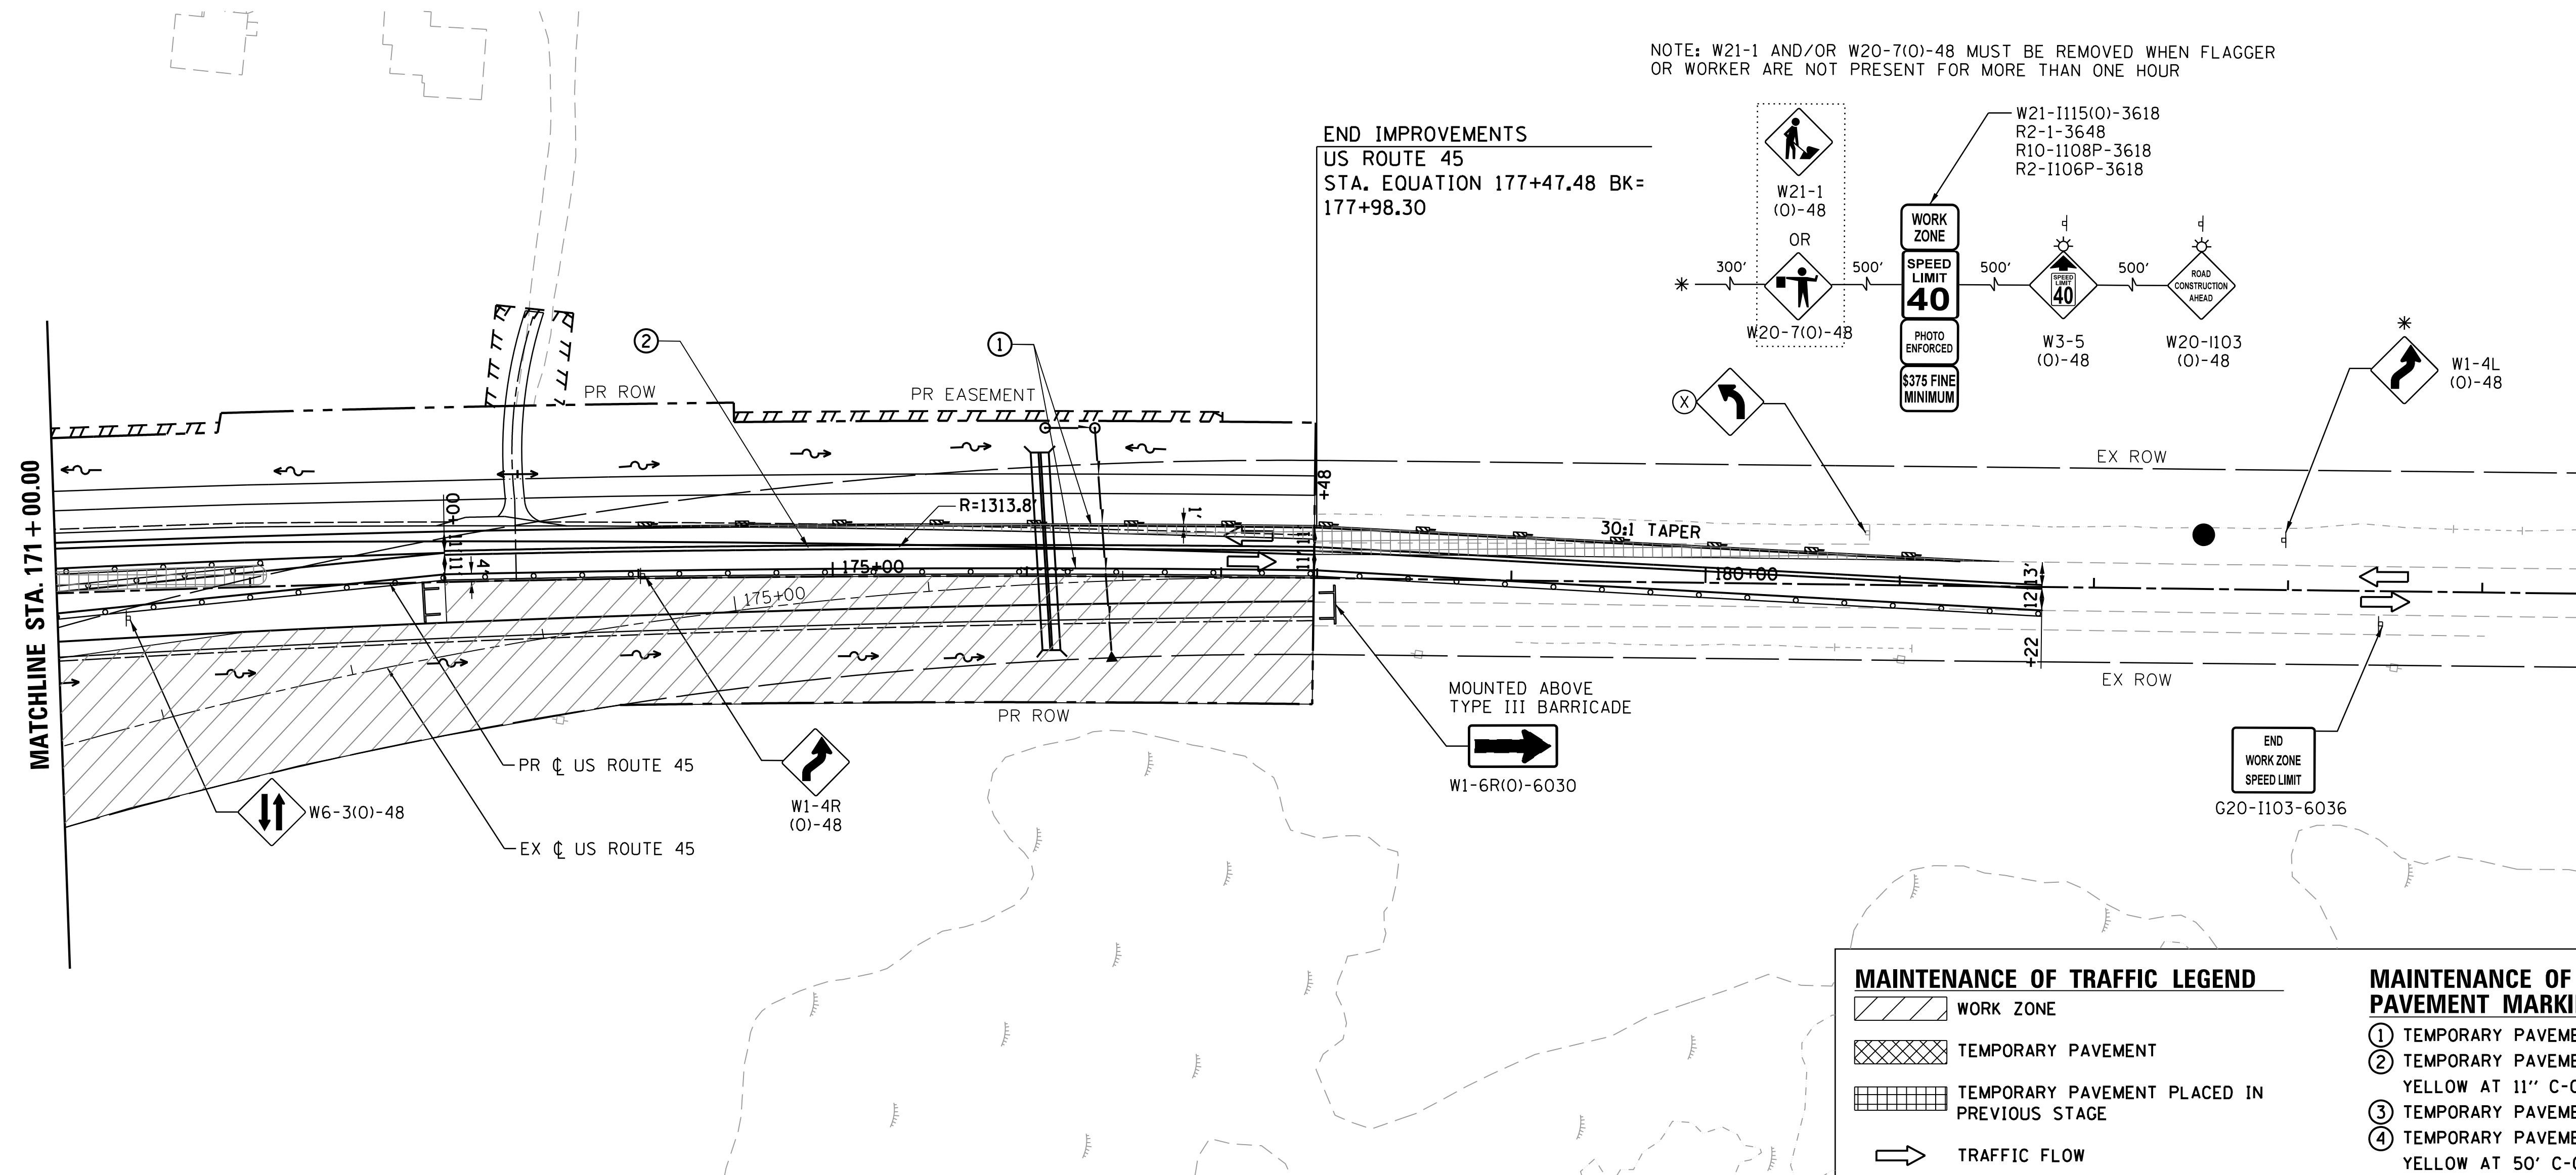

MAINTENANCE OF TRAFFIC LEGEND

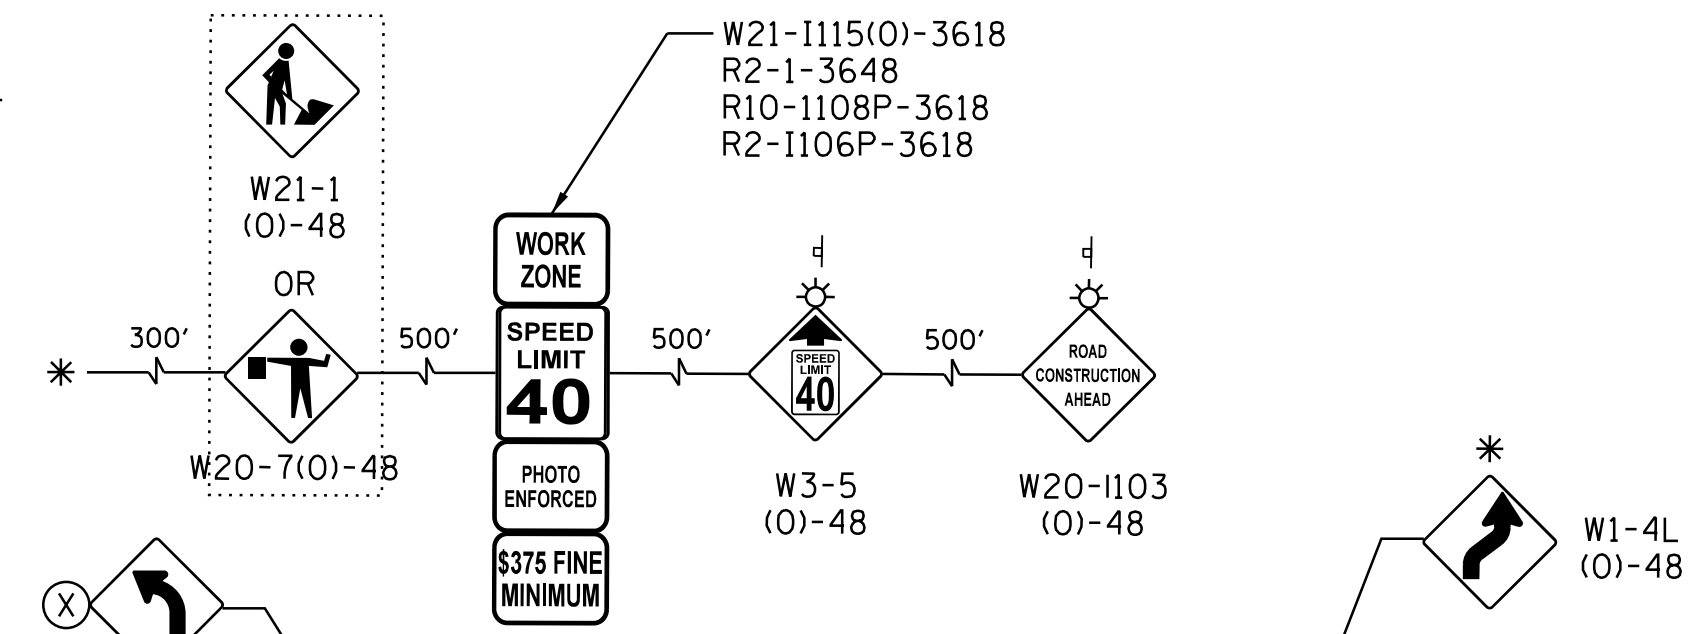- WORK ZONE
- TEMPORARY PAVEMENT
- TEMPORARY PAVEMENT PLACED IN PREVIOUS STAGE
- TRAFFIC FLOW
- TYPE II BARRICADES OR DRUMS WITH BI-DIRECTIONAL STEADY BURN LIGHT AT 50' C-C (TYP.) 25' C-C IN CURVES AND RADII, AND 20' C-C IN TAPERS
- DOUBLE VERTICAL PANEL WITH STEADY BURN BI-DIRECTIONAL LIGHT
- FLAGGER WITH TRAFFIC CONTROL DEVICE
- TYPE III BARRICADE
- TEMPORARY CONCRETE BARRIER

MAINTENANCE OF TRAFFIC PAVEMENT MARKING

- ① TEMPORARY PAVEMENT MARKING, LINE 4" WHITE
- ② TEMPORARY PAVEMENT MARKING, LINE 4" DOUBLE YELLOW AT 11" C-C
- ③ TEMPORARY PAVEMENT MARKING, LINE 24" WHITE
- ④ TEMPORARY PAVEMENT MARKING, LINE 12" YELLOW AT 50' C-C
- ⑤ TEMPORARY PAVEMENT MARKING, LINE 4", WHITE (10'-30' SKIP DASH)
- ⑥ TEMPORARY PAVEMENT MARKING LETTERS AND SYMBOLS
- ⑦ TEMPORARY PAVEMENT MARKING, LINE 4", WHITE (2'-6' SKIP DASH)

MAINTENANCE OF TRAFFIC SIGNING

- (X) REMOVE EXISTING SIGN
- (R) RELOCATE EXISTING SIGN
- (C) COVER EXISTING SIGN

USER NAME = 35361	DESIGNED MO	REVISED -
	DRAWN MO	REVISED
PLOT SCALE = 50.0000' / in.	CHECKED FZ	REVISED
PLOT DATE = 9/14/2017	DATE 02/02/2017	REVISED

STATE OF ILLINOIS
DEPARTMENT OF TRANSPORTATION

MAINTENANCE OF TRAFFIC
STAGE 3





SCALE: 1"=50' SHEET 7 OF 10 SHEETS STA. 171+00 TO STA. 178+00

F.A.P. RTE.	SECTION	COUNTY	TOTAL SHEETS	SHEET NO.
344	39 R	LAKE	510	116
CONTRACT NO. 60T75				
ILLINOIS FED. AID PROJECT				

PLAN	SURVEYED	BY	DATE
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PROFILE	SURVEYED	BY	DATE
	PLOTTED		
	CHECKED		
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	NO.		
	FILE NAME		

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NOTE: W21-1 AND/OR W20-7(O)-48 MUST BE REMOVED WHEN FLAGGER OR WORKER ARE NOT PRESENT FOR MORE THAN ONE HOUR

MAINTENANCE OF TRAFFIC LEGEND

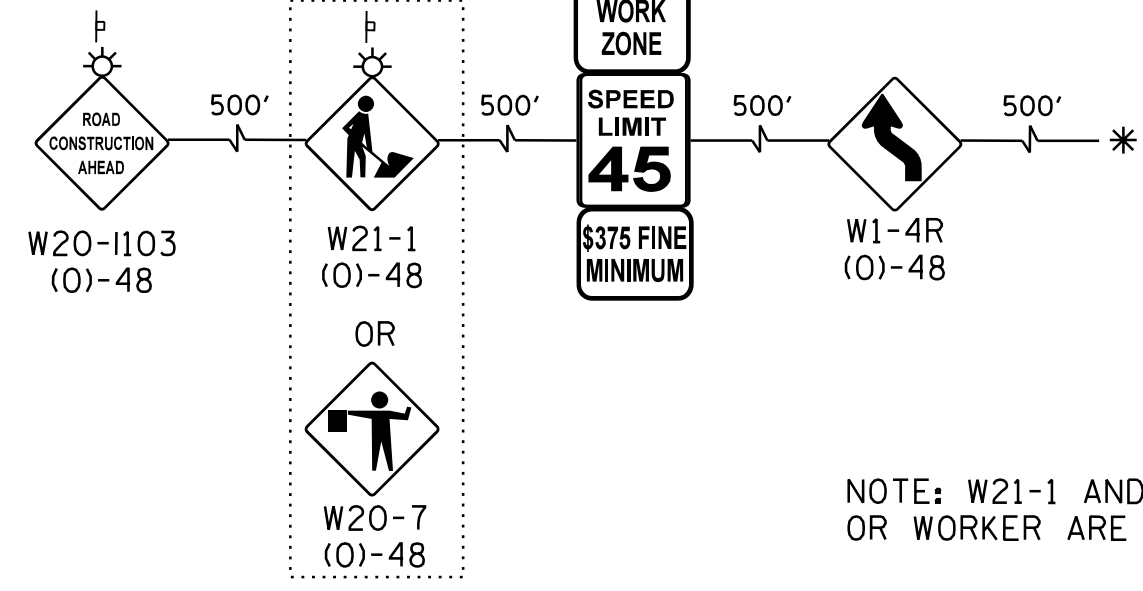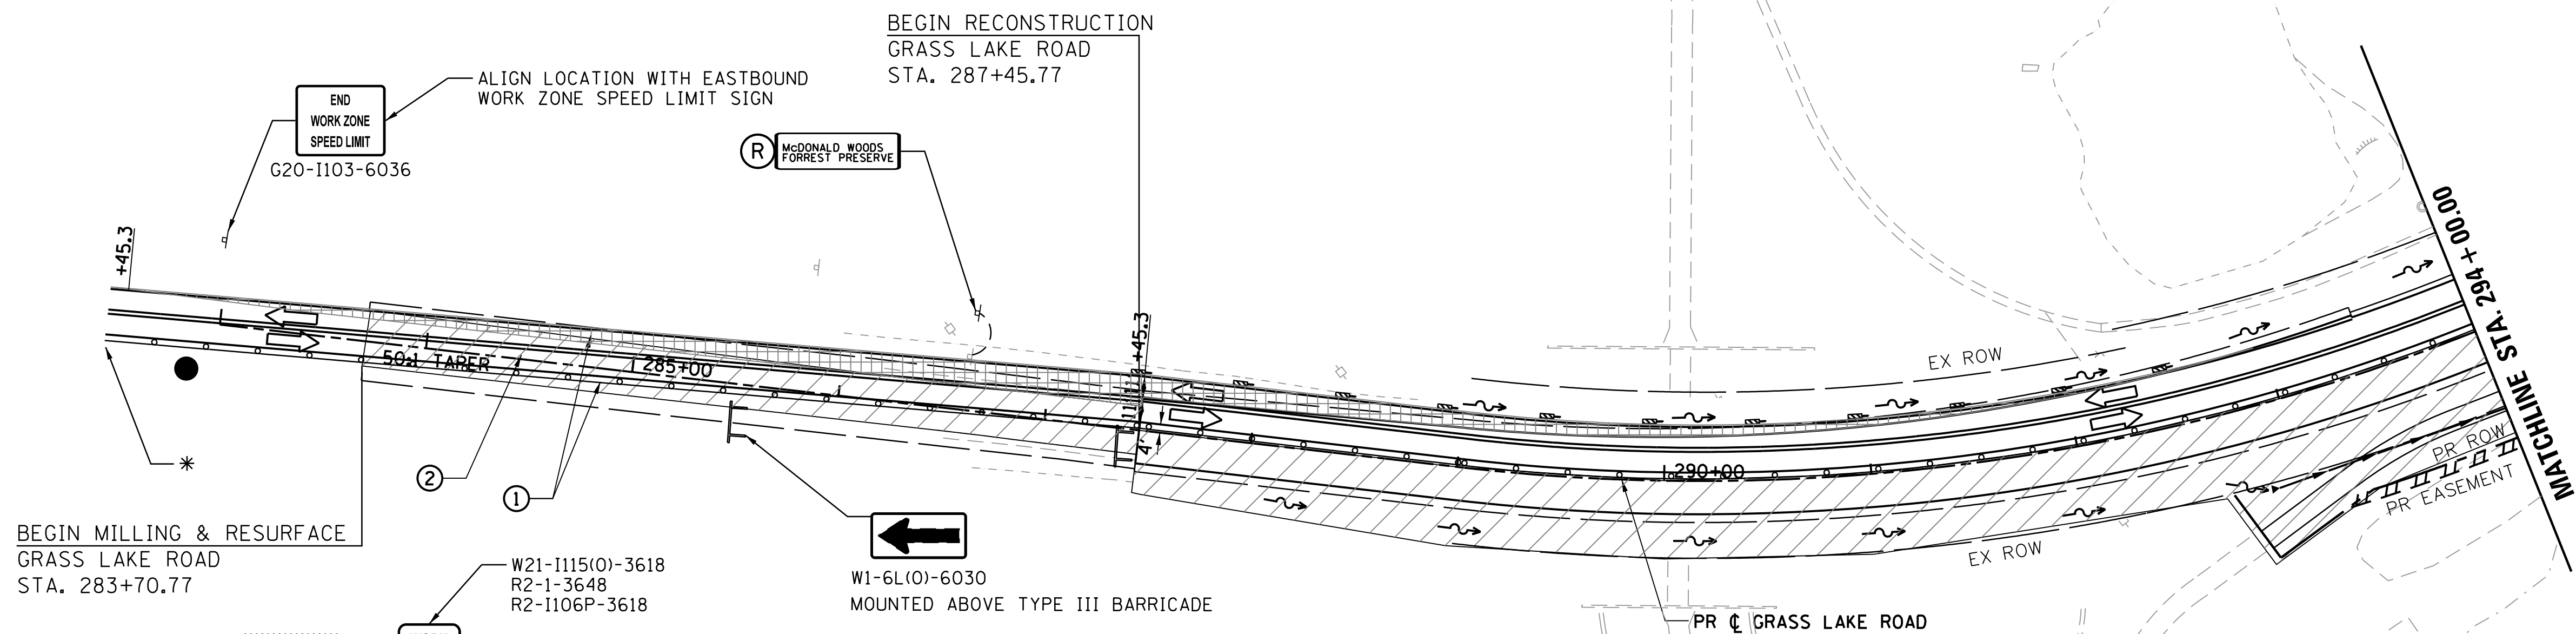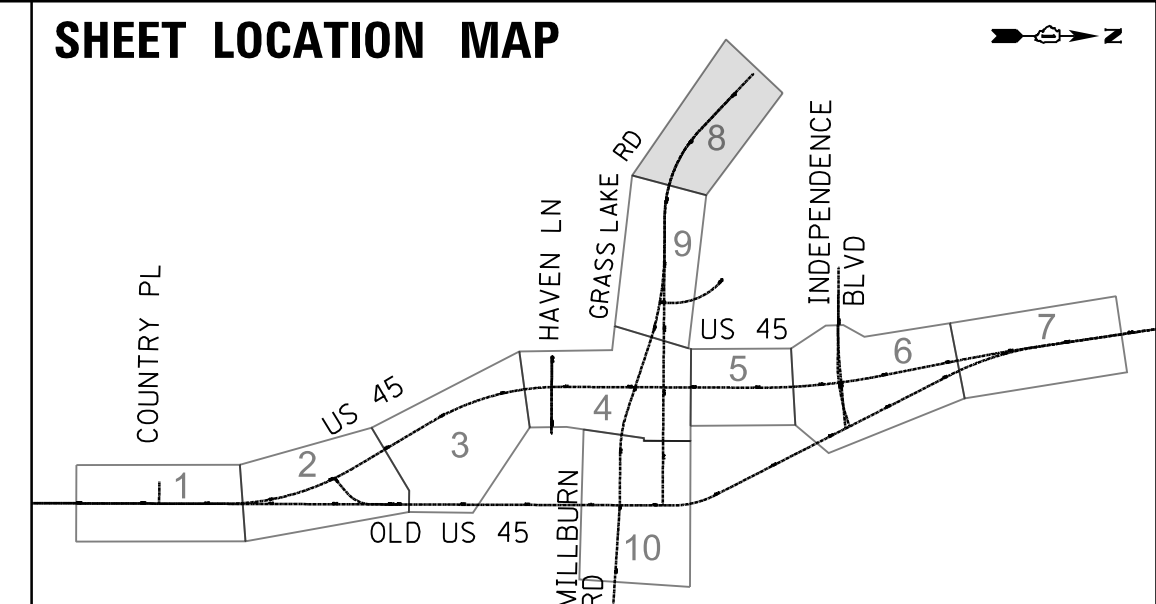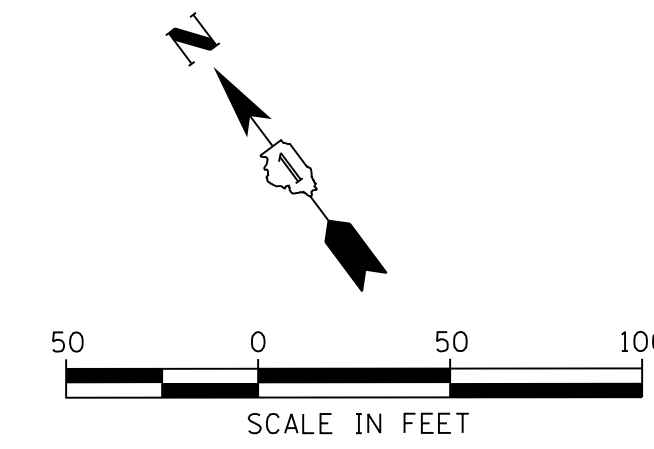- WORK ZONE
- TEMPORARY PAVEMENT
- TEMPORARY PAVEMENT PLACED IN PREVIOUS STAGE
- TRAFFIC FLOW
- TYPE II BARRICADES OR DRUMS WITH BI-DIRECTIONAL STEADY BURN LIGHT AT 50' C-C (TYP.) 25' C-C IN CURVES AND RADII, AND 20' C-C IN TAPERS
- DOUBLE VERTICAL PANEL WITH STEADY BURN BI-DIRECTIONAL LIGHT
- FLAGGER WITH TRAFFIC CONTROL DEVICE
- TYPE III BARRICADE
- TEMPORARY CONCRETE BARRIER

MAINTENANCE OF TRAFFIC PAVEMENT MARKING

- ① TEMPORARY PAVEMENT MARKING, LINE 4" WHITE
- ② TEMPORARY PAVEMENT MARKING, LINE 4" DOUBLE YELLOW AT 11" C-C
- ③ TEMPORARY PAVEMENT MARKING, LINE 24" WHITE
- ④ TEMPORARY PAVEMENT MARKING, LINE 12" YELLOW AT 50' C-C
- ⑤ TEMPORARY PAVEMENT MARKING, LINE 4", WHITE (10'-30' SKIP DASH)
- ⑥ TEMPORARY PAVEMENT MARKING LETTERS AND SYMBOLS
- ⑦ TEMPORARY PAVEMENT MARKING, LINE 4", WHITE (2'-6' SKIP DASH)

MAINTENANCE OF TRAFFIC SIGNING

- ⓧ REMOVE EXISTING SIGN
- Ⓡ RELOCATE EXISTING SIGN
- Ⓢ COVER EXISTING SIGN

USER NAME = 35361	DESIGNED MO	REVISED -
	DRAWN MO	REVISED
PLOT SCALE = 50.0000' / 1"	CHECKED FZ	REVISED
PLOT DATE = 9/14/2017	DATE 02/02/2017	REVISED

**STATE OF ILLINOIS
DEPARTMENT OF TRANSPORTATION**

**MAINTENANCE OF TRAFFIC
STAGE 3**

SCALE: 1"=50' SHEET 8 OF 10 SHEETS STA. 287+50 TO STA. 294+00

F.A.P. RTE.	SECTION	COUNTY	TOTAL SHEETS	SHEET NO.
344	39 R	LAKE	510	117
CONTRACT NO. 60T75				
ILLINOIS FED. AID PROJECT				


MAINTENANCE OF TRAFFIC LEGEND

- WORK ZONE
- TEMPORARY PAVEMENT
- TEMPORARY PAVEMENT PLACED IN PREVIOUS STAGE
- TRAFFIC FLOW
- TYPE II BARRICADES OR DRUMS WITH BI-DIRECTIONAL STEADY BURN LIGHT AT 50' C-C (TYP.) 25' C-C IN CURVES AND RADII, AND 20' C-C IN TAPERS
- DOUBLE VERTICAL PANEL WITH STEADY BURN BI-DIRECTIONAL LIGHT
- FLAGGER WITH TRAFFIC CONTROL DEVICE
- TYPE III BARRICADE
- TEMPORARY CONCRETE BARRIER

MAINTENANCE OF TRAFFIC PAVEMENT MARKING

- ① TEMPORARY PAVEMENT MARKING, LINE 4" WHITE
 - ② TEMPORARY PAVEMENT MARKING, LINE 4" DOUBLE YELLOW AT 11" C-C
 - ③ TEMPORARY PAVEMENT MARKING, LINE 24" WHITE YELLOW AT 50' C-C
 - ④ TEMPORARY PAVEMENT MARKING, LINE 12" YELLOW AT 50' C-C
 - ⑤ TEMPORARY PAVEMENT MARKING, LINE 4", WHITE (10'-30' SKIP DASH)
 - ⑥ TEMPORARY PAVEMENT MARKING LETTERS AND SYMBOLS
 - ⑦ TEMPORARY PAVEMENT MARKING, LINE 4", WHITE (2'-6' SKIP DASH)
- MAINTENANCE OF TRAFFIC SIGNING**
- (X) REMOVE EXISTING SIGN
 - (R) RELOCATE EXISTING SIGN
 - (C) COVER EXISTING SIGN


SHEET LOCATION MAP

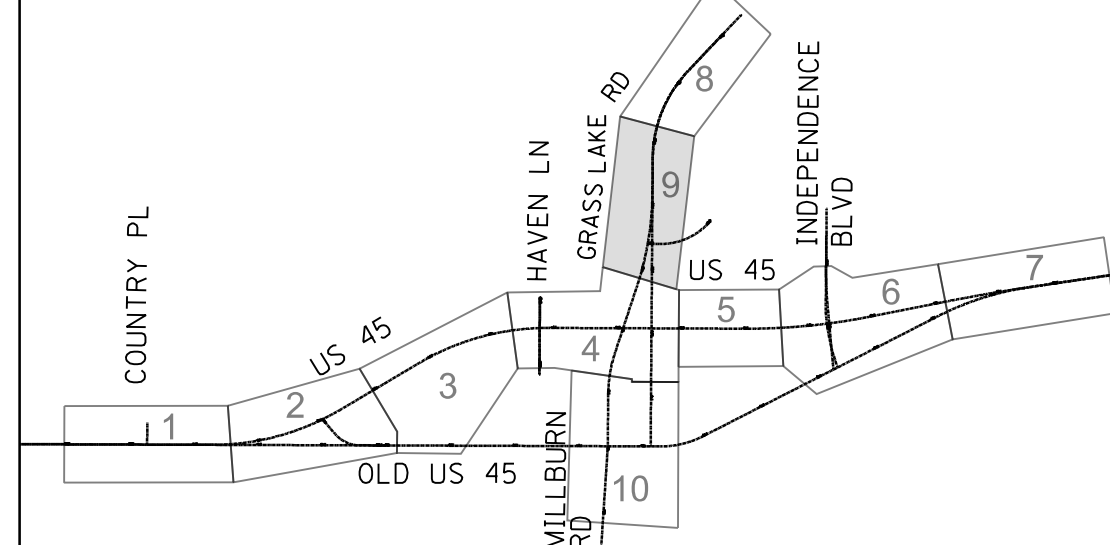

PLAN	SURVEYED	DATE
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	DATE	

PROFILE	SURVEYED	DATE
	PLOTTED	
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	BY	
	DATE	

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USER NAME = 35361	DESIGNED MO	REVISED -
	DRAWN MO	REVISED
PLOT SCALE = 50.0000' / in.	CHECKED FZ	REVISED
PLOT DATE = 9/14/2017	DATE 02/02/2017	REVISED

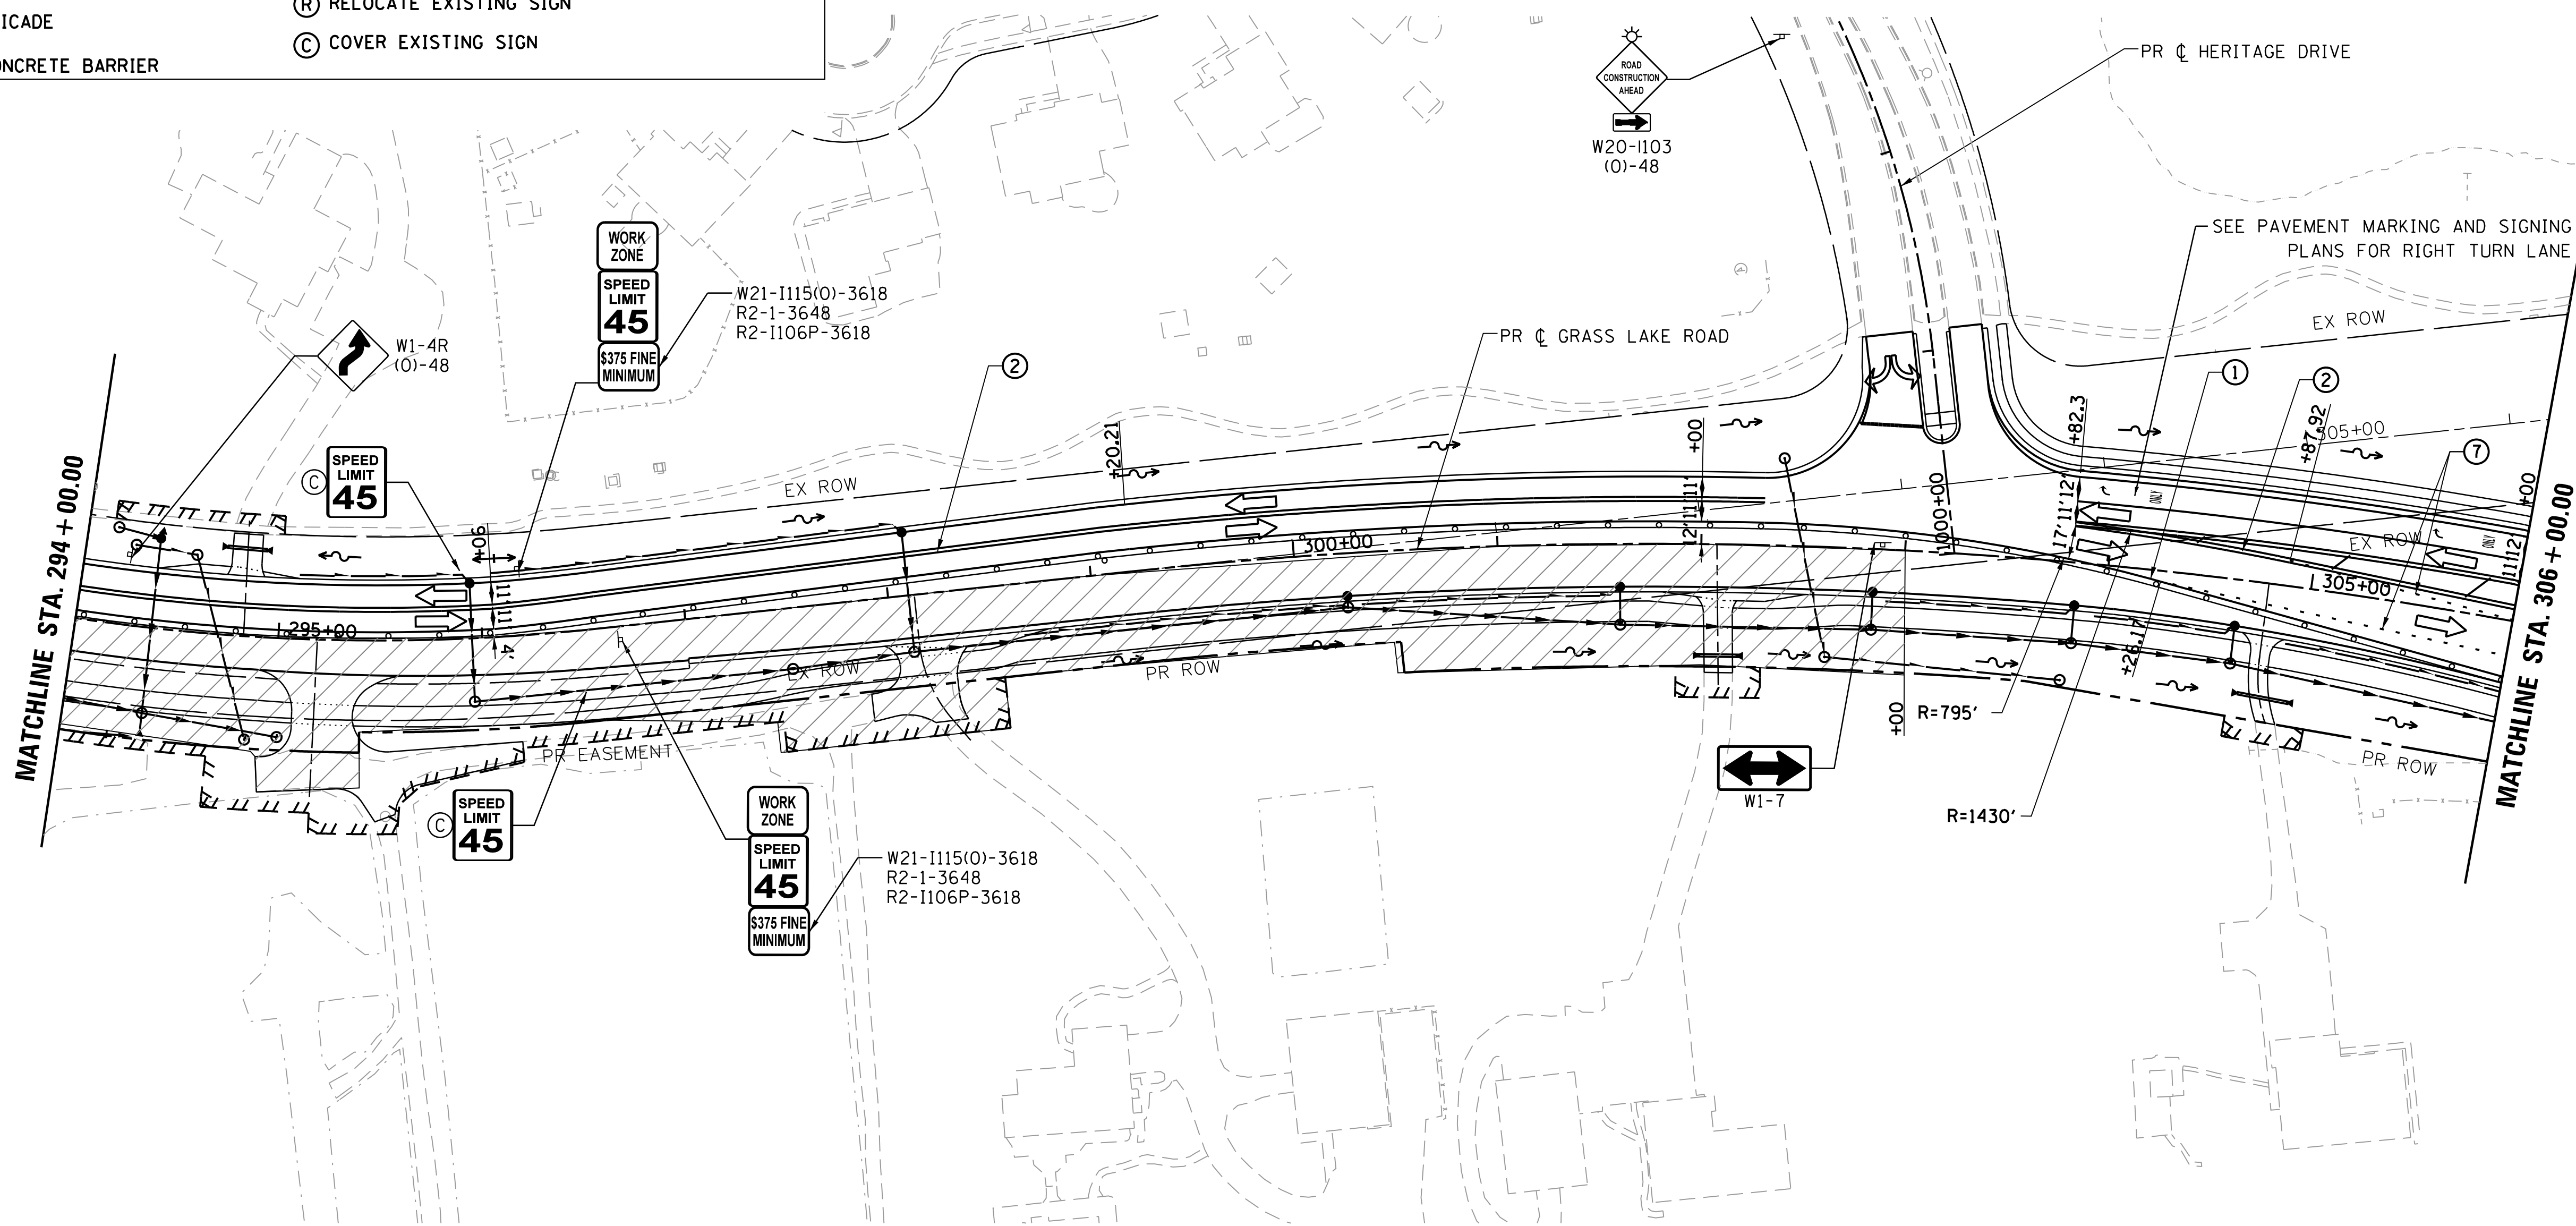**STATE OF ILLINOIS
DEPARTMENT OF TRANSPORTATION**

**MAINTENANCE OF TRAFFIC
STAGE 3**




SCALE: 1"=50' SHEET 9 OF 10 SHEETS STA. 294+00 TO STA. 304+00

F.A.P. RTE.	SECTION	COUNTY	TOTAL SHEETS	SHEET NO.
344	39 R	LAKE	510	118
CONTRACT NO. 60T75			ILLINOIS FED. AID PROJECT	

PLAN	SURVEYED	DATE
	PLOTTED	
	GRADES CHECKED	
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	NOTE BOOK NO.	
	CADD FILE NAME	

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	PLOTTED	
	GRADES CHECKED	
	STRUCTURE NOTATIONS CHECKED	
	NOTE BOOK NO.	
	CADD FILE NAME	

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MAINTENANCE OF TRAFFIC LEGEND

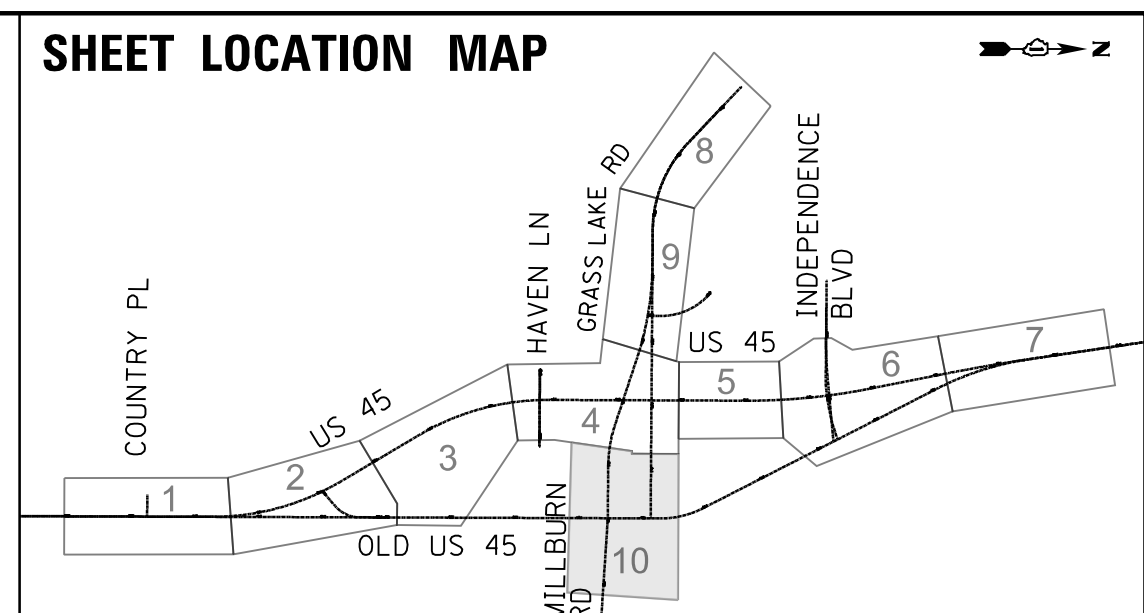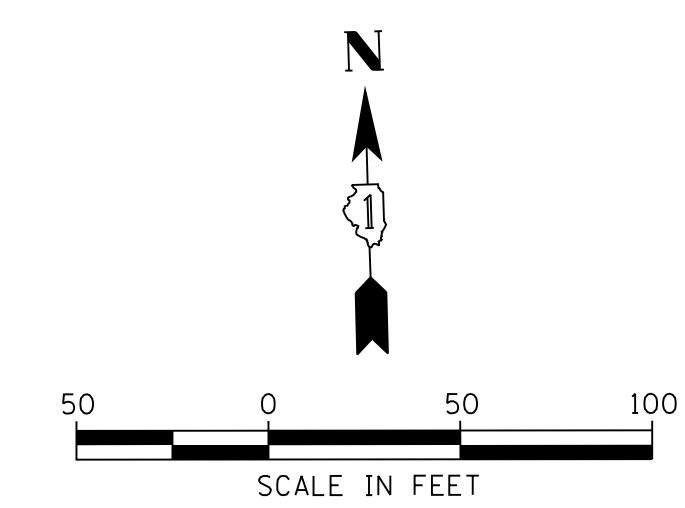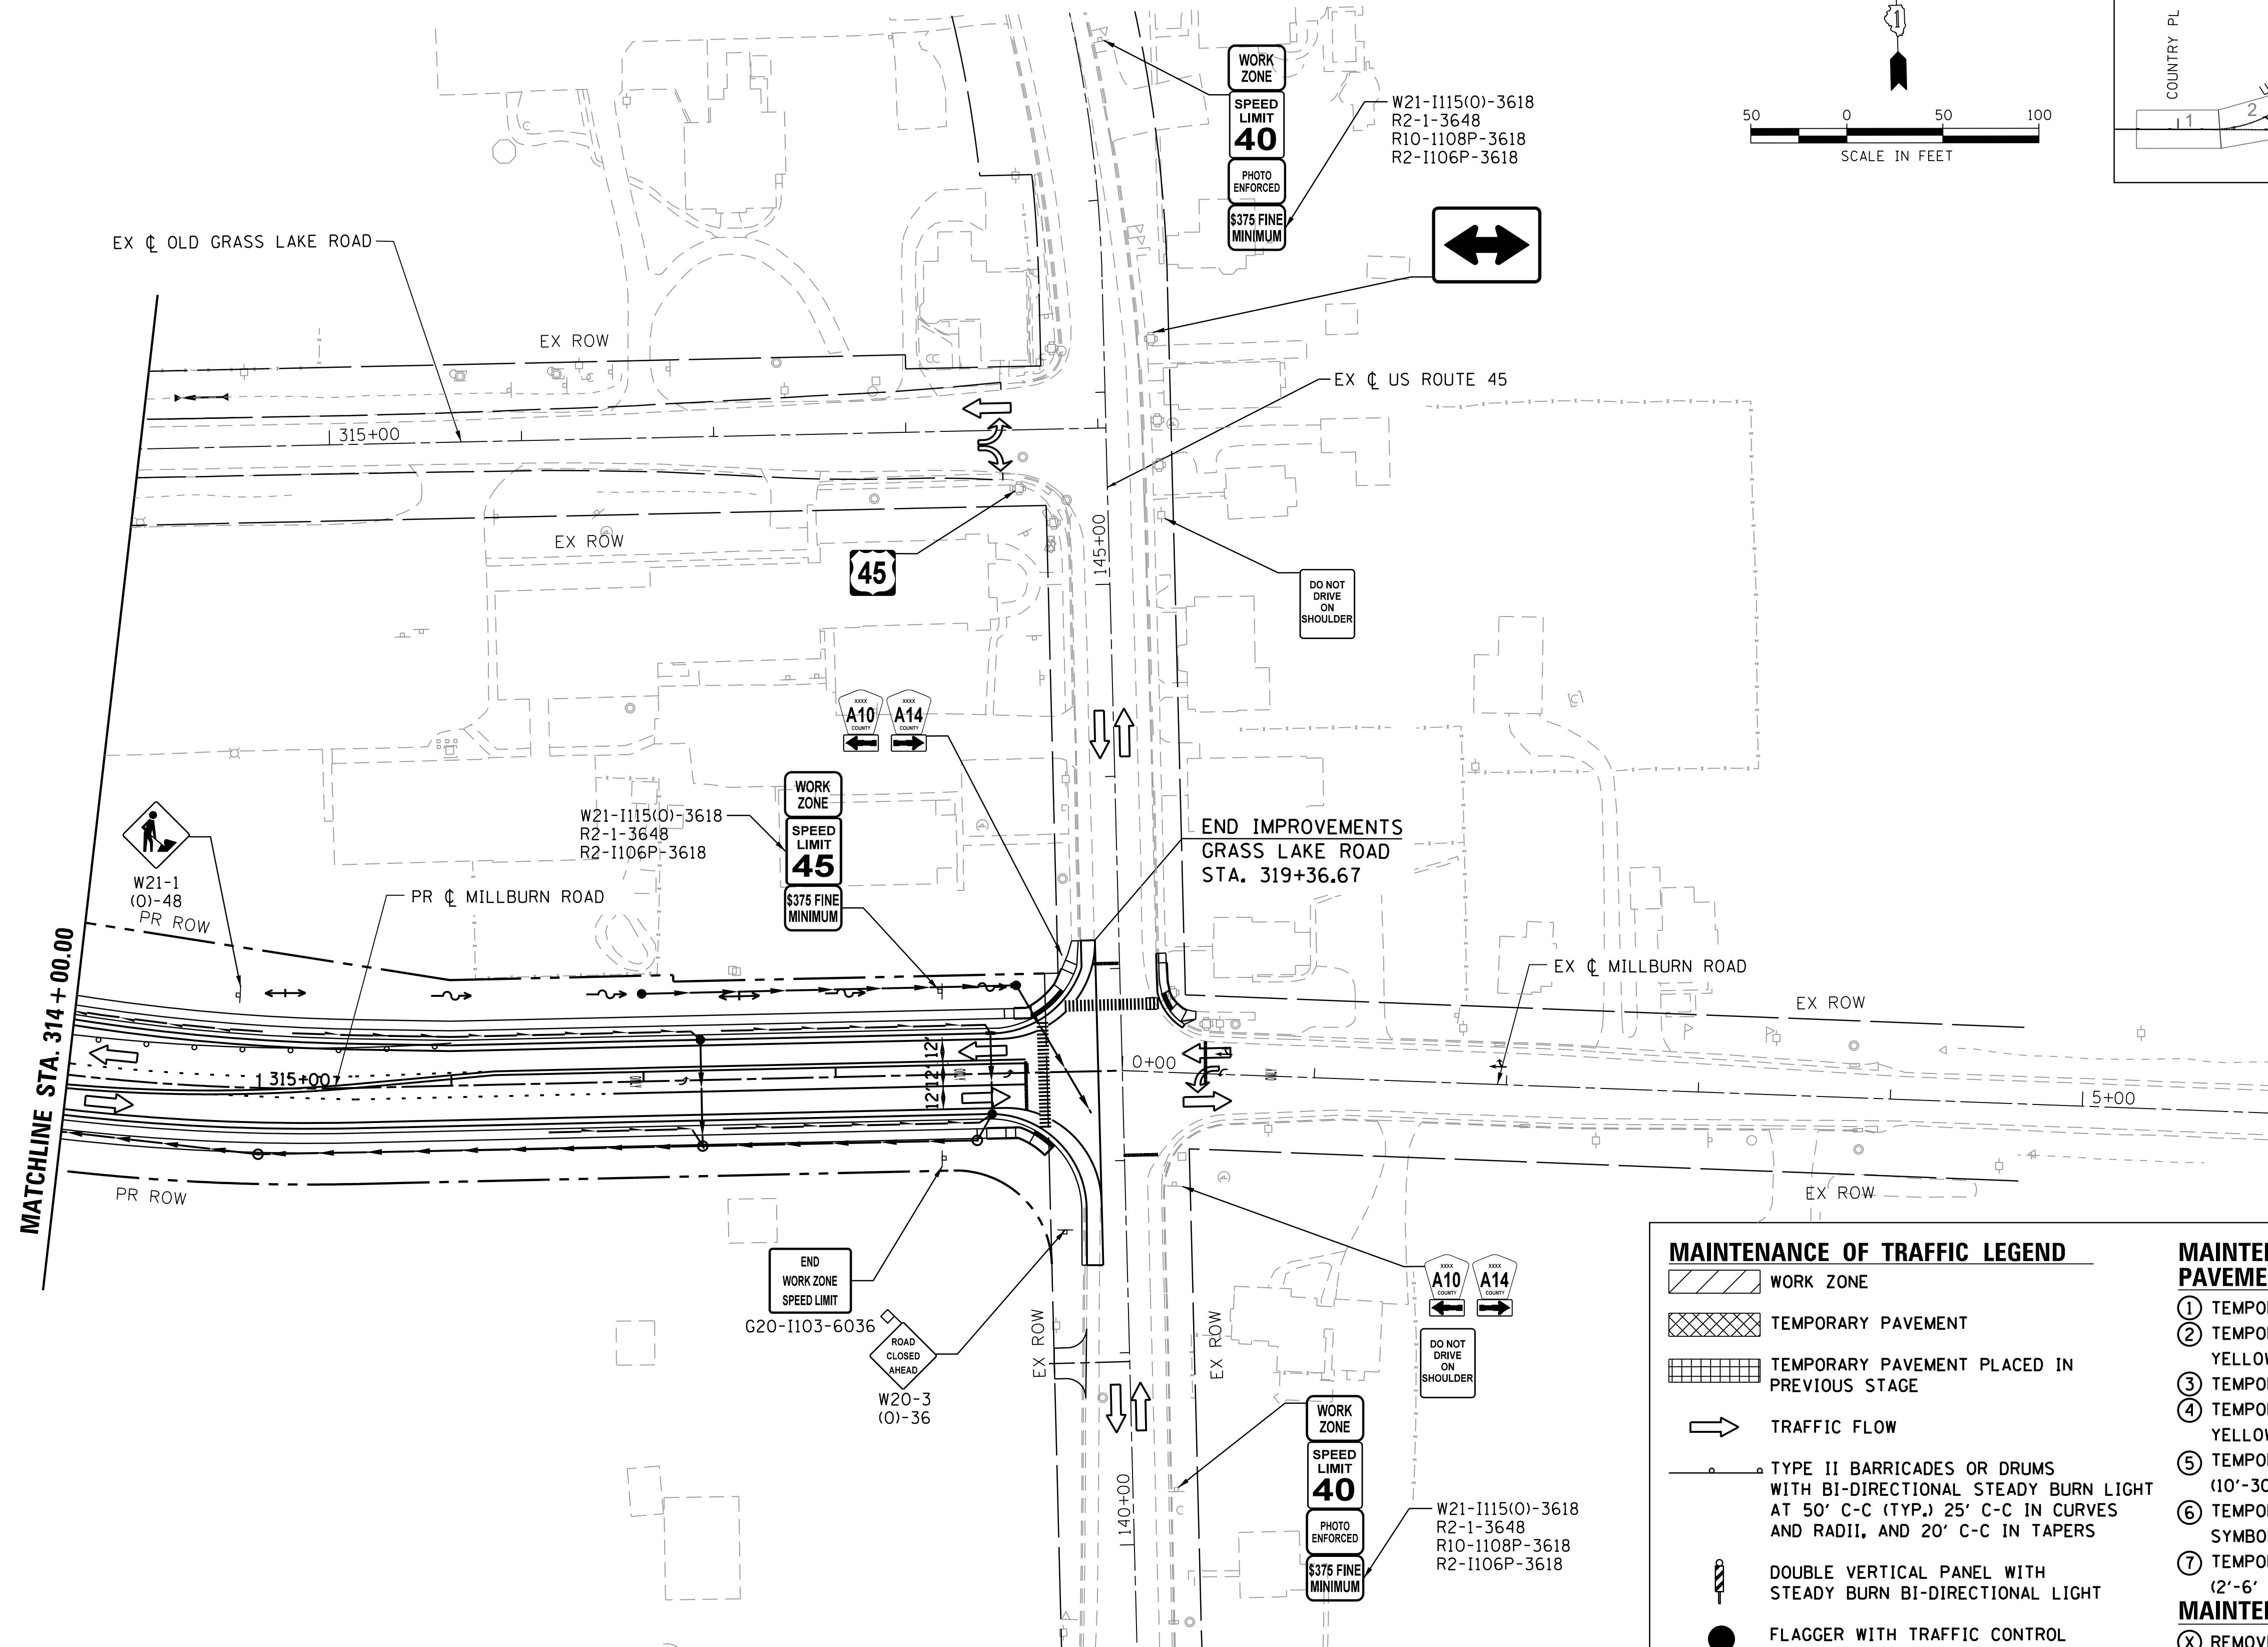- WORK ZONE
- TEMPORARY PAVEMENT
- TEMPORARY PAVEMENT PLACED IN PREVIOUS STAGE
- TRAFFIC FLOW
- TYPE II BARRICADES OR DRUMS WITH BI-DIRECTIONAL STEADY BURN LIGHT AT 50' C-C (TYP.), 25' C-C IN CURVES AND RADII, AND 20' C-C IN TAPERS
- DOUBLE VERTICAL PANEL WITH STEADY BURN BI-DIRECTIONAL LIGHT
- FLAGGER WITH TRAFFIC CONTROL DEVICE
- TYPE III BARRICADE
- TEMPORARY CONCRETE BARRIER

MAINTENANCE OF TRAFFIC PAVEMENT MARKING

- ① TEMPORARY PAVEMENT MARKING, LINE 4" WHITE
- ② TEMPORARY PAVEMENT MARKING, LINE 4" DOUBLE YELLOW AT 11" C-C
- ③ TEMPORARY PAVEMENT MARKING, LINE 24" WHITE
- ④ TEMPORARY PAVEMENT MARKING, LINE 12" YELLOW AT 50' C-C
- ⑤ TEMPORARY PAVEMENT MARKING, LINE 4", WHITE (10'-30' SKIP DASH)
- ⑥ TEMPORARY PAVEMENT MARKING LETTERS AND SYMBOLS
- ⑦ TEMPORARY PAVEMENT MARKING, LINE 4", WHITE (2'-6' SKIP DASH)

MAINTENANCE OF TRAFFIC SIGNING

- ⓧ REMOVE EXISTING SIGN
- Ⓡ RELOCATE EXISTING SIGN
- Ⓢ COVER EXISTING SIGN

USER NAME = 35361	DESIGNED MO	REVISED -
	DRAWN MO	REVISED
PLOT SCALE = 50.0000' / in.	CHECKED FZ	REVISED
PLOT DATE = 9/14/2017	DATE 02/02/2017	REVISED

**STATE OF ILLINOIS
DEPARTMENT OF TRANSPORTATION**

**MAINTENANCE OF TRAFFIC
STAGE 3**





SCALE: 1"=50' SHEET 10 OF 10 SHEETS STA. 314+00 TO STA.

F.A.P. RTE.	SECTION	COUNTY	TOTAL SHEETS	SHEET NO.
344	39 R	LAKE	510	119
CONTRACT NO. 60T75				
ILLINOIS FED. AID PROJECT				

PLAN	SURVEYED	DATE
	PLOTTED	BY
	GRADES CHECKED	
	STRUCTURE NOTATIONS CHECKED	
	NOTE BOOK NO.	
	CADD FILE NAME	

PROFILE	SURVEYED	DATE
	PLOTTED	BY
	GRADES CHECKED	
	STRUCTURE NOTATIONS CHECKED	
	NOTE BOOK NO.	
	CADD FILE NAME	

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W21-1115(0)-3618
R2-1-3648
R10-1108P-3618
R2-1106P-3618

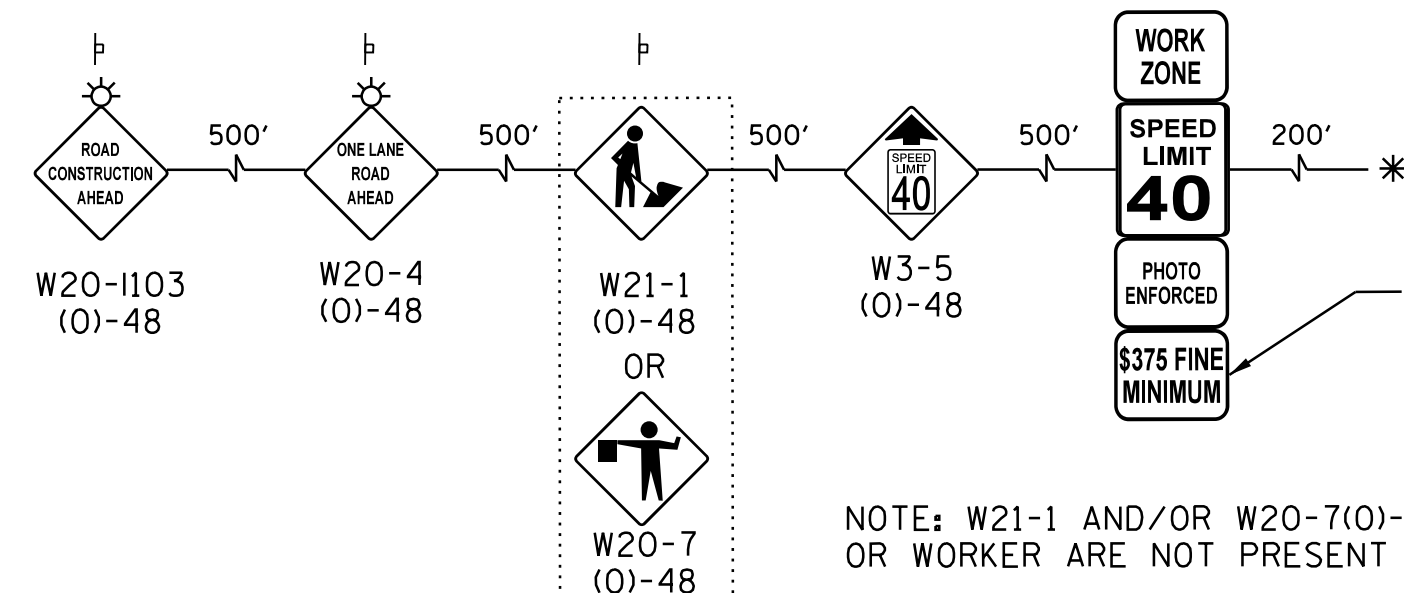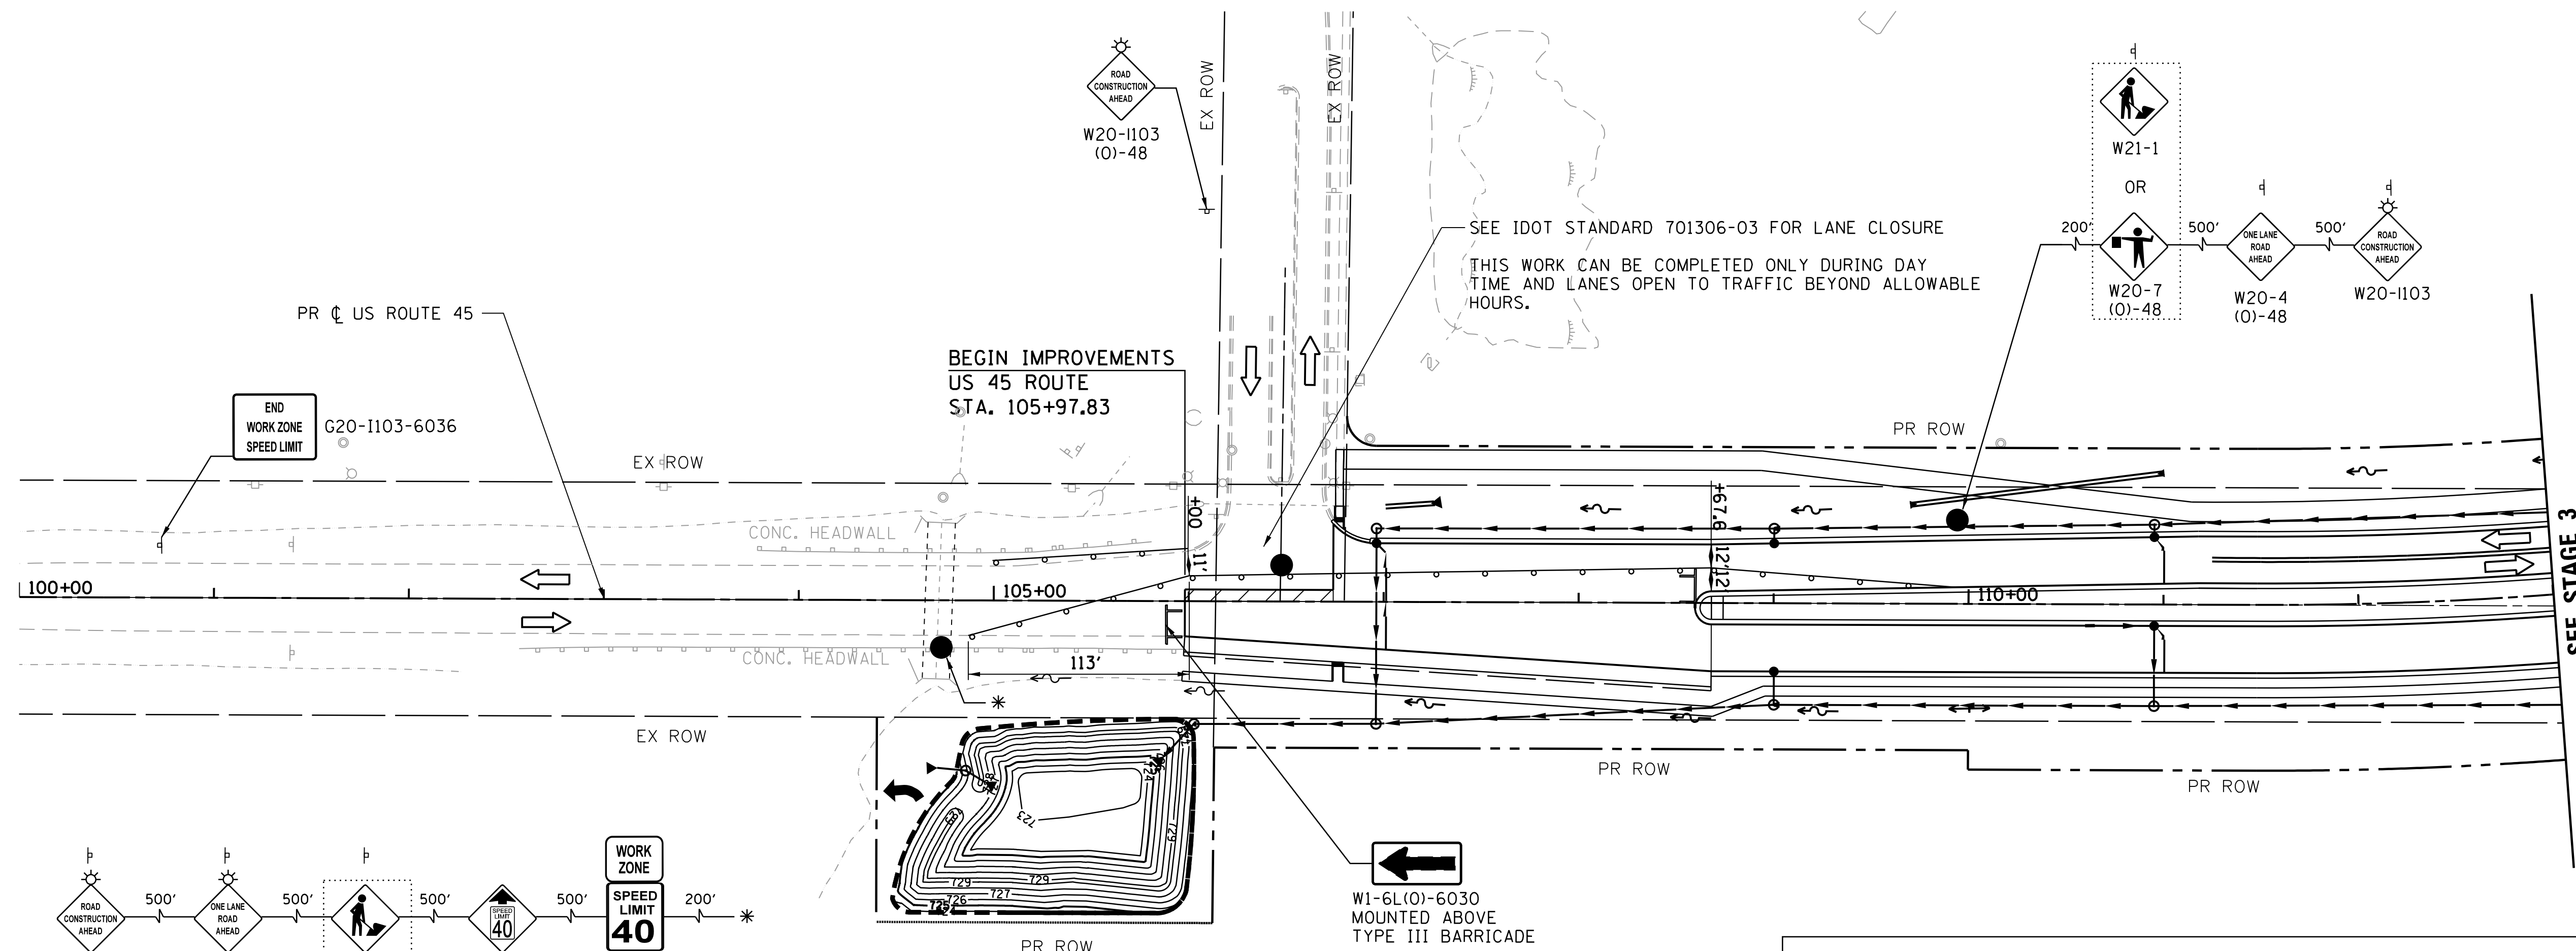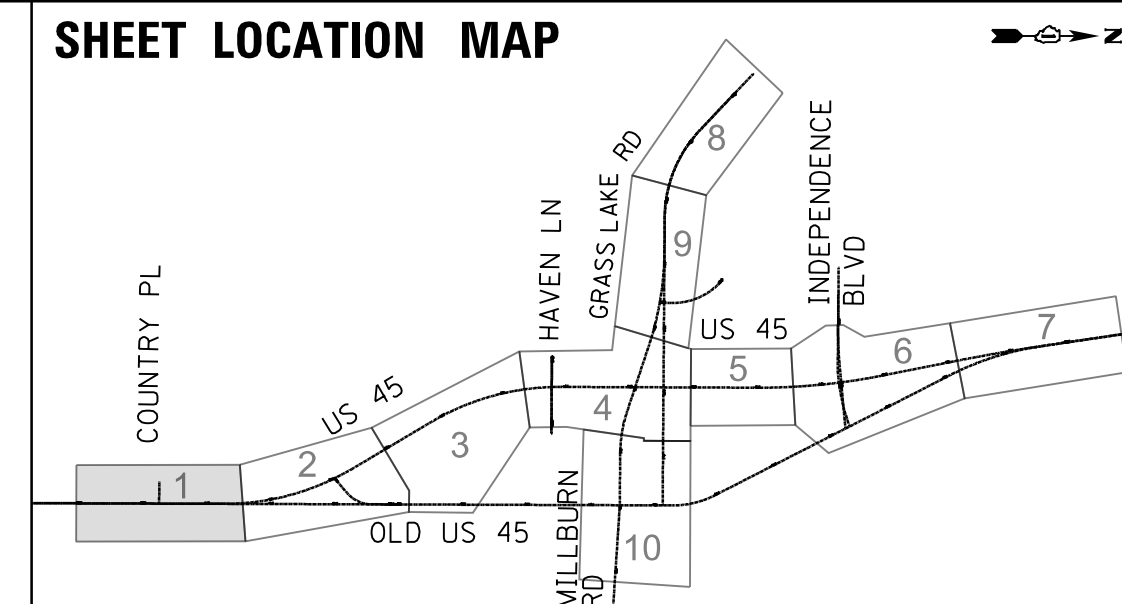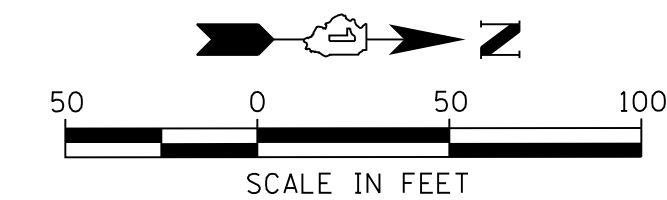NOTE: W21-1 AND/OR W20-7(0)-48 MUST BE REMOVED WHEN FLAGGER OR WORKER ARE NOT PRESENT FOR MORE THAN ONE HOUR

MAINTENANCE OF TRAFFIC LEGEND

- WORK ZONE
- TEMPORARY PAVEMENT
- TEMPORARY PAVEMENT PLACED IN PREVIOUS STAGE
- TRAFFIC FLOW
- TYPE II BARRICADES OR DRUMS WITH BI-DIRECTIONAL STEADY BURN LIGHT AT 50' C-C (TYP.) 25' C-C IN CURVES AND RADII, AND 20' C-C IN TAPERS
- DOUBLE VERTICAL PANEL WITH STEADY BURN BI-DIRECTIONAL LIGHT
- FLAGGER WITH TRAFFIC CONTROL DEVICE
- TYPE III BARRICADE
- TEMPORARY CONCRETE BARRIER

MAINTENANCE OF TRAFFIC PAVEMENT MARKING

- ① TEMPORARY PAVEMENT MARKING, LINE 4" WHITE
- ② TEMPORARY PAVEMENT MARKING, LINE 4" DOUBLE YELLOW AT 11" C-C
- ③ TEMPORARY PAVEMENT MARKING, LINE 24" WHITE YELLOW AT 50' C-C
- ④ TEMPORARY PAVEMENT MARKING, LINE 12" YELLOW AT 50' C-C
- ⑤ TEMPORARY PAVEMENT MARKING, LINE 4", WHITE (10'-30' SKIP DASH)
- ⑥ TEMPORARY PAVEMENT MARKING LETTERS AND SYMBOLS
- ⑦ TEMPORARY PAVEMENT MARKING, LINE 4", WHITE (2'-6' SKIP DASH)

MAINTENANCE OF TRAFFIC SIGNING

- ⓧ REMOVE EXISTING SIGN
- Ⓡ RELOCATE EXISTING SIGN
- Ⓢ COVER EXISTING SIGN

USER NAME = 35361	DESIGNED MO	REVISED -
	DRAWN MO	REVISED
PLOT SCALE = 50.0000' / in.	CHECKED FZ	REVISED
PLOT DATE = 9/14/2017	DATE 02/02/2017	REVISED

**STATE OF ILLINOIS
DEPARTMENT OF TRANSPORTATION**

**MAINTENANCE OF TRAFFIC
STAGE 4A**





SCALE: 1"=50' SHEET 1 OF 10 SHEETS STA. 100+00 TO STA. 113+00

F.A.P. RTE.	SECTION	COUNTY	TOTAL SHEETS	SHEET NO.
344	39 R	LAKE	510	120
CONTRACT NO. 60T75				
ILLINOIS FED. AID PROJECT				

PLAN	SURVEYED	BY	DATE
	PLOTTED		
	GRADES CHECKED		
	STRUCTURE NOTATIONS CHECKED		
	NOTE BOOK NO.		
	CADD FILE NAME		

PROFILE	SURVEYED	BY	DATE
	PLOTTED		
	GRADES CHECKED		
	STRUCTURE NOTATIONS CHECKED		
	NOTE BOOK NO.		
	CADD FILE NAME		

FILE NAME = p:\t\l\p\02\p\02\person\com\illinois\State Documents\US45 - 647965\48 - Design\CAD\Roadway\Sheets\160775.shx.MOT.dwg

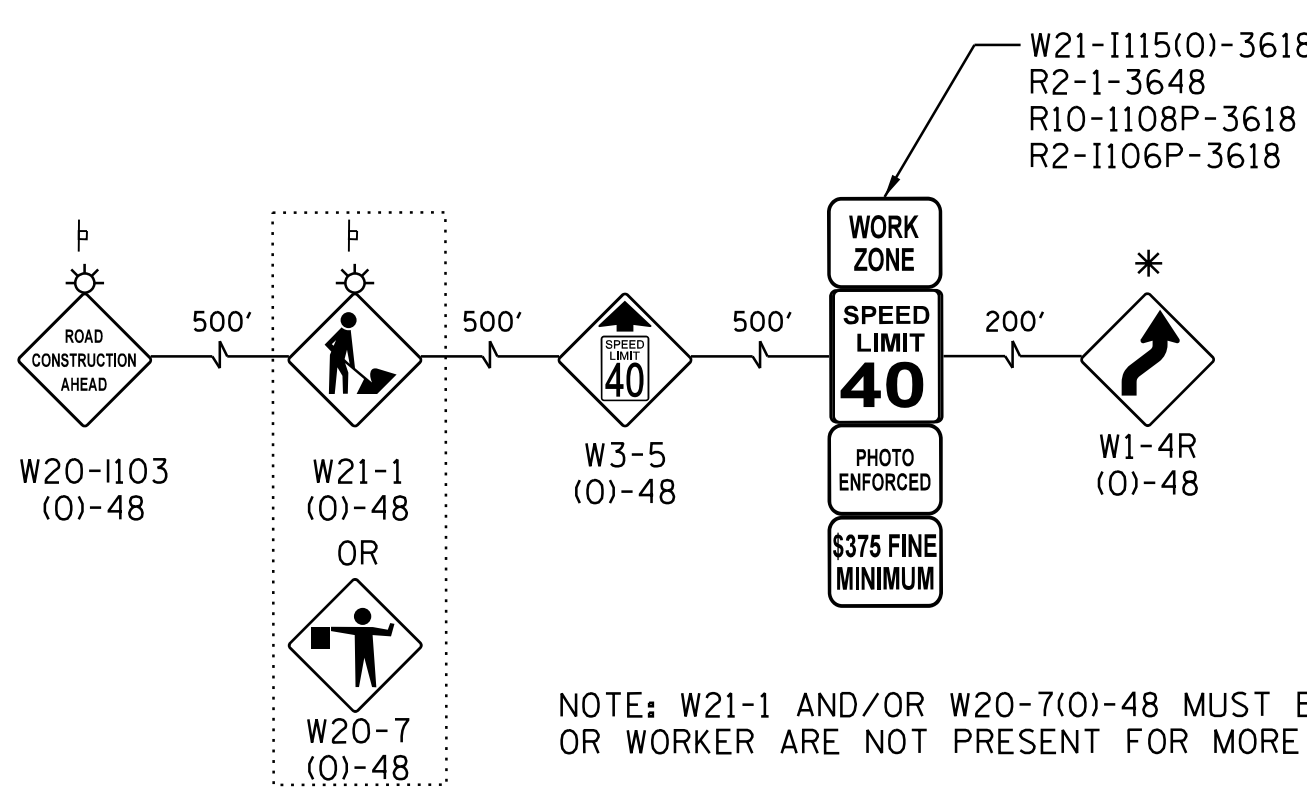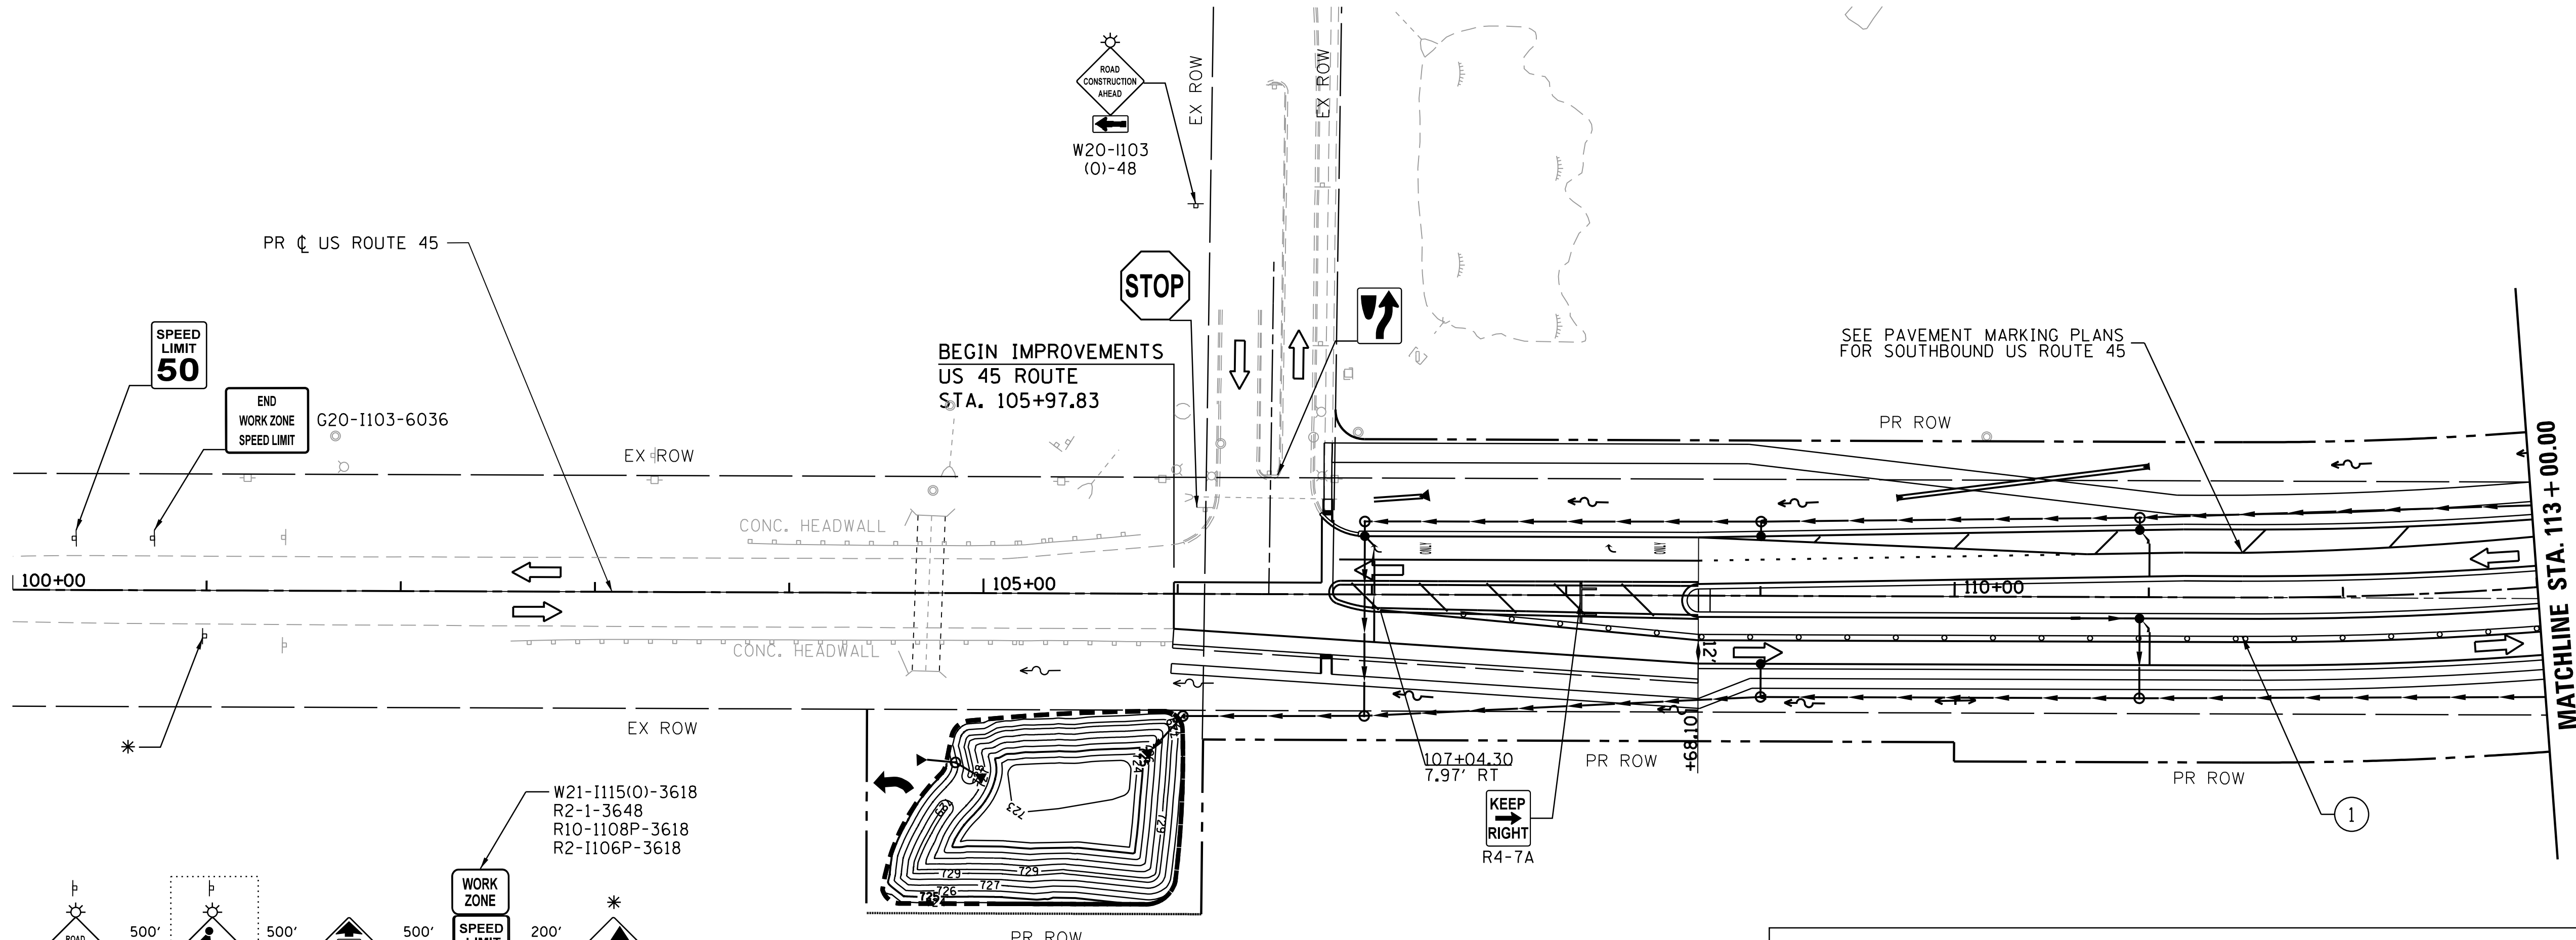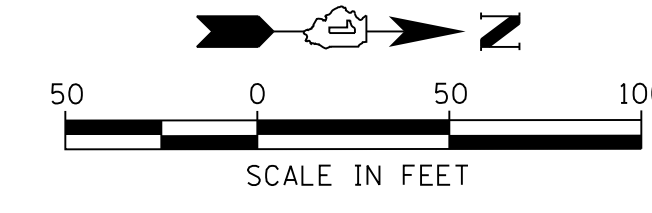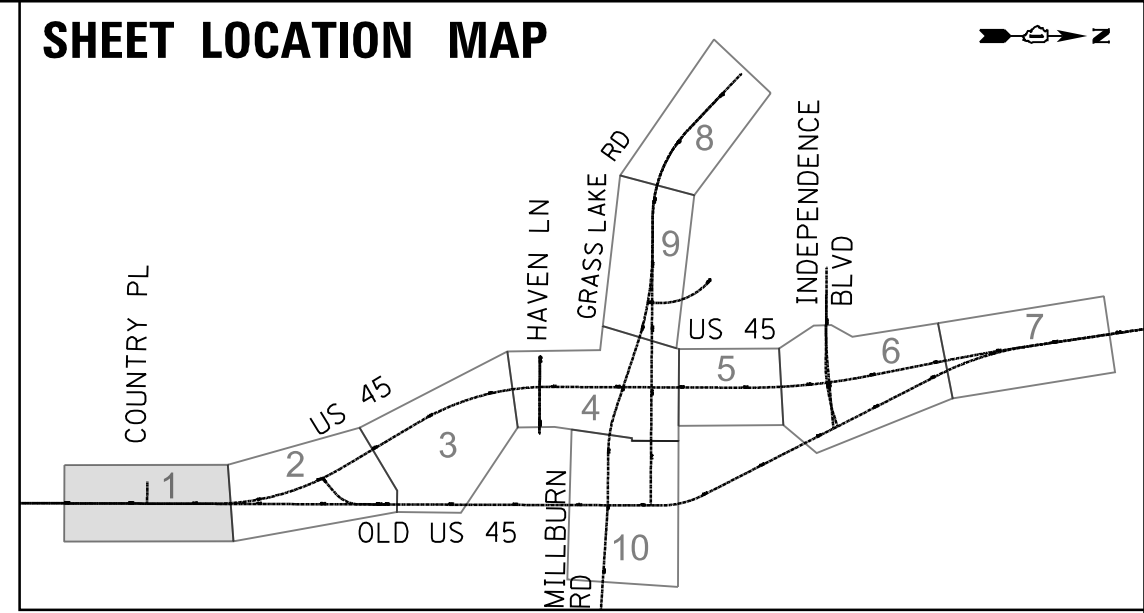

NOTE: W21-1 AND/OR W20-7(0)-48 MUST BE REMOVED WHEN FLAGGER OR WORKER ARE NOT PRESENT FOR MORE THAN ONE HOUR

MAINTENANCE OF TRAFFIC LEGEND

- WORK ZONE
- TEMPORARY PAVEMENT
- TEMPORARY PAVEMENT PLACED IN PREVIOUS STAGE
- TRAFFIC FLOW
- TYPE II BARRICADES OR DRUMS WITH BI-DIRECTIONAL STEADY BURN LIGHT AT 50' C-C (TYP.), 25' C-C IN CURVES AND RADII, AND 20' C-C IN TAPERS
- DOUBLE VERTICAL PANEL WITH STEADY BURN BI-DIRECTIONAL LIGHT
- FLAGGER WITH TRAFFIC CONTROL DEVICE
- TYPE III BARRICADE
- TEMPORARY CONCRETE BARRIER

MAINTENANCE OF TRAFFIC PAVEMENT MARKING

- TEMPORARY PAVEMENT MARKING, LINE 4" WHITE
- TEMPORARY PAVEMENT MARKING, LINE 4" DOUBLE YELLOW AT 11" C-C
- TEMPORARY PAVEMENT MARKING, LINE 24" WHITE
- TEMPORARY PAVEMENT MARKING, LINE 12" YELLOW AT 50' C-C
- TEMPORARY PAVEMENT MARKING, LINE 4", WHITE (10'-30' SKIP DASH)
- TEMPORARY PAVEMENT MARKING LETTERS AND SYMBOLS
- TEMPORARY PAVEMENT MARKING, LINE 4", WHITE (2'-6' SKIP DASH)

MAINTENANCE OF TRAFFIC SIGNING

- REMOVE EXISTING SIGN
- RELOCATE EXISTING SIGN
- COVER EXISTING SIGN

USER NAME = 35361	DESIGNED MO	REVISED -
	DRAWN MO	REVISED
PLOT SCALE = 50.0000' / in.	CHECKED FZ	REVISED
PLOT DATE = 9/14/2017	DATE 02/02/2017	REVISED

**STATE OF ILLINOIS
DEPARTMENT OF TRANSPORTATION**

SCALE: 1"=50' SHEET 1 OF 10 SHEETS STA. 100+00 TO STA. 113+00



**MAINTENANCE OF TRAFFIC
STAGE 4**

F.A.P. RTE.	SECTION	COUNTY	TOTAL SHEETS	SHEET NO.
344	39 R	LAKE	510	121
CONTRACT NO. 60T75				
ILLINOIS FED. AID PROJECT				

PLAN	SURVEYED	BY	DATE
	PLOTTED		
	CHECKED		
	ALIGNED		
	FILED		
	NO. _____		
	FILE NAME _____		

PROFILE	SURVEYED	BY	DATE
	PLOTTED		
	CHECKED		
	GRADES		
	STRUCTURE		
	NOTATRS		
	CHKD		
	NO. _____		
	FILE NAME _____		


FILE NAME = p:\t\l\ed2\p\p\person\com\illinois\State\Documents\US45 - 647965\48 - Design\CAD\Roadway\Sheets\160775.shx\160775.dwg

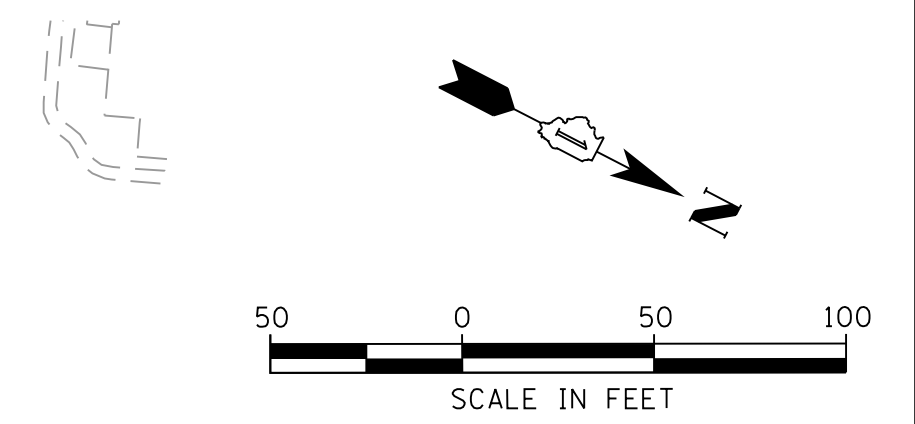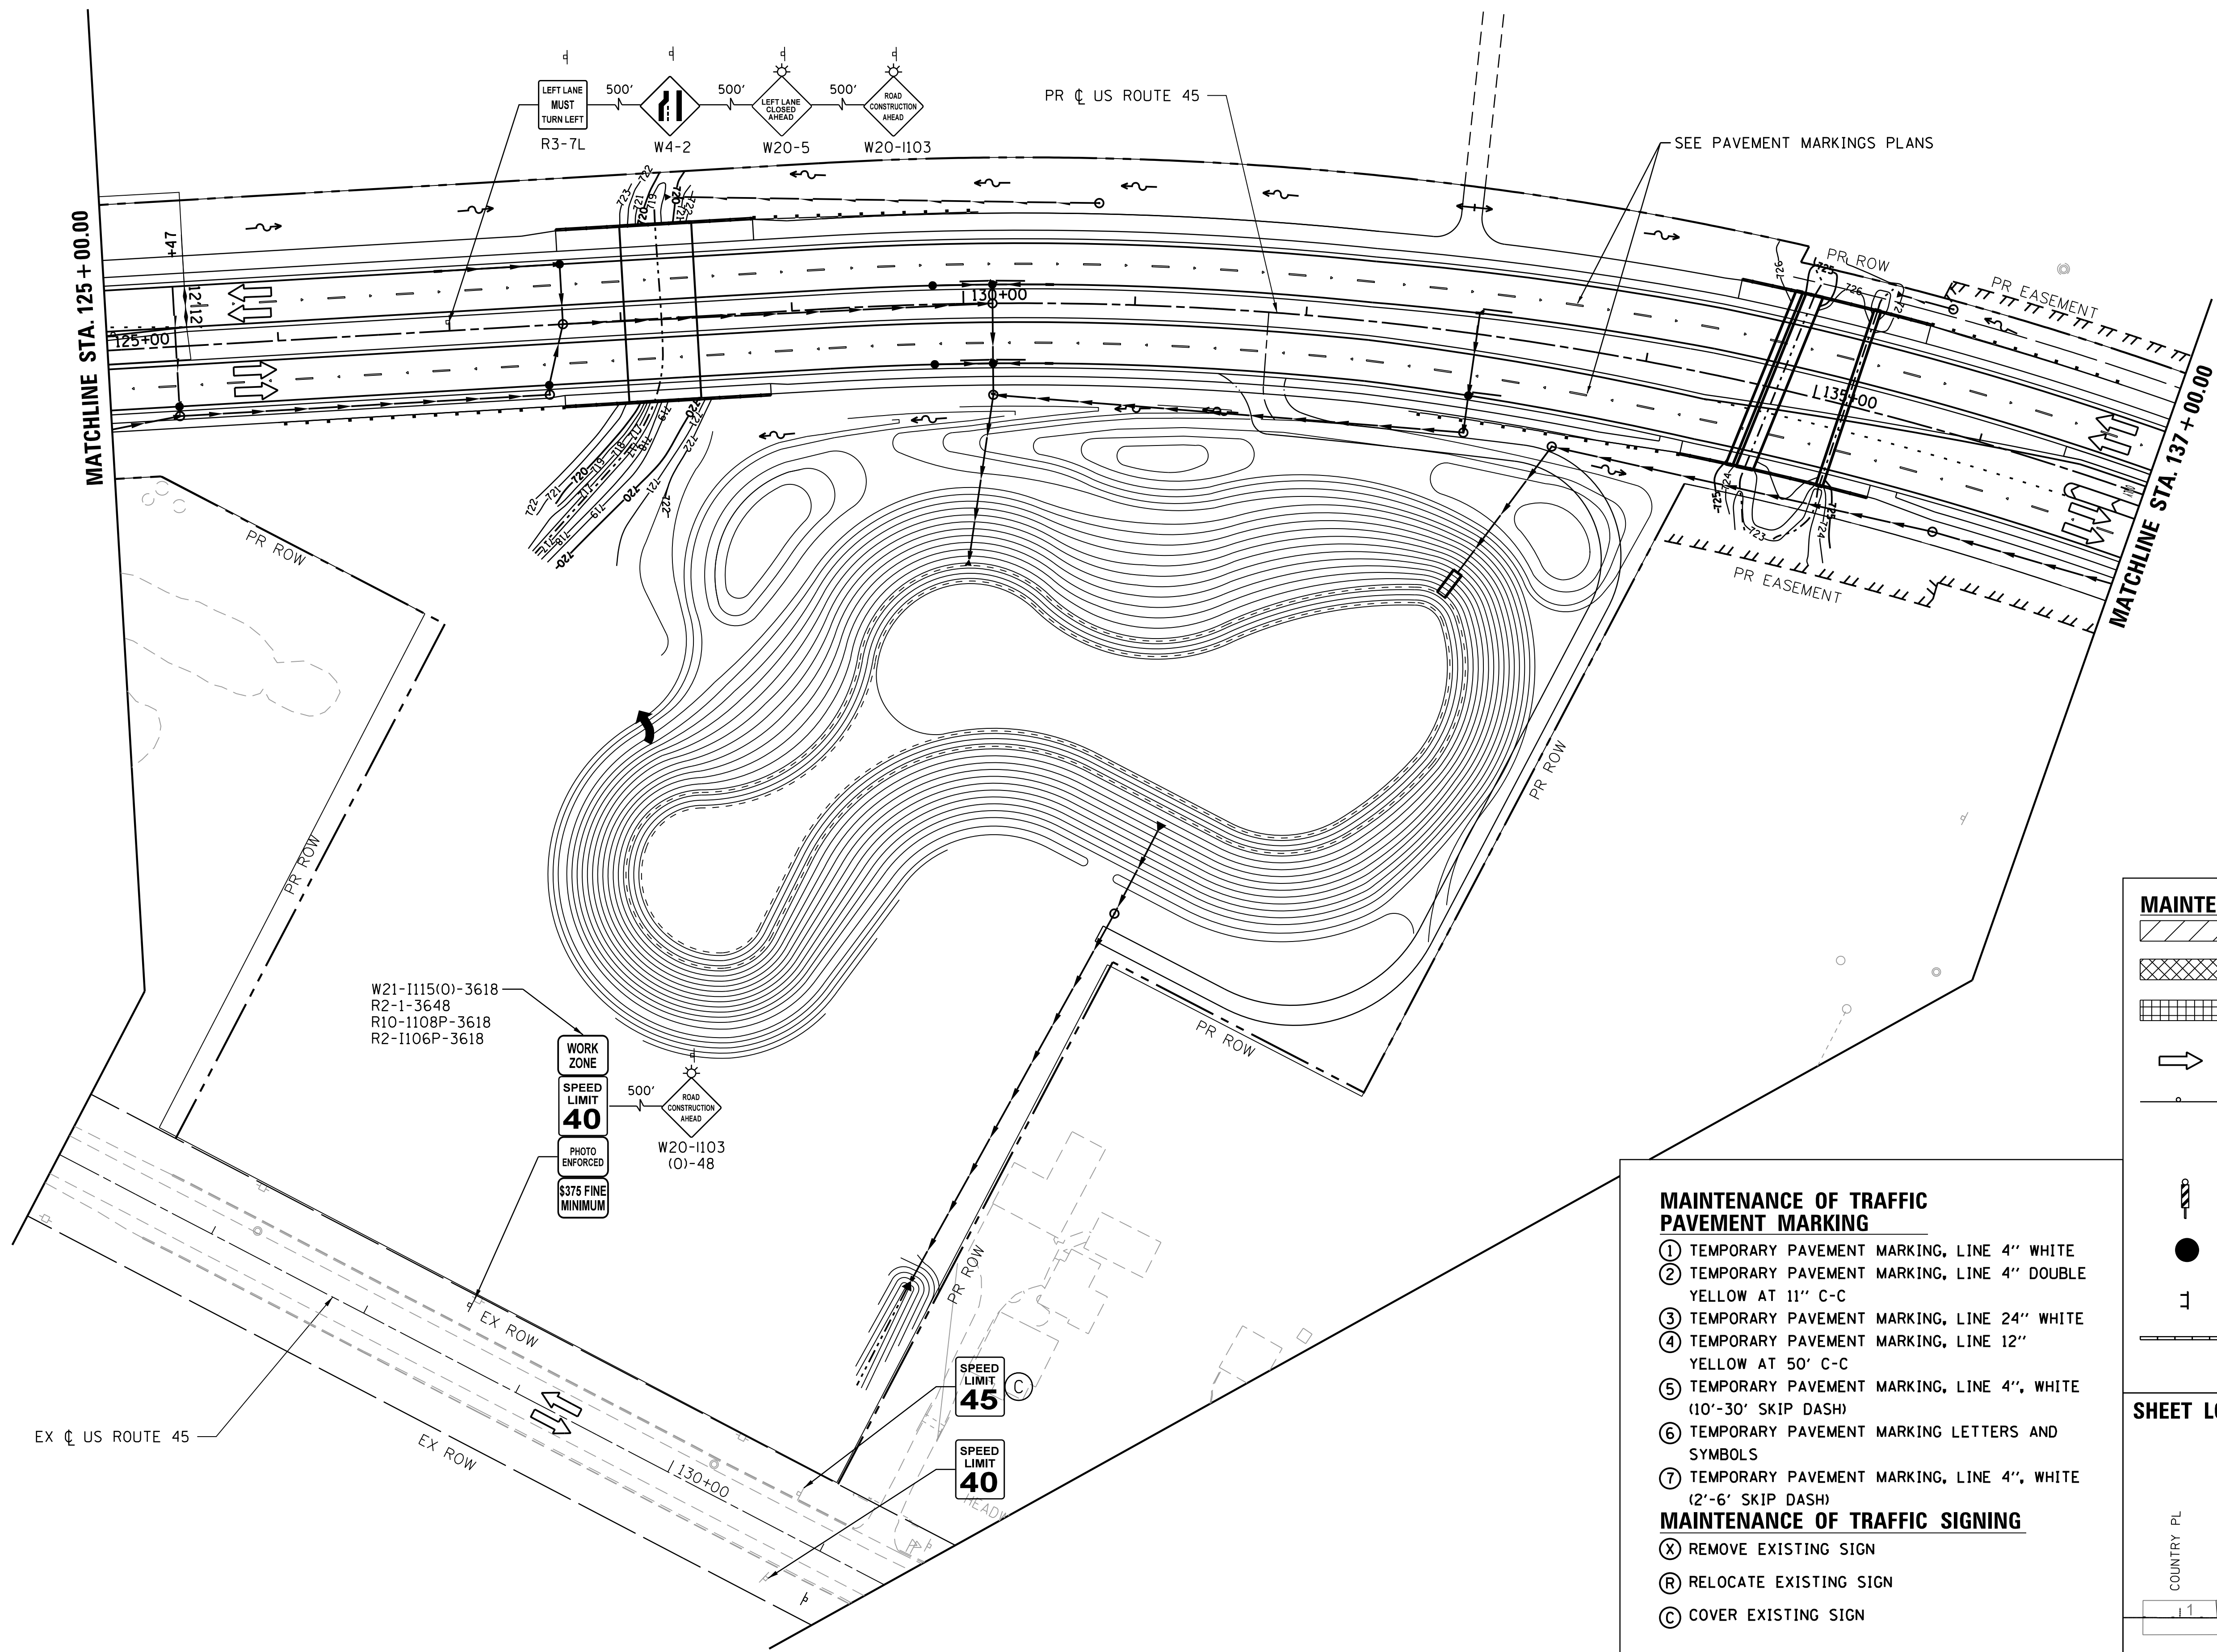

MAINTENANCE OF TRAFFIC LEGEND

- WORK ZONE
- TEMPORARY PAVEMENT
- TEMPORARY PAVEMENT PLACED IN PREVIOUS STAGE
- TRAFFIC FLOW
- TYPE II BARRICADES OR DRUMS WITH BI-DIRECTIONAL STEADY BURN LIGHT AT 50' C-C (TYP.) 25' C-C IN CURVES AND RADII, AND 20' C-C IN TAPERS
- DOUBLE VERTICAL PANEL WITH STEADY BURN BI-DIRECTIONAL LIGHT
- FLAGGER WITH TRAFFIC CONTROL DEVICE
- TYPE III BARRICADE
- TEMPORARY CONCRETE BARRIER

- ### MAINTENANCE OF TRAFFIC PAVEMENT MARKING
- ① TEMPORARY PAVEMENT MARKING, LINE 4" WHITE
 - ② TEMPORARY PAVEMENT MARKING, LINE 4" DOUBLE YELLOW AT 11" C-C
 - ③ TEMPORARY PAVEMENT MARKING, LINE 24" WHITE
 - ④ TEMPORARY PAVEMENT MARKING, LINE 12" YELLOW AT 50' C-C
 - ⑤ TEMPORARY PAVEMENT MARKING, LINE 4", WHITE (10'-30' SKIP DASH)
 - ⑥ TEMPORARY PAVEMENT MARKING LETTERS AND SYMBOLS
 - ⑦ TEMPORARY PAVEMENT MARKING, LINE 4", WHITE (2'-6" SKIP DASH)
- ### MAINTENANCE OF TRAFFIC SIGNING
- (X) REMOVE EXISTING SIGN
 - (R) RELOCATE EXISTING SIGN
 - (C) COVER EXISTING SIGN

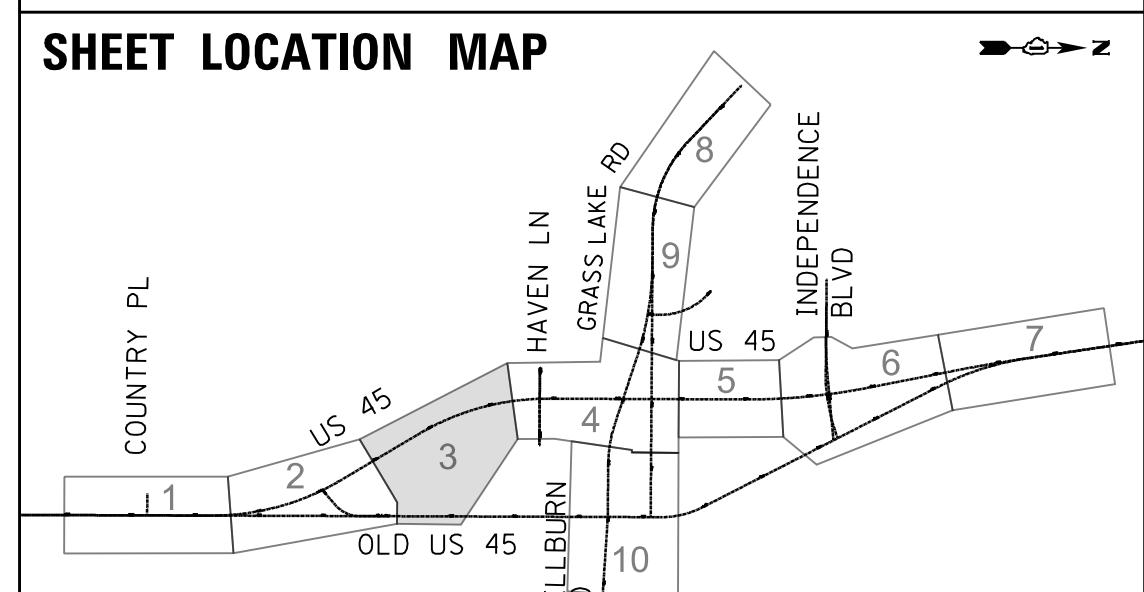

USER NAME = 35361	DESIGNED MO	REVISED -
	DRAWN MO	REVISED
PLOT SCALE = 50.0000' / in.	CHECKED FZ	REVISED
PLOT DATE = 9/14/2017	DATE 02/02/2017	REVISED

**STATE OF ILLINOIS
DEPARTMENT OF TRANSPORTATION**

**MAINTENANCE OF TRAFFIC
STAGE 4**




SCALE: 1"=50' SHEET 3 OF 10 SHEETS STA. 125+00 TO STA. 137+00

F.A.P. RTE. 344	SECTION 39 R	COUNTY LAKE	TOTAL SHEETS 510	SHEET NO. 123
CONTRACT NO. 60T75				ILLINOIS FED. AID PROJECT

PLAN	SURVEYED	BY	DATE
	PLOTTED		
	CHECKED		
	ALIGNED		
	CADD FILE NAME		
NOTE BOOK NO.			

PROFILE	SURVEYED	BY	DATE
	PLOTTED		
	CHECKED		
	GRADES		
	STRUCTURE		
NOTE BOOK NO.	NOT AT THIS OFFICE		

FILE NAME = p:\t\l\p\l\02\p\l\01\person\com\illinois State Documents\US45 - 647965\40 - Design\CAD\Roadway\Sheets\DI60775.sht.MOT4_05.dgn

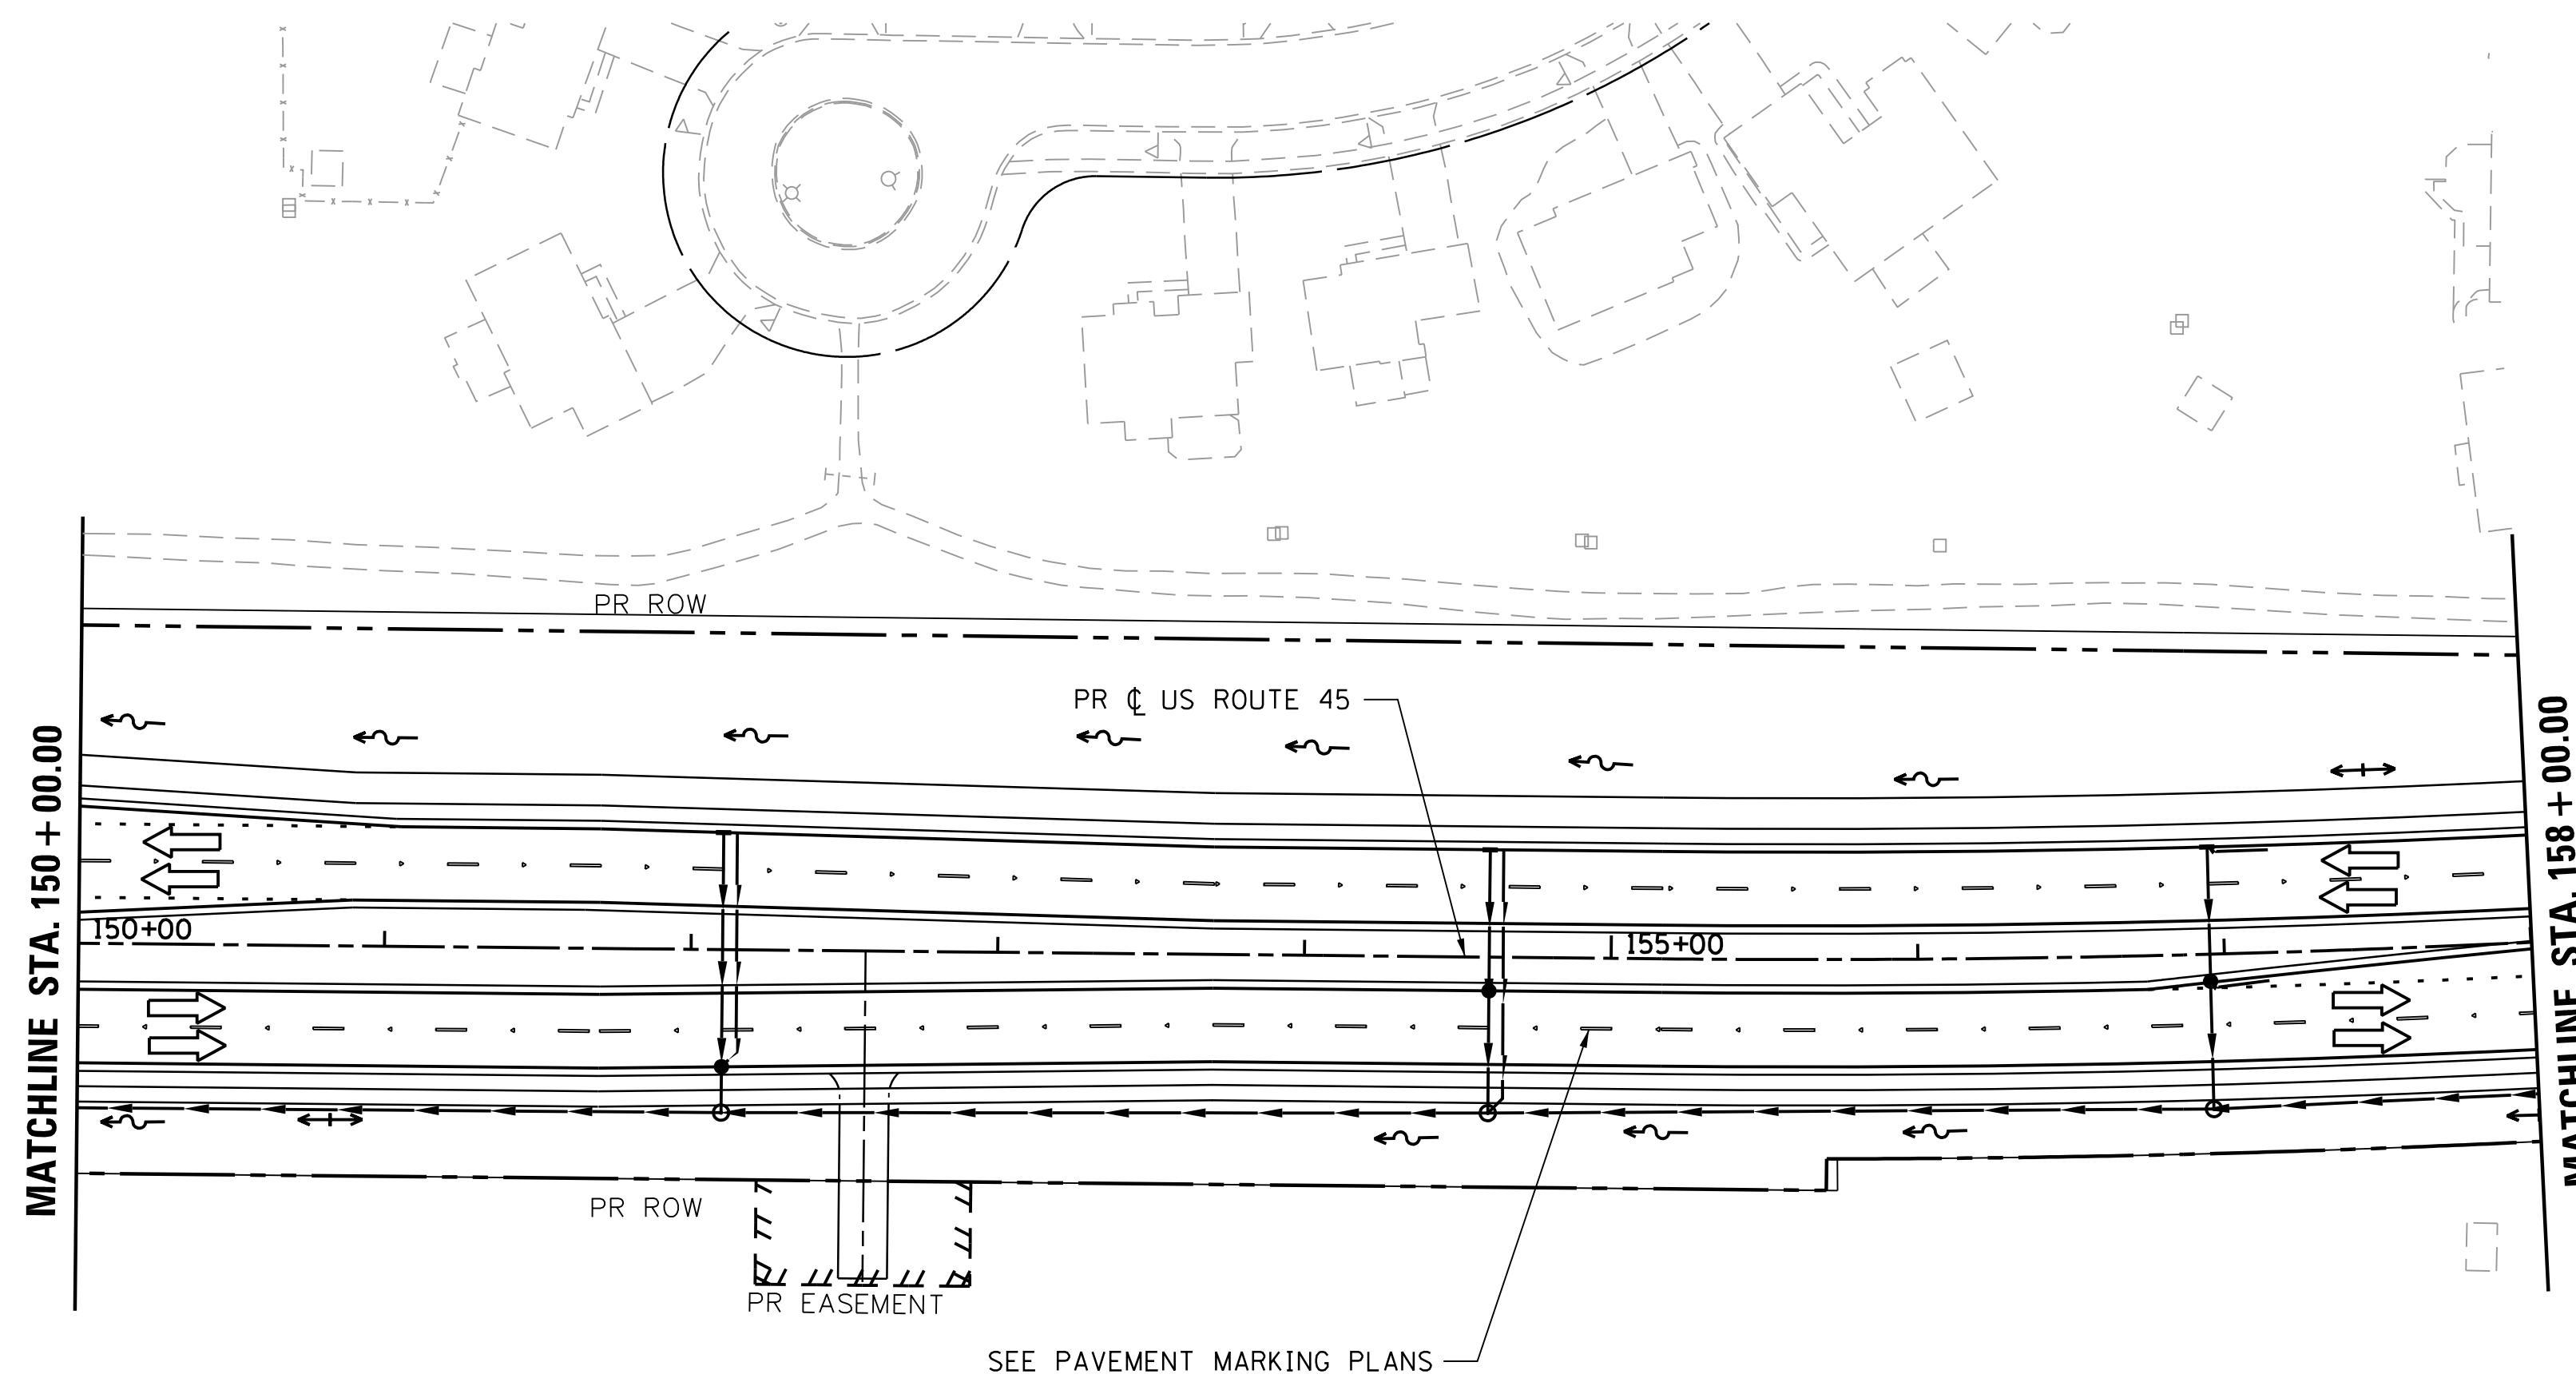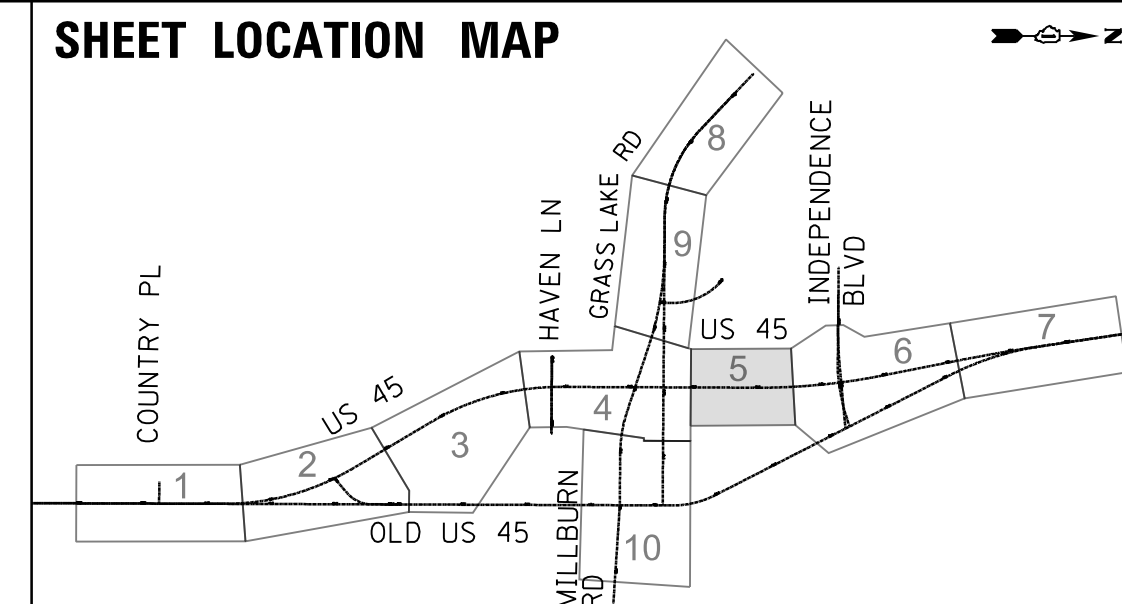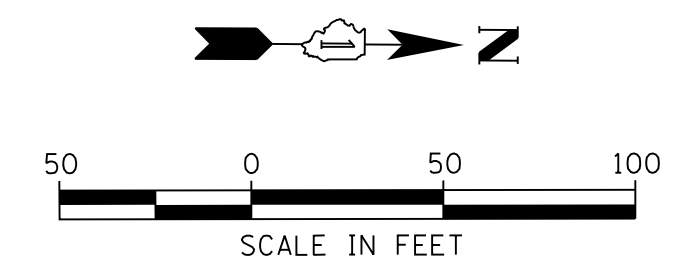

MAINTENANCE OF TRAFFIC LEGEND

- WORK ZONE
- TEMPORARY PAVEMENT
- TEMPORARY PAVEMENT PLACED IN PREVIOUS STAGE
- TRAFFIC FLOW
- TYPE II BARRICADES OR DRUMS WITH BI-DIRECTIONAL STEADY BURN LIGHT AT 50' C-C (TYP.) 25' C-C IN CURVES AND RADII, AND 20' C-C IN TAPERS
- DOUBLE VERTICAL PANEL WITH STEADY BURN BI-DIRECTIONAL LIGHT
- FLAGGER WITH TRAFFIC CONTROL DEVICE
- TYPE III BARRICADE
- TEMPORARY CONCRETE BARRIER

MAINTENANCE OF TRAFFIC PAVEMENT MARKING

- ① TEMPORARY PAVEMENT MARKING, LINE 4" WHITE
- ② TEMPORARY PAVEMENT MARKING, LINE 4" DOUBLE YELLOW AT 11" C-C
- ③ TEMPORARY PAVEMENT MARKING, LINE 24" WHITE YELLOW AT 50' C-C
- ④ TEMPORARY PAVEMENT MARKING, LINE 12" YELLOW AT 50' C-C
- ⑤ TEMPORARY PAVEMENT MARKING, LINE 4", WHITE (10'-30' SKIP DASH)
- ⑥ TEMPORARY PAVEMENT MARKING LETTERS AND SYMBOLS
- ⑦ TEMPORARY PAVEMENT MARKING, LINE 4", WHITE (2'-6' SKIP DASH)

MAINTENANCE OF TRAFFIC SIGNING

- ⓧ REMOVE EXISTING SIGN
- Ⓡ RELOCATE EXISTING SIGN
- Ⓢ COVER EXISTING SIGN

USER NAME = 35361	DESIGNED MO	REVISED -
	DRAWN MO	REVISED
PLOT SCALE = 50.0000' / in.	CHECKED FZ	REVISED
PLOT DATE = 9/14/2017	DATE 02/02/2017	REVISED

**STATE OF ILLINOIS
DEPARTMENT OF TRANSPORTATION**

**MAINTENANCE OF TRAFFIC
STAGE 4**




SCALE: 1"=50' SHEET 5 OF 10 SHEETS STA. 150+00 TO STA. 158+00

F.A.P. RTE.	SECTION	COUNTY	TOTAL SHEETS	SHEET NO.
344	39 R	LAKE	510	125
CONTRACT NO. 60T75				
ILLINOIS FED. AID PROJECT				

PLAN	SURVEYED	BY	DATE
	PLOTTED		
	CHECKED		
	AT		
	FILE NAME		
	NO.		

PROFILE	SURVEYED	BY	DATE
	PLOTTED		
	CHECKED		
	AT		
	FILE NAME		
	NO.		

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MAINTENANCE OF TRAFFIC LEGEND

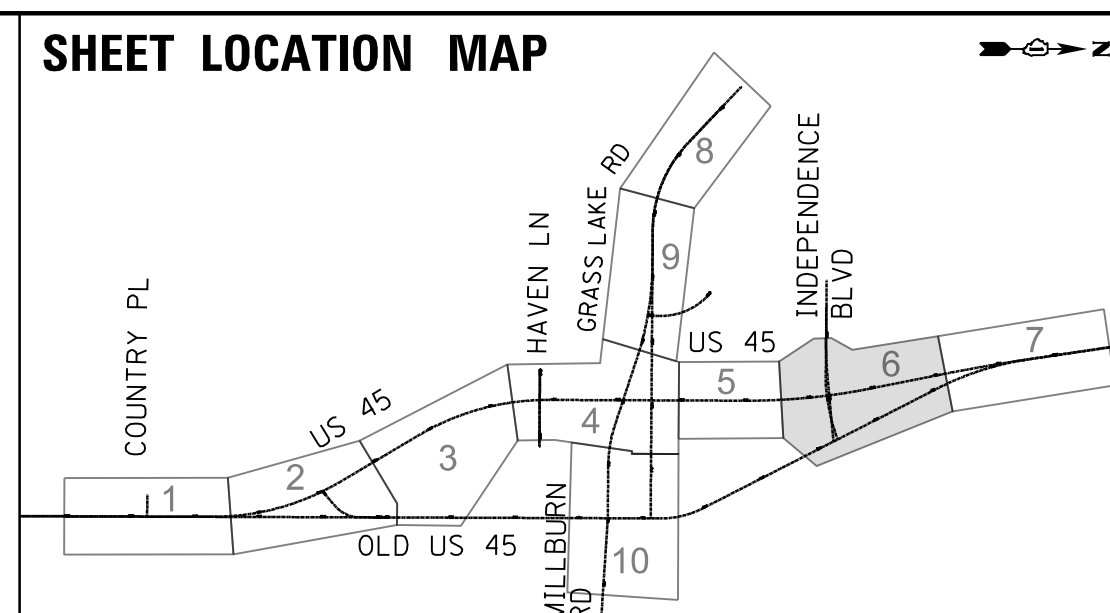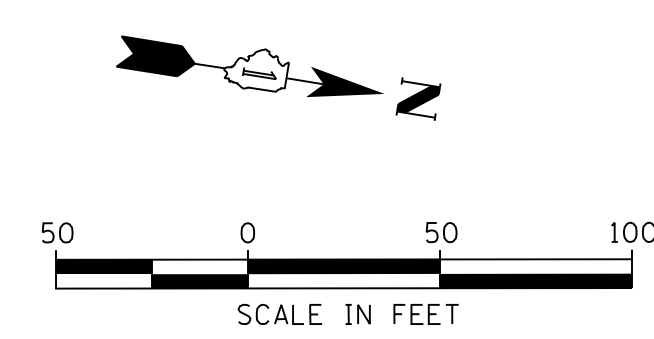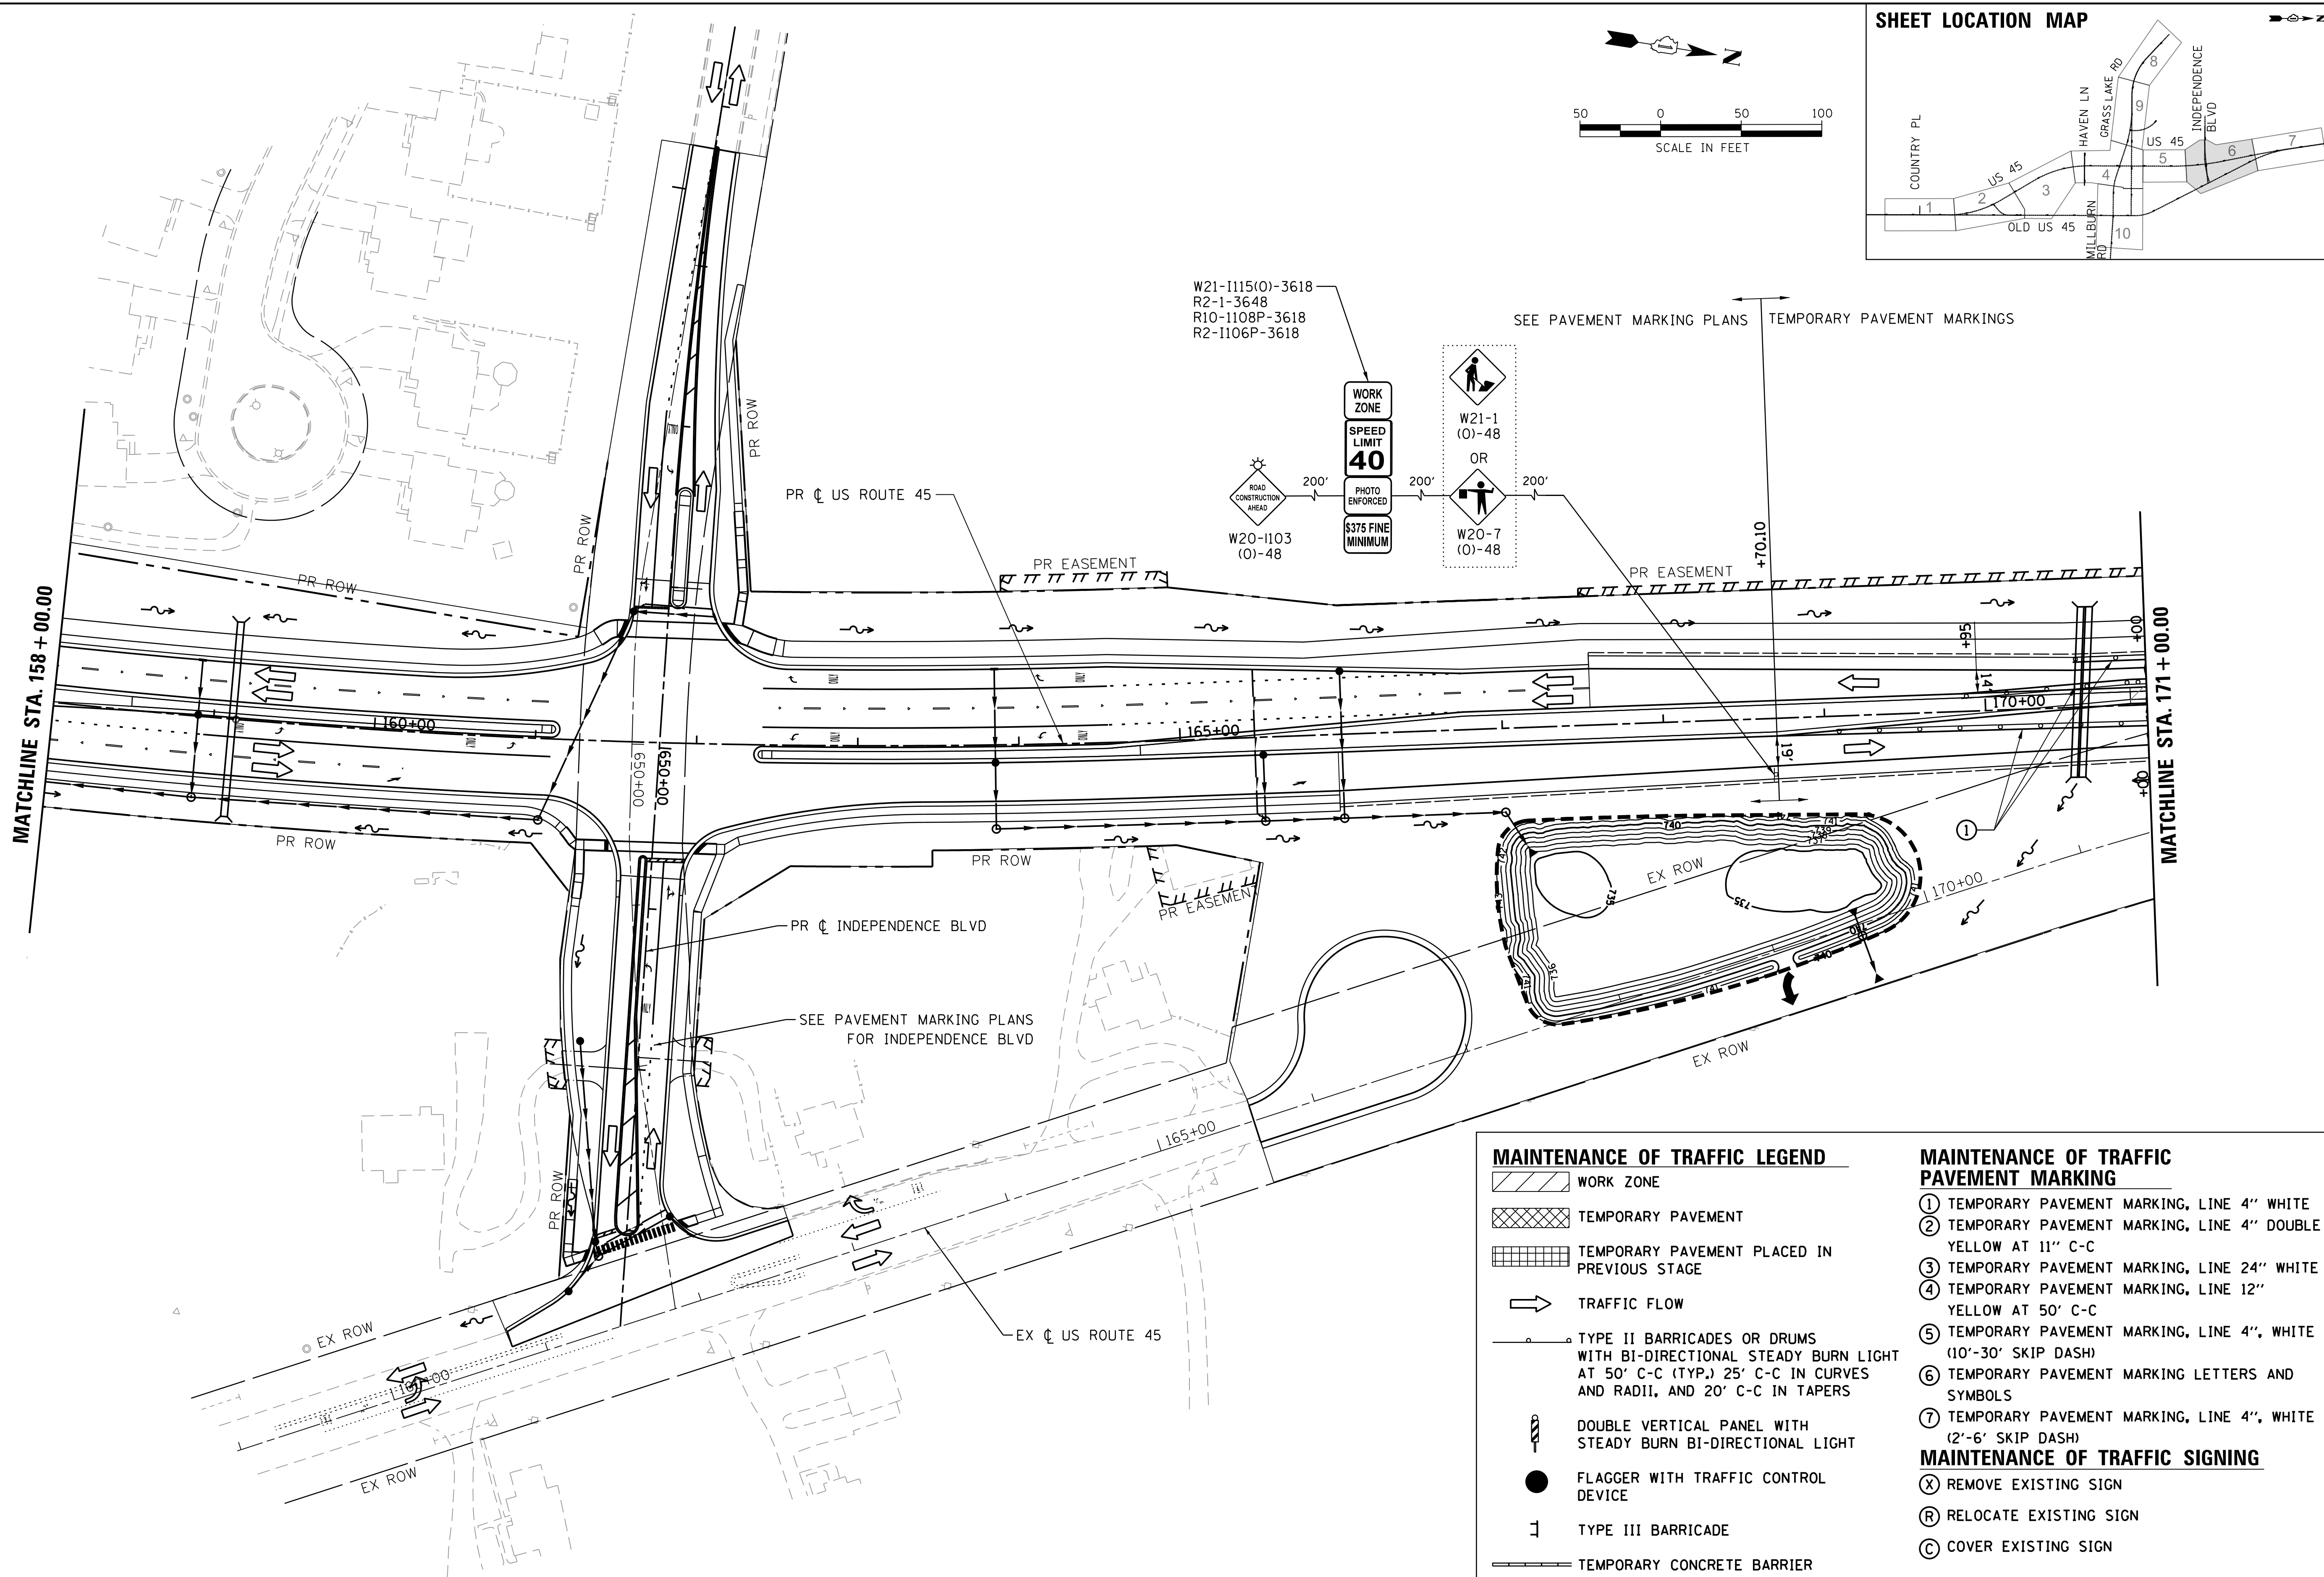- WORK ZONE
- TEMPORARY PAVEMENT
- TEMPORARY PAVEMENT PLACED IN PREVIOUS STAGE
- TRAFFIC FLOW
- TYPE II BARRICADES OR DRUMS WITH BI-DIRECTIONAL STEADY BURN LIGHT AT 50' C-C (TYP.), 25' C-C IN CURVES AND RADII, AND 20' C-C IN TAPERS
- DOUBLE VERTICAL PANEL WITH STEADY BURN BI-DIRECTIONAL LIGHT
- FLAGGER WITH TRAFFIC CONTROL DEVICE
- TYPE III BARRICADE
- TEMPORARY CONCRETE BARRIER

MAINTENANCE OF TRAFFIC PAVEMENT MARKING

- ① TEMPORARY PAVEMENT MARKING, LINE 4" WHITE
- ② TEMPORARY PAVEMENT MARKING, LINE 4" DOUBLE YELLOW AT 11" C-C
- ③ TEMPORARY PAVEMENT MARKING, LINE 24" WHITE
- ④ TEMPORARY PAVEMENT MARKING, LINE 12" YELLOW AT 50' C-C
- ⑤ TEMPORARY PAVEMENT MARKING, LINE 4", WHITE (10'-30' SKIP DASH)
- ⑥ TEMPORARY PAVEMENT MARKING LETTERS AND SYMBOLS
- ⑦ TEMPORARY PAVEMENT MARKING, LINE 4", WHITE (2'-6' SKIP DASH)

MAINTENANCE OF TRAFFIC SIGNING

- ⓧ REMOVE EXISTING SIGN
- Ⓡ RELOCATE EXISTING SIGN
- Ⓢ COVER EXISTING SIGN

USER NAME = 35361	DESIGNED MO	REVISED -
	DRAWN MO	REVISED
PLOT SCALE = 50.0000' / in.	CHECKED FZ	REVISED
PLOT DATE = 9/14/2017	DATE 02/02/2017	REVISED

**STATE OF ILLINOIS
DEPARTMENT OF TRANSPORTATION**

**MAINTENANCE OF TRAFFIC
STAGE 4**




SCALE: 1"=50' SHEET 6 OF 10 SHEETS STA. 158+00 TO STA. 171+00

F.A.P. RTE.	SECTION	COUNTY	TOTAL SHEETS	SHEET NO.
344	39 R	LAKE	510	126
CONTRACT NO. 60T75				
ILLINOIS FED. AID PROJECT				

PLAN	SURVEYED	BY	DATE
	PLOTTED		
	CHECKED		
	AT		
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	NO.		

PROFILE	SURVEYED	BY	DATE
	PLOTTED		
	CHECKED		
	AT		
	FILE NAME		
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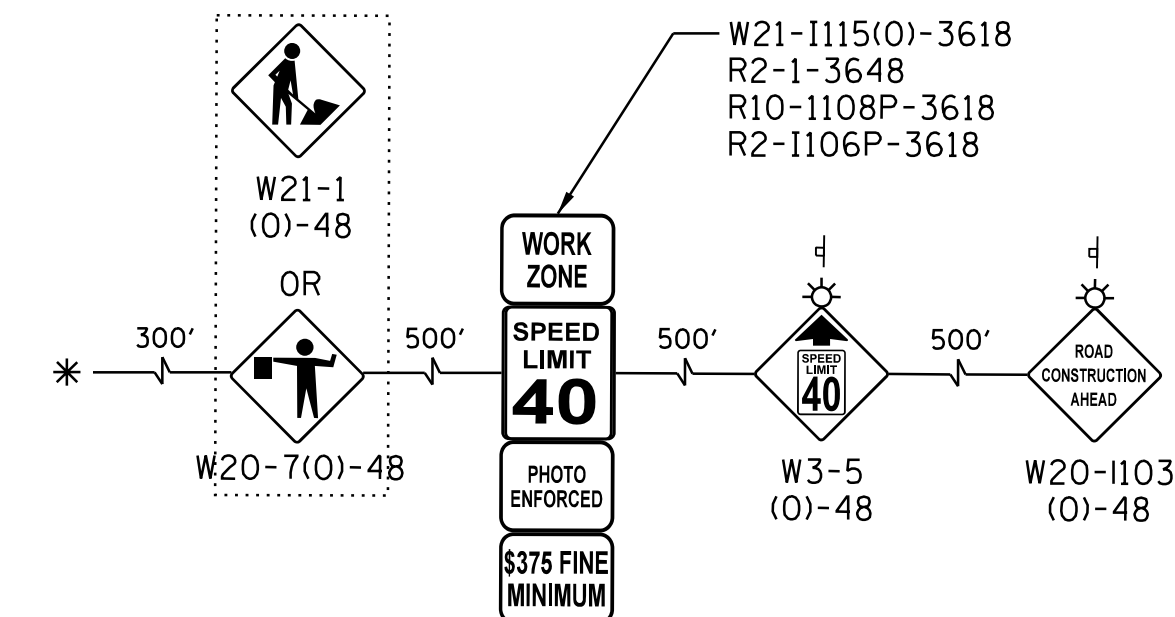
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END IMPROVEMENTS

US ROUTE 45
STA. EQUATION 177+47.48 BK=
177+98.30

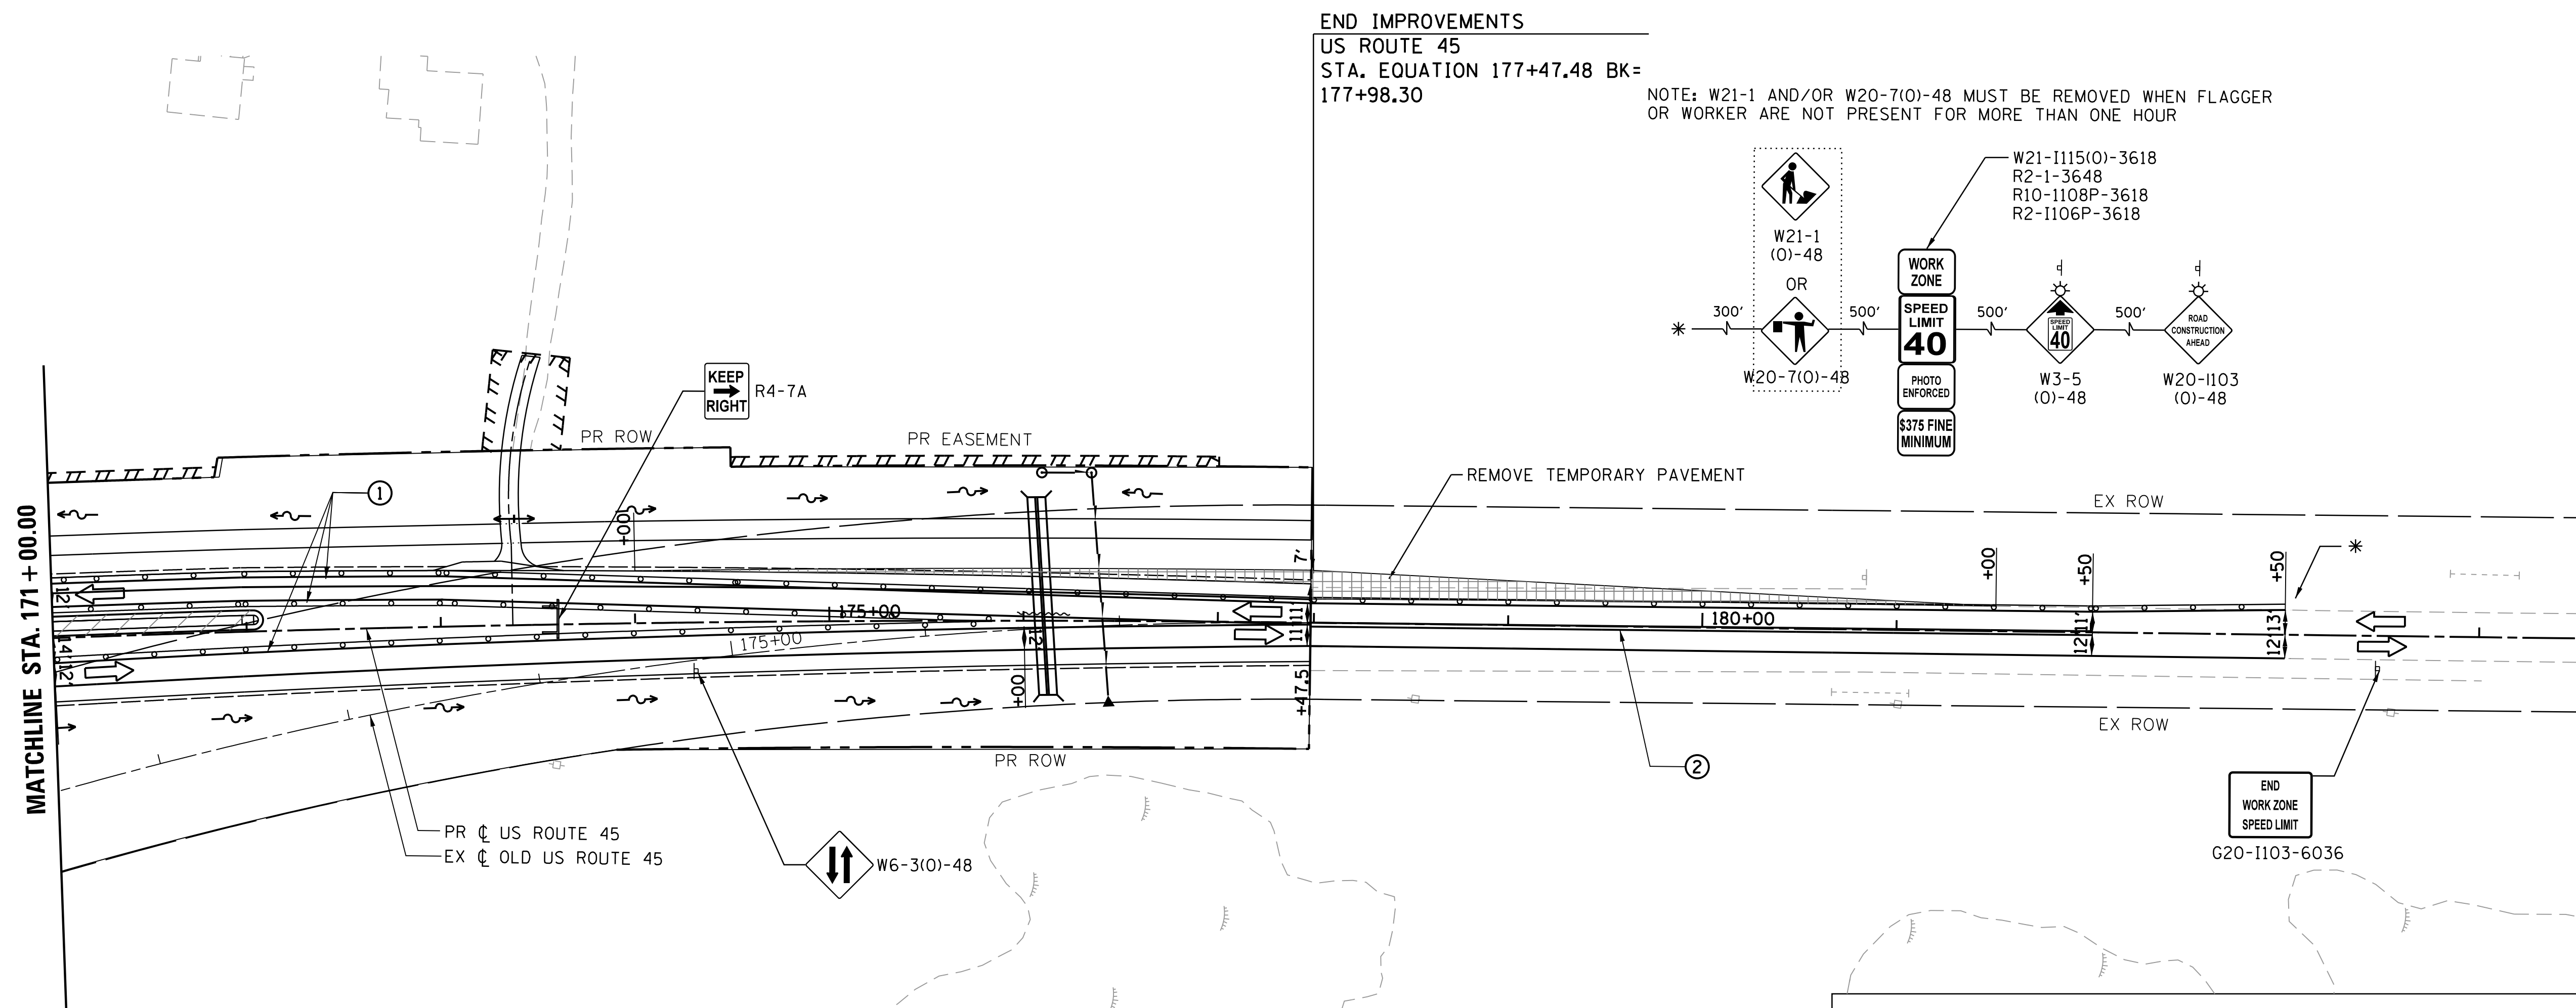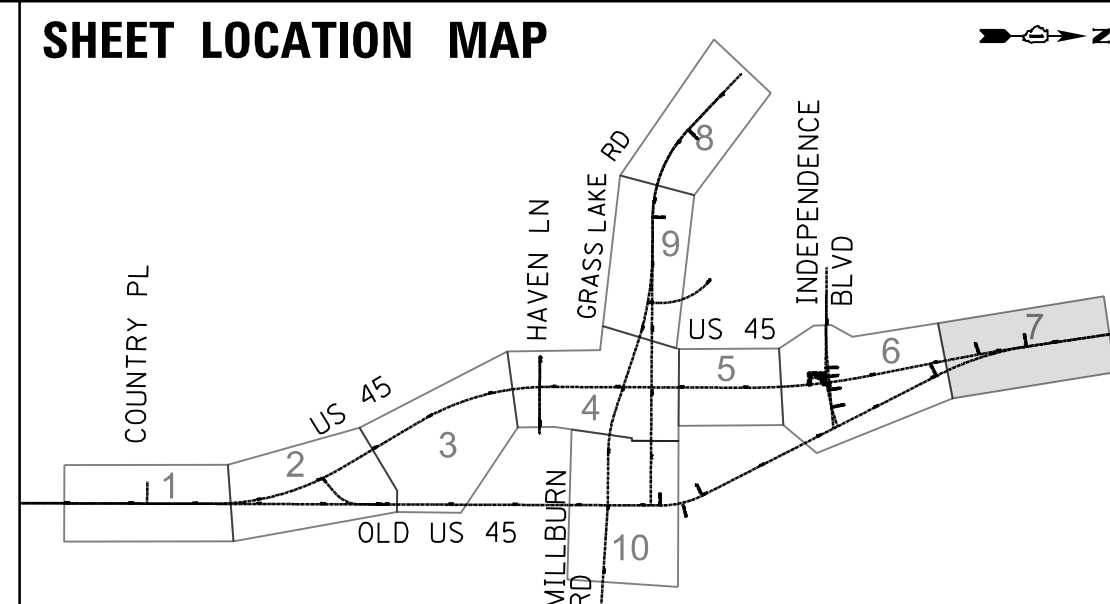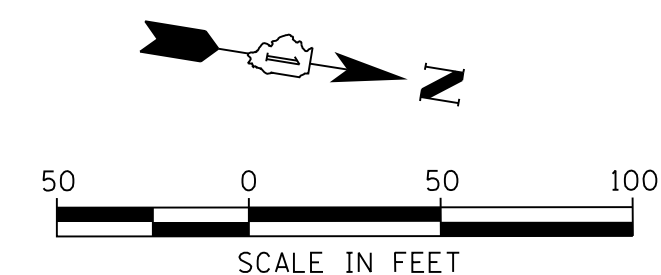NOTE: W21-1 AND/OR W20-7(O)-48 MUST BE REMOVED WHEN FLAGGER OR WORKER ARE NOT PRESENT FOR MORE THAN ONE HOUR



MAINTENANCE OF TRAFFIC LEGEND

- WORK ZONE
- TEMPORARY PAVEMENT
- TEMPORARY PAVEMENT PLACED IN PREVIOUS STAGE
- TRAFFIC FLOW
- TYPE II BARRICADES OR DRUMS WITH BI-DIRECTIONAL STEADY BURN LIGHT AT 50' C-C (TYP.), 25' C-C IN CURVES AND RADII, AND 20' C-C IN TAPERS
- DOUBLE VERTICAL PANEL WITH STEADY BURN BI-DIRECTIONAL LIGHT
- FLAGGER WITH TRAFFIC CONTROL DEVICE
- TYPE III BARRICADE
- TEMPORARY CONCRETE BARRIER

MAINTENANCE OF TRAFFIC PAVEMENT MARKING

- ① TEMPORARY PAVEMENT MARKING, LINE 4" WHITE
- ② TEMPORARY PAVEMENT MARKING, LINE 4" DOUBLE YELLOW AT 11" C-C
- ③ TEMPORARY PAVEMENT MARKING, LINE 24" WHITE
- ④ TEMPORARY PAVEMENT MARKING, LINE 12" YELLOW AT 50' C-C
- ⑤ TEMPORARY PAVEMENT MARKING, LINE 4", WHITE (10'-30' SKIP DASH)
- ⑥ TEMPORARY PAVEMENT MARKING LETTERS AND SYMBOLS
- ⑦ TEMPORARY PAVEMENT MARKING, LINE 4", WHITE (2'-6' SKIP DASH)

MAINTENANCE OF TRAFFIC SIGNING

- ⓧ REMOVE EXISTING SIGN
- Ⓡ RELOCATE EXISTING SIGN
- Ⓢ COVER EXISTING SIGN

USER NAME = 35361	DESIGNED MO	REVISED -
	DRAWN MO	REVISED
PLOT SCALE = 50.0000' / in.	CHECKED FZ	REVISED
PLOT DATE = 9/14/2017	DATE 02/02/2017	REVISED



**STATE OF ILLINOIS
DEPARTMENT OF TRANSPORTATION**

**MAINTENANCE OF TRAFFIC
STAGE 4**

SCALE: 1"=50' SHEET 7 OF 10 SHEETS STA. 171+00 TO STA. 178+00

F.A.P. RTE.	SECTION	COUNTY	TOTAL SHEETS	SHEET NO.
344	39 R	LAKE	510	127
CONTRACT NO. 60T75				
ILLINOIS FED. AID PROJECT				


NO MAINTENANCE OF TRAFFIC ON THIS SHEET

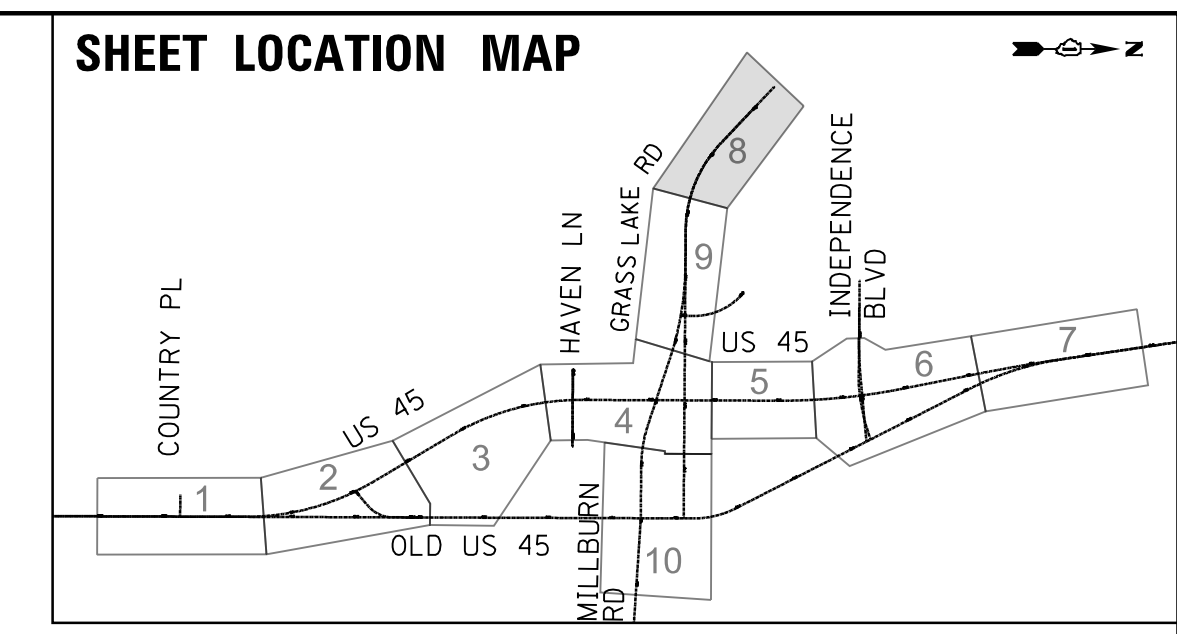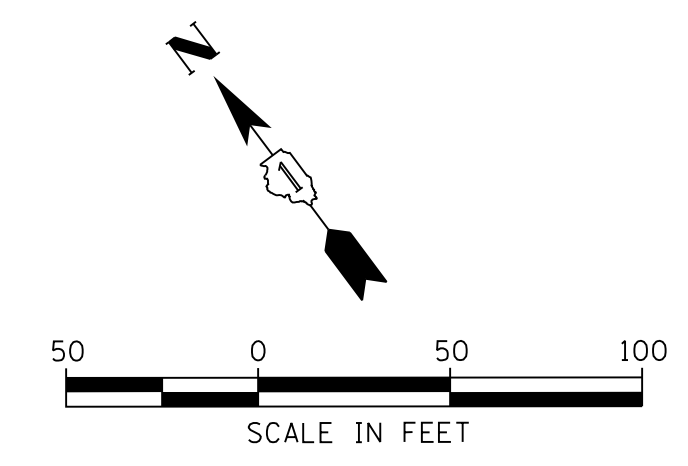

PLAN	SURVEYED	DATE
NOTE BOOK NO.	PLOTTED	BY
	CHECKED	
	ATTEMPTED	
	FILE NAME	

PROFILE	SURVEYED	DATE
NOTE BOOK NO.	GRADES CHECKED	BY
	STRUCTURE NOT AT THIS CHFD	

FILE NAME = p:\t\l\p\02\p\01\person\com\illinois State Documents\US45 - 647965\48 - Design\CAD\Roadway\Sheet\DI68775.sht.MOT4_08.dgn

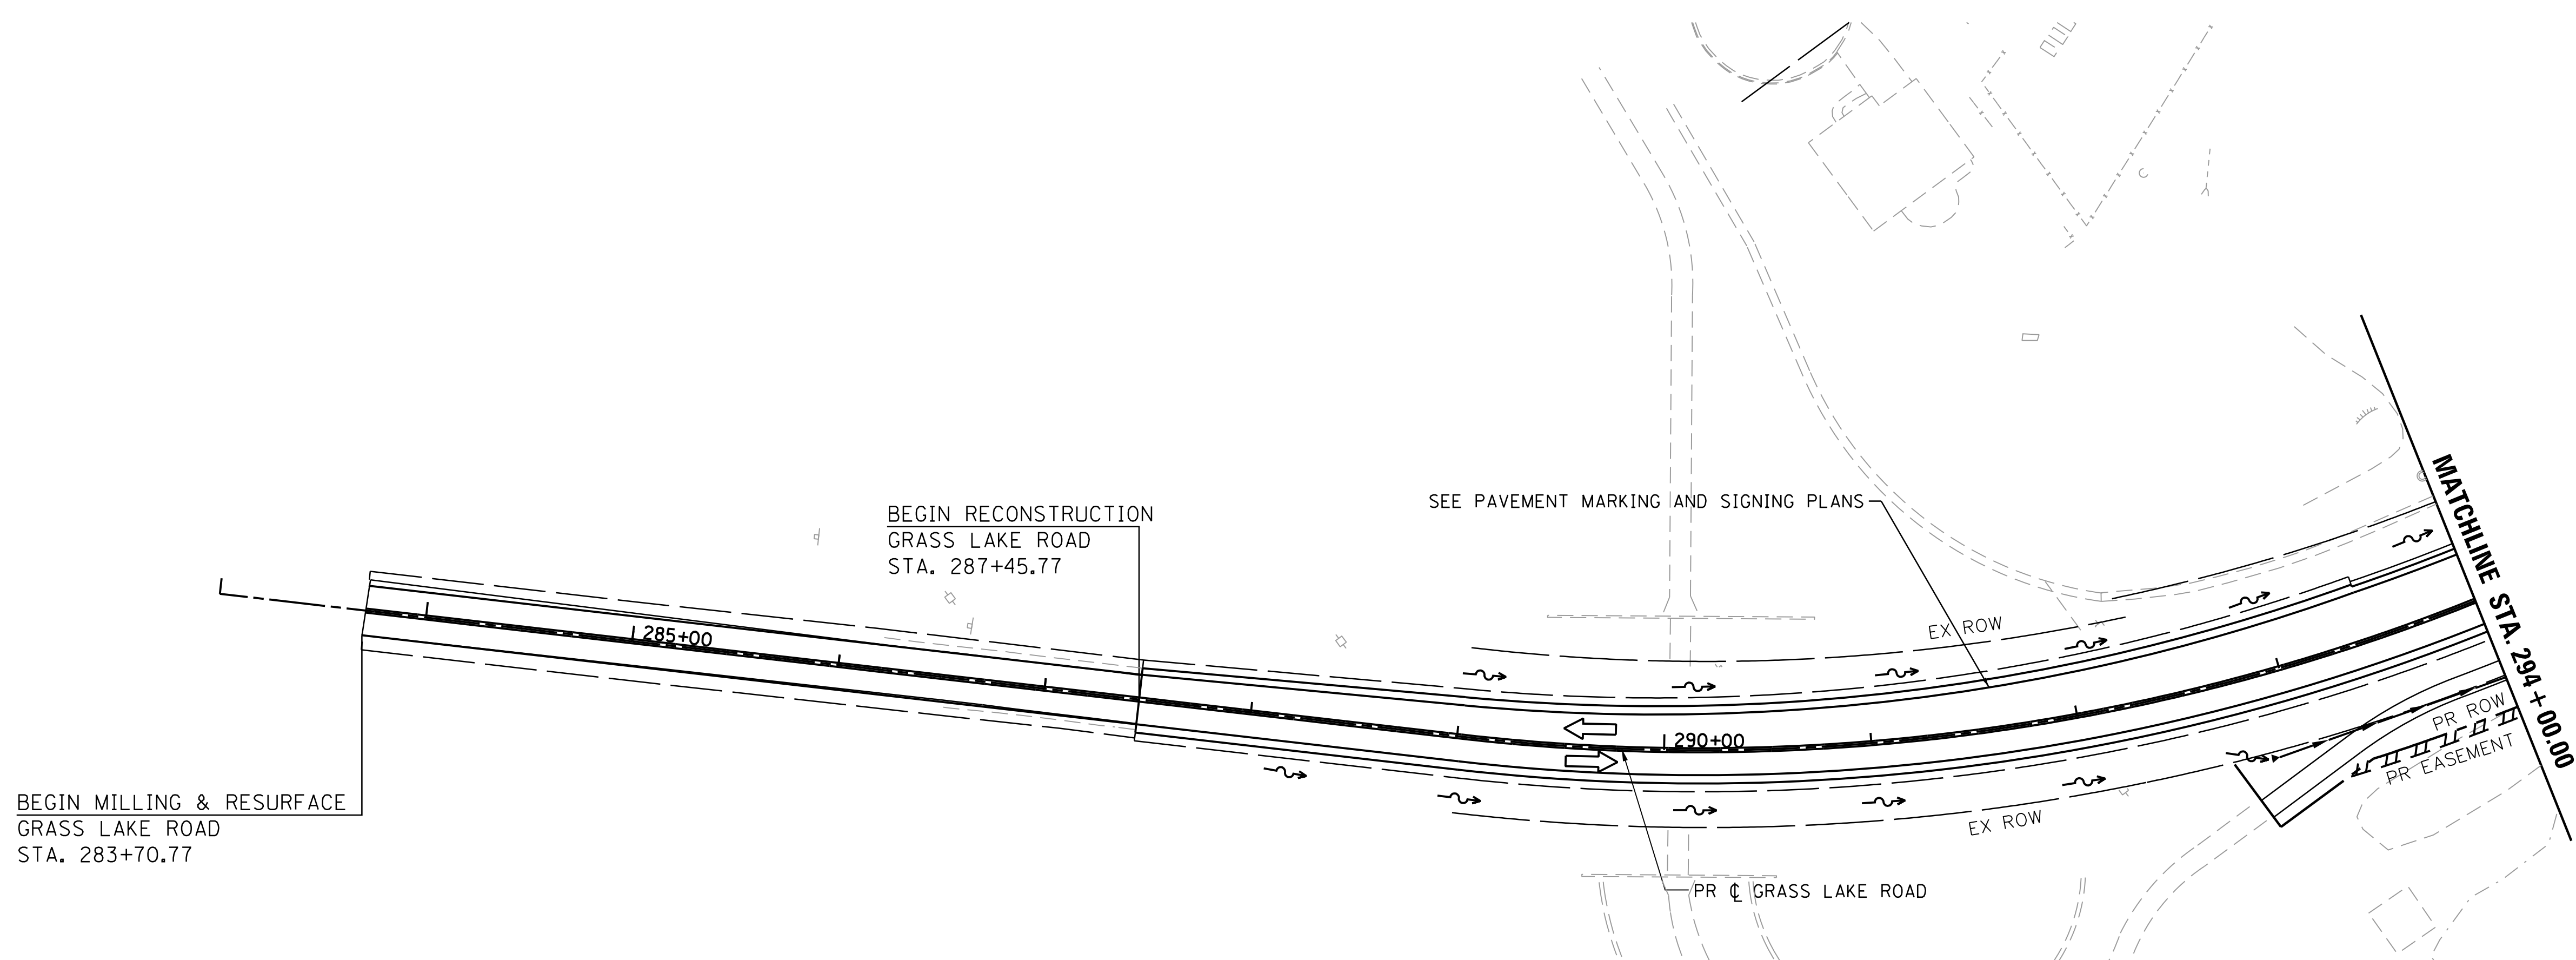

MAINTENANCE OF TRAFFIC LEGEND

	WORK ZONE
	TEMPORARY PAVEMENT
	TEMPORARY PAVEMENT PLACED IN PREVIOUS STAGE
	TRAFFIC FLOW
	TYPE II BARRICADES OR DRUMS WITH BI-DIRECTIONAL STEADY BURN LIGHT AT 50' C-C (TYP.) 25' C-C IN CURVES AND RADII, AND 20' C-C IN TAPERS
	DOUBLE VERTICAL PANEL WITH STEADY BURN BI-DIRECTIONAL LIGHT
	FLAGGER WITH TRAFFIC CONTROL DEVICE
	TYPE III BARRICADE
	TEMPORARY CONCRETE BARRIER

MAINTENANCE OF TRAFFIC PAVEMENT MARKING

- ① TEMPORARY PAVEMENT MARKING, LINE 4" WHITE
- ② TEMPORARY PAVEMENT MARKING, LINE 4" DOUBLE YELLOW AT 11" C-C
- ③ TEMPORARY PAVEMENT MARKING, LINE 24" WHITE
- ④ TEMPORARY PAVEMENT MARKING, LINE 12" YELLOW AT 50' C-C
- ⑤ TEMPORARY PAVEMENT MARKING, LINE 4", WHITE (10'-30' SKIP DASH)
- ⑥ TEMPORARY PAVEMENT MARKING LETTERS AND SYMBOLS
- ⑦ TEMPORARY PAVEMENT MARKING, LINE 4", WHITE (2'-6' SKIP DASH)

MAINTENANCE OF TRAFFIC SIGNING

- ⓧ REMOVE EXISTING SIGN
- Ⓡ RELOCATE EXISTING SIGN
- Ⓢ COVER EXISTING SIGN



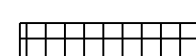






USER NAME = 35361	DESIGNED MO	REVISED -
	DRAWN MO	REVISED
PLOT SCALE = 50.0000' / in.	CHECKED FZ	REVISED
PLOT DATE = 9/14/2017	DATE 02/02/2017	REVISED

**STATE OF ILLINOIS
DEPARTMENT OF TRANSPORTATION**

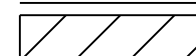**MAINTENANCE OF TRAFFIC
STAGE 4**
SCALE: 1"=50' SHEET 8 OF 10 SHEETS STA. 287+50 TO STA. 294+00

F.A.P. RTE.	SECTION	COUNTY	TOTAL SHEETS	SHEET NO.
344	39 R	LAKE	510	128
CONTRACT NO. 60T75			ILLINOIS FED. AID PROJECT	

MAINTENANCE OF TRAFFIC LEGEND



-  WORK ZONE
-  TEMPORARY PAVEMENT
-  TEMPORARY PAVEMENT PLACED IN PREVIOUS STAGE
-  TRAFFIC FLOW
-  TYPE II BARRICADES OR DRUMS WITH BI-DIRECTIONAL STEADY BURN LIGHT AT 50' C-C (TYP.) 25' C-C IN CURVES AND RADII, AND 20' C-C IN TAPERS
-  DOUBLE VERTICAL PANEL WITH STEADY BURN BI-DIRECTIONAL LIGHT
-  FLAGGER WITH TRAFFIC CONTROL DEVICE
-  TYPE III BARRICADE
-  TEMPORARY CONCRETE BARRIER

MAINTENANCE OF TRAFFIC PAVEMENT MARKING

- ① TEMPORARY PAVEMENT MARKING, LINE 4" WHITE
 - ② TEMPORARY PAVEMENT MARKING, LINE 4" DOUBLE YELLOW AT 11" C-C
 - ③ TEMPORARY PAVEMENT MARKING, LINE 24" WHITE
 - ④ TEMPORARY PAVEMENT MARKING, LINE 12" YELLOW AT 50' C-C
 - ⑤ TEMPORARY PAVEMENT MARKING, LINE 4", WHITE (10'-30' SKIP DASH)
 - ⑥ TEMPORARY PAVEMENT MARKING LETTERS AND SYMBOLS
 - ⑦ TEMPORARY PAVEMENT MARKING, LINE 4", WHITE (2'-6' SKIP DASH)
- MAINTENANCE OF TRAFFIC SIGNING**
- (X) REMOVE EXISTING SIGN
 - (R) RELOCATE EXISTING SIGN
 - (C) COVER EXISTING SIGN

NO MAINTENANCE OF TRAFFIC ON THIS SHEET


SHEET LOCATION MAP

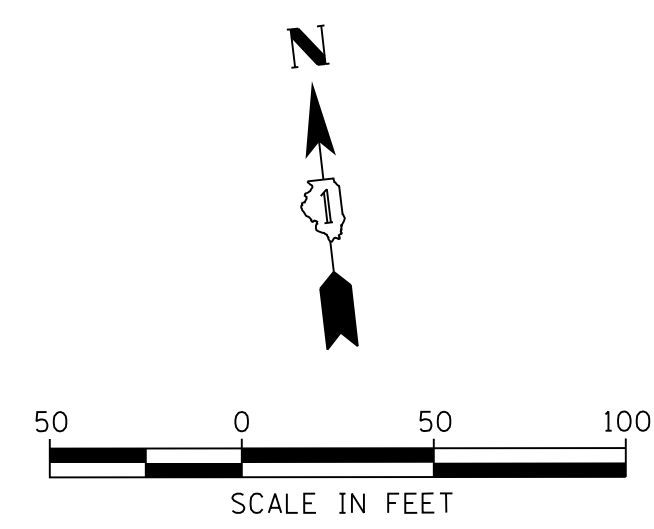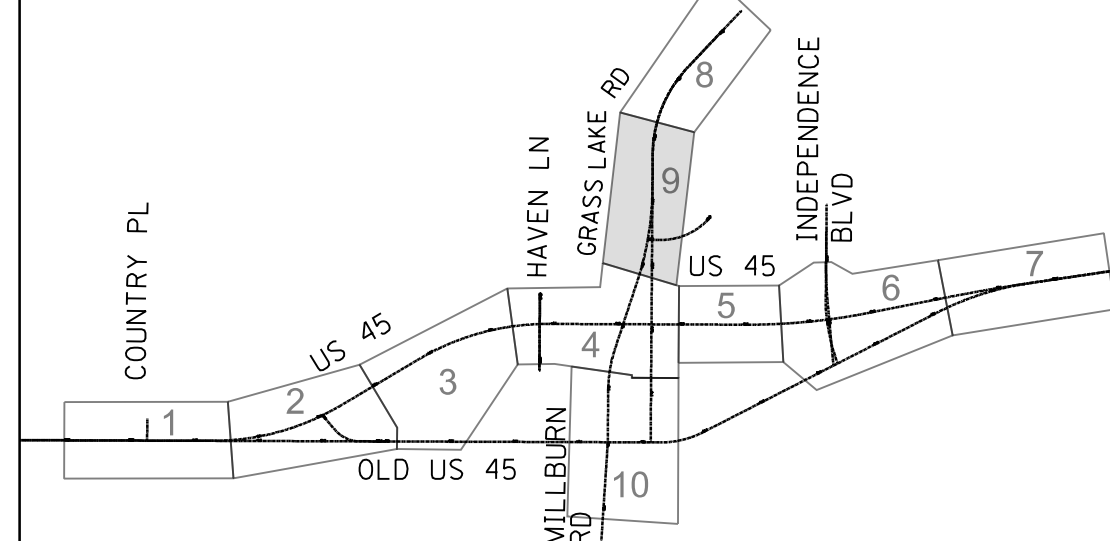

PLAN	SURVEYED	DATE
NOTE BOOK NO.	PLOTTED	BY
	CHECKED	
	AT	
	FILE NAME	

PROFILE	SURVEYED	DATE
NOTE BOOK NO.	GRADES CHECKED	BY
	STRUCTURE	
	NOT AT THIS OFFICE	

FILE NAME = p:\t\l\p\2\p\10\person\com\illinois\State\Documents\US45 - 647965\48 - Design\CAD\Roadway\Sheets\160775.shx\NOT_09.dgn

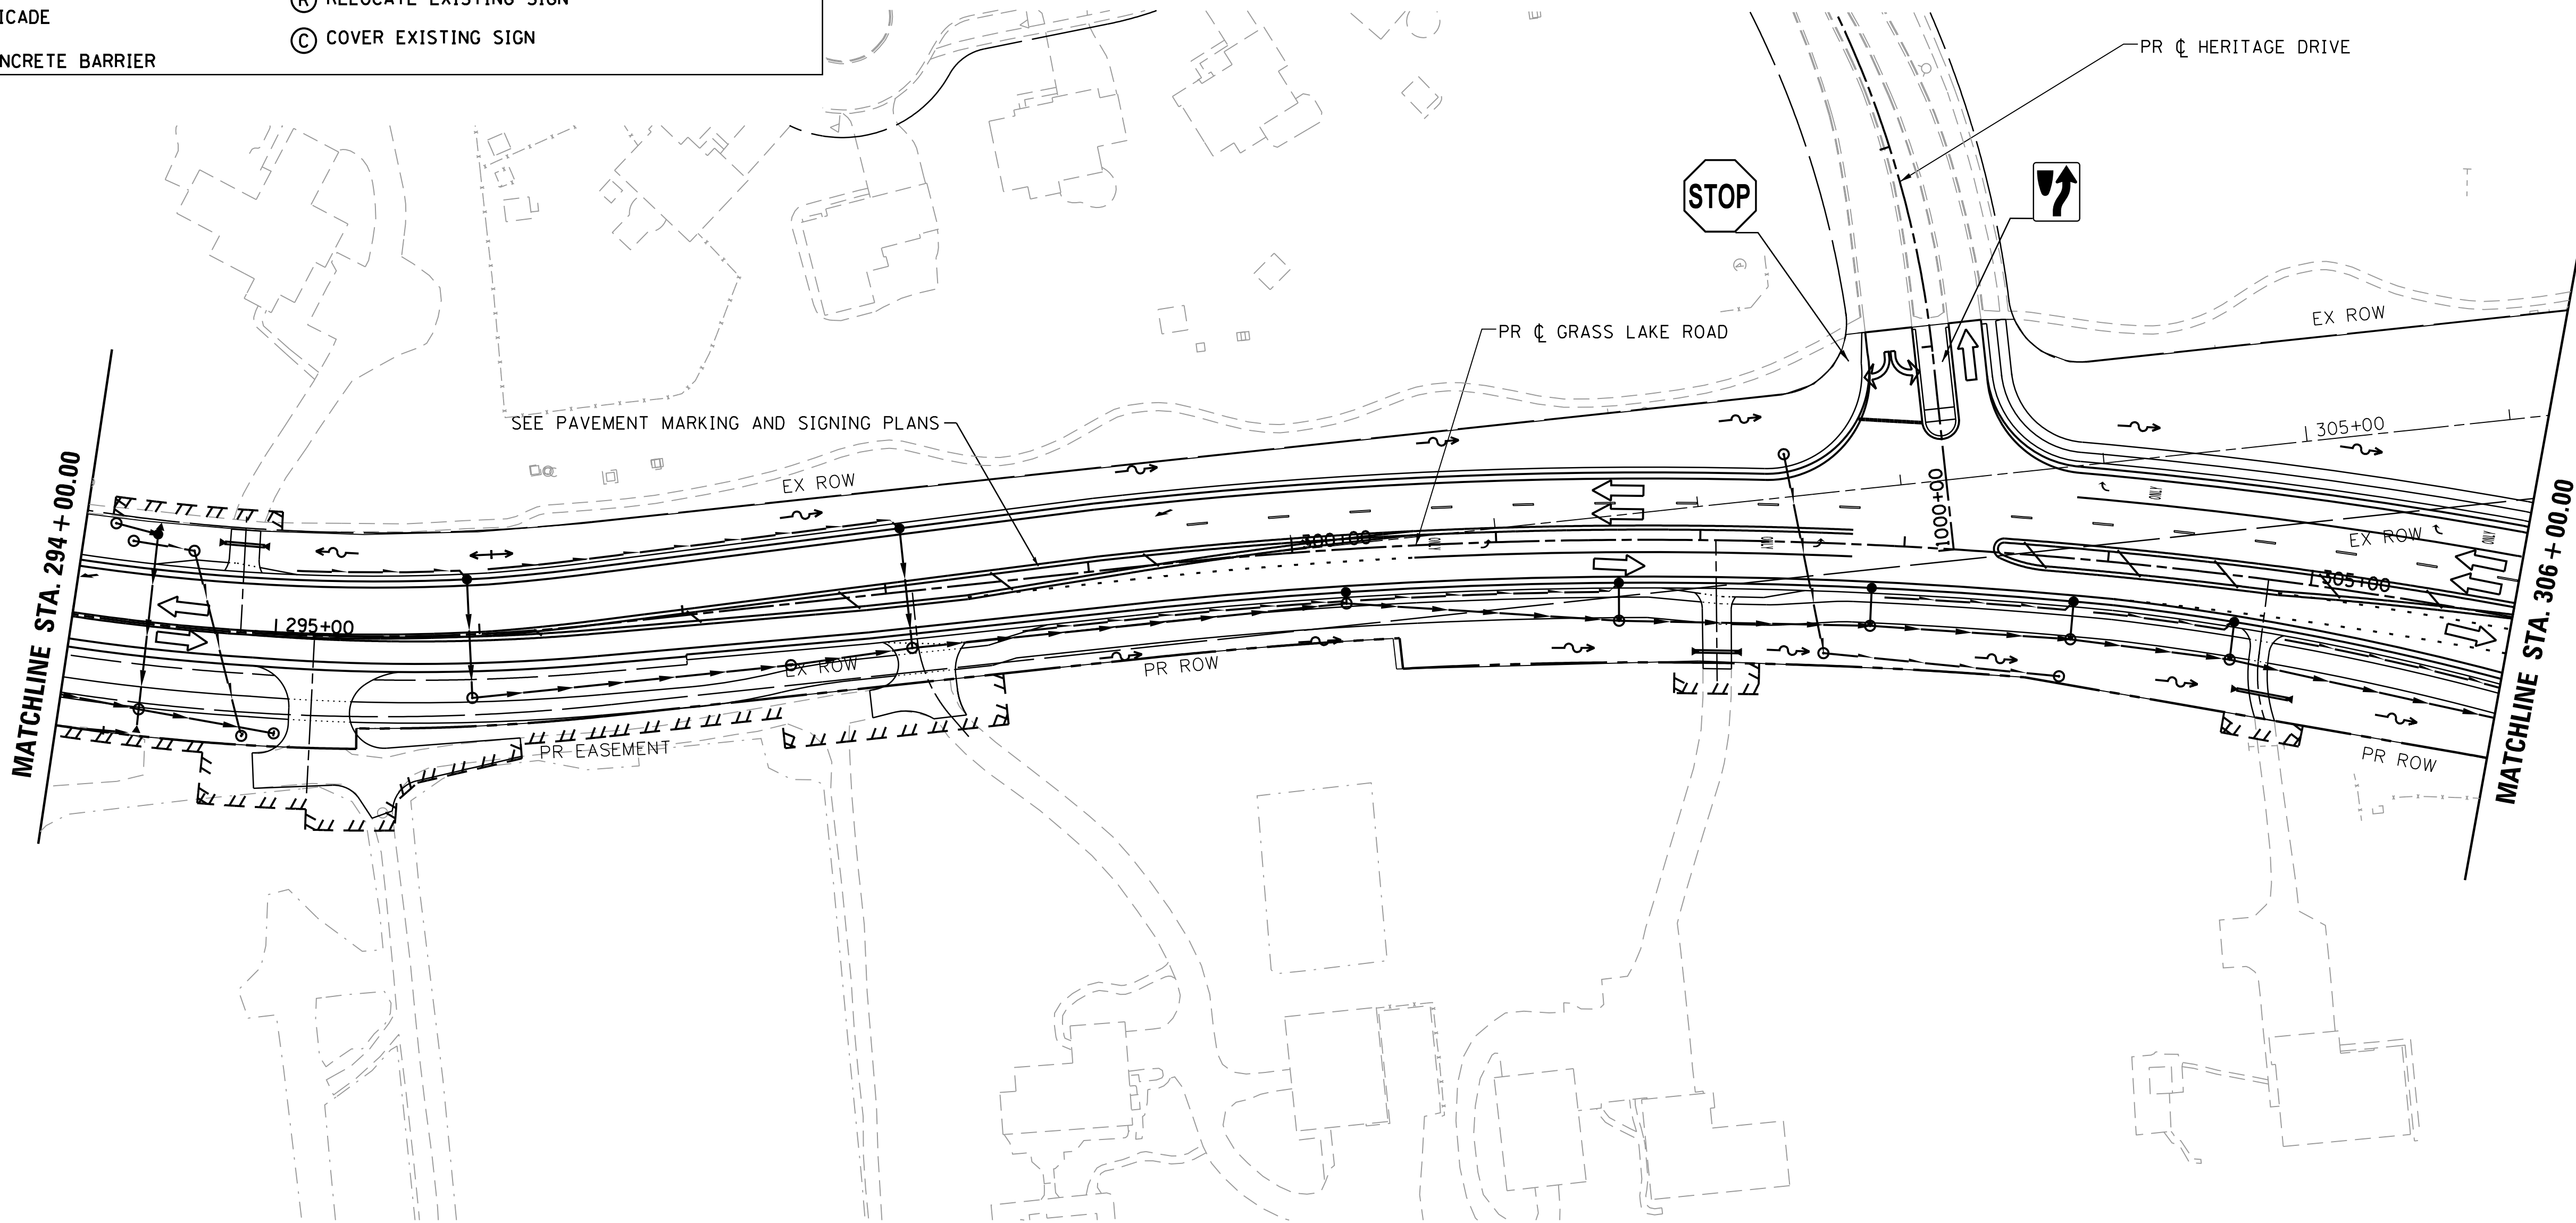



USER NAME = 35361	DESIGNED MO	REVISED -
	DRAWN MO	REVISED
PLOT SCALE = 50.0000' / in.	CHECKED FZ	REVISED
PLOT DATE = 9/14/2017	DATE 02/02/2017	REVISED

STATE OF ILLINOIS
DEPARTMENT OF TRANSPORTATION

MAINTENANCE OF TRAFFIC STAGE 4			
SCALE: 1"=50'	SHEET 9 OF 10 SHEETS	STA. 294+00 TO STA. 304+00	

F.A.P. RTE.	SECTION	COUNTY	TOTAL SHEETS	SHEET NO.
344	39 R	LAKE	510	129
CONTRACT NO. 60T75			ILLINOIS FED. AID PROJECT	


NO MAINTENANCE OF TRAFFIC ON THIS SHEET

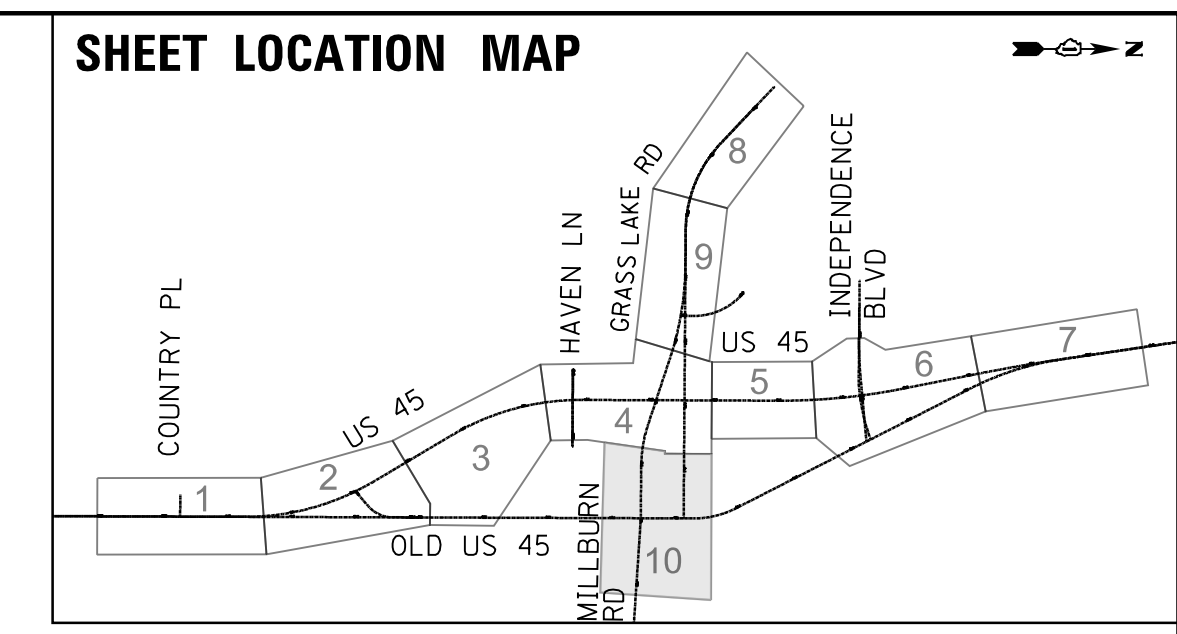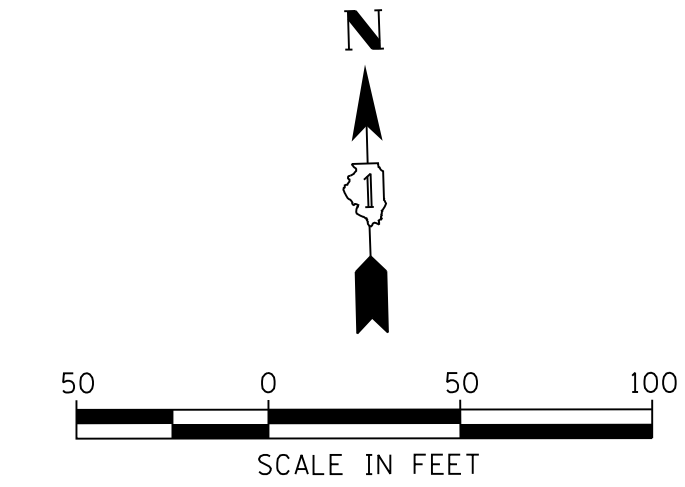

PLAN	SURVEYED	DATE
NOTE BOOK NO.	PLOTTED	BY
	CHECKED	
	AT	
	FILE NAME	

PROFILE	SURVEYED	DATE
NOTE BOOK NO.	GRADES CHECKED	BY
	STRUCTURE NOT AT THIS CHECK	

FILE NAME = p:\t\l\p\02\p\01\person\com\illinois\State\Documents\US45 - 647985\48 - Design\CAD\Roadway\Sheet\DI60775.shx\NOT 4.10.dgn

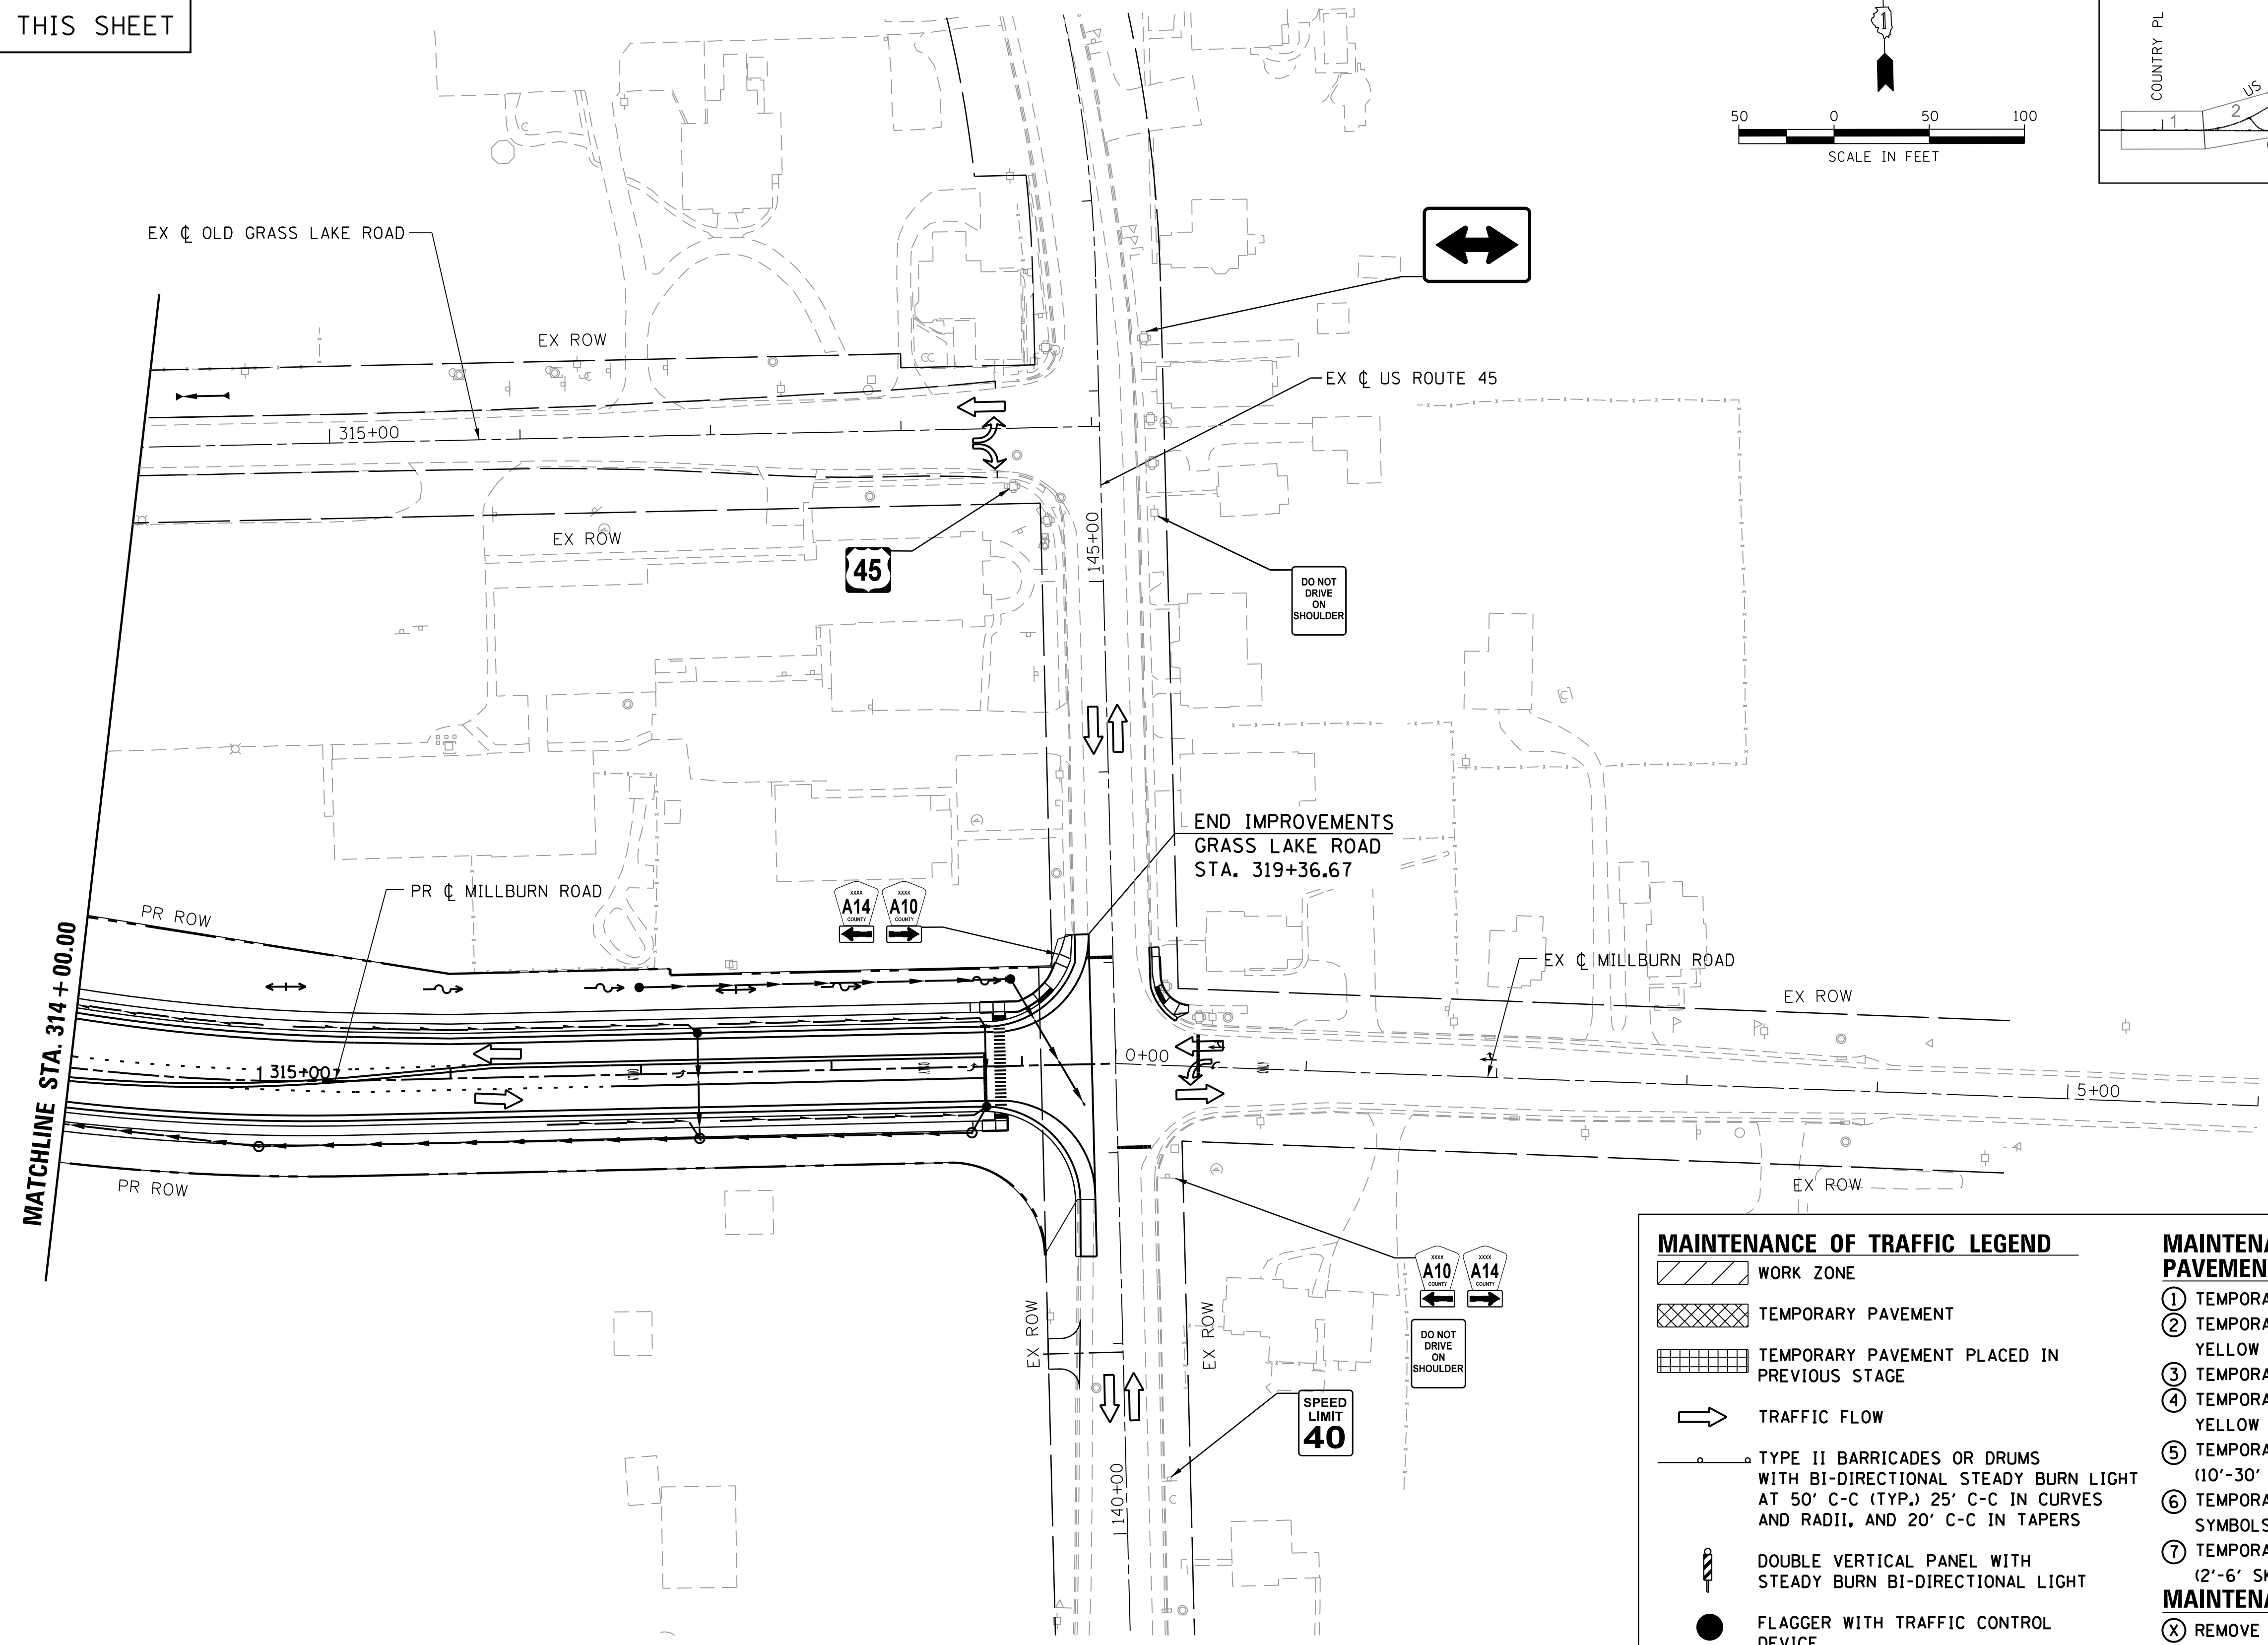

MAINTENANCE OF TRAFFIC LEGEND

- WORK ZONE
- TEMPORARY PAVEMENT
- TEMPORARY PAVEMENT PLACED IN PREVIOUS STAGE
- TRAFFIC FLOW
- TYPE II BARRICADES OR DRUMS WITH BI-DIRECTIONAL STEADY BURN LIGHT AT 50' C-C (TYP.), 25' C-C IN CURVES AND RADII, AND 20' C-C IN TAPERS
- DOUBLE VERTICAL PANEL WITH STEADY BURN BI-DIRECTIONAL LIGHT
- FLAGGER WITH TRAFFIC CONTROL DEVICE
- TYPE III BARRICADE
- TEMPORARY CONCRETE BARRIER

MAINTENANCE OF TRAFFIC PAVEMENT MARKING

- ① TEMPORARY PAVEMENT MARKING, LINE 4" WHITE
- ② TEMPORARY PAVEMENT MARKING, LINE 4" DOUBLE YELLOW AT 11" C-C
- ③ TEMPORARY PAVEMENT MARKING, LINE 24" WHITE
- ④ TEMPORARY PAVEMENT MARKING, LINE 12" YELLOW AT 50' C-C
- ⑤ TEMPORARY PAVEMENT MARKING, LINE 4", WHITE (10'-30' SKIP DASH)
- ⑥ TEMPORARY PAVEMENT MARKING LETTERS AND SYMBOLS
- ⑦ TEMPORARY PAVEMENT MARKING, LINE 4", WHITE (2'-6' SKIP DASH)

MAINTENANCE OF TRAFFIC SIGNING

- ⓧ REMOVE EXISTING SIGN
- Ⓡ RELOCATE EXISTING SIGN
- Ⓢ COVER EXISTING SIGN

USER NAME = 35361	DESIGNED MO	REVISED -
	DRAWN MO	REVISED
PLOT SCALE = 50.0000' / in.	CHECKED FZ	REVISED
PLOT DATE = 12/6/2017	DATE 02/02/2017	REVISED









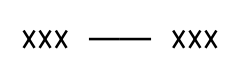
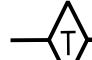
STATE OF ILLINOIS
DEPARTMENT OF TRANSPORTATION



MAINTENANCE OF TRAFFIC
STAGE 4

SCALE: 1"=50' SHEET 10 OF 10 SHEETS STA. 314+00 TO STA.

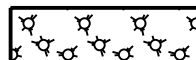F.A.P. RTE.	SECTION	COUNTY	TOTAL SHEETS	SHEET NO.
344	39 R	LAKE	510	130
CONTRACT NO. 60T75			ILLINOIS FED. AID PROJECT	

EROSION CONTROL LEGEND


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-  EROSION CONTROL BLANKET FROM PREVIOUS STAGE
-  MULCH, METHOD 3, TEMPORARY EROSION CONTROL SEEDING
-  MULCH, METHOD 3 FROM PREVIOUS STAGE
-  TEMPORARY PAVEMENT
-  TREE TRUNK PROTECTION
-  INLET AND PIPE PROTECTION
-  PERIMETER EROSION BARRIER (PEB)
-  FENCE TEMPORARY
-  TEMPORARY DITCH CHECKS

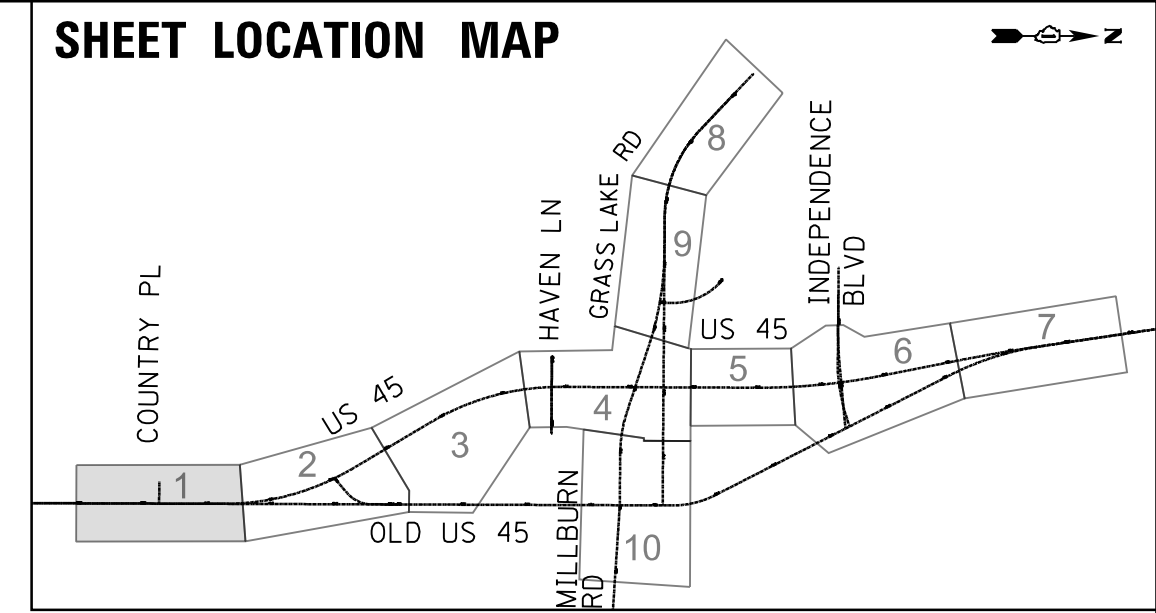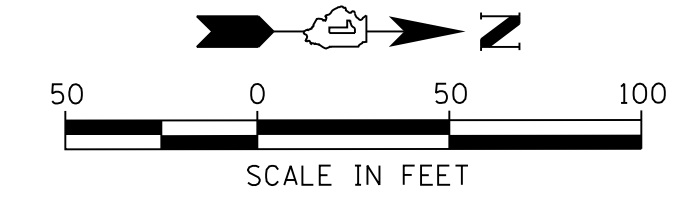

PLAN	SURVEYED	DATE
NOTE BOOK NO.	PLOTTED	BY
	CHECKED	
	DATE	
	FILE NAME	

PROFILE	SURVEYED	DATE
NOTE BOOK NO.	GRADES CHECKED	BY
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USER NAME = 35361	DESIGNED FZ	REVISED -
	DRAWN MO	REVISED
PLOT SCALE = 50.0000' / in.	CHECKED BN	REVISED
PLOT DATE = 9/14/2017	DATE 02/02/2017	REVISED

**STATE OF ILLINOIS
DEPARTMENT OF TRANSPORTATION**

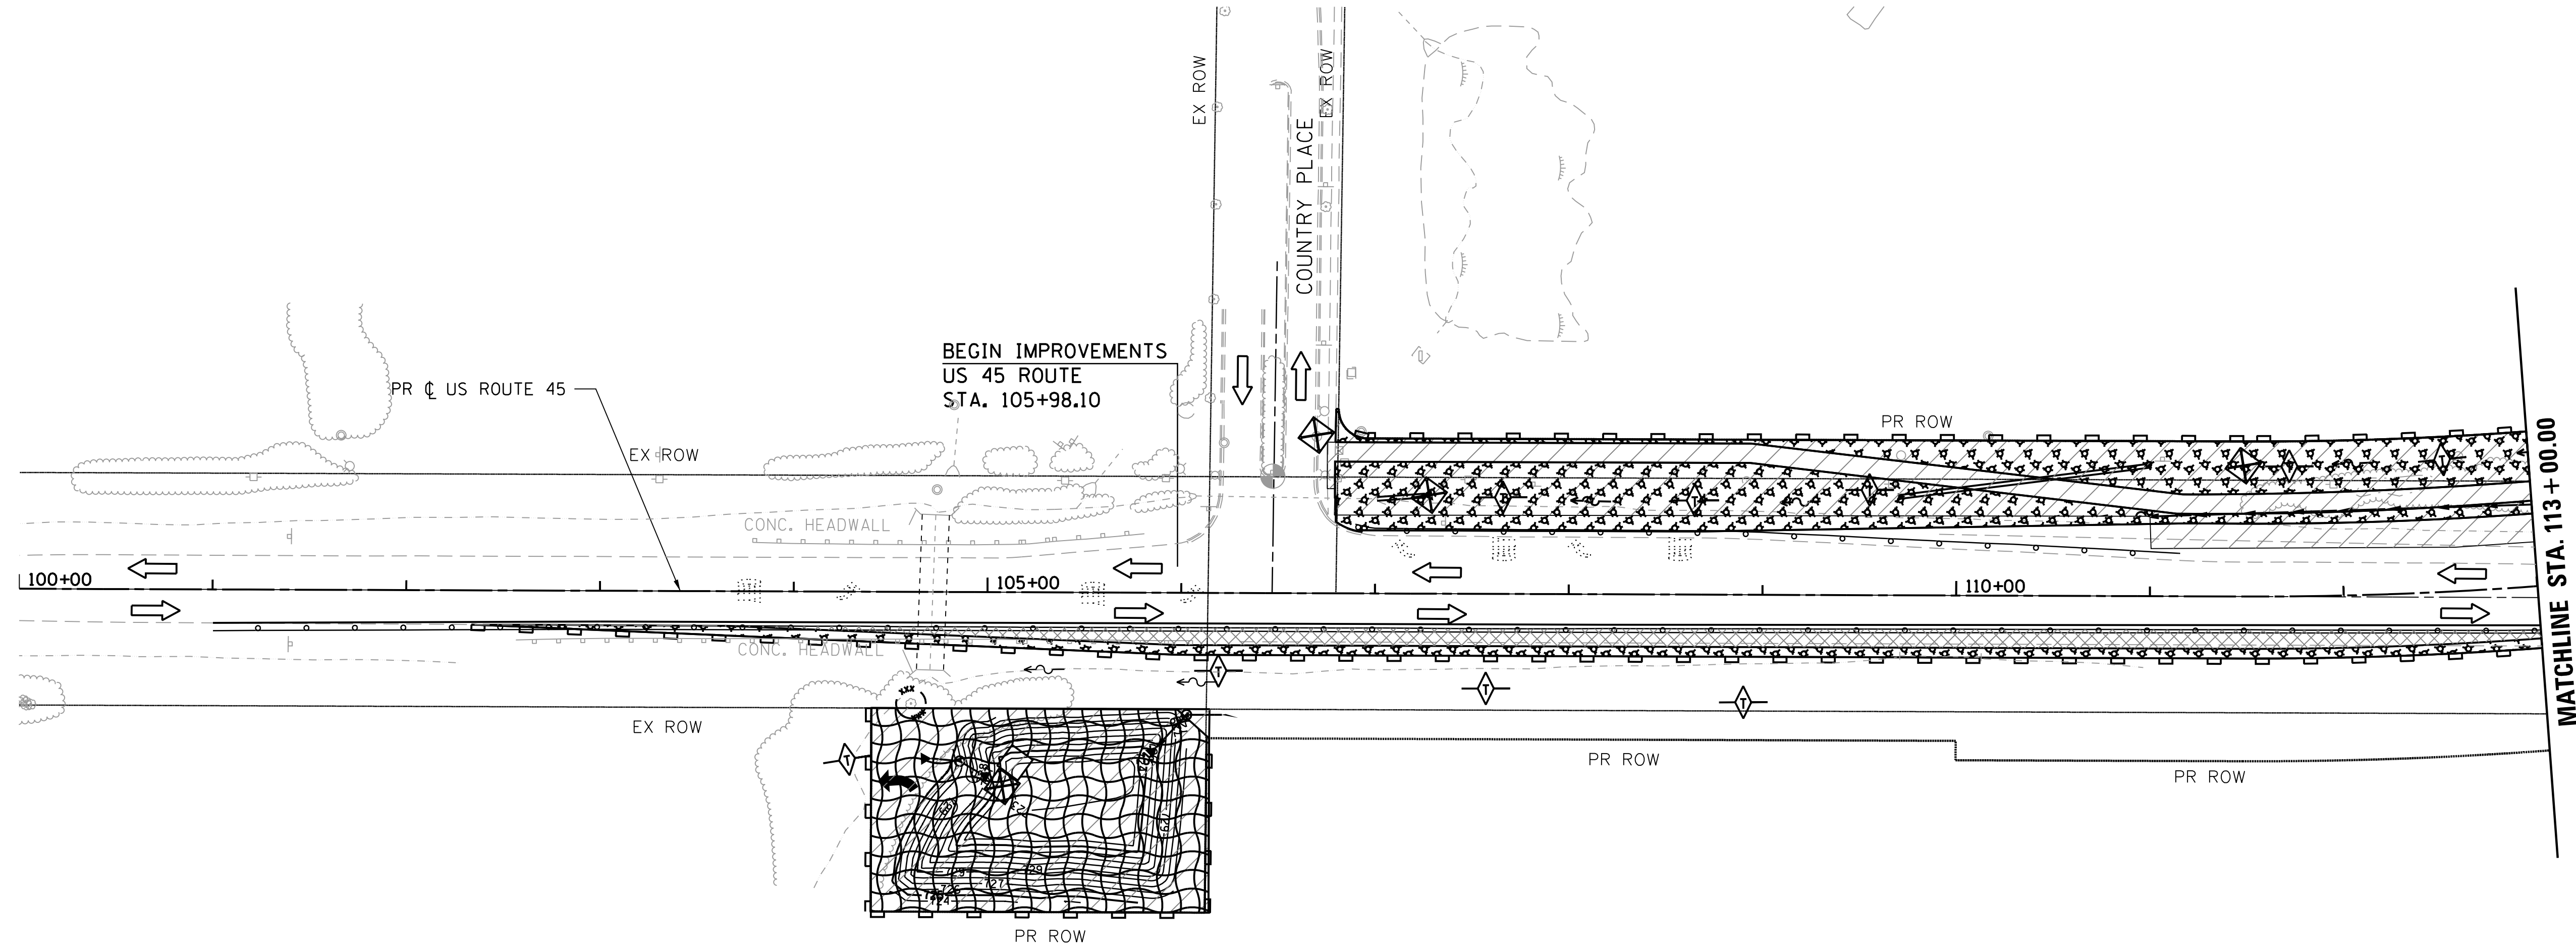**EROSION AND SEDIMENT CONTROL STAGING PLAN – STAGE 1
US ROUTE 45**


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F.A.P. RTE.	SECTION	COUNTY	TOTAL SHEETS	SHEET NO.
344	39 R	LAKE	510	131
CONTRACT NO.			60T75	
ILLINOIS FED. AID PROJECT				

PLAN	SURVEYED	BY	DATE
	PLOTTED		
	CHECKED		
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	FILE NAME		
	NO.		

PROFILE	SURVEYED	BY	DATE
	PLOTTED		
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	NO.		

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EROSION CONTROL LEGEND

- EROSION CONTROL BLANKET, TEMPORARY EROSION CONTROL SEEDING
- EROSION CONTROL BLANKET FROM PREVIOUS STAGE
- MULCH, METHOD 3, TEMPORARY EROSION CONTROL SEEDING
- MULCH, METHOD 3 FROM PREVIOUS STAGE
- TEMPORARY PAVEMENT
- TREE TRUNK PROTECTION
- INLET AND PIPE PROTECTION
- PERIMETER EROSION BARRIER (PEB)
- FENCE TEMPORARY
- TEMPORARY DITCH CHECKS

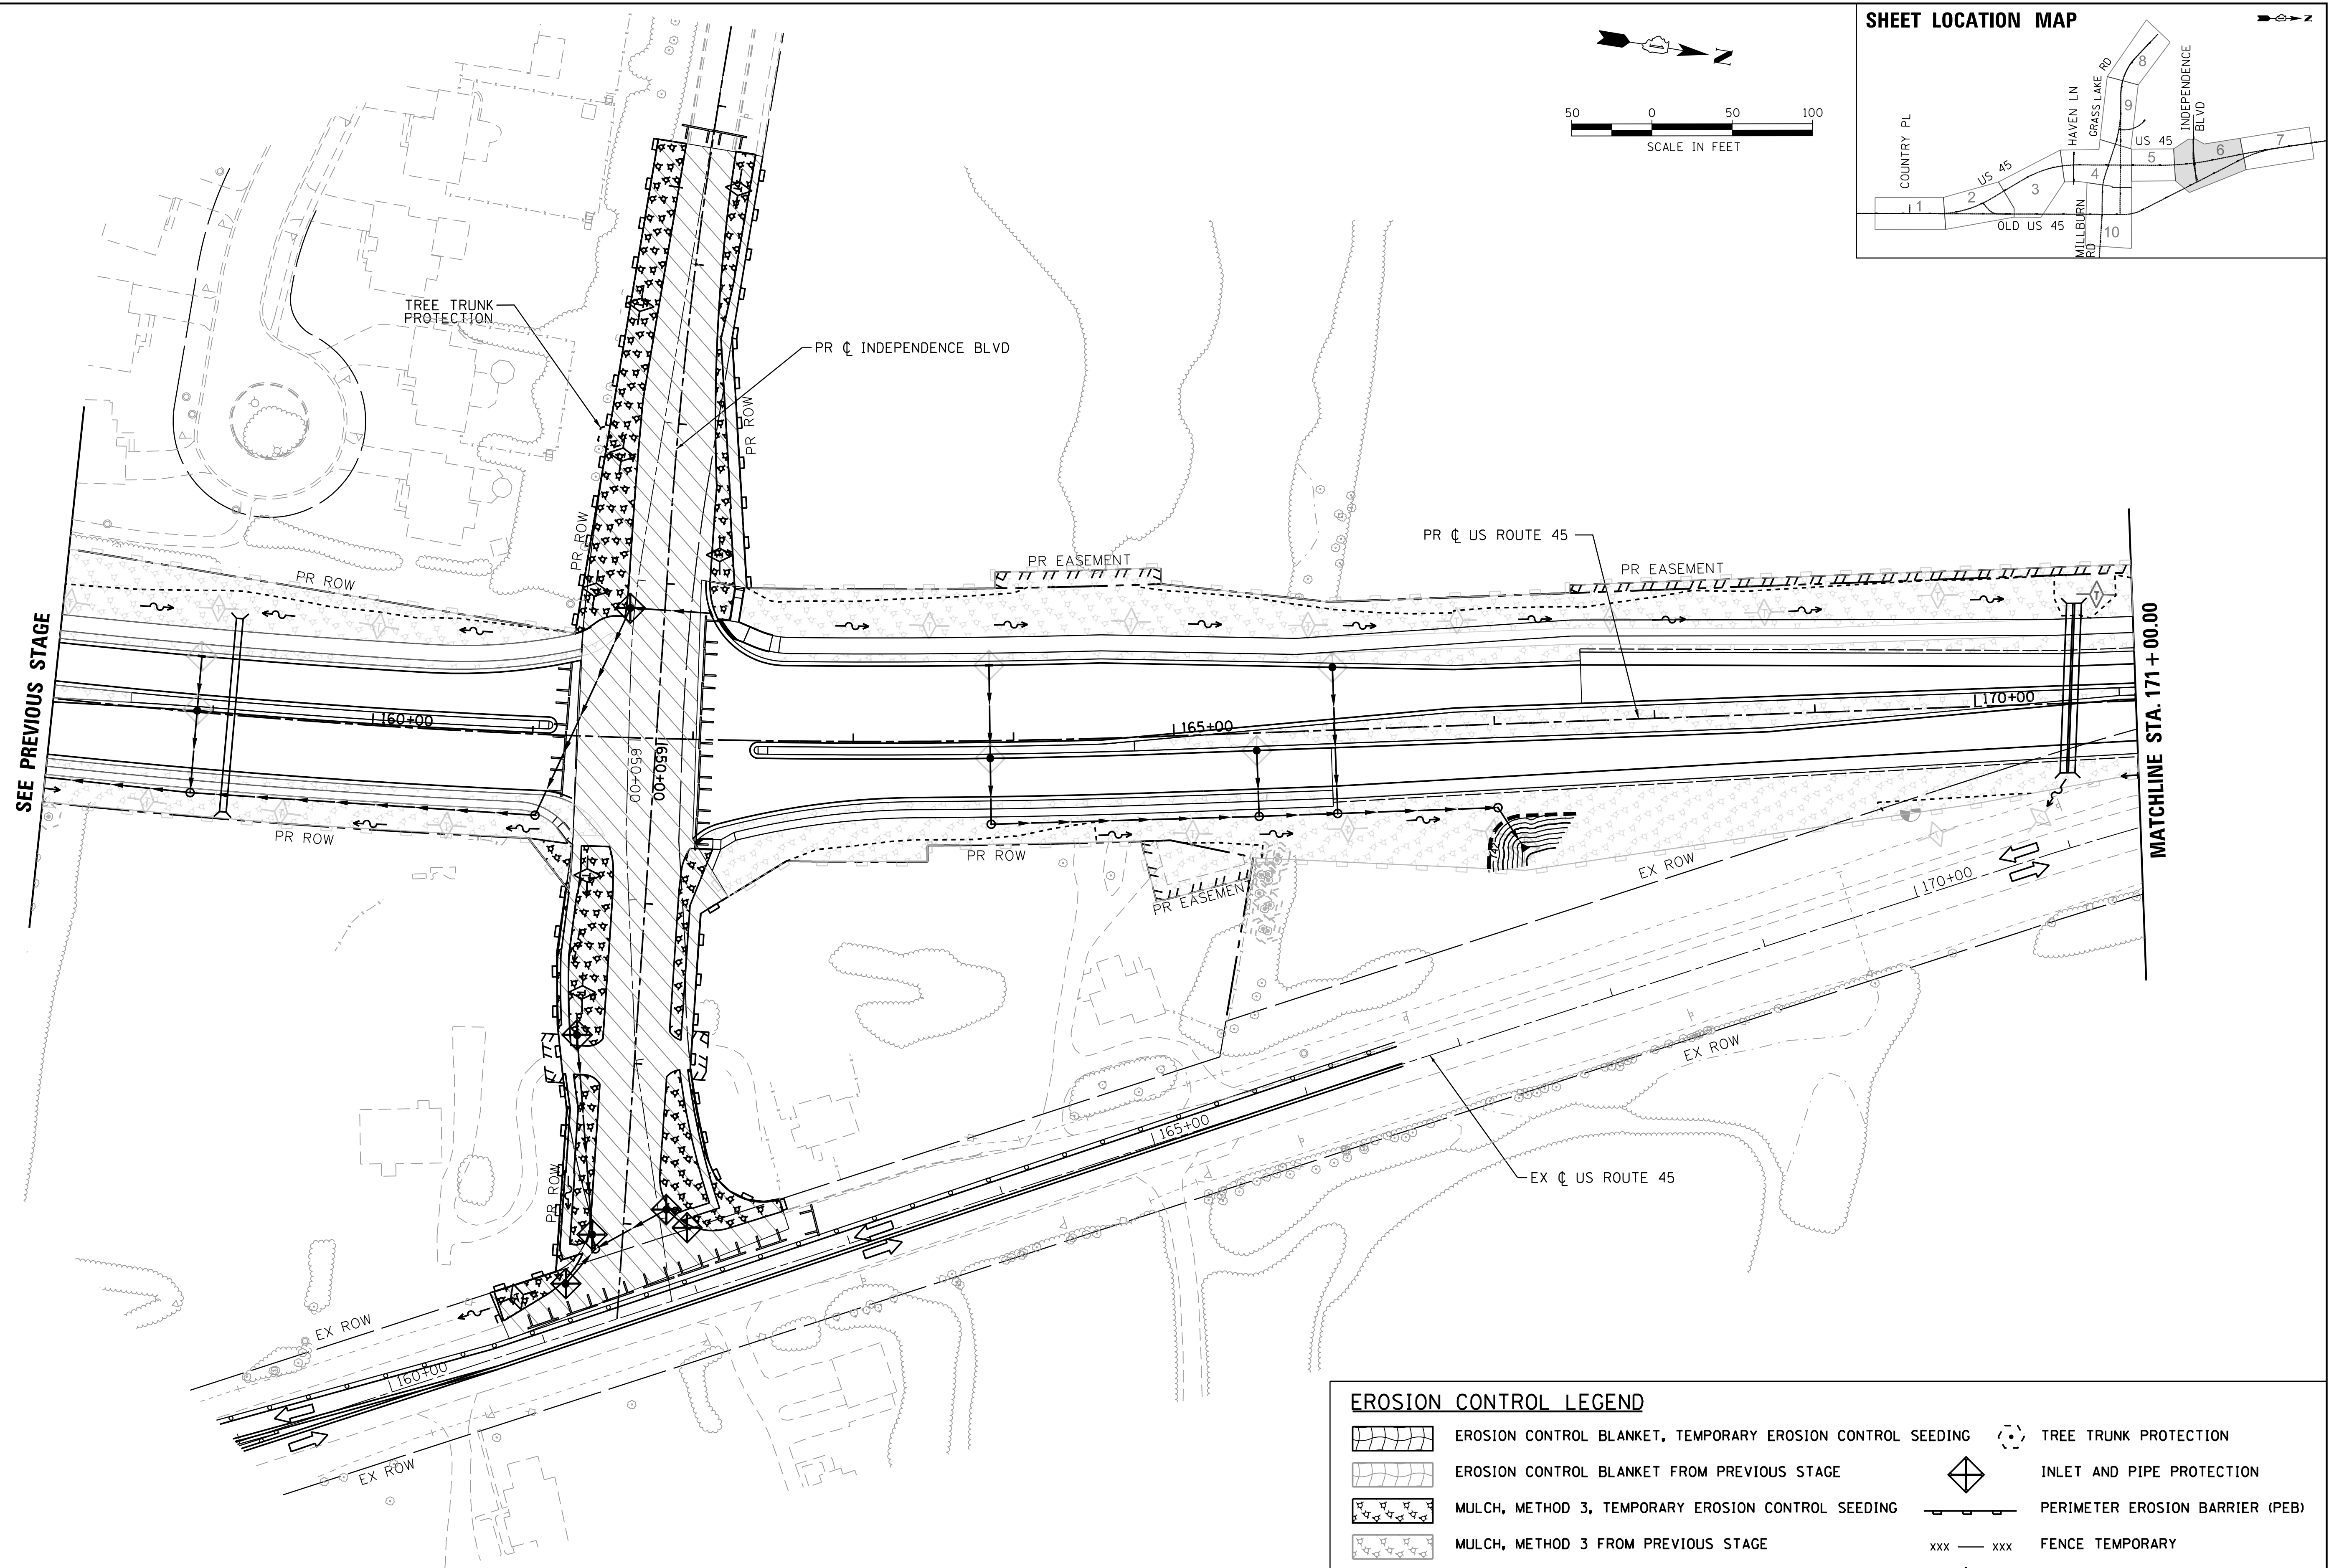USER NAME = 35361	DESIGNED FZ	REVISED -
	DRAWN MO	REVISED
PLOT SCALE = 50.0000' / 1"	CHECKED BN	REVISED
PLOT DATE = 9/14/2017	DATE 02/02/2017	REVISED









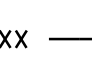
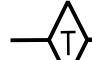
**STATE OF ILLINOIS
DEPARTMENT OF TRANSPORTATION**



**EROSION AND SEDIMENT CONTROL STAGING PLAN - STAGE 2
US ROUTE 45**

SCALE: 1"=50' SHEET 6 OF 8 SHEETS STA. 158+00 TO STA. 171+00

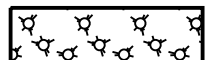F.A.P. RTE. 344	SECTION 39 R	COUNTY LAKE	TOTAL SHEETS 510	SHEET NO. 144
			CONTRACT NO. 60T75	
ILLINOIS FED. AID PROJECT				

EROSION CONTROL LEGEND


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-  EROSION CONTROL BLANKET FROM PREVIOUS STAGE
-  MULCH, METHOD 3, TEMPORARY EROSION CONTROL SEEDING
-  MULCH, METHOD 3 FROM PREVIOUS STAGE
-  TEMPORARY PAVEMENT
-  TREE TRUNK PROTECTION
-  INLET AND PIPE PROTECTION
-  PERIMETER EROSION BARRIER (PEB)
-  FENCE TEMPORARY
-  TEMPORARY DITCH CHECKS

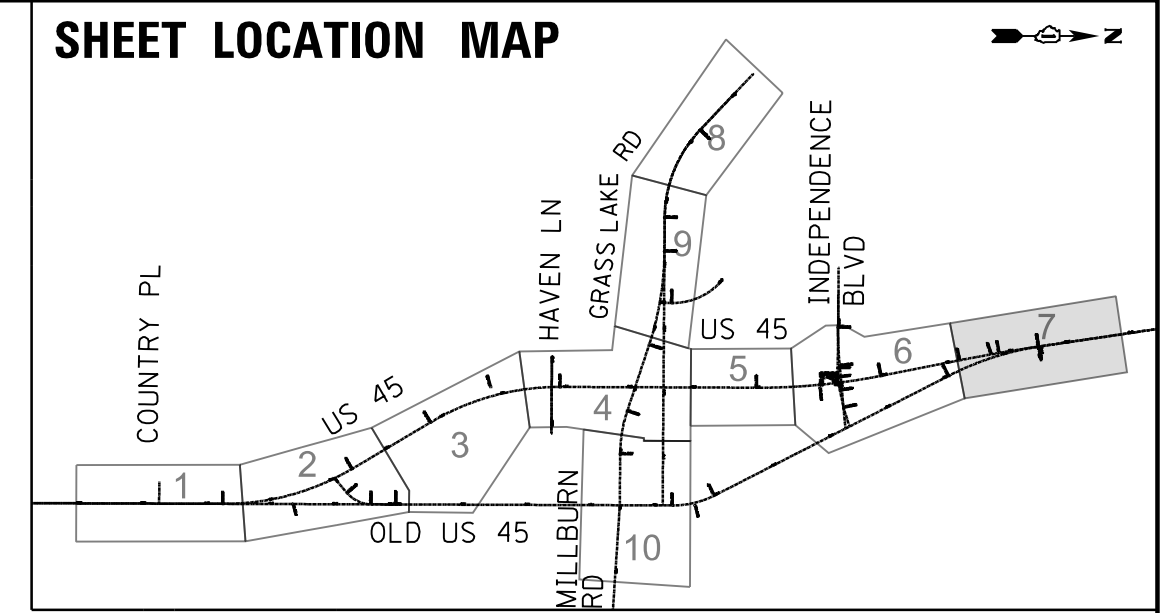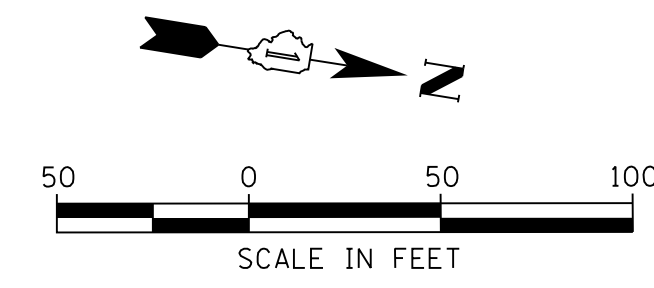

PLAN	SURVEYED	DATE
	PLOTTED	
	CHECKED	
	AT	
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	FILE NAME	

PROFILE	SURVEYED	DATE
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USER NAME = 35361	DESIGNED FZ	REVISED -
	DRAWN MO	REVISED
PLOT SCALE = 50.0000' / in.	CHECKED BN	REVISED
PLOT DATE = 9/14/2017	DATE 02/02/2017	REVISED

**STATE OF ILLINOIS
DEPARTMENT OF TRANSPORTATION**

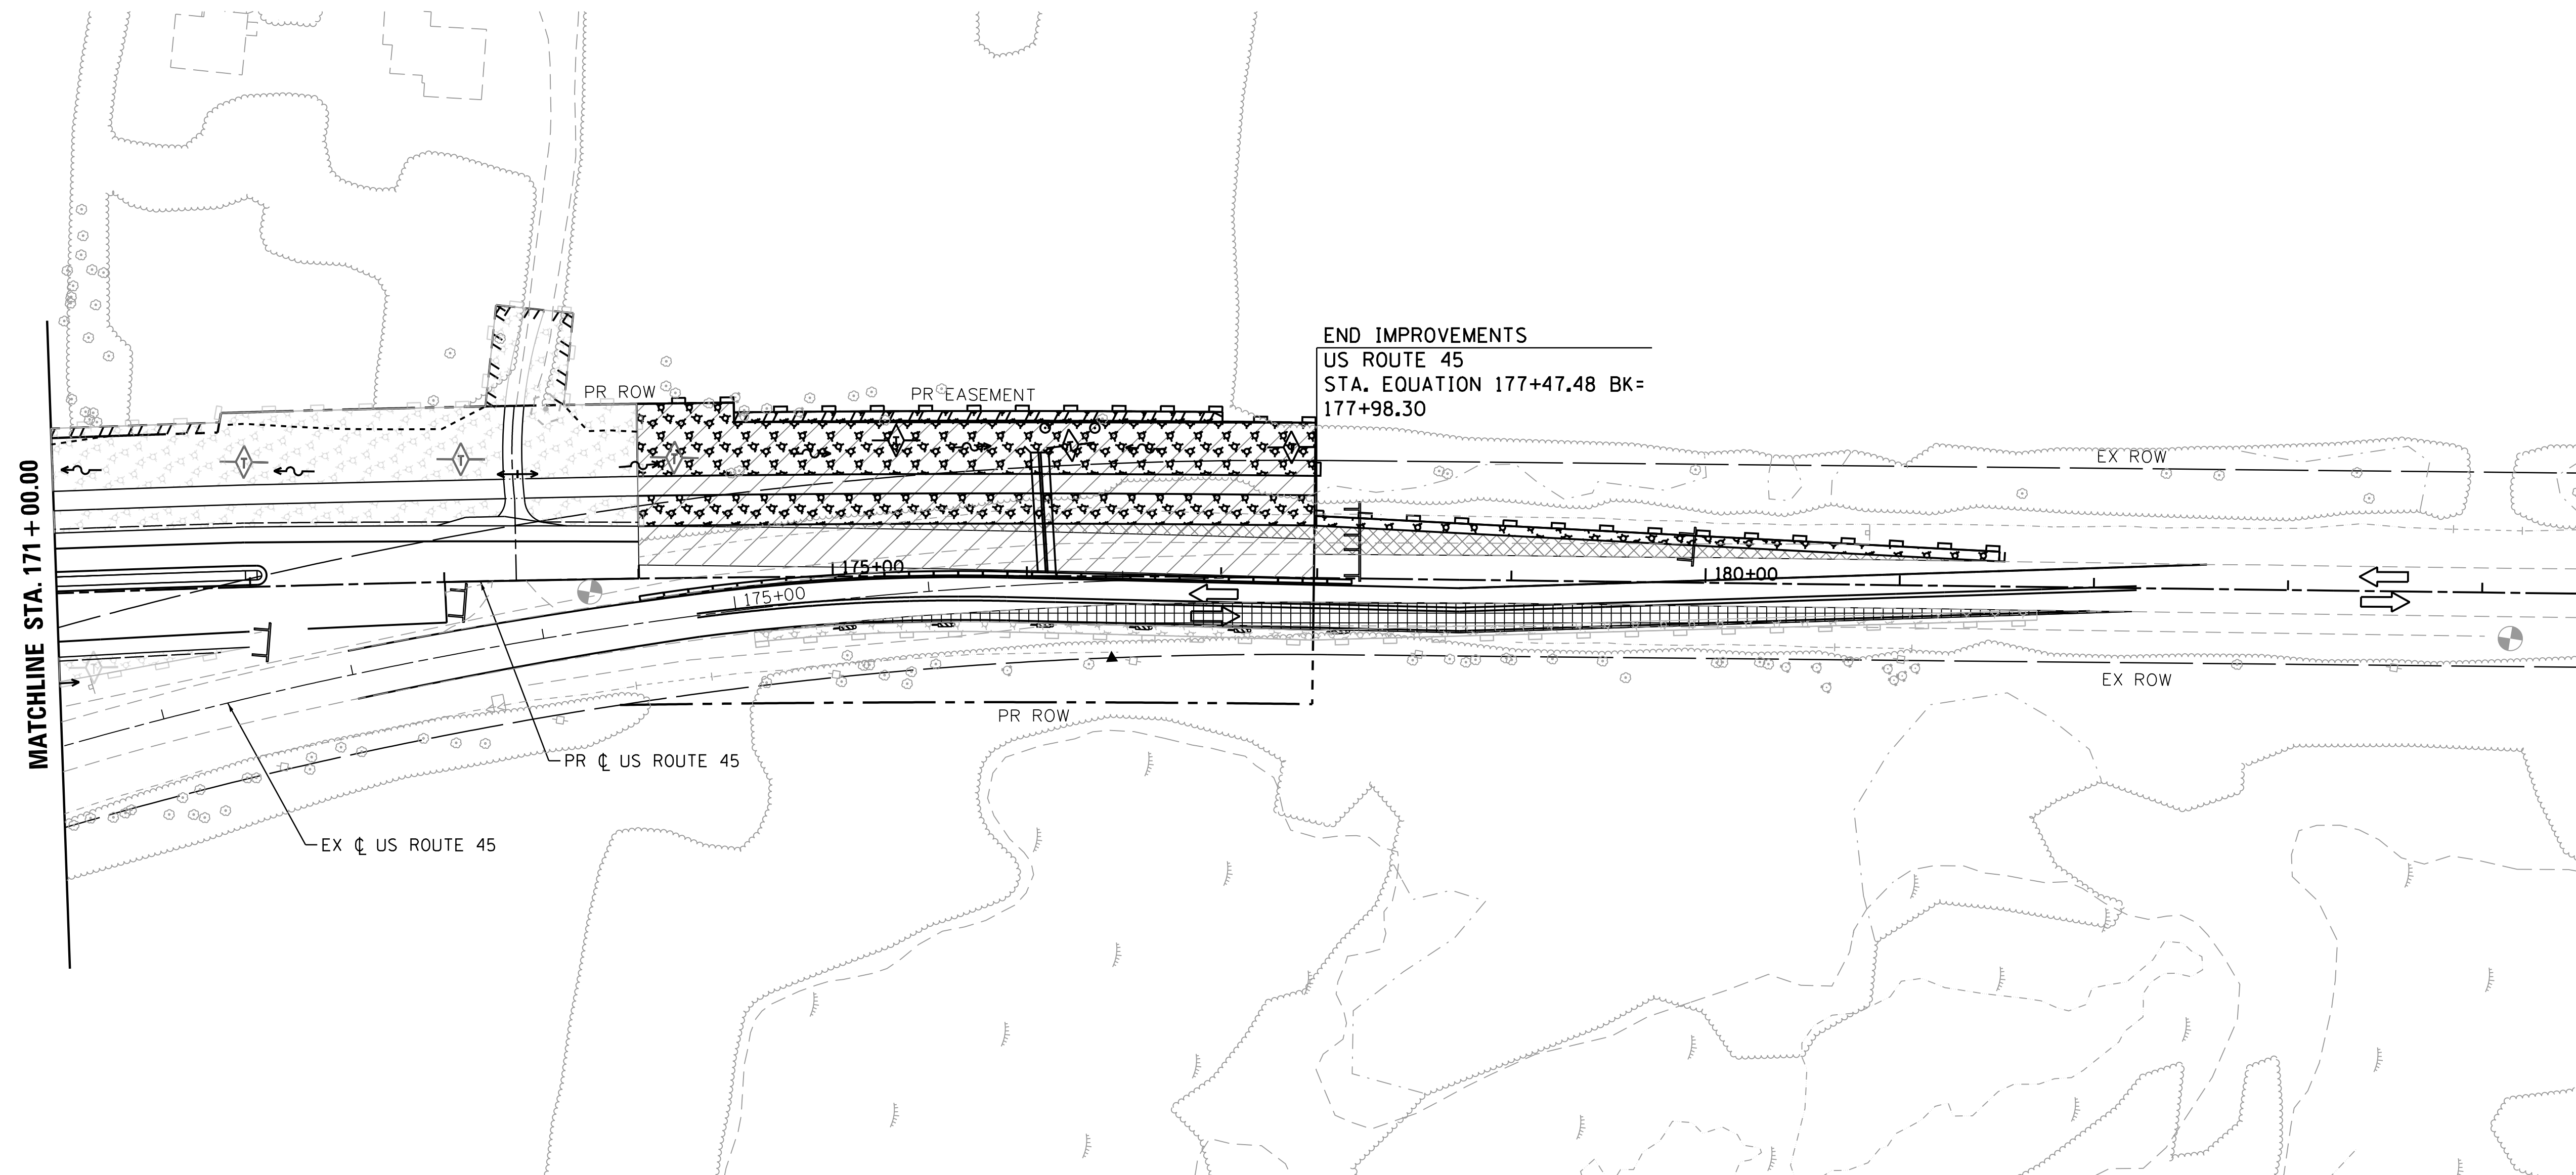**EROSION AND SEDIMENT CONTROL STAGING PLAN - STAGE 2
US ROUTE 45**

SCALE: 1"=50' SHEET 7 OF 8 SHEETS STA. 171+00 TO STA. 178+00



F.A.P. RTE. 344	SECTION 39 R	COUNTY LAKE	TOTAL SHEETS 510	SHEET NO. 145
CONTRACT NO. 60T75			ILLINOIS FED. AID PROJECT	

REMOVAL DRAINAGE LEGEND

- ////// LINEAR ITEM REMOVAL
- X ITEM REMOVAL
- AX STRUCTURE TO BE ADJUSTED
- (AX) PIPE TO BE REMOVED

NOTE:


1. FOR DRAINAGE REMOVAL SCHEDULE SEE SHEET NO. 183

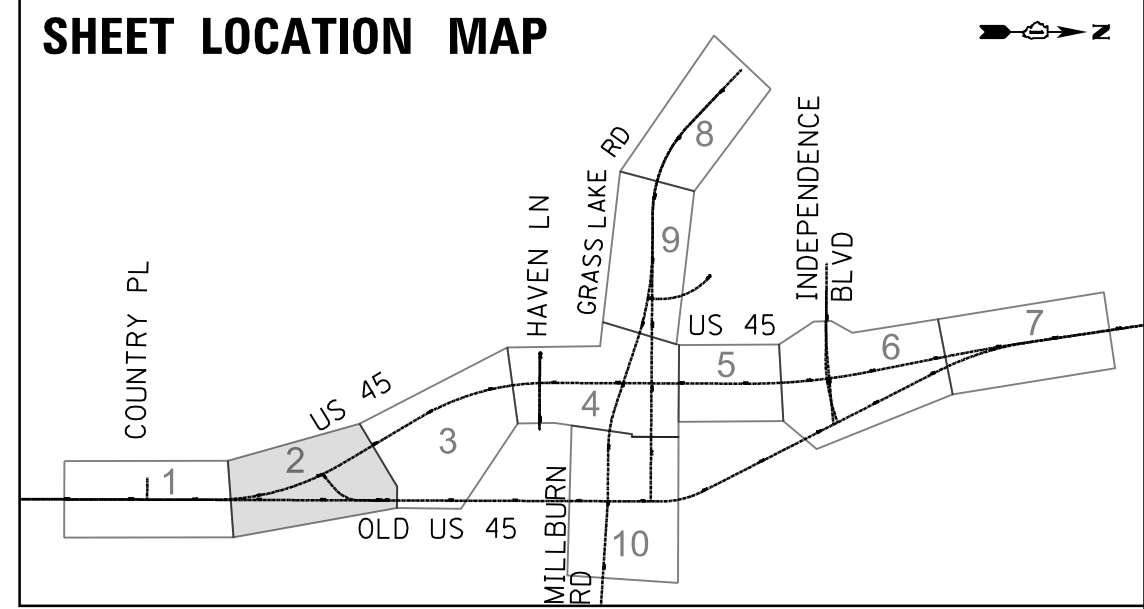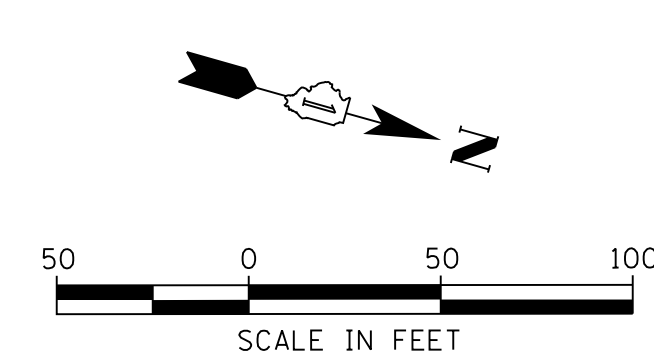

PLAN	SURVEYED	DATE
	PLOTTED	
	GRADES CHECKED	
	STRUCTURE NOT AT THIS CHECKED	
	NO. _____	
	NO. _____	
	NO. _____	
	NO. _____	
	NO. _____	

PROFILE	SURVEYED	DATE
	PLOTTED	
	GRADES CHECKED	
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END PROJECT
PR C OLD US ROUTE 45 STA. 604+43.59

USER NAME = 35361	DESIGNED SS	REVISED -
	DRAWN SS	REVISED
PLOT SCALE = 50.0000' / in.	CHECKED DW	REVISED
PLOT DATE = 9/18/2017	DATE 02/02/2017	REVISED

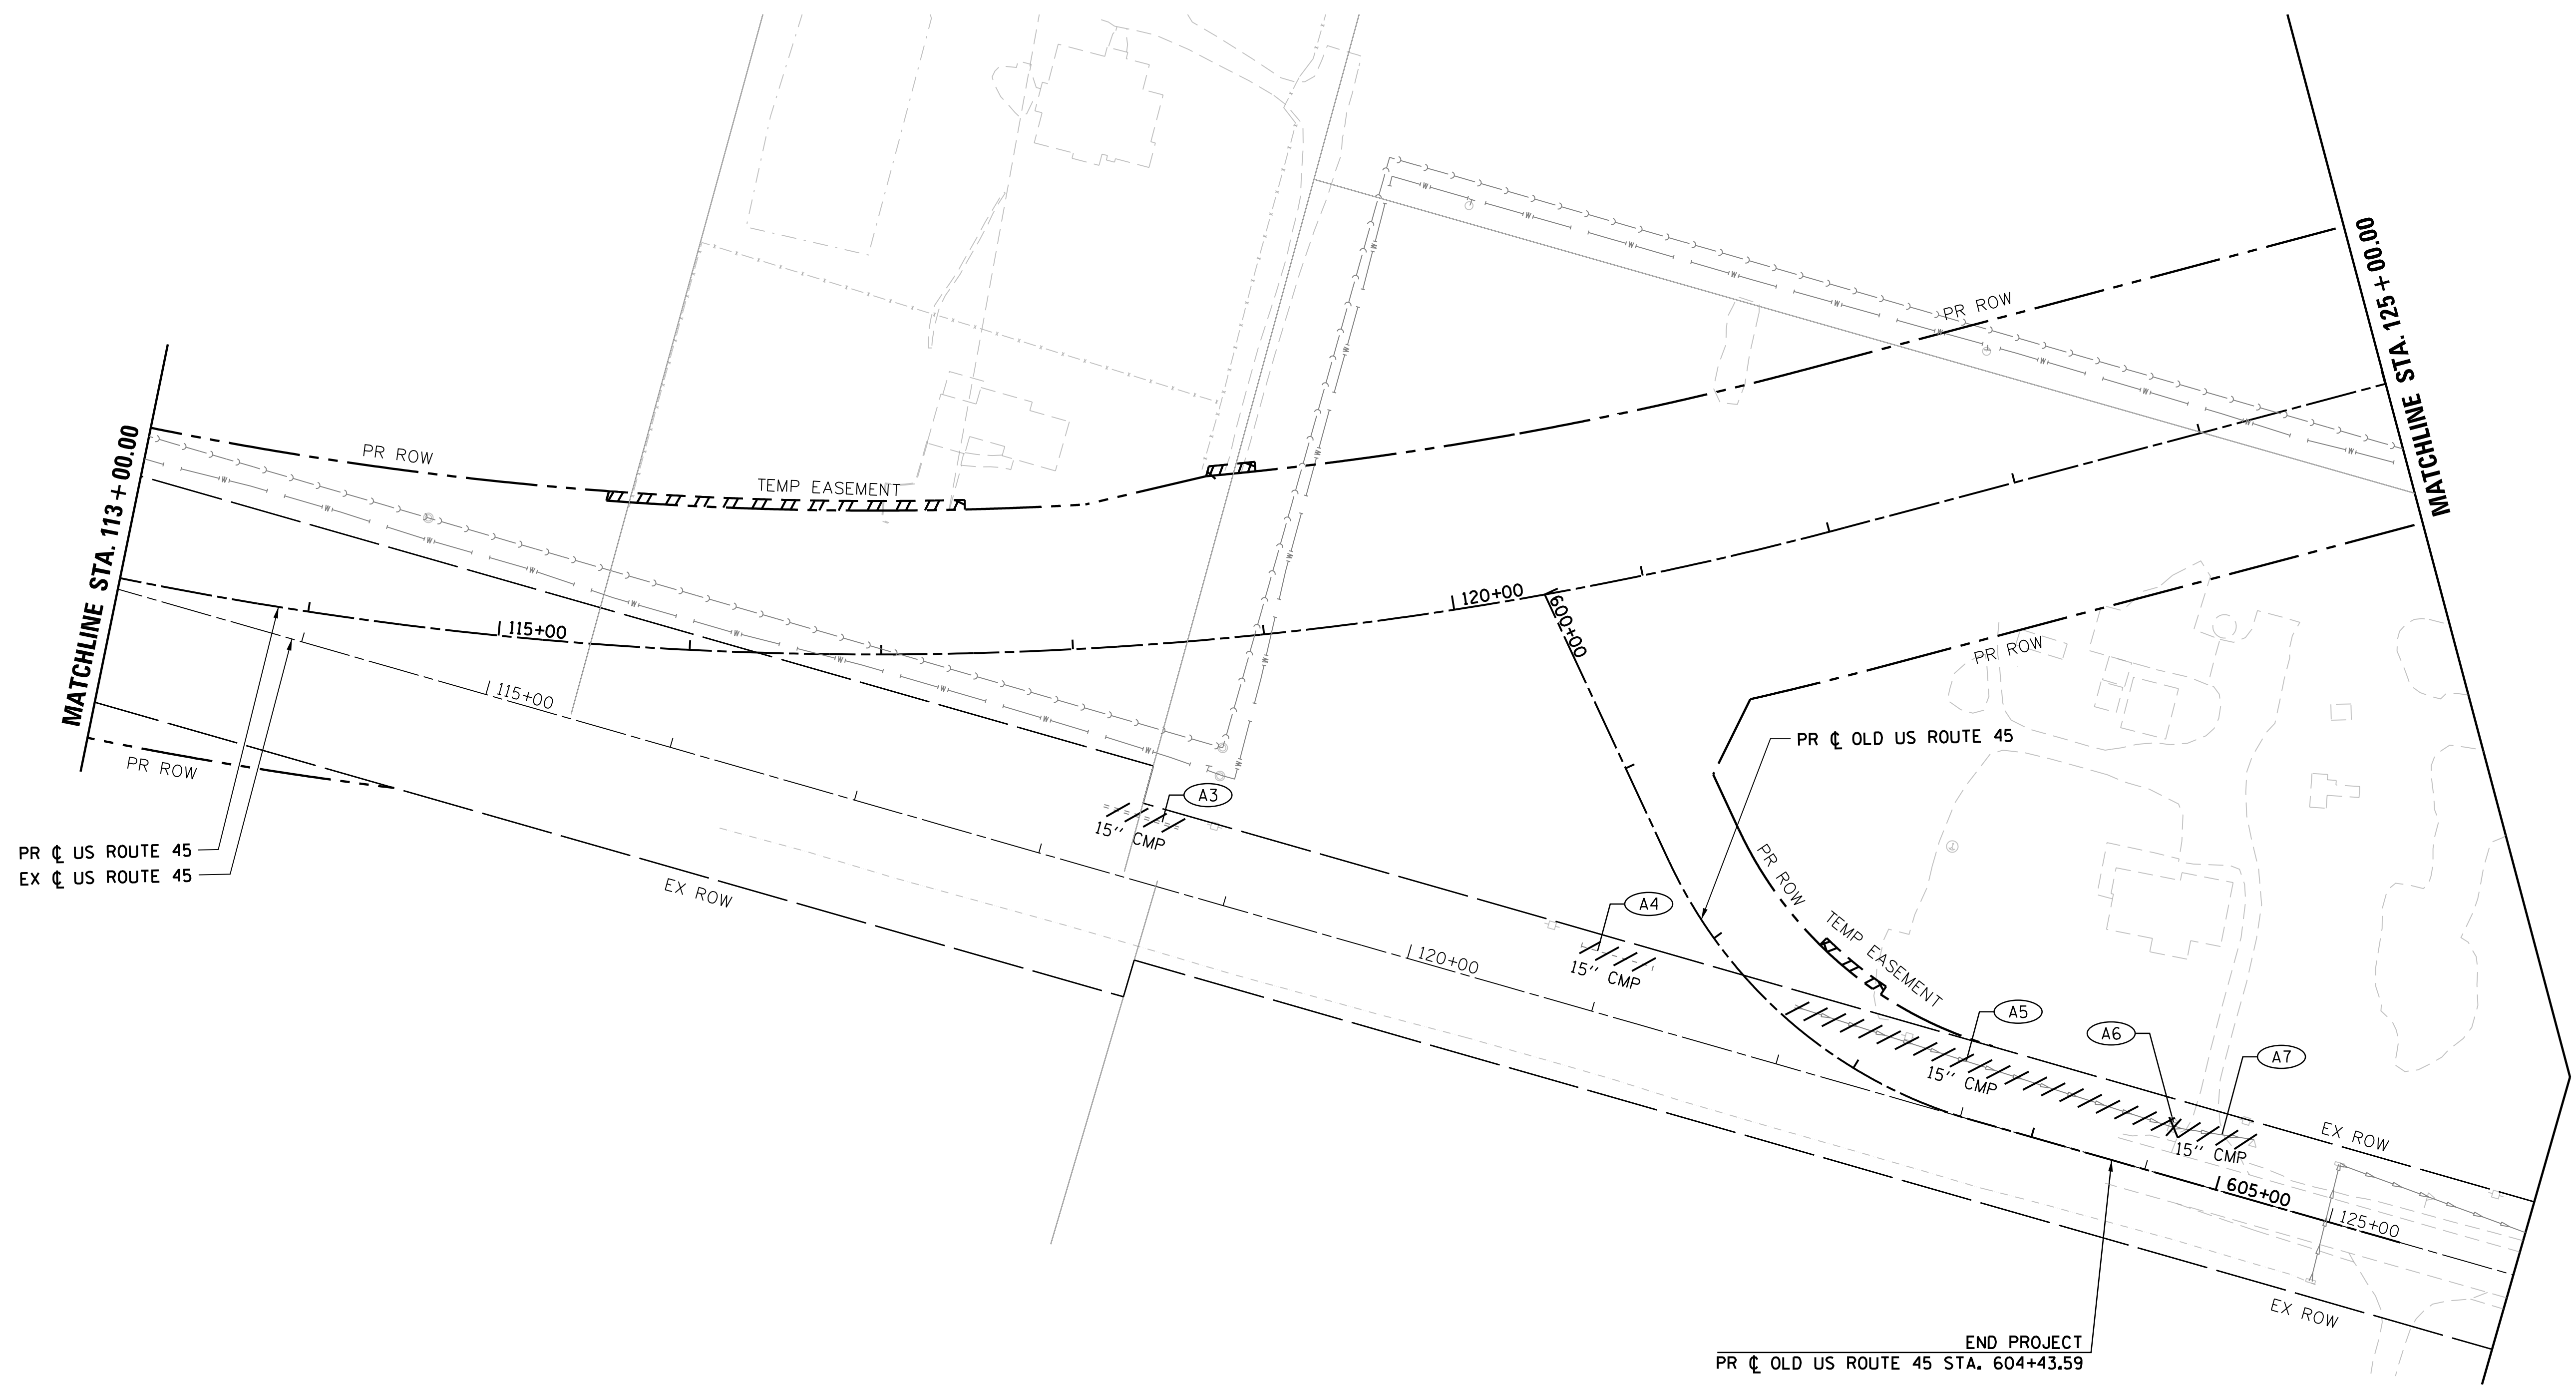**STATE OF ILLINOIS
DEPARTMENT OF TRANSPORTATION**

**DRAINAGE REMOVAL PLAN
US ROUTE 45**



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F.A.P. RTE.	SECTION	COUNTY	TOTAL SHEETS	SHEET NO.
344	39 R	LAKE	510	157
ILLINOIS FED. AID PROJECT			CONTRACT NO. 60T75	

PLAN	SURVEYED	BY	DATE
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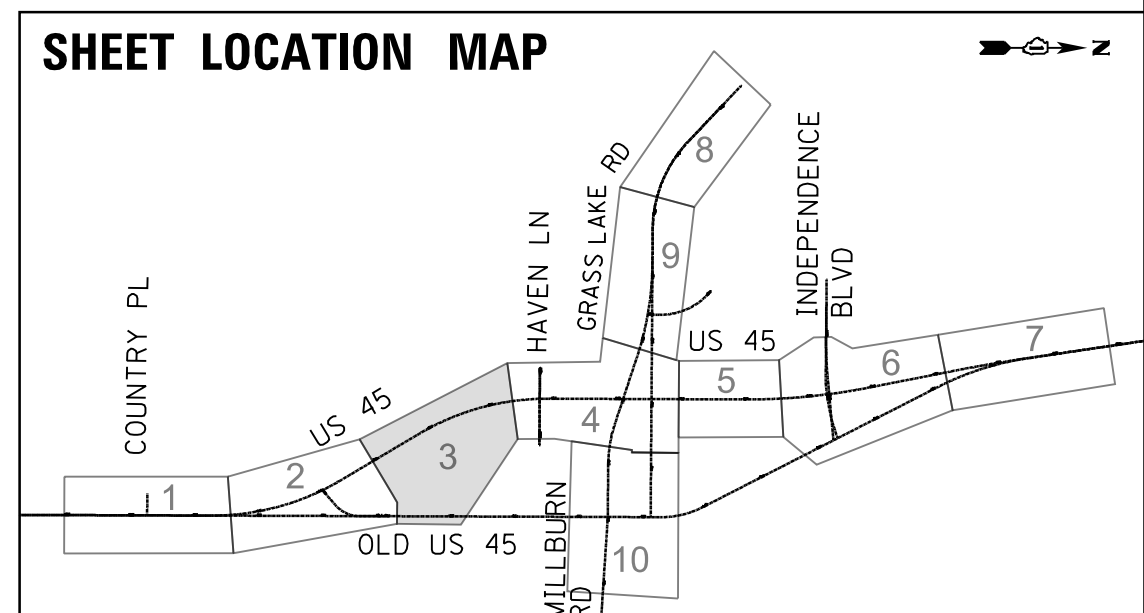
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NOTE:
1. FOR DRAINAGE REMOVAL SCHEDULE SEE SHEET NO. 183

REMOVAL DRAINAGE LEGEND	
	LINEAR ITEM REMOVAL
	ITEM REMOVAL
	STRUCTURE TO BE ADJUSTED
	PIPE TO BE REMOVED



USER NAME = 35361	DESIGNED SS	REVISED -
	DRAWN SS	REVISED
PLOT SCALE = 50.0000' / in.	CHECKED DW	REVISED
PLOT DATE = 9/18/2017	DATE 02/02/2017	REVISED


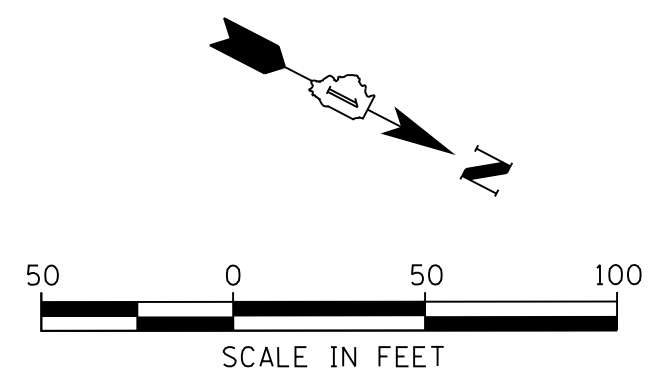
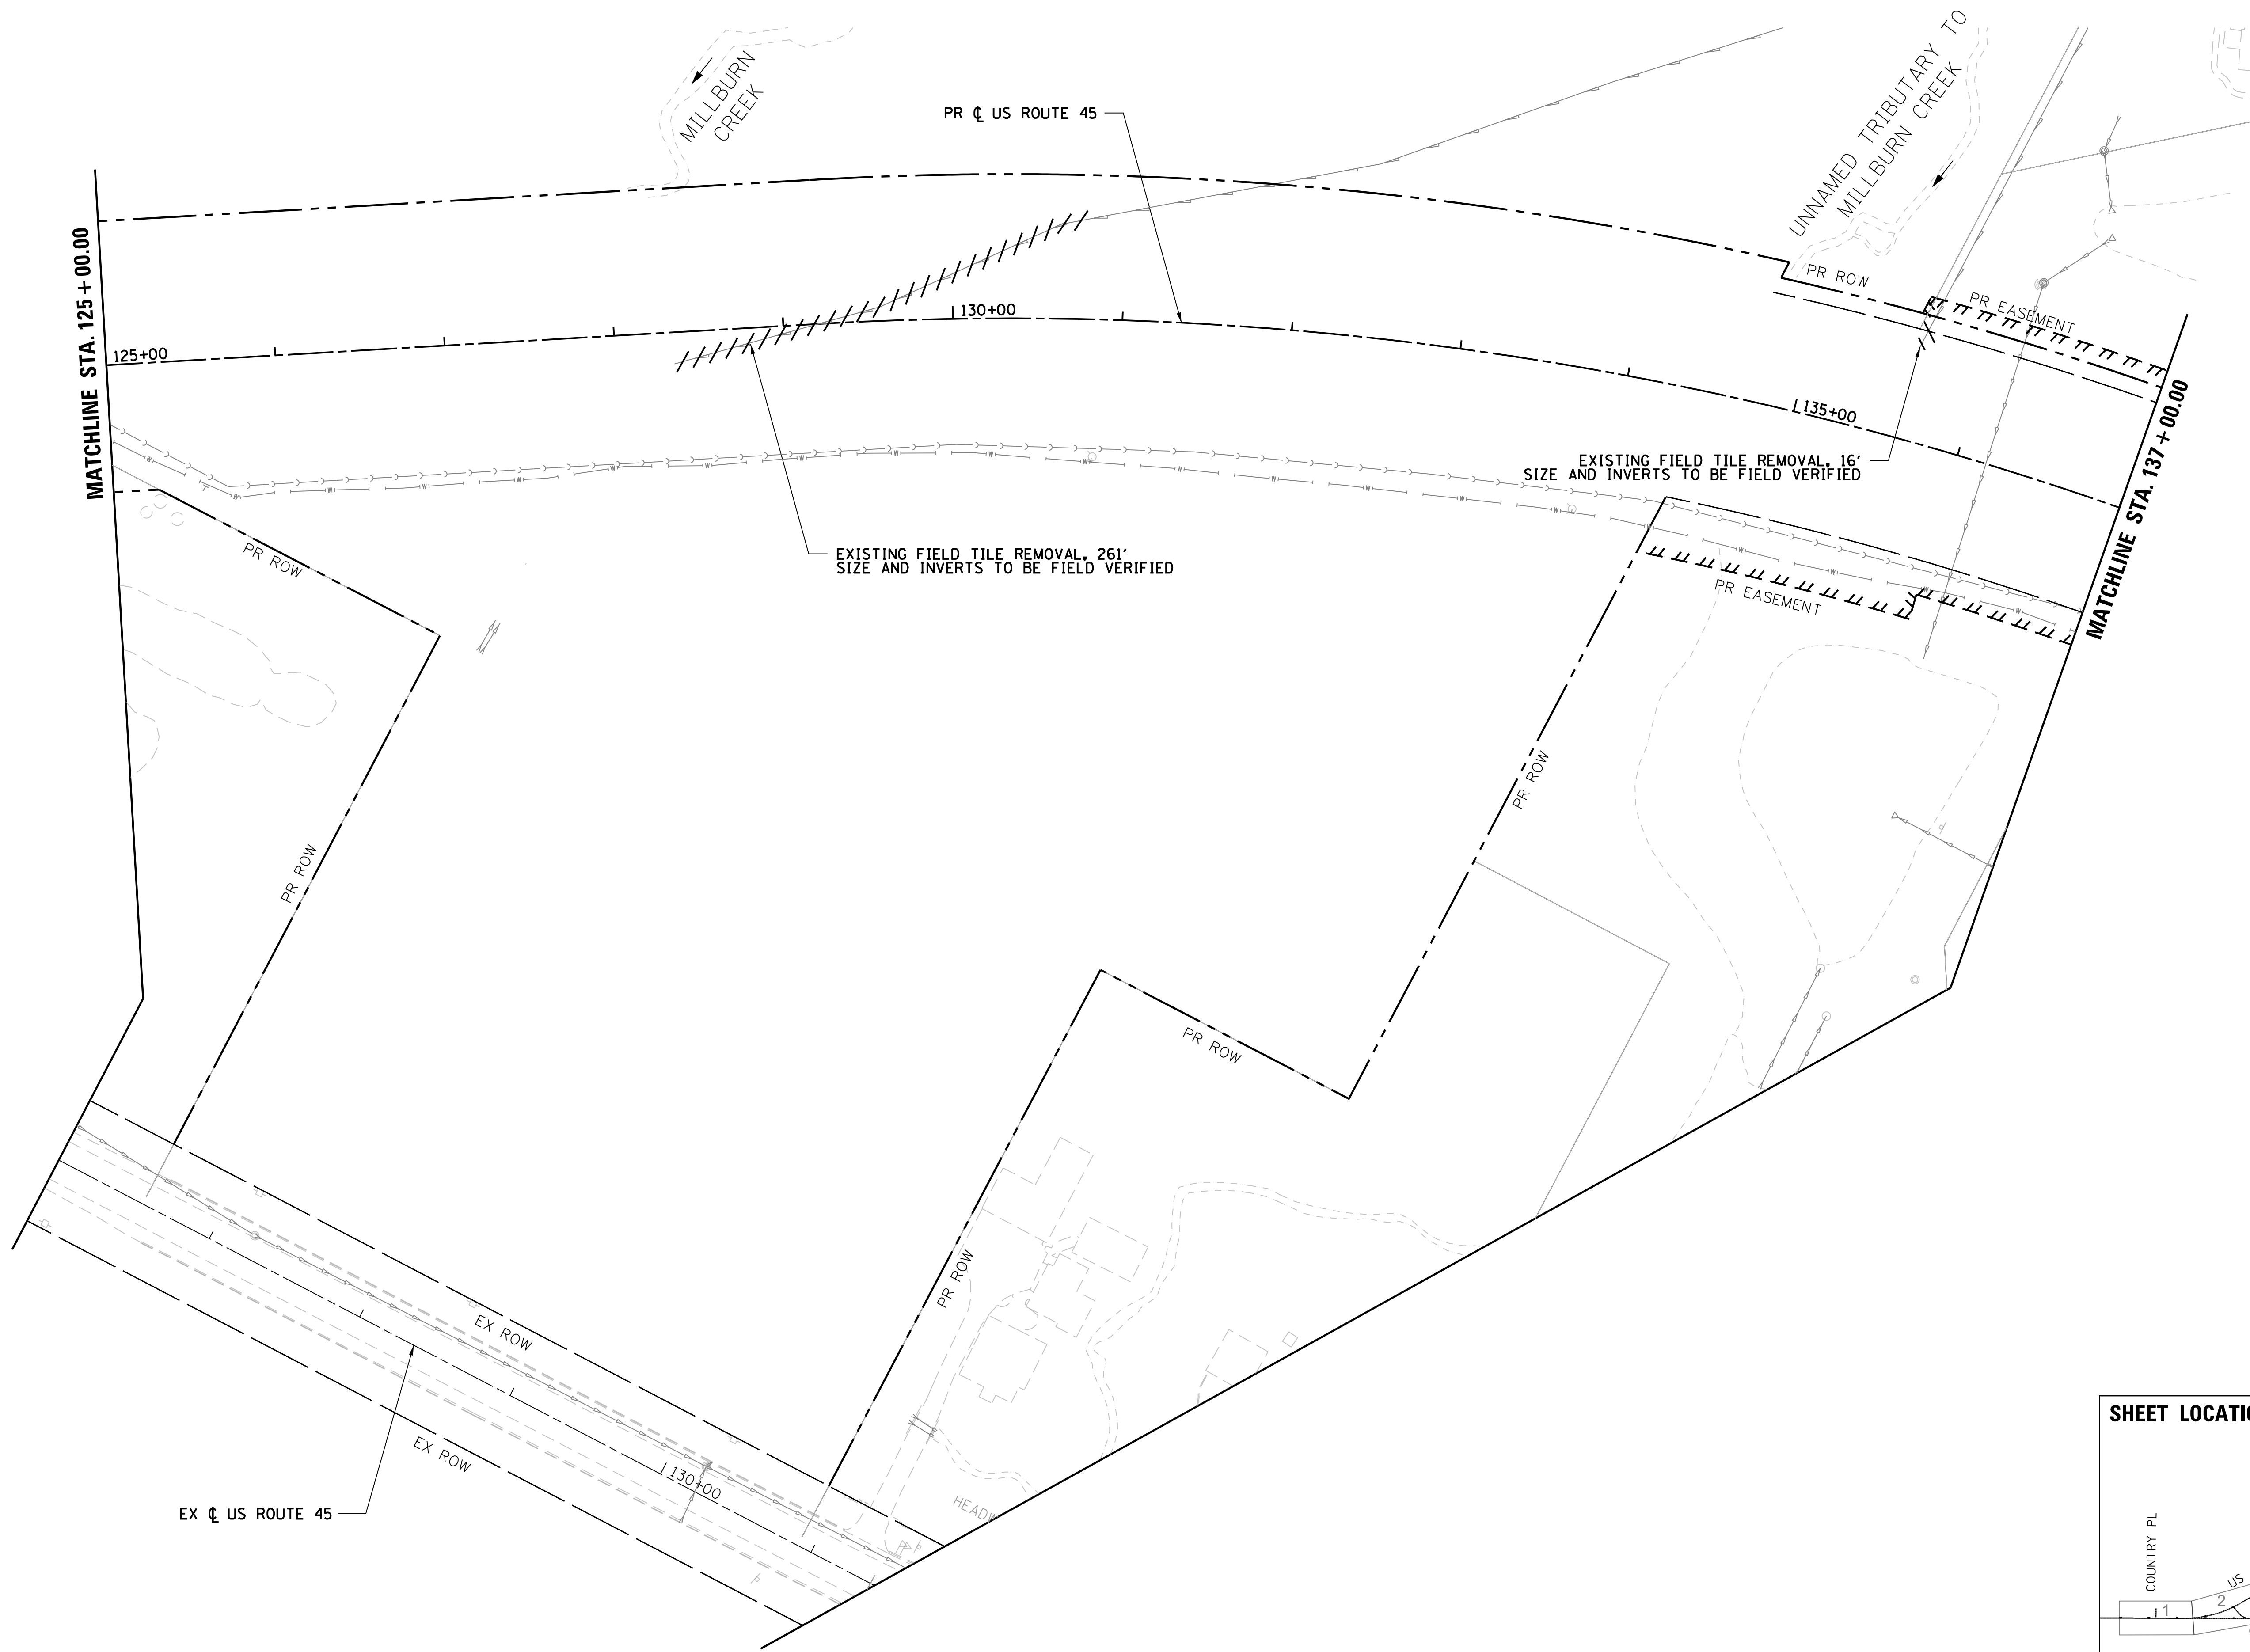
**STATE OF ILLINOIS
DEPARTMENT OF TRANSPORTATION**

**DRAINAGE REMOVAL PLAN
US ROUTE 45**
SCALE: 1"=50' SHEET 3 OF 10 SHEETS STA. 125+00 TO STA. 137+00

F.A.P. RTE.	SECTION	COUNTY	TOTAL SHEETS	SHEET NO.
344	39 R	LAKE	510	158
CONTRACT NO. 60T75				
ILLINOIS FED. AID PROJECT				

DRAINAGE SYMBOLS

EXISTING	PROPOSED	
		STORM SEWER LINE
		UNDERDRAIN LINE
		STORM SEWER MANHOLE
		CATCH BASIN
		INLET
		STORM SEWER END SECTION
		ROADWAY DITCH FLOW
		PROPOSED STORM SEWER PIPE NUMBER
		PROPOSED PIPE UNDERDRAINS NUMBER
		PROPOSED DRAINAGE STRUCTURE NUMBER

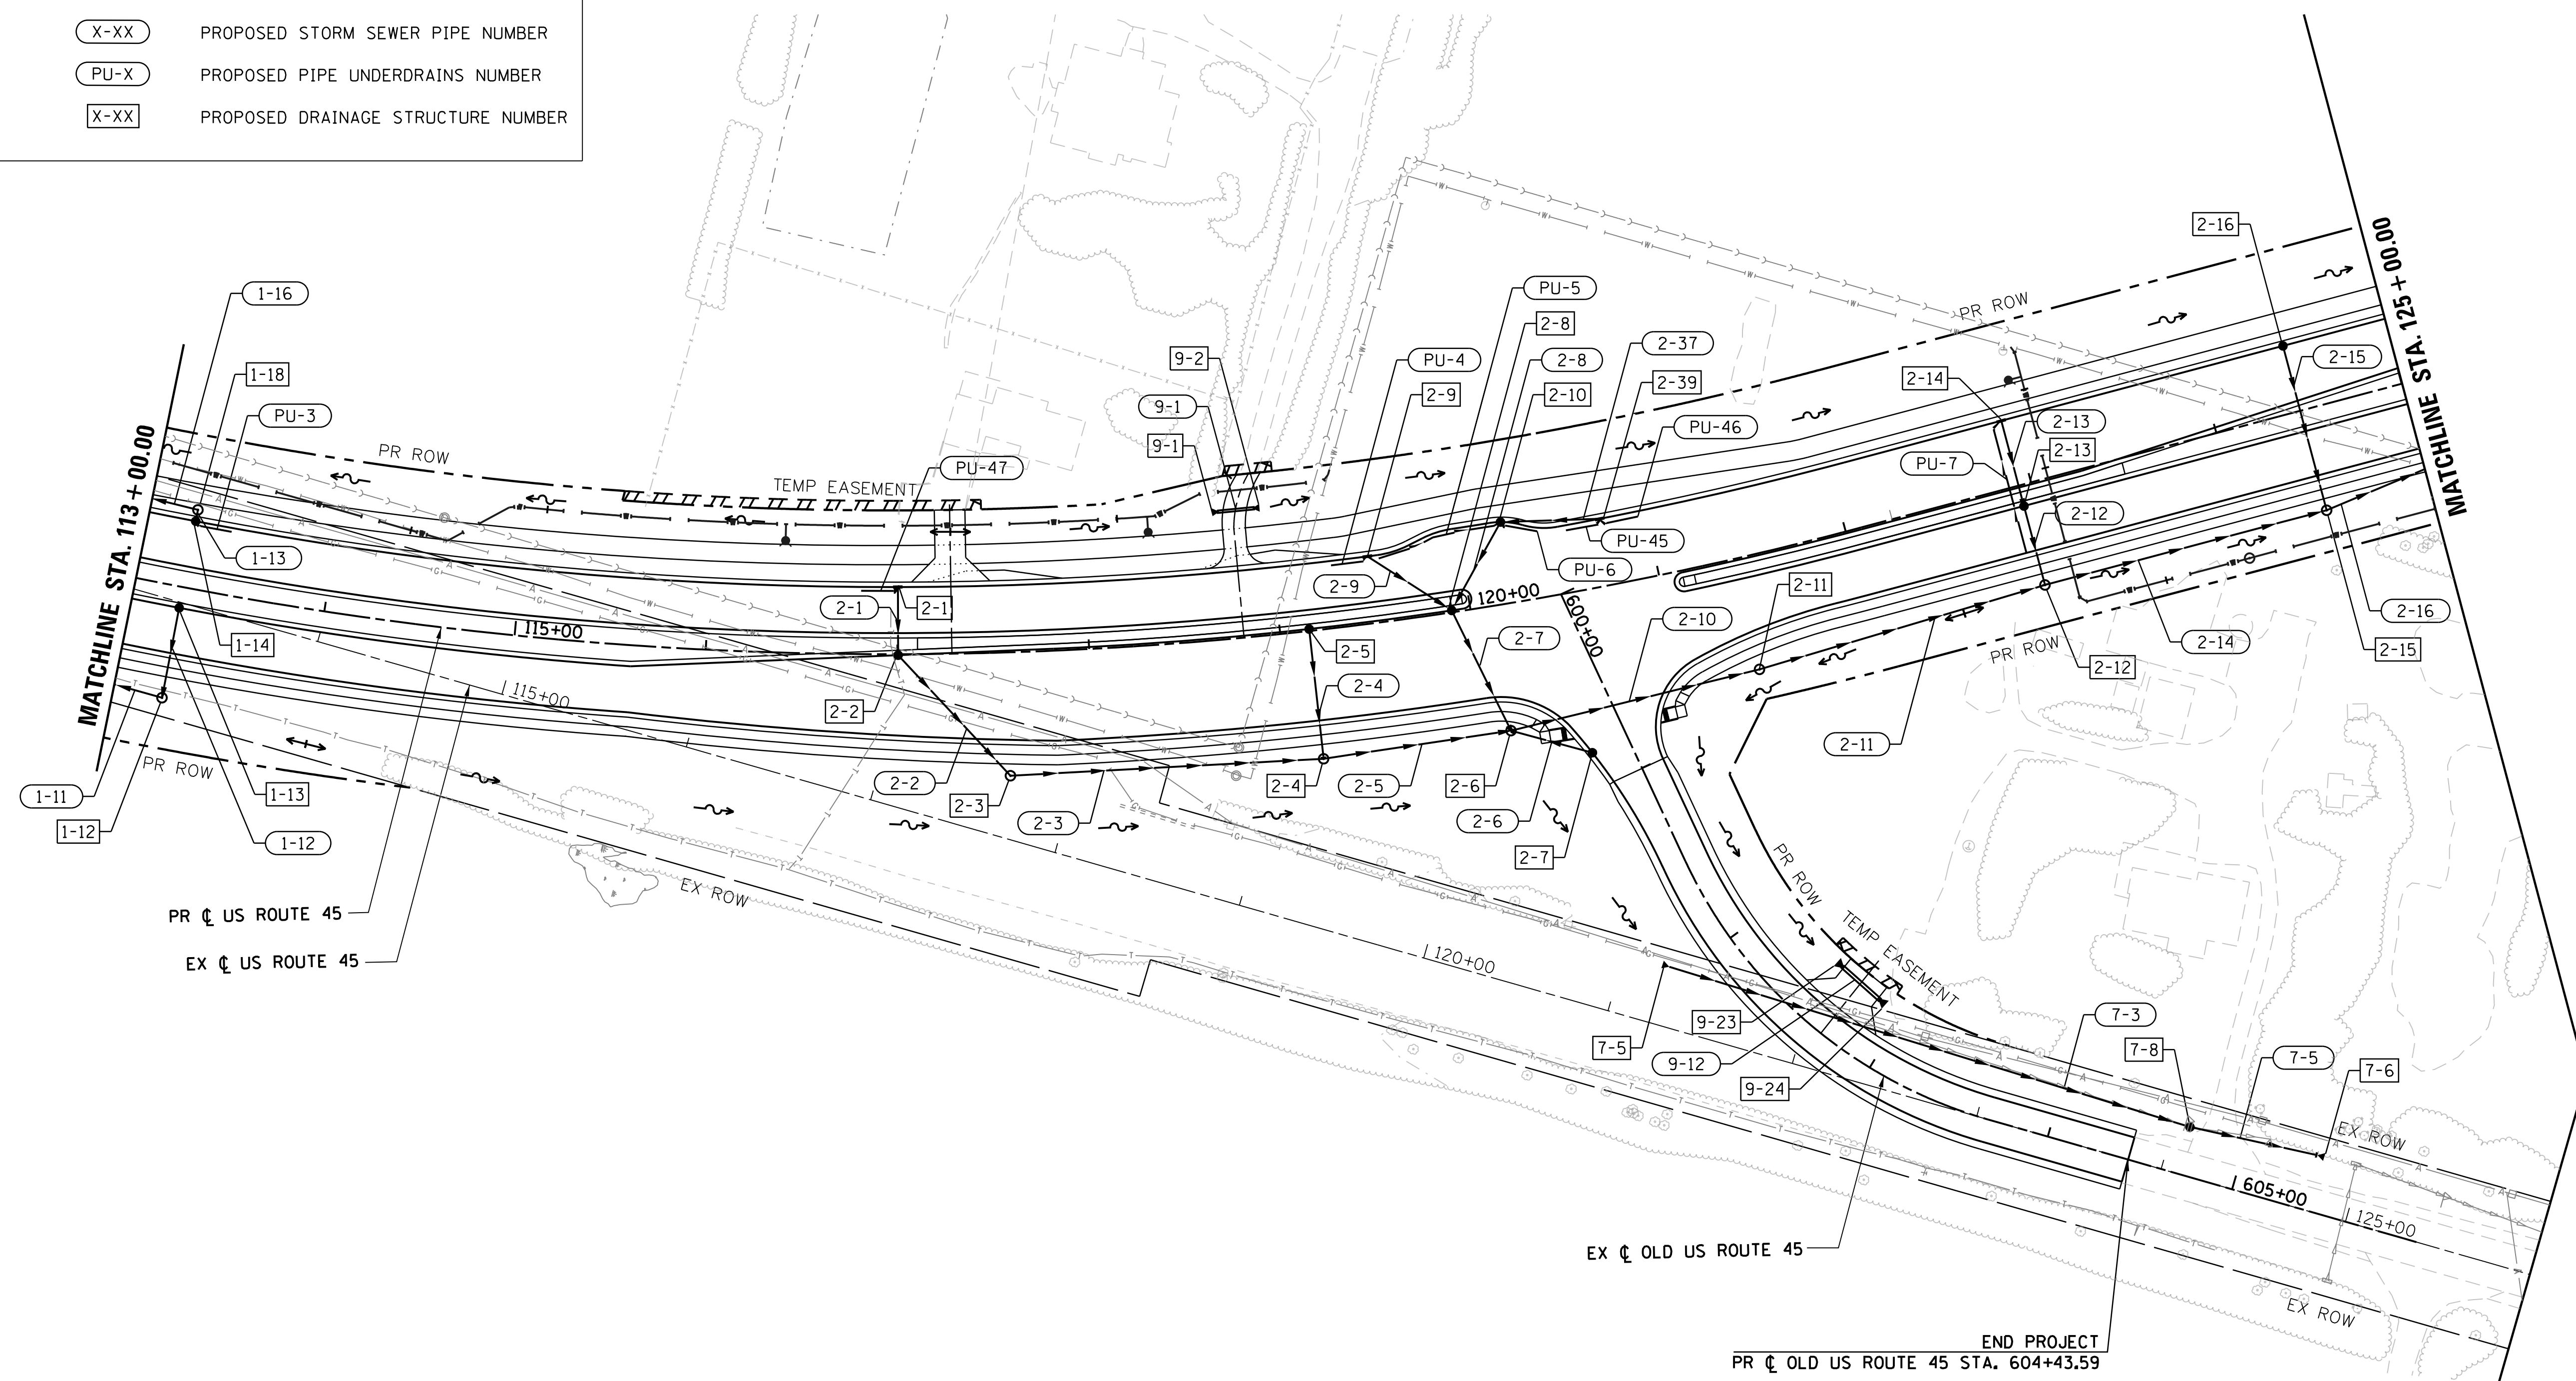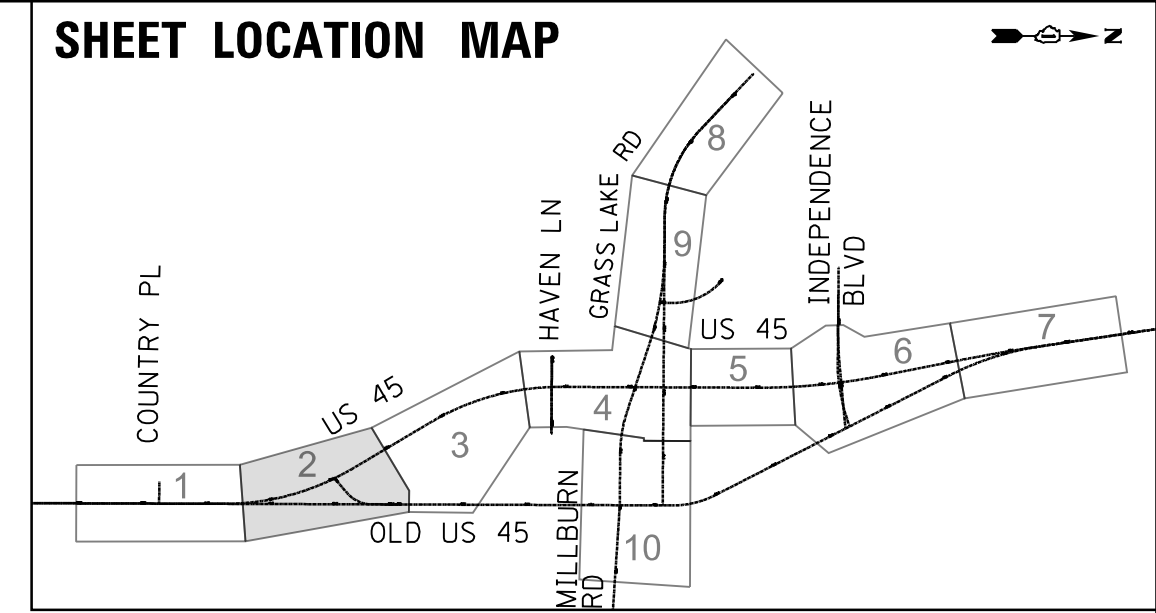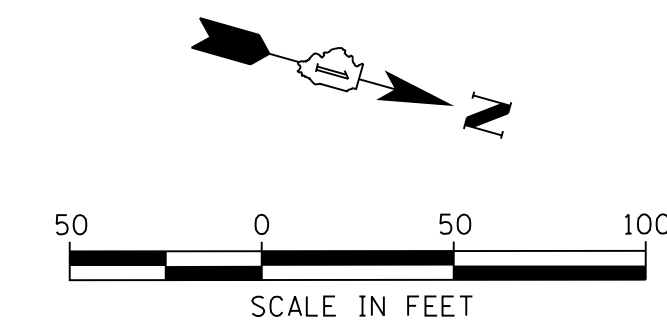

PLAN	SURVEYED	DATE
NOTE BOOK	PLOTTED	
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	FILE NAME	

PROFILE	SURVEYED	DATE
NOTE BOOK	GRADES CHECKED	
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PLOT SCALE = 50.0000' / in.	DRAWN DW	REVISED
PLOT DATE = 9/18/2017	CHECKED SS	REVISED
	DATE 02/02/2017	REVISED

**STATE OF ILLINOIS
DEPARTMENT OF TRANSPORTATION**



PROPOSED DRAINAGE PLAN US ROUTE 45			
SCALE: 1"=50'	SHEET 2	OF 10 SHEETS	STA. 113+00 TO STA. 125+00

F.A.P. RTE. 344	SECTION 39 R	COUNTY LAKE	TOTAL SHEETS 510	SHEET NO. 167
CONTRACT NO. 60T75				ILLINOIS FED. AID PROJECT

PLAN	SURVEYED	BY	DATE
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	ALIGNED		
	FILED		
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PROFILE	SURVEYED	BY	DATE
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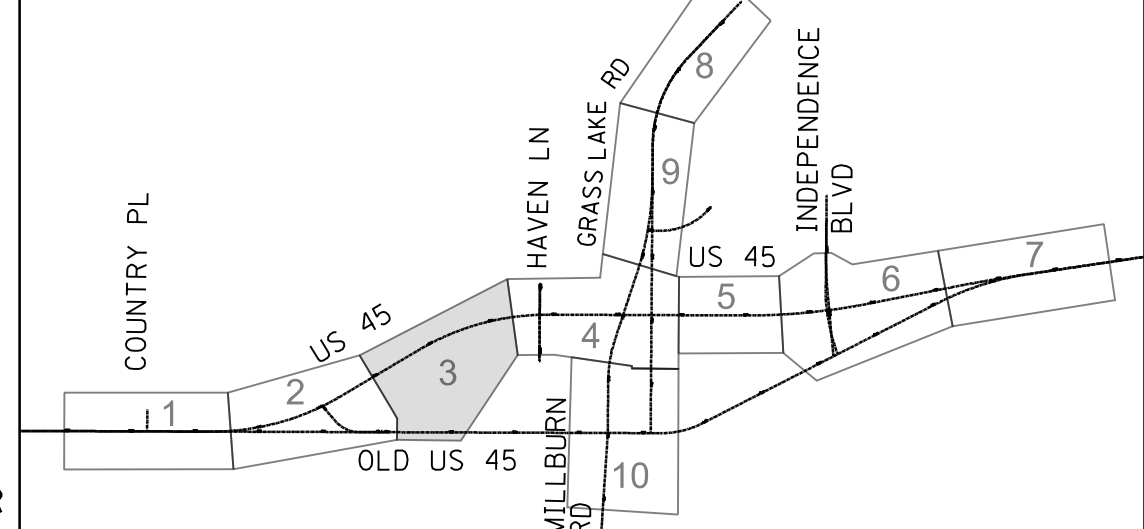
DRAINAGE SYMBOLS

EXISTING	PROPOSED	
		STORM SEWER LINE
		UNDERDRAIN LINE
		STORM SEWER MANHOLE
		CATCH BASIN
		INLET
		STORM SEWER END SECTION
		ROADWAY DITCH FLOW
		PROPOSED STORM SEWER PIPE NUMBER
		PROPOSED PIPE UNDERDRAINS NUMBER
		PROPOSED DRAINAGE STRUCTURE NUMBER

NOTE:

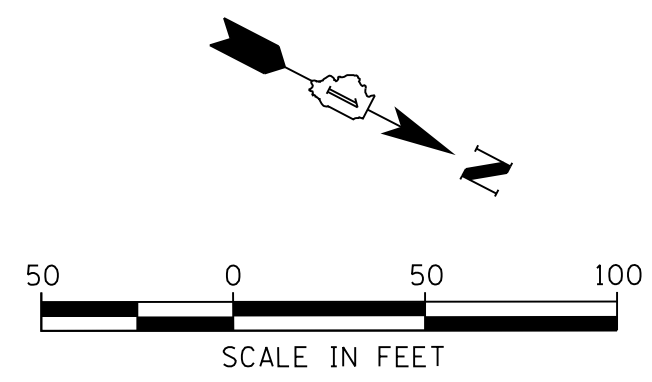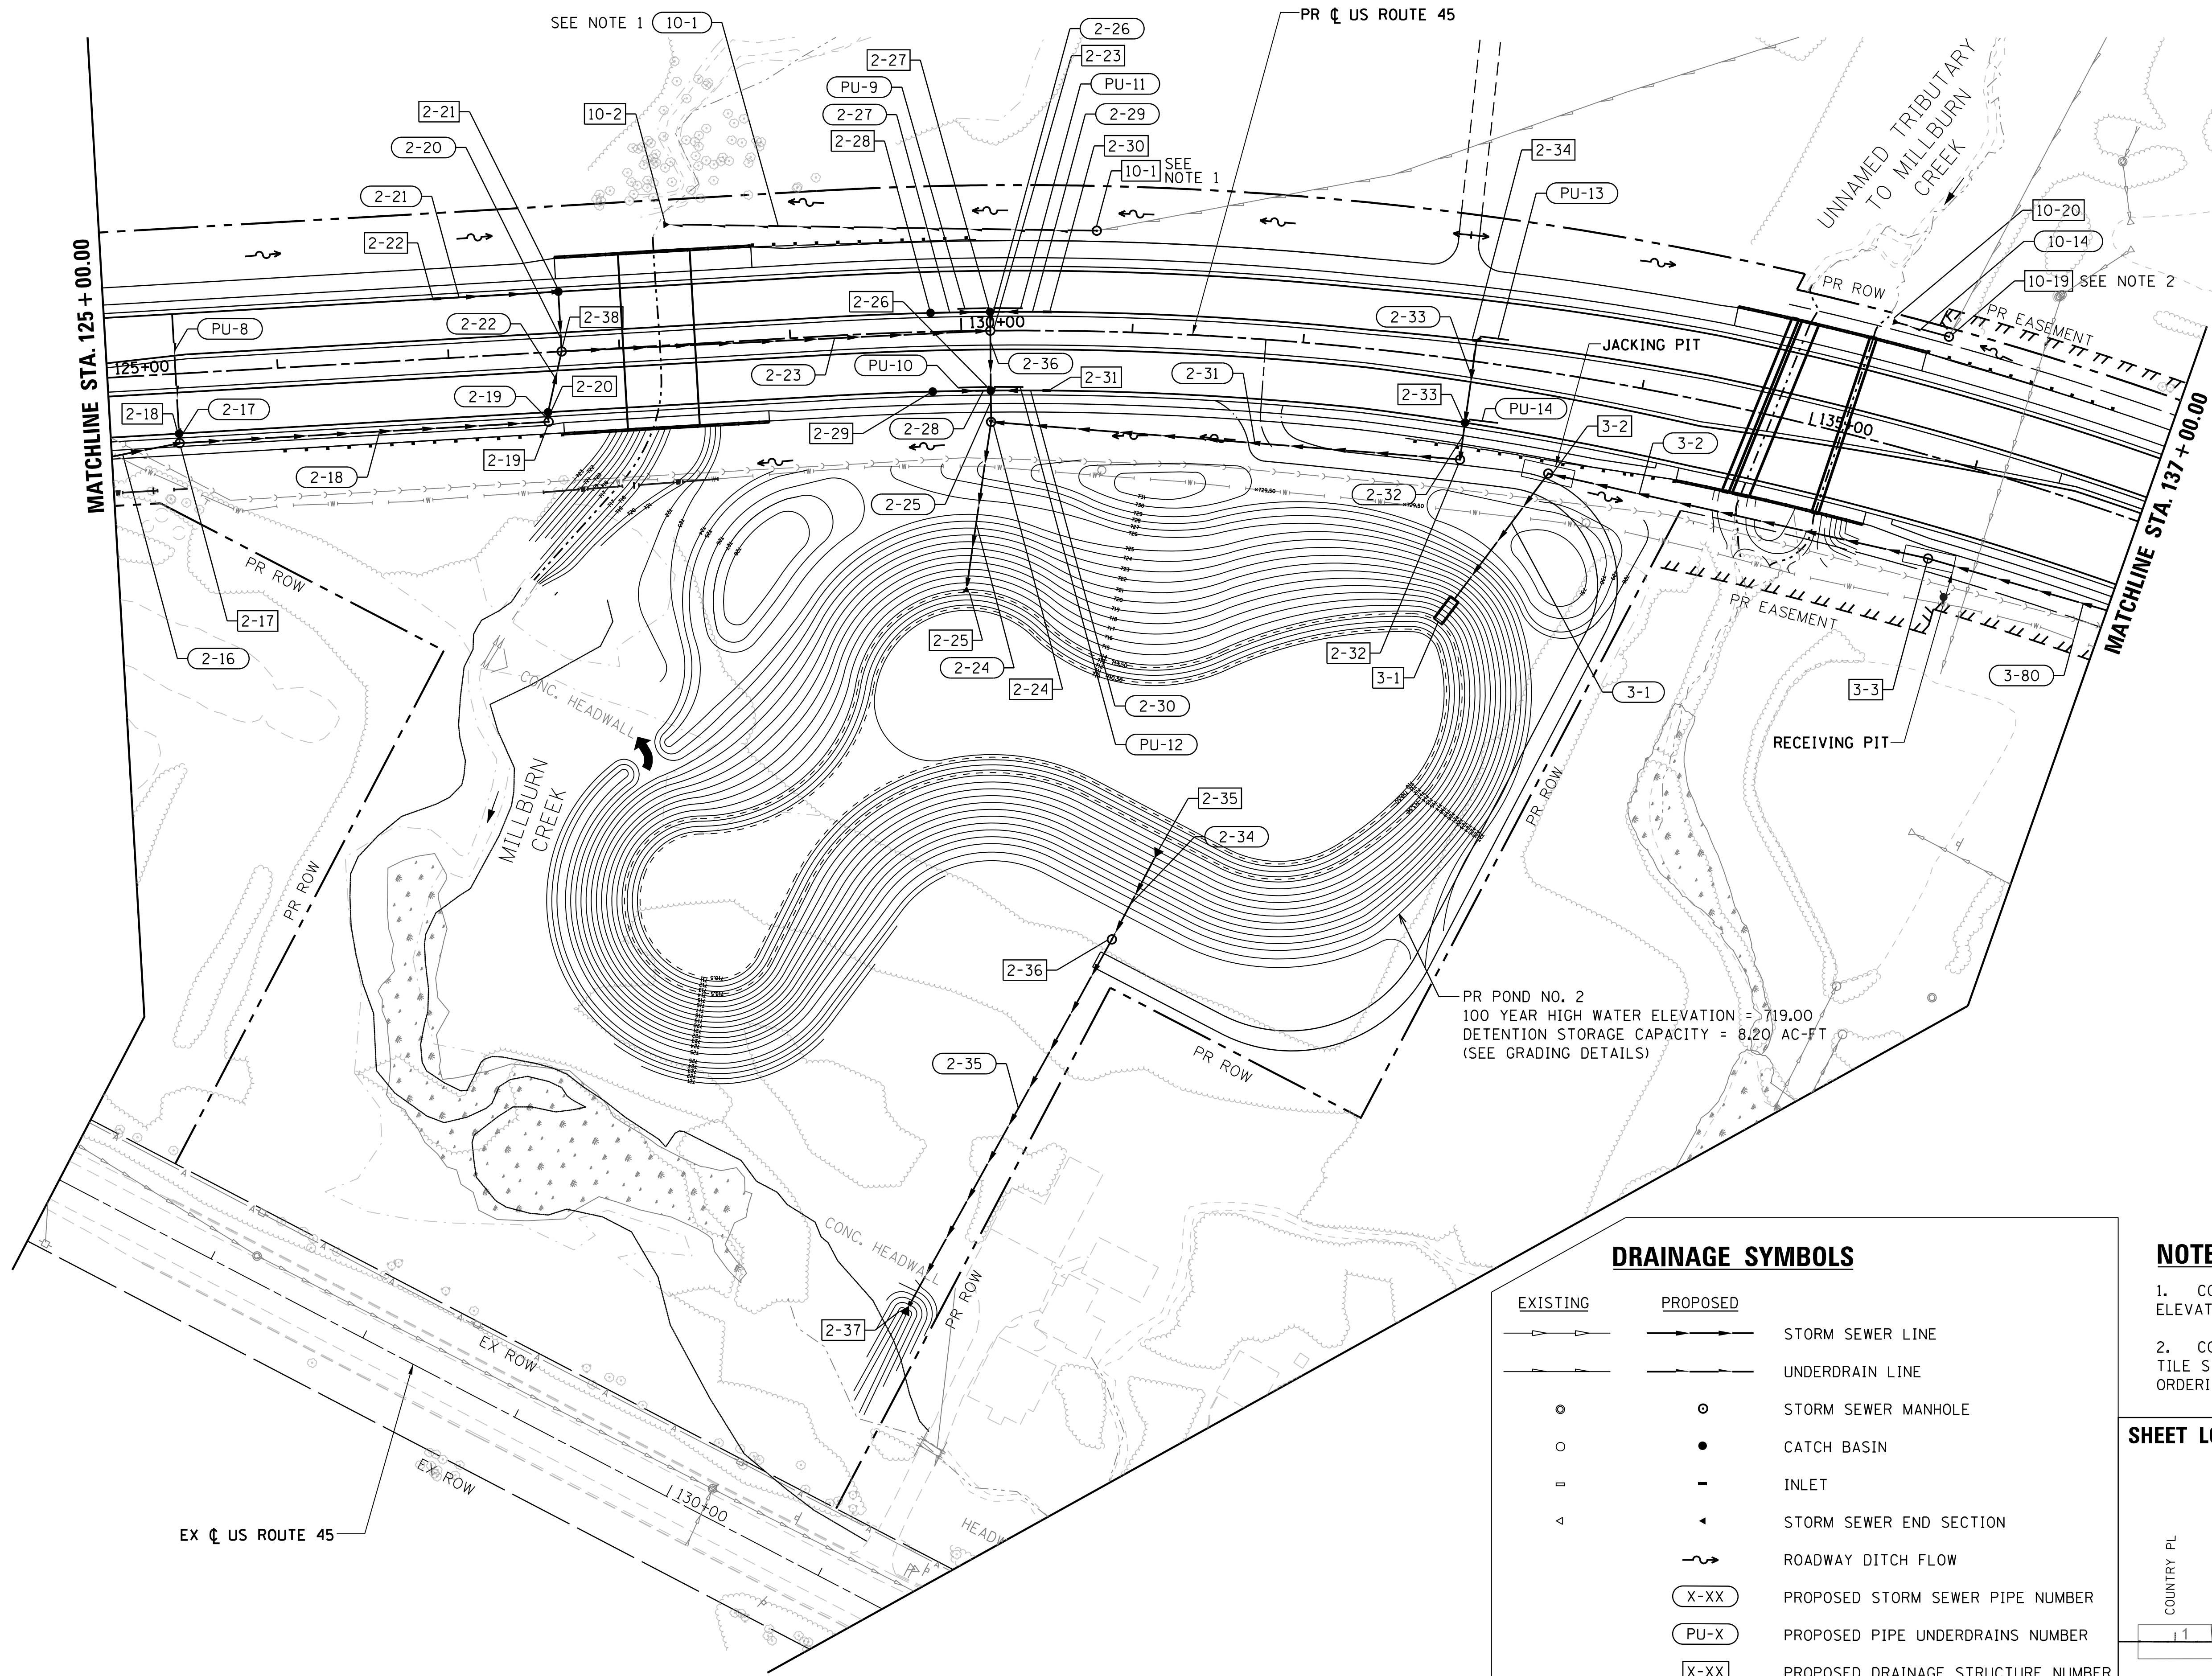- CONTRACTOR TO VERIFY EXISTING INVERT ELEVATION BEFORE ORDERING STRUCTURE 10-1.
- CONTRACTOR TO VERIFY EXISTING FIELD TILE SIZE AND INVERT ELEVATION BEFORE ORDERING STRUCTURE 10-19.

SHEET LOCATION MAP



USER NAME = 35361	DESIGNED DW	REVISED -
	DRAWN DW	REVISED
PLOT SCALE = 50.0000' / 1"	CHECKED SS	REVISED
PLOT DATE = 9/18/2017	DATE 02/02/2017	REVISED

**STATE OF ILLINOIS
DEPARTMENT OF TRANSPORTATION**

**PROPOSED DRAINAGE PLAN
US ROUTE 45**




SCALE: 1"=50' SHEET 3 OF 10 SHEETS STA. 125+00 TO STA. 137+00

F.A.P. RTE. 344	SECTION 39 R	COUNTY LAKE	TOTAL SHEETS 510	SHEET NO. 168
			CONTRACT NO. 60T75	
ILLINOIS FED. AID PROJECT				

PLAN	SURVEYED	BY	DATE
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CONSTRUCT TEMPORARY SWALE TO MAINTAIN DRAINAGE DURING MOT STAGES 2 AND 3 UNTIL DETENTION BASIN HAS BEEN CONSTRUCTED. SWALE TO HAVE 2' WIDE DITCH BOTTOM AND 1:3 SIDE SLOPES. PAID FOR AS GRADING AND SHAPING DITCHES.

DRAINAGE SYMBOLS	
EXISTING	PROPOSED

USER NAME = 35361	DESIGNED DW	REVISED -
	DRAWN DW	REVISED
PLOT SCALE = 50.0000' / in.	CHECKED SS	REVISED
PLOT DATE = 9/18/2017	DATE 02/02/2017	REVISED

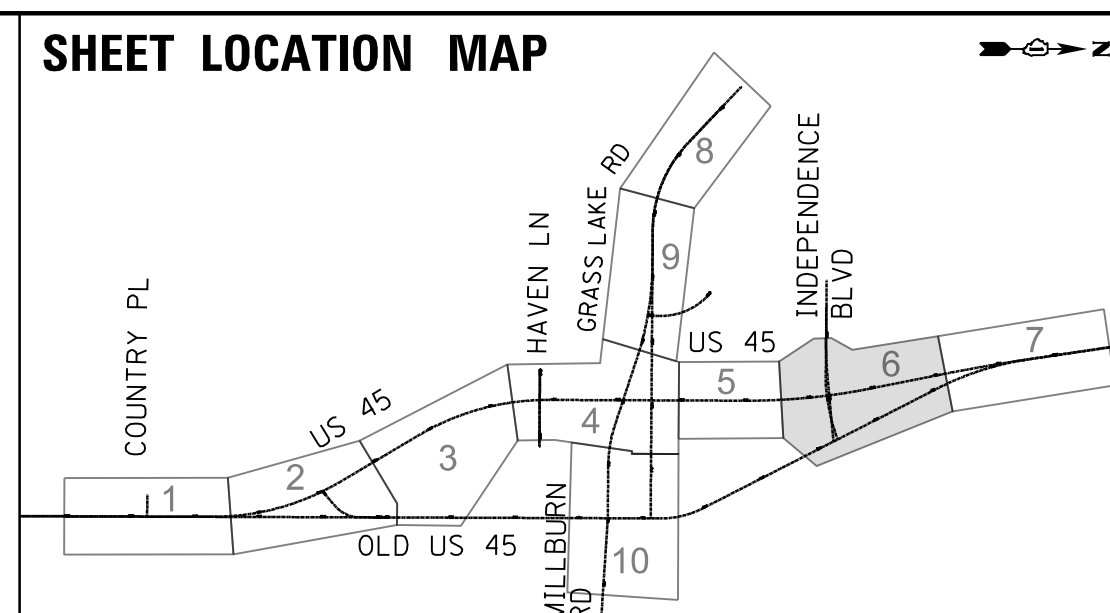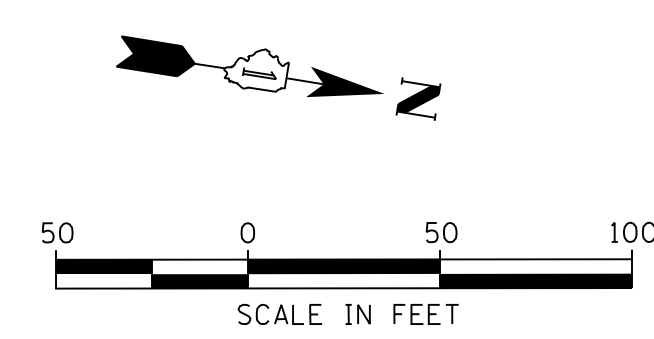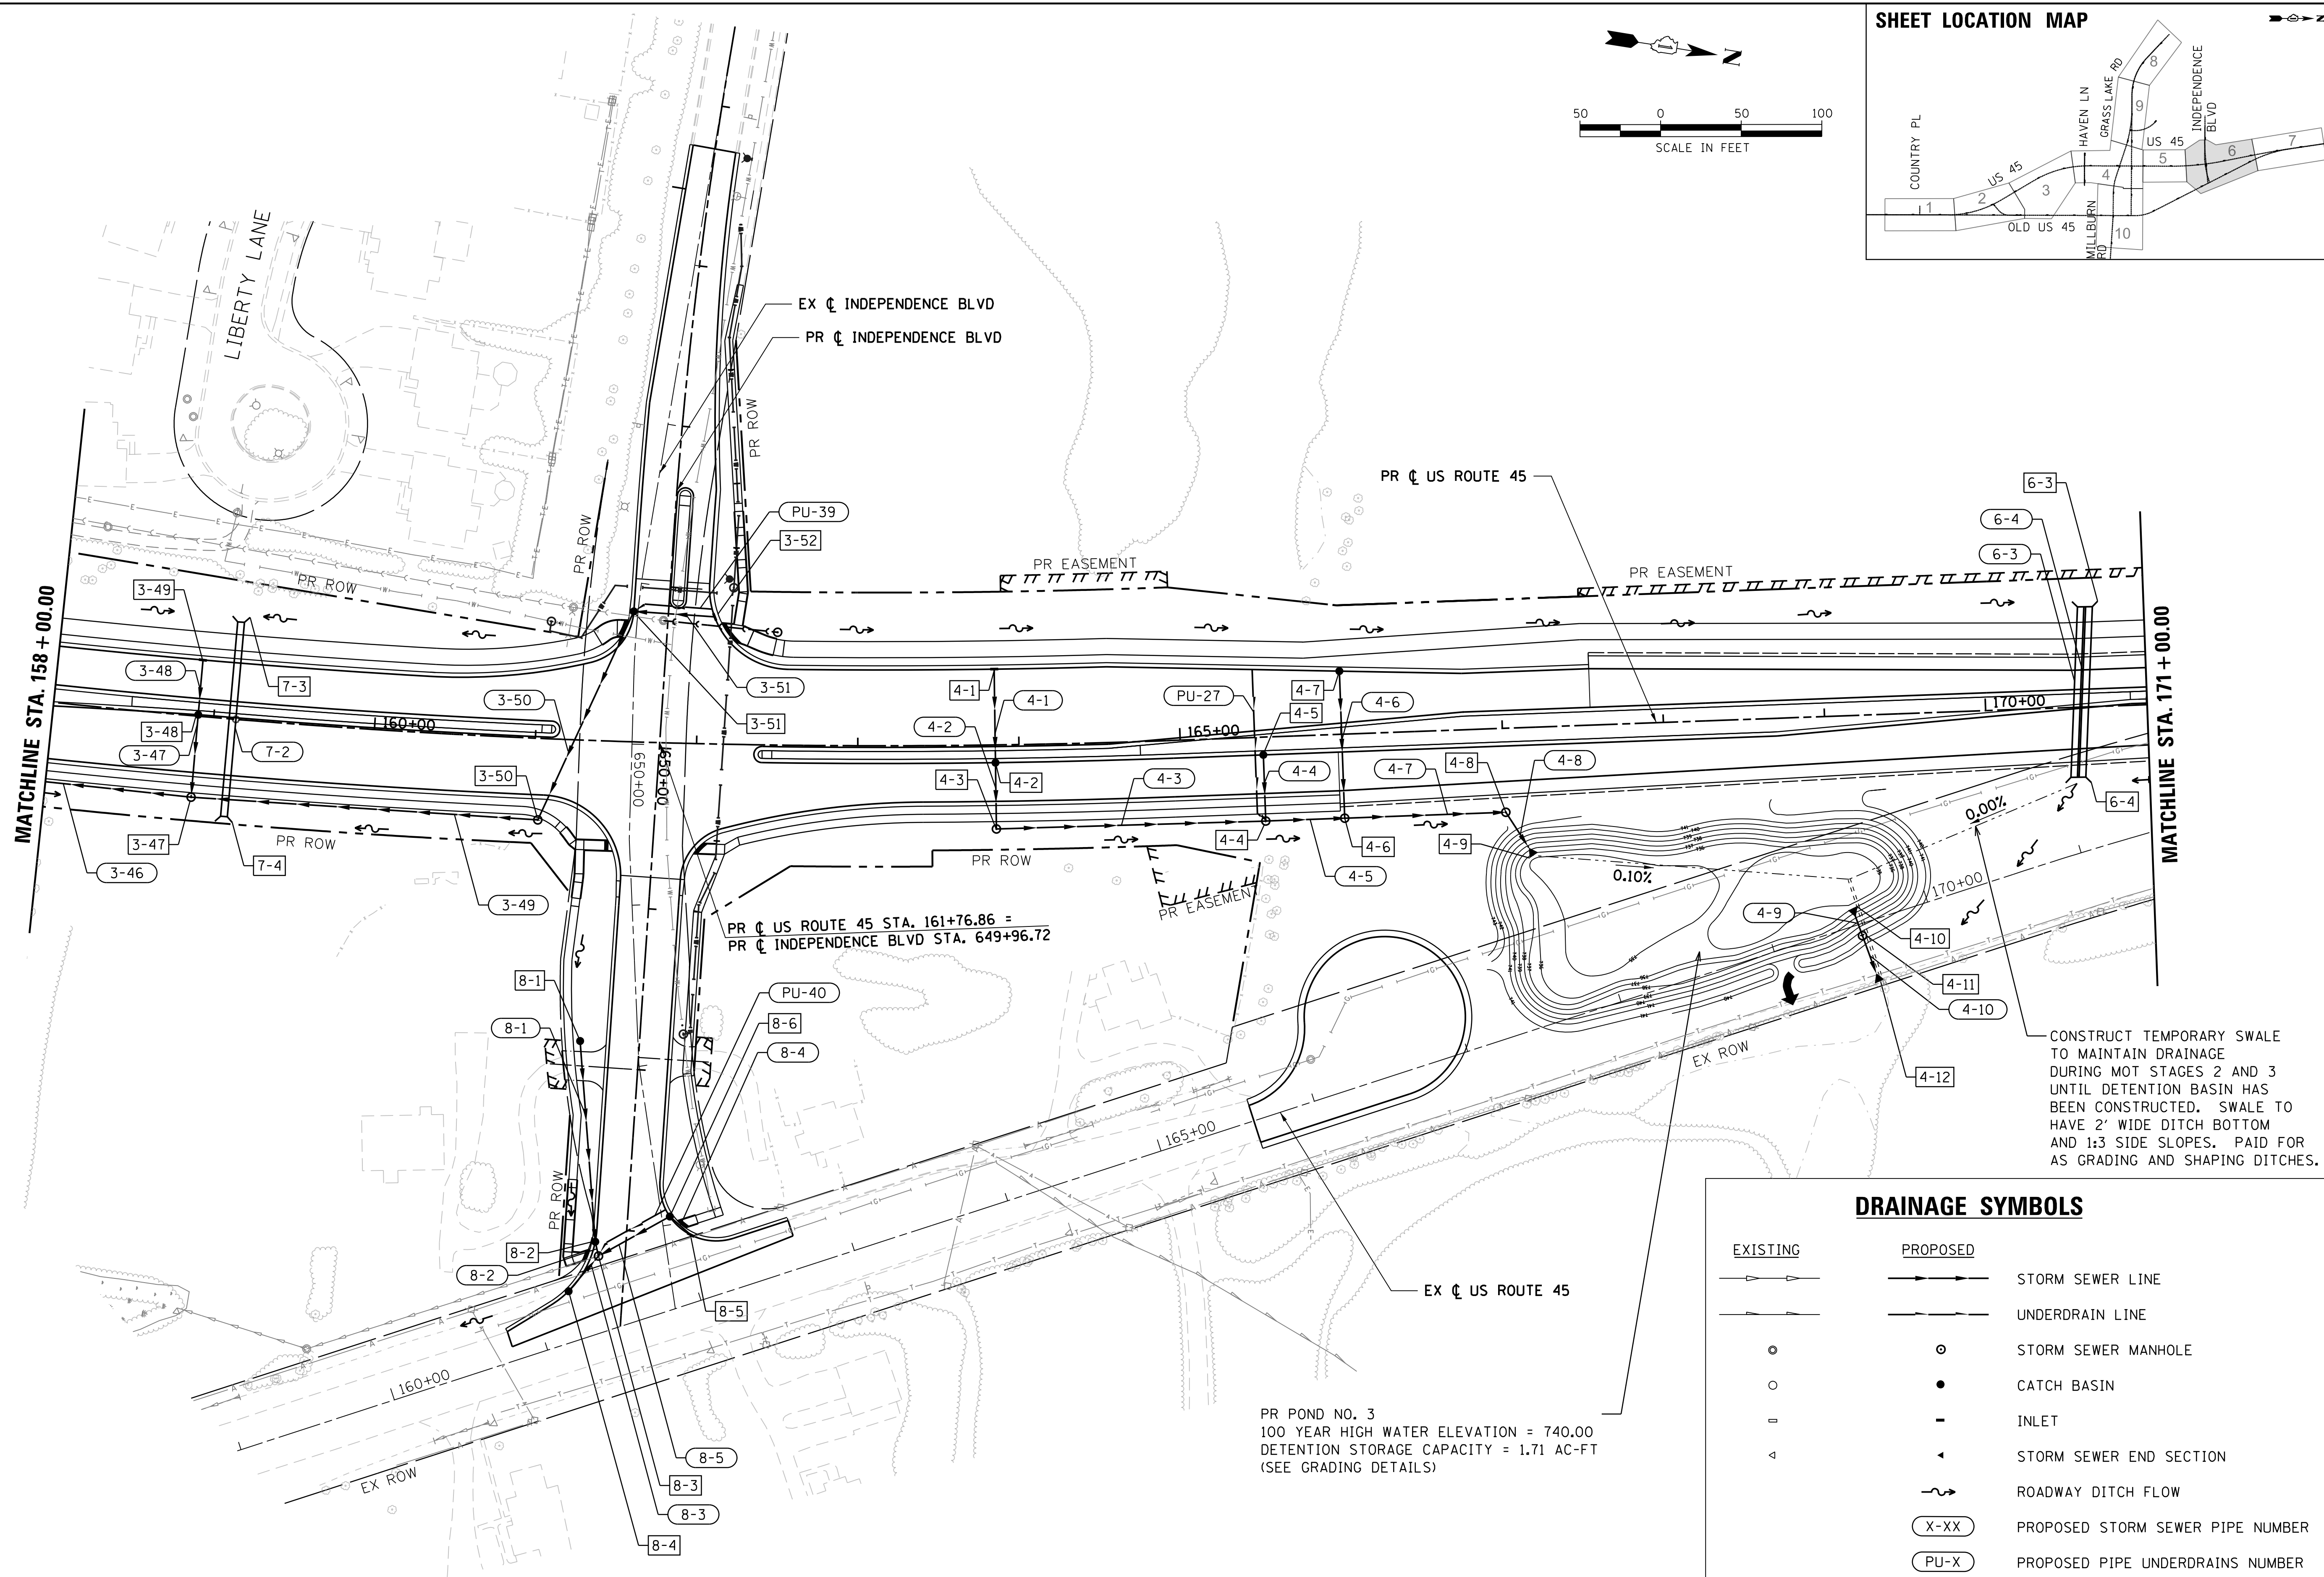STATE OF ILLINOIS
 DEPARTMENT OF TRANSPORTATION

PROPOSED DRAINAGE PLAN
 US ROUTE 45
 SCALE: 1"=50' SHEET 6 OF 10 SHEETS STA. 158+00 TO STA. 171+00

F.A.P. RTE.	SECTION	COUNTY	TOTAL SHEETS	SHEET NO.
344	39 R	LAKE	510	171
				CONTRACT NO. 60T75
ILLINOIS FED. AID PROJECT				




DRAINAGE SYMBOLS

EXISTING	PROPOSED	
		STORM SEWER LINE
		UNDERDRAIN LINE
		STORM SEWER MANHOLE
		CATCH BASIN
		INLET
		STORM SEWER END SECTION
		ROADWAY DITCH FLOW
		PROPOSED STORM SEWER PIPE NUMBER
		PROPOSED PIPE UNDERDRAINS NUMBER
		PROPOSED DRAINAGE STRUCTURE NUMBER


NOTES:

1. THE CONTRACTOR SHALL LOCATE AND DETERMINE THE EXISTING DRAIN TILE INVERT ELEVATIONS. IF A CONFLICT EXISTS, THE CONTRACTOR SHALL NOTIFY THE ENGINEER AND PROVIDE THE STATION, OFFSET AND INVERT ELEVATION OF THE EXISTING DRAIN TILE IN WRITING. MATERIALS SHALL NOT BE ORDERED FOR STORM SEWER NETWORK #3 OR DRAIN TILE NETWORK #10 WITHOUT THE ENGINEER'S APPROVAL.
2. THE CONTRACTOR TO VERIFY EXISTING INVERT ELEVATION BEFORE ORDERING STRUCTURE.

SHEET LOCATION MAP

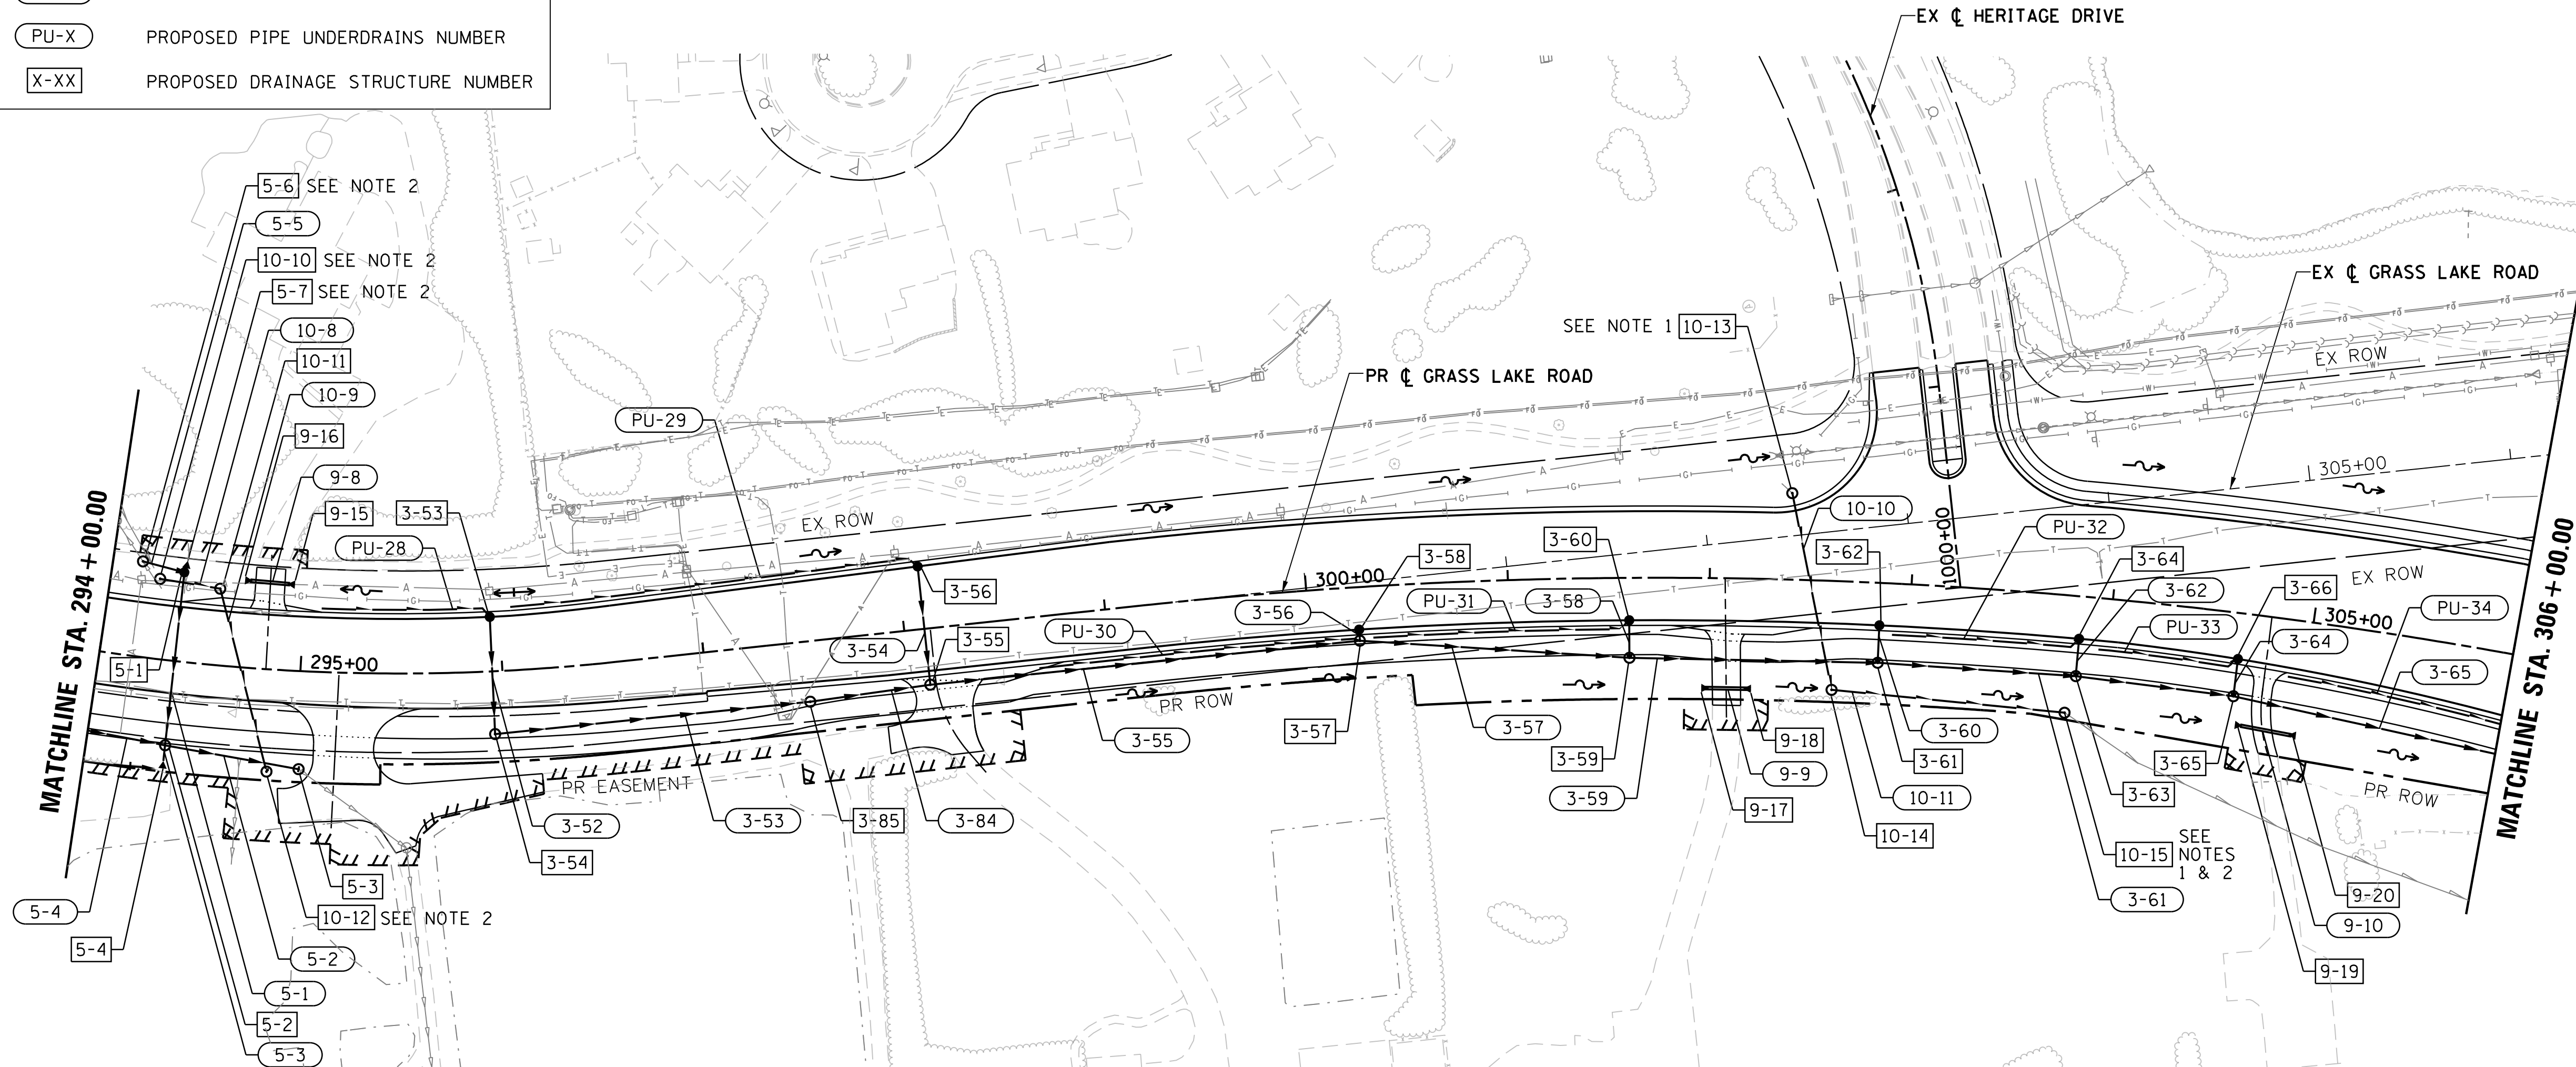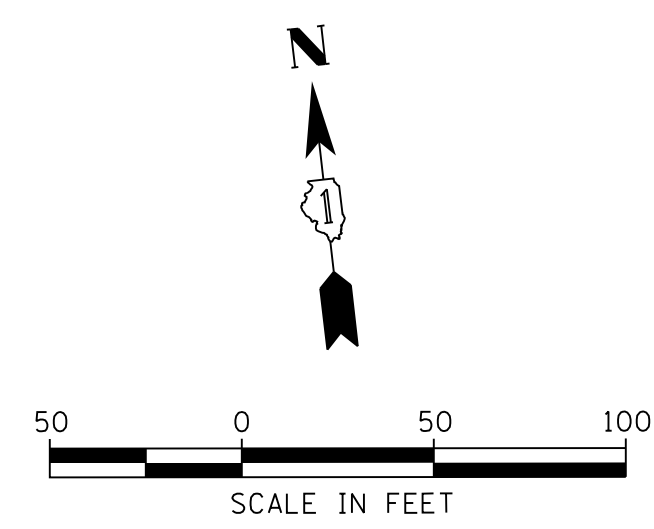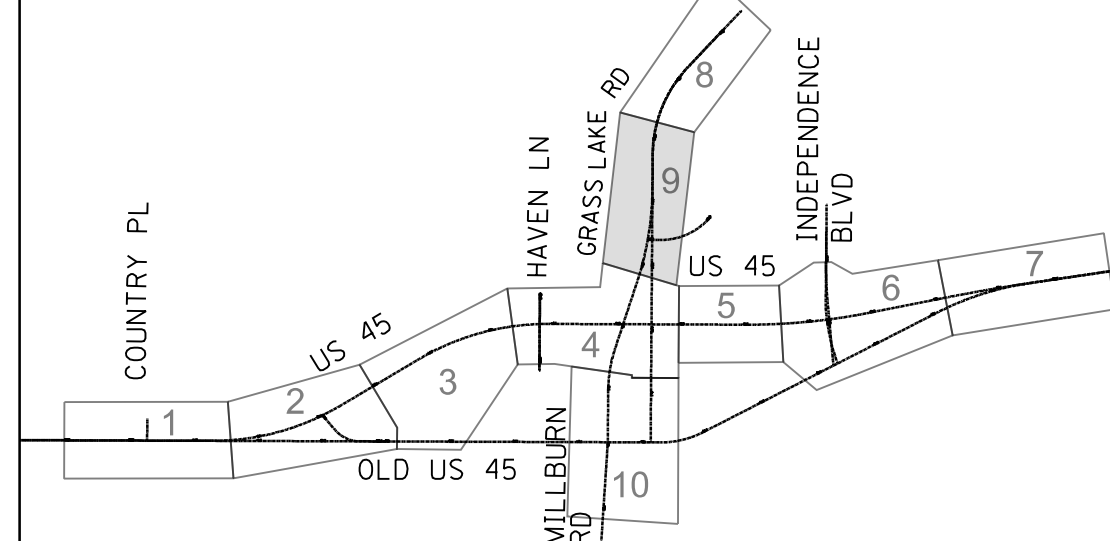

TEMPORARY DRAINAGE PLAN

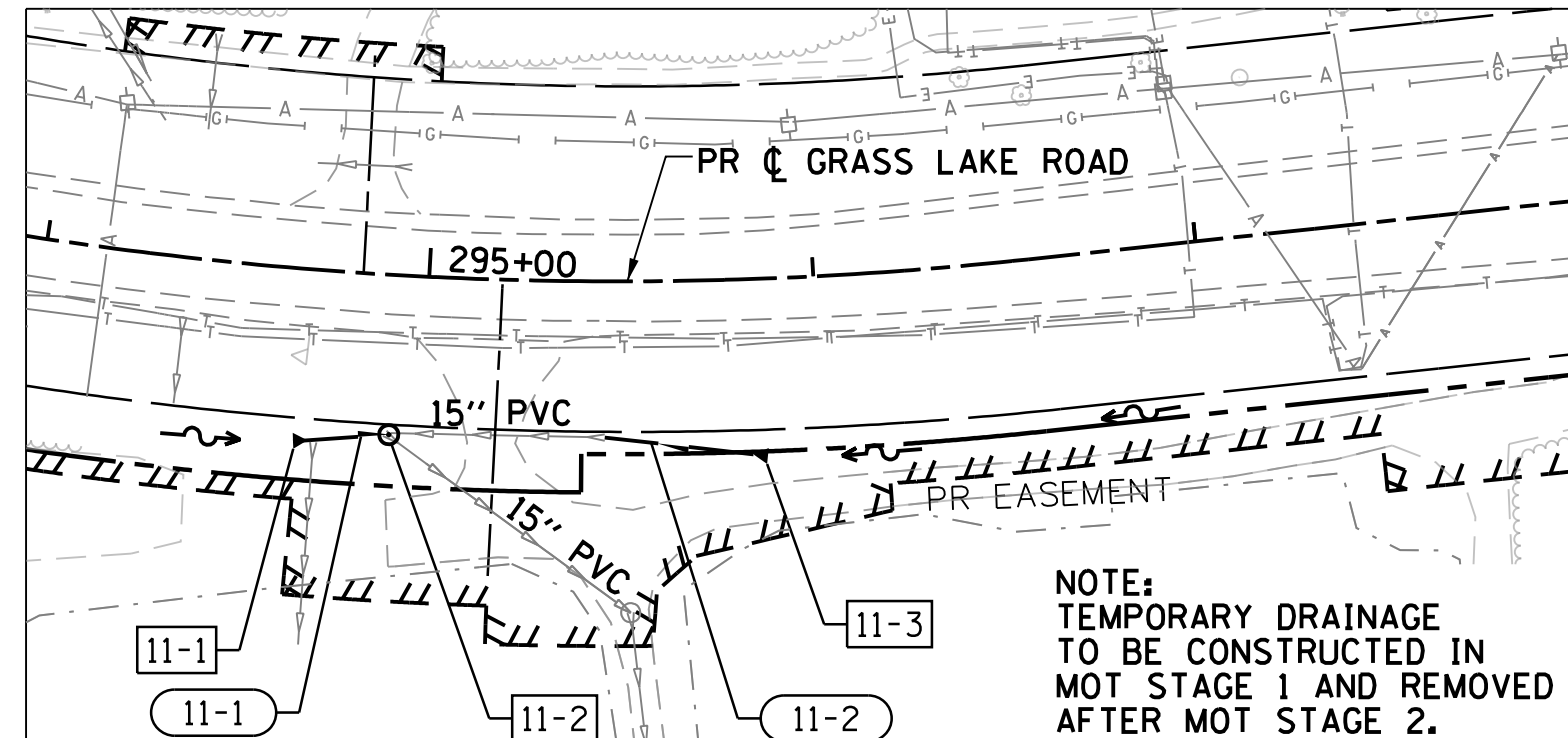

PLAN	DATE
SURVEYED	
PLOTTED	
CHECKED	
BY	
NO.	

PROFILE	DATE
SURVEYED	
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NO.	

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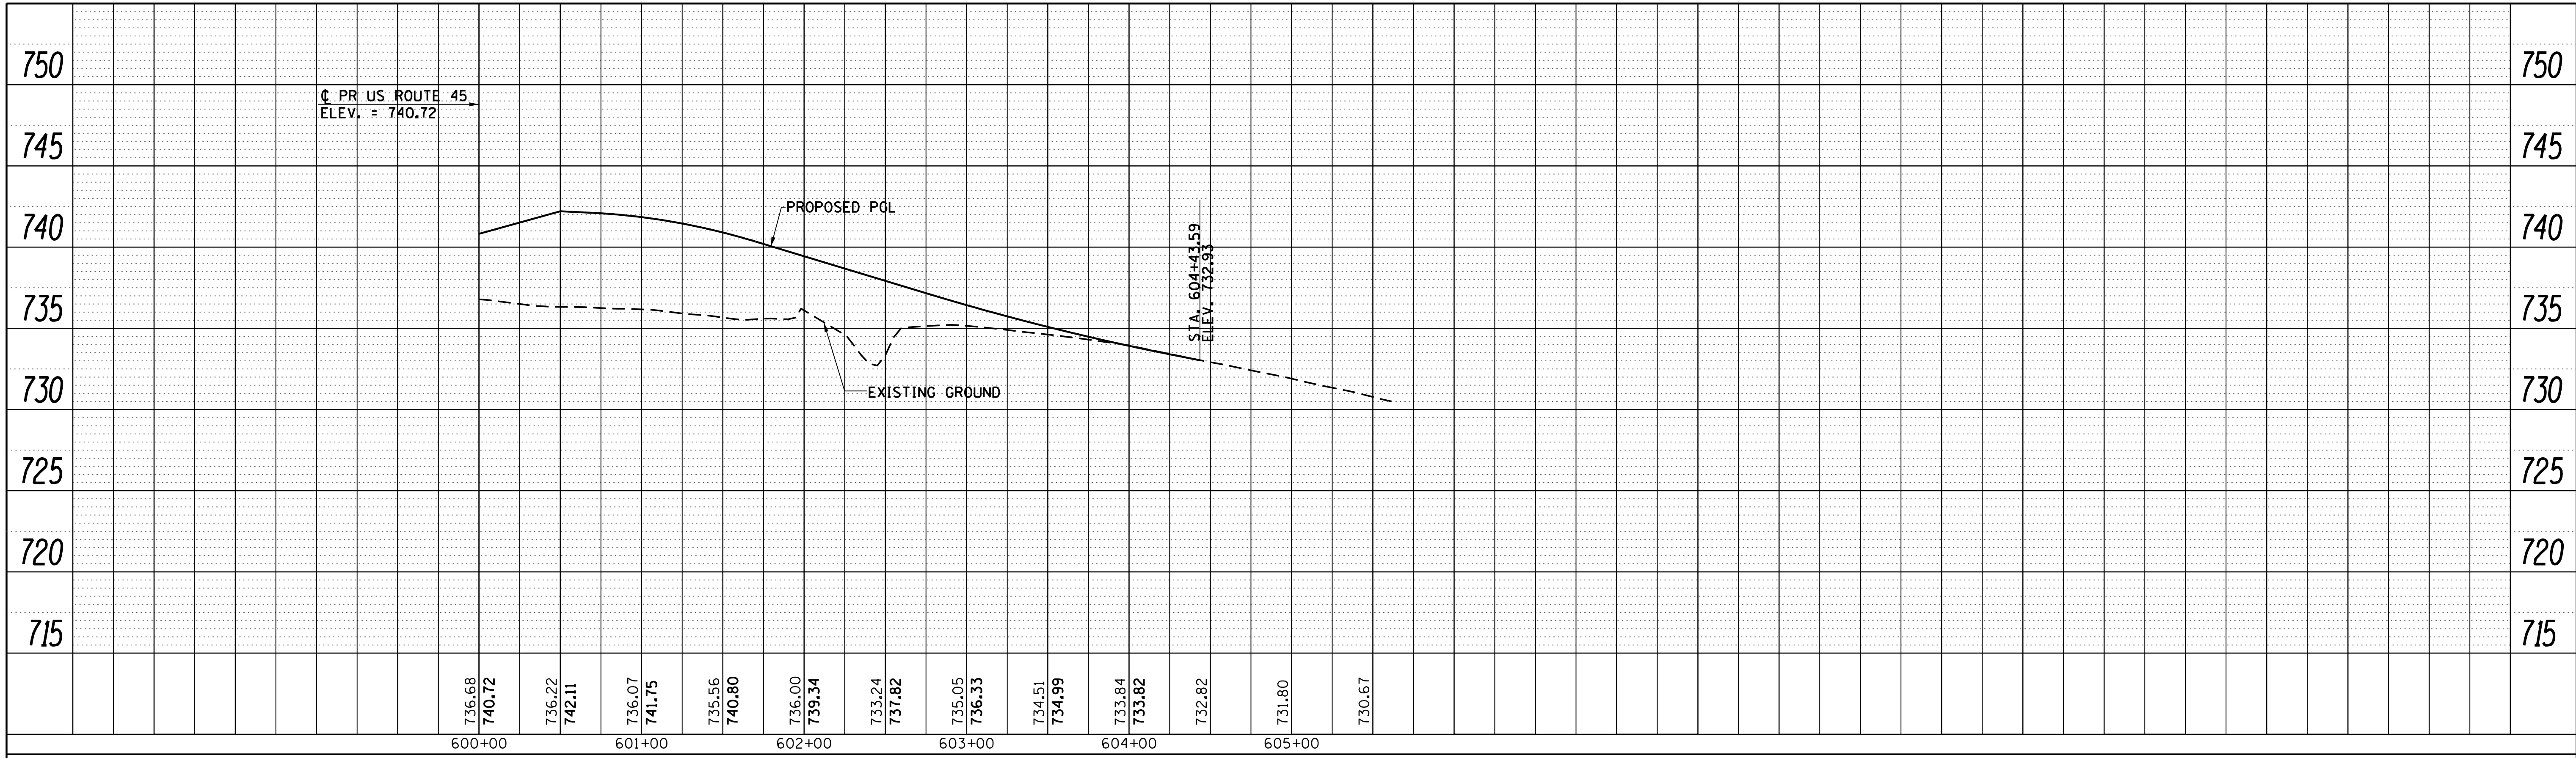
USER NAME = 35361	DESIGNED DW	REVISED -
PLOT SCALE = 50.0000' / in.	DRAWN DW	REVISED
PLOT DATE = 9/18/2017	CHECKED SS	REVISED
	DATE 02/02/2017	REVISED

**STATE OF ILLINOIS
DEPARTMENT OF TRANSPORTATION**


PROPOSED DRAINAGE PLAN GRASS LAKE ROAD			
SCALE: 1"=50'	SHEET 9	OF 10 SHEETS	STA. 294+00 TO STA. 304+00

F.A.P. RTE.	SECTION	COUNTY	TOTAL SHEETS	SHEET NO.
344	39 R	LAKE	510	174
				CONTRACT NO. 60T75
ILLINOIS FED. AID PROJECT				

PLAN	SURVEYED	BY	DATE
	PLOTTED		
	NOTE BOOK		
	NO.		
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	FILE NAME		



PROFILE	SURVEYED	BY	DATE
	PLOTTED		
	GRADES CHECKED		
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	STRUCTURE		
	NOT AT THIS OFFICE		

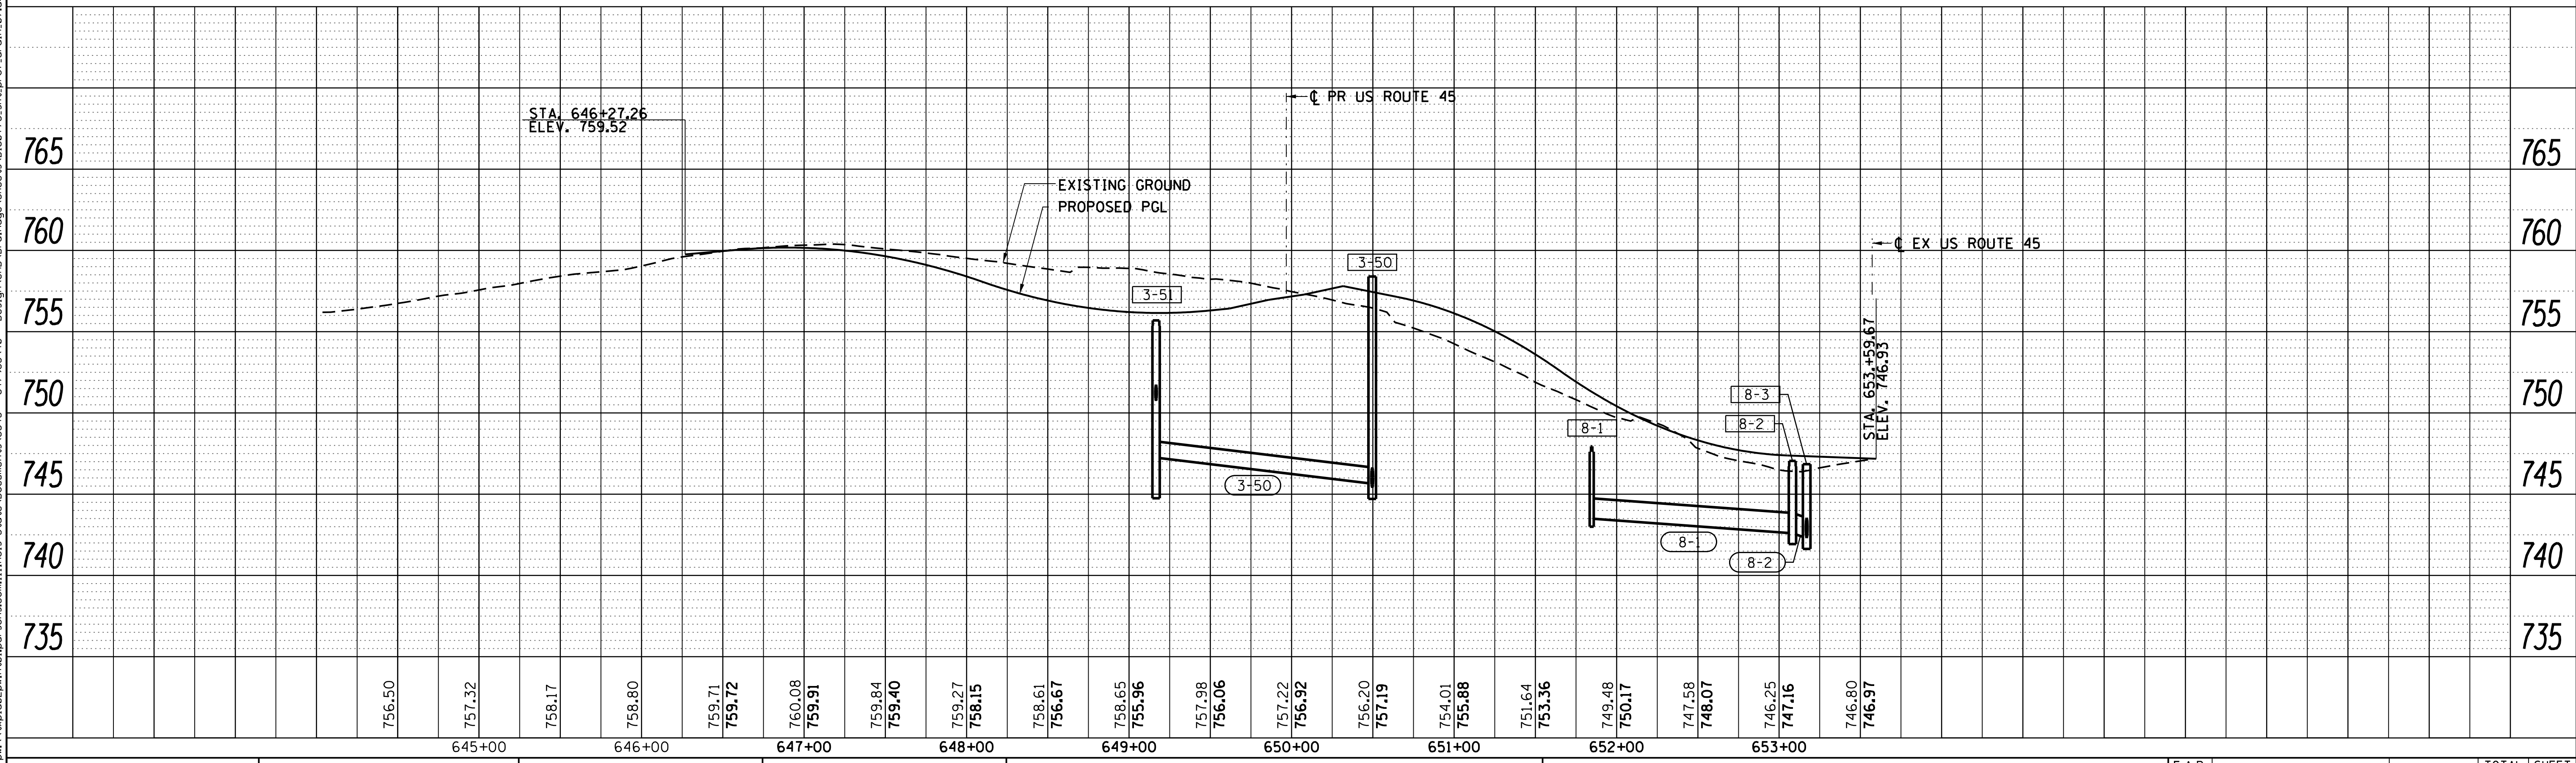

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USER NAME = 35361	DESIGNED - DW	REVISED -
	DRAWN - DW	REVISED -
PLOT SCALE = 50.0000' / in.	CHECKED - SS	REVISED -
PLOT DATE = 12/6/2017	DATE - 02/02/2017	REVISED -

**STATE OF ILLINOIS
DEPARTMENT OF TRANSPORTATION**

**PROPOSED DRAINAGE PROFILE
OLD US ROUTE 45 & INDEPENDENCE BLVD**

1"=50' SHEET 1 OF 1 SHEETS STA. TO STA.

F.A.P. RTE.	SECTION	COUNTY	TOTAL SHEETS	SHEET NO.
344	39 R	LAKE	510	182
CONTRACT NO. 60T75				
ILLINOIS FED. AID PROJECT				

PLAN	SURVEYED	DATE
NOTE BOOK NO.	PLOTTED	BY
CHECKED	DATE	
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PROFILE	SURVEYED	DATE
NOTE BOOK NO.	GRADES CHECKED	BY
CHECKED	STRUCTURE NOTATIONS CHECKED	

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DRAINAGE & UTILITIES					
STRUCTURE NUMBER	STATION	OFFSET	DESCRIPTION	RIM ELEVATION	INVERTS
1-1	105+88	79.1' RT	PRECAST REINFORCED CONCRETE FLARED END SECTIONS 18"	-	724.00 NW (IN)
1-2	106+03	63.0' RT	MANHOLES, TYPE A, 4'-DIAMETER, TYPE 1 FRAME, CLOSED LID	728.00	724.30 N (IN) 724.20 SE (OUT)
1-3	106+96	62.6' RT	MANHOLES, TYPE A, 4'-DIAMETER, TYPE 1 FRAME, CLOSED LID	729.90	725.15 N (IN) 724.90 S (OUT) 725.15 W (IN)
1-4	106+96	30.0' LT	CATCH BASINS, TYPE A, 4'-DIAMETER, TYPE 24 FRAME AND GRATE	731.44	726.99 E (OUT) 726.99 W (IN)
1-5	109+00	52.1' RT	MANHOLES, TYPE A, 4'-DIAMETER, TYPE 1 FRAME, CLOSED LID	734.40	729.25 N (IN) 730.15 W (IN) 729.15 S (OUT)
1-6	109+00	35.0' RT	CATCH BASINS, TYPE C, TYPE 24 FRAME AND GRATE	735.22	731.02 E (OUT)
1-7	109+00	30.6' LT	CATCH BASINS, TYPE C, TYPE 24 FRAME AND GRATE	735.21	731.01 W (OUT)
1-8	110+95	52.1' RT	MANHOLES, TYPE A, 4'-DIAMETER, TYPE 1 FRAME, CLOSED LID	738.34	732.70 N (IN) 733.30 W (IN) 732.35 S (OUT)
1-9	110+95	11.0' RT	CATCH BASINS, TYPE A, 4'-DIAMETER, TYPE 24 FRAME AND GRATE	738.95	734.00 E (OUT) 734.00 S (IN)
1-10	110+95	34.5' LT	CATCH BASINS, TYPE C, TYPE 24 FRAME AND GRATE	738.47	734.27 W (OUT)
1-11	110+62	11.0' RT	INLETS, TYPE A, TYPE 24 FRAME AND GRATE	738.51	734.31 N (OUT)
1-12	113+25	58.7' RT	MANHOLES, TYPE A, 4'-DIAMETER, TYPE 1 FRAME, CLOSED LID	738.97	735.25 W (IN) 735.00 S (OUT)
1-13	113+25	11.0' RT	CATCH BASINS, TYPE C, TYPE 24 FRAME AND GRATE	741.22	737.02 E (OUT)
1-14	113+25	35.0' LT	CATCH BASINS, TYPE C, TYPE 24 FRAME AND GRATE	740.40	736.20 W (OUT)
1-15	104+95	92.8' RT	PRECAST REINFORCED CONCRETE FLARED END SECTIONS 15"	-	724.00 SW (OUT)
1-16	104+86	87.3' RT	MANHOLES, TYPE A, 6'-DIAMETER, WITH 2 TYPE 1 FRAME, CLOSED LID, RESTRICTOR PLATE	729.00	723.90 NE (IN) 723.90 S (OUT)
1-17	104+71	86.1' RT	PRECAST REINFORCED CONCRETE FLARED END SECTIONS 15"	-	723.80 N (IN)
1-18	113+25	41.0' LT	MANHOLES, TYPE A, 4'-DIAMETER, TYPE 1 FRAME, CLOSED LID	740.62	736.00 E (IN) 735.75 S (OUT)
1-19	110+95	40.9' LT	MANHOLES, TYPE A, 4'-DIAMETER, TYPE 1 FRAME, CLOSED LID	738.68	734.00 E (IN) 733.85 N (IN) 733.75 S (OUT)
1-20	109+00	38.2' LT	MANHOLES, TYPE A, 4'-DIAMETER, TYPE 1 FRAME, CLOSED LID	735.37	730.80 E (IN) 730.65 N (IN) 730.55 S (OUT)
1-21	106+96	37.6' LT	MANHOLES, TYPE A, 4'-DIAMETER, TYPE 1 FRAME, CLOSED LID	731.60	727.30 N (IN) 727.20 E (OUT)

DRAINAGE & UTILITIES						
PIPE NUMBER	FROM STRUCTURE	TO STRUCTURE	DESCRIPTION	LENGTH (FT)	SLOPE (%)	TBF (CY)
1-1	1-2	1-1	STORM SEWERS, CLASS A, TYPE 1 18"	20	0.98%	-
1-2	1-3	1-2	STORM SEWERS, CLASS A, TYPE 1 18"	89	0.67%	-
1-3	1-4	1-3	STORM SEWERS, CLASS A, TYPE 2 15"	89	2.08%	18
1-4	1-5	1-3	STORM SEWERS, CLASS A, TYPE 2 15"	200	2.00%	20
1-5	1-6	1-5	STORM SEWERS, CLASS A, TYPE 1 12"	14	6.18%	5
1-6	1-7	1-20	STORM SEWERS, CLASS A, TYPE 2 12"	5	4.58%	2
1-7	1-8	1-5	STORM SEWERS, CLASS A, TYPE 2 15"	191	1.62%	-
1-8	1-9	1-8	STORM SEWERS, CLASS A, TYPE 2 12"	37	1.89%	10
1-9	1-10	1-19	STORM SEWERS, CLASS A, TYPE 2 12"	3	7.97%	1
1-10	1-11	1-9	STORM SEWERS, CLASS A, TYPE 2 12"	30	1.03%	8
1-11	1-12	1-8	STORM SEWERS, CLASS A, TYPE 1 15"	231	1.00%	-
1-12	1-13	1-12	STORM SEWERS, CLASS A, TYPE 1 12"	45	3.96%	9
1-13	1-14	1-18	STORM SEWERS, CLASS A, TYPE 2 12"	3	6.60%	1
1-14	1-15	1-16	STORM SEWERS, CLASS A, TYPE 1 15"	8	1.25%	-
1-15	1-16	1-17	STORM SEWERS, CLASS A, TYPE 1 15"	12	0.84%	-
1-16	1-18	1-19	STORM SEWERS, CLASS A, TYPE 2 15"	222	0.86%	58
1-17	1-19	1-20	STORM SEWERS, CLASS A, TYPE 2 15"	191	1.62%	-
1-18	1-20	1-21	STORM SEWERS, CLASS A, TYPE 2 15"	200	1.63%	-
1-19	1-21	1-4	STORM SEWERS, CLASS A, TYPE 2 15"	4	5.87%	1

USER NAME = 35361	DESIGNED DW	REVISED -
	DRAWN DW	REVISED
PLOT SCALE = 50.0000' / in.	CHECKED SS	REVISED
PLOT DATE = 9/18/2017	DATE 02/02/2017	REVISED

**STATE OF ILLINOIS
DEPARTMENT OF TRANSPORTATION**

DRAINAGE STRUCTURE SCHEDULE

SCALE: NS SHEET 1 OF 9 SHEETS STA. TO STA.

F.A.P. RTE.	SECTION	COUNTY	TOTAL SHEETS	SHEET NO.
344	39 R	LAKE	510	184
CONTRACT NO. 60T75			ILLINOIS FED. AID PROJECT	

PLAN	SURVEYED	DATE
NOTE BOOK NO.	PLOTTED	BY
	CHECKED	
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PROFILE	SURVEYED	DATE
NOTE BOOK NO.	GRADES CHECKED	BY
	STRUCTURE	
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DRAINAGE & UTILITIES						
PIPE NUMBER	FROM STRUCTURE	TO STRUCTURE	DESCRIPTION	LENGTH (FT)	SLOPE (%)	TBF (CY)
2-1	2-1	2-2	STORM SEWERS, CLASS A, TYPE 2 12"	33	1.19%	7
2-2	2-2	2-3	STORM SEWERS, CLASS A, TYPE 2 12"	82	1.10%	12
2-3	2-3	2-4	STORM SEWERS, CLASS A, TYPE 2 15"	160	0.47%	-
2-4	2-5	2-4	STORM SEWERS, CLASS A, TYPE 2 12"	65	2.64%	13
2-5	2-4	2-6	STORM SEWERS, CLASS A, TYPE 2 15"	94	0.74%	-
2-6	2-7	2-6	STORM SEWERS, CLASS A, TYPE 2 12"	40	1.48%	4
2-7	2-8	2-6	STORM SEWERS, CLASS A, TYPE 2 12"	65	1.15%	51
2-8	2-10	2-8	STORM SEWERS, CLASS A, TYPE 2 12"	49	0.95%	14
2-9	2-9	2-8	STORM SEWERS, CLASS A, TYPE 2 12"	49	3.35%	15
2-10	2-6	2-11	STORM SEWERS, CLASS A, TYPE 2 15"	129	1.12%	103
2-11	2-11	2-12	STORM SEWERS, CLASS A, TYPE 2 18"	151	0.66%	-
2-12	2-13	2-12	STORM SEWERS, CLASS A, TYPE 2 12"	39	4.14%	13
2-13	2-14	2-13	STORM SEWERS, CLASS A, TYPE 2 12"	43	1.21%	11
2-14	2-12	2-15	STORM SEWER (WATER MAIN REQUIREMENTS) 18 INCH	148	0.74%	-
2-15	2-16	2-15	STORM SEWERS, CLASS A, TYPE 2 12"	86	1.63%	16
2-16	2-15	2-17	STORM SEWERS, CLASS A, TYPE 2 18"	91	0.77%	67
2-17	2-18	2-17	STORM SEWERS, CLASS A, TYPE 2 12"	2	51.99%	1
2-18	2-17	2-19	STORM SEWERS, CLASS A, TYPE 1 EQUIVALENT ROUND-SIZE 24"	211	0.52%	178
2-19	2-19	2-20	STORM SEWERS, CLASS A, TYPE 1 EQUIVALENT ROUND-SIZE 24"	1	34.18%	1
2-20	2-21	2-38	STORM SEWERS, CLASS A, TYPE 2 12"	31	0.51%	6
2-21	2-22	2-21	STORM SEWERS, CLASS A, TYPE 2 12"	68	1.35%	12
2-22	2-20	2-38	STORM SEWERS, CLASS A, TYPE 1 EQUIVALENT ROUND-SIZE 24"	31	0.96%	27
2-23	2-38	2-23	STORM SEWERS, CLASS A, TYPE 2 EQUIVALENT ROUND-SIZE 24"	246	0.90%	-
2-24	2-24	2-25	STORM SEWERS, CLASS A, TYPE 1 24"	92	4.87%	-
2-25	2-26	2-24	STORM SEWERS, CLASS A, TYPE 2 24"	13	5.26%	13
2-26	2-27	2-23	STORM SEWERS, CLASS A, TYPE 2 12"	6	1.54%	11
2-27	2-28	2-27	STORM SEWERS, CLASS A, TYPE 2 12"	32	1.23%	7
2-28	2-29	2-26	STORM SEWERS, CLASS A, TYPE 2 12"	30	2.20%	7
2-29	2-30	2-27	STORM SEWERS, CLASS A, TYPE 2 12"	31	4.29%	7
2-30	2-31	2-26	STORM SEWERS, CLASS A, TYPE 2 12"	29	5.44%	7
2-31	2-32	2-24	STORM SEWERS, CLASS A, TYPE 2 15"	270	1.48%	-
2-32	2-33	2-32	STORM SEWERS, CLASS A, TYPE 2 12"	18	1.24%	4
2-33	2-34	2-33	STORM SEWERS, CLASS A, TYPE 2 12"	46	1.80%	6
2-34	2-35	2-36	STORM SEWERS, CLASS A, TYPE 1 15"	49	1.02%	-
2-35	2-36	2-37	STORM SEWERS, CLASS A, TYPE 1 15"	242	0.41%	-
2-36	2-23	2-26	STORM SEWERS, CLASS A, TYPE 2 24"	30	6.33%	-
2-37	2-39	2-10	STORM SEWERS, CLASS A, TYPE 2 12"	49	0.47%	10

USER NAME = 35361	DESIGNED DW	REVISED -
	DRAWN DW	REVISED
PLOT SCALE = 50.0000' / in.	CHECKED SS	REVISED
PLOT DATE = 9/18/2017	DATE 02/02/2017	REVISED

**STATE OF ILLINOIS
DEPARTMENT OF TRANSPORTATION**

DRAINAGE STRUCTURE SCHEDULE

SCALE: NS SHEET 3 OF 9 SHEETS STA. TO STA.

F.A.P. RTE.	SECTION	COUNTY	TOTAL SHEETS	SHEET NO.
344	39 R	LAKE	510	186
CONTRACT NO. 60T75			ILLINOIS FED. AID PROJECT	

PLAN	SURVEYED	DATE
NOTE BOOK NO.	PLOTTED	BY
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PROFILE	SURVEYED	DATE
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DRAINAGE & UTILITIES							
PIPE NUMBER	FROM STRUCTURE	TO STRUCTURE	DESCRIPTION	LENGTH (FT)	SLOPE (%)	TBF (CY)	
3-1	3-2	3-1	STORM SEWERS, CLASS A, TYPE 3 42"	89	0.23%	-	
3-2	3-3	3-2	STORM SEWERS JACKED IN PLACE, 42"	221	0.21%	-	
3-3	3-4	3-81	STORM SEWERS, CLASS A, TYPE 3 42"	79	0.24%	-	
3-4	3-5	3-4	STORM SEWERS, CLASS A, TYPE 2 12"	12	2.42%	4	
3-5	3-6	3-5	STORM SEWERS, CLASS A, TYPE 2 12"	51	1.61%	10	
3-6	3-7	3-4	STORM SEWERS, CLASS A, TYPE 3 42"	62	0.32%	-	
3-7	3-8	3-7	STORM SEWERS, CLASS A, TYPE 2 12"	65	1.59%	12	
3-8	3-9	3-7	STORM SEWERS, CLASS A, TYPE 3 36"	157	0.66%	395	
3-9	3-10	3-9	STORM SEWERS, CLASS A, TYPE 2 15"	11	2.83%	14	
3-10	3-11	3-10	STORM SEWERS, CLASS A, TYPE 2 12"	50	1.20%	9	
3-11	3-12	3-11	STORM SEWERS, CLASS A, TYPE 2 12"	28	1.91%	7	
3-12	3-13	3-10	STORM SEWERS, CLASS A, TYPE 2 12"	28	2.33%	7	
3-13	3-14	3-11	STORM SEWERS, CLASS A, TYPE 2 12"	48	1.14%	8	
3-14	3-15	3-10	STORM SEWERS, CLASS A, TYPE 2 12"	34	1.98%	8	
3-15	3-16	3-9	STORM SEWERS, CLASS A, TYPE 2 36"	153	0.52%	299	
3-16	3-17	3-16	STORM SEWERS, CLASS A, TYPE 2 12"	68	2.34%	15	
3-17	3-18	3-16	STORM SEWERS, CLASS A, TYPE 2 36"	105	0.57%	216	
3-18	3-19	3-18	STORM SEWERS, CLASS A, TYPE 2 12"	10	3.01%	7	
3-19	3-20	3-19	STORM SEWERS, CLASS A, TYPE 2 12"	56	1.07%	16	
3-20	3-21	3-20	STORM SEWERS, CLASS A, TYPE 2 12"	31	1.28%	8	
3-21	3-22	3-18	STORM SEWERS, CLASS A, TYPE 2 36"	140	1.00%	322	
3-22	3-23	3-22	STORM SEWERS, CLASS A, TYPE 2 24"	127	1.02%	193	
3-23	3-24	3-23	STORM SEWERS, CLASS A, TYPE 2 24"	66	0.46%	-	
3-24	3-25	3-24	STORM SEWERS, CLASS A, TYPE 2 12"	47	6.12%	13	
3-25	3-26	3-25	STORM SEWERS, CLASS A, TYPE 2 12"	74	1.36%	21	
3-26	3-27	3-22	STORM SEWERS, CLASS A, TYPE 2 24"	50	9.17%	27	
3-27	3-28	3-27	STORM SEWERS, CLASS A, TYPE 2 24"	84	2.02%	82	
3-28	3-29	3-28	STORM SEWERS, CLASS A, TYPE 2 24"	100	1.10%	32	
3-29	3-30	3-29	STORM SEWERS, CLASS A, TYPE 2 12"	23	0.00%	12	
3-30	3-31	3-30	STORM SEWERS, CLASS A, TYPE 2 12"	87	1.10%	20	
3-31	3-32	3-29	STORM SEWERS, CLASS A, TYPE 2 24"	80	0.88%	10	
3-32	3-33	3-32	STORM SEWERS, CLASS A, TYPE 2 12"	12	2.56%	4	
3-33	3-34	3-33	STORM SEWERS, CLASS A, TYPE 2 12"	87	1.09%	21	
3-34	3-35	3-32	STORM SEWERS, CLASS A, TYPE 2 18"	205	1.56%	260	
3-35	3-36	3-35	STORM SEWERS, CLASS A, TYPE 2 12"	10	2.94%	8	
3-36	3-37	3-36	STORM SEWERS, CLASS A, TYPE 2 12"	82	1.15%	16	
3-37	3-38	3-35	STORM SEWERS, CLASS A, TYPE 2 18"	231	1.17%	310	
3-38	3-39	3-38	STORM SEWERS, CLASS A, TYPE 2 12"	11	2.74%	8	
3-39	3-40	3-39	STORM SEWERS, CLASS A, TYPE 2 12"	73	1.12%	13	
3-40	3-41	3-38	STORM SEWERS, CLASS A, TYPE 2 18"	246	1.48%	339	
3-41	3-42	3-41	STORM SEWERS, CLASS A, TYPE 2 12"	36	2.23%	24	
3-42	3-43	3-42	STORM SEWERS, CLASS A, TYPE 2 12"	43	1.16%	8	

DRAINAGE & UTILITIES							
PIPE NUMBER	FROM STRUCTURE	TO STRUCTURE	DESCRIPTION	LENGTH (FT)	SLOPE (%)	TBF (CY)	
3-43	3-44	3-41	STORM SEWERS, CLASS A, TYPE 2 15"	233	1.46%	302	
3-44	3-45	3-44	STORM SEWERS, CLASS A, TYPE 2 12"	38	1.33%	13	
3-45	3-46	3-45	STORM SEWERS, CLASS A, TYPE 2 12"	41	1.20%	8	
3-46	3-47	3-44	STORM SEWERS, CLASS A, TYPE 2 15"	193	0.78%	243	
3-47	3-48	3-47	STORM SEWERS, CLASS A, TYPE 2 12"	47	1.27%	16	
3-48	3-49	3-48	STORM SEWERS, CLASS A, TYPE 2 12"	31	1.25%	6	
3-49	3-50	3-47	STORM SEWERS, CLASS A, TYPE 2 15"	212	0.78%	267	
3-50	3-51	3-50	STORM SEWERS, CLASS A, TYPE 2 12"	138	1.08%	97	
3-51	3-52	3-51	STORM SEWERS, CLASS A, TYPE 2 12"	47	1.31%	15	
3-52	3-53	3-54	STORM SEWERS, CLASS A, TYPE 2 12"	55	1.00%	34	
3-53	3-54	3-85	STORM SEWERS, CLASS A, TYPE 2 15"	153	0.37%	125	
3-54	3-56	3-55	STORM SEWERS, CLASS A, TYPE 2 12"	56	2.13%	18	
3-55	3-55	3-57	STORM SEWERS, CLASS A, TYPE 2 15"	210	0.64%	135	
3-56	3-58	3-57	STORM SEWERS, CLASS A, TYPE 2 12"	3	16.18%	1	
3-57	3-57	3-59	STORM SEWERS, CLASS A, TYPE 2 15"	130	0.69%	49	
3-58	3-60	3-59	STORM SEWERS, CLASS A, TYPE 2 12"	16	1.73%	5	
3-59	3-59	3-61	STORM SEWERS, CLASS A, TYPE 2 15"	119	1.26%	41	
3-60	3-62	3-61	STORM SEWERS, CLASS A, TYPE 2 12"	16	4.30%	6	
3-61	3-61	3-63	STORM SEWERS, CLASS A, TYPE 2 15"	94	1.33%	38	
3-62	3-64	3-63	STORM SEWERS, CLASS A, TYPE 2 12"	16	3.98%	6	
3-63	3-63	3-65	STORM SEWERS, CLASS A, TYPE 2 15"	75	1.14%	27	
3-64	3-66	3-65	STORM SEWERS, CLASS A, TYPE 2 12"	16	0.83%	5	
3-65	3-65	3-84	STORM SEWERS, CLASS A, TYPE 3 15"	143	7.57%	146	
3-66	3-68	3-67	STORM SEWERS, CLASS A, TYPE 2 12"	15	18.17%	12	
3-67	3-67	3-24	STORM SEWERS, CLASS A, TYPE 3 24"	242	0.50%	44	
3-68	3-69	3-25	STORM SEWERS, CLASS A, TYPE 2 12"	17	8.88%	5	
3-69	3-70	3-26	STORM SEWERS, CLASS A, TYPE 2 12"	7	11.83%	2	
3-70	3-71	3-28	STORM SEWERS, CLASS A, TYPE 2 12"	47	1.19%	4	
3-71	3-72	3-27	STORM SEWERS, CLASS A, TYPE 2 15"	171	3.72%	198	
3-72	3-73	3-72	STORM SEWERS, CLASS A, TYPE 2 12"	65	1.01%	42	
3-73	3-74	3-72	STORM SEWERS, CLASS A, TYPE 2 15"	202	0.35%	276	
3-74	3-75	3-74	STORM SEWERS, CLASS A, TYPE 2 15"	228	0.33%	303	
3-75	3-76	3-75	STORM SEWERS, CLASS A, TYPE 2 12"	52	5.12%	35	
3-76	3-77	3-75	STORM SEWERS, CLASS A, TYPE 2 15"	139	0.36%	135	
3-77	3-78	3-77	STORM SEWERS, CLASS A, TYPE 2 12"	12	1.70%	7	
3-78	3-79	3-78	STORM SEWERS, CLASS A, TYPE 2 12"	39	1.15%	11	
3-79	3-80		STORM SEWERS, CLASS A, TYPE 2 10"	75	1.20%	27	
3-80	3-81	3-3	STORM SEWERS, CLASS A, TYPE 3 42"	111	0.23%	-	
3-81	3-82	3-80	STORM SEWERS, CLASS A, TYPE 2 10"	192	1.02%	-	
3-82	3-83	3-84	STORM SEWERS, CLASS A, TYPE 2 12"	16	14.64%	11	
3-83	3-84	3-67	STORM SEWERS, CLASS A, TYPE 3 18"	82	0.98%	182	
3-84	3-85	3-55	STORM SEWERS, CLASS A, TYPE 2 15"	56	0.38%	40	

USER NAME = 35361	DESIGNED DW	REVISED -
	DRAWN DW	REVISED
PLOT SCALE = 50.0000' / in.	CHECKED SS	REVISED
PLOT DATE = 9/18/2017	DATE 02/02/2017	REVISED

**STATE OF ILLINOIS
DEPARTMENT OF TRANSPORTATION**

DRAINAGE STRUCTURE SCHEDULE

SCALE: NS SHEET 6 OF 9 SHEETS STA. TO STA.

F.A.P. RTE.	SECTION	COUNTY	TOTAL SHEETS	SHEET NO.
344	39 R	LAKE	510	189
CONTRACT NO. 60T75			ILLINOIS FED. AID PROJECT	

PLAN	SURVEYED	DATE
NOTE BOOK	PLOTTED	BY
NO.	CHECKED	
	ALIGNED	
	STRUCTURE	
	NOTATIS	
	CHKD	
	FILE NAME	

PROFILE	SURVEYED	DATE
NOTE BOOK	PLOTTED	BY
NO.	CHECKED	
	ALIGNED	
	STRUCTURE	
	NOTATIS	
	CHKD	
	FILE NAME	

FILE NAME = p:\t\l\ed2\p\m\02\person\com\illinois State Documents\US45 - 647985\48 - Design\CAD\Drawings\Sheets\010775-sh-t-b-dm-br-n-sched-les-07.dgn

DRAINAGE & UTILITIES					
STRUCTURE NUMBER	STATION	OFFSET	DESCRIPTION	RIM ELEVATION	INVERTS
4-1	163+85	47.0' LT	INLETS, TYPE A, TYPE 24 FRAME AND GRATE	753.46	749.26 E (OUT)
4-2	163+85	11.0' RT	CATCH BASINS, TYPE A, 4'-DIAMETER, TYPE 24 FRAME AND GRATE	754.29	748.70 W (IN) 748.70 E (OUT)
4-3	163+85	52.1' RT	MANHOLES, TYPE A, 4'-DIAMETER, TYPE 1 FRAME, CLOSED LID	754.00	748.25 W (IN) 748.00 N (OUT)
4-4	165+51	52.1' RT	MANHOLES, TYPE A, 4'-DIAMETER, TYPE 1 FRAME, CLOSED LID	750.14	744.90 S (IN) 744.80 N (OUT) 746.30 W (IN)
4-5	165+51	11.0' RT	CATCH BASINS, TYPE C, TYPE 24 FRAME AND GRATE	750.97	746.77 E (OUT)
4-6	166+00	52.1' RT	MANHOLES, TYPE A, 4'-DIAMETER, TYPE 1 FRAME, CLOSED LID	746.92	743.50 S (IN) 743.70 W (IN) 743.00 N (OUT)
4-7	166+00	39.2' LT	CATCH BASINS, TYPE C, TYPE 24 FRAME AND GRATE	749.42	745.22 E (OUT)
4-8	167+00	52.1' RT	MANHOLES, TYPE A, 4'-DIAMETER, TYPE 1 FRAME, CLOSED LID	744.10	739.00 S (IN) 737.00 NE (OUT)
4-9	167+13	74.6' RT	PRECAST REINFORCED CONCRETE FLARED END SECTIONS 15"	-	736.00 SW (IN)
4-10	169+13	120.9' RT	PRECAST REINFORCED CONCRETE FLARED END SECTIONS 15"	-	736.00 NE (OUT)
4-11	169+18	135.5' RT	MANHOLES, TYPE A, 6'-DIAMETER, WITH 2 TYPE 1 FRAME, CLOSED LID, RESTRICTOR PLATE	741.00	735.90 SW (IN) 735.90 NE (OUT)
4-12	169+26	160.3' RT	PRECAST REINFORCED CONCRETE FLARED END SECTIONS 15"	-	735.20 SW (IN)

DRAINAGE & UTILITIES					
STRUCTURE NUMBER	STATION	OFFSET	DESCRIPTION	RIM ELEVATION	INVERTS
5-1	294+37	44.2' LT	CATCH BASINS, TYPE A, 4'-DIAMETER, TYPE 8 GRATE	751.00	747.60 S (OUT) 748.00 W (IN)
5-2	294+37	42.0' RT	MANHOLES, TYPE A, 4'-DIAMETER, TYPE 1 FRAME, CLOSED LID	755.80	747.30 N (IN) 747.30 E (OUT) 751.00 S (IN) 747.30 W (IN)
5-3	295+01	48.6' RT	MANHOLES, TYPE A, 4'-DIAMETER, TYPE 8 GRATE	752.80	747.10 W (IN)
5-4	294+37	53.5' RT	PRECAST REINFORCED CONCRETE FLARED END SECTIONS 12"	-	751.80 N (OUT)
5-5	292+85	41.1' RT	PRECAST REINFORCED CONCRETE FLARED END SECTIONS 15"	-	753.00 E (OUT)
5-6	294+15	47.1' LT	MANHOLES, TYPE A, 4'-DIAMETER, TYPE 1 FRAME, CLOSED LID	754.00	750.86 E (OUT)
5-7	294+39	50.1' LT	METAL END SECTIONS 12"	-	751.00 NE (IN)

MULTI-CELL BOX CULVERT END SECTIONS TABLE							
STRUCTURE NUMBER	STATION	OFFSET	DESCRIPTION	INVERTS	SPAN X RISE	SLOPE (V:H)	LENGTH
6-1	142+99	69.5' LT	BOX CULVERT END SECTIONS, CULVERT NO. 1	728.10 E	4' x 2'	1:3	7
6-2	142+46	68.4' RT	BOX CULVERT END SECTIONS, CULVERT NO. 2	727.00 W	4' x 2'	1:3	7
6-3	170+64	62.1' LT	BOX CULVERT END SECTIONS, CULVERT NO. 3	736.20 E	4' x 2'	1:3	7
6-4	170+56	43.5' RT	BOX CULVERT END SECTIONS, CULVERT NO. 4	735.70 W	4' x 2'	1:3	7
6-5	176+06	63.6' LT	BOX CULVERT END SECTIONS, CULVERT NO. 5	732.15 E	4' x 2'	1:3	7
6-6	176+12	38.1' RT	BOX CULVERT END SECTIONS, CULVERT NO. 6	731.90 W	4' x 2'	1:3	7
6-7	308+81	63.1' LT	BOX CULVERT END SECTIONS, CULVERT NO. 7	731.60 S	4' x 2'	1:3	7
6-8	308+81	60.9' RT	BOX CULVERT END SECTIONS, CULVERT NO. 8	731.30 N	4' x 2'	1:3	7

PRECAST BOX CULVERT SCHEDULE (ASTM C 1577)											
PIPE NUMBER	FROM STRUCTURE	TO STRUCTURE	DESCRIPTION	LENGTH (FT)	SLOPE (%)	SKEW	DESIGN FILL (FT) EDGE OF SHOULDER (MINIMUM)	DESIGN FILL (FT) MAXIMUM	PGE BACKFILL REQUIRED (CY)		
6-1	6-1	6-2	PRECAST CONCRETE BOX CULVERTS 4' X 2'	148	0.75%	21	1.58	2.58	19		
6-2	6-1	6-2	PRECAST CONCRETE BOX CULVERTS 4' X 2'	148	0.75%	21	1.58	2.58	19		
6-3	6-3	6-4	PRECAST CONCRETE BOX CULVERTS 4' X 2'	106	0.47%	4	3.24	4.11	31		
6-4	6-3	6-4	PRECAST CONCRETE BOX CULVERTS 4' X 2'	106	0.47%	4	3.24	4.11	31		
6-5	6-5	6-6	PRECAST CONCRETE BOX CULVERTS 4' X 2'	102	0.25%	4	3.56	4.20	32		
6-6	6-5	6-6	PRECAST CONCRETE BOX CULVERTS 4' X 2'	102	0.25%	4	3.56	4.20	32		
6-7	6-7	6-8	PRECAST CONCRETE BOX CULVERTS 4' X 2'	124	0.24%	0	2.95	3.90	47		
6-8	6-7	6-8	PRECAST CONCRETE BOX CULVERTS 4' X 2'	124	0.24%	0	2.95	3.90	47		

DRAINAGE & UTILITIES							
PIPE NUMBER	FROM STRUCTURE	TO STRUCTURE	DESCRIPTION	LENGTH (FT)	SLOPE (%)	TBF (CY)	
4-1	4-1	4-2	STORM SEWERS, CLASS A, TYPE 2 12"	55	1.02%	15	
4-2	4-2	4-3	STORM SEWERS, CLASS A, TYPE 2 12"	37	1.21%	13	
4-3	4-3	4-4	STORM SEWERS, CLASS A, TYPE 2 15"	163	1.90%	-	
4-4	4-5	4-4	STORM SEWERS, CLASS A, TYPE 1 12"	38	1.23%	7	
4-5	4-4	4-6	STORM SEWERS, CLASS A, TYPE 1 15"	45	2.89%	-	
4-6	4-7	4-6	STORM SEWERS, CLASS A, TYPE 1 12"	88	1.72%	11	
4-7	4-6	4-8	STORM SEWERS, CLASS A, TYPE 2 15"	96	4.17%	-	
4-8	4-8	4-9	STORM SEWERS, CLASS A, TYPE 1 15"	25	4.07%	-	
4-9	4-10	4-11	STORM SEWERS, CLASS A, TYPE 1 15"	12	0.80%	-	
4-10	4-11	4-12	STORM SEWERS, CLASS A, TYPE 1 15"	23	3.00%	-	

DRAINAGE & UTILITIES						
PIPE NUMBER	FROM STRUCTURE	TO STRUCTURE	DESCRIPTION	LENGTH (FT)	SLOPE (%)	TBF (CY)
5-1	5-1	5-2	STORM SEWERS, CLASS A, TYPE 1 18"	82	0.37%	28
5-2	5-2	5-3	STORM SEWERS, CLASS A, TYPE 2 18"	63	0.32%	32
5-3	5-4	5-2	STORM SEWERS, CLASS A, TYPE 1 12"	10	8.41%	-
5-4	5-5	5-2	STORM SEWERS, CLASS A, TYPE 1 15"	156	3.65%	40
5-5	5-6	5-1	STORM SEWERS, CLASS A, TYPE 1 12"	17	16.65%	-

USER NAME = 35361	DESIGNED DW	REVISED -
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PLOT SCALE = 50.0000' / in.	CHECKED SS	REVISED
PLOT DATE = 9/18/2017	DATE 02/02/2017	REVISED

STATE OF ILLINOIS
DEPARTMENT OF TRANSPORTATION

DRAINAGE STRUCTURE SCHEDULE

SCALE: NS SHEET 7 OF 10 SHEETS STA. TO STA.

F.A.P. RTE.	SECTION	COUNTY	TOTAL SHEETS	SHEET NO.
344	39 R	LAKE	510	190
ILLINOIS FED. AID PROJECT			CONTRACT NO. 60T75	

PLAN	SURVEYED	DATE
NOTE BOOK NO.	PLOTTED	BY
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PROFILE	SURVEYED	DATE
NOTE BOOK NO.	GRADES CHECKED	BY
	STRUCTURE NOTATIONS CHECKED	

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FIELD TILE CONNECTIONS					
STRUCTURE NUMBER	STATION	OFFSET	DESCRIPTION	RIM ELEVATION	INVERTS
10-1	130+78	58.8' LT	FIELD TILE JUNCTION VAULTS, 4' DIA.	730.00	722.00 SE (OUT)
10-2	128+33	70.4' LT	PRECAST REINFORCED CONCRETE FLARED END SECTIONS 12"	-	719.00 NW (IN)
10-3	142+80	75.9' RT	FIELD TILE JUNCTION VAULTS, 4' DIA.	729.90	726.70 N (IN)
10-4	144+09	76.0' RT	FIELD TILE JUNCTION VAULTS, 4' DIA.	732.07	727.50 W (IN) 727.50 S (OUT)
10-5	144+09	88.6' LT	FIELD TILE JUNCTION VAULTS, 4' DIA.	734.70	728.25 E (OUT) 728.25 N (IN)
10-6	309+14	85.9' RT	FIELD TILE JUNCTION VAULTS, 4' DIA.	736.50	728.90 NW (IN) 728.90 S (OUT)
10-7	308+64	70.7' RT	FIELD TILE JUNCTION VAULTS, 4' DIA.	736.00	729.20 N (IN) 729.20 SE (OUT)
10-8	308+64	57.1' LT	FIELD TILE JUNCTION VAULTS, 4' DIA.	735.00	729.80 NE (IN) 729.80 S (OUT)
10-9	147+16	77.6' LT	FIELD TILE JUNCTION VAULTS, 4' DIA.	737.70	730.10 SW (OUT)
10-10	294+25	39.6' LT	FIELD TILE JUNCTION VAULTS, 4' DIA.	752.80	745.60 E (OUT)
10-11	294+57	37.9' LT	FIELD TILE JUNCTION VAULTS, 4' DIA.	752.33	745.50 W (IN) 745.50 S (OUT)
10-12	294+86	50.6' RT	FIELD TILE JUNCTION VAULTS, 4' DIA.	753.00	745.00 N (IN)
10-13	302+40	42.8' LT	FIELD TILE JUNCTION VAULTS, 4' DIA.	750.15	745.00 S (OUT)
10-14	302+62	53.9' RT	FIELD TILE JUNCTION VAULTS, 4' DIA.	744.80	740.50 N (IN) 740.50 E (OUT)
10-15	303+81	58.1' RT	FIELD TILE JUNCTION VAULTS, 4' DIA.	744.20	740.00 W (IN)
10-16	176+09	76.3' LT	FIELD TILE JUNCTION VAULTS, 4' DIA.	735.00	730.60 N (OUT)
10-17	176+34	76.3' LT	FIELD TILE JUNCTION VAULTS, 4' DIA.	735.00	730.35 E (OUT) 730.35 S (IN)
10-18	176+43	38.0' RT	PRECAST REINFORCED CONCRETE FLARED END SECTIONS 12"	-	729.80 W (IN)
10-19	135+65	70.0' LT	FIELD TILE JUNCTION VAULTS, 4' DIA.	729.40	726.20 S (OUT)
10-20	135+38	70.1' LT	PRECAST REINFORCED CONCRETE FLARED END SECTIONS 12"	-	726.00 N (IN)

TEMPORARY DRAINAGE CULVERTS					
STRUCTURE NUMBER	STATION	OFFSET	DESCRIPTION	RIMS	INVERTS
11-1	294+71	50.5' RT	METAL END SECTIONS 15"	-	749.90 E
11-2	294+92	47.6' RT	MANHOLES, TYPE A, 4'-DIAMETER, TYPE 1 FRAME, CLOSED LID	751.90	747.07 W 747.07 E
11-3	295+83	51.7' RT	METAL END SECTIONS 15"	-	750.00 W

TEMPORARY DRAINAGE CULVERTS						
PIPE NUMBER	FROM STRUCTURE	TO STRUCTURE	DESCRIPTION	LENGTH (FT)	SLOPE (%)	TBF (CY)
11-1	11-1	11-2	PIPE CULVERTS, CLASS D, TYPE 1 15"	15	18.45%	-
11-2	11-3	11-2	PIPE CULVERTS, CLASS D, TYPE 1 15"	35	6.95%	-

FIELD TILE CONNECTIONS						
PIPE NUMBER	FROM STRUCTURE	TO STRUCTURE	DESCRIPTION	LENGTH (FT)	SLOPE (%)	TBF (CY)
10-1	10-1	10-2	STORM SEWERS PROTECTED, CLASS A, 12"	248	1.21%	-
10-2	10-4	10-3	STORM SEWERS (SPECIAL), 12"	125	0.64%	-
10-3	10-5	10-4	STORM SEWERS PROTECTED, CLASS A, 12"	161	0.47%	116
10-4	10-6	10-5	STORM SEWERS (SPECIAL), 12"	104	0.62%	-
10-5	10-7	10-6	STORM SEWERS (SPECIAL), 12"	49	0.62%	-
10-6	10-8	10-7	STORM SEWERS PROTECTED, CLASS A, 12"	124	0.48%	90
10-7	10-9	10-8	STORM SEWERS (SPECIAL), 12"	64	0.47%	-
10-8	10-10	10-11	STORM SEWERS (SPECIAL), 12"	26	0.38%	-
10-9	10-11	10-12	STORM SEWERS PROTECTED, CLASS A, 12"	89	0.56%	76
10-10	10-13	10-14	STORM SEWERS PROTECTED, CLASS A, 12"	95	4.72%	23
10-11	10-14	10-15	STORM SEWERS (SPECIAL), 12"	112	0.45%	-
10-12	10-16	10-17	STORM SEWERS (SPECIAL), 12"	22	1.16%	23
10-13	10-17	10-18	STORM SEWERS PROTECTED, CLASS A, 12"	113	0.49%	-
10-14	10-19	10-20	STORM SEWERS (SPECIAL), 12"	26	0.76%	-

PIPE UNDERDRAINS TYPE 2 4"				
PIPE NUMBER	DESCRIPTION	STATION	LENGTH (FT)	
PU-1	PIPE UNDERDRAINS 4"	107+01	54	
PU-2	PIPE UNDERDRAINS 4"	111+00	24	
PU-3	PIPE UNDERDRAINS 4"	113+45	20	
PU-4	PIPE UNDERDRAINS 4"	119+31	20	
PU-5	PIPE UNDERDRAINS 4"	119+55	66	
PU-6	PIPE UNDERDRAINS 4"	120+42	20	
PU-7	PIPE UNDERDRAINS 4"	122+88	70	
PU-8	PIPE UNDERDRAINS 4"	125+40	70	
PU-9	PIPE UNDERDRAINS 4"	129+98	20	
PU-10	PIPE UNDERDRAINS 4"	129+97	20	
PU-11	PIPE UNDERDRAINS 4"	130+36	20	
PU-12	PIPE UNDERDRAINS 4"	130+36	20	
PU-13	PIPE UNDERDRAINS 4"	133+19	20	
PU-14	PIPE UNDERDRAINS 4"	133+19	20	
PU-15	PIPE UNDERDRAINS 4"	137+76	20	
PU-16	PIPE UNDERDRAINS 4"	137+76	20	
PU-17	PIPE UNDERDRAINS 4"	138+46	20	
PU-18	PIPE UNDERDRAINS 4"	140+26	36	
PU-19	PIPE UNDERDRAINS 4"	140+26	31	
PU-20	PIPE UNDERDRAINS 4"	143+04	94	
PU-21	PIPE UNDERDRAINS 4"	146+85	90	
PU-22	PIPE UNDERDRAINS 4"	149+79	85	
PU-23	PIPE UNDERDRAINS 4"	152+14	76	

PIPE UNDERDRAINS TYPE 2 4"				
PIPE NUMBER	DESCRIPTION	STATION	LENGTH (FT)	
PU-24	PIPE UNDERDRAINS 4"	154+64	86	
PU-25	PIPE UNDERDRAINS 4"	157+15	20	
PU-26	PIPE UNDERDRAINS 4"	157+14	20	
PU-27	PIPE UNDERDRAINS 4"	165+46	94	
PU-28	PIPE UNDERDRAINS 4"	295+09	83	
PU-29	PIPE UNDERDRAINS 4"	296+06	203	
PU-30	PIPE UNDERDRAINS 4"	298+65	159	
PU-31	PIPE UNDERDRAINS 4"	300+32	126	
PU-32	PIPE UNDERDRAINS 4"	302+92	92	
PU-33	PIPE UNDERDRAINS 4"	303+95	69	
PU-34	PIPE UNDERDRAINS 4"	304+91	122	
PU-35	PIPE UNDERDRAINS 4"	307+58	139	
PU-36	PIPE UNDERDRAINS 4"	311+66	130	
PU-37	PIPE UNDERDRAINS 4"	315+01	196	
PU-38	PIPE UNDERDRAINS 4"	315+17	213	
PU-39	PIPE UNDERDRAINS 4"	649+12	48	
PU-40	PIPE UNDERDRAINS 4"	652+85	48	
PU-41	PIPE UNDERDRAINS 4"	317+41	141	
PU-42	PIPE UNDERDRAINS 4"	316+50	83	
PU-43	PIPE UNDERDRAINS 4"	317+41	141	
PU-44	PIPE UNDERDRAINS 4"	111+00	24	
PU-45	PIPE UNDERDRAINS 4"	120+55	20	
PU-46	PIPE UNDERDRAINS 4"	120+95	20	
PU-47	PIPE UNDERDRAINS 4"	117+00	20	

NOTE:
PIPE UNDERDRAINS SHALL BE INSTALLED ACCORDING TO SECTION 601 OF THE SSRBC AND STANDARD 601001-05. TOP OF PIPE UNDERDRAINS SHALL BE PLACED MINIMUM 6" BELOW THE AGGREGATE SUBGRADE IMPROVEMENT LAYER. THE COST OF MAKING PIPE UNDERDRAIN CONNECTIONS TO DRAINAGE STRUCTURES SHALL BE INCLUDED IN THE COST OF THE PIPE UNDERDRAINS.

USER NAME = 35361	DESIGNED DW	REVISED -
	DRAWN DW	REVISED
PLOT SCALE = 50.0000' / in.	CHECKED SS	REVISED
PLOT DATE = 9/18/2017	DATE 02/02/2017	REVISED

STATE OF ILLINOIS
DEPARTMENT OF TRANSPORTATION

DRAINAGE STRUCTURE SCHEDULE



SCALE: NS SHEET 9 OF 9 SHEETS STA. TO STA.

F.A.P. RTE.	SECTION	COUNTY	TOTAL SHEETS	SHEET NO.
344	39 R	LAKE	510	192
CONTRACT NO. 60T75				
ILLINOIS FED. AID PROJECT				



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PROFILE	SURVEYED	BY	DATE
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	STRUCTURE NOTATIONS CHECKED		
	NOTE BOOK NO.		
	CADD FILE NAME		

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- NOTES:**
- CONTRACTOR SHALL CONSTRUCT ONLY ONE WATER MAIN RELOCATION SECTION AT A TIME. WORK SHALL BE FULLY COMPLETED AND THE WATER TURNED BACK ON BEFORE CONSTRUCTION BEGINS AT THE NEXT SECTION.
 - CONTRACTOR SHALL HAVE THE VILLAGE PUBLIC WORKS DEPARTMENT OPEN AND CLOSE EXISTING WATER VALVES.

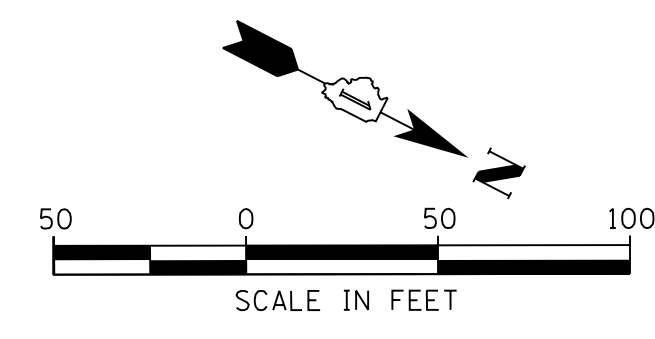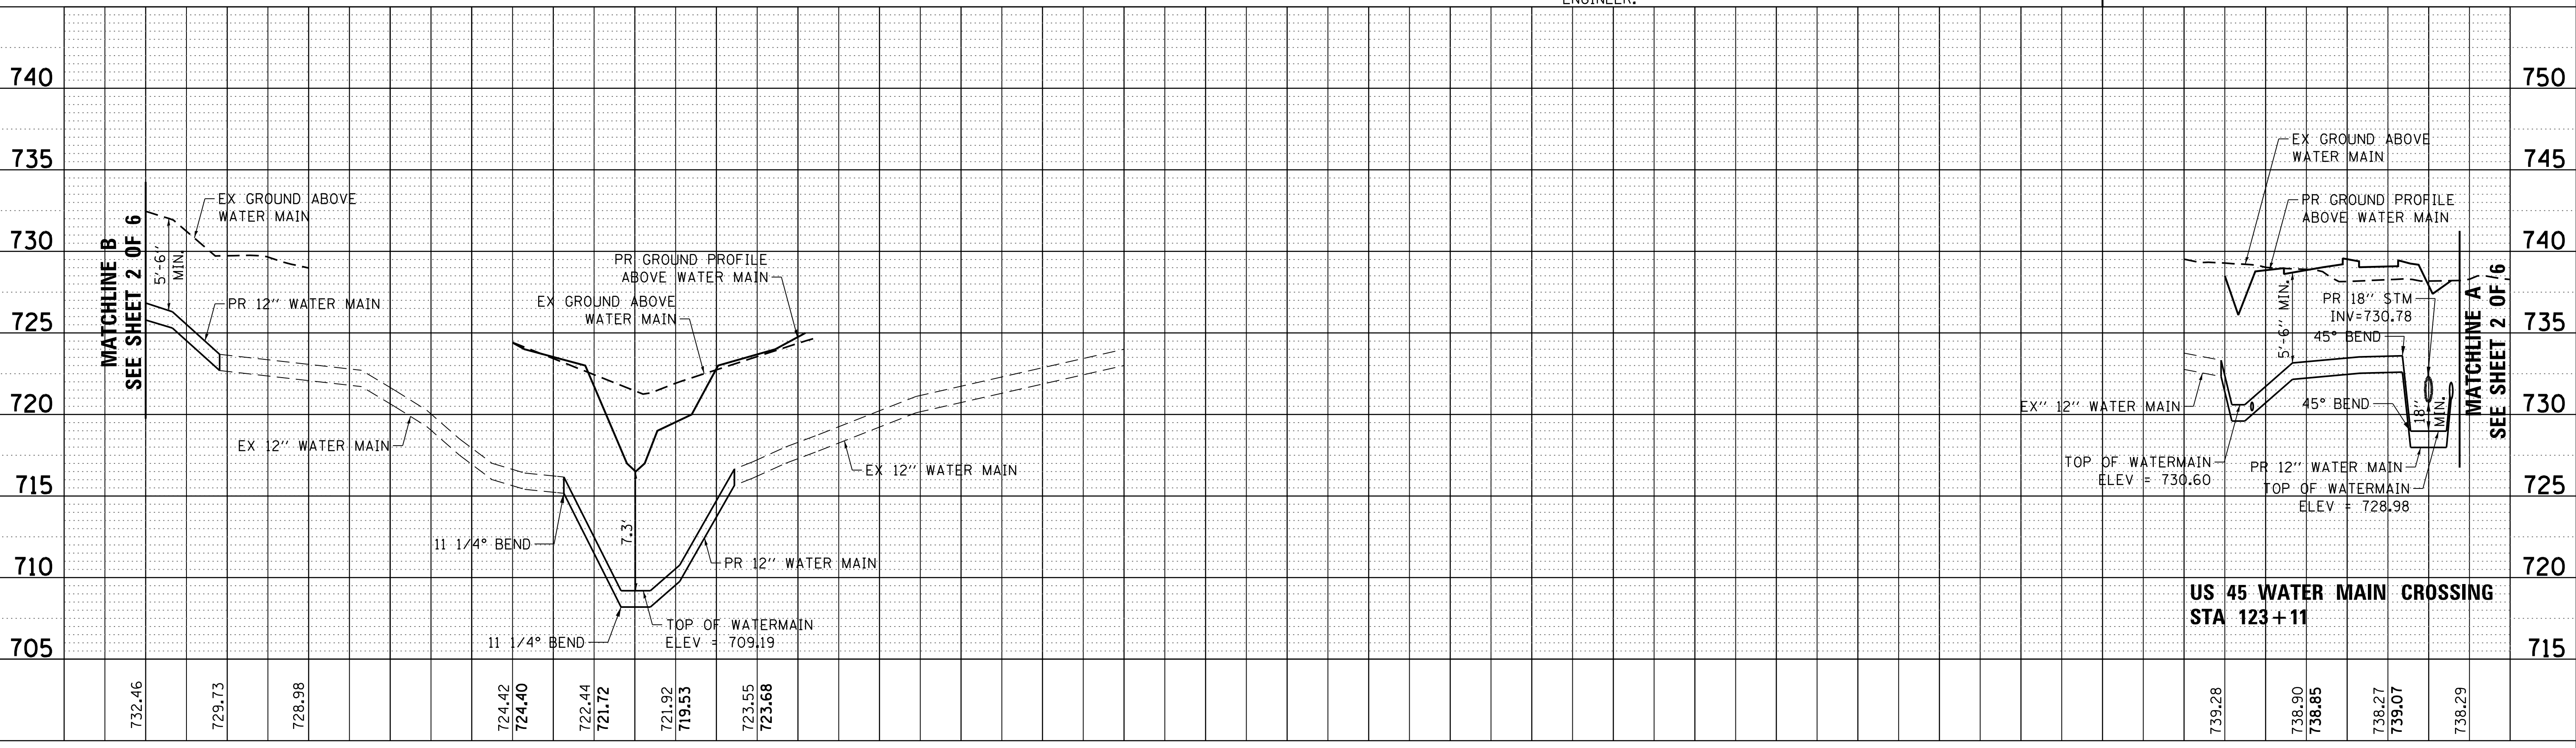

USER NAME = 35361	DESIGNED SS	REVISED -
	DRAWN SJ	REVISED
PLOT SCALE = 50.0000' / 1"	CHECKED VW	REVISED
PLOT DATE = 12/6/2017	DATE 02/02/2017	REVISED



**STATE OF ILLINOIS
DEPARTMENT OF TRANSPORTATION**

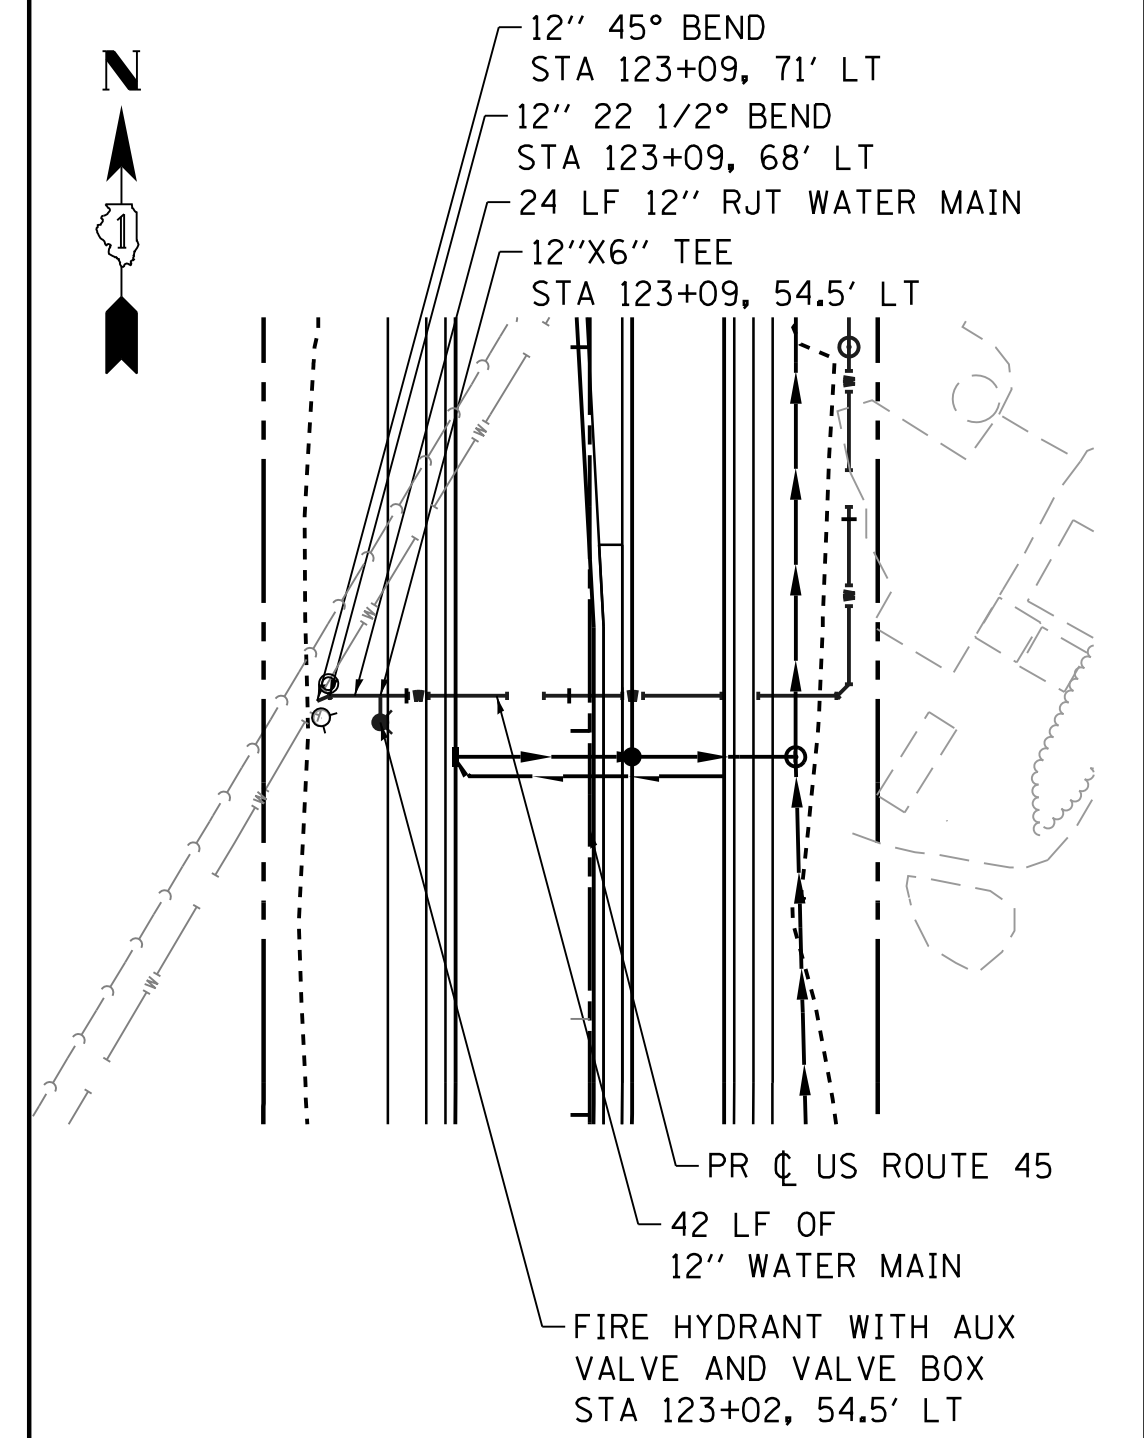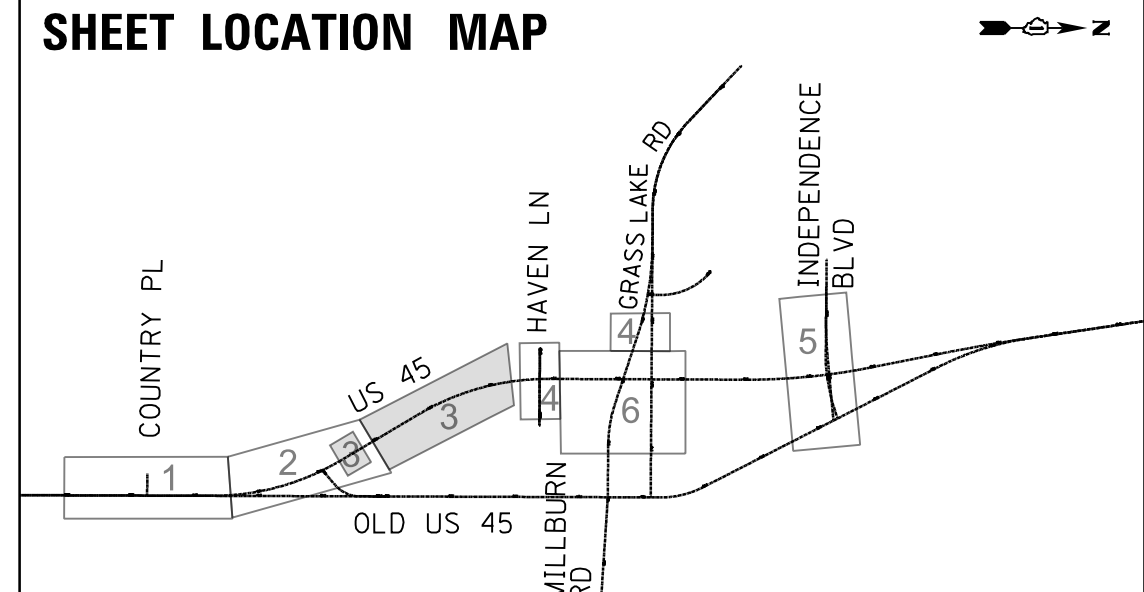**WATER MAIN AND SANITARY SEWER - PLAN & PROFILES
US ROUTE 45**

SCALE: 1"=50' SHEET 3 OF 6 SHEETS STA. 125+00 TO STA. 137+00


F.A.P. RTE. 344	SECTION 39 R	COUNTY LAKE	TOTAL SHEETS 510	SHEET NO. 199
CONTRACT NO. 60T75				ILLINOIS FED. AID PROJECT

SHEET LOCATION MAP

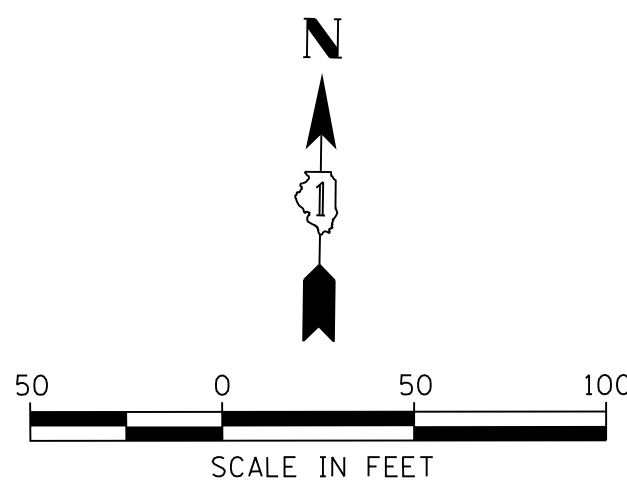
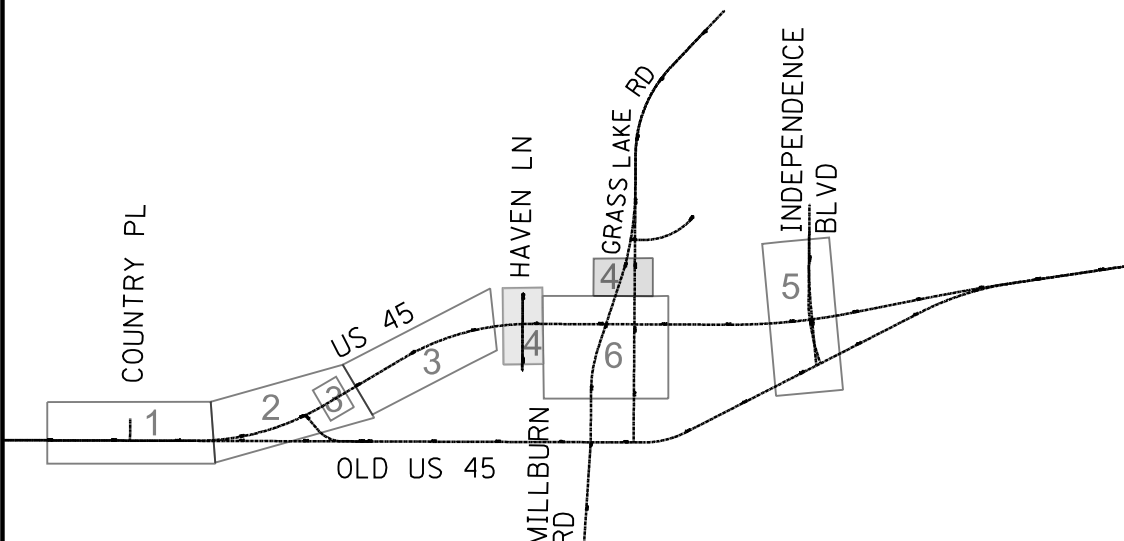


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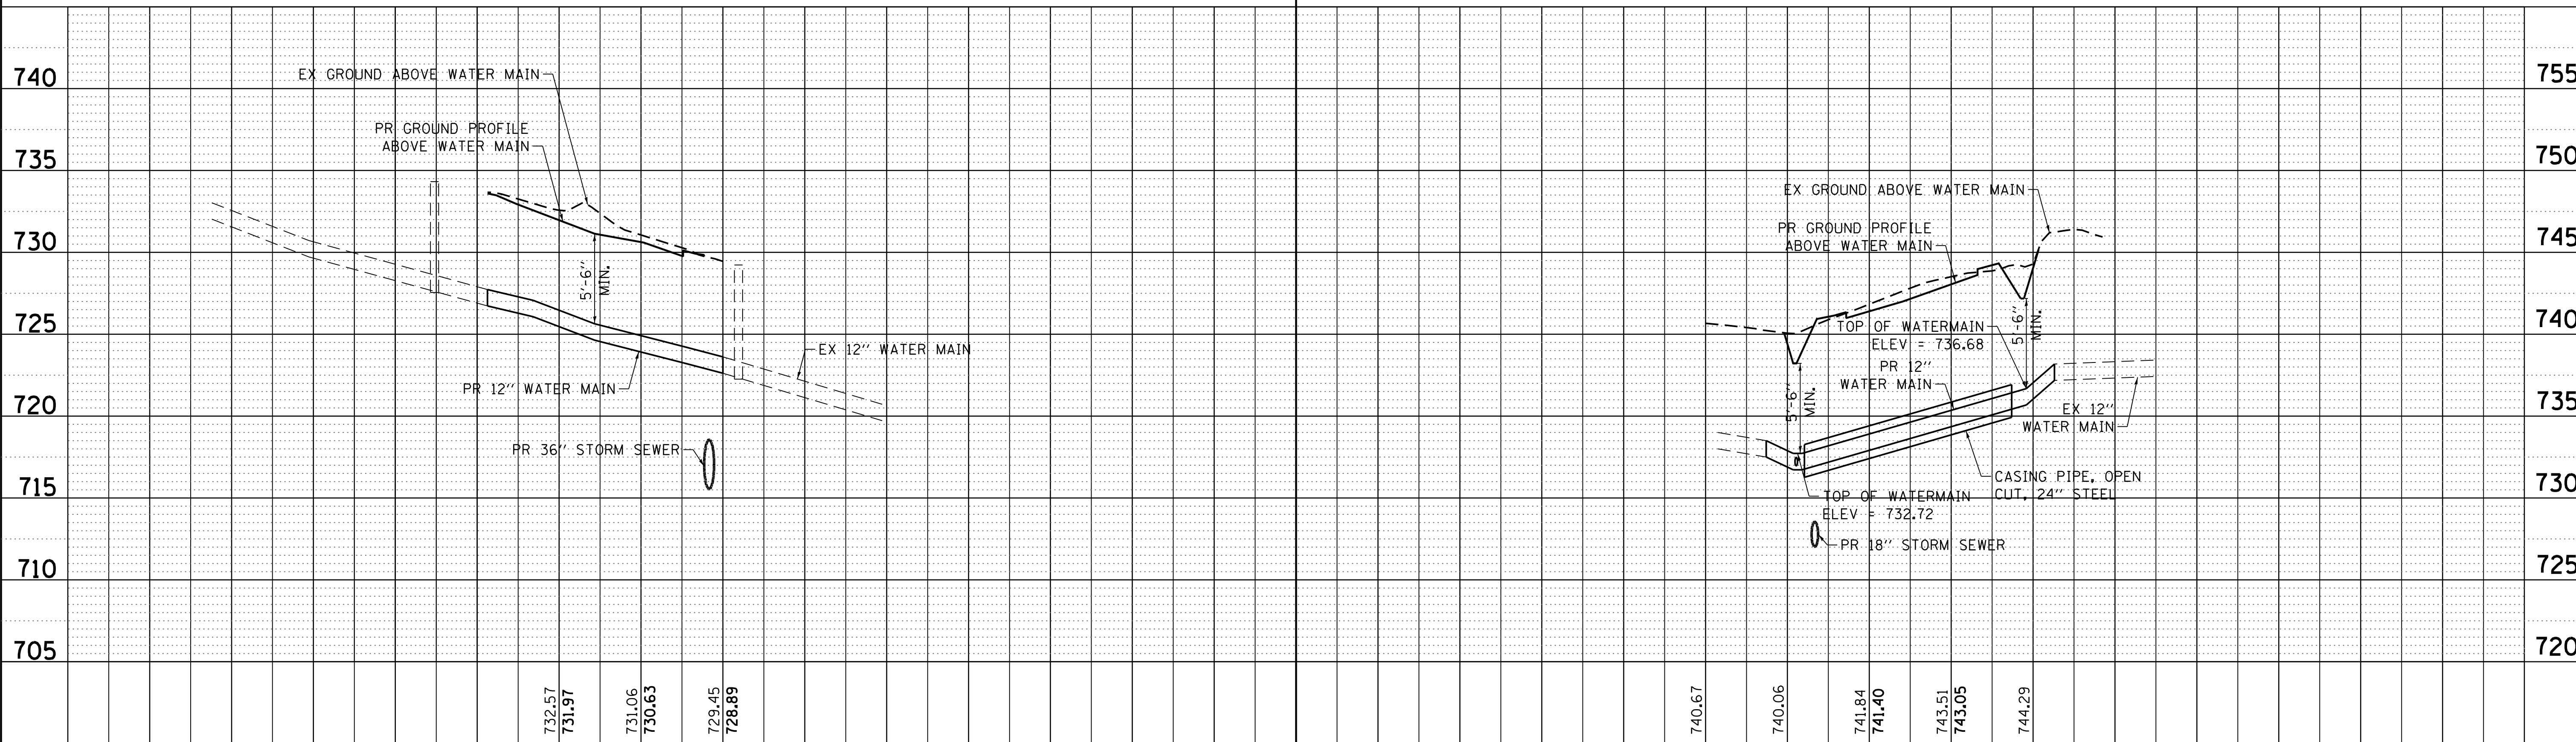
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PLAN	SURVEYED	BY	DATE
	PLOTTED		
	CHECKED		
	ATTEMPTED		
	FILE NAME		
	NO.		

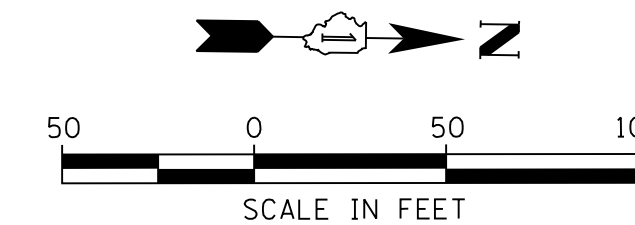

PROFILE	SURVEYED	BY	DATE
	PLOTTED		
	CHECKED		
	GRADES		
	STRUCTURE		
	NOT AT THIS OFFICE		
	NO.		

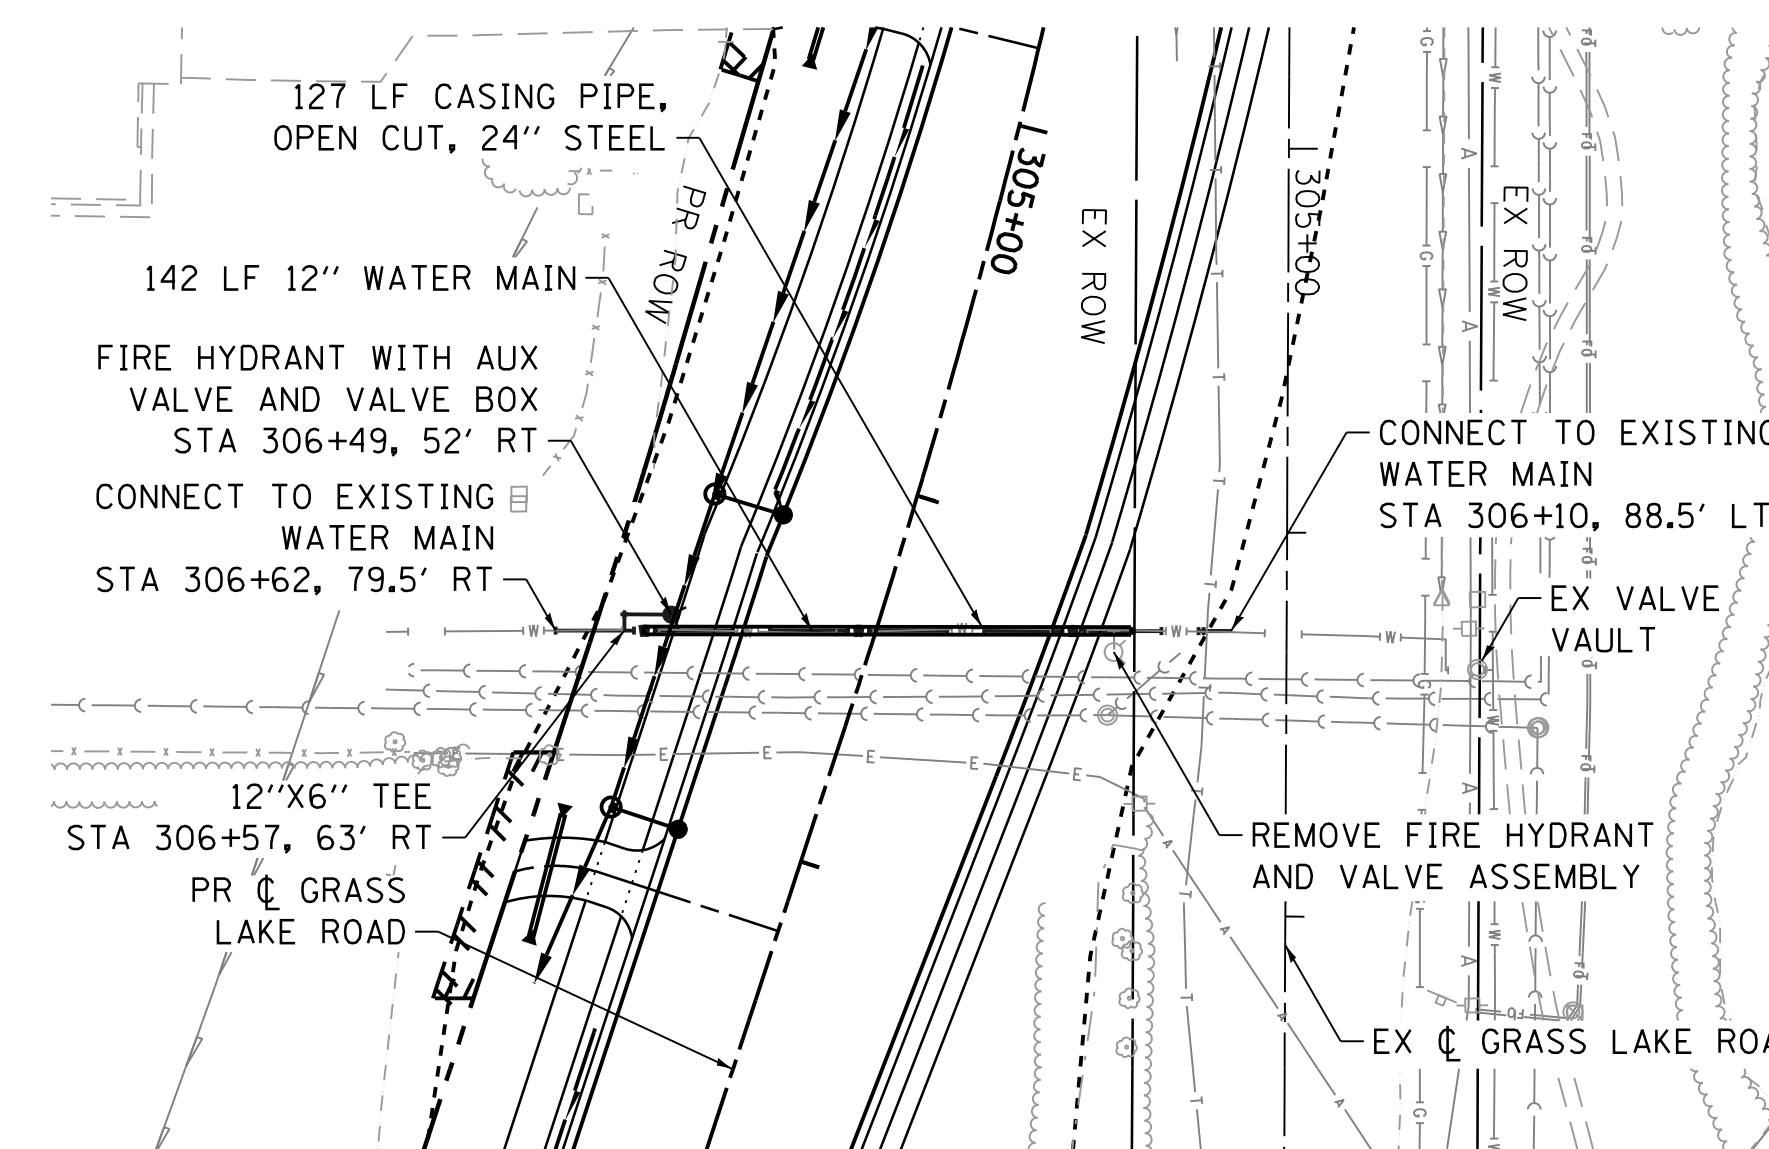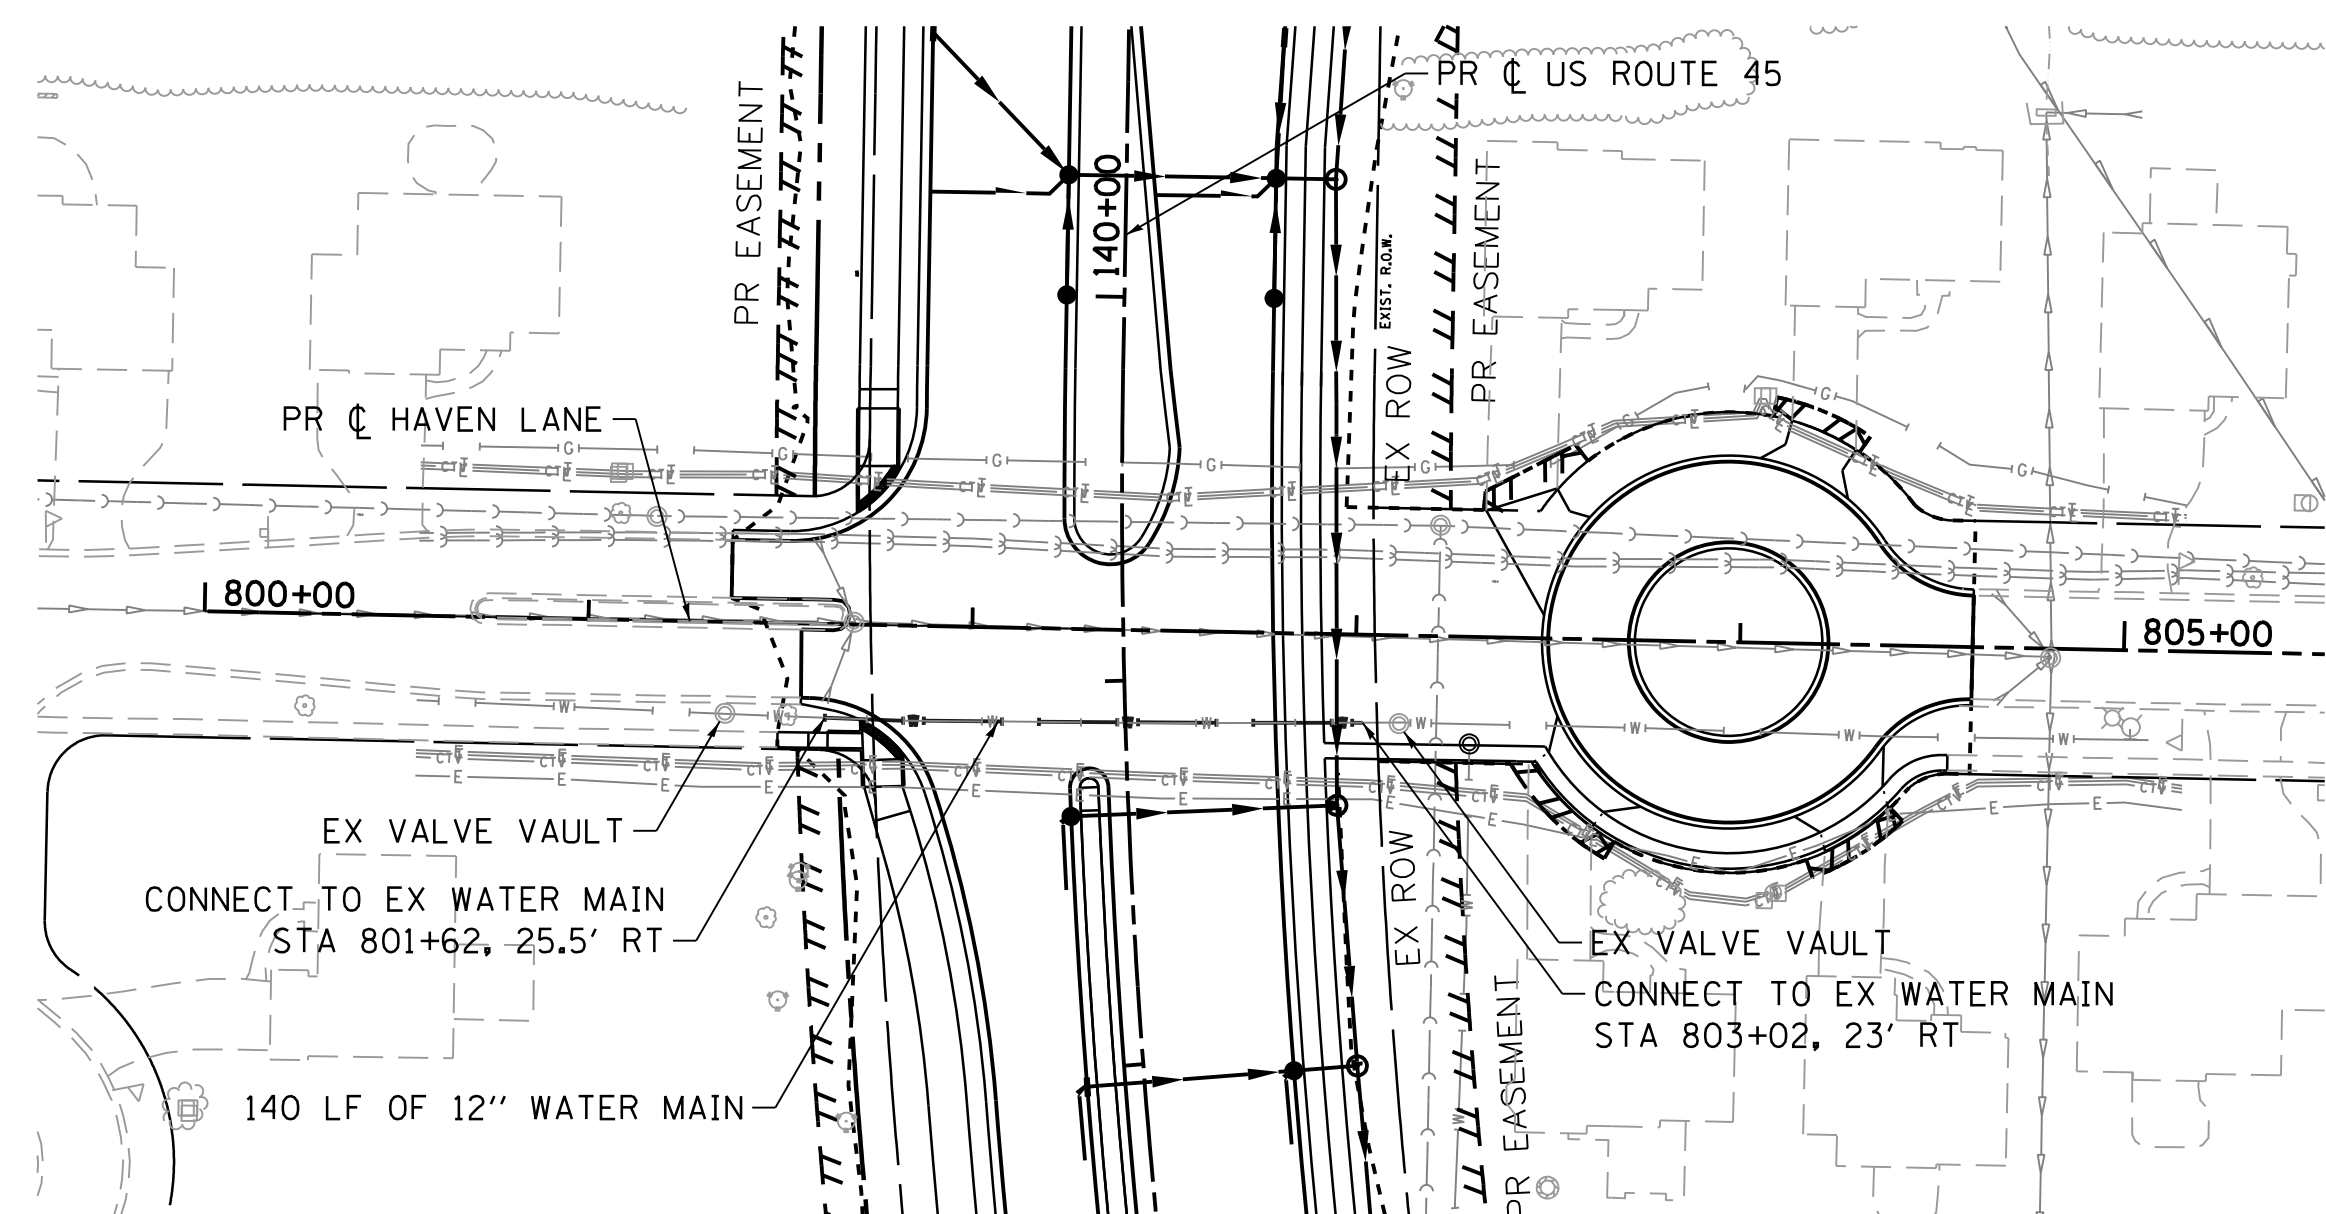

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USER NAME = 35361	DESIGNED SS	REVISED -
	DRAWN SJ	REVISED
PLOT SCALE = 50.0000' / in.	CHECKED VW	REVISED
PLOT DATE = 12/6/2017	DATE 02/02/2017	REVISED

**STATE OF ILLINOIS
DEPARTMENT OF TRANSPORTATION**

**WATER MAIN AND SANITARY SEWER - PLAN & PROFILES
US ROUTE 45**

SCALE: 1"=50' SHEET 4 OF 6 SHEETS STA. 137+00 TO STA. 150+00

F.A.P. RTE. 344	SECTION 39 R	COUNTY LAKE	TOTAL SHEETS 510	SHEET NO. 200
CONTRACT NO. 60T75			ILLINOIS FED. AID PROJECT	