04-27-2018 LETTING ITEM 164

# STATE OF ILLINOIS

**DEPARTMENT OF TRANSPORTATION** 

FOR INDEX OF SHEETS, SEE SHEET NO. 2

# PLANS FOR PROPOSED FEDERAL AID HIGHWAY

**FAU ROUTE 1241 (GOLF ROAD) BUTTERFIELD ROAD TO IL ROUTE 21 (MILWAUKEE AVENUE)** RESURFACING SECTION 17-00119-00-RS PROJECT 3WJZ(855) **VILLAGE OF LIBERTYVILLE LAKE COUNTY** 

C-91-189-17

GOLF ROAD - MAJOR COLLECTOR (2016 ADT = 6,900) BEGIN IMPROVEMENTS

STA. 10+81

LOCATION MAP (NOTTO SCALE)

RELEASING FOR BID

END IMPROVEMENTS

STA. 75+85

GROSS LENGTH = 6,504 FT. = 1,23 MILE NET LENGTH = 6.504 FT. = 1.23 MILE

PRINTED BY THE AUTHORITY OF THE STATE OF ILLINOIS

LOCATION OF SECTION INDICATED THUS: -STATE OF ILLINOIS

LAKE

CONTRACT NO. 61E59

17-00119-00-R5

SCHAUMBURG,

**DESIGN SPEED** 

GOLF ROAD - 30 MPH

POSTED SPEED
GOLF ROAD - 25 MPH
(148)
FUNCTIONAL CLASSIFICATION

CONTRACT NO. 61E59

1-800-892-0123

OR 811

CONFORM TO STANDARD SCALES. IN MAKING MEASUREMENTS ON REDUCED PLANS, THE ABOVE SCALES MAY BE USED.

JOINT UTILITY LOCATION INFORMATION FOR EXCAVATION

#### **INDEX OF SHEETS**

SHEET NO.	DESCRIPTION
1	COVER SHEET
2	GENERAL NOTES AND INDEX OF SHEETS
3	GENERAL NOTES AND STANDARD DRAWINGS
4 - 5	SUMMARY OF QUANTITIES
6	LANDSCAPING SCHEDULE OF QUANTITIES
7	TYPICAL SECTIONS
8 - 14	ROADWAY PLANS
15 - 18	PAVEMENT MARKING, SIGNING, AND LANDSCAPING PLANS
19 - 28	SIDEWALK GRADING DETAILS
29 - 36	CONSTRUCTION DETAILS

#### **DRIVEWAY ACCESS**

COMMERCIAL DRIVEWAYS SHALL BE COMPLETED IN HALVES ALLOWING ACCESS TO THEM AT ALL TIMES. COORDINATION WITH PROPERTY OWNERS SHALL BE COMPLETED PRIOR TO CLOSING ANY RESIDENTIAL DRIVEWAYS. ACCESS TO DRIVEWAYS SHALL NOT BE RESTRICTED FOR MORE THAN TWO WEEKS IN TOTAL DURING CONSTRUCTION.

#### CONSTRUCTION SEQUENCE

THIS CONSTRUCTION SEQUENCE WAS DEVELOPED TO MINIMIZE IMPACTS TO PROPERTY OWNERS AND TO PROVIDE AN ADEQUATE METHOD OF INSPECTING THE CONDITION OF THE PAVEMENT BASE AND CURB AND GUTTER. THIS CONSTRUCTION SEQUENCE SHALL BE FOLLOWED UNLESS ALTERNATE SEQUENCE IS APPROVED BY THE ENGINEER AS COORDINATED WITH THE VILLAGE.

- SET UP APPLICABLE TRAFFIC CONTROL MEASURES USING IDOT HIGHWAY STANDARDS AND DISTRICT ONE DETAILS PROVIDED IN THE PLANS.
- 2. SET UP EROSION AND SEDIMENT CONTROL MEASURES.
- 3. REMOVE HOT-MIX ASPHALT PAVEMENT SURFACE.
- 4. THE RESIDENT ENGINEER SHALL INSPECT THE CONDITION OF THE PORTLAND CEMENT CONCRETE PAVEMENT BASE AND MARK THE AREAS REQUIRING PAVEMENT PATCHING. THE ENGINEER WILL ALSO INSPECT THE CONDITION OF COMBINATION CONCRETE CURB AND GUTTER AND MARK THE LIMITS OF CURB AND GUTTER REQUIRING REPLACEMENT. UNDER NO CONDITION SHALL THE CONTRACTOR PROCEED WITH THIS WORK WITHOUT PRIOR CONSENT FROM THE ENGINEER.
- 5. REMOVE AND REPLACE COMBINATION CONCRETE CURB AND GUTTER AND INSTALL PAVEMENT PATCHES AS DEFINED BY THE ENGINEER.
- 5. INSTALL SIDEWALK AND DETECTABLE WARNINGS
- INSTALL POLYMERIZED LEVELING BINDER.
- LANDSCAPE.
- INSTALL HMA SURFACE.
- 10. INSTALL PERMANENT PAVEMENT MARKINGS AND SIGNING.

#### SPECIFICATIONS, STANDARDS AND SPECIAL PROVISIONS

- 1. ALL CONSTRUCTION SHALL BE IN ACCORDANCE WITH THE "STANDARD SPECIFICATIONS FOR ROAD AND BRIDGE CONSTRUCTION" ("STANDARD SPECIFICATIONS"), ADOPTED APRIL 1, 2016; THE "SUPPLEMENTAL SPECIFICATIONS AND RECURRING SPECIAL PROVISIONS", ADOPTED JANUARY 1, 2018; THE LATEST EDITION OF THE "ILLINOIS MANUAL ON UNIFORM TRAFFIC CONTROL DEVICES FOR STREETS AND HIGHWAYS" (IMUTCD); THE "STANDARD SPECIFICATIONS FOR WATER AND SEWER CONSTRUCTION IN ILLINOIS", 7TH EDITION, 2014; THE LATEST EDITION OF THE "ILLINOIS URBAN MANUAL"; THE DETAILS IN THE PLANS; AND THE SPECIAL PROVISIONS AND IDOT STANDARD DRAWINGS INCLUDED IN THE CONTRACT DOCUMENTS.
- 2. ALL REFERENCES TO "ENGINEER" SHALL BE INTERPRETED AS THE RESIDENT ENGINEER.
- 3. ALL UTILITY COMPANIES, SCHOOL DISTRICTS, AND LOCAL POLICE AND FIRE DEPARTMENTS SHALL BE NOTIFIED BY THE CONTRACTOR AT LEAST 72 HOURS PRIOR TO THE START OF CONSTRUCTION. THE CONTACT INFORMATION FOR UTILITY COMPANIES IS PROVIDED IN THE SPECIAL PROVISIONS, AND THE VILLAGE WILL PROVIDE ALL OTHER CONTACT INFORMATION FOR THE REMAINING LOCAL AGENCIES AT THE PRECONSTRUCTION MEETING.

#### STAKING

- ALIGNMENT, TIES AND BENCHMARKS ARE NOT PROVIDED IN THE PLANS DUE TO THE SCOPE OF WORK SHOWN IN THE PLANS. AERIAL BACKGROUNDS HAVE BEEN PROVIDED TO AID THE CONTRACTOR IN DETERMINING THE GENERAL LOCATION OF WORK.
- AN EXISTING CENTERLINE HAS BEEN SHOWN FOR ALL THE ROADWAYS. IN GENERAL, THE CENTERLINE REPRESENTS THE CENTER-OF-ROADWAY AND THE CENTER-OF-ROW. THE EXISTING CENTERLINE IS ONLY A BEST-FIT APPROXIMATION BASED ON AERIAL IMAGERY. ITS PURPOSE IS ONLY TO PROVIDE A GENERAL LENGTH OF ROADWAY IMPROVEMENTS.
- 3. ALL DIMENSIONS SHOWN IN THE PLANS ARE APPROXIMATE BASED ON FIELD INVESTIGATIONS. BY NO MEANS SHOULD THE DIMENSIONS ACT AS AN ABSOLUTE LIMIT OF PROPOSED WORK. THE FINAL LENGTHS AND AREAS OF PROPOSED WORK WILL BE DETERMINED IN THE FIELD BY THE ENGINEER.
- 4. THE CONTRACTOR SHALL PROTECT AND CAREFULLY PRESERVE ALL SECTION OR SUBSECTION MONUMENTS OR PROPERTY OR REFERENCE MARKERS UNTIL THE ENGINEER, VILLAGE OR AN AUTHORIZED SURVEYOR HAS WITNESSED OR OTHERWISE REFERENCED THEIR LOCATIONS.

#### PAVING, CURB & GUTTER, AND SIDEWALK

- THE PAVEMENT PATCHING AND CURB AND GUTTER REMOVAL AND REPLACEMENT LOCATIONS SHOWN IN THE PLANS ARE ONLY APPROXIMATIONS MADE DURING THE DESIGN PROCESS BASED ON FIELD INVESTIGATIONS. THE ENGINEER IN THE FIELD SHALL MAKE THE FINAL DETERMINATION ON THE LOCATION OF PAVEMENT PATCHES AND CURB AND GUTTER REMOVAL AND REPLACEMENT.
- 2. THE CONTRACTOR SHALL SAW CUT PAVEMENT, CURB & GUTTER, DRIVEWAY AND SIDEWALK BY MEANS OF AN APPROVED SAW ACCORDING TO ARTICLE 442.03 OF THE STANDARD SPECIFICATIONS TO SEPARATE THE EXISTING MATERIAL TO BE REMOVED ACCORDING TO SECTION 440 OF THE STANDARD SPECIFICATIONS AS SHOWN ON THE PLANS OR AS DIRECTED BY THE ENGINEER.
- 3. BINDER COURSE SHALL NOT BE PLACED ADJACENT TO CURB AND GUTTER UNTIL THE CURB AND GUTTER HAS BEEN PROPERLY CURED AND BACKFILLED TO THE SATISFACTION OF THE ENGINEER.
- 4. HOT-MIX ASPHALT SURFACE COURSE SHALL NOT BE PLACED IN A STAGE UNTIL ALL EARTH EXCAVATION, TOPSOIL PLACEMENT, AND HOT-MIX ASPHALT BINDER COURSE WITHIN THE STAGE HAVE BEEN COMPLETED TO THE SATISFACTION OF THE ENGINEER.
- 5. THE THICKNESSES OF HOT-MIX ASPHALT MIXTURES SHOWN ON THE PLANS ARE NOMINAL. DEVIATIONS MAY OCCUR DUE TO IRREGULARITIES IN THE BINDER OR BASE UPON WHICH THE HOT-MIX ASPHALT MATERIALS ARE PLACED.
- 6. THE FINAL EDGE-OF-PAVEMENT SURFACE ELEVATION SHALL BE  $\frac{1}{4}$ " ABOVE THE GUTTER AS SHOWN IN IDOT HIGHWAY STANDARD 606001.

#### EXCAVATION

. EXCAVATION BENEATH PAVEMENT PATCHES AS SHOWN IN THE PLANS IS ASSUMED TO BE A 50/50 SPLIT OF STABLE MATERIAL AND UNSTABLE MATERIAL. THE FINAL CONDITION OF THE MATERIAL WILL BE DETERMINED BY THE ENGINEER IN THE FIELD. REGARDLESS, THE AREA BENEATH THE PAVEMENT PATCH WILL BE REPLACED WITH AGGREGATE BASE COURSE, TYPE B.

#### **DRIVEWAY RECONSTRUCTION**

- 1. FOR THIS PROJECT THERE IS NO ANTICIPATION TO RECONSTRUCT RESIDENTIAL AND COMMERCIAL DRIVEWAY ENTRANCES. HOWEVER, IF A SITUATION ARISES WHERE DRIVEWAY RECONSTRUCTION IS NEEDED TO COMPLETE THE WORK SHOWN IN THE PLANS, PRIOR APPROVAL SHALL BE OBTAINED FROM THE ENGINEER BEFORE STARTING WORK. THE VILLAGE'S DRIVEWAY RECONSTRUCTION STANDARD FOR ROADWAY RESURFACING PROJECTS IS UP TO 4 FEET BEHIND THE BACK-OF-CURB. THE ENGINEER SHALL MAKE THE FINAL DECISION ON THE LIMITS OF DRIVEWAY RECONSTRUCTION.
- THE "CURB OR CURB AND GUTTER REMOVAL AND REPLACEMENT" DETAIL SHOWS
  A MAXIMUM DRIVEWAY RESTORATION WIDTH OF 18" BEHIND THE BACK-OF-CURB. THIS RESTORATION WIDTH
  WILL NOT BE ALLOWED IF PAVEMENT PATCHING IS BEING DONE IN FRONT OF A CURB AND GUTTER REMOVAL
  AND REPLACEMENT.
- 3. WHEN PERMITTED BY THE ENGINEER, RESIDENTIAL DRIVEWAY RECONSTRUCTION AND COMMERCIAL DRIVEWAY RECONSTRUCTION SHALL BE CONSTRUCTED AS FOLLOWS:

RESIDENTIAL HMA DRIVEWAY RECONSTRUCTION:
-HOT-MIX ASPHALT DRIVEWAY PAVEMENT, 3"
-AGGREGATE BASE COURSE, TYPE B, 6"
RESIDENTIAL PCC DRIVEWAY RECONSTRUCTION:
-PORTLAND CEMENT CONCRETE DRIVEWAY PAVEMENT, 6 INCH
-AGGREGATE BASE COURSE, TYPE B, 4"
COMMERCIAL PCC DRIVEWAY RECONSTRUCTION:
-PORTLAND CEMENT CONCRETE DRIVEWAY PAVEMENT, 8 INCH
-AGGREGATE BASE COURSE, TYPE B, 4"

#### **SEWER**

1. UNLESS OTHERWISE NOTED ON THE PLANS, THE EXISTING DRAINAGE FACILITIES SHALL REMAIN IN USE DURING THE PERIOD OF CONSTRUCTION. LOCATIONS OF EXISTING DRAINAGE STRUCTURES AND SEWERS AS SHOWN ON THE PLANS ARE APPROXIMATE. PRIOR TO COMMENCING WORK THE CONTRACTOR SHALL DETERMINE THE EXACT LOCATIONS OF EXISTING STRUCTURES WHICH ARE WITHIN THE PROPOSED CONSTRUCTION LIMITS. DURING CONSTRUCTION, IF THE CONTRACTOR ENCOUNTERS OR OTHERWISE BECOMES AWARE OF ANY SEWERS, UNDERDRAINS OR FIELD DRAINS WITHIN THE RIGHT-OF-WAY OTHER THAN THOSE SHOWN ON THE PLANS, HE/SHE SHALL SO INFORM THE ENGINEER, WHO SHALL DIRECT THE WORK NECESSARY TO MAINTAIN OR REPLACE THE FACILITIES IN SERVICE AND TO PROTECT THEM FROM DAMAGE DURING CONSTRUCTION IF MAINTAINED. EXISTING FACILITIES TO BE MAINTAINED THAT ARE DAMAGED DUE TO NEGLIGENCE SHALL BE REPLACED ACCORDING TO ARTICLE 107.20 OF THE STANDARD SPECIFICATIONS. SHOULD THE ENGINEER HAVE DIRECTED THE REPLACEMENT OF A FACILITY, THE NECESSARY WORK SHALL BE DONE ACCORDING TO SECTIONS 550 AND 601, AND ARTICLE 104.02 OF THE STANDARD SPECIFICATIONS.

#### **UTILITIES**

SCALE: N.T.S.

- 1. THE CONTRACTOR SHALL COORDINATE CONSTRUCTION ACTIVITIES WITH UTILITY COMPANIES. THE LOCATION OF PUBLIC OR PRIVATE UTILITIES SHOWN ON THE PLANS ARE APPROXIMATE AND THE ENGINEER DOES NOT GUARANTEE THEIR ACCURACY. THE CONTRACTOR WILL BE REQUIRED TO ASCERTAIN THE EXACT LOCATION OF SUCH UTILITIES AND EXERCISE CARE DURING CONSTRUCTION OPERATIONS SO AS NOT TO DAMAGE THEM IN ACCORDANCE WITH THE SPECIAL PROVISIONS AND ARTICLE 107.30 OF THE STANDARD SPECIFICATIONS. THE CONTRACTOR SHALL BE RESPONSIBLE FOR CONTACTING THE OWNERS OF ALL EXISTING UTILITIES SO THAT THEIR FACILITIES MAY BE LOCATED AND ADJUSTED OR MOVED, IF NECESSARY, PRIOR TO THE START OF THE CONSTRUCTION OPERATIONS.
- THE CONTRACTOR SHALL BE RESPONSIBLE FOR THE PROTECTION OF ALL ABOVE AND BELOW GROUND UTILITIES EVEN THOUGH THEY MAY NOT BE SHOWN ON THE PLANS ACCORDING TO ARTICLE 107.20 OF THE STANDARD SPECIFICATIONS.
- THE CONTRACTOR SHALL STAGE CONSTRUCTION NECESSARY TO ACCOMMODATE UTILITY RELOCATION OR ADJUSTMENT.



USER NAME = mJp	DESIGNED - MJP	REVISED -
	DRAWN - MPR	REVISED -
PLOT SCALE = 1.00000 '/ in.	CHECKED - DNM	REVISED -
PLOT DATE = 1/12/2018	DATE - 01/15/18	REVISED -

#### SOIL EROSION AND SEDIMENT CONTROL

- ALL VEGETATIVE AND STRUCTURAL EROSION CONTROL PRACTICES SHALL BE CONSTRUCTED AND MAINTAINED IN ACCORDANCE WITH THE MINIMUM STANDARDS AND SPECIFICATIONS OF THE "ILLINOIS URBAN MANUAL (JUNE, 2013 EDITION)".
- SOIL DISTURBANCE SHALL BE CONDUCTED IN SUCH A MANNER AS TO MINIMIZE EROSION. SOIL STABILIZATION MEASURES SHALL CONSIDER THE TIME OF YEAR, SITE CONDITIONS AND THE USE OF TEMPORARY OR PERMANENT MEASURES.
- ALL EROSION CONTROL MEASURES SHALL BE IN PLACE BEFORE ANY WORK BEGINS.
- THE CONTRACTOR SHALL INSPECT ALL EROSION CONTROL MEASURES WEEKLY AND AFTER EACH  $\frac{1}{2}$ " RUNOFF-PRODUCING RAINFALL EVENT. ANY NECESSARY REPAIRS OR CLEANUP TO MAINTAIN THE EFFECTIVENESS OF SAID MEASURES SHALL BE MADE IMMEDIATELY. ALL MAINTENANCE OF EROSION CONTROL ITEMS IS INCLUDED IN THE COST OF THE ITEM AND NO ADDITIONAL COMPENSATION SHALL BE GIVEN TO THE CONTRACTOR.
- ALL STORM SEWER FACILITIES THAT ARE OR WILL BE FUNCTIONING DURING CONSTRUCTION SHALL BE PROTECTED, FILTERED OR OTHERWISE TREATED TO REMOVE SEDIMENT. MUD AND SEDIMENT DEPOSITS SHALL BE REMOVED FROM THE ROADWAY AT THE END OF EACH WORK DAY BY SHOVELING
- INLET FILTERS SHALL BE PLACED ON ALL CATCH BASINS, INLETS, AND MANHOLES WITH OPEN GRATES IN THE CURB AND GUTTER.
- 7. ALL SLOPES SHALL BE COVERED WITH SOD OR SEED & EROSION CONTROL BLANKET AS SOON AS GRADING AND PLACEMENT OF TOPSOIL HAS BEEN COMPLETED.
- THE EROSION CONTROL MEASURES INDICATED ON THE PLANS ARE THE MINIMUM REQUIREMENTS. ADDITIONAL MEASURES MAY BE REQUIRED AS DIRECTED BY THE ENGINEER.

#### **CLEARING**

CONTRACTOR SHALL PAY SPECIAL ATTENTION TO ARTICLE 201.01(a) OF THE STANDARD SPECIFICATIONS. REMOVAL OF ALL OBSTRUCTIONS IN THE RIGHT-OF-WAY, THAT ARE NOT INCLUDED IN A SPECIFIC REMOVAL ITEM. SHALL BE CONSIDERED CLEARING AND INCLUDED IN THE COST OF THE CONTRACT. THIS SHALL INCLUDE, BUT NOT LIMITED TO, FENCES, WALLS, FOUNDATIONS, BUILDINGS, WOODEN POWER POLES, WOODEN PLANTERS, GATES, AND ALL VEGETATION, TREES, SHRUBS, ETC. LESS THAN 6" IN DIAMETER.

#### **EPOXY COATING ON REINFORCEMENT**

ALL REFERENCES IN THE HIGHWAY STANDARDS AND STANDARD SPECIFICATIONS FOR REINFORCEMENT, DOWEL BARS AND TIE BARS IN PAVEMENT, SHOULDERS, CURB, GUTTER, COMBINATION CURB AND GUTTER AND MEDIAN, AND CHAIR SUPPORTS FOR CRC PAVEMENT, SHALL BE EPOXY COATED, UNLESS NOTED ON THE PLANS.

#### MISCELLANEOUS

- 1. DIMENSIONS: IT SHALL BE THE CONTRACTOR'S RESPONSIBILITY TO VERIFY ALL DIMENSIONS AND CONDITIONS EXISTING IN THE FIELD PRIOR TO ORDERING MATERIALS AND BEGINNING CONSTRUCTION.
- UNLESS OTHERWISE AUTHORIZED BY THE ENGINEER, ALL EXISTING ACCESS POINTS SHALL BE MAINTAINED AT ALL TIMES BY THE CONTRACTOR.

#### SIGNING & STRIPING

- ALL PARKING LANES SHALL BEGIN AND END A MINIMUM DISTANCE OF 30 FEET FROM THE CURB AND GUTTER RADIUS RETURN AT AN INTERSECTION UNLESS OTHERWISE SHOWN IN THE PLANS. PARKING LANES THAT BEGIN OR END AT A DRIVEWAY ENTRANCE SHALL BE OFFSET 3 FEET FROM THE EDGE-OF-DRIVEWAY APRON TAPER
- ALL EXISTING TRAFFIC SIGNS WHICH INTERFERE WITH THE CONTRACTOR'S WORK SHALL BE REMOVED PER ARTICLE 107.25. A RECORD SHALL BE MADE OF THEIR CONDITION, AND THEY SHALL BE SAFELY STORED AND SAFEGUARDED BY THE CONTRACTOR UNTIL THE ENGINEER DETERMINES THAT THEY BE REINSTALLED IN THE PERMANENT LOCATIONS.
- 3. ALL EXISTING SIGNS AND POSTS REMOVED AND NOT REINSTALLED SHALL BE RETURNED TO THE JURISDICTION FROM WHICH IT WAS REMOVED:

VILLAGE OF LIBERTYVILLE PUBLIC WORKS DEPARTMENT YARD 600 NORTH AVENUE LIBERTYVILLE, IL 60048

#### ADDITIONAL SYMBOLS, ABBREVIATIONS AND PATTERNS

X	EXISTING VALVE VAULT	STANDARD NO.	DESCRIPTION
	EXISTING VALVE AND VALVE BOX	000001-06	STANDARD SYMBOLS, ABBREVIATIONS AND PATTERNS
$\searrow \checkmark$	EVICTING FIRE INVENANT	280001-07	TEMPORARY EROSION CONTROL SYSTEMS
$\bigcirc$	EXISTING FIRE HYDRANT	424001-10	PERPENDICULAR CURB RAMPS FOR SIDEWALKS
0	EXISTING DOMESTIC WATER SERVICE BOX	442201-03	CLASS C AND D PATCHES
\ /		606001-07	CONCRETE CURB TYPE B AND COMBINATION CONCRETE CURB AND GUTTER
Д	EXISTING TELEPHONE JUNCTION CHAMBER	701011-04	OFF-RD MOVING OPERATIONS, 2L, 2W, DAY ONLY
īg	EXISTING GAS VALVE	701301-04	LANE CLOSURE, 2L, 2W, SHORT TIME OPERATIONS
	ENISTING GAS VALVE	701311-03	LANE CLOSURE, 2L, 2W, MOVING OPERATIONS - DAY ONLY
$\triangleleft$	EXISTING RAISED REFLECTOR PAVEMENT MARKER	701501-06	URBAN LANE CLOSURE, 2L, 2W, UNDIVIDED
•		701701-10	URBAN LANE CLOSURE, MULTILANE INTERSECTION
	COMBINATION CONCRETE CURB AND GUTTER REMOVAL AND REPLACEMENT	701801-06	SIDEWALK, CORNER OR CROSSWALK CLOSURE
2000000	DETECTABLE WARNING	701901-07	TRAFFIC CONTROL DEVICES
	DETECTABLE WANTING	720001-01	SIGN PANEL MOUNTING DETAILS
	SIDEWALK LANDING AND TURNING SPACE AREA	720006-04	SIGN PANEL ERECTION DETAILS
	SIDEWALK LANDING AND TORNING SPACE AREA	728001-01	TELESCOPING STEEL SIGN SUPPORT
	CLASS D PATCHES (TYPE AND DEPTH NOTED ON ROADWAY PLANS)	780001-05	TYPICAL PAVEMENT MARKINGS
	HOT-MIX ASPHALT SURFACE REMOVAL - BUTT JOINT		DISTRICT ONE DETAILS

DETAIL NO.

BD-8 BD-32

TC-10

TC-13

TC-16

TC-22

# GEOTECHNICAL, PSI AND CCDD REPORTS

THOSE SEEKING THE FULL GEOTECHNICAL, PSI AND CCDD REPORTS SHOULD CONTACT THE OWNER OF RECORD. TO MAKE ARRANGEMENTS FOR ACCESS TO THIS INFORMATION, PLEASE CONTACT:

FREDERICK CHUNG SENIOR PROJECT ENGINEER VILLAGE OF LIBERTYVILLE (847) 247-5435



USER NAME = mJp	DESIGNED	-	MJP	REVISED	=
	DRAWN	-	MPR	REVISED	-
PLOT SCALE = 1.0000 '/ in.	CHECKED	-	DNM	REVISED	-
PLOT DATE = 1/11/2018	DATE	-	01/15/18	REVISED	-

#### STATE OF ILLINOIS **DEPARTMENT OF TRANSPORTATION**

SCALE: N.T.S.

					F.A.U. RTE.	SECTION
GENERAL NOTES AND STATE STANDARDS						17-00119-00-RS
GLIVLIVA	LINUILO					
HEET	OF	CHECTO	CTA	TO CTA		

STATE STANDARDS

DESCRIPTION

DETAILS FOR FRAMES AND LIDS ADJUSTMENT WITH MILLING

PAVEMENT MARKING LETTERS AND SYMBOLS FOR TRAFFIC STAGING

TRAFFIC CONTROL AND PROTECTION FOR SIDE ROADS, INTERSECTIONS, AND DRIVEWAYS

BUTT JOINT AND HMA TAPER DETAILS

ARTERIAL ROAD INFORMATION SIGN

DISTRICT ONE TYPICAL PAVEMENT MARKINGS

### **SUMMARY OF QUANTITIES**

CONS	TRUCTI	ON	CODE	S
STP	URBAN	FUI	ND I NG	;

80% FEDERAL / 20% LOCAL

SUMMARY OF QUANTITIES				GOLF ROAD		
CODE NO.	ITEM	UNIT	TOTAL QUANTITY	ROADWAY RESURFACE 0005	SAFETY 0021	
20101000	TEMPORARY FENCE	FOOT	2,080	2,080	0	
20101200	TREE ROOT PRUNING	EACH	22	22	0	
20101300	TREE PRUNING (1 TO 10 INCH DIAMETER)	EACH	7	7	0	
20101350	TREE PRUNING (OVER 10 INCH DIAMETER)	EACH	34	34	0	
20200100	EARTH EXCAVATION	CU YD	456	456	0	
		00 12	133	,,,,,,,,,,,,,,,,,,,,,,,,,,,,,,,,,,,,,,,		
20201200	REMOVAL AND DISPOSAL OF UNSUITABLE MATERIAL	CU YD	456	456	0	
21101615	TOPSOIL FURNISH AND PLACE, 4"	SQ YD	1,408	1,408	0	
25000400	NITDOCEN CENTILIZED MUTDICALT	POUND	1.0	1.0	0	
23000400	NITROGEN FERTILIZER NUTRIENT	POUND	18	18	0	
25000600	POTASSIUM FERTILIZER NUTRIENT	POUND	18	18	0	
25200110	SODDING, SALT TOLERANT	SQ YD	1,408	1,408	0	
25200200	SUPPLEMENTAL WATERING	UNIT	13	13	0	
	JOHN ELPIENTAL WATERTRO	0,111	13	13	0	
28000510	INLET FILTERS	EACH	51	51	0	
35101500	AGGREGATE BASE COURSE, TYPE B	CU YD	734	734	0	
40201000	AGGREGATE FOR TEMPORARY ACCESS	TON	50	50	0	
40600290	BITUMINOUS MATERIALS (TACK COAT)	POUND	18,290	18,290	0	
40600400	MIXTURE FOR CRACKS, JOINTS, AND FLANGEWAYS	TON	60	60	0	
40600827	POLYMERIZED LEVELING BINDER (MACHINE METHOD), IL-4.75, N50	TON	1,524	1,524	0	
40600982	HOT-MIX ASPHALT SURFACE REMOVAL - BUTT JOINT	SQ YD	319	319	0	
40603335	HOT-MIX ASPHALT SURFACE COURSE, MIX "D", N50	TON	3,041	3,041	0	
42001300	PROTECTIVE COAT	SQ YD	1,775	1,775	0	
42300200	PORTLAND CEMENT CONCRETE DRIVEWAY PAVEMENT, 6 INCH	SQ YD	493	493	0	
42300400	PORTLAND CEMENT CONCRETE DRIVEWAY PAVEMENT, 8 INCH	SQ YD	85	85	0	
42400200	PORTLAND CEMENT CONCRETE SIDEWALK 5 INCH	SQ FT	4,549	4,549	0	
42400800	DETECTABLE WARNINGS	SO ET	453	453	0	
72400000	DETECTABLE WARNINGS	SQ FT	433	455	U	

CONSTRUCTION CODES
STP URBAN FUNDING
0% FEDERAL / 20% LOCAL

	SUMMARY OF QUANTITIES			GOLF	ROAD
CODE NO.	ITEM	UNIT	TOTAL QUANTITY	ROADWAY RESURFACE 0005	SAFETY 0021
44201725	CLASS D PATCHES, TYPE 1, 7 INCH	SQ YD	59	59	0
44201729	CLASS D PATCHES, TYPE II, 7 INCH	SQ YD	503	503	0
44201733	CLASS D PATCHES, TYPE III, 7 INCH	SQ YD	763	763	0
44201735	CLASS D PATCHES, TYPE IV, 7 INCH	SQ YD	6,800	6,800	0
67000400	ENGINEER'S FIELD OFFICE, TYPE A	CAL MO	5	5	0
67100100	MOBILIZATION	L SUM	1	1	0
70102620	TRAFFIC CONTROL AND PROTECTION, STANDARD 701501	L SUM	1	0	1
70102635	TRAFFIC CONTROL AND PROTECTION, STANDARD 701701	L SUM	1	0	1
70102640	TRAFFIC CONTROL AND PROTECTION, STANDARD 701801	L SUM	1	0	1
70300100	SHORT TERM PAVEMENT MARKING	FOOT	4,509	0	4,509
70300150	SHORT TERM PAVEMENT MARKING REMOVAL	SQ FT	507	0	507
70300210	TEMPORARY PAVEMENT MARKING LETTERS AND SYMBOLS	SQ FT	291	0	291
70300220	TEMPORARY PAVEMENT MARKING - LINE 4"	FOOT	22,932	0	22,932
70300240	TEMPORARY PAVEMENT MARKING - LINE 6"	FOOT	705	0	705
70300280	TEMPORARY PAVEMENT MARKING - LINE 24"	FOOT	473	0	473
72000100	SIGN PANEL - TYPE 1	SQ FT	193	0	193
72400100	REMOVE SIGN PANEL ASSEMBLY - TYPE A	EACH	55	0	55
72800100	TELESCOPING STEEL SIGN SUPPORT	FOOT	176	0	176
78000100	THERMOPLASTIC PAVEMENT MARKING - LETTERS AND SYMBOLS	SQ FT	146	0	146
78000200	THERMOPLASTIC PAVEMENT MARKING - LINE 4"	FOOT	22,324	0	22,324
78000400	THERMOPLASTIC PAVEMENT MARKING - LINE 6"	FOOT	1,947	0	1,947
		5007		0	
78000600	THERMOPLASTIC PAVEMENT MARKING - LINE 12"	FOOT	48		48
78000650	THERMOPLASTIC PAVEMENT MARKING - LINE 24"	FOOT	238	0	238
78100100	RAISED REFLECTIVE PAVEMENT MARKER	EACH	28	0	28
78300200	RAISED REFLECTIVE PAVEMENT MARKER REMOVAL	EACH	22	0	22
Z0004510	HOT-MIX ASPHALT DRIVEWAY PAVEMENT, 3"	SQ YD	59	59	0

\*THIS DESIGNATES SPECIALTY ITEMS



44000200 DRIVEWAY PAVEMENT REMOVAL

44000600 SIDEWALK REMOVAL

USER NAME = mjp	DESIGNED - NEM	REVISED -
	DRAWN - MPR	REVISED -
PLOT SCALE = 1.0000 '/ in.	CHECKED - DNM	REVISED -
PLOT DATE = 1/11/2018	DATE - 01/15/18	REVISED -

SQ YD

5Q FT

636

4,821

636

4,821

GOLF ROAD					SECTION	COUNTY	SHEETS	NO.
SUMMARY OF QUANTITIES					17-00119-00-RS	LAKE	36	4
SOMMAN OF QUANTITIES								51E59
SCALE: N.T.S. SHEET O	F SHEETS	STA.	TO STA.	ILLINOIS FED. AID PROJECT				

### **SUMMARY OF QUANTITIES**

CONS	TRUCTI	ON	CODES	
 STP	URBAN	FUI	ND I NG	

80% FEDERAL / 20% LOCAL

	SUMMARY OF QUANTITIES	SUMMARY OF QUANTITIES GOLF RO		ROAD	
CODE NO.	ITEM	UNIT	TOTAL QUANTITY	ROADWAY RESURFACE 0005	SAFETY 0021
Z0004562	COMBINATION CONCRETE CURB AND GUTTER REMOVAL AND REPLACEMENT	FOOT	2,602	2,602	0
Z0004910	HOT-MIX ASPHALT FOR PATCHING POTHOLES (HOT MIX)	TON	30	30	0
Z0017400	DRAINAGE & UTILITY STRUCTURES TO BE ADJUSTED	EACH	7	7	0
Z0017700	DRAINAGE & UTILITY STRUCTURES TO BE RECONSTRUCTED	EACH	1	1	0
Z0030850	TEMPORARY INFORMATION SIGNING	SQ FT	52	0	52
X0320050	CONSTRUCTION LAYOUT (SPECIAL)	L SUM	1	0	1
X0320586	FLEXIBLE DELINEATORS	EACH	16	0	16
X2130010	EXPLORATION TRENCH, SPECIAL	FOOT	250	250	0
X4400196	HOT-MIX ASPHALT SURFACE REMOVAL, SPECIAL	SQ YD	27,096	27,096	0
X6026624	VALVE BOXES TO BE ADJUSTED (SPECIAL)	EACH	2	2	0
X6030310	FRAMES AND LIDS TO BE ADJUSTED (SPECIAL)	EACH	11	11	0
X7015005	CHANGEABLE MESSAGE SIGN	CAL DAY	100	0	100
X7800200	PAINT PAVEMENT MARKING CURB	FOOT	333	0	333

\*THIS DESIGNATES SPECIALTY ITEMS

CIVILTECH

USER NAME = mjp	DESIGNED -	-	NEM	REVISED	-
	DRAWN -	-	MPR	REVISED	-
PLOT SCALE = 1.0000 '/ in.	CHECKED -	-	DNM	REVISED	-
PLOT DATE = 1/11/2018	DATE -	-	01/15/18	REVISED	-

STATE OF ILLINOIS
DEPARTMENT OF TRANSPORTATION

		G	F.A.U. RTE.				COUNTY TOTA		SHEET NO.			
	1241	17-0011	9-00-RS		LAKE	36	5					
		SUMMAN	RY OF QUA	IVIIILO						CONTRACT	NO.	61E59
CALE: N.T.S.	SHEET	OF	SHEETS	STA.	TO STA.			ILLINOIS	FED. Al	D PROJECT		

### LANDSCAPING SCHEDULE OF QUANTITIES

				LANDSCAPIN	G SCHEDULE		
SHEET NO.	STATION	OFFSET	LT/ RT	20101000 TEMPORARY FENCE	20101200 TREE ROOT PRUNING	20101300 TREE PRUNING (1 TO 10 INCH DIAMETER)	20101350 TREE PRUNING (OVER 10 INCH DIAMETER)
		(FEET)		(FOOT)	(EACH)	(EACH)	(EACH)
15	10+88.8	28.2	RT	40			1
15	11+15.7	29.1	RT	40			1
15	12+56.4	27.2	LT			1	
15	12+95.5	27.6	LT	40			1
15	13+01.6	26.1	RT	40			1
15	13+33.8	26.1	LT	40	1		1
15	13+59.0	26.7	RT				1
15	14+04.8	26.2	LT	40			1
15	14+56.4	26.5	RT	40	1		1
15	15+03.8	27.6	RT				1
15	15+57.8	28.1	LT			1	
15	16+03.3	27.8	RT	40			1
15	16+32.4	28.6	LT	40	1		1
15	16+60.3	26.0	RT				1
15	16+95.3	28.5	LT				1
15	17+54.7	28.4	RT	40		1	_
15	18+78.9	28.1	LT	40	1	_	1
15	19+56.4	43.3	LT	40	1		
15	20+06.5	26.6	LT		-		1
15	20+32.8	28.6	RT				1
15	20+80.4	25.7	LT				1
15	21+37.1	27.4	RT	40	1		1
15	22+06.5	25.9	LT	40	1		1
15	22+28.2	26.0	RT				1
16	24+15.4	30.5	LT				1
16	24+16.5	26.6	RT				1
16	24+16.5	30.0	RT	40	1		1
16	25+51.3	30.8	RT	40	1		1
16	25+75.3	31.0	RT	40	1		1
16	26+03.8	29.5	RT	40	1	1	
	26+15.5			40	1	1	1
16		25.9	LT	40	1	1	1
16	26+50.3	27.8	RT	40	1	1	
16	26+51.7	27.9	LT	40			
16	26+91.6	28.2	RT	40			1
16	26+94.1	25.2	LT	40			1
16	27+83.2	48.6	RT	40	1		
16	27+88.4	45.8	LT	40	1		
16	28+45.0	48.7	LT	40	1		
16	28+60.9	45.4	RT	40	1		
16	28+66.0	27.7	RT	40	1		
16	29+20.8	30.1	LT	40			
16	29+23.4	27.7	RT	40	1	1	
16	30+28.2	30.8	RT	40			
16	31+14.0	30.7	RT	40			
16	31+38.2	30.7	RT	40			
16	32+59.6	28.5	RT				1
16	35+91.3	28.3	RT	40			
16	36+37.7	26.5	RT	40			
16	37+85.8	29.1	LT	40	1		1
16	38+60.8	46.9	LT	40	1		

				LANDSCAPIN	IG SCHEDULE		
SHEET NO.	STATION OFFSET		LT/ RT	20101000 TEMPORARY FENCE	20101200 TREE ROOT PRUNING	20101300 TREE PRUNING (1 TO 10 INCH DIAMETER)	20101350 TREE PRUNING (OVER 10 INCH DIAMETER)
		(FEET)		(FOOT)	(EACH)	(EACH)	(EACH)
16	41+25.7	27.1	RT	40	1		
16	42+07.9	28.6	RT	40			
16	42+29.9	28.4	LT	40	1		1
16	42+88.3	27.1	RT	40			
16	43+16.2	28.1	LT				1
16	43+87.2	29.2	RT	40			
16	43+88.0	28.5	LT	40			1
17	44+82.3	29.4	LT	40			
17	45+25.4	28.5	LT	40	1		
17	45+28.4	28.4	RT	40			1
17	45+98.4	27.7	RT	40	1		1
17	46+21.6	27.5	LT	40			
17	48+46.0	29.3	RT	40		1	
17	50+06.9	27.9	RT	40			
17	50+18.5	28.8	LT	40			
17	59+17.7	27.0	RT	40			1
17	60+04.9	27.1	RT	40			
17	60+92.0	26.2	RT	40			
	TO	TAL QUAN	TITY=	2080	22	7	34

### **NOTES**

SCALE: N.T.S.


- 1. PRIOR TO START OF ANY WORK, THE CONTRACTOR SHALL INVESTIGATE ALL TREE BRANCHES THAT OVERHANG INTO THE ROADWAY. ANY BRANCHES THAT WILL BE IN CONFLICT WITH CONSTRUCTION EQUIPMENT SHALL BE REPORTED TO THE ENGINEER. THE ENGINEER WILL MAKE THE FINAL DECISION ON TREES REQUIRING TREE PRUNING.
- 2. THE ENGINEER WILL DETERMINE AREAS WHERE TEMPORARY FENCE MAY BE NEEDED TO PROTECT TREES IN CLOSE PROXIMITY TO CONSTRUCTION OPERATIONS. TEMPORARY FENCE SHALL BE PLACED AROUND THE TREE AT DRIP LINE. NEW TEMPORARY FENCE OR THE RELOCATION OF TEMPORARY FENCE FROM ONE LOCATION TO ANOTHER LOCATION SHALL BE PAID FOR AS "TEMPORARY FENCE". THE TEMPORARY FENCE SHALL NOT BE RELOCATED UNTIL ALL WORK IS COMPLETED IN THAT AREA.
- 3. EXCAVATION NEAR TREES MAY REQUIRE TREE ROOT PRUNING AS DIRECTED BY THE ENGINEER.



USER NAME = mJp	DESIGNED - NEM	REVISED -
	DRAWN - NEM	REVISED -
PLOT SCALE = 1.00000 ' / in.	CHECKED - DNM	REVISED -
PLOT DATE = 1/11/2018	DATE - 01/15/18	REVISED -


STATE OF ILLINOIS
DEPARTMENT OF TRANSPORTATION

		GC	DLF ROAD	)		F.A.U. RTE	SECT	ION		COUNTY	TOTAL SHEETS	
LANDSCAPING SCHEDULE OF QUANTITIES						1241	17-0011	9-00-RS		LAKE	36	6
	LANDSCAPING SCHEDULE OF QUANTITIES									CONTRACT	NO.	61E59
	SHEET	OF	SHEETS	STA.	TO STA.			ILLINOIS	FED. A	ID PROJECT		

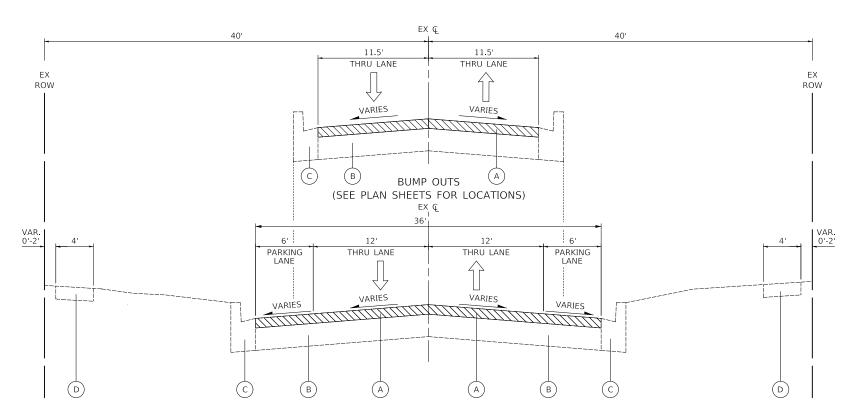

#### **EXISTING TYPICAL SECTION**

STA. 10+81 TO STA. 75+85, GOLF ROAD

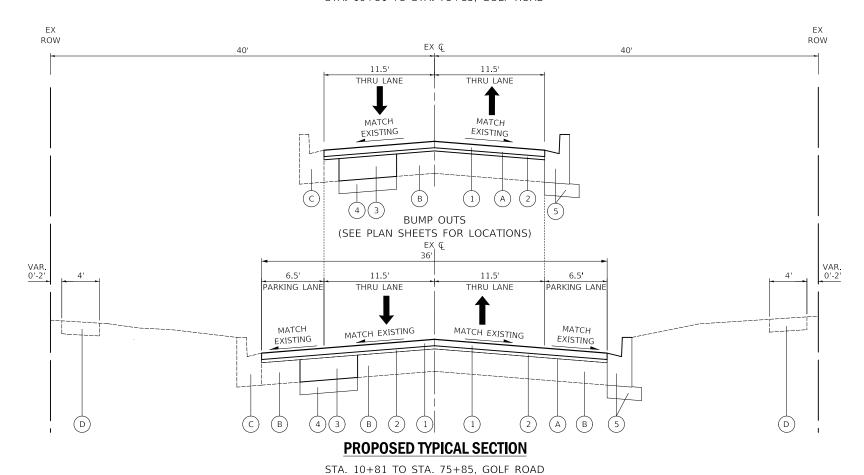

#### LEGEND

- (A) EXISTING HOT-MIX ASPHALT SURFACE PAVEMENT: -GOLF ROAD =  $1\frac{1}{2}$ " TO  $3\frac{1}{2}$ "
- B EXISTING PORTLAND CEMENT CONCRETE PAVEMENT:
  -GOLF ROAD = 5" TO 7"
- EXISTING COMBINATION CONCRETE CURB AND GUTTER:
  -GOLF ROAD = TYPE B-6.18
- (D) EXISTING PORTLAND CEMENT CONCRETE SIDEWALK
- (1) HOT-MIX ASPHALT SURFACE COURSE, MIX "D", N50, 2"
- 2 POLYMERIZED LEVELING BINDER (MACHINE METHOD), IL-4.75, N50, 3/4"
- (3) CLASS D PATCHES, TYPE AS NOTED ON PLANS, 7 INCH (SEE NOTE 2)
- 4 AGGREGATE BASE COURSE, TYPE B, 4"
  (MEASURED FOR PAYMENT IN CUBIC YARDS)
- 5 COMBINATION CONCRETE CURB AND GUTTER REMOVAL AND REPLACEMENT (AGGREGATE BASE COURSE, TYPE B, 4" IS INCLUDED IN COST OF ITEM) (SEE NOTE 3)



HOT-MIX ASPHALT SURFACE REMOVAL, SPECIAL (SEE NOTE 1)

#### **NOTES**

- 1. THE CONTRACTOR SHALL REMOVE 2¾" OF THE EXISTING HMA OVERLAY. IN SITUATIONS WHERE THERE IS LESS THAN 2¾" OF EXISTING HMA OVERLAY, THE CONTRACTOR SHALL REDUCE THE HMA SURFACE REMOVAL TO 2" (MIN.). UNDER NO CONDITION SHALL THE CONTRACTOR REMOVE LESS THAN 2" OF MATERIAL, EVEN IF IT REQUIRES SOME REMOVAL OF THE PCC BASE PAVEMENT. FOR MORE DETAILS, SEE THE SPECIAL PROVISION FOR "HOT-MIX ASPHALT SURFACE REMOVAL, SPECIAL".
- THE ENGINEER SHALL MAKE THE FINAL DETERMINATION OF THE LOCATION, WIDTH, AND LENGTH OF CLASS D PATCHES IN THE FIELD.
- 3. THE ENGINEER SHALL MAKE THE FINAL DETERMINATION OF THE LOCATION AND LENGTH OF THE REMOVAL AND REPLACEMENT OF COMBINATION CONCRETE CURB AND GUTTER IN THE FIELD. SEE DISTRICT ONE DETAIL BD-24 "CURB OR CURB AND GUTTER REMOVAL AND REPLACEMENT" FOR ADDITIONAL DETIALS.
- 4. THE CONTRACTOR SHALL MILL THE EXISTING PAVEMENT SURFACE PRIOR TO PAVEMENT PATCHING.

HOT-MIX ASPHALT MIXTURE REQUIREMENTS	
MIXTURE TYPE	AIR VOIDS @ NDES
PAVEMENT RESURFACING	
HOT-MIX ASPHALT SURFACE COURSE, MIX "D", N50 (IL 9.5 mm); 2"	4% @ 50 GYR.
POLYMERIZED LEVELING BINDER (MACHINE METHOD), IL-4.75, N50; 3/4"	3.5% @ 50 GYR.
CLASS D PATCHES	
CLASS D PATCH (HMA BINDER IL-19.0 mm)	4% @ 70 GYR.
HOT-MIX ASPHALT DRIVEWAY PAVEMENT	
HOT-MIX ASPHALT SURFACE COURSE, MIX "D", N50 (IL 9.5 mm); 3"	4% @ 50 GYR.

THE UNIT WEIGHT USED TO CALCULATE ALL HOT-MIX ASPHALT MIXTURES IS 112 LB/SQ YD/IN. THE "AC-TYPE" FOR POLYMERIZED HMA MIXES SHALL BE "SBS/SBR PG 76-22" AND FOR NON-POLYMERIZED HMA MIXES SHALL BE "PG 64-22" UNLESS MODIFIED BY DISTRICT ONE SPECIAL PROVISIONS.

CIVILTECH


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	DRAWN	-	MPR	REVISED	-
PLOT SCALE = 1.0000 '/ in.	CHECKED	-	DNM	REVISED	-
PLOT DATE = 1/11/2018	DATE	_	01/15/18	REVISED	-

STATE OF ILLINOIS
DEPARTMENT OF TRANSPORTATION

SCALE: N.T.S.

SHEET

GOLF ROAD					SECTIO	V	COUNTY	TOTAL SHEETS	SHEET NO.
TYPICAL SECTIONS				1241	17-00119-00-RS		LAKE	36	7
ITPICAL SECTIONS							CONTRACT	NO. 6	1E59
OF	SHEETS	STA.	TO STA.		TIT	INOIS FED.	AID PROJECT		

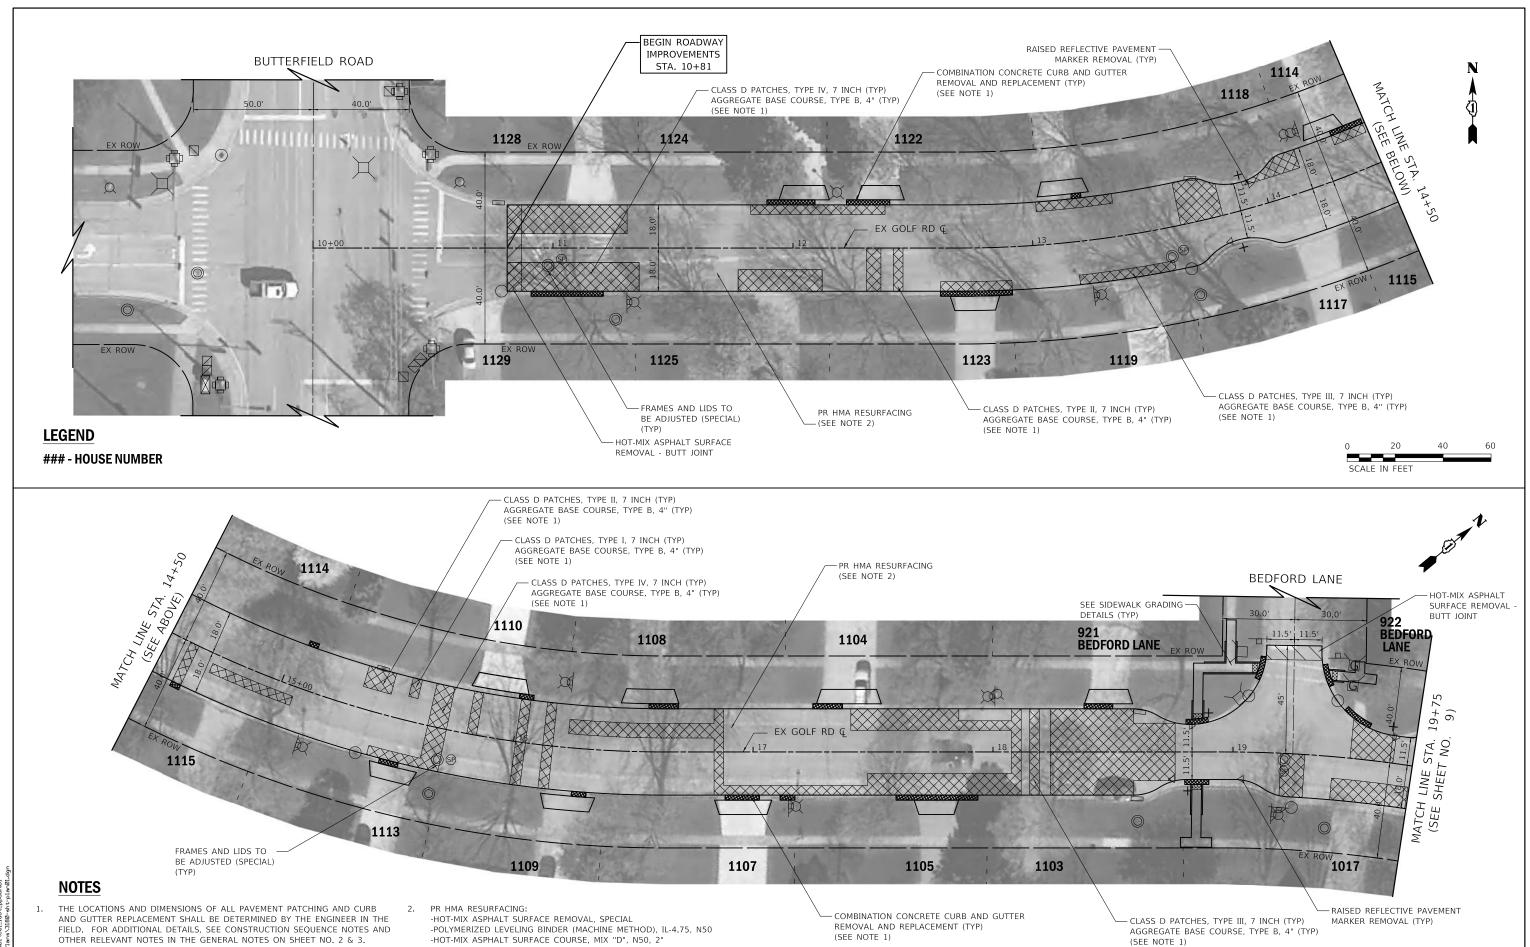

DESIGNED - NEM JSER NAME = mjp REVISED DRAWN MPR REVISED CIVILTECH LOT SCALE = 20.0000 '/ in. HECKED -DNM REVISED PLOT DATE = 1/11/2018 DATE 01/15/18 REVISED

STATE OF ILLINOIS **DEPARTMENT OF TRANSPORTATION** 

REMOVAL AND REPLACEMENT (TYP)


SCALE: 1" = 20' SHEET


(SEE NOTE 1)

SECTION **GOLF ROAD** 1241 17-00119-00-RS LAKE 36 **ROADWAY PLAN** CONTRACT NO. 61E59 SHEETS STA. 10+00 TO STA. 19+75

AGGREGATE BASE COURSE, TYPE B, 4" (TYP)

(SEE NOTE 1)

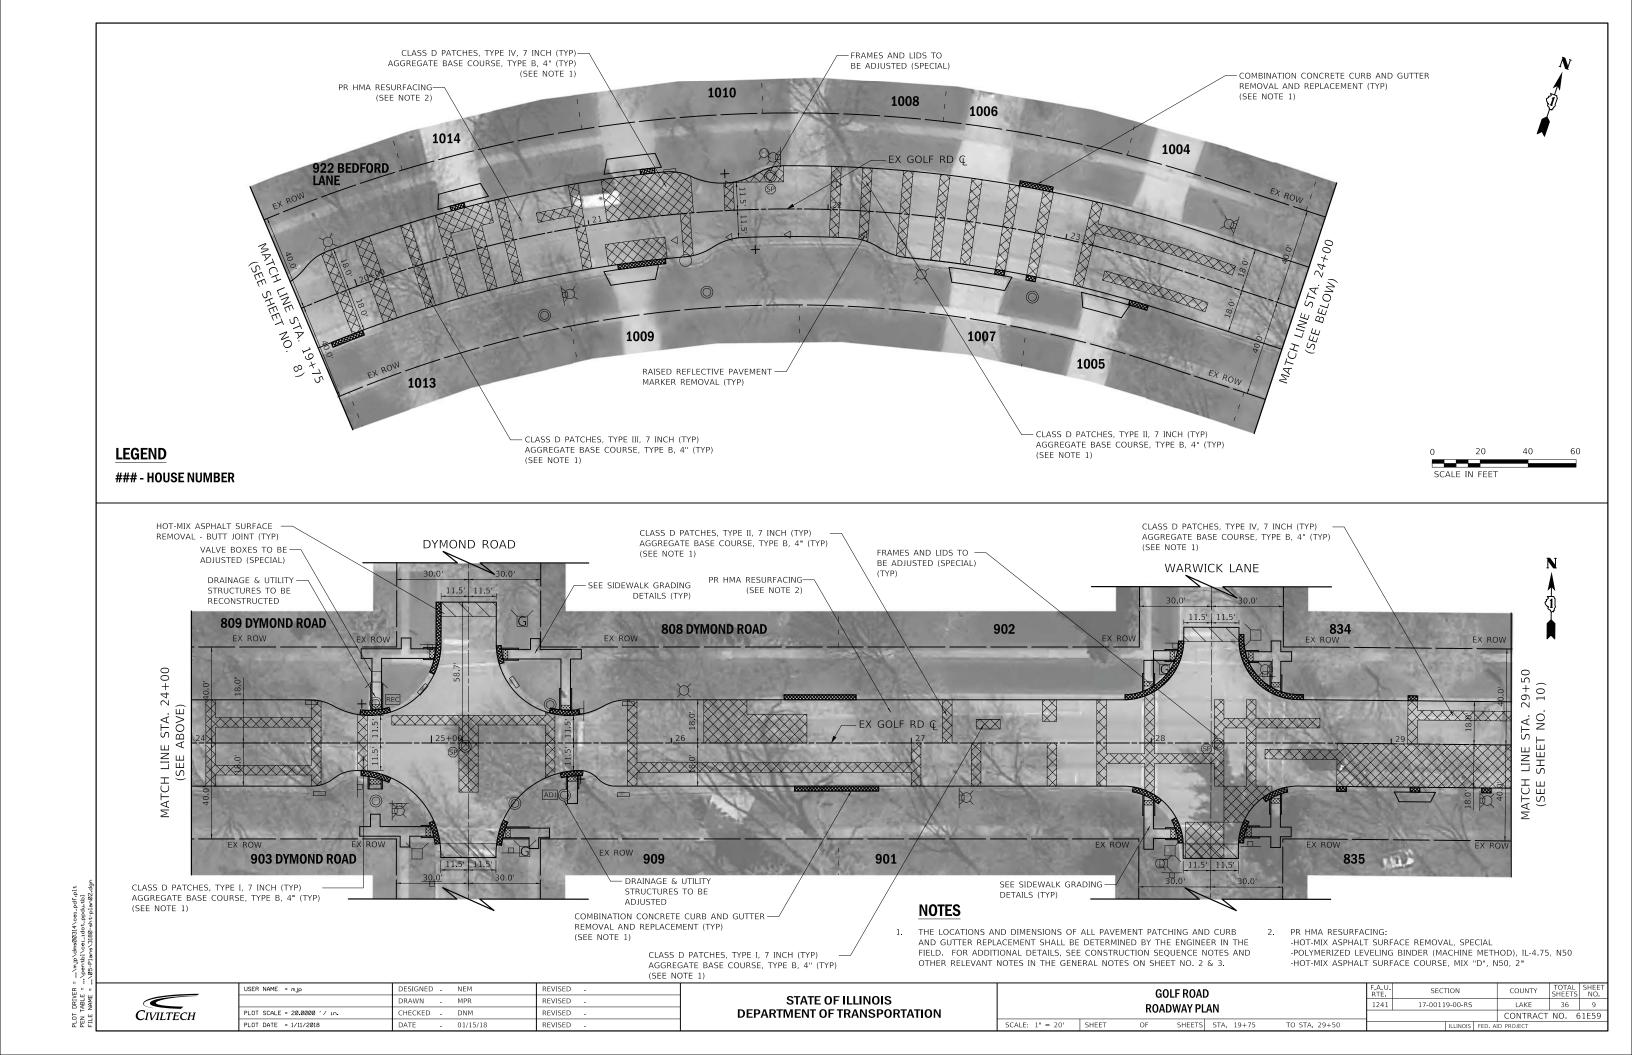

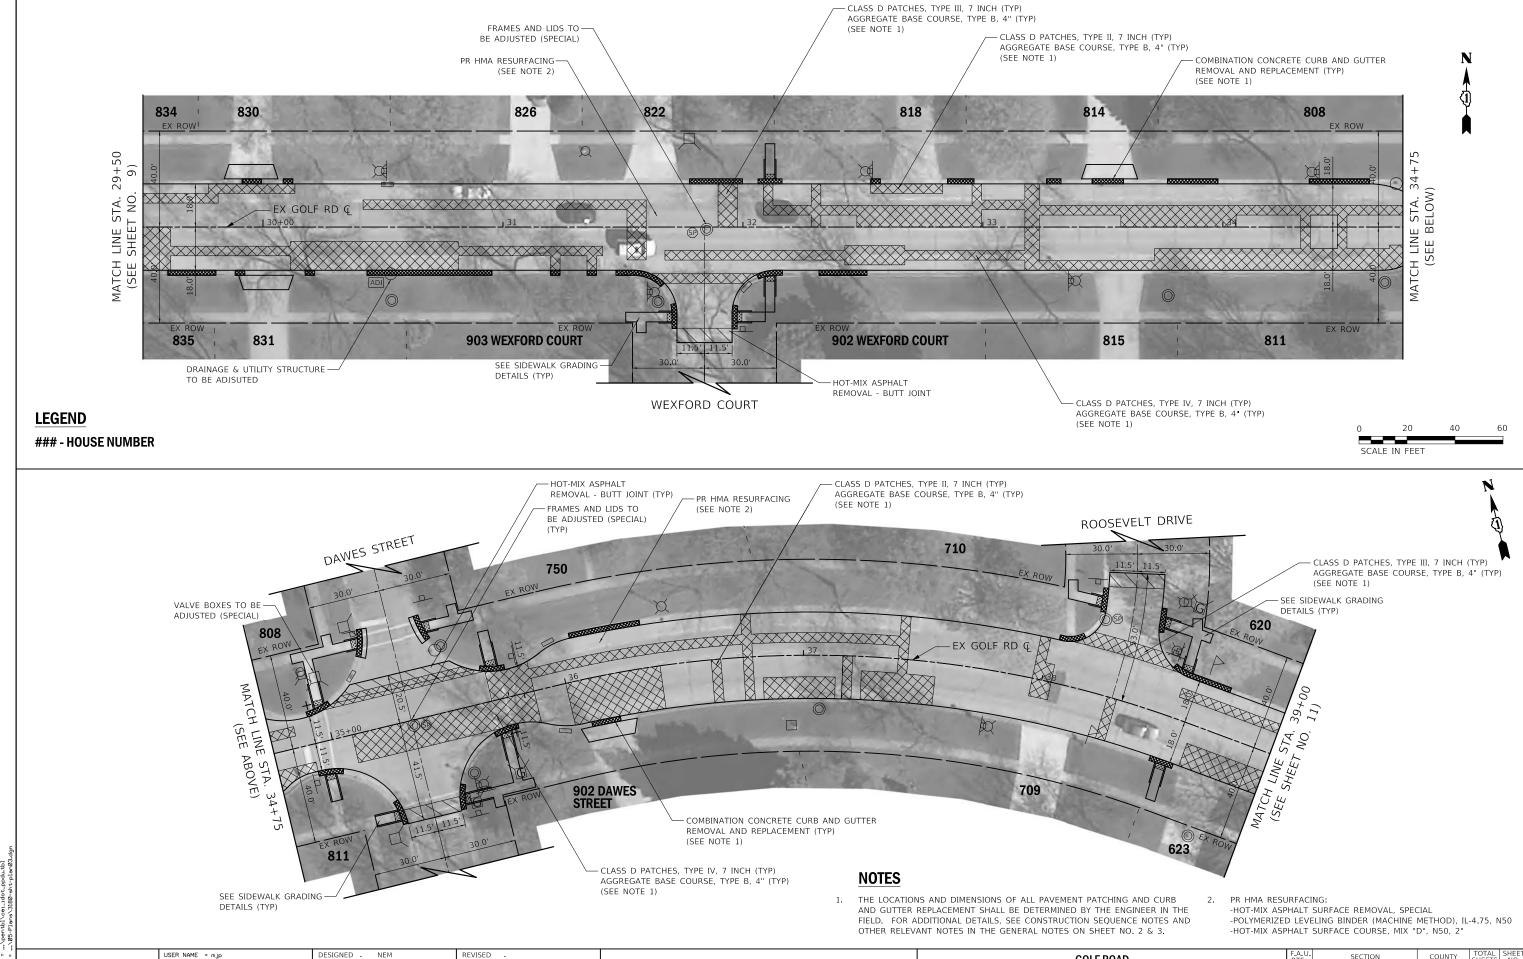

STATE OF ILLINOIS

**DEPARTMENT OF TRANSPORTATION** 

SECTION

17-00119-00-RS

LAKE

36 10

CONTRACT NO. 61E59

**GOLF ROAD** 

**ROADWAY PLAN** 

SHEETS STA. 29+50

TO STA. 39+00

SCALE: 1" = 20' SHEET

CIVILTECH

DRAWN

DATE

HECKED -

LOT SCALE = 20.0000 '/ in.

PLOT DATE = 1/11/2018

MPR


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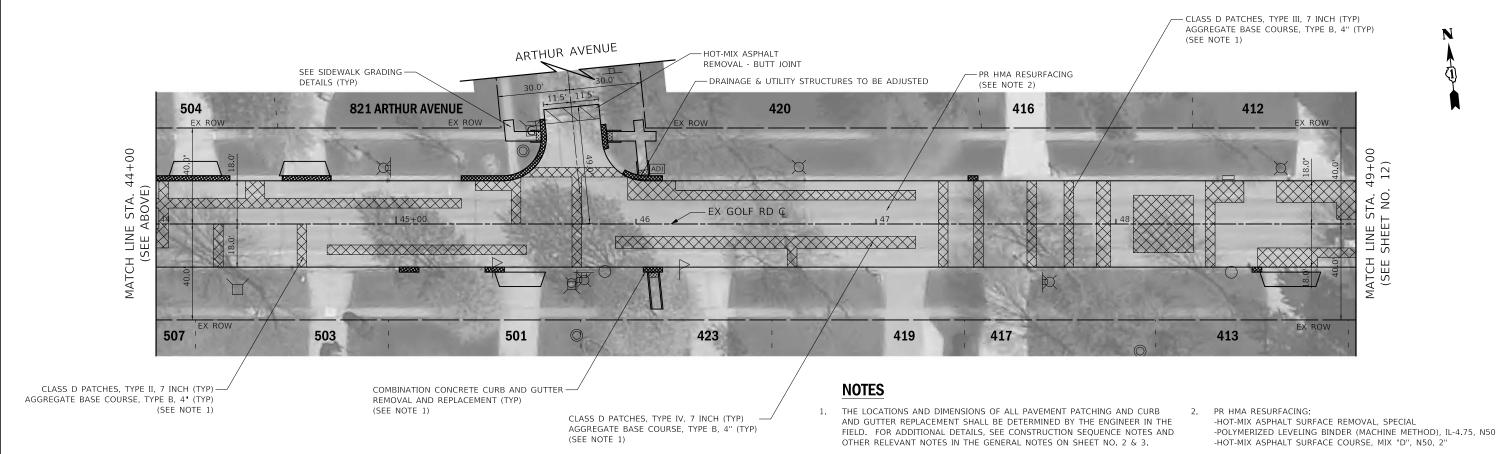
01/15/18

REVISED

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CIVILTECH


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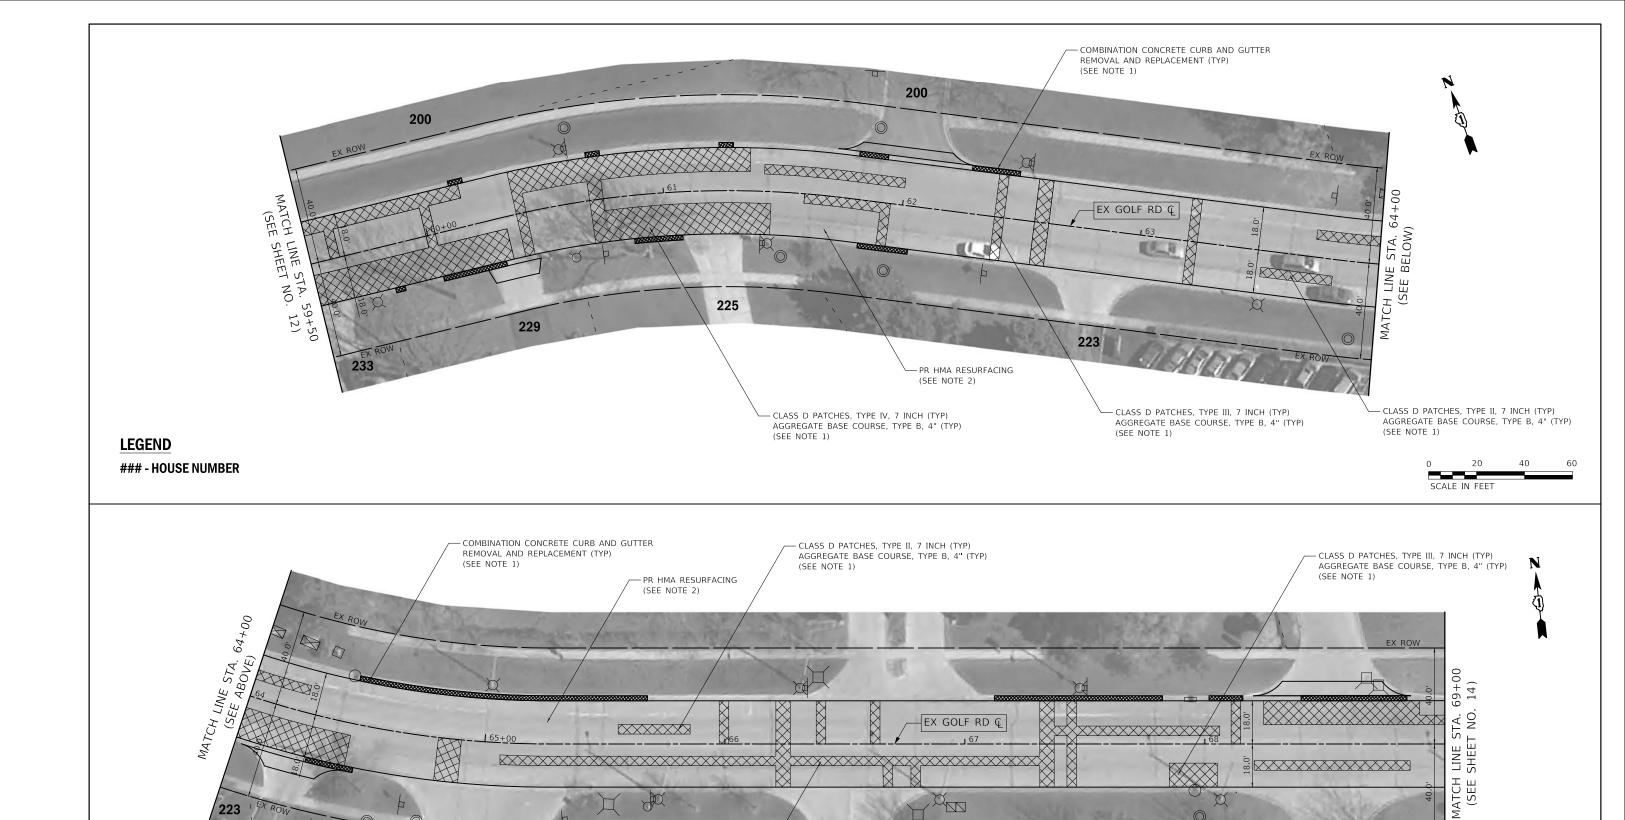
STATE OF ILLINOIS **DEPARTMENT OF TRANSPORTATION** 

SCALE: 1" = 20' SHEET

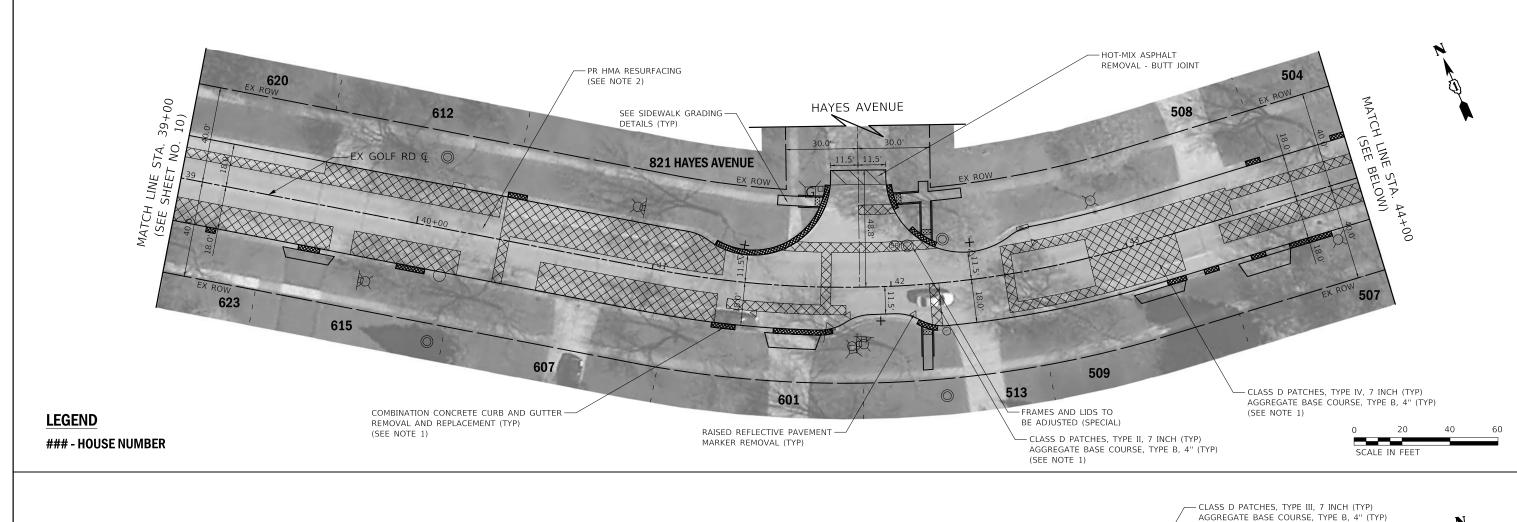SECTION **GOLF ROAD** 1241 17-00119-00-RS LAKE **ROADWAY PLAN** CONTRACT NO. 61E59 SHEETS STA. 39+00 TO STA. 49+00

36 11



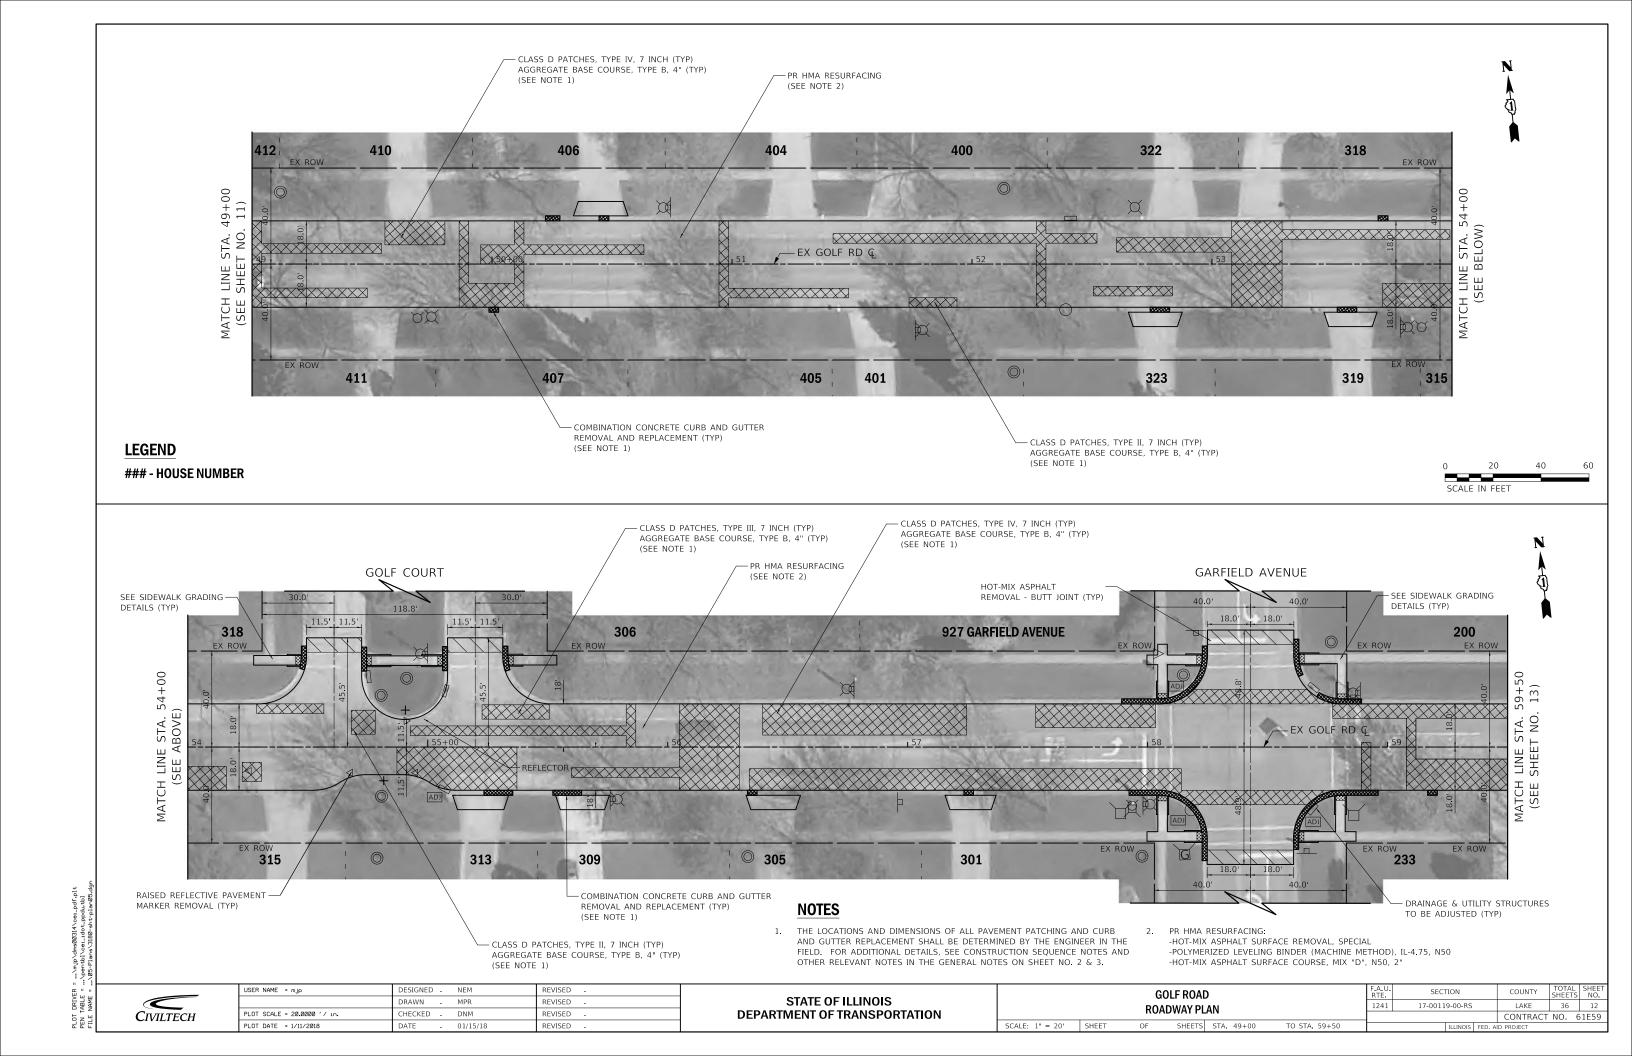

USER NAME = mjp DESIGNED - NEM REVISED CIVILTECH DRAWN MPR REVISED HECKED -DNM REVISED PLOT DATE = 1/11/2018 DATE REVISED 01/15/18

201

CLASS D PATCHES, TYPE IV, 7 INCH (TYP)-AGGREGATE BASE COURSE, TYPE B, 4" (TYP)

(SEE NOTE 1)

STATE OF ILLINOIS **DEPARTMENT OF TRANSPORTATION** 

**NOTES** 

1. THE LOCATIONS AND DIMENSIONS OF ALL PAVEMENT PATCHING AND CURB

SCALE: 1" = 20' SHEET

AND GUTTER REPLACEMENT SHALL BE DETERMINED BY THE ENGINEER IN THE FIELD. FOR ADDITIONAL DETAILS, SEE CONSTRUCTION SEQUENCE NOTES AND OTHER RELEVANT NOTES IN THE GENERAL NOTES ON SHEET NO. 2 & 3.

151

SECTION **GOLF ROAD** 1241 17-00119-00-RS **ROADWAY PLAN** SHEETS STA. 59+50 TO STA. 69+00


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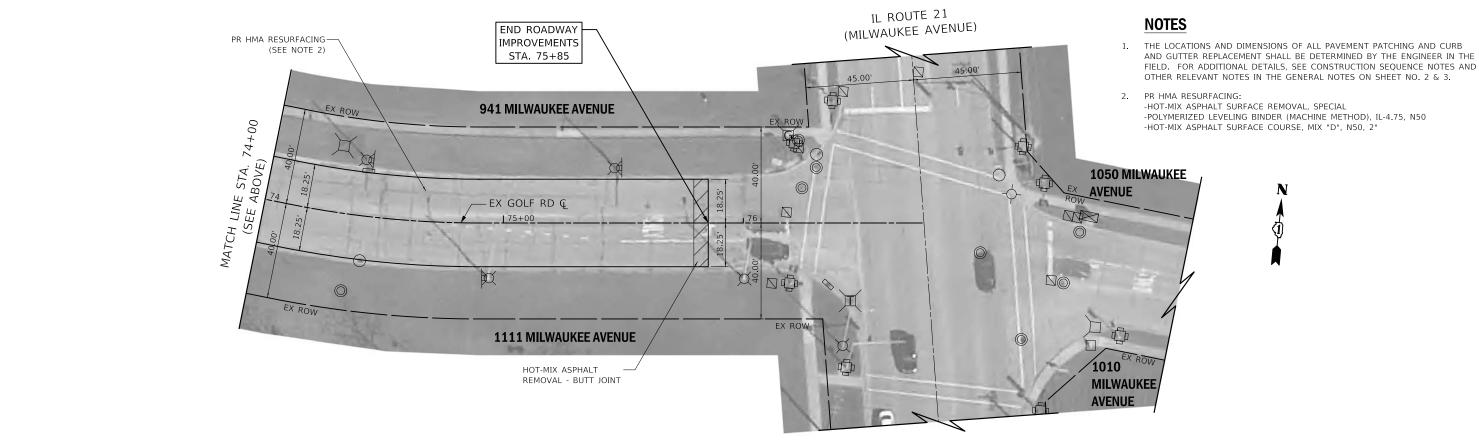
PR HMA RESURFACING:

LAKE 36 13 CONTRACT NO. 61E59

EX ROW

-HOT-MIX ASPHALT SURFACE REMOVAL, SPECIAL -POLYMERIZED LEVELING BINDER (MACHINE METHOD), IL-4.75, N50 -HOT-MIX ASPHALT SURFACE COURSE, MIX "D", N50, 2"




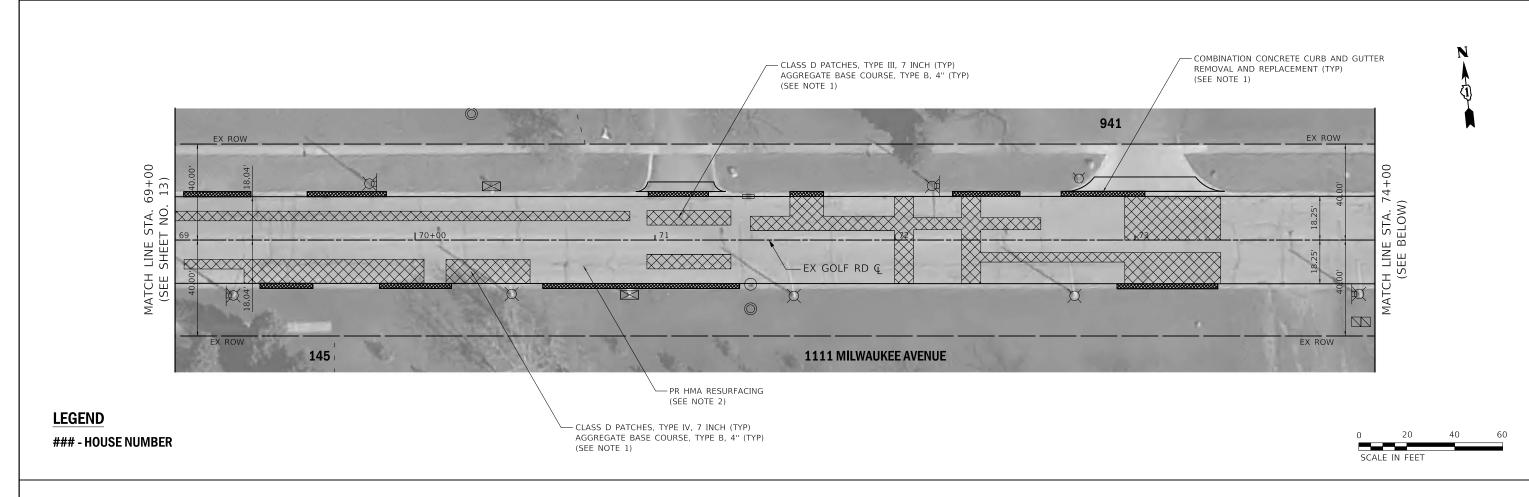



STATE OF ILLINOIS
DEPARTMENT OF TRANSPORTATION


SCALE: 1" = 20' SHEET

G	OLF ROAD	)		F.A.U. RTE	SEC	TION		COUNTY	TOTAL SHEETS	SHEET NO.
ROADWAY PLAN		ΔN			17-0011	9-00-RS		LAKE	36	14
INO,	ואווער	AN						CONTRACT	NO.	51E59
OF	SHEETS	STA. 69+00	TO STA. 86+75	ILLINOI:			FED. A	ID PROJECT		

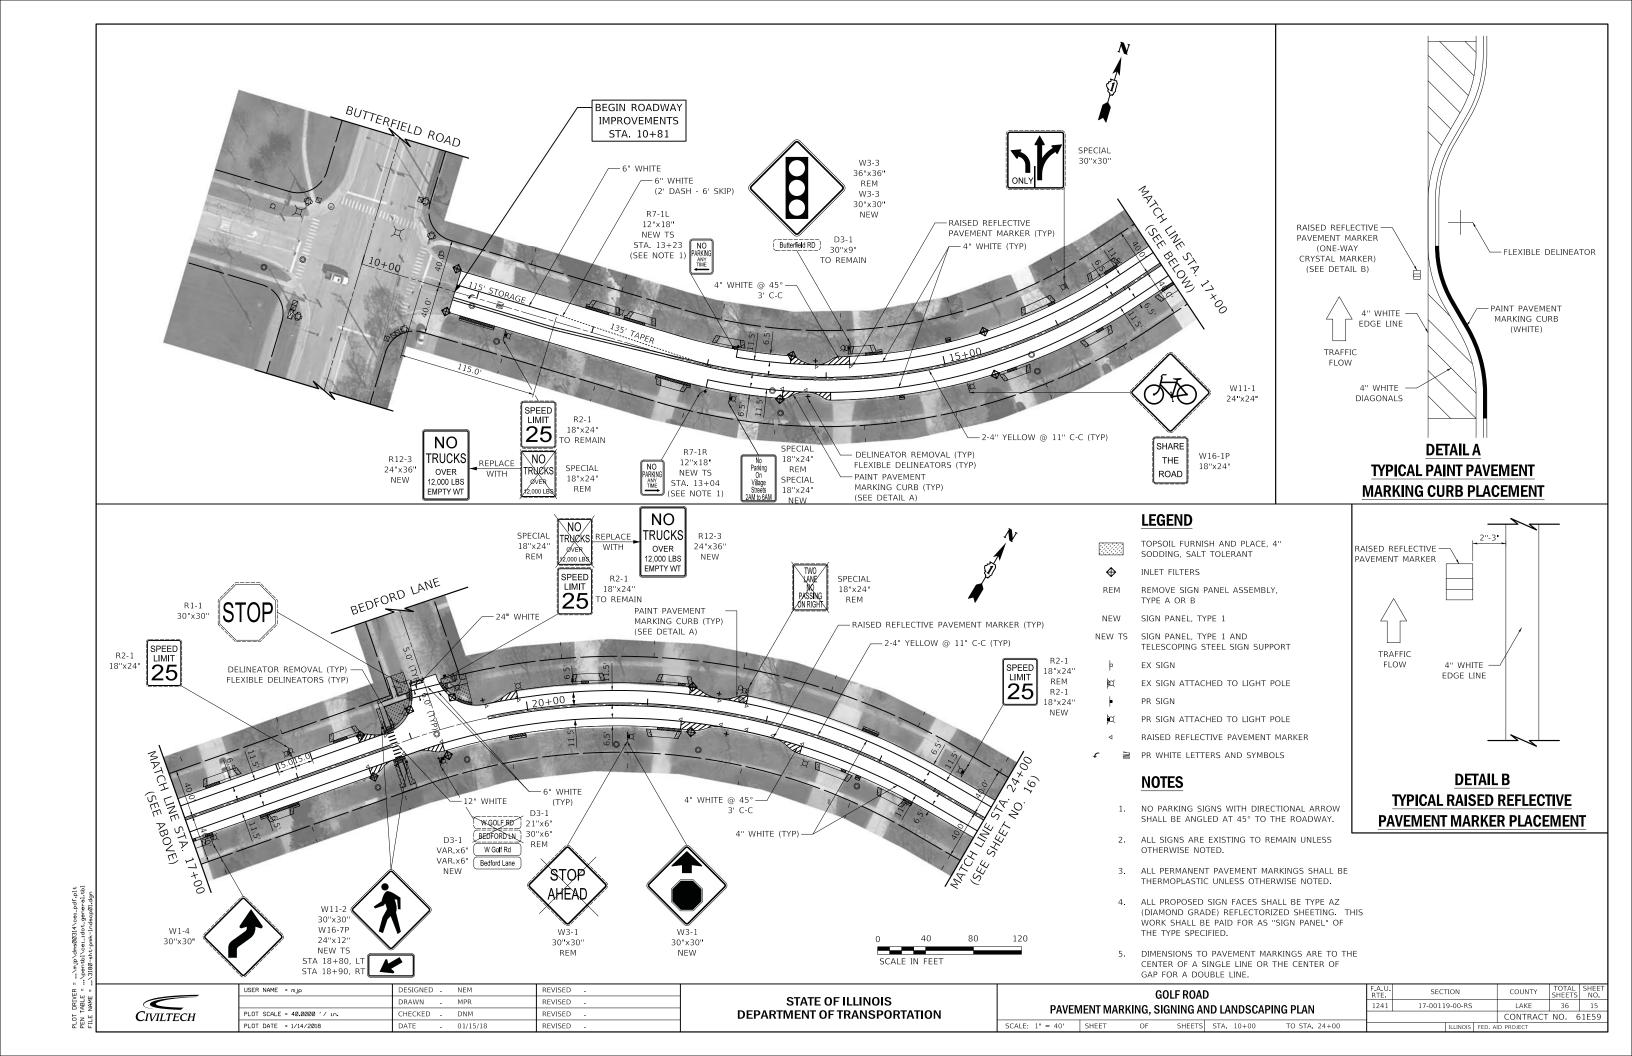

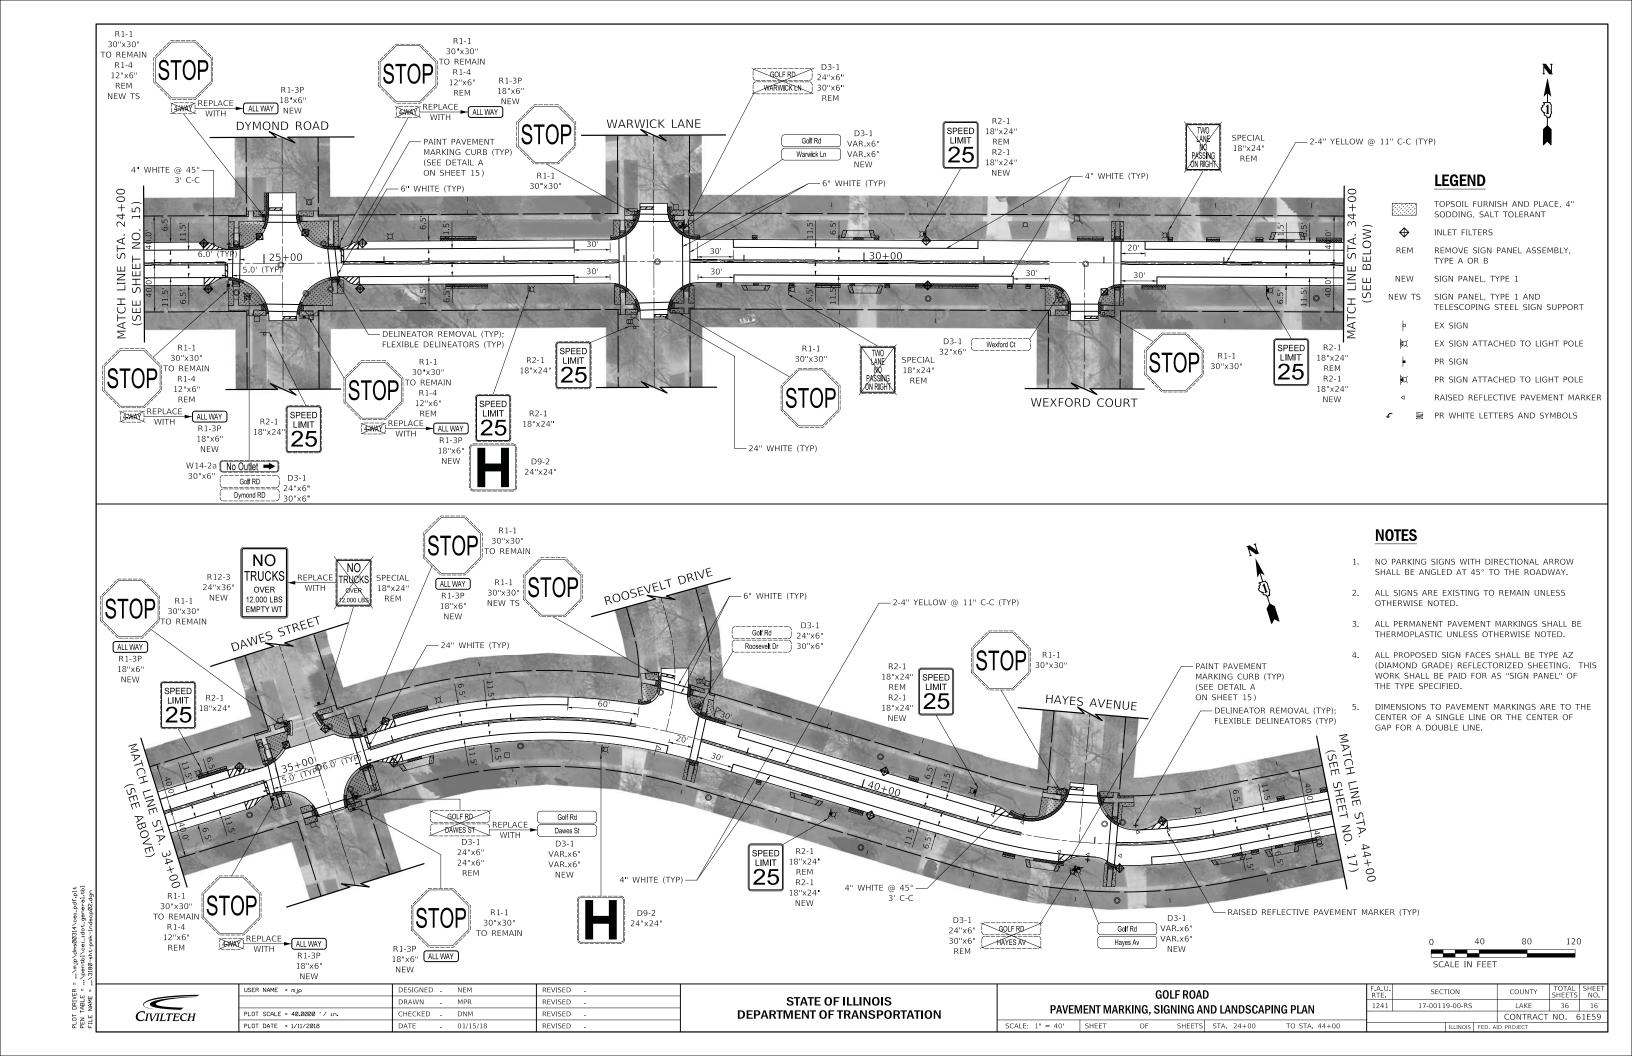


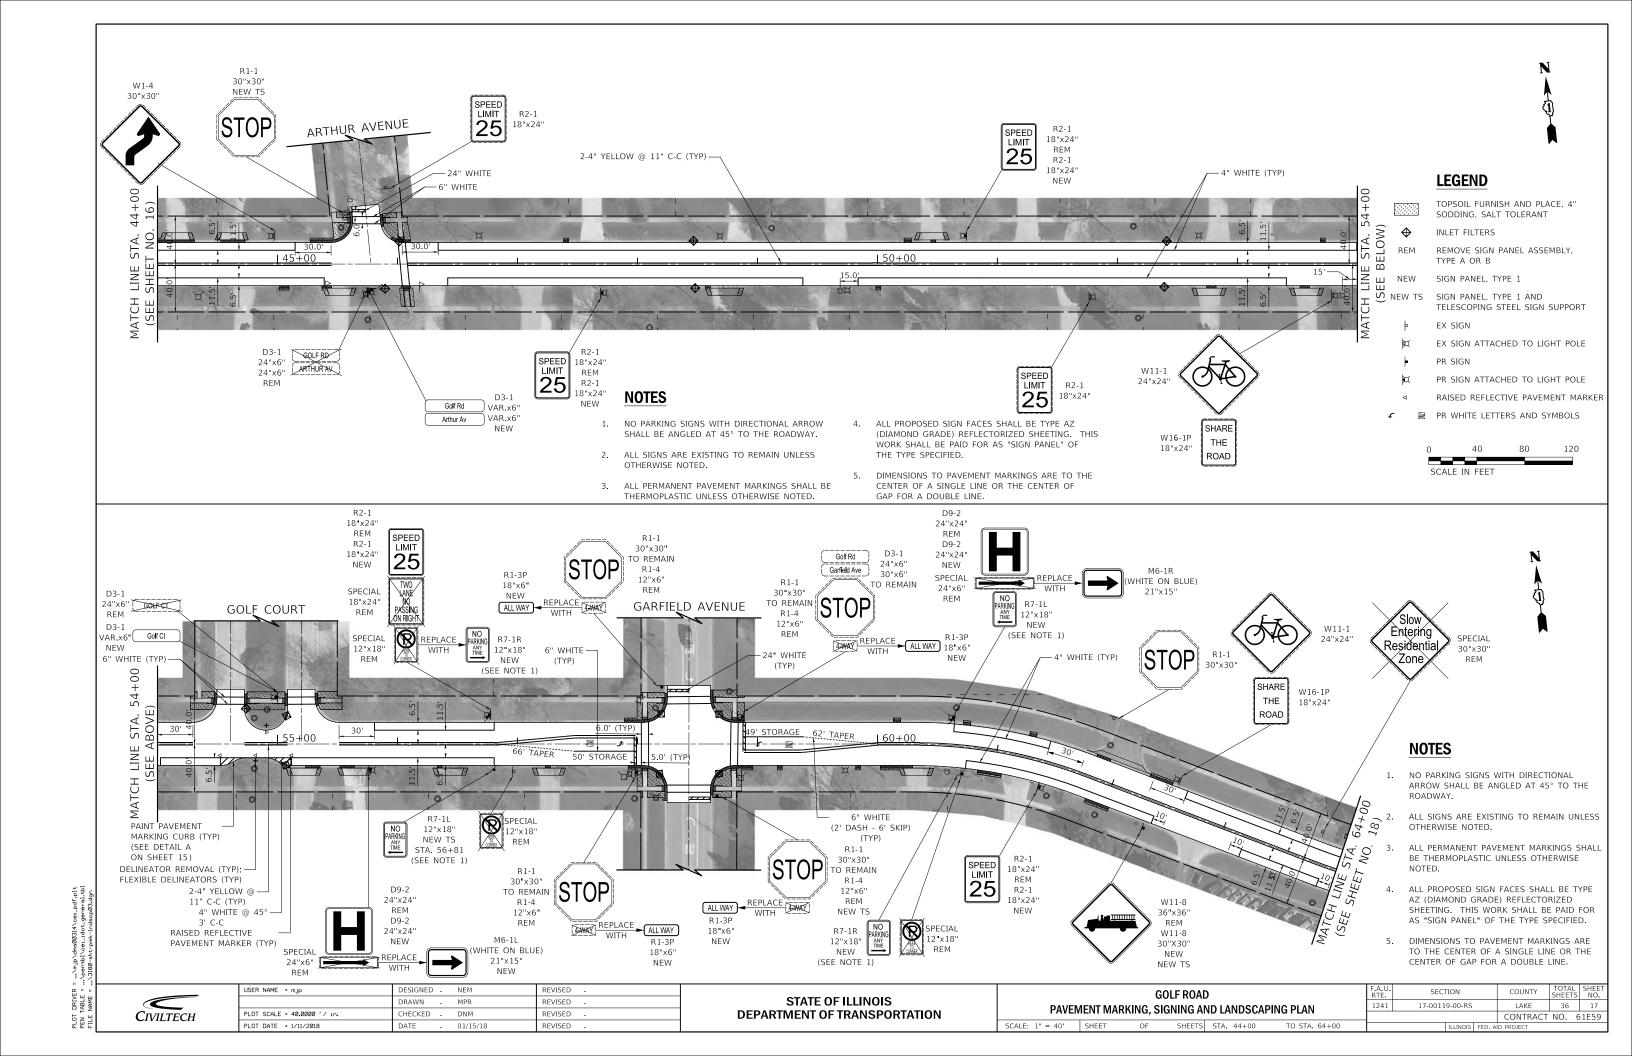


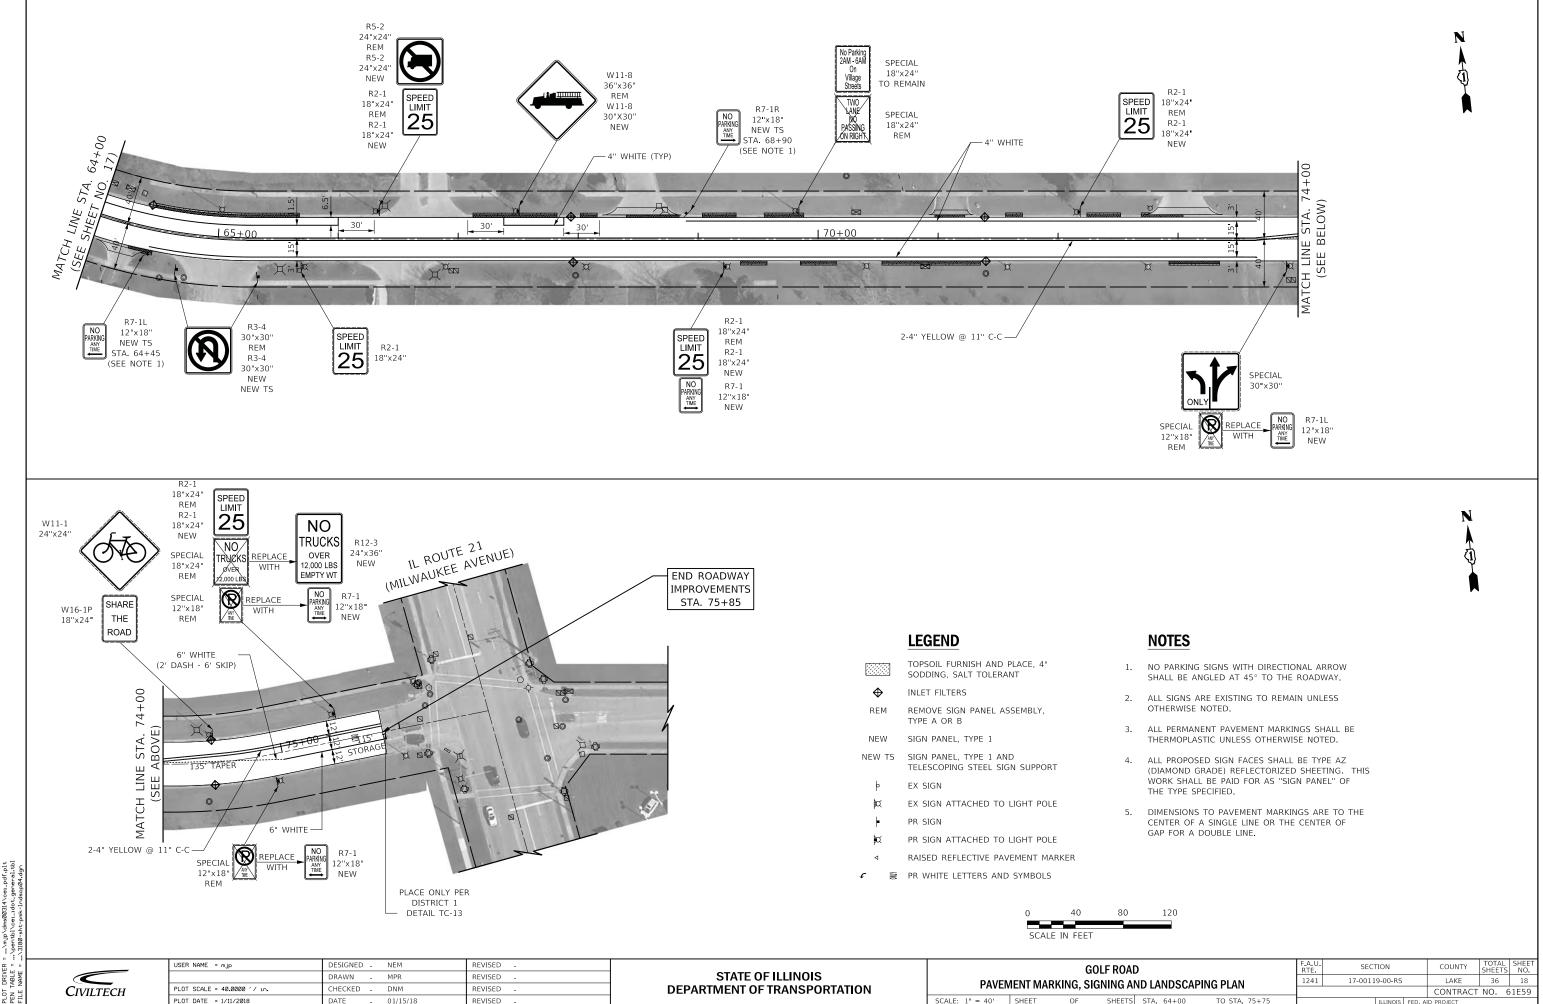



PLOT DATE = 1/11/2018


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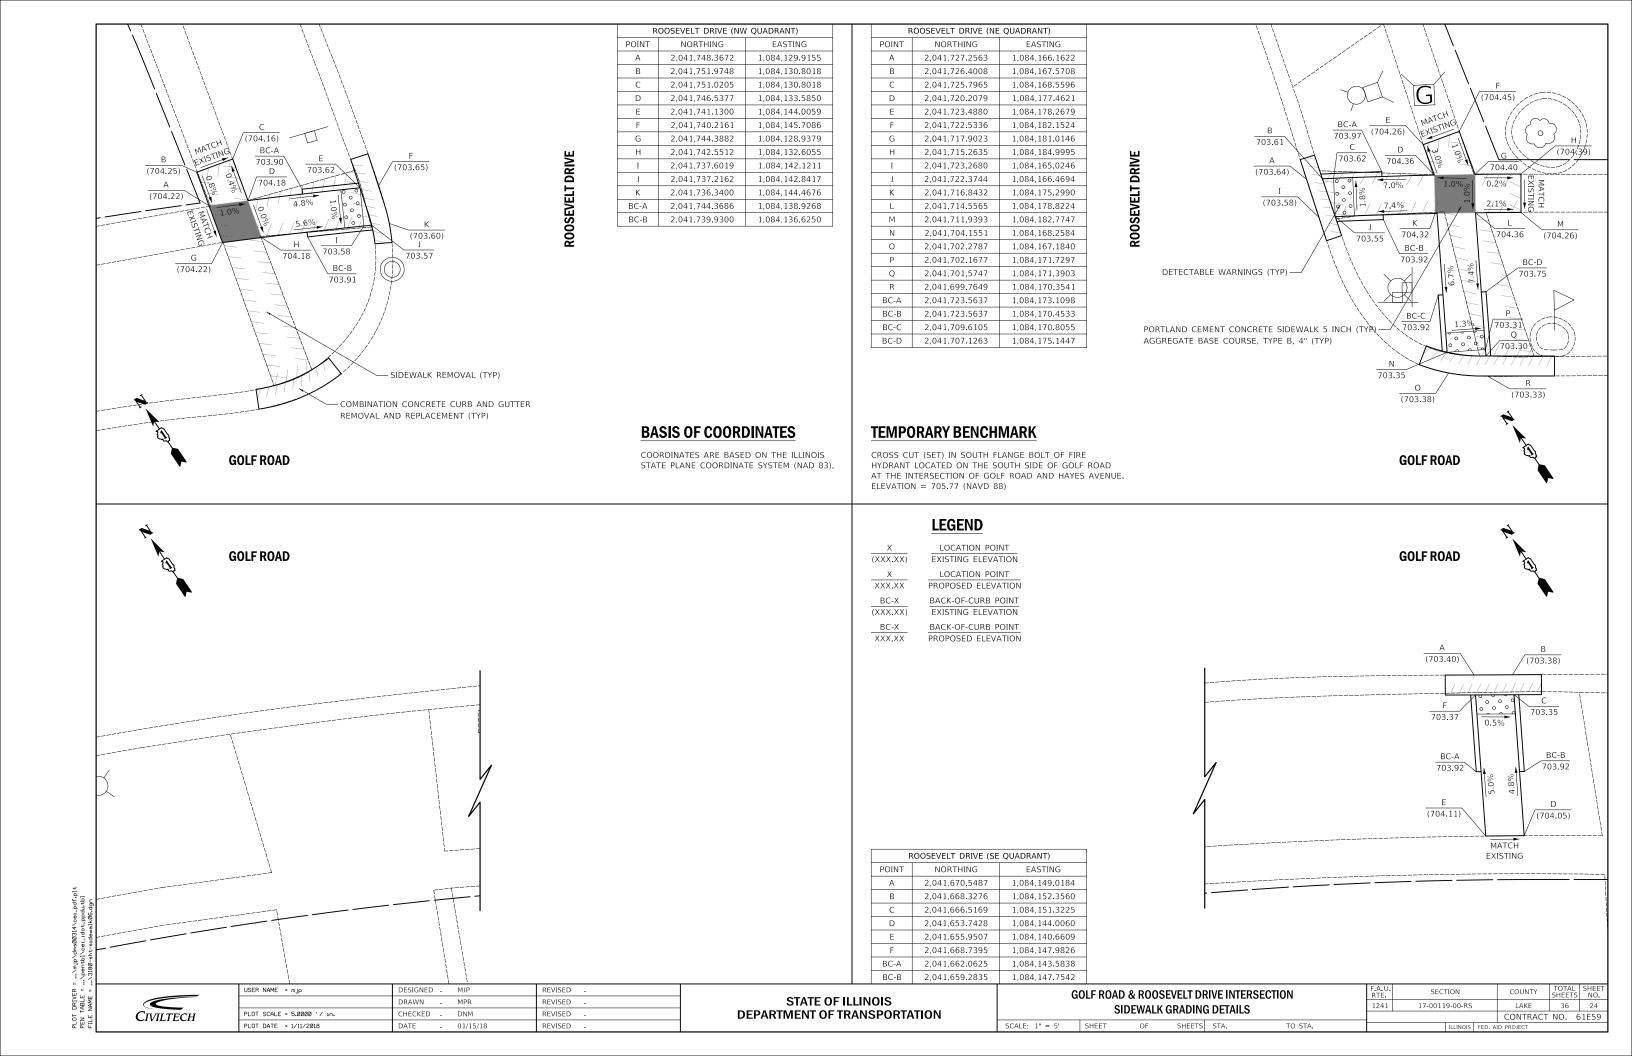


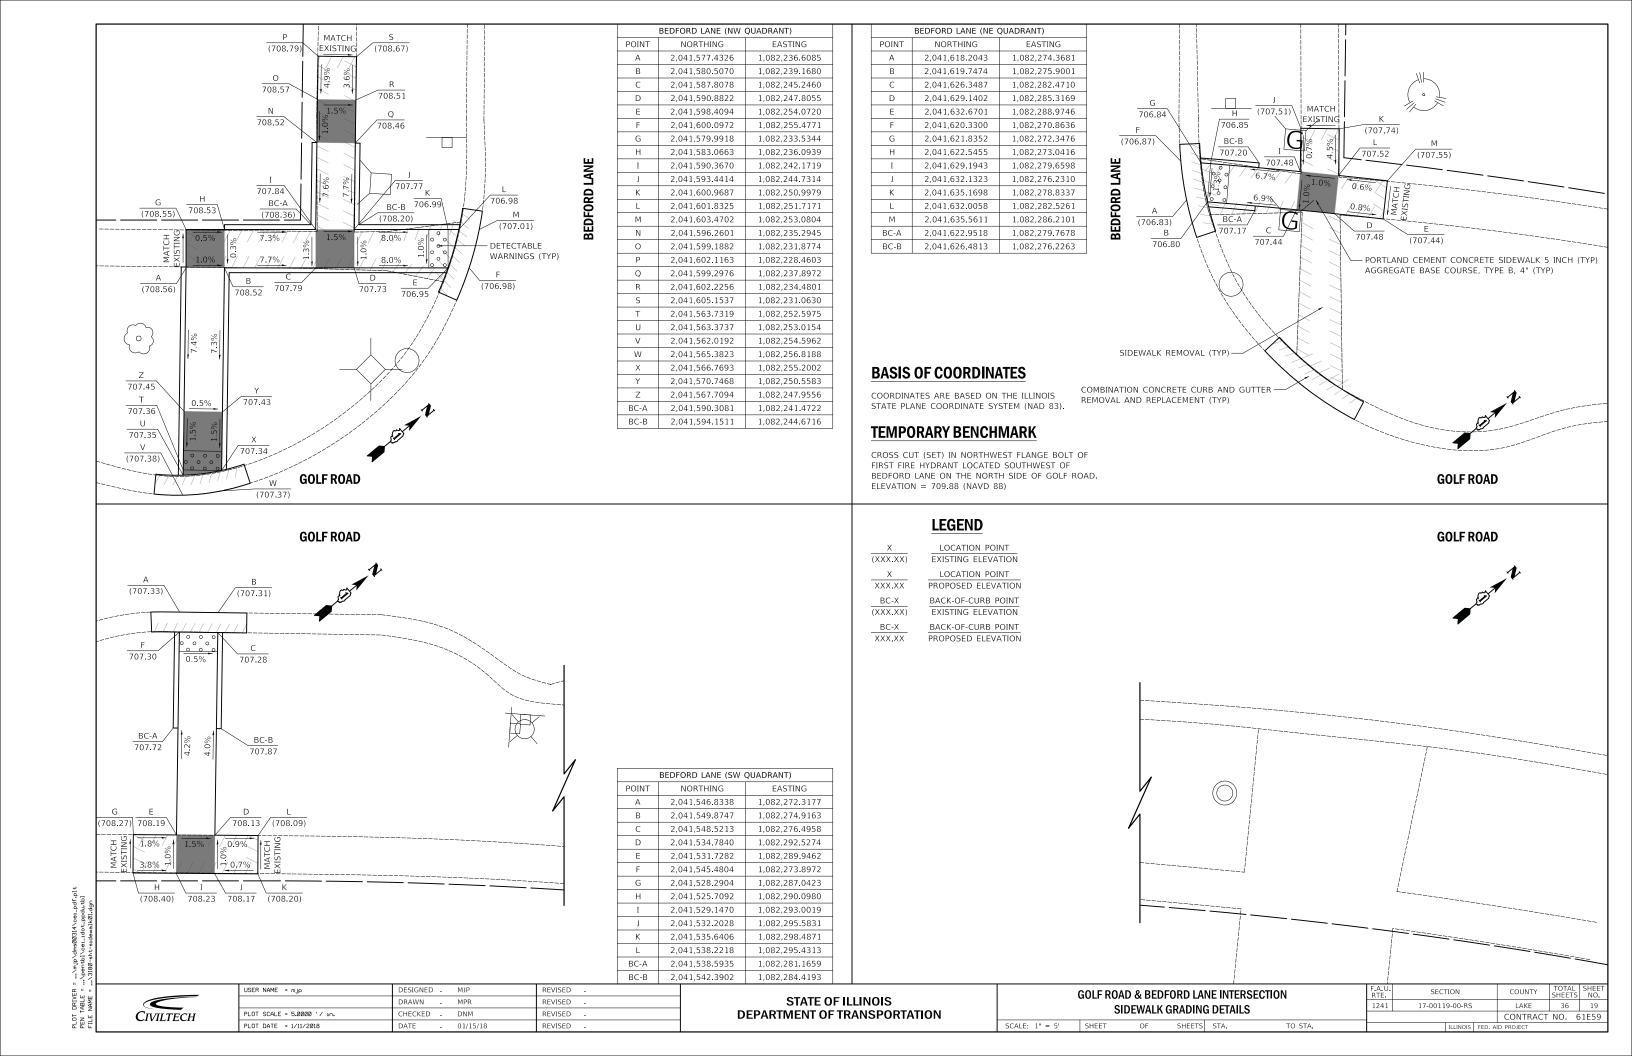


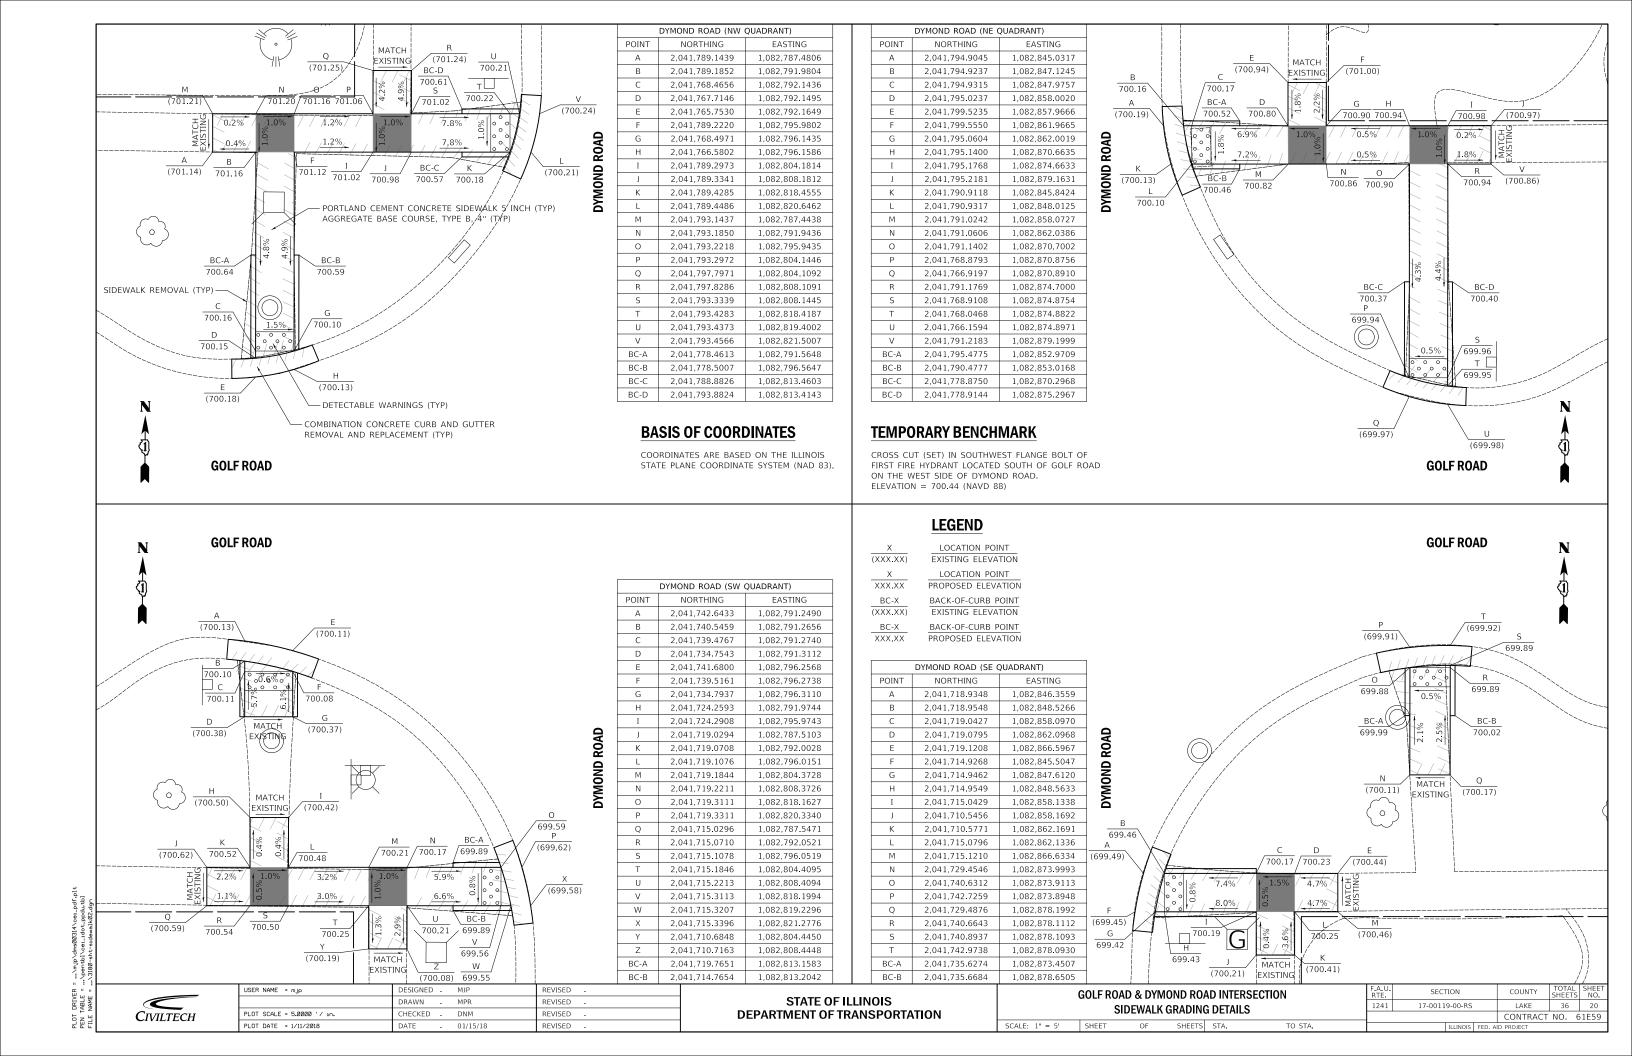


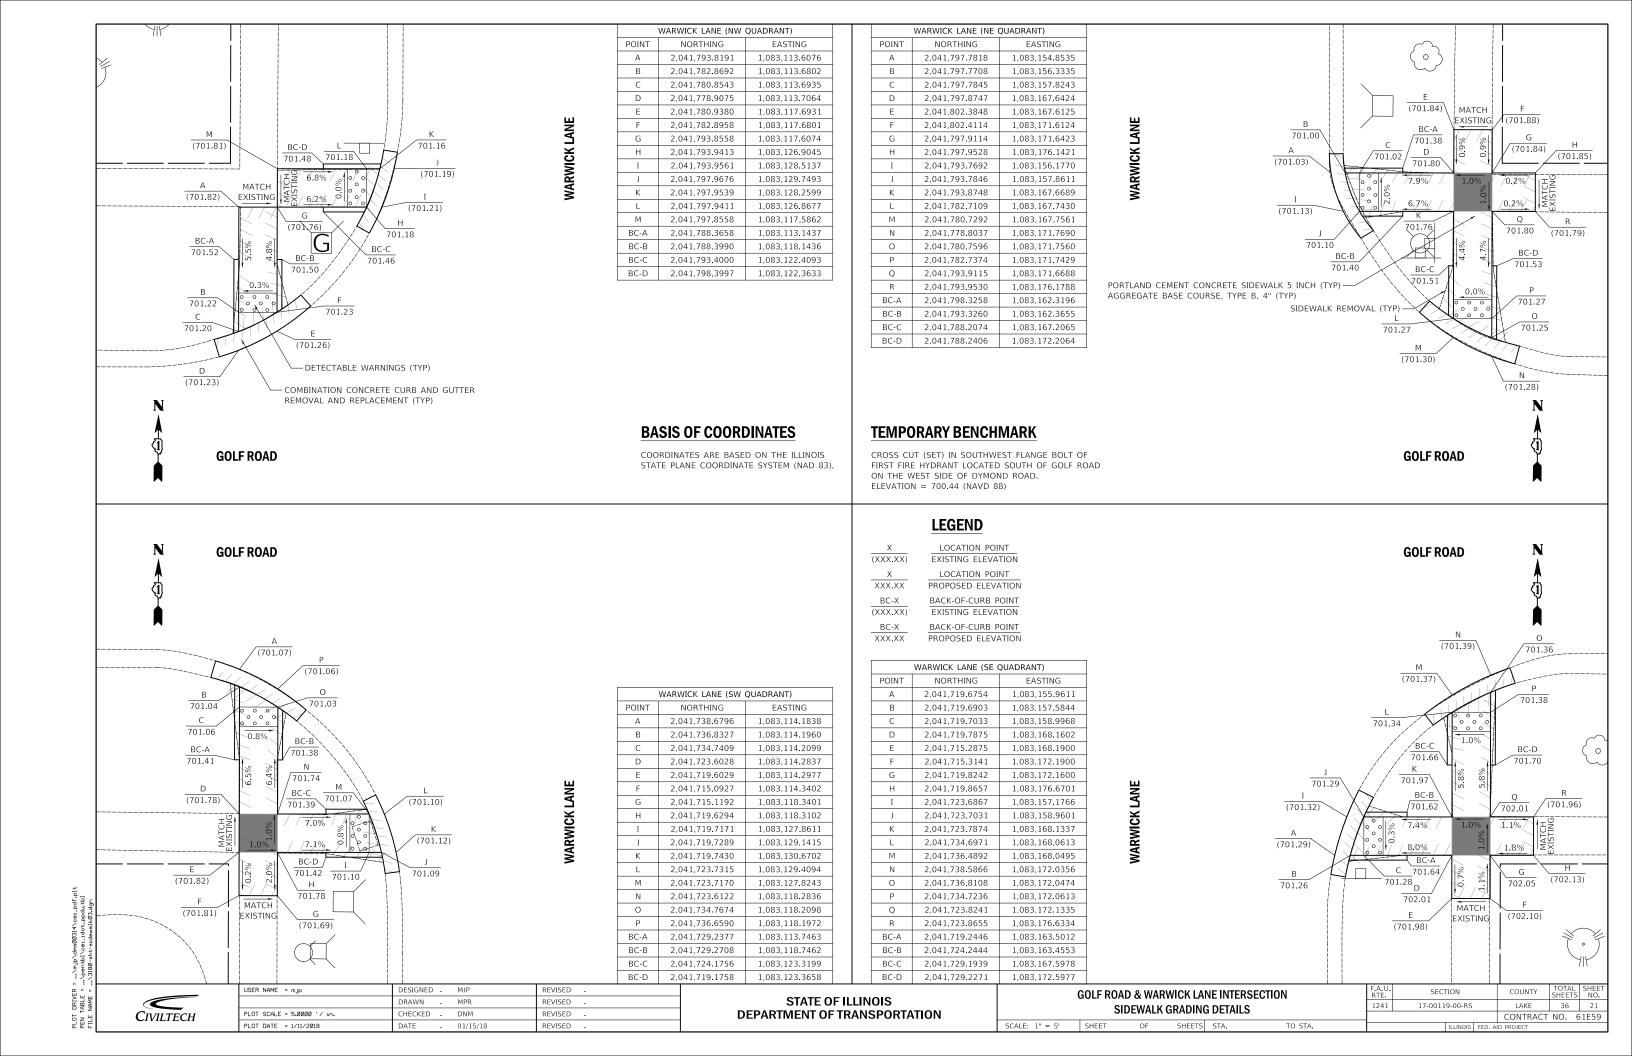


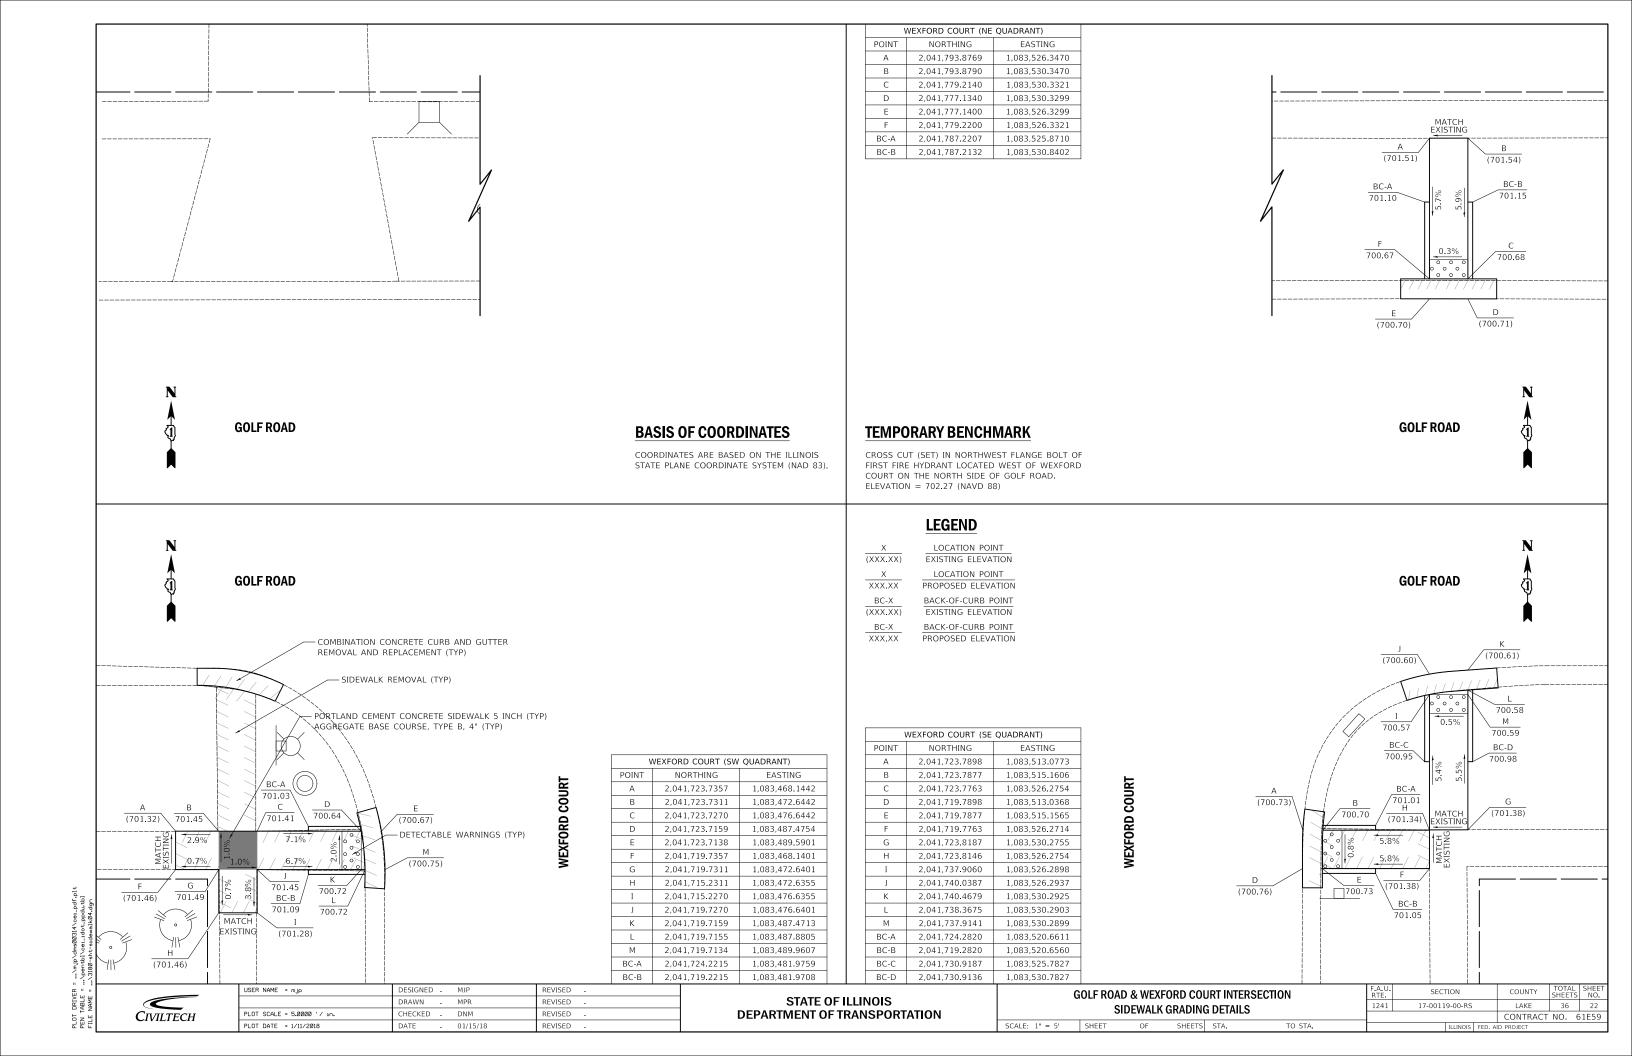


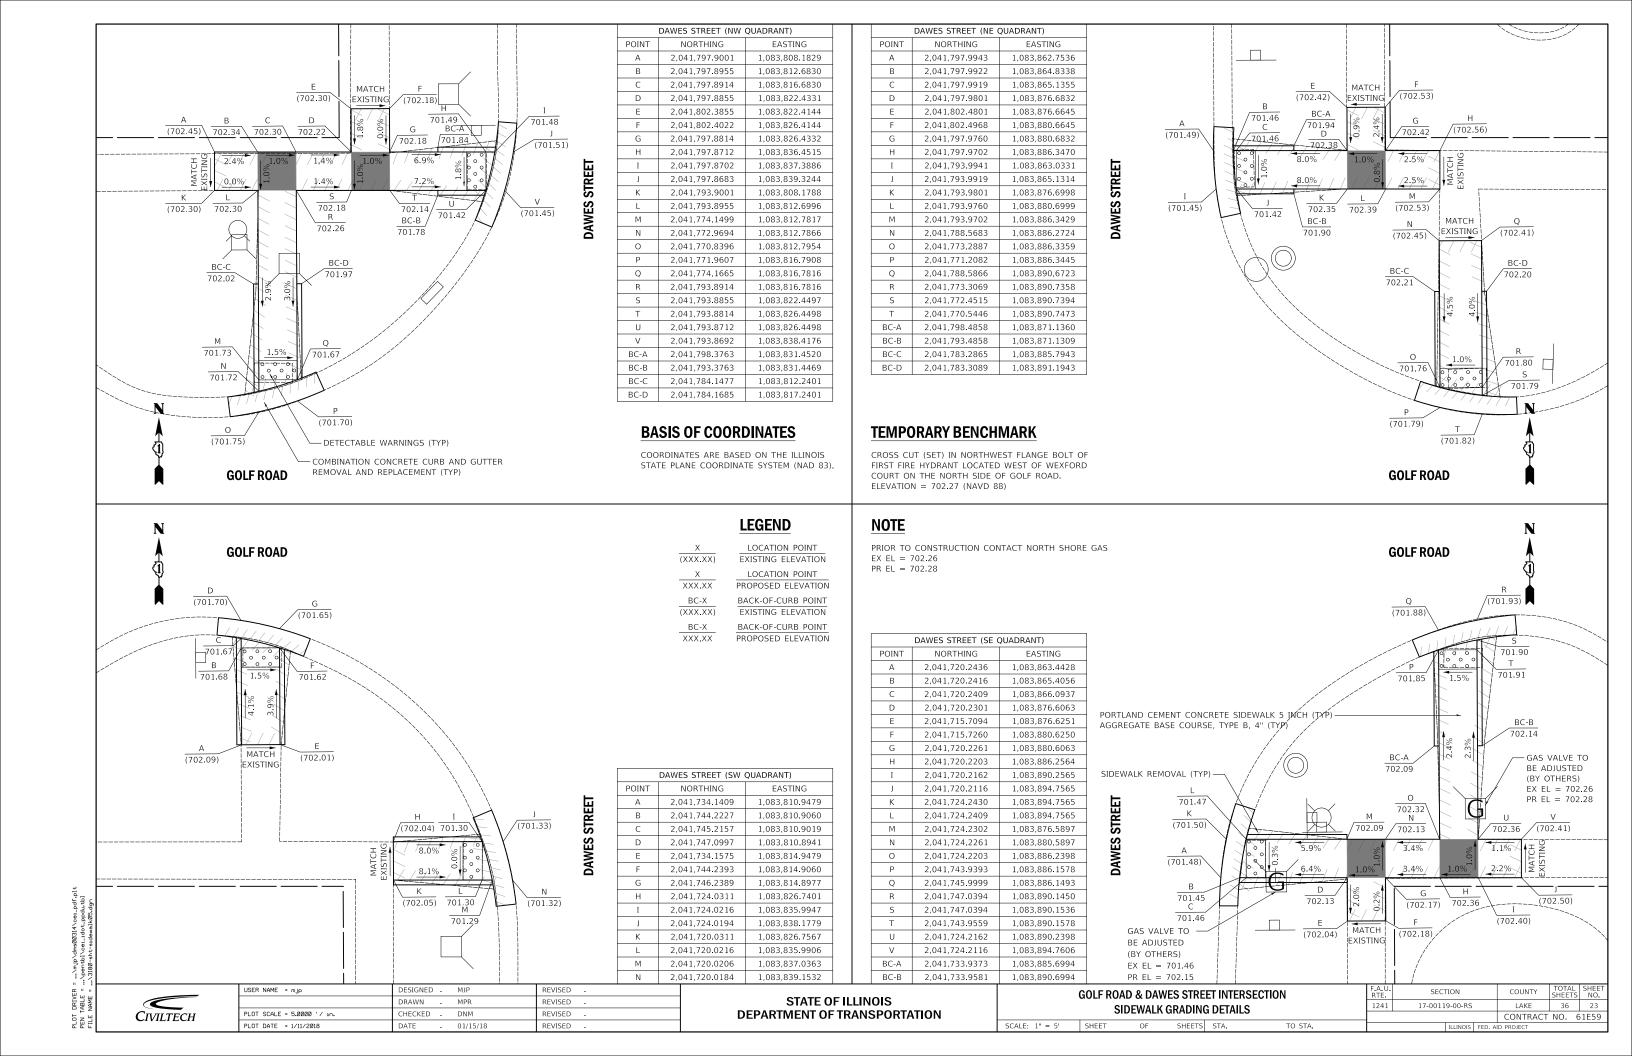


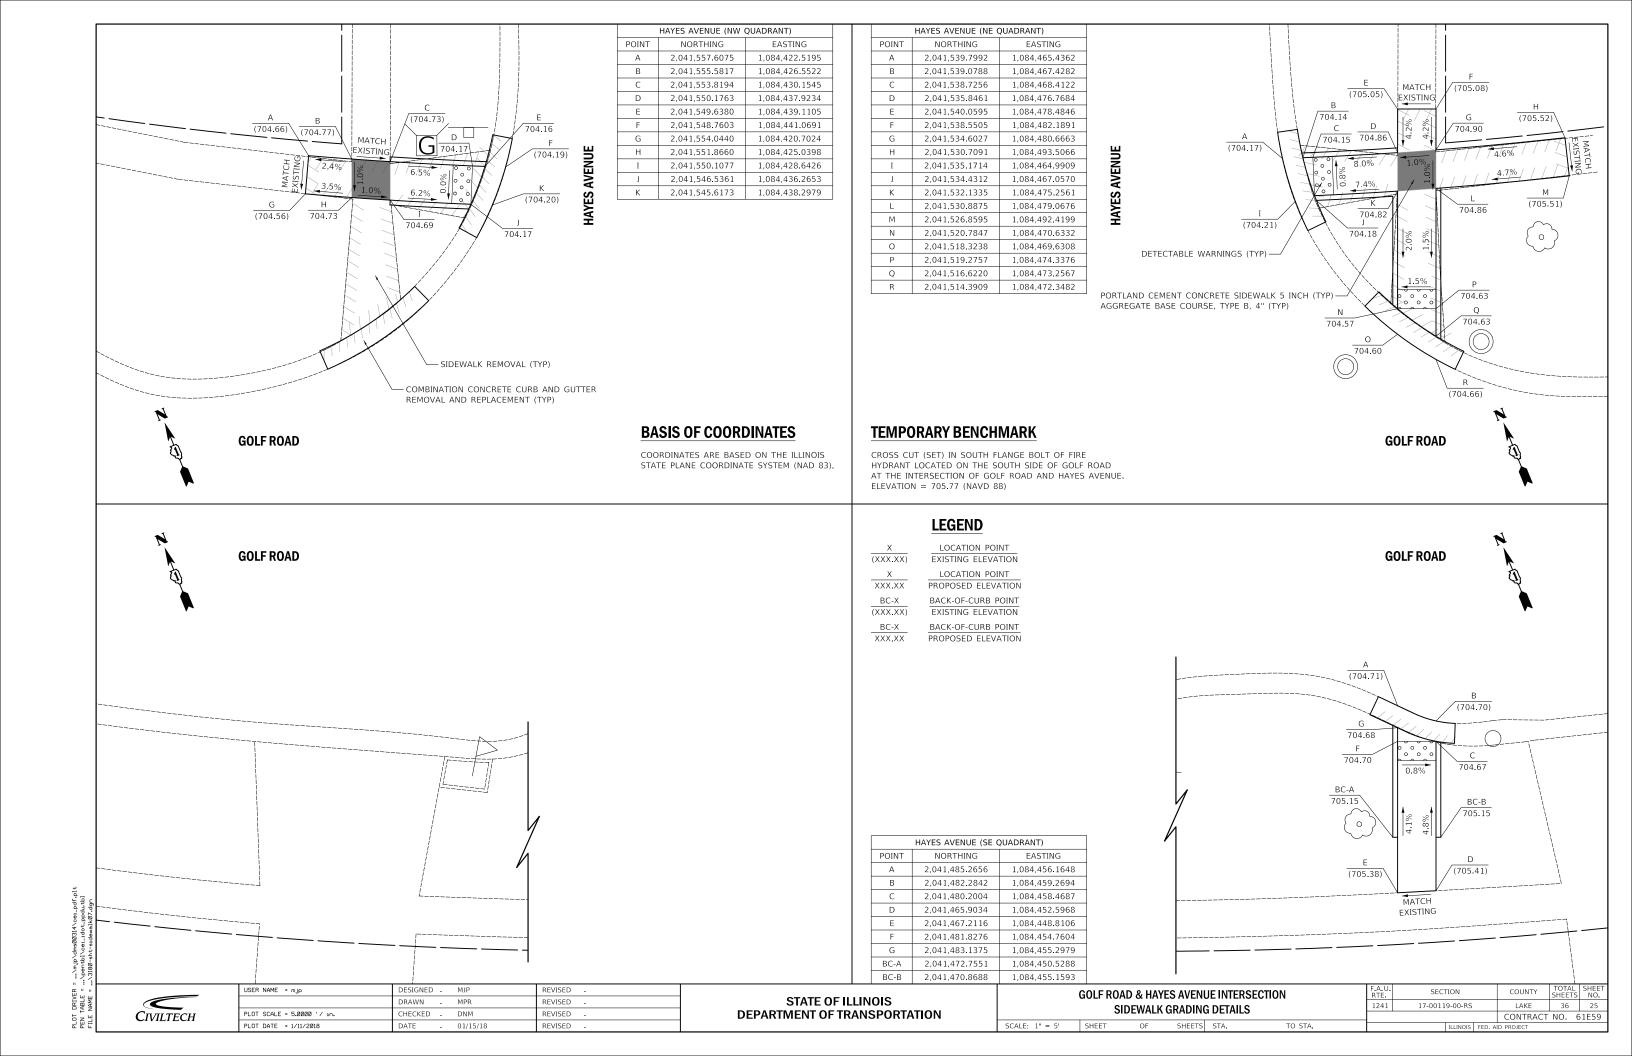

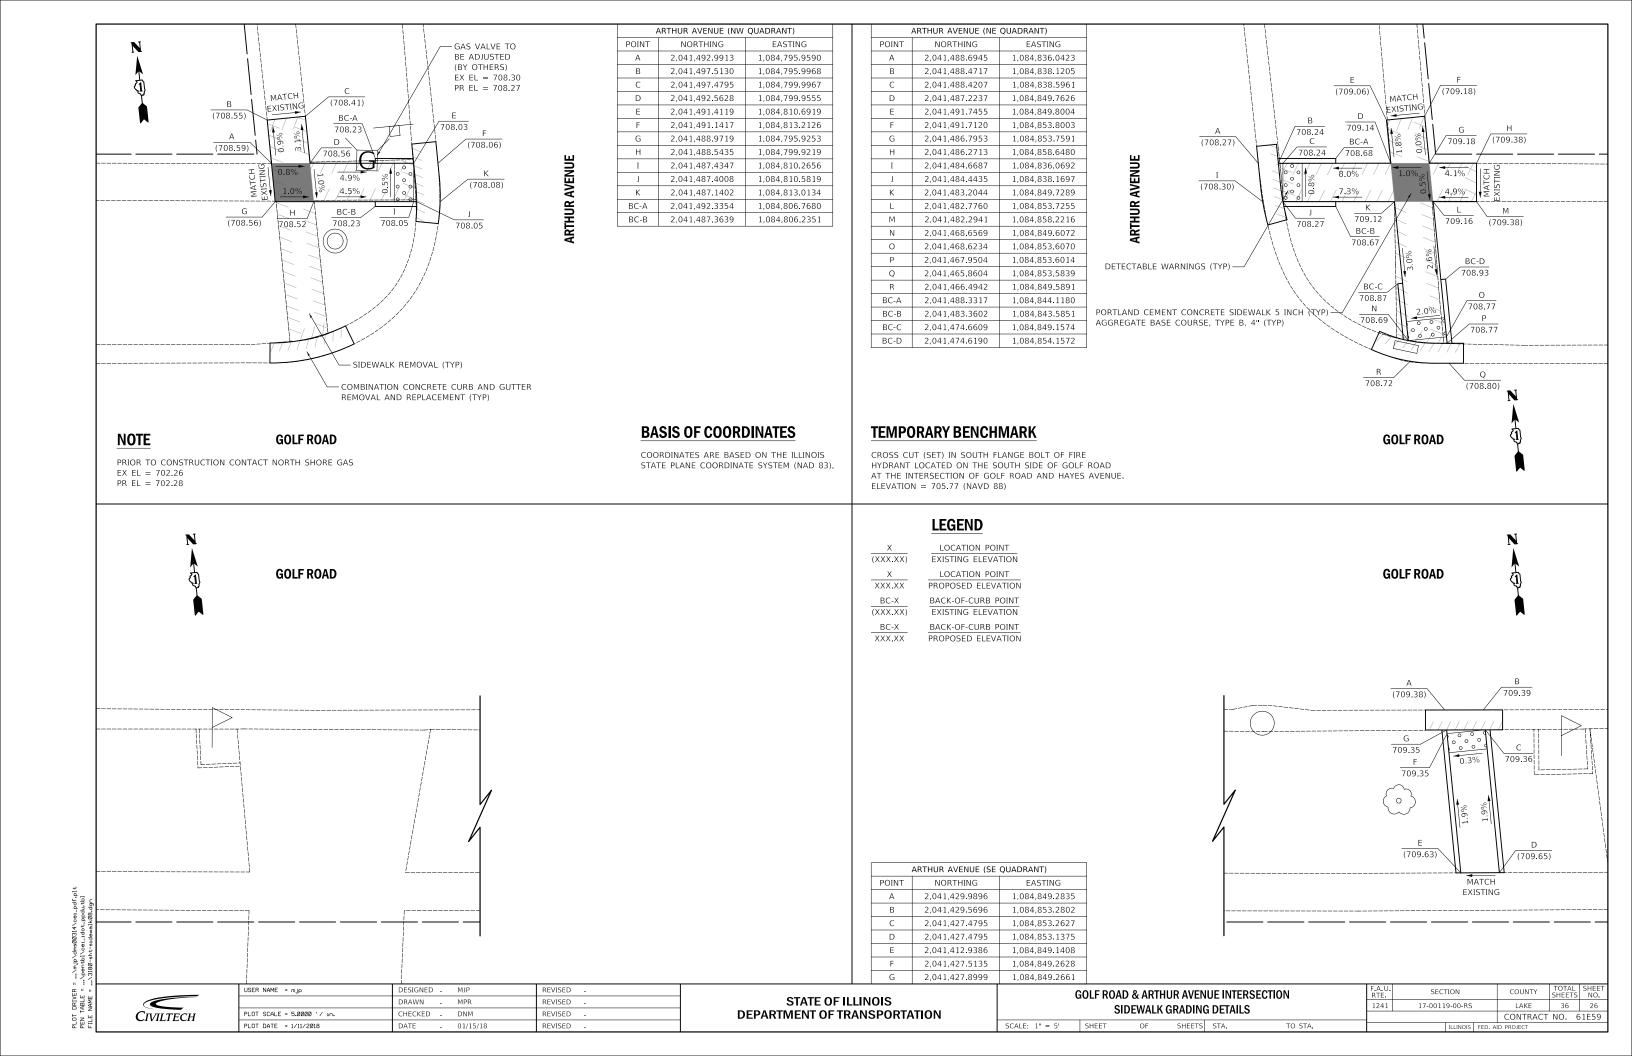

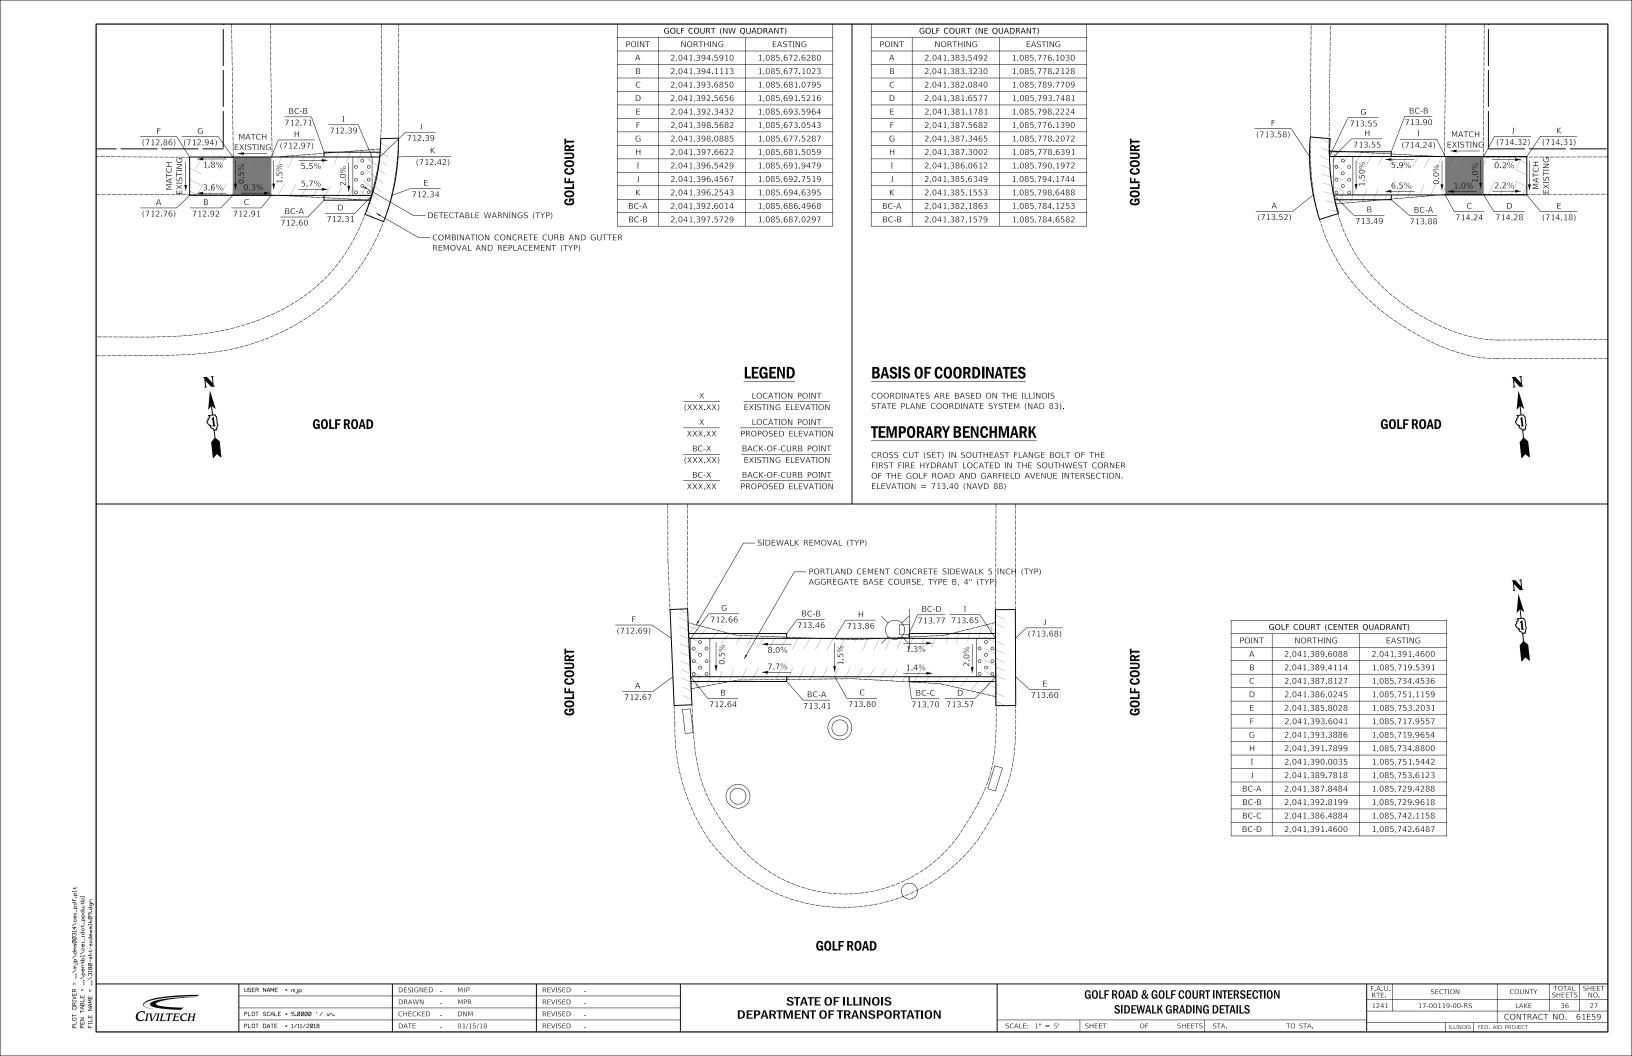

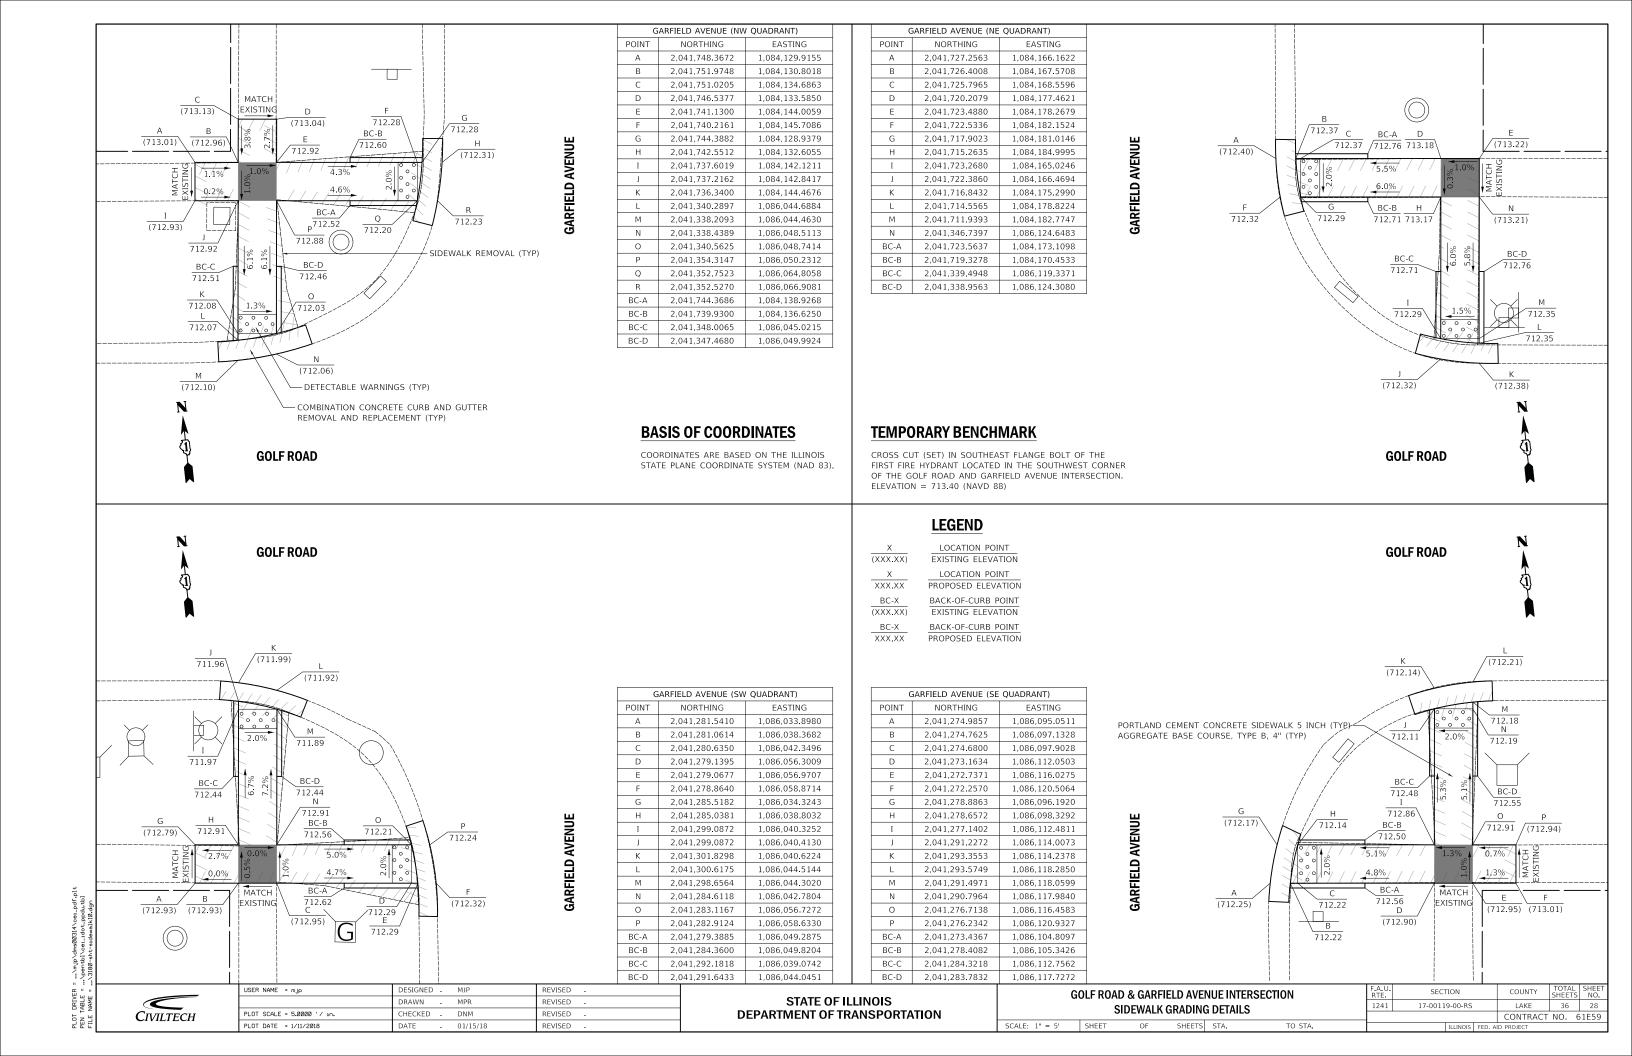

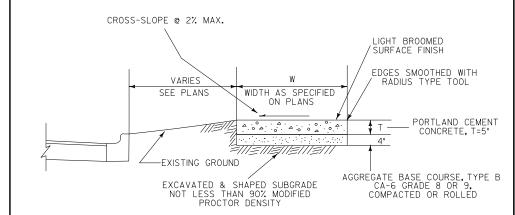

#### GENERAL NOTES:

- I. At locations where sidewalk is subjected to wheeltraffic and/or constructed across access drive entrances, the New P.C.C. Sidewalk Section shall be thickened to 6" across the width of the driveway. This work shall be included in the cost of "PORTLAND CEMENT CONCRETE SIDEWALK 5 INCH".
- Placing, finishing and curing of P.C.C. Sidewalk shall meet the requirements of Sections 424 of the Standard Specifications for Road and Bridge Construction.
- 3. Slab or panel contraction (control) joints shall be as follows:

For 4' Sidewalk width = 5' O.C. Joint Spacing
5' Sidewalk width = 5' O.C. Joint Spacing
6' Sidewalk width = 6' O.C. Joint Spacing
8' Sidewalk width = 8' O.C. Joint Spacing

4. Transverse expansion joints shall consist of preformed joint filler of thickness as follows: I/2' between sidewalk and structures, standards, poles 3/4' at sidewalk intervals of not more thean 50 feet & abutting concrete curbing or pavement.

5. If excavation or undercutting of subgrade has been made deeper than necessary, the base shallbe brought to proper grade by the addition of well-compacted bedding material without any extra compensation to the Contractor.

TYPICAL SECTION - P.C.C. SIDEWALK


CIVILTECH

USER NAME = mJp	DESIGNED - MJP	REVISED -
	DRAWN - MPR	REVISED -
PLOT SCALE = 1.0000 ' / in.	CHECKED - DNM	REVISED -
PLOT DATE = 1/11/2018	DATE - 01/15/18	REVISED -

GOLF ROAD CONSTRUCTION DETAILS - LIBERTYVILLE										
SCALE: N.T.S.	SHEET	OF	SHEETS	STA.	TO STA.					

SECTION COUNTY LAKE 36 29 1241 17-00119-00-RS CONTRACT NO. 61E59


STATE OF ILLINOIS **DEPARTMENT OF TRANSPORTATION** 

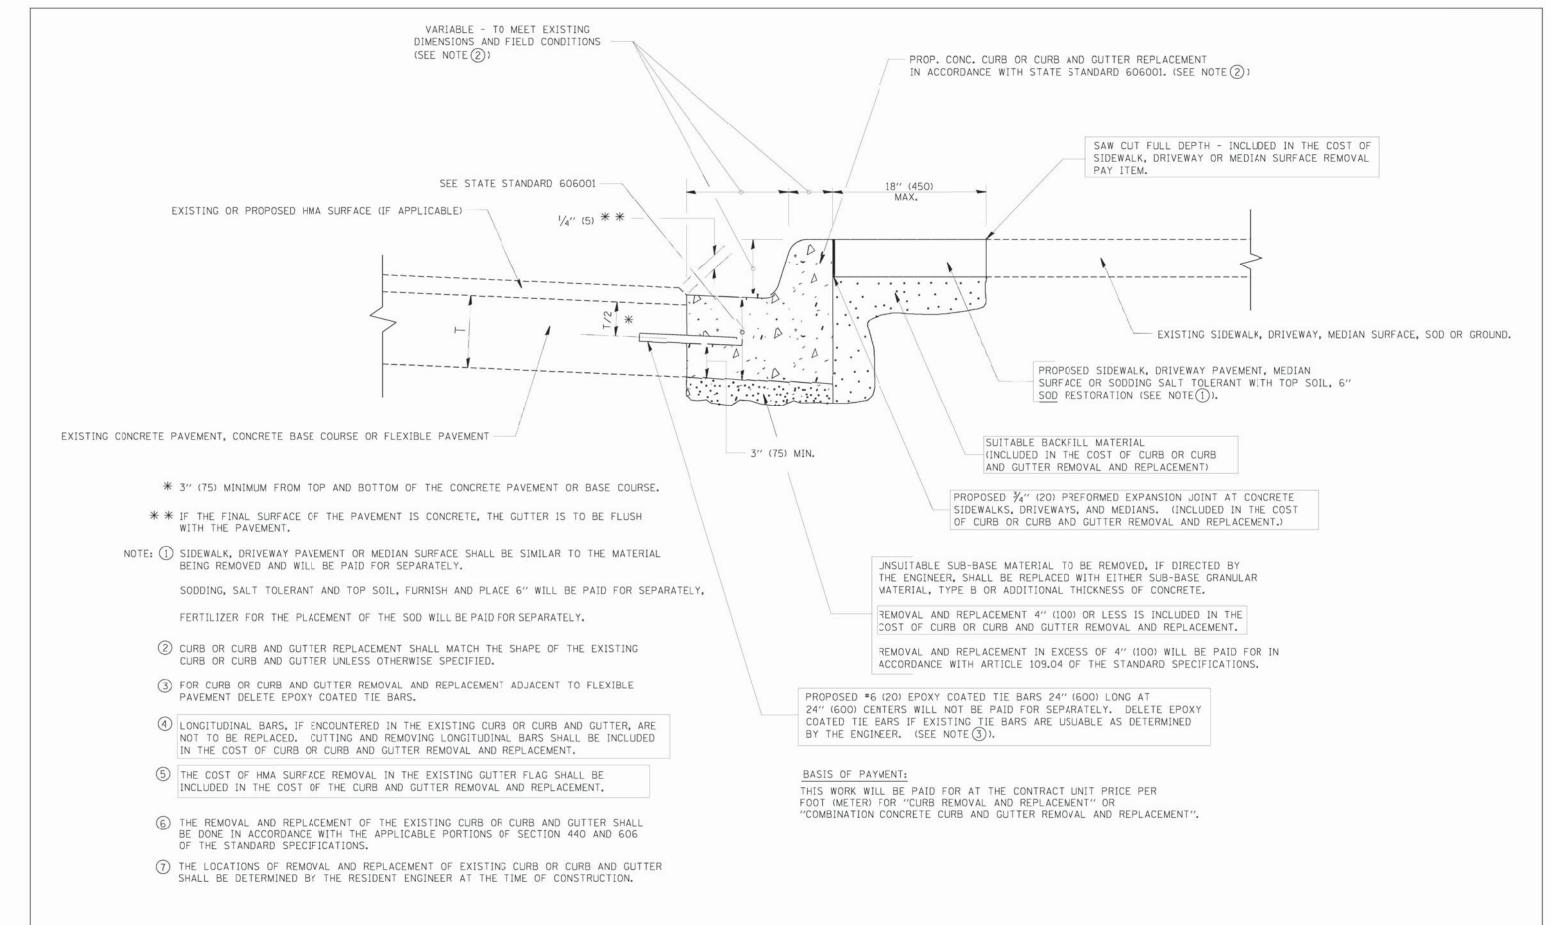


## CURB OR CURB AND GUTTER REMOVAL AND REPLACEMENT

ALL DIMENSIONS ARE IN INCHES (MILLIMETERS) UNLESS OTHERWISE SHOWN.

FILE NAME =	USER NAME = drivakosgn	DESIGNED - A. HOUSEH	REVISED - R. SHAH 10-03-96			CURB OR CURB AND GUTTER	F.A.U.	SEC.	TION	COUNTY	TOTAL S	SHEET
p:/pw.work/pwidot/drivakosgn/d0108315/bd	24.dgn	DRAWN -	REVISED - A. ABBAS 03-21-97	STATE OF ILLINOIS			1241	17-0011	19-00-RS	LAKE	36	30
	PLOT SCALE = 50.000 ' / IN.	CHECKED -	REVISED - M. GOMEZ 01-22-01	DEPARTMENT OF TRANSPORTATION		REMOVAL AND REPLACEMENT		-	-	CONTRACT	T NO. 61	E59
PLC	PLOT DATE = 12/15/2009	DATE - 03-11-94	REVISED - R. BORO 12-15-09	SCA	SCALE: NONE	SHEET NO. 1 OF 1 SHEETS STA. TO STA.	FED. RO.	AD DIST. NO. 1	ILLINOIS FED. AII		1101	

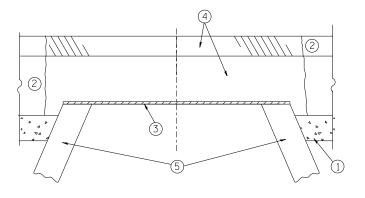

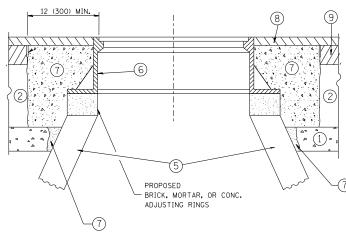

#### NOTES:

EXISTING BROKEN FRAMES AND LIDS SHALL BE REMOVED AND DISPOSED OF BY THE CONTRACTOR AND SHALL BE REPLACED AS DIRECTED BY THE ENGINEER. REPLACEMENT FRAMES AND LIDS WILL BE PAID FOR IN ACCORDANCE WITH ARTICLE 109.04 OF THE STANDARD SPECIFICATIONS UNLESS A SEPARATE PAY ITEM HAS BEEN PROVIDED.

IF THE EXISTING LIDS ARE OPEN, THE FRAME WILL BE ADJUSTED TO THE ELEVATION OF THE MILLED PAVEMENT SURFACE PRIOR TO THE MILLING OPERATION. THE FRAME WILL NOT BE REMOVED AND COVERED BY THE METAL PLATE.

CITY OF CHICAGO CASTINGS ARE THE PROPERTY OF THE CITY AND THE CONTRACTOR SHALL NOTIFY THE CITY FOR REMOVAL AND DISPOSITION OF THE CASTINGS.

THE METAL PLATE USED TO COVER THE STRUCTURE SHALL REMAIN THE PROPERTY OF THE CONTRACTOR.

WHEN STRUCTURES ARE TO BE ADJUSTED OR RECONSTRUCTED, THE LOWERING AND RAISING OF THE FRAMES AND LIDS WILL NOT BE PAID FOR SEPARATELY BUT WILL BE INCLUDED IN THE COST OF THE CORRESPONDING PAY ITEM.

SCALE: NONE

#### CONSTRUCTION PROCEDURES

#### STAGE 1 (BEFORE PAVEMENT MILLING)

- A) REMOVE A MINIMUM OF 12 (300) OF THE PAVEMENT FROM
- AROUND THE STRUCTURE.

  B) REMOVE THE EXISTING FRAME AND LID FROM THE STRUCTURE.
- C) COVER THE STRUCTURE OPENING WITH A 36 (900) DIAMETER METAL PLATE.

  D) BACKFILL WITH CRUSHED STONE AND A MINIMUM 1½ (40)
- THICK HMA SURFACE MIX APPROVED BY THE ENGINEER.

#### STAGE 2 (AFTER PAVEMENT MILLING)

- A) REMOVE THE HMA SURFACE MIX AND CRUSHED STONE.
- B) INSTALL THE FRAME AND LID; ADJUST THE FRAME TO ITS FINAL SURFACE ELEVATION.
- C) THE SURROUNDING SPACE SHALL BE FILLED WITH CLASS PP-1\* CONCRETE TO THE ELEVATION OF THE SURFACE OF THE EXISTING BASE COURSE OR THE BINDER COURSE.
- \*UNLESS OTHERWISE SPECIFIED IN THE PLANS.

THE PROCEDURE EXPLAINED ABOVE SHALL CONFORM TO THE APPLICABLE PORTIONS OF SECTIONS 353, 406, 602, AND 603 OF THE STANDARD SPECIFICATIONS EXCEPT THAT "THE CONTRACTOR SHALL ADJUST THE STRUCTURES TO THE FINISHED PAVEMENT ELEVATION NO MORE THAN 5 CALENDAR DAYS PRIOR TO PLACEMENT OF THE FINAL LIFT OF SURFACE UNLESS APPROVED BY THE

#### LEGEND

- 1 SUB-BASE GRANULAR MATERIAL
- (6) FRAME AND LID (SEE NOTES)
- 2 EXISTING PAVEMENT
- (7) CLASS PP-1\* CONCRETE
- 3 36 (900) DIAMETER METAL PLATE
- PROPOSED CRUSHED STONE AND HMA SURFACE MIX
- (8) PROPOSED HMA SURFACE COURSE
- (5) EXISTING STRUCTURE
- (9) PROPOSED HMA BINDER COURSE

#### LOCATION OF STRUCTURES:

THE CONTRACTOR WILL BE REQUIRED TO KEEP A RECORD OF THE LOCATIONS OF THE BURIED STRUCTURES ACCORDING TO THE STATION AND DISTANCE LEFT OR RIGHT OF THE CENTERLINE OF PAVEMENT. UPON COMPLETION OF THE WORK, THE CONTRACTOR WILL DELIVER THE RECORD TO THE ENGINEER.

#### BASIS OF PAYMENT:

REMOVING FRAMES AND LIDS ON DRAINAGE AND UTILITY STRUCTURES IN THE PAVEMENT PRIOR TO MILLING, AND ADJUSTING TO FINAL GRADE PRIOR TO PLACING THE SURFACE COURSE, WILL BE PAID FOR AT THE CONTRACT UNIT PRICE EACH FOR "FRAMES AND LIDS TO BE ADJUSTED

THIS WORK WILL NOT BE PAID FOR WHEN DRAINAGE AND UTILITY STRUCTURES ARE SPECIFIED FOR PAYMENT AS STRUCTURE RECONSTRUCTION.

NEW FRAMES AND LIDS, WHEN SPECIFIED, WILL BE PAID FOR SEPARATELY.

#### DETAILS FOR FRAMES AND LIDS ADJUSTMENT WITH MILLING


ALL DIMENSIONS ARE IN INCHES (MILLIMETERS) UNLESS OTHERWISE SHOWN

DESIGNED - R. SHAH FILE NAME = USER NAME = bauerdl REVISED - R. WIEDEMAN 05-14-04 c:\pw\_work\pwidot\bauerdl\d0108315\bd08 DRAWN REVISED - R. BORO 01-01-07 CHECKED REVISED REVISED - R. BORO 12-06-11 PLOT DATE = 12/6/2011 DATE 10-25-94


STATE OF ILLINOIS **DEPARTMENT OF TRANSPORTATION** 

**DETAILS FOR** FRAMES AND LIDS ADJUSTMENT WITH MILLING SHEET NO. 1 OF 1 SHEETS STA.

COUNTY 1241 17-00119-00-RS LAKE 36 31 CONTRACT NO. 61E59 BD600-03 (BD-8)

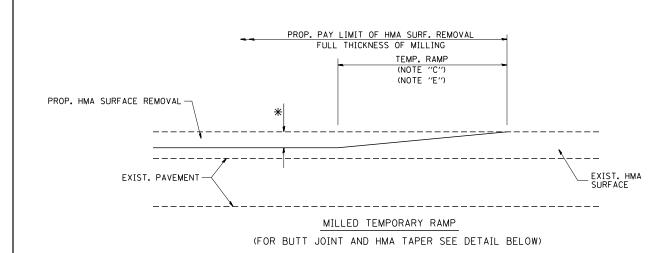


#### OPTION 1

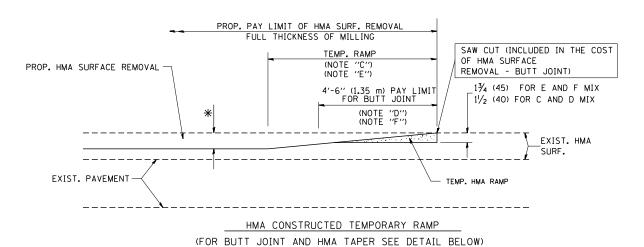

## OPTION 2

#### TYPICAL TEMPORARY RAMP

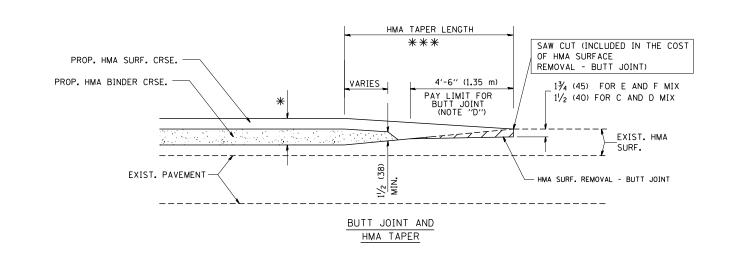


# TYPICAL BUTT JOINT AND HMA TAPER FOR MILLING AND RESURFACING


FILE NAME = DESIGNED - M. DE YONG REVISED - R. SHAH 10-25-94 USER NAME = gaglianobt W:\diststd\22x34\bd32.dqr DRAWN REVISED A. ABBAS 03-21-97 CHECKED REVISED M. GOMEZ 04-06-01 DATE R. BORO 01-01-07 PLOT DATE = 1/4/2008 06-13-90 REVISED

# STATE OF ILLINOIS DEPARTMENT OF TRANSPORTATION

ALL DIMENSIONS ARE IN INCHES (MILLIMETERS) UNLESS

OTHERWISE SHOWN.

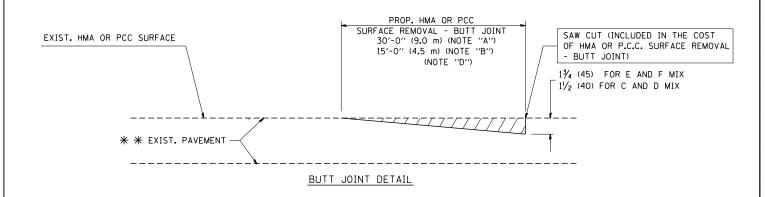

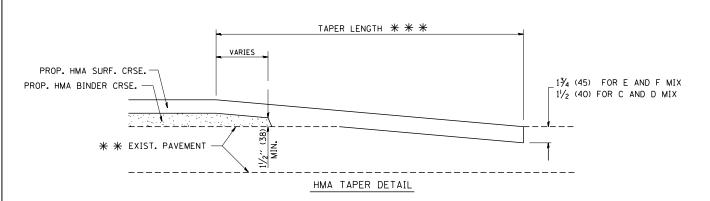

# TYPICAL BUTT JOINT AND HMA TAPER FOR RESURFACING ONLY

\* \* PC CONCRETE, HMA OR HMA RESURFACED PAVEMENT.


#### NOTES

- A: MAINLINE ROADWAYS AND MAJOR SIDE ROADS.
- B: MINOR SIDE ROADS.
- C: THE TEMP. RAMP SHALL BE CONSTRUCTED IMMEDIATELY UPON REMOVAL OF THE EXISTING HMA SURFACE.
- D: THE BUTT JOINT SHALL BE CONSTRUCTED IMMEDIATELY PRIOR TO PLACING THE PROPOSED HMA COURSES.
- E: TAPER THE TEMP. RAMP AT A RATE OF 3'-0" (900 mm) PER 1 INCH (25 mm) OF MILLING THICKNESS.
- F: INSTALLATION AND REMOVAL OF THE 4'-6" (1.35 m) TEMP. RAMP IS INCLUDED IN COST OF HMA SURFACE REMOVAL BUTT JOINT
- G: SEE ARTICLE 406.08 AND 406.14 OF THE STANDARD SPECIFICATIONS FOR "HMA AND/OR PCC SURFACE REMOVAL, BUTT JOINT".
- \* SEE TYPICAL SECTIONS FOR MILLING THICKNESS.
- \*\* \* 20'-0" (6.1 m) PER 1 (25) RESURFACING (NOTE "A") 10'-0" (3.0 m) PER 1 (25) RESURFACING (NOTE "B")

#### BASIS OF PAYMENT:

THE BUTT JOINT WILL BE PAID FOR AT THE CONTRACT UNIT PRICE PER SQUARE YARD (SQUARE METER) FOR "HOT-MIX ASPHALT SURFACE REMOVAL - BUTT JOINT" OR FOR "PORTLAND CEMENT CONCRETE SURFACE REMOVAL- BUTT JOINT".

SCALE: NONE

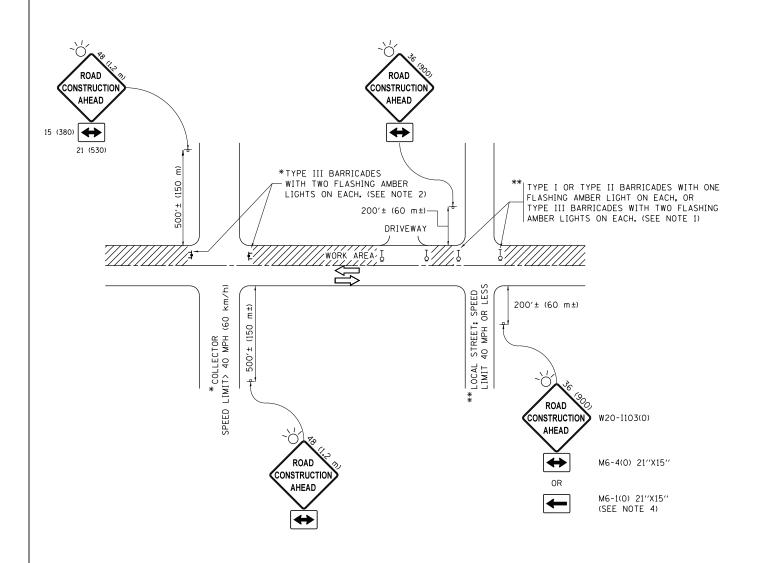

#### NOTES:

- SIDE ROAD WITH A SPEED LIMIT OF 40 MPH (60 km/h) OR LESS AS SHOWN ON THE DRAWING AND AS DIRECTED BY THE ENGINEER:
  - a) ONE "ROAD CONSTRUCTION AHEAD" SIGN 36 x 36 (900x900) WITH A FLASHER MOUNTED ON IT APPROXIMATELY 200" (60 m) IN ADVANCE OF THE MAIN ROUTE.
  - b) THE CLOSED PORTION OF THE MAIN ROUTE SHALL BE PROTECTED BY BLOCKING WITH TYPE I, TYPE II OR TYPE III BARRICADES, 1/3 OF THE CROSS SECTION OF THE CLOSED PORTION.
- 2. SIDE ROAD WITH A SPEED LIMIT GREATER THAN 40 MPH (60 km/h) AS SHOWN ON THE DRAWING AND AS DIRECTED BY THE ENGINEER:
  - a) ONE "ROAD CONSTRUCTION AHEAD" SIGN 48 x 48 (1.2 m x 1.2 m) WITH A FLASHER MOUNTED ON IT APPROXIMATELY 500" (150 m) IN ADVANCE OF THE MAIN ROUTE.
  - b) THE CLOSED PORTION OF THE MAIN ROUTE SHALL BE PROTECTED BY BLOCKING WITH TYPE III BARRICADES, 1/2 OF THE CROSS SECTION OF THE CLOSED PORTION.
- 3. CONES MAY BE SUBSTITUTED FOR BARRICADES OR DRUMS AT HALF THE SPACING DURING DAY OPERATIONS. CONES SHALL BE A MINIMUM OF 28 (710)
  IN HEICHT
- 4. WHEN THE SIDE ROAD LIES BETWEEN THE BEGINNING OF THE MAINLINE SIGNING AND THE WORK ZONE, A SINGLE HEADED ARROW (M6-1) SHALL BE USED IN LIEU OF THE DOUBLE HEADED ARROW (M6-4).

SCALE: NONE


- 5. WHEN WORK IS BEING PERFORMED ON A SIDE ROAD OR DRIVEWAY, FOLLOW THE APPLICABLE STANDARD(S). THE DIRECTIONAL ARROW (M6-1 OR M6-4) SHALL BE COVERED OR REMOVED WHEN NO LONGER CONSISTENT WITH THE TRAFFIC CONTROL SET-UP.
- 6. ADVANCE WARNING SIGNS ARE TO BE OMITTED ON DRIVEWAYS UNLESS OTHERWISE SPECIFIED IN THE PLANS OR BY THE ENGINEER
- 7. THE TRAFFIC CONTROL AND PROTECTION FOR SIDE ROADS, INTERSECTIONS, AND DRIVEWAYS SHALL BE INCLUDED IN THE COST OF SPECIFIED TRAFFIC CONTROL STANDARDS OR ITEMS.


All dimensions are in inches (millimeters) unless otherwise shown.


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	PLOT SCALE = 50.000 '/ in.	CHECKED -	REVISED	- A. SCHUETZE 07-01-13
Default	PLOT DATE = 9/15/2016	DATE - 06-89	REVISED	- A. SCHUETZE 09-15-16

STATI	E OF	ILLINOIS
DEPARTMENT	0F	TRANSPORTATION

	TRAFFIC CONTROL AND PROTECTION FOR DE ROADS, INTERSECTIONS, AND DRIVEWAYS					F.A.U. RTE.	SECTION
CI	SIDE DOADS INTERSECTIONS AND DRIVEWAVS						17-00119-00-RS
SIDE NUADS, INTENSECTION				, AND L	JIIVLVVAIS		TC-10
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#### WIDTH OF LINE PATTERN COLOR SPACING / REMARKS SKIP-DASH YELLOW 10' (3 m) LINE WITH 30' (9 m) SPACE CENTERLINE ON MULTI-LANE UNDIVIDED PAVEMENT 2 @ 4 (100) SOLID YELLOW 11 (280) C-C NO PASSING ZONE LINES: FOR ONE DIRECTION FOR BOTH DIRECTIONS 5½ (140) C-C FROM SKIP-DASH CENTERLINE 11 (280) C-C OMIT SKIP-DASH CENTERLINE BETWEEN 4 (100) 2 **e** 4 (100) SOLID SOLID YELLOW YELLOW 10' (3 m) LINE WITH 30' (9 m) SPACE LANE LINES SKIP-DASH SKIP-DASH 4 (100) 5 (125) ON FREEWAYS DOTTED LINES (EXTENSIONS OF CENTER, LANE OR TURN LANE MARKINGS) SAME AS LINE BEING EXTENDED SKIP-DASH SAME AS LINE BEING EXTENDED 2' (600) LINE WITH 6' (1.8 m) SPACE EDGE LINES SOLID 4 (100) OUTLINE MEDIANS IN YELLOW YELLOW-LEFT WHITE-RIGHT 6 (150) LINE; FULL SIZE LETTERS & SYMBOLS (8' (2.4m) SEE TYPICAL TURN LANE MARKING DETAIL TURN LANE MARKINGS SOLID 10' (3 m) LINE WITH 30' (9 m) SPACE FOR SKIP-DASH; 5/2 (140) C-C BETWEEN SOLID LINE AND SKIP-DASH LINE SEE TYPICAL TWO-WAY LEFT TURN MARKING DETAIL TWO WAY LEFT TURN MARKING 2 @ 4 (100) EACH DIRECTION YELLOW 8' (2.4m) LEFT ARROW WHITE CROSSWALK LINES (PEDESTRIAN) A. DIAGONALS (BIKE & EQUESTRIAN) B. LONGITUDINAL BARS (SCHOOL) 2 @ 6 (150) 12 (300) @ 45° 12 (300) @ 90° NOT LESS THAN 6' (1.8 m) APART 2' (600) APART 2' (600) APART SOLID SOLID WHITE SEE TYPICAL CROSSWALK MARKING DETAILS. PLACE 4' (1.2 m) IN ADVANCE OF AND PARALLEL TO CROSSMALK, IF PRESENT. OTHERWISE, PLACE AT DESIRED STOPPING POINT. PARALLEL TO CROSSROAD CENTERLINE, WHERE POSSIBLE STOP LINES 24 (600) SOLID WHITE 2 @ 4 (100) WITH 12 (300) DIAGONALS @ 45° NO DIAGONALS USED FOR 4' (1,2 m) WIDE MEDIANS 11 (280) C-C FOR THE DOUBLE LINE SEE TYPICAL PAINTED MEDIAN MARKING. SOLID PAINTED MEDIANS YELLOW: TWO WAY TRAFFIC WHITE: ONE WAY TRAFFIC GORE MARKING AND CHANNELIZING LINES 8 (200) WITH 12 (300) DIAGONALS @ 45° DIAGONALS: 15' (4.5' m) C-C (LESS THAN 30MPH (50 km/h)) 20' (6' m) C-C 30MPH (50 km/h) TO 45MPH (70 km/h)) 30' (9' m) C-C (OVER 45MPH (70 km/h)) 24 (600) TRANSVERSE LINES; "RR" IS 6' (1.8 LETTERS; 16 (400) LINE FOR "X" SEE STATE STANDARD 780001 AREA OF: "R"=3.6 SO. FT. (0.33 m²) EACH "X"=54.0 SO. FT. (5.0 m²) RAILROAD CROSSING SOLID WHITE 50' (15 m) C-C (LESS THAN 30MPH (50 km/h)) 75' (25 m) C-C (30 MPH (50 km/h) T0 45MPH (70 km/h)) 150' (45 m) C-C (0VER 45MPH (70 km/h)) SHOULDER DIAGONALS (REQUIRED FOR 12 (300) **ø** 45° SOLID WHITE - RIGHT YELLOW - LEFT SHOULDERS > 8') U TURN ARROW SEE DETAIL SOLID WHITE 16.3 SF 2 ARROW COMBINATION LEFT AND U TURN SEE DETAIL SOLID WHITE 30.4 SF

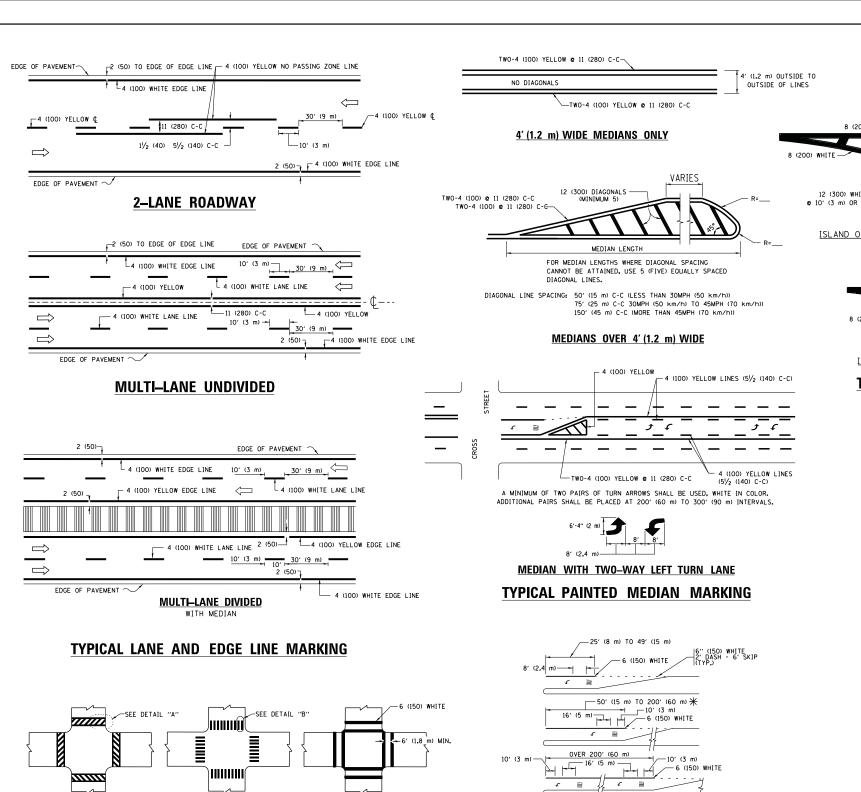**U-TURN** 

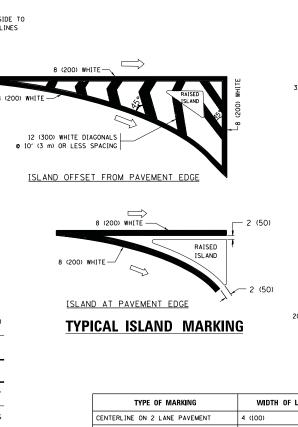FOR FURTHER DETAILS ON PAVEMENT MARKING REFER TO STANDARD SPECIFICATIONS FOR ROAD AND BRIDGE CONSTRUCTION AND STATE STANDARD 780001.

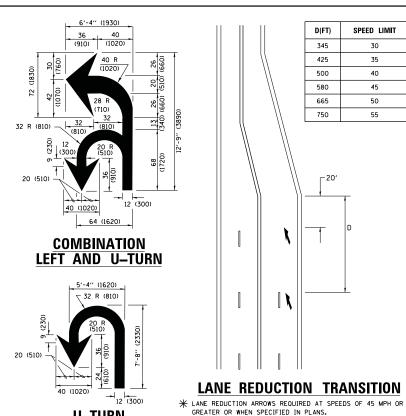SCALE: NON

All dimensions are in inches (millimeters) unless otherwise shown.

FILE NAME =	USER NAME = leyso	DESIGNED - EVERS	REVISED -	C. JUCIUS 09-09-09
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	PLOT SCALE = 50.000 '/ in.	CHECKED -	REVISED -	C. JUCIUS 12-21-15
Default	PLOT DATE = 6/23/2017	DATE - 03-19-90	REVISED -	C. JUCIUS 04-12-16

TYPICAL CROSSWALK MARKING

\* MARKINGS SHALL BE INSTALLED PARALLEL TO THE CENTERLINE OF

6 (150) WHITE

DETAIL "A"

2' (600)

DETAIL "B"

-12 (300) WHITE

PEDESTRIAN

BICYCLE & EQUESTRIAN

STATE OF ILLINOIS **DEPARTMENT OF TRANSPORTATION** 

FULL SIZE LETTERS 8' (2.4 m) AND ARROWS SHALL BE USED.


ARROW - "ONLY".

AREA = 15.6 SO. FT. (1.5 m<sup>2</sup> ) ONLY AREA = 20.8 SO. FT. (1.9 m<sup>2</sup>) \* TURN LANES IN EXCESS OF 400' (120 m) IN LENGTH MAY HAVE AN ADDITIONAL SET OF ARROW - "ONLY" INSTALLED MIDWAY BETWEEN THE OTHER TWO SETS OF

TYPICAL LEFT (OR RIGHT) TURN LANE


TYPICAL TURN LANE MARKING

		DI	STRICT O	NE		F.A.U. RTE.	SECTION	COUNTY	TOTAL SHEETS	SHEET NO.
	TYPICAL PAVEMENT MARKINGS					1241	17-00119-00-RS	LAKE	36	34
							TC-13	CONTRACT	NO. 6	1E59
NE	SHEET 1	OF 1	SHEETS	STA.	TO STA.		ILLINOIS FED.	AID PROJECT		

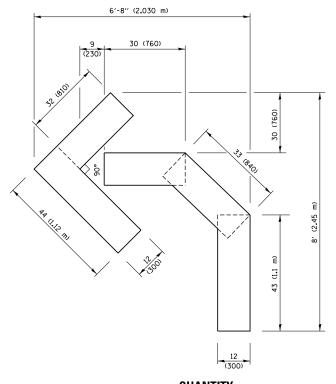


#### QUANTITY

4 (100) LINE = 45.5 ft. (13.9 m) 15.2 sq. ft. (1.41 sq. m)

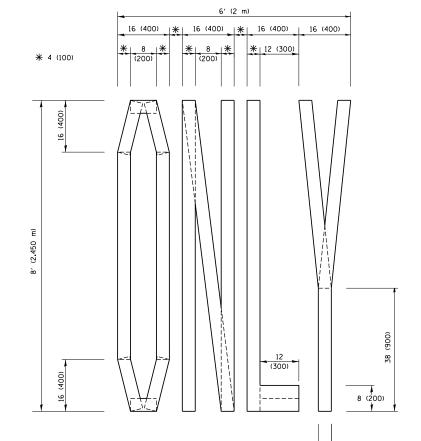

4 (100) LINE = 64.1 ft. (19.5 m) 21.4 sq. ft. (1.99 sq. m)

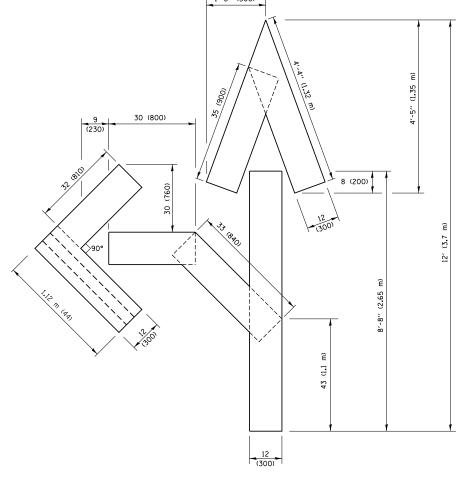


#### **QUANTITY**

4 (100) LINE = 82.5 ft. (25.1 m) 27.5 sq. ft. (2.53 sq. m)

#### NOTE:

ALL QUANTITIES OF PLACEMENT ARE REPRESENTED IN LINEAR FEET OF 4" LINES TO MATCH THE 4" TEMPORARY TAPE PAY ITEM AND REPRESENTS THE TOTAL QUANTITY OF 4" TAPE REQUIRED.

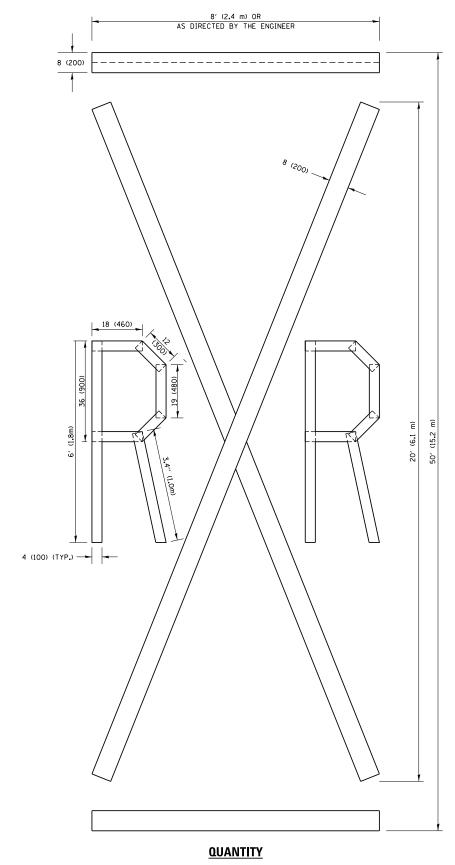

4 (100) LINE = 225.9 ft. (68.9 m) 75.3 sq. ft. (6.99 sq. m)


All dimensions are in inches (millimeters) unless otherwise shown.

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	PLOT SCALE = 50.0000 '/ in.	CHECKED -	REVISED	-E. GOMEZ 08-28-00
	PLOT DATE = 9/15/2016	DATE - 09-18-94	REVISED	- A. SCHUETZE 09-15-16

QUANTITY

STATE OF ILLINOIS
DEPARTMENT OF TRANSPORTATION

			LETTERS AND	SYMBOLS	F.A.U. RTE.	SECTION	COUNTY TOTAL SHEE SHEETS NO.			
ı	SHORT	TERM PAVEMENT MARKING	1241	17-00119-00-RS	LAKE	36	35			
I				TC-16	CONTRACT	NO. 6	1E59			
ı	SCALE: NONE	SHEET NO. 1 OF 1 SHEETS	STA.	TO STA.	FED. RO	DAD DIST. NO. 1 ILLINOIS FED. A	ID PROJECT			

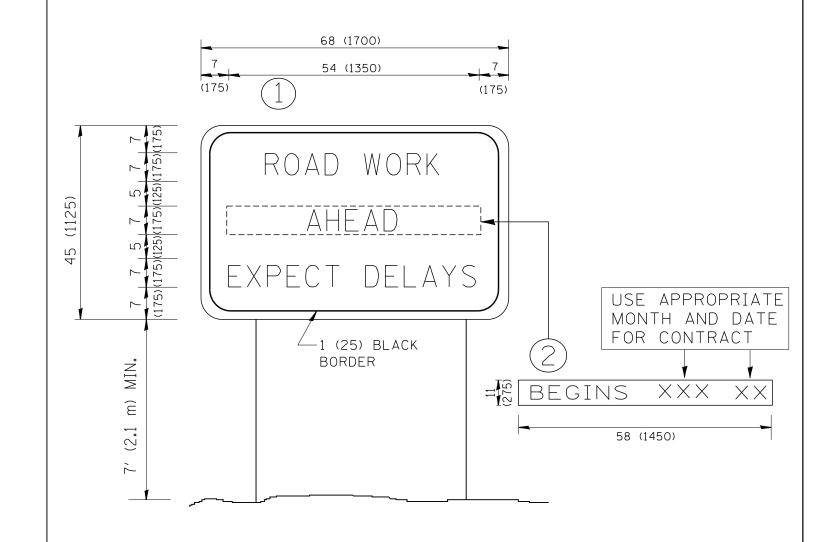

## NOTES:

- 1. USE BLACK LETTERING ON ORANGE BACKGROUND.
- 2. ERECT SIGNS IN ADVANCE OF THE LOCATION FOR THE "ROAD CONSTRUCTION AHEAD" SIGN AT LOCATIONS AS DIRECTED BY THE ENGINEER.
- 3. ERECT SIGN (1) WITH INSTALLED PANEL (2) ONE WEEK PRIOR TO THE START OF CONSTRUCTION.
- 4. REMOVE PANEL (2) SOON AFTER THE START OF CONSTRUCTION.
- 5. SEE SPECIAL PROVISION FOR "TEMPORARY INFORMATION SIGNING" FOR ADDITIONAL INFORMATION.
- 6. ONE SIGN ASSEMBLY EQUALS 25.70 SQ. FT. (2.3 SQ. M.)
- 7. SHALL BE PAID FOR AS TEMPORARY INFORMATION SIGNING.

ALL DIMENSIONS ARE IN INCHES (MILLIMETERS) UNLESS OTHERWISE SHOWN.

FILE NAME =	USER NAME = gaglianobt	DESIGNED -	REVISED - R. MIRS 09-15-97			ARTERIAL ROAD		F.A.U. RTE.	SECTION	COUNTY	TOTAL	SHEET NO.
W:\diststd\22x34\tc22.dgn		DRAWN -	REVISED - R. MIRS 12-11-97	STATE OF ILLINOIS		INFORMATION SIGN		1241	17-00119-00-RS	LAKE	36	36
	PLOT SCALE = 50.000 '/ IN.	CHECKED -	REVISED -T. RAMMACHER 02-02-99	DEPARTMENT OF TRANSPORTATION		INFORMATION SIGN			TC-22	CONTRACT	NO. 61	E59
	PLOT DATE = 1/4/2008	DATE -	REVISED - C. JUCIUS 01-31-07		SCALE: NONE	SHEET NO. 1 OF 1 SHEETS STA.	TO STA.	FED. ROAD	DIST. NO. 1 ILLINOIS FED.	AID PROJECT		