
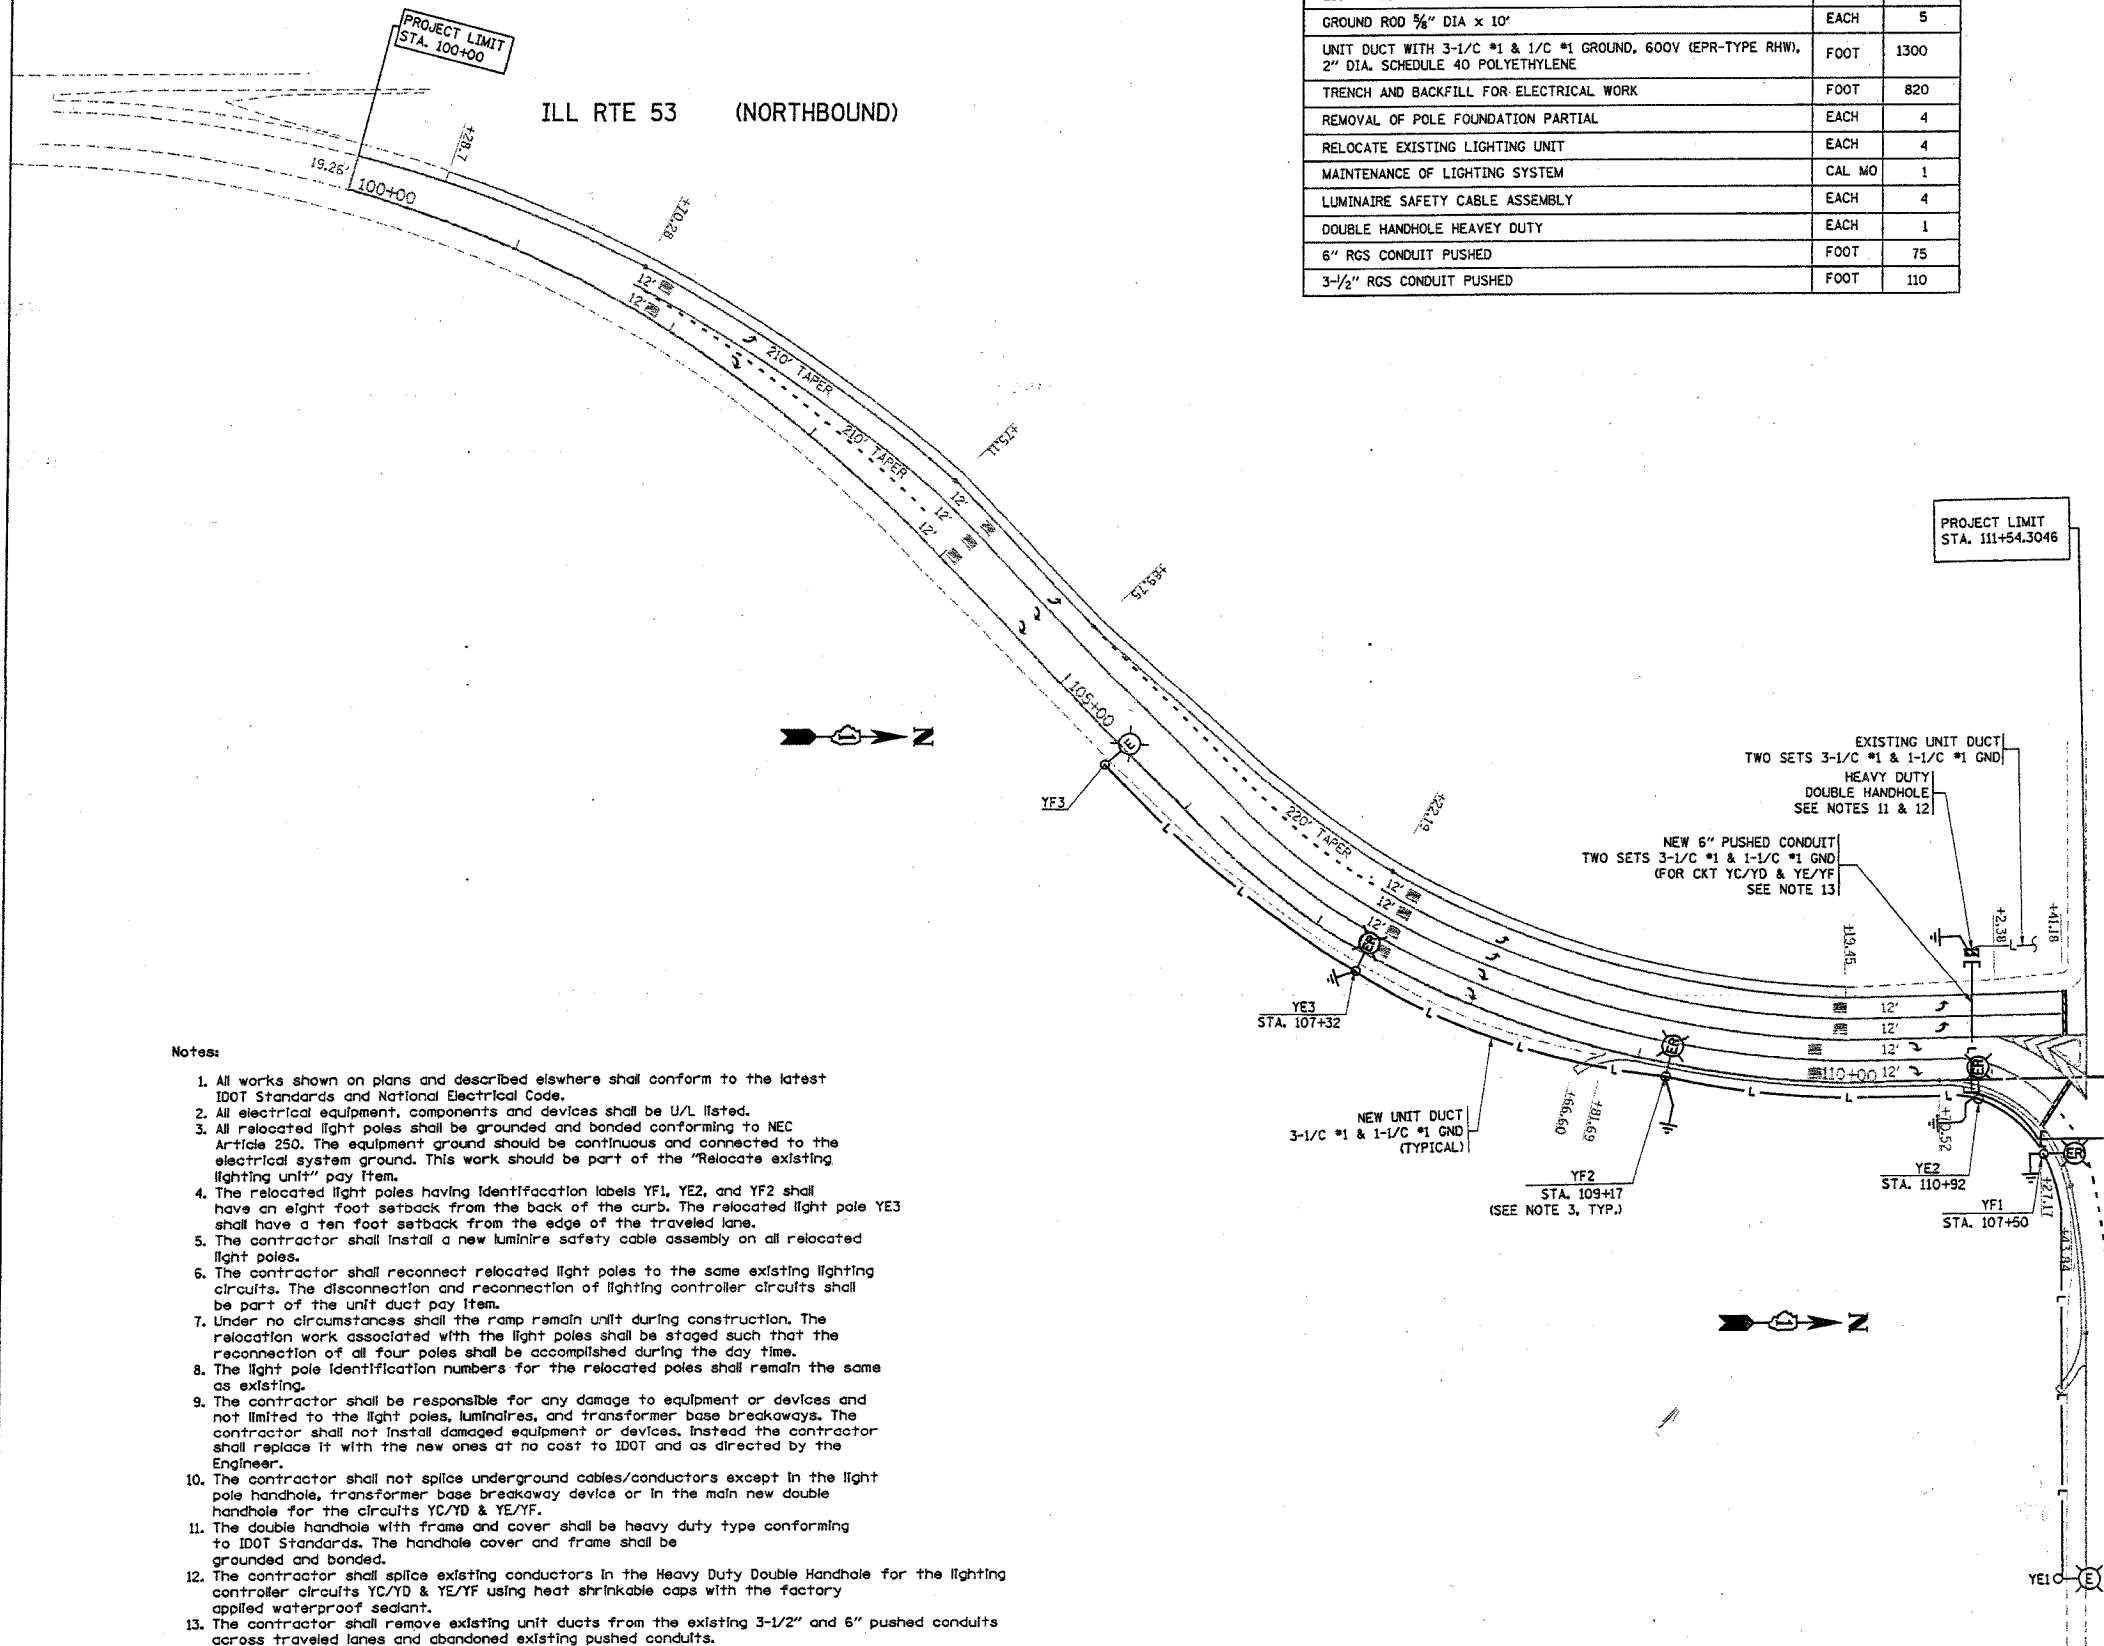


CONTRACT NO.			
F.A. RTE.	SECTION	COUNTY	TOTAL SHEETS
	530-N-2	COOK	53 19
STA. 100+00		TO STA. 111+54.3406	
FED. ROAD DIST. NO.		ILLINOIS FED. AID PROJECT	
CONTRACT NO. 60A61			

IL-53 & IL-68 SUMMARY OF QUANTITIES ELECTRICAL PAY ITEMS

ITEM DESCRIPTION	QUANTITY	UNIT	QUANTITY
LIGHT POLE FOUNDATION 30" DIAMETER		FOOT	40
GROUND ROD 5/8" DIA x 10'		EACH	5
UNIT DUCT WITH 3-1/2" #1 & 1/2" #1 GROUND, 600V (EPR-TYPE RHW), 2" DIA. SCHEDULE 40 POLYETHYLENE		FOOT	1300
TRENCH AND BACKFILL FOR ELECTRICAL WORK		FOOT	820
REMOVAL OF POLE FOUNDATION PARTIAL		EACH	4
RELOCATE EXISTING LIGHTING UNIT		EACH	4
MAINTENANCE OF LIGHTING SYSTEM		CAL MO	1
LUMINAIRE SAFETY CABLE ASSEMBLY		EACH	4
DOUBLE HANDHOLE HEAVEY DUTY		EACH	1
6" RGS CONDUIT PUSHED		FOOT	75
3-1/2" RGS CONDUIT PUSHED		FOOT	110

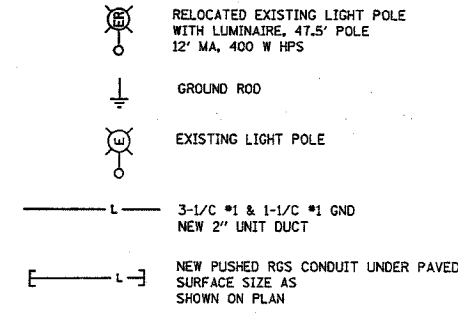

Notes:

- All works shown on plans and described elsewhere shall conform to the latest IDOT Standards and National Electrical Code.
- All electrical equipment, components and devices shall be U/L listed.
- All relocated light poles shall be grounded and bonded conforming to NEC Article 250. The equipment ground should be continuous and connected to the electrical system ground. This work should be part of the "Relocate existing lighting unit" pay item.
- The relocated light poles having identification labels YF1, YE2, and YF2 shall have an eight foot setback from the back of the curb. The relocated light pole YE3 shall have a ten foot setback from the edge of the traveled lane.
- The contractor shall install a new luminaire safety cable assembly on all relocated light poles.
- The contractor shall reconnect relocated light poles to the same existing lighting circuits. The disconnection and reconnection of lighting controller circuits shall be part of the unit duct pay item.
- Under no circumstances shall the ramp remain unit during construction. The relocation work associated with the light poles shall be staged such that the reconnection of all four poles shall be accomplished during the day time.
- The light pole identification numbers for the relocated poles shall remain the same as existing.
- The contractor shall be responsible for any damage to equipment or devices and not limited to the light poles, luminaires, and transformer base breakaways. The contractor shall not install damaged equipment or devices. Instead the contractor shall replace it with the new ones at no cost to IDOT and as directed by the Engineer.
- The contractor shall not splice underground cables/conductors except in the light pole handhole, transformer base breakaway device or in the main new double handhole for the circuits YC/YD & YE/YF.
- The double handhole with frame and cover shall be heavy duty type conforming to IDOT Standards. The handhole cover and frame shall be grounded and bonded.
- The contractor shall splice existing conductors in the Heavy Duty Double Handhole for the lighting controller circuits YC/YD & YE/YF using heat shrinkable caps with the factory applied waterproof sealant.
- The contractor shall remove existing unit ducts from the existing 3-1/2" and 6" pushed conduits across traveled lanes and abandoned existing pushed conduits.

REVISIONS	
NAME	DATE

ILLINOIS DEPARTMENT OF TRANSPORTATION
 PROPOSED ROADWAY LIGHTING PLAN
 IL-53 NORTH EXIT RAMP "C"
 FOR IL. 68 (E&W)
 SCALE: VERT. 1"=50'
 HORIZ. DATE 12/21/2005
 DRAWN BY CADD
 CHECKED BY

PLOT DATE = 12/21/2005
 FILE NAME = c:\projects\11060905\sh_11060905.dwg
 PLOT SCALE = 1/8"=1'-0"
 USER NAME = c:\admin