

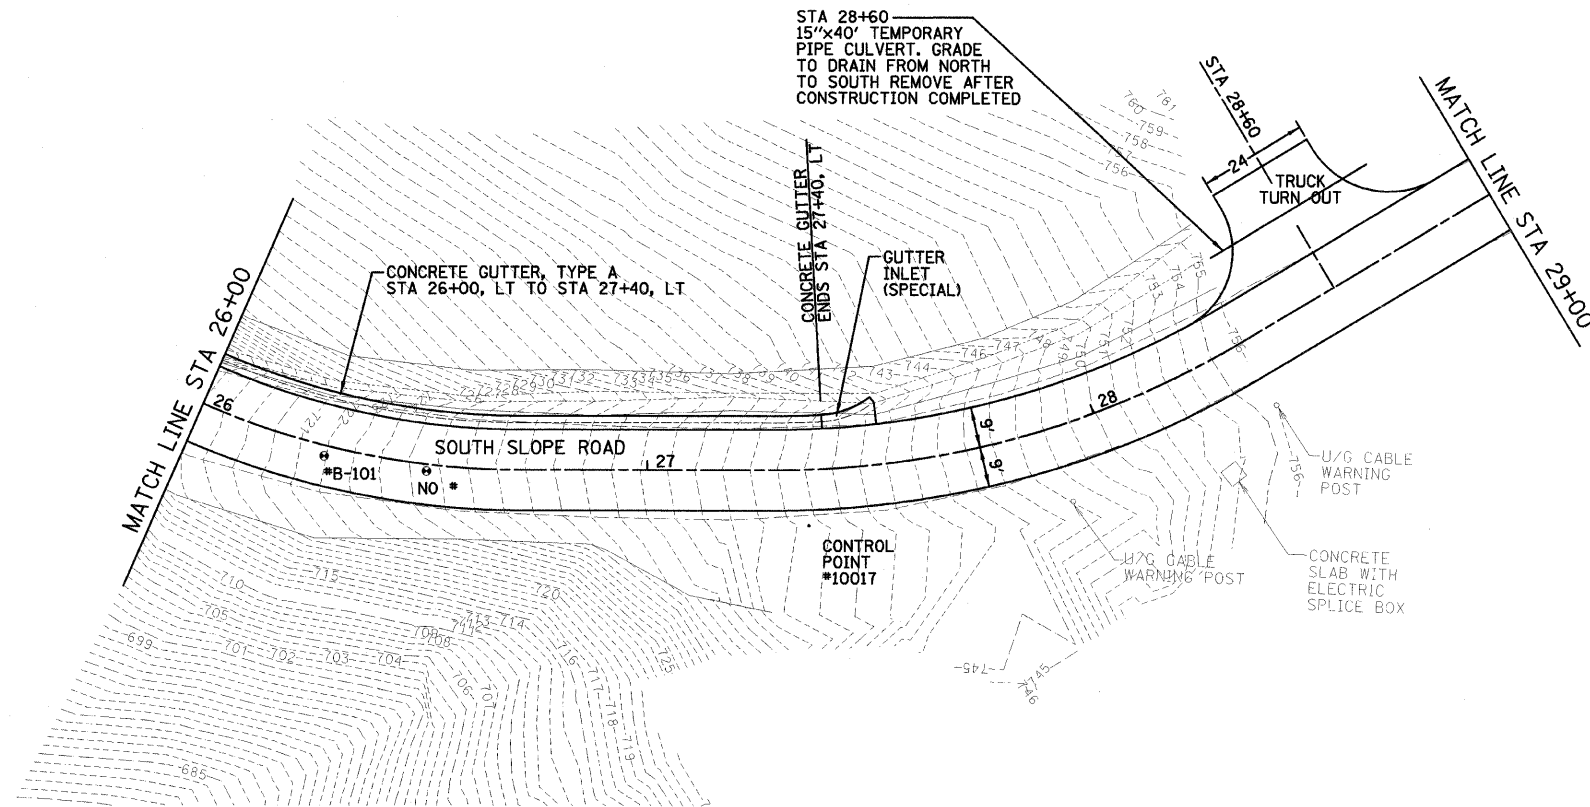


PLAN SURVEYED BY DATE
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 NOTE BOOK NO. FILED BY DATE
 FILE NAME

PROFILE SURVEYED BY DATE
 PLOTTED BY
 NOTE BOOK NO. FILED BY DATE
 FILE NAME

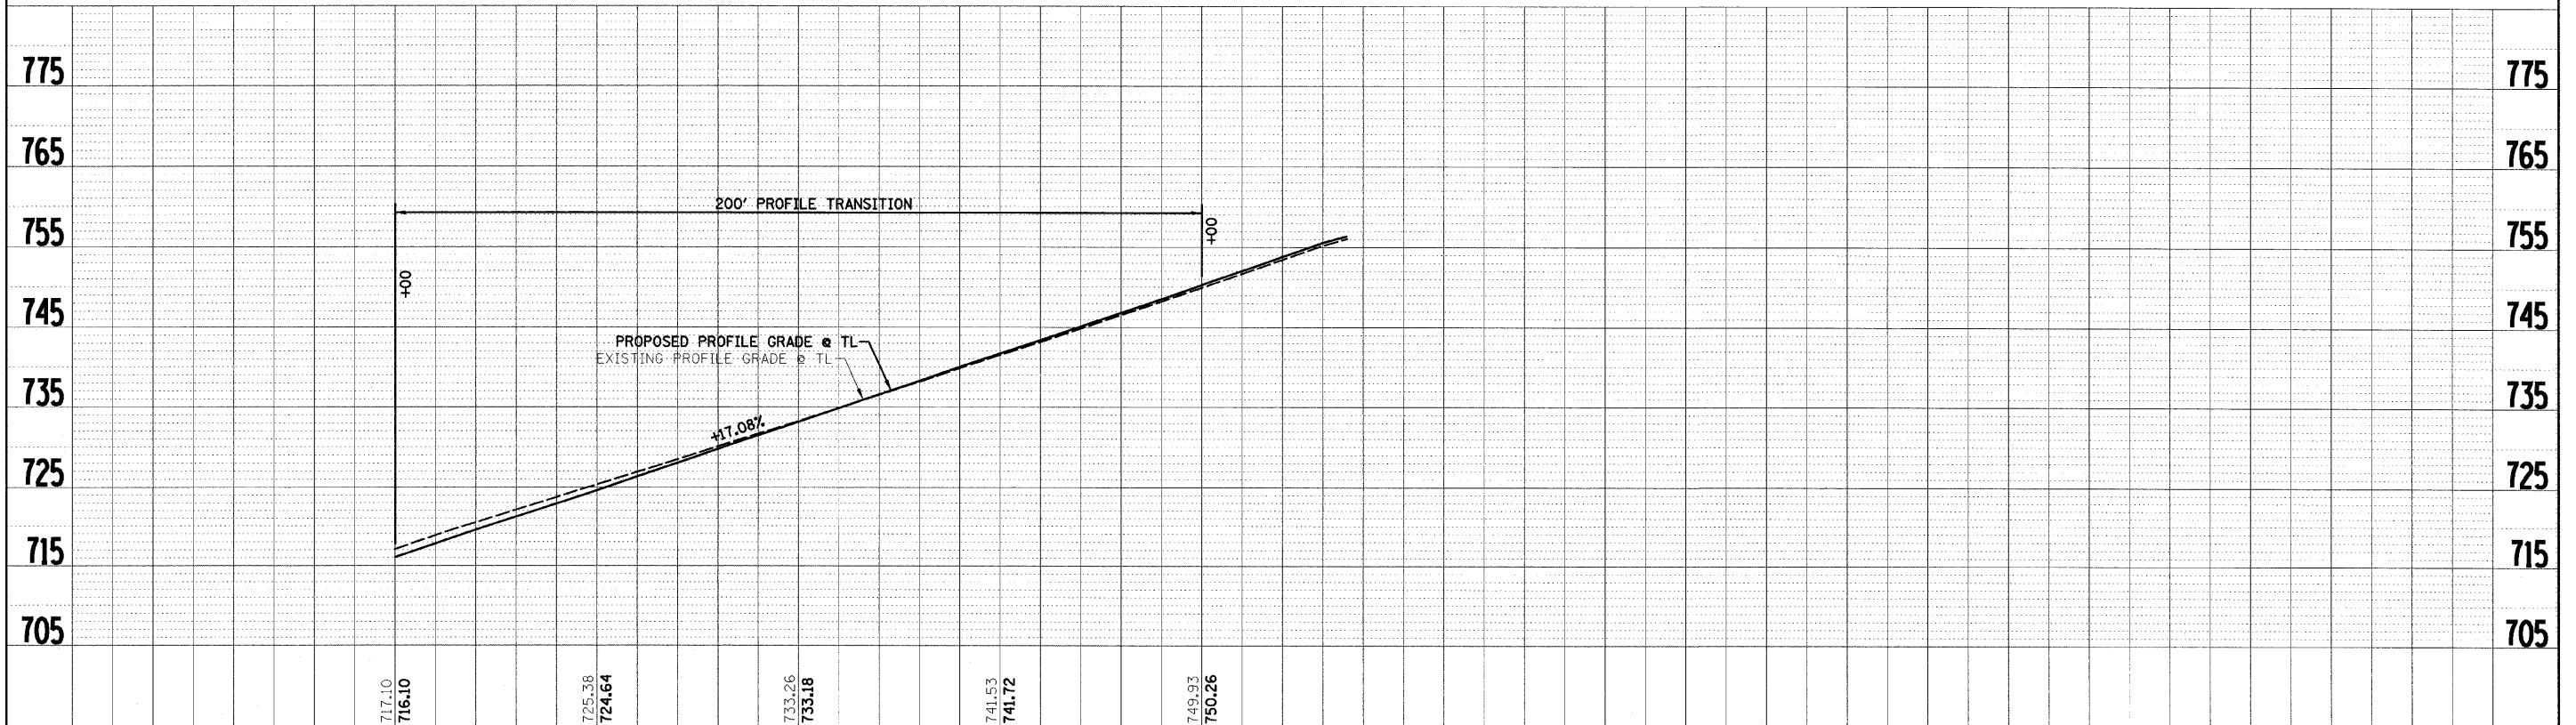

- NOTE:**
1. PLACE 100 FT LENGTH OF PERIMETER EROSION CONTROL BARRIER AT THE SAGS IN THE ROADWAY. LOCATIONS TO BE DETERMINED BY THE RESIDENT ENGINEER.
 2. NO TREES ARE TO BE REMOVED. THE CONTRACTOR SHALL COORDINATE HIS/HER WORK TO AVOID ANY DAMAGE TO TREES OR ROOTS.
 3. CULVERTS SHALL HAVE A MINIMUM OF 1 FOOT OF COVER AS MEASURED BETWEEN THE ROADWAY SURFACE AND THE TOP OF THE CULVERT.
 4. CULVERT FLOWLINES SHALL MATCH THE EXISTING DITCH FLOWLINES.

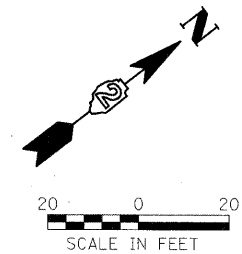

FILE NAME = #FILEL#	USER NAME = #USER#	DESIGNED - PJM	REVISED - 01-14-11	STATE OF ILLINOIS DEPARTMENT OF TRANSPORTATION		SOUTH SLOPE ROAD PLAN AND PROFILE SHEET		F.A. RTE.	SECTION	COUNTY	TOTAL SHEETS	SHEET NO.
	PLOT SCALE = #SCALE#	DRAWN - DRR	REVISED -			SCALE: 1"=20'	SHEET NO. 12 OF 36 SHEETS	STA. 26+00.00 TO STA. 29+00.00	FED. ROAD DIST. NO.	ILLINOIS FED. AID PROJECT	CARROLL	36
	PLOT DATE = #DATE#	CHECKED - LAW	REVISED -			CONTRACT NO. 46166		REVISED 01/26/11 DRR				
		DATE - 10-29-10	REVISED -					24-8373				