


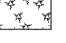
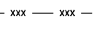
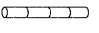
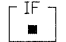
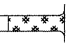
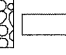
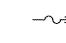
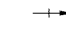



EROSION CONTROL LEGEND


-  INLET AND PIPE PROTECTION
-  TEMPORARY DITCH CHECK
-  PERIMETER EROSION BARRIER
-  TEMPORARY EROSION CONTROL SEEDING WITH MULCH METHOD 2
-  - xxx - xxx - TEMPORARY CHAIN LINK FENCE
-  EC, TEMPORARY PIPE SLOPE DRAIN
-  IF INLET FILTER
-  STABILIZED CONSTRUCTION ENTRANCE
-  STONE OUTLET STRUCTURE SEDIMENT TRAP
-  DITCH FLOW
-  SWALE
-  DRAINAGE SUMMIT

MATCH LINE SEE DRAWING EC-15

MATCH LINE SEE DRAWING EC-5
RAMP B STA. 3005+00.00
RAMP E STA. 121+62.75



MATCH LINE SEE DRAWING EC-4
EAST FRONTAGE RD STA. 8018+96.11
RAMP B STA. 3018+96.11
RAMP E STA. 106+76.88

MATCH LINE SEE DRAWING EC-7
EAST FRONTAGE RD STA. 8047+00.00

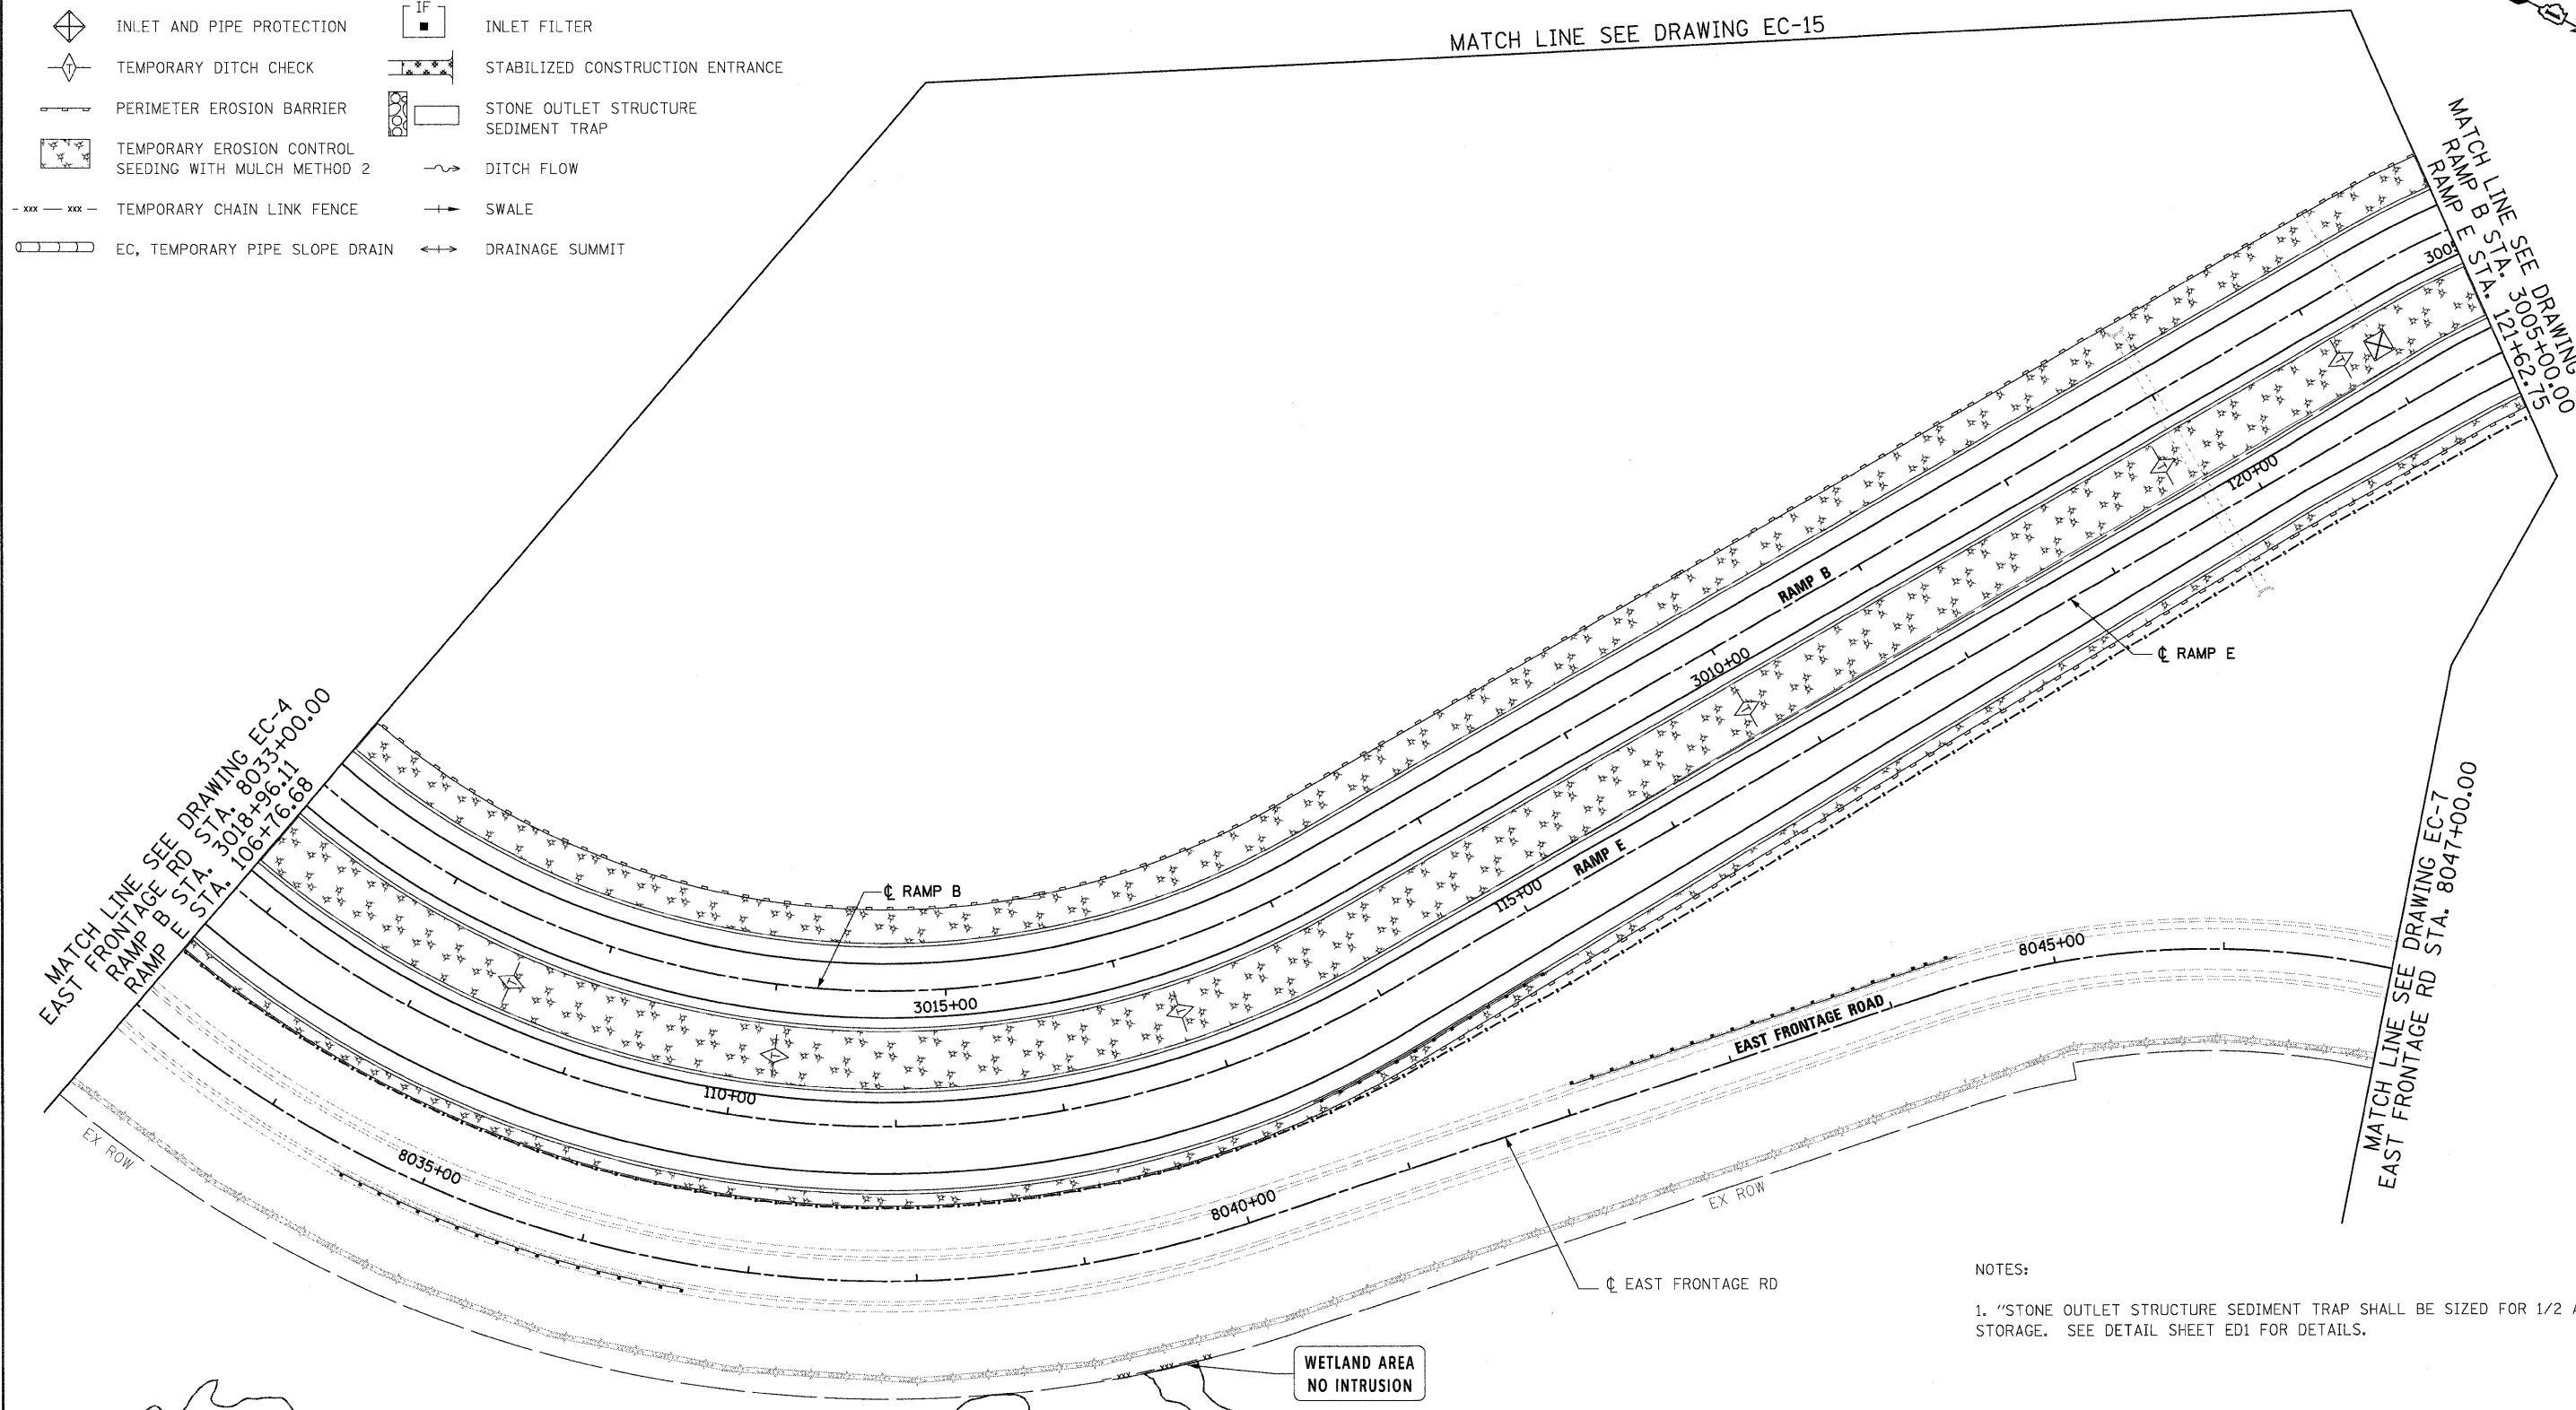

NOTES:

1. "STONE OUTLET STRUCTURE SEDIMENT TRAP SHALL BE SIZED FOR 1/2 ACRE STORAGE. SEE DETAIL SHEET ED1 FOR DETAILS.

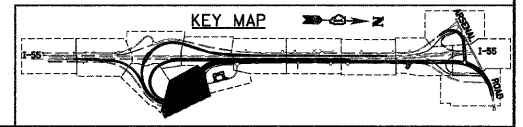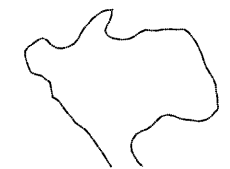

McDonough Associates Inc.
 Engineers / Architects
 130 East Randolph Street, Chicago, Illinois 60601

FILE NAME =	USER NAME = TKluegel
D160F12-SH7-EROS16.cgn	

DESIGNED - JCL	REVISD -
DRAWN - JCL	REVISD -
CHECKED - DLT	REVISD -
DATE - 2/4/11	REVISD -

PLDT SCALE = 1:50
PLDT DATE = 2/3/2011

DESIGNED - JCL	REVISD -
DRAWN - JCL	REVISD -
CHECKED - DLT	REVISD -
DATE - 2/4/11	REVISD -

**STATE OF ILLINOIS
DEPARTMENT OF TRANSPORTATION**

EROSION AND SEDIMENT CONTROL PLAN

SCALE: 1"=50' SHEET NO. 6 OF 15 SHEETS STA. TO STA.

F.A.I. RTE.	SECTION	COUNTY	TOTAL SHEETS	SHEET NO.
55	99-2HB-2B-1	WILL	756	155
CONTRACT NO. 60F12				
FED. ROAD DIST. NO. 1 ILLINOIS FED. AID PROJECT				