
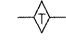

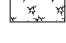
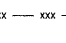
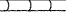
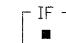
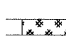







- EROSION CONTROL LEGEND**
-  INLET AND PIPE PROTECTION
 -  TEMPORARY DITCH CHECK
 -  PERIMETER EROSION BARRIER
 -  TEMPORARY EROSION CONTROL SEEDING WITH MULCH METHOD 2
 -  TEMPORARY CHAIN LINK FENCE
 -  EC, TEMPORARY PIPE SLOPE DRAIN
 -  INLET FILTER
 -  STABILIZED CONSTRUCTION ENTRANCE
 -  STONE OUTLET STRUCTURE SEDIMENT TRAP
 -  DITCH FLOW
 -  SWALE
 -  DRAINAGE SUMMIT

MATCH LINE SEE DRAWING EC-10 WEST FRONTAGE CONNECTOR STA. 6064+50.00


MATCH LINE SEE DRAWING EC-10 ARSENAL RD STA. 947+00.00

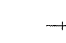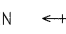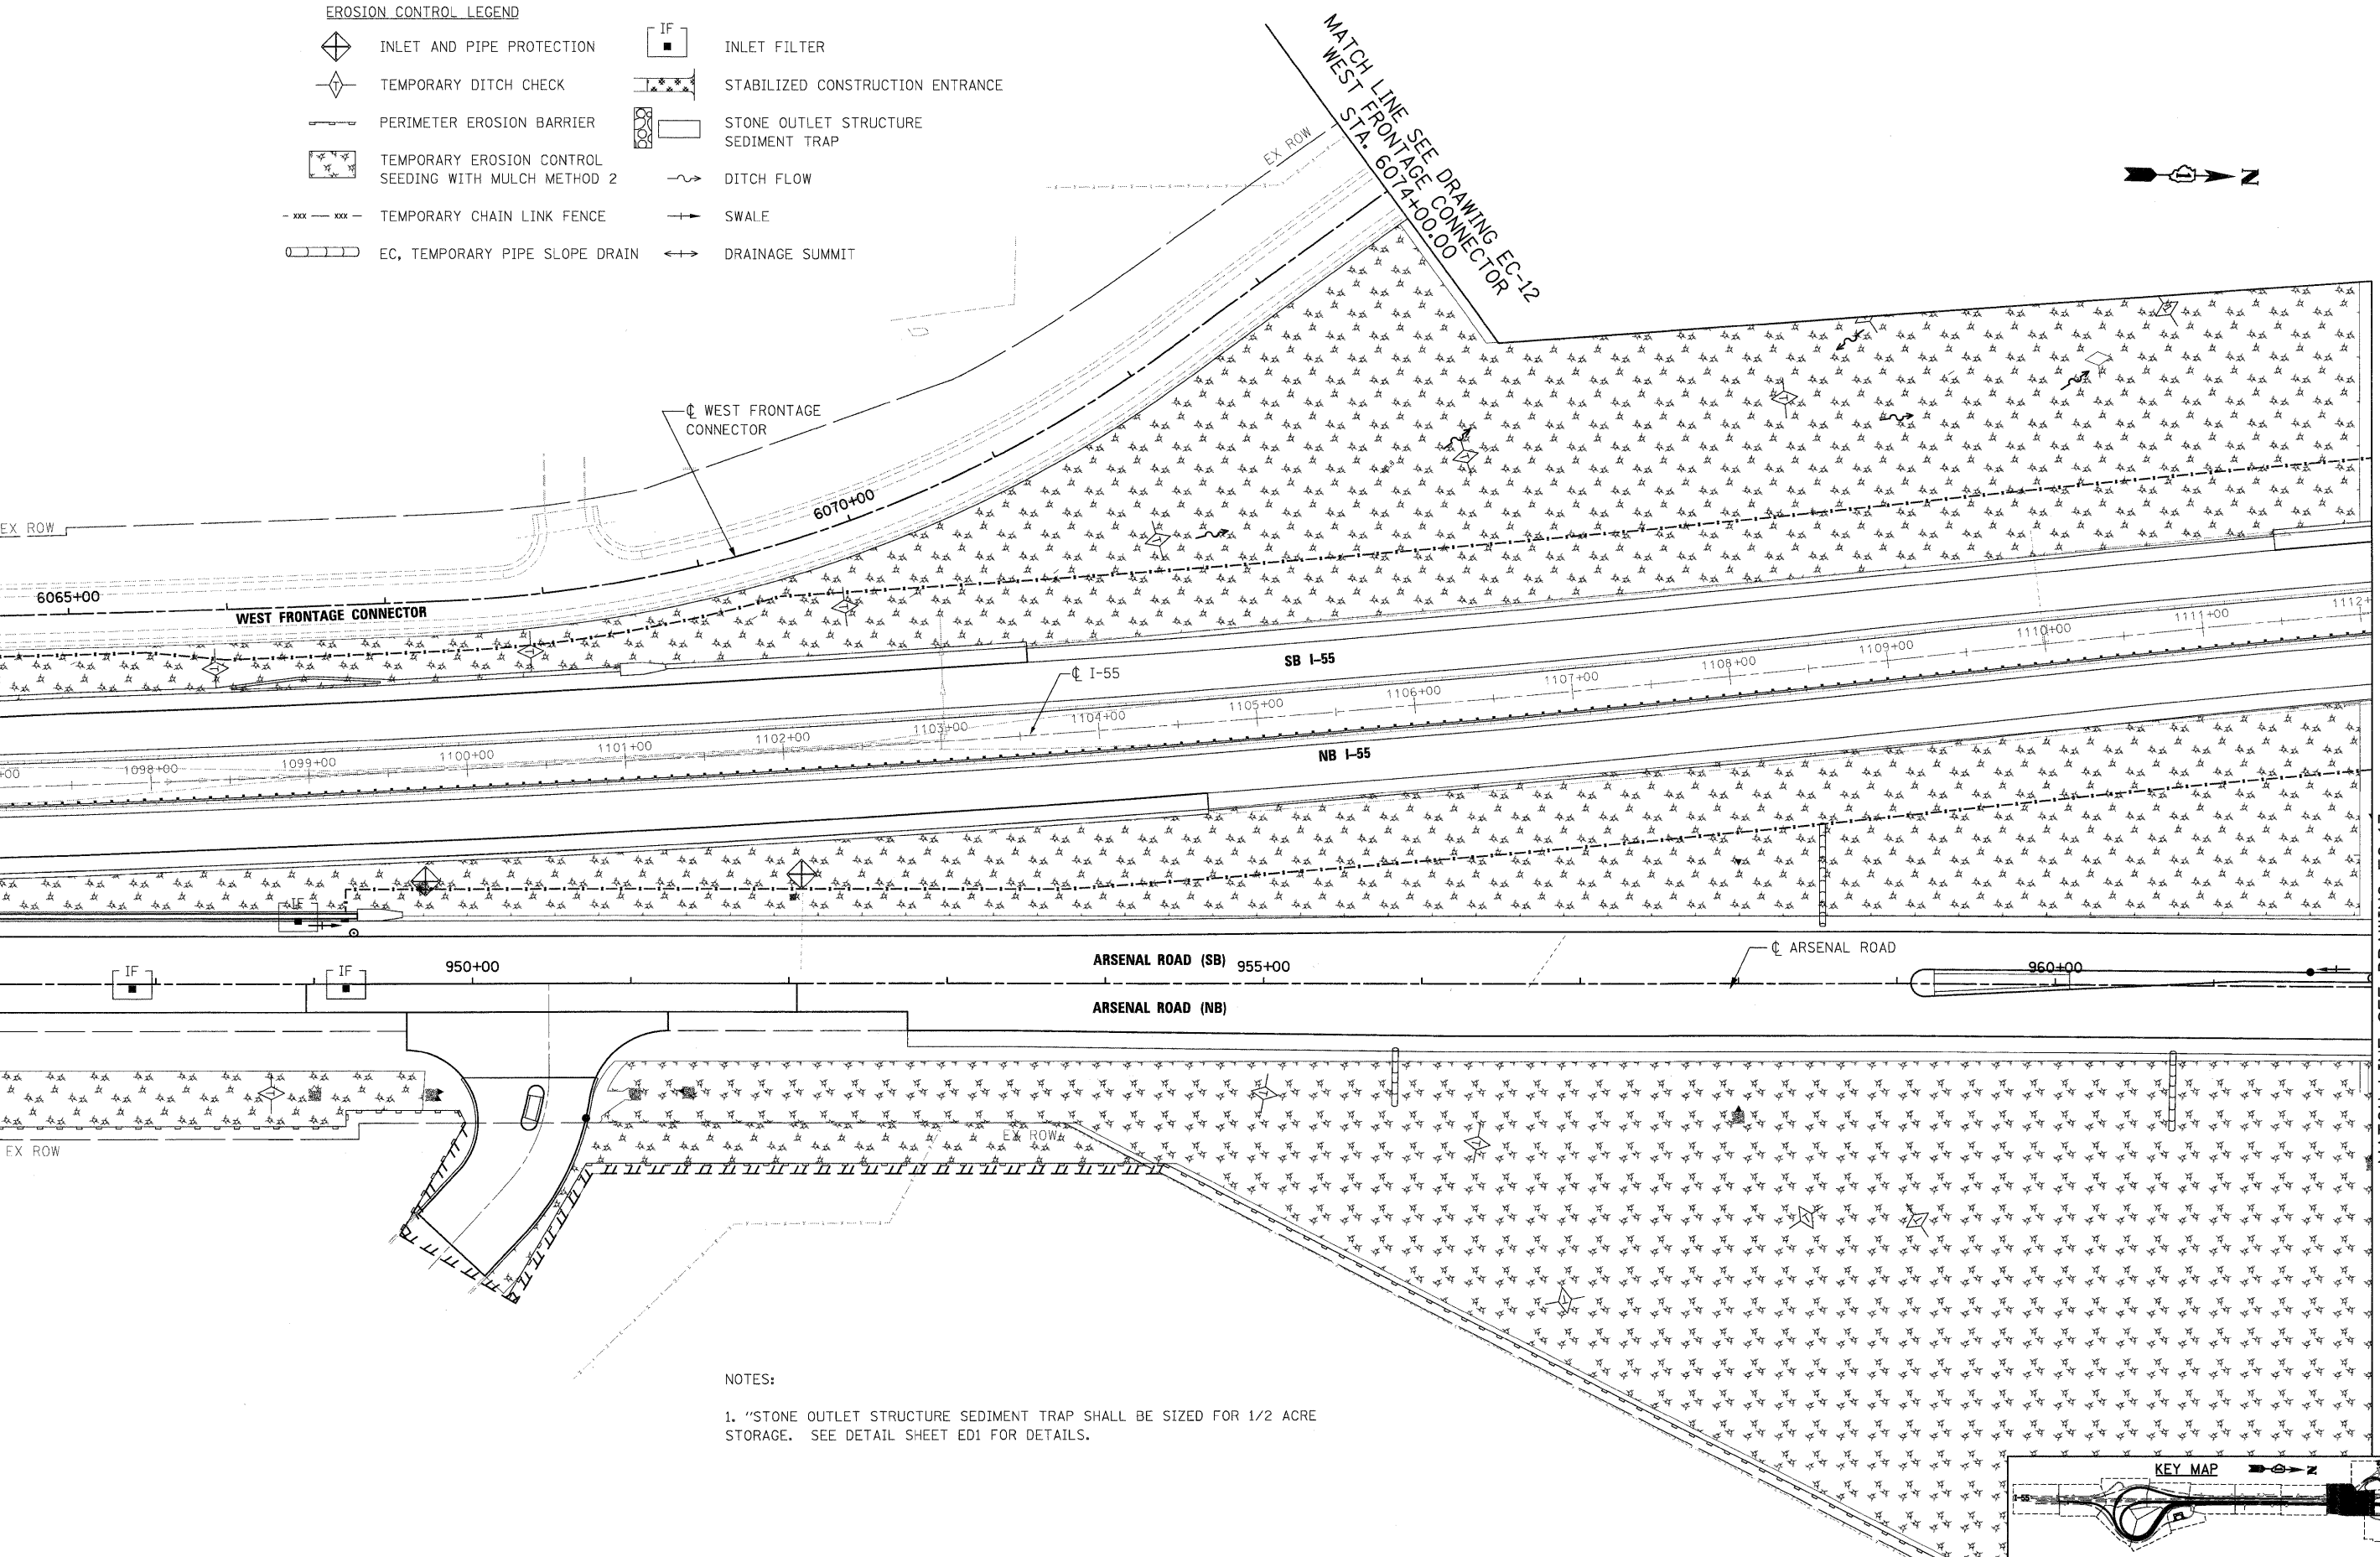

MATCH LINE SEE DRAWING EC-13 ARSENAL RD STA. 962+00.00

NOTES:

- "STONE OUTLET STRUCTURE SEDIMENT TRAP SHALL BE SIZED FOR 1/2 ACRE STORAGE. SEE DETAIL SHEET ED1 FOR DETAILS.

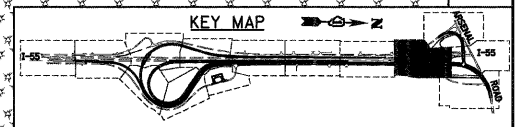

McDonough Associates Inc.
 Engineers / Architects
 130 East Randolph Street, Chicago, Illinois 60601

FILE NAME =	USER NAME = TK1uegl
D160F12-SHT-EROS21.dgn	

DESIGNED - JCL	REVISD -
DRAWN - JCL	REVISD -
CHECKED - DLT	REVISD -
DATE - 2/4/11	REVISD -

DESIGNED - JCL	REVISD -
DRAWN - JCL	REVISD -
CHECKED - DLT	REVISD -
DATE - 2/4/11	REVISD -

**STATE OF ILLINOIS
DEPARTMENT OF TRANSPORTATION**

EROSION AND SEDIMENT CONTROL PLAN

SCALE: 1"=50' SHEET NO. 11 OF 15 SHEETS STA. TO STA.

F.A.I. RTE.	SECTION	COUNTY	TOTAL SHEETS	SHEET NO.
55	99-2HB-2B-1	WILL	756	160
FED. ROAD DIST. NO. 1 ILLINOIS FED. AID PROJECT			CONTRACT NO. 60F12	