


- LEGEND**
- CLASS 1 SEEDING AND EROSION CONTROL BLANKET (WITH FERTILIZER)
 - CLASS 1A SEEDING AND EROSION CONTROL BLANKET (WITH FERTILIZER)
 - CLASS 4A SEEDING AND HEAVY DUTY EROSION CONTROL BLANKET (WITH FERTILIZER)
 - PERIMETER EROSION BARRIER

- FERTILIZER REQUIREMENTS**
- NITROGEN FERTILIZER NUTRIENT (90 LBS/AC)
 - POTASSIUM FERTILIZER NUTRIENT (90 LBS/AC)
 - PHOSPHORUS FERTILIZER NUTRIENT (90 LBS/AC)

- CRATAEGUS CRUSGALLI INERMIS (THORN LESS COCKSPUR HAWTHORN), 2 1/2" CALIPER TREE FORM, BALLED AND BURLAPPED
- CORNUS MAS (CORNELIAN CHERRY DOG WOOD), 2" CALIPER, TREE FORM, BALLED AND BURLAPPED
- SYRINGA RETICULATA (JAPANESE TREE LILAC) 2 1/2" CALIPER TREE FORM, BALLED AND BURLAPPED
- INLET FILTER
- TEMPORARY DITCH CHECK
- RIP RAP

THE THICKNESS OF THE TOPSOIL/VEGETATION SUSTAINING SOIL SHALL BE A MINIMUM OF 4".

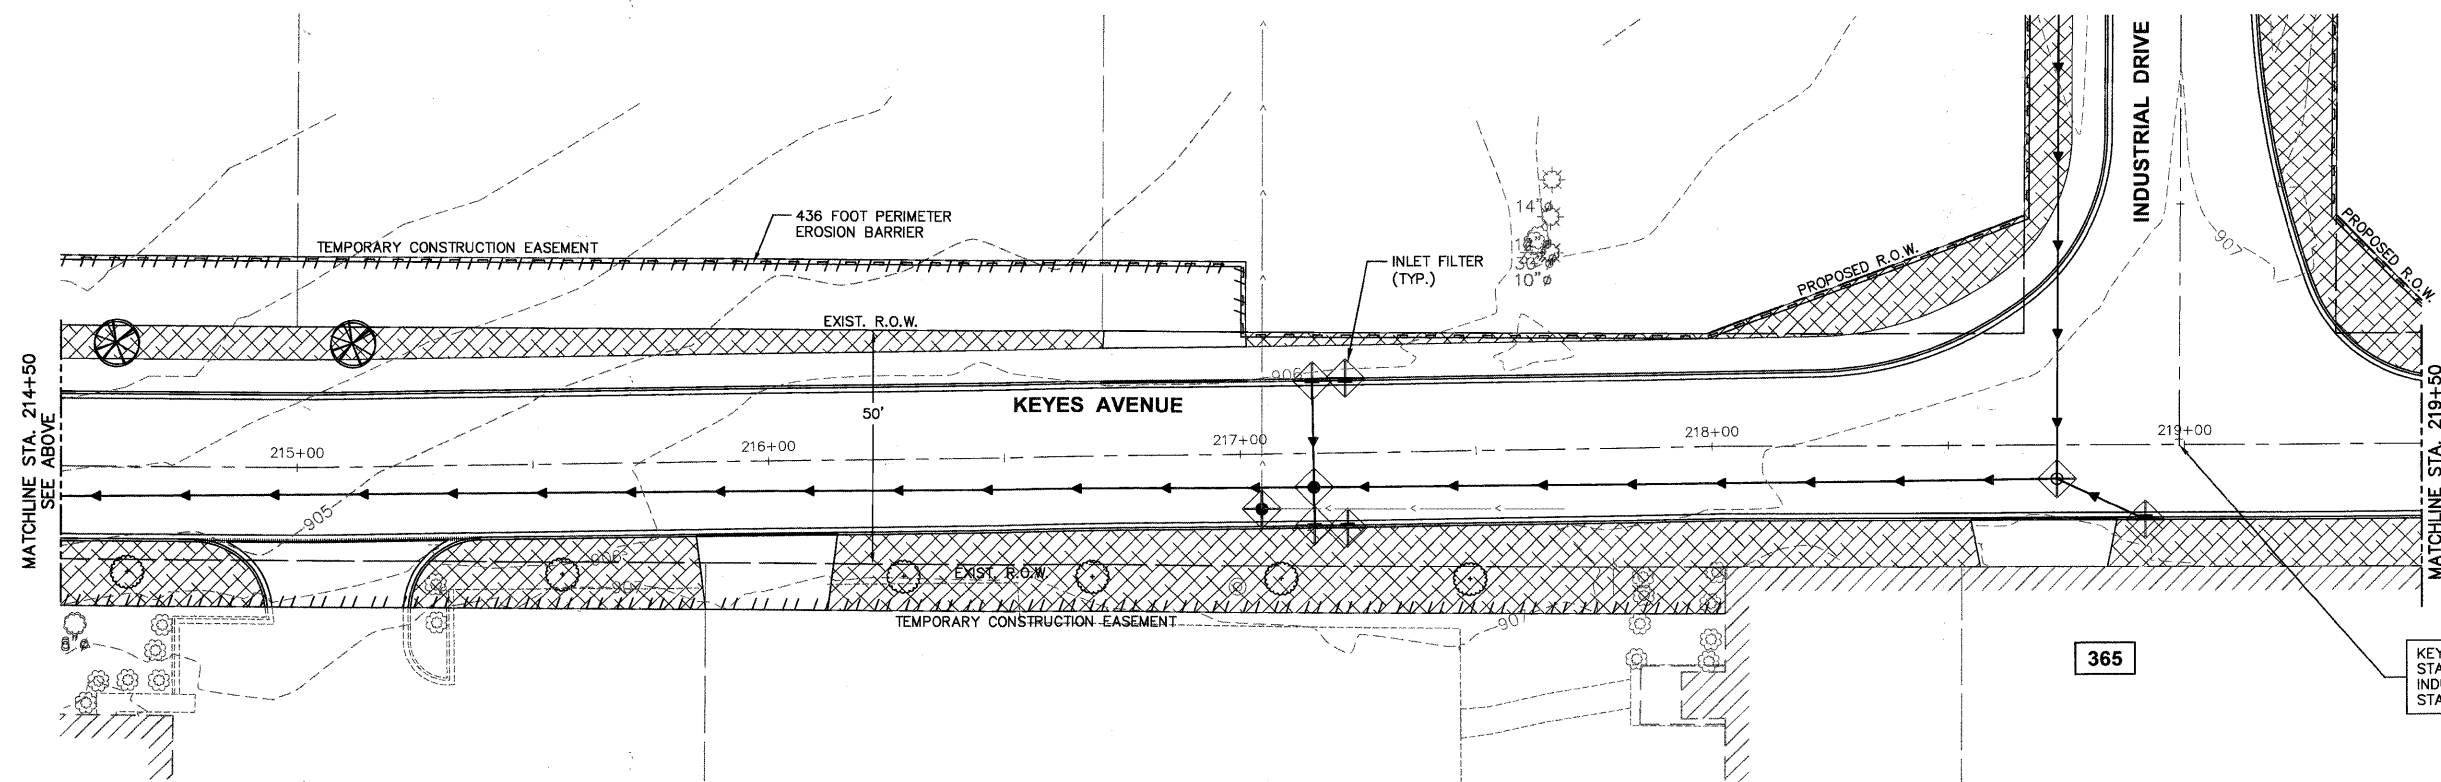

KEYES AVENUE
STATION 218+98.83
INDUSTRIAL DRIVE
STATION 299+98.82

Plotted: February 2, 2010 10:02 AM By: Kris Pung - Job: 88-KEYES LAND (22x34)

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FILE NAME	USER NAME = #USER#	DESIGNED - JAM, SWM	REVISED - 12/02/09
#FILE#		DRAWN - KKP	REVISED - 01/22/10
	PLOT SCALE = #SCALE#	CHECKED - JAM	REVISED - 02/03/10
	PLOT DATE = #DATE#	DATE - 10/16/09	REVISED -

**STATE OF ILLINOIS
DEPARTMENT OF TRANSPORTATION**

KEYES AVENUE LANDSCAPING AND EROSION CONTROL PLAN	
PROJECT NO. HPP-1468(004)	JOB NO. C-91-175-06
SCALE: 1"=20'	SHEET NO. 63 OF 92 SHEETS
STA. N/A	TO STA. N/A

F.A. RTE.	SECTION	COUNTY	TOTAL SHEETS	SHEET NO.
N/A	06-00015-00-PV	KANE	97	68
FED. ROAD DIST. NO. - (ILLINOIS) FED. AID PROJECT			CONTRACT NO. 63406	

Path: H:\SDS\PROJ\14687\DWG\14687\LANDSCAPE