
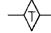


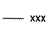
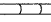

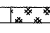
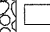



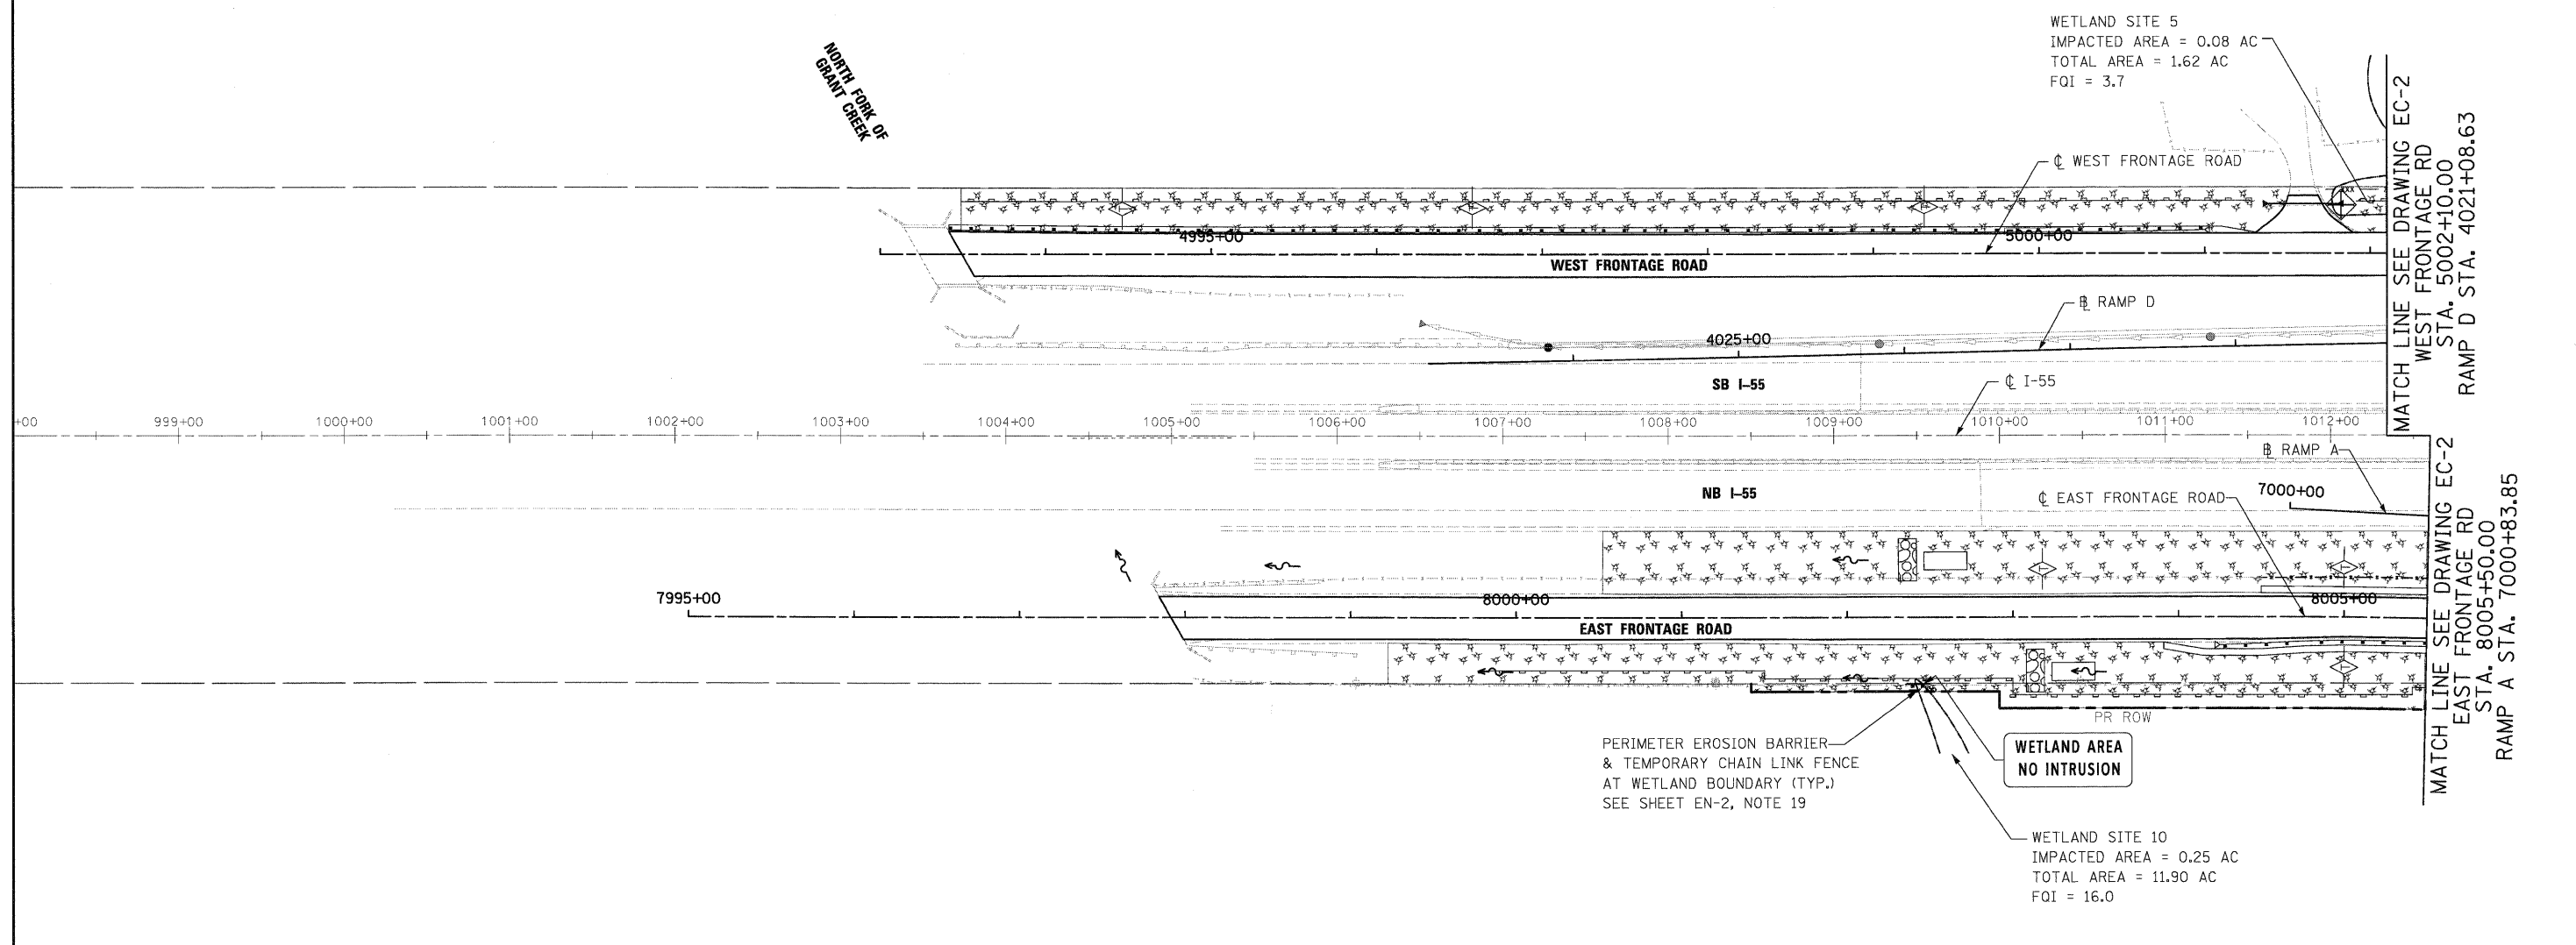


EROSION CONTROL LEGEND

-  INLET AND PIPE PROTECTION
-  TEMPORARY DITCH CHECK
-  PERIMETER EROSION BARRIER
-  TEMPORARY EROSION CONTROL SEEDING WITH MULCH METHOD 2
-  TEMPORARY CHAIN LINK FENCE
-  EC, TEMPORARY PIPE SLOPE DRAIN
-  IF INLET FILTER
-  STABILIZED CONSTRUCTION ENTRANCE
-  STONE OUTLET STRUCTURE SEDIMENT TRAP
-  DITCH FLOW
-  SWALE
-  DRAINAGE SUMMIT



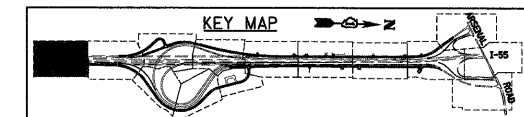
PERIMETER EROSION BARRIER & TEMPORARY CHAIN LINK FENCE AT WETLAND BOUNDARY (TYP.) SEE SHEET EN-2, NOTE 19

WETLAND AREA NO INTRUSION

WETLAND SITE 10
 IMPACTED AREA = 0.25 AC
 TOTAL AREA = 11.90 AC
 FQI = 16.0

NOTES:

1. "STONE OUTLET STRUCTURE SEDIMENT TRAP" SHALL BE SIZED FOR 1/2 ACRE STORAGE. SEE DETAIL SHEET ED1 FOR DETAILS.
2. PERIMETER EROSION BARRIER HAS BEEN OFFSET FOR CLARITY.



FILE NAME = D160C31-SHT-EROS11.dgn	USER NAME = TKluegel	DESIGNED - JCL	REVISED -	STATE OF ILLINOIS DEPARTMENT OF TRANSPORTATION	EROSION AND SEDIMENT CONTROL PLAN	F.A.I. RTE. 55	SECTION (99-1&2)AC-3	COUNTY WILL	TOTAL SHEETS 524	SHEET NO. 128		
PLOT SCALE = 1:50	CHECKED - DLT	DRAWN - JCL	REVISED -			SCALE: 1"=50'	SHEET NO. 1 OF 15 SHEETS	STA.	TO STA.	CONTRACT NO. 60C31		
PLOT DATE = 12/14/2009	DATE - 12/18/09	CHECKED - DLT	REVISED -			FED. ROAD DIST. NO. 1 ILLINOIS FED. AID PROJECT						
		DESIGNED - JCL	REVISED -			FINAL						