


SEC. 33, T16N, R10E, 3rdPM

DETAIL OF ACROSS ROAD BOX CULVERT NO. 2
STATION 557+90.90 EXIST. S.N. 021-8022 PROP. S.N. 021-8053



557+90.90 PROPOSED S.N. 021-8053
 PRECAST CONC BOX CULVERT (M273)
 8'-0" X 3'-0" X 62'-0"
 U.S.F.L. 31.00' LT, 557+90.90, ELEV = 636.21
 D.S.F.L. 31.00' RT, 557+90.90, ELEV = 636.21
 BOX CULVERT END SECTION, CULVERT NO. 2

A.R. STATION 557+90.90 EXIST. S.N. 021-8022
 EXISTING R.C BOX CULVERT 8'-0" X 3'-0" X 62'-0"
 REMOVE EXISTING STRUCTURE NO. 2

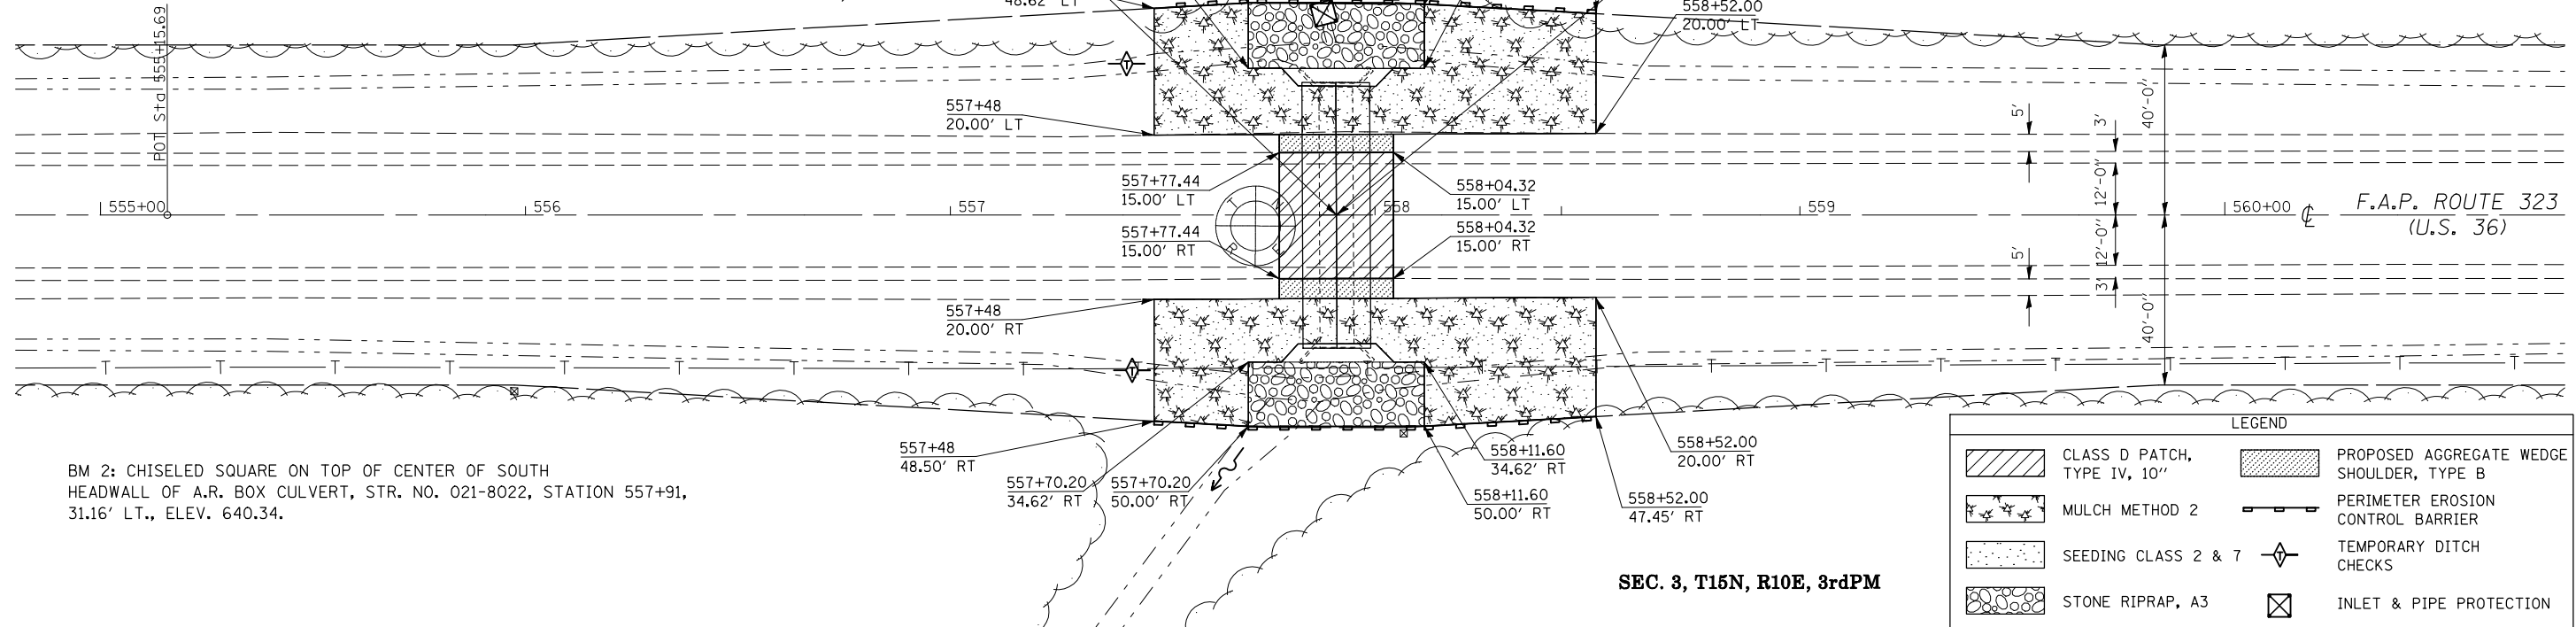


BM 2: CHISELED SQUARE ON TOP OF CENTER OF SOUTH HEADWALL OF A.R. BOX CULVERT, STR. NO. 021-8022, STATION 557+91, 31.16' LT., ELEV. 640.34.

LEGEND	
	CLASS D PATCH, TYPE IV, 10"
	MULCH METHOD 2
	SEEDING CLASS 2 & 7
	STONE RIPRAP, A3
	PROPOSED AGGREGATE WEDGE SHOULDER, TYPE B
	PERIMETER EROSION CONTROL BARRIER
	TEMPORARY DITCH CHECKS
	INLET & PIPE PROTECTION

SEC. 3, T15N, R10E, 3rdPM

PLAN	SURVEYED	DATE
NOTE BOOK NO.	PLOTTED	BY
	GRADES CHECKED	
	STRUCTURE NOTATIONS OK'D	

PROFILE	SURVEYED	DATE
NOTE BOOK NO.	PLOTTED	BY
	GRADES CHECKED	
	STRUCTURE NOTATIONS OK'D	

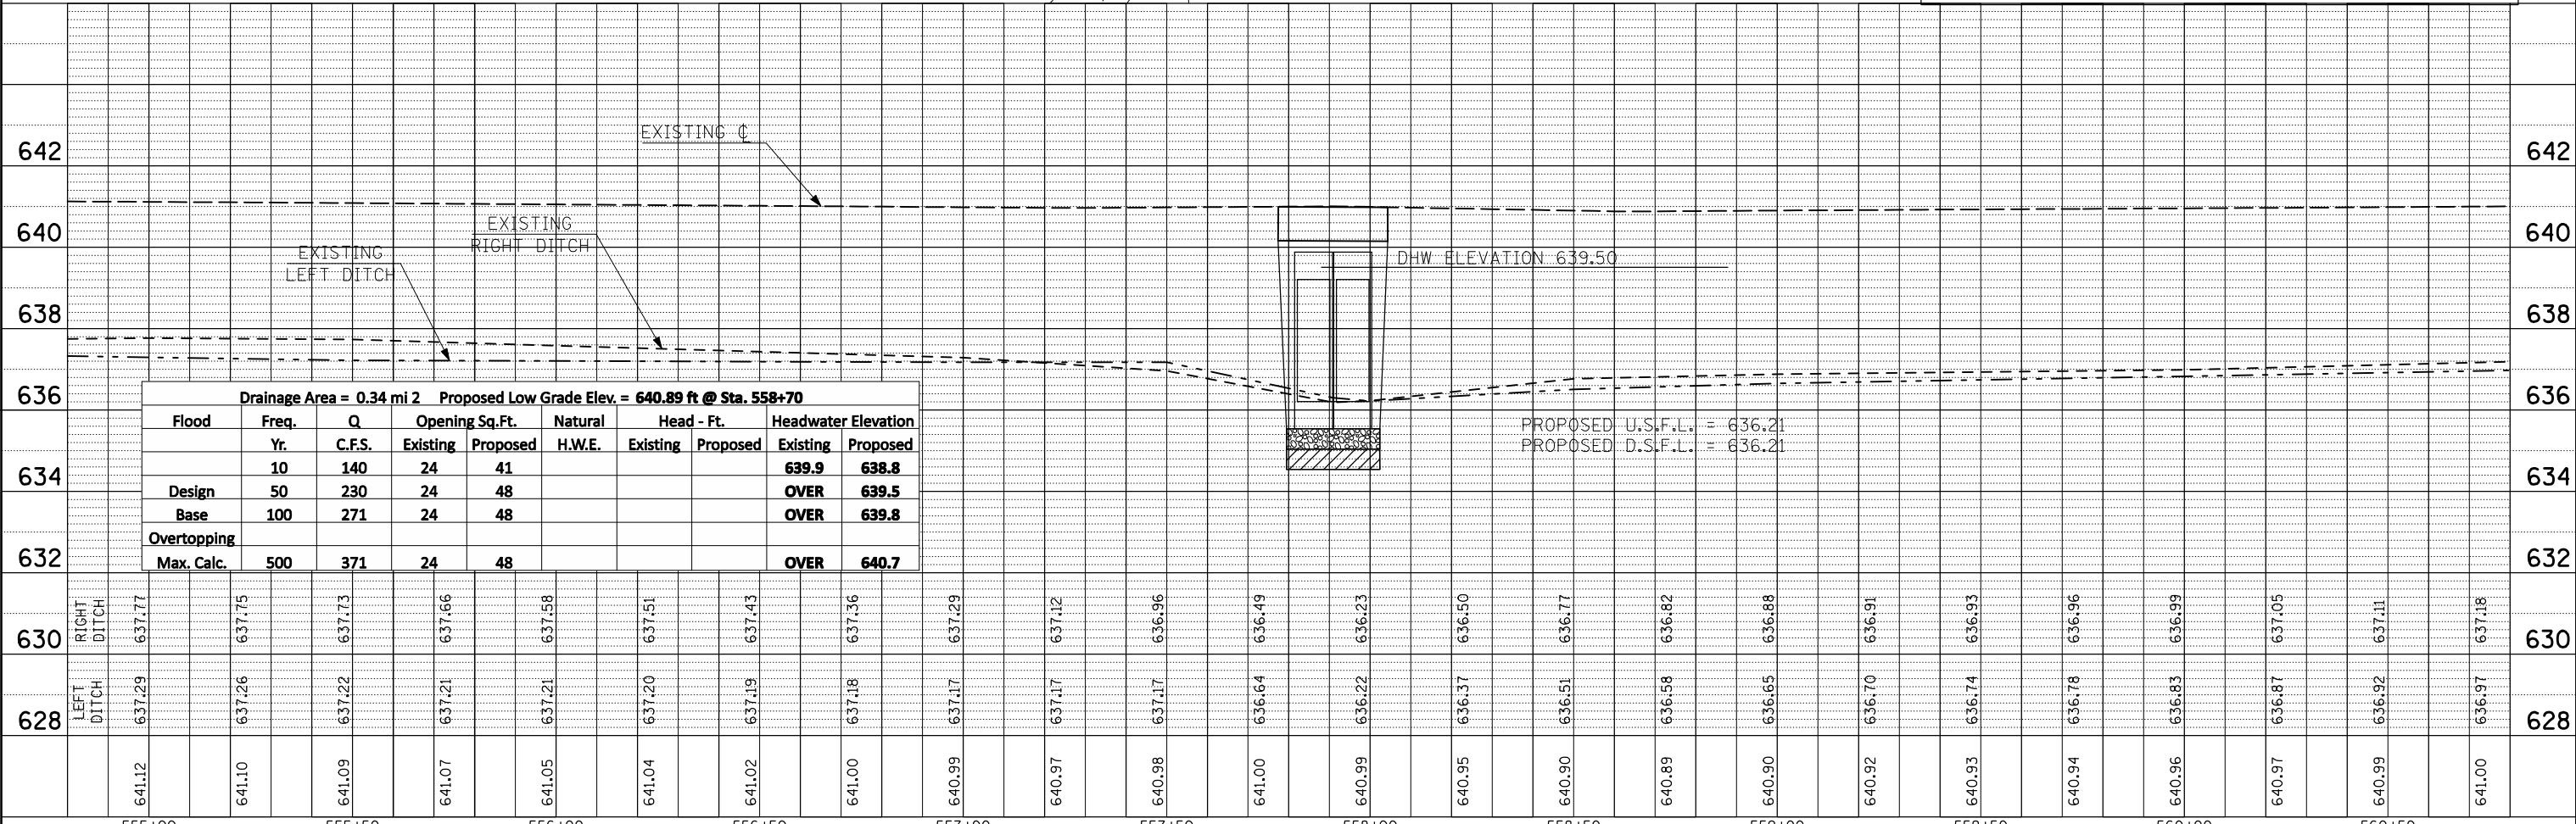

FILE NAME =	USER NAME = bucklesj	DESIGNED - RLA	REVISED -
ct:\pwwork\pwwidot\BUCKLESJ\0134382\0570696-sht-plnprf.dgn		DRAWN - JJB	REVISED -
PLOT SCALE = 40.0000' / IN.		CHECKED -	REVISED -
PLOT DATE = 3/22/2010		DATE - 7-9-09	REVISED -

STATE OF ILLINOIS
 DEPARTMENT OF TRANSPORTATION

PLAN & PROFILE S.N. 021-8053

SCALE: 1:20 SHEET NO. 1 OF 5 SHEETS STA. 557+73.10 TO STA. 558+08.70

F.A.P. RTE. 323	SECTION (145,146)CR	COUNTY DOUGLAS	TOTAL SHEETS 31	SHEET NO. 15
CONTRACT NO. 70696			ILLINOIS FED. AID PROJECT	