

STATE OF ILLINOIS
DEPARTMENT OF TRANSPORTATION
DIVISION OF HIGHWAYS

F.A. RTE.	SECTION	COUNTY	TOTAL SHEETS	SHEET NO.
	JUBILEE COLLEGE 2021	PEORIA	24	1
		ILLINOIS	CONTRACT NO. 46926	

D-4

INDEX OF SHEETS

(SEE SHEET 2)

IDOT HIGHWAY STANDARDS

(SEE SHEET 2)

I.D.O.T./I.D.N.R. STATEWIDE
JUBILEE COLLEGE STATE PARK
SECTION: JUBILEE COLLEGE 2021

CULVERT REPLACEMENT / CHANNEL CHANGE
PEORIA COUNTY


I.D.O.T. PROJECT No. P-00-000-00

I.D.N.R. FILE No. 1-20-045


ROUTE: INTERNAL PARK ROADS

C-30-004-21

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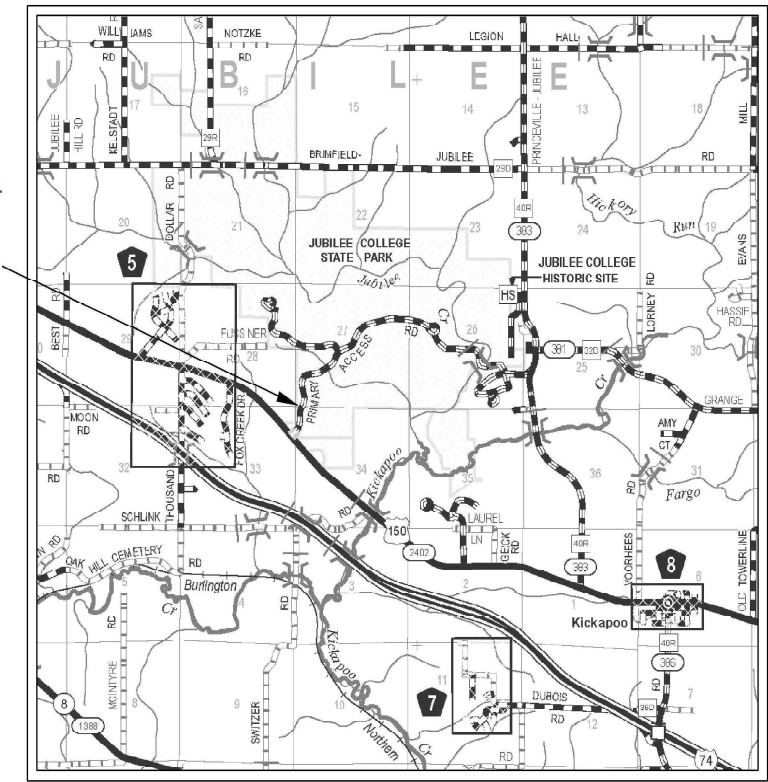


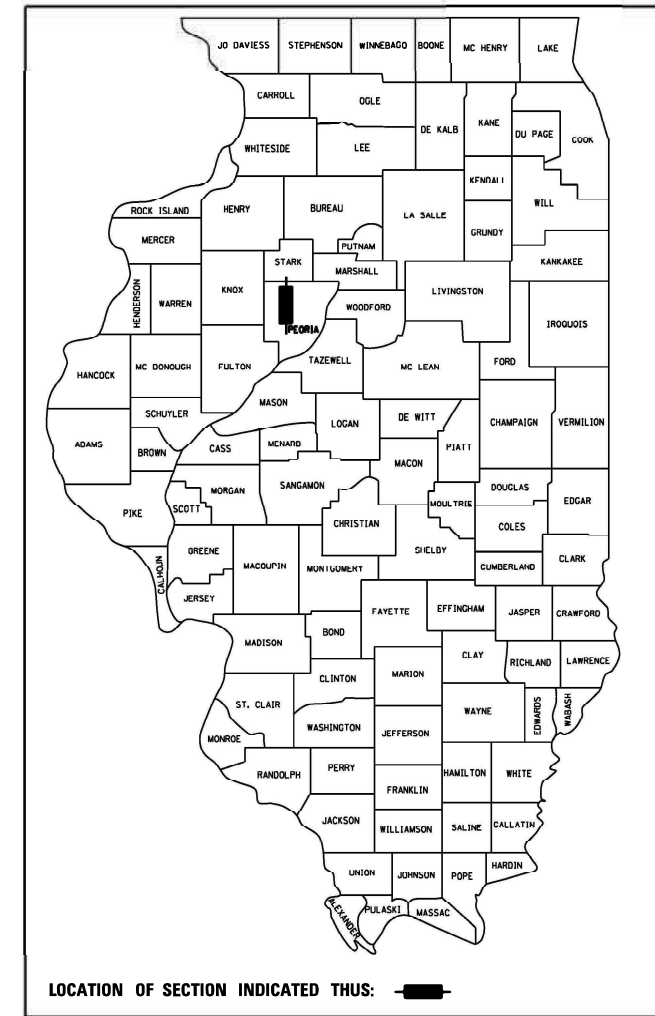PROJECT LOCATION

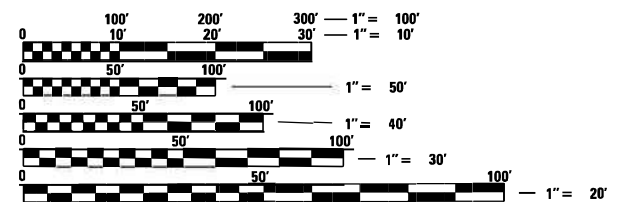

FULL SIZE PLANS HAVE BEEN PREPARED USING STANDARD ENGINEERING SCALES. REDUCED SIZED PLANS WILL NOT CONFORM TO STANDARD SCALES. IN MAKING MEASUREMENTS ON REDUCED PLANS, THE ABOVE SCALES MAY BE USED.

J.U.L.I.E.
JOINT UTILITY LOCATING INFORMATION FOR EXCAVATORS
1-800-892-0123
OR 811



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STATE OF ILLINOIS
DEPARTMENT OF TRANSPORTATION
DIVISION OF HIGHWAYS

SUBMITTED May 7, 2021

May 7, 2021

May 7, 2021

DEPUTY DIRECTOR OF HIGHWAYS, REGION ENGINEER
ENGINEER OF DESIGN AND ENVIRONMENT
DIRECTOR OF HIGHWAYS PROJECT IMPLEMENTATION

INDEX OF SHEETS

- 1 COVER SHEET
- 2 INDEX OF SHEETS, HIGHWAY STANDARDS AND GENERAL NOTES
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- 10 MAIN PARK ROAD (PLAN & PROFILE)
- 11 CHANNEL CHANGE (PLAN & PROFILE)
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- 13 SITE DETAILS
- 14 DETOUR PLAN
- 15 SIGN DETAILS
- 16-17 MAIN PARK ROAD (CROSS SECTIONS)
- 18-24 CHANNEL CHANGE (CROSS SECTIONS)

GENERAL NOTES

- 1 SPECIFICATIONS SHALL BE THE "STANDARD SPECIFICATIONS FOR ROAD AND BRIDGE CONSTRUCTION" ADOPTED APRIL 1, 2016.
 - 2 ALL GRADES ARE REFERENCED TO ELEVATIONS ESTABLISHED BY VEENSTRA & KIMM, INC.
 - 3 THE CONTRACTOR SHALL ASSUME COMPLETE RESPONSIBILITY FOR JOB SITE CONDITIONS DURING THE COURSE OF CONSTRUCTION, INCLUDING SAFETY OF ALL PERSONS AND PROPERTY, THAT THIS REQUIREMENT SHALL APPLY CONTINUOUSLY AND NOT BE LIMITED TO NORMAL WORKING HOURS, AND THAT THE CONTRACTOR SHALL DEFEND, IDEMNIFY, AND HOLD THE OWNER AND THE ENGINEER HARMLESS FROM ANY AND ALL LIABILITY, REAL OR ALLEGED, IN CONNECTION WITH THE PERFORMANCE OF WORK ON THIS PROJECT, EXCEPT FOR LIABILITY ARISING FROM THE SOLE NEGLIGENCE OF THE OWNER OR THE ENGINEER.
 - 4 WHERE SECTION STONES OR PROPERTY MARKERS ARE ENCOUNTERED, THE ENGINEER SHALL BE NOTIFIED BEFORE SUCH STONES OR MARKERS ARE REMOVED. THE CONTRACTOR SHALL PROTECT AND PRESERVE ALL PROPERTY MARKERS UNTIL AN OWNER OR AUTHORIZED SURVEYOR HAS WITNESSED OR REFERENCED THEIR LOCATION.
 - 5 ALL BORROW/WASTE/USE SITES MUST BE APPROVED BY THE DEPARTMENT PRIOR TO REMOVING ANY MATERIAL FROM THE PROJECT OR INITIATING ANY EARTHMOVING ACTIVITIES, INCLUDING TEMPORARY STOCKPILING OUTSIDE THE LIMITS OF CONSTRUCTION.
 - 6 EXISTING TOP SOIL EXCAVATED FOR THIS PROJECT MAY BE USED FOR THE PLACEMENT LOCATIONS NOTED ON THE PLANS PROVIDED THAT THE EXCAVATED MATERIALS MEET THE REQUIREMENTS OF ARTICLE 1081.05(d) OF THE STANDARD SPECIFICATIONS.
 - 7 THE FINAL TOP FOUR INCHES OF SOIL IN ANY RIGHT-OF-WAY AREA DISTURBED BY THE CONTRACTOR MUST BE CAPABLE OF SUPPORTING VEGETATION. THE SOIL MUST BE FROM THE A HORIZON (ZERO TO 2' DEEP) OF SOIL PROFILES OF LOCAL SOILS. THE COST OF THIS WORK SHALL BE INCLUDED IN THE UNIT PRICES BID AND NO ADDITIONAL COMPENSATION WILL BE ALLOWED.
 - 8 THE CONTRACTOR SHALL BE RESPONSIBLE FOR LOCATING AND PROTECTING UTILITY PROPERTY DURING CONSTRUCTION OPERATIONS AS OUTLINED IN ARTICLE 107.39 OF THE STANDARD SPECIFICATIONS. A MINIMUM OF 48 HOURS ADVANCE NOTICE IS REQUIRED FOR NON-EMERGENCY WORK. THE J.U.L.I.E. NUMBER IS (800) 892-0123.
- NOTE THAT IDOT IS NOT A MEMBER OF J.U.L.I.E. IF YOU ARE NEAR ANY OVERHEAD LIGHTING, INTERSECTION LIGHTING OR TRAFFIC SIGNALS, CONTACT THE IDOT TRAFFIC OFFICE AT (309) 671-3333 AT LEAST 48 HOURS PRIOR TO WORK.

THE FOLLOWING RATES OF APPLICATION HAVE BEEN USED TO CALCULATE THE PLAN QUANTITIES:











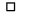




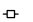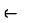





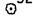




BITUMINOUS MATERIALS (TACK COAT ON PAVEMENT)	0.05 LB/SQ FT
BITUMINOUS MATERIALS (TACK COAT BETWEEN LIFTS)	0.025 LB/SQ FT
BITUMINOUS MATERIALS (PRIME COAT)	0.25 LB/SQ FT
BITUMINOUS CONCRETE SURFACE/BINDER	112 LBS/SQ YD/INCH
SEEDING FERTILIZER NUTRIENTS (N, P, K)	90,90,90 LBS/ACRE

GENERAL NOTES

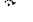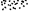(CONTINUED)

- 9 ALL EMBANKMENT CONSTRUCTED OF COHESIVE SOIL SHALL BE CONSTRUCTED WITH NOT MORE THAN 110% OF OPTIMUM MOISTURE CONTENT, DETERMINED BY THE STANDARD PROCTOR TEST. COHESIVE SOIL SHALL BE DEFINED AS ANY SOIL WHICH CONTAINS GREATER THAN 10% PARTICLES BY WEIGHT PASSING THE 75 M (#200 SIEVE). THE 110% OF OPTIMUM MOISTURE LIMIT MAY BE WAIVED IN FREE-DRAINING GRANULAR MATERIAL WHEN APPROVED BY THE ENGINEER.
 - 10 THE AREA TO BE TACKED OR PRIMED SHALL BE LIMITED TO THAT WHICH CAN BE COVERED WITH HMA ON THE NEXT DAY'S PRODUCTION, BUT NO MORE THAN FIVE DAYS IN ADVANCE OF THE PLACEMENT OF THE HMA, UNLESS APPROVED BY THE ENGINEER.
 - 11 THE CONTRACTOR SHALL BE RESPONSIBLE FOR COLLECTING AND MAINTAINING AN ELECTRONIC LOG OF ALL STAKEOUT SURVEY THAT IS PERFORMED ON THE JOB, EITHER BY HIM/HER OR ANY SUBCONTRACTOR PERFORMING THE STAKEOUT. UPON REQUEST, ALL LOGS SHALL BE SUBMITTED TO THE DEPARTMENT. NO ADDITIONAL COMPENSATION WILL BE ALLOWED FOR THIS WORK, BUT SHALL BE CONSIDERED INCLUDED IN THE COST FOR CONSTRUCTION LAYOUT.
 - 12 CADD DATA WILL BE AVAILABLE TO CONTRACTORS AND CONSULTANTS WORKING ON THIS PROJECT. THIS INFORMATION WILL BE PROVIDED UPON REQUEST AS MICROSTATION CADD FILES AND GEOPAK CO-ORDINATE GEOMETRY FILES ONLY. IF DATA IS REQUIRED IN OTHER FORMATS IT WILL BE THE CONTRACTOR'S RESPONSIBILITY TO MAKE THESE CONVERSIONS. IF ANY DISCREPANCY OR INCONSISTENCY ARISES BETWEEN THE ELECTRONIC DATA AND THE INFORMATION ON THE HARD COPY, THE INFORMATION ON THE HARD COPY SHOULD BE USED. CONTACT THE DISTRICT'S PROJECT ENGINEER TO REQUEST THESE FILES.
 - 13 ALL CONSTRUCTION LAYOUT SHALL BE THE RESPONSIBILITY OF THE CONTRACTOR.
 - 14 THE FOLLOWING MIXTURE REQUIREMENTS ARE APPLICABLE FOR THIS PROJECT:
- | LOCATION(S): | VARIOUS | | |
|--|--------------------|------------|----------|
| | BIND CSE | LEVEL BNDR | SURF CSE |
| PG: | PG58-28 | PG58-28 | PG58-28 |
| DESIGN AIR VOIDS: | 4.0% | 4.0% | 4.0% |
| MIXTURE COMPOSITION (MIXTURE GRADATION): | IL-9.5 | IL-9.5FG | IL-9.5 |
| FRICTION AGGREGATE: | N/A | N/A | D |
| MIXTURE WEIGHT: | 112 LBS/SQ YD/INCH | | |
| QUALITY MANAGEMENT PROGRAM: | QCQA | | |
| SUBLOT SIZE: | N/A | | |
- 17 WHEN A NUMBER OF ROLLER PASSES IS SPECIFIED, THE CONTRACTOR MAY OPT TO USE INTELLIGENT COMPACTION IN LIEU OF DENSITY TESTING UNDER THE QUALITY CONTROL FOR PERFORMANCE (QCP) PROGRAM.

LEGEND

-  - EXISTING POWER POLE
-  - EXISTING GUY WIRE
-  - EXISTING SIGN
-  - EXISTING WOOD POST
-  - EXISTING FENCE POST
-  - EXISTING MAILBOX
-  - EXISTING DECIDUOUS TREE
-  - EXISTING EVERGREEN TREE
-  - EXISTING BUSH
-  - EXISTING JUNCTION BOX
-  - EXISTING ELECTRIC SPLICE BOX
-  - EXISTING TELEPHONE SPLICE BOX
-  - EXISTING WATER VALVE
-  - EXISTING CATCH BASIN
-  - EXISTING MANHOLE
-  - EXISTING END SECTION
-  - EXISTING PARKING BLOCK
-  - EXISTING A.D.A. PARKING SYMBOL
-  - EXISTING RIPRAP
-  - EXISTING FENCE LINE
-  - EXISTING DITCH LINE
-  - EXISTING GUARD RAIL
-  - EXISTING CONTOURS
-  - EXISTING TREE LINE
-  - EXISTING BUILDING LIMITS
-  - EXISTING CULVERT

IDOT HIGHWAY STANDARDS

- 000001-08 STANDARD SYMBOLS, ABBREVIATIONS AND PATTERNS
- 001001-02 AREAS OF REINFORCEMENT BARS
- 001006 DECIMAL OF AN INCH AND A FOOT
- 280001-07 TEMPORARY EROSION CONTROL SYSTEMS
- 542301-03 PRECAST REINFORCED CONCRETE FLARED END SECTION
- 602411-09 PRECAST MANHOLE, TYPE A, 7' DIAMETER
- 602701-02 MANHOLE STEPS
- 604001-05 FRAME AND LIDS, TYPE 1
- 720001-01 SIGN PANEL MOUNTING DETAILS
- 720021-02 SIGN PANELS, EXTRUDED ALUMINUM TYPE
- 701901-08 TRAFFIC CONTROL DEVICES
- BLR 21-9 TYPICAL APPLICATION OF TRAFFIC CONTROL DEVICES FOR CONSTRUCTION ON RURAL LOCAL HIGHWAYS

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		DRAWN - J.E.B.	REVISED -			JUBILEE COLLEGE 2021	PEORIA	24	2	
		CHECKED - R.H.D.	REVISED -			CONTRACT NO. 46926				
Default	PLOT DATE = 4/7/2021	DATE - 02/12/21	REVISED -			SCALE:	SHEET OF SHEETS	STA. TO STA.	[ILLINOIS] FED. AID PROJECT	

CODE NO.	ITEM	UNIT	TOTAL QUANTITY	CONSTR. CODE
				100% STATE
				ROADWAY
				0004
				S.N.
20100110	TREE REMOVAL (6 TO 15 UNITS DIAMETER)	UNIT	12	12
20100210	TREE REMOVAL (OVER 15 UNITS DIAMETER)	UNIT	18	18
20800150	TRENCH BACKFILL	CU YD	44	44
25000115	SEEDING, CLASS 1B	ACRE	0.18	0.18
25000400	NITROGEN FERTILIZER NUTRIENT	POUND	78	78
25000600	POTASSIUM FERTILIZER NUTRIENT	POUND	78	78
25100630	EROSION CONTROL BLANKET	SQ YD	3,145	3,145
25100900	TURF REINFORCEMENT MAT	SQ YD	458	458
28000250	TEMPORARY EROSION CONTROL SEEDING	POUND	132	132
28000400	PERIMETER EROSION BARRIER	FOOT	1,000	1,000
28000500	INLET AND PIPE PROTECTION	EACH	4	4
28100209	STONE RIPRAP, CLASS A5	TON	467	467
28200200	FILTER FABRIC	SQ YD	412	412
35102400	AGGREGATE BASE COURSE, TYPE B 12"	SQ YD	108	108

* DENOTES SPECIAL PAY ITEM

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	DATE - 04/02/21	REVISED -		ILLINOIS FED. AID PROJECT								

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				ROADWAY
				0004
				S.N.
40600275	BITUMINOUS MATERIALS (PRIME COAT)	POUND	242	242
40600290	BITUMINOUS MATERIALS (TACK COAT)	POUND	36	36
40600982	HOT-MIX ASPHALT SURFACE REMOVAL - BUTT JOINT	SQ YD	50	50
40602965	HOT-MIX ASPHALT BINDER COURSE, IL-9.5FG, N50	TON	15	15
40604010	HOT-MIX ASPHALT SURFACE COURSE, IL-9.5FG, MIX "D", N50	TON	13	13
44000100	PAVEMENT REMOVAL	SQ YD	103	103
48101500	AGGREGATE SHOULDERS, TYPE B 6"	SQ YD	28	28
50105220	PIPE CULVERT REMOVAL	FOOT	195	195
542A0265	PIPE CULVERTS, CLASS A, TYPE 1 60"	FOOT	12	12
542A1099	PIPE CULVERTS, CLASS A, TYPE 2 54"	FOOT	68	68
542A1933	PIPE CULVERTS, CLASS A, TYPE 3 48"	FOOT	71	71
54213693	PRECAST REINFORCED CONCRETE FLARED END SECTIONS 48"	EACH	1	1
54213699	PRECAST REINFORCED CONCRETE FLARED END SECTIONS 54"	EACH	1	1
54213705	PRECAST REINFORCED CONCRETE FLARED END SECTIONS 60"	EACH	1	1
60224445	MANHOLES, TYPE A, 7'-DIAMETER, TYPE 1 FRAME, OPEN LID	EACH	1	1

* DENOTES SPECIAL PAY ITEM


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PLOT DATE = 4/7/2021	DATE - 04/02/21	REVISIED -		ILLINOIS FED. AID PROJECT								

CODE NO.	ITEM	UNIT	TOTAL QUANTITY	CONSTR. CODE
				100% STATE
				ROADWAY
				0004 S.N.
67000500	ENGINEER'S FIELD OFFICE, TYPE B	CAL MO	6	6
67100100	MOBILIZATION	L SUM	1	1
* 72000200	SIGN PANEL - TYPE 2	SQ FT	64	64
* 72000300	SIGN PANEL - TYPE 3	SQ FT	96	96
73000100	WOOD SIGN SUPPORT	FOOT	248	248
K1004572	PRAIRIE SEEDING (SPECIAL)	ACRE	0.75	0.75
X0100002	GRADING AND SHAPING SPECIAL	SQ YD	200	200
X0322939	RELOCATE EXISTING FLARED END SECTION	EACH	3	3
X2020410	EARTH EXCAVATION (SPECIAL)	CU YD	2,367	2,367
X2110104	TOPSOIL FURNISH AND PLACE, 4" (SPECIAL)	SQ YD	3,603	3,603
X7010216	TRAFFIC CONTROL AND PROTECTION, (SPECIAL)	L SUM	1	1
X7011006	TRAFFIC CONTROL AND PROTECTION FOR TEMPORARY DETOUR	EACH	1	1
Z0013798	CONSTRUCTION LAYOUT	L SUM	1	1
X6022445	MANHOLES, TYPE A, 7'-DIAMETER, TYPE 1 FRAME, OPEN LID (SPECIAL)	EACH	1	1

* DENOTES SPECIAL PAY ITEM

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PLOT DATE = 4/7/2021	CHECKED - R.H.D.	REVISED -		SCALE: SHEET OF SHEETS STA. TO STA.				ILLINOIS FED. AID PROJECT		CONTRACT NO. 46926		
	DATE - 04/02/21	REVISED -										

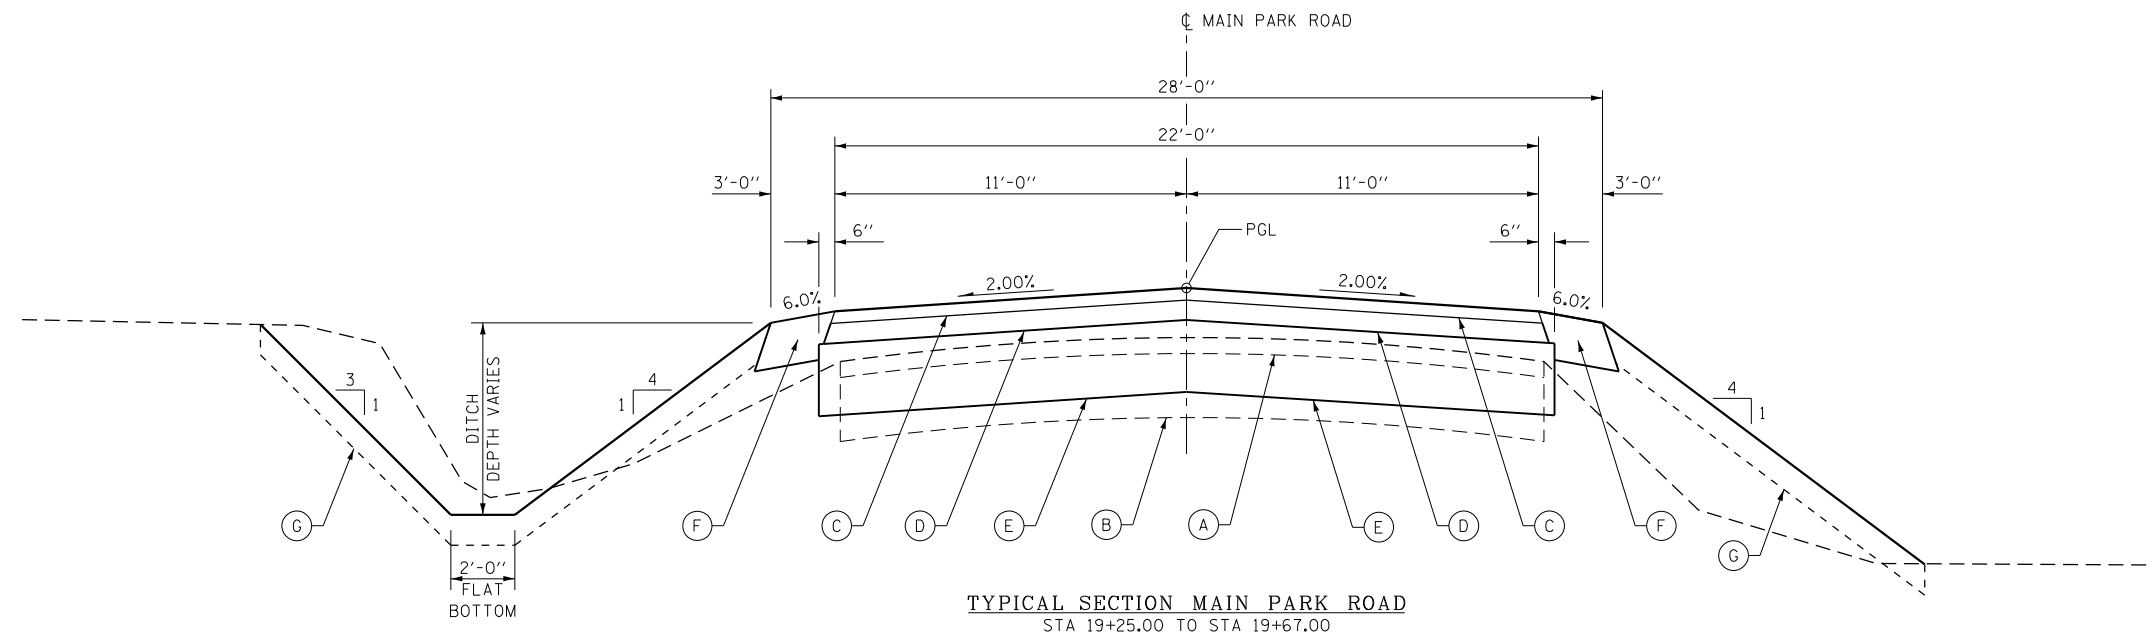

LEGEND

- (A) EXISTING BITUMINOUS SURFACE COURSE, 2"±
- (B) EXISTING AGGREGATE BASE COURSE, 6"±
- (C) PROPOSED HOT-MIX ASPHALT SURFACE COURSE, MIX "D", N50, 1½"
- (D) PROPOSED HOT-MIX ASPHALT BINDER COURSE, IL-9.5FG, N50, 2½"
- (E) PROPOSED AGGREGATE BASE COURSE, TYPE B 12"
- (F) PROPOSED AGGREGATE SHOULDER, TYPE B 6"
- (G) PROPOSED TOPSOIL FURNISH AND PLACE, 4" (SPECIAL)

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		DRAWN - J.E.B.	REVISED -
		CHECKED - R.H.D.	REVISED -
		DATE - 04/02/21	REVISED -

STATE OF ILLINOIS
DEPARTMENT OF TRANSPORTATION

PROPOSED TYPICAL ROADWAY SECTION			
JUBILEE COLLEGE STATE PARK			
SCALE: NTS	SHEET 1 OF 11 SHEETS	STA. N/A	TO STA. N/A

F.A. RTE.	SECTION	COUNTY	TOTAL SHEETS	SHEET NO.
	JUBILEE COLLEGE 2021	PEORIA	24	6
CONTRACT NO. 46926				
ILLINOIS FED. AID PROJECT				

REMOVAL SCHEDULE							
LOCATION			TREE REM (6 TO 15 UNITS DIA) (UNIT) 20100110	TREE REM (OVER 15 UNITS DIA) (UNIT) 20100210	PAVEMENT REMOVAL (SQ YD) 44000100	PIPE CULV REMOVAL (FOOT) 50105220	REL EX FLAR END SEC (EACH) X0322939
103+35.00		15'	LT	12	18		
19+25.00	TO	19+67.00	CL		103		
19+30.00	RT	19+60.00	LT			195	3
TOTAL				12	18	103	195

PAVEMENT SCHEDULE									
LOCATION			AGG BASE CSE TYPE B 12" (SQ YD) 35102400	BIT MATLS (PRIME COAT) (POUND) 40600275	BIT MATLS (TACK COAT) (POUND) 40600290	HMA SURF REM BUTT JT (SQ YD) 40600982	HMA BC IL-9.5FG N50 (TON) 40602965	HMA SC IL-9.5FG D N50 (TON) 40604010	AGGREGATE SHLDS B 6 (SQ YD) 48101500
19+25.00	TO	19+67.00	RT	108	242	24.2	14.7	8.7	28
19+15.00	TO	19+25.00	RT			5.5		2.1	
19+67.00	TO	19+77.00	LT			5.5		2.1	
TOTAL				108	242	36	50	13	28

DRAINAGE SCHEDULE														
STATION	OFFSET	STATION	OFFSET	TRENCH BACKFILL (CU YD) 20800150	PIPE CULVERTS, CL A, TY 1 60" (FOOT) 542A0265	PIPE CULVERTS, CL A, TY 2 54" (FOOT) 542A1099	PIPE CULVERTS, CL A, TY 3 48" (FOOT) 542A1933	PRC FLARED END SEC 48" (EACH) 54213693	PRC FLARED END SEC 54" (EACH) 54213699	PRC FLARED END SEC 60" (EACH) 54213705	MH, TY A, 7'-DIA, TY 1 FRAME, OLID (EACH) 60224445	MH, TY A, 7'-DIA, TY 1 FRAME, OLID (SPECIAL) (EACH)	RELOCATE EX FLAR END SEC (EACH) X0322939	GRADING & SHAPING SPL (SQ YD) X0100002
CHANNEL CHANGE ALIGNMENT														
100+25.00	RT/LT	100+60.00	RT/LT											200
100+52.43	1.35' RT												1	
100+62.07	11.04' LT												1	
100+63.45	CL											1		
100+64.77	11.05' RT												1	
100+65.61	CL	101+33.67	CL			68								
100+86.92	CL	101+13.08	CL	44										
101+42.00	CL								1					
103+18.00	CL									1				
103+26.25	CL	103+38.20	CL		12									
103+40.00	CL										1			
103+42.90	CL	104+13.83	CL				71							
104+22.00	CL							1						
TOTALS				44	12	68	71	1	1	1	1	1	3	200

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USER NAME = jbeque	DESIGNED - R.H.D.	REVISED -
	DRAWN - J.E.B.	REVISED -
PLOT SCALE = 40.0000' / in.	CHECKED - R.H.D.	REVISED -
PLOT DATE = 4/7/2021	DATE - 04/02/21	REVISED -

STATE OF ILLINOIS
DEPARTMENT OF TRANSPORTATION

SCHEDULE OF QUANTITIES
JUBILEE COLLEGE STATE PARK

SCALE: SHEET OF SHEETS STA. TO STA.

F.A. RTE.	SECTION	COUNTY	TOTAL SHEETS	SHEET NO.
	JUBILEE COLLEGE 2021	PEORIA	24	7
			CONTRACT NO. 46926	
		ILLINOIS	FED. AID PROJECT	

EARTHWORK SCHEDULE				
1 Location	2 Earth Exc (Special) X2020410	3 Earth Excavation Adjusted For Shrinkage (25%)	4 Embankment	5 Earthwork Balance Waste (+) or Shortage (-)
	Cubic Yard	Cubic Yard	Cubic Yard	Cubic Yard
Sta 19+00 to 20+00	181	136	45	+ 91
Sta 101+42 to 105+30	2,186	1,640	1,093	+ 547
TOTAL	2,367	1,775	1,138	+ 637

Columns 1, 2, & 4

Location and Quantities from Cross Sections:

Cut = Earth Excavation (Special) Fill = Embankment

Column 3

Quantity of Earth Excavation (Cut) Adjusted for a Shrinkage Factor of 25%

Column 5

Earthwork Required:

(-) = Quantity of Fill or Embankment needed (Furnished or Borrow Excavation)

(+) = Quantity to be Wasted

SIGN SCHEDULE				
SIGN DESIGNATION	LOCATION FROM JUBILEE ROAD / US 150 INTERSECTION	SIGN PANEL TYPE 2 (SQ FT) 72000200	SIGN PANEL TYPE 3 (SQ FT) 72000300	WOOD SIGN SUPPORT (FOOT) 73000100
ALONG US 150				2 PER SIGN
001	3 MILES WEST		24	32
001	3 MILES EAST		24	32
002	1000' WEST		24	32
002	1000' EAST		24	32
003	500' WEST	16		30
003	500' EAST	16		30
	FROM MPR ENTRANCE			
004	500' WEST	16		30
004	500' EAST	16		30
		64	96	248

RIPRAP SCHEDULE				
LOCATION		STONE RIPRAP CL A5 (TON) 28100209	FILTER FABRIC (SQ YD) 28200200	
101+34.00	TO 101+83.00	227	200	
104+16.00	TO 104+69.00	240	212	
	TOTAL	467	412	

PERMANENT SEEDING SCHEDULE							
LOCATION				SEEDING CLASS 1B (ACRE) 25000115	PRAIRIE SEED (SPECIAL) (ACRE) K1004572	NITROGEN FERT NUTR (POUND) 25000400	POTASSIUM FERT NUTR (POUND) 25000600
19+00.00	TO	20+00.00	LT	0.13	0.13	23.4	23.4
* 19+00.00	TO	20+00.00	RT	0.05	0.05	9.0	9.0
101+42.00	TO	105+30.00	RT		0.50	45.0	45.0
		TOTAL		0.18	0.68	78	78

* DITCH AND FORESLOPE

EROSION CONTROL SCHEDULE								
LOCATION			TOPSOIL F & P 4 SPL (SQ YD) X2110104	EROS CONTR BLANKET (SQ YD) 25100630	TURF REINF MAT (SQ YD) 25100900	TEMP EROS CONTR SEED (POUND) 28000250	PERIMETER EROS BAR (FOOT) 28000400	INLET & PIPE PROTECTION (EACH) 28000500
19+00.00	TO	19+38.00	40		40	2		1
19+50.00								1
19+00.00	TO	20+00.00	533	533		25		
19+00.00	TO	20+00.00	225	225		10		
19+61.00	TO	20+00.00	40		40	2		1
101+40.00	TO	103+18.00	295	295		11		
101+40.00	TO	103+18.00	327	327		11		
101+83.00	TO	103+18.00	225		225	10		1
103+18.00	TO	105+30.00	952	952		25		
103+18.00	TO	105+30.00	813	813		31		
104+21.00	TO	104+54.00	26		26			
104+20.00	TO	104+52.00	25		25			
104+69.00	TO	105+30.00	102		102	5		
		ESTIMATED					1000	
		TOTAL	3,603	3,145	458	132	1,000	4

STATE OF ILLINOIS
DEPARTMENT OF TRANSPORTATION

SCHEDULE OF QUANTITIES
JUBILEE COLLEGE STATE PARK

F.A. RTE.	SECTION	COUNTY	TOTAL SHEETS	SHEET NO.
	JUBILEE COLLEGE 2021	PEORIA	24	8
			CONTRACT NO. 46926	
		ILLINOIS	FED. AID PROJECT	

SCALE: SHEET OF SHEETS STA. TO STA.

PR CURVE 1 DATA
 P.I. STA. 15+54.83
 $\Delta = 47^\circ 22' 24''$ (LT)
 $D = 7^\circ 30' 51''$
 $R = 762.50'$
 $T = 334.50'$
 $L = 630.45'$
 $E = 70.15'$
 $e = \text{N.C.}$
 P.C. STA. 12+20.33
 P.T. STA. 18+50.78



PR CURVE 2 DATA
 P.I. STA. 24+12.73
 $\Delta = 32^\circ 34' 04''$ (RT)
 $D = 10^\circ 25' 03''$
 $R = 550.00'$
 $T = 160.66'$
 $L = 312.63'$
 $E = 22.99'$
 $e = \text{N.C.}$
 P.C. STA. 21+52.07
 P.T. STA. 24+64.69

PR CURVE CHANNEL 1
 P.I. STA. 101+63.26
 $\Delta = 25^\circ 19' 25''$ (RT)
 $D = 114^\circ 35' 30''$
 $R = 50.00'$
 $T = 11.24'$
 $L = 22.10'$
 $E = 1.25'$
 P.C. STA. 101+52.03
 P.T. STA. 101+74.13

PR CURVE CHANNEL 2
 P.I. STA. 102+14.28
 $\Delta = 25^\circ 20' 31''$ (LT)
 $D = 57^\circ 17' 45''$
 $R = 100.00'$
 $T = 22.48'$
 $L = 44.24'$
 $E = 2.50'$
 P.C. STA. 101+91.80
 P.T. STA. 102+36.03

PR CURVE CHANNEL 3
 P.I. STA. 102+98.20
 $\Delta = 4^\circ 57' 58''$ (RT)
 $D = 28^\circ 38' 52''$
 $R = 200.00'$
 $T = 8.67'$
 $L = 17.34'$
 $E = 0.19'$
 P.C. STA. 102+89.53
 P.T. STA. 103+06.86



PR CURVE CHANNEL 4
 P.I. STA. 104+79.95
 $\Delta = 7^\circ 37' 17''$ (RT)
 $D = 19^\circ 05' 55''$
 $R = 300.00'$
 $T = 19.98'$
 $L = 39.91'$
 $E = 0.66'$
 P.C. STA. 104+59.97
 P.T. STA. 104+99.88

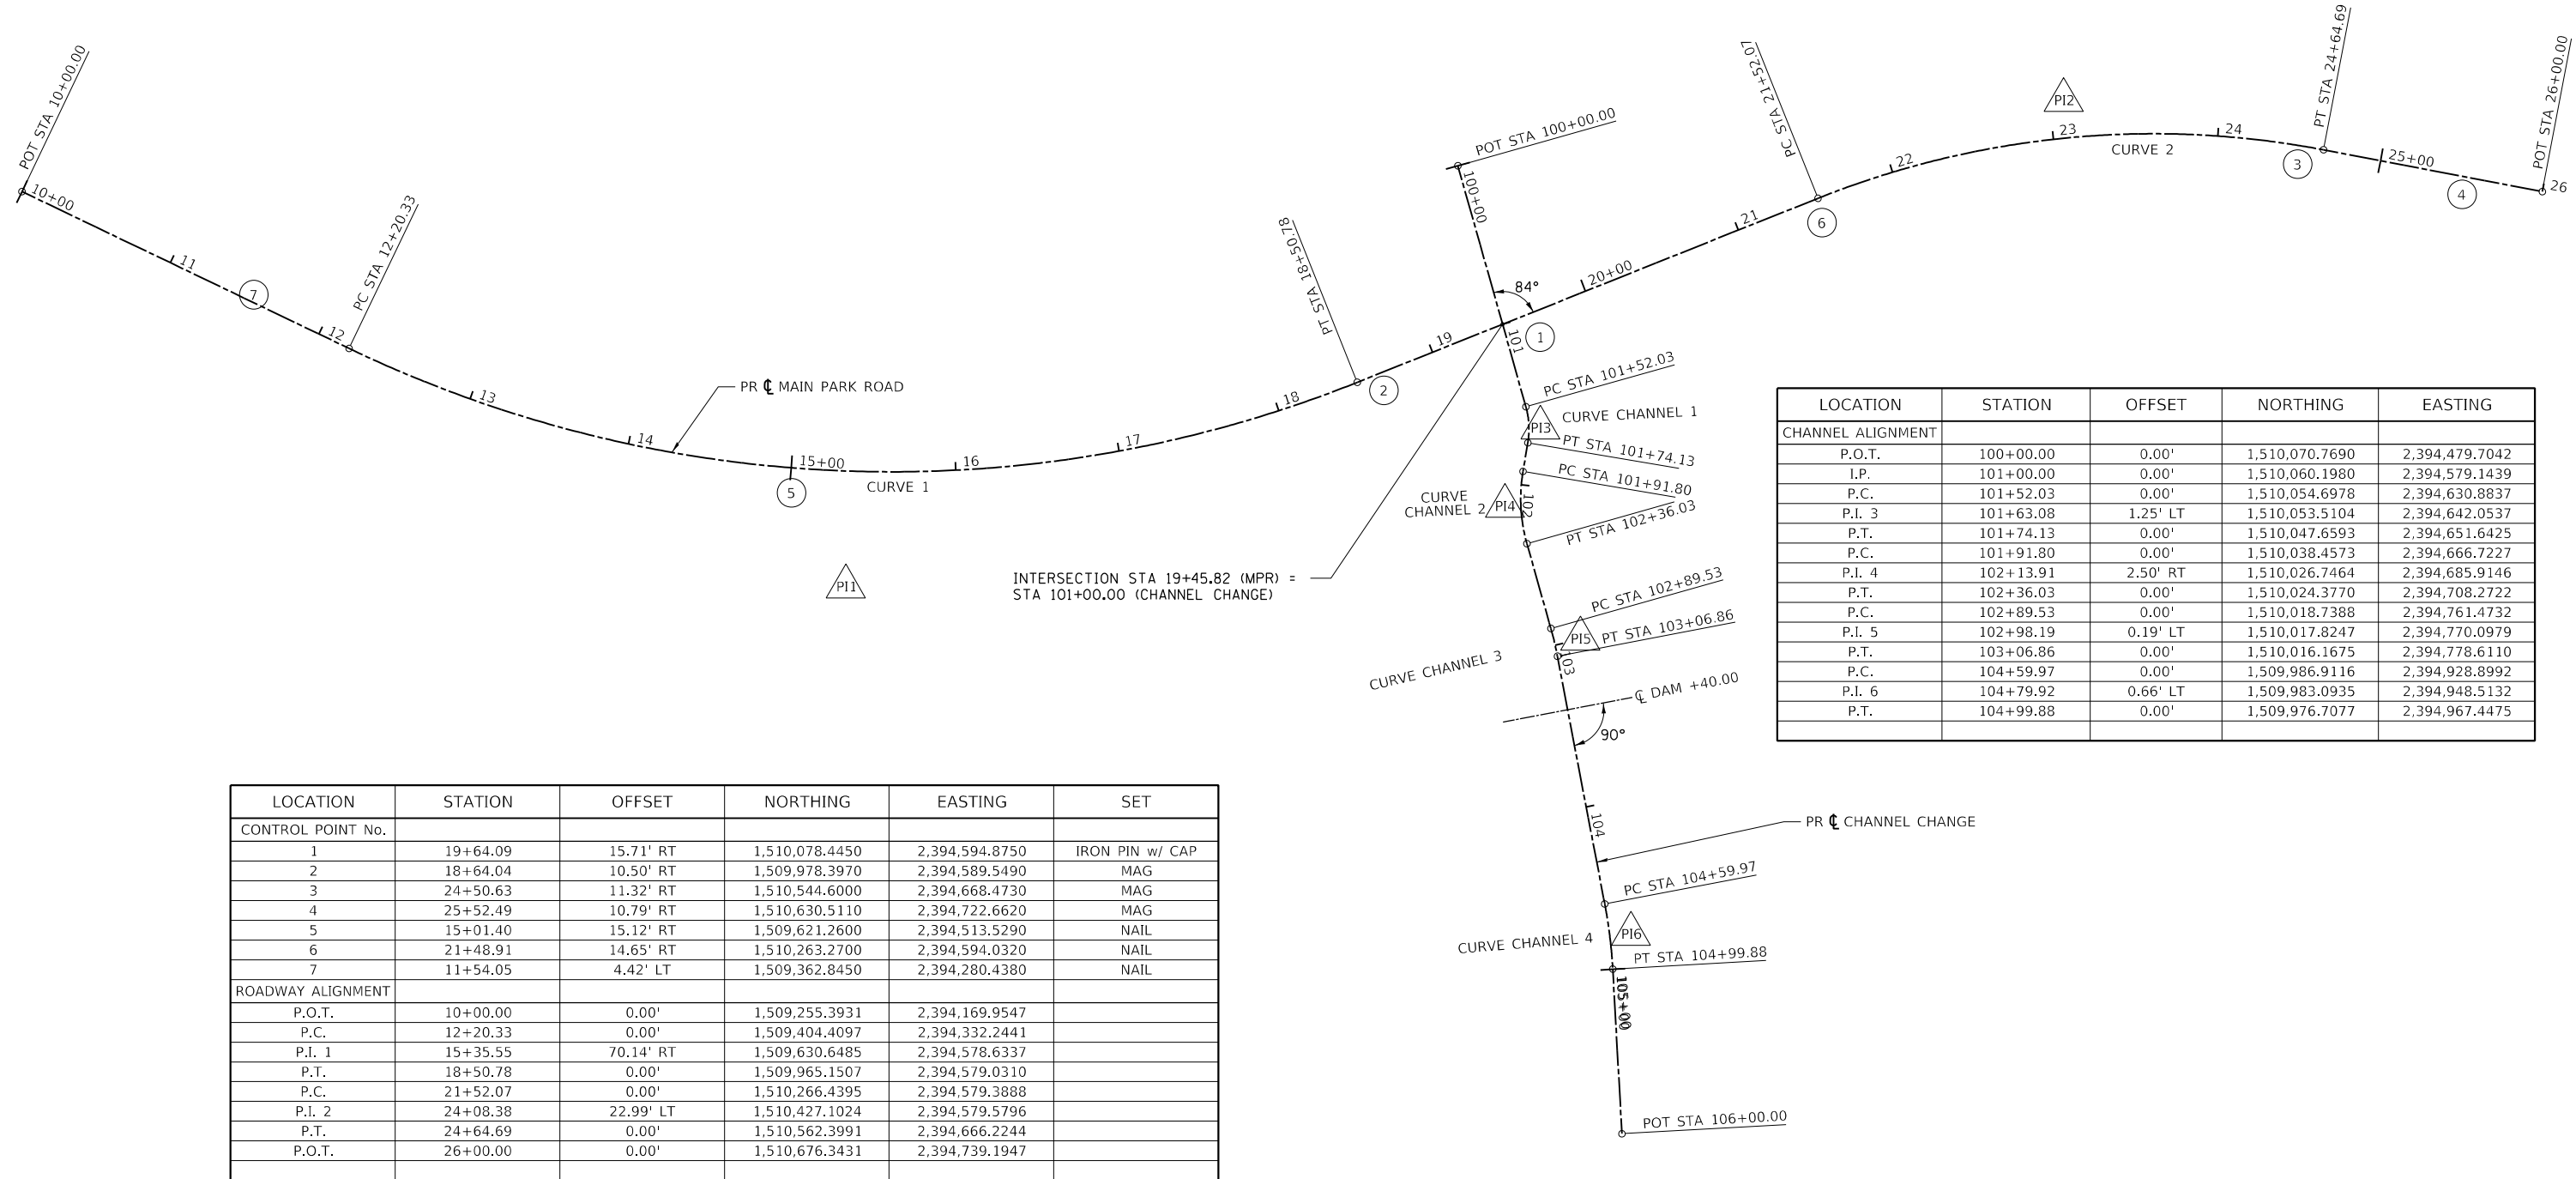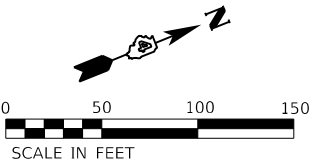


LOCATION	STATION	OFFSET	NORTHING	EASTING
CHANNEL ALIGNMENT				
P.O.T.	100+00.00	0.00'	1,510,070.7690	2,394,479.7042
I.P.	101+00.00	0.00'	1,510,060.1980	2,394,579.1439
P.C.	101+52.03	0.00'	1,510,054.6978	2,394,630.8837
P.I. 3	101+63.08	1.25' LT	1,510,053.5104	2,394,642.0537
P.T.	101+74.13	0.00'	1,510,047.6593	2,394,651.6425
P.C.	101+91.80	0.00'	1,510,038.4573	2,394,666.7227
P.I. 4	102+13.91	2.50' RT	1,510,026.7464	2,394,685.9146
P.T.	102+36.03	0.00'	1,510,024.3770	2,394,708.2722
P.C.	102+89.53	0.00'	1,510,018.7388	2,394,761.4732
P.I. 5	102+98.19	0.19' LT	1,510,017.8247	2,394,770.0979
P.T.	103+06.86	0.00'	1,510,016.1675	2,394,778.6110
P.C.	104+59.97	0.00'	1,509,986.9116	2,394,928.8992
P.I. 6	104+79.92	0.66' LT	1,509,983.0935	2,394,948.5132
P.T.	104+99.88	0.00'	1,509,976.7077	2,394,967.4475

LOCATION	STATION	OFFSET	NORTHING	EASTING	SET
CONTROL POINT No.					
1	19+64.09	15.71' RT	1,510,078.4450	2,394,594.8750	IRON PIN w/ CAP
2	18+64.04	10.50' RT	1,509,978.3970	2,394,589.5490	MAG
3	24+50.63	11.32' RT	1,510,544.6000	2,394,668.4730	MAG
4	25+52.49	10.79' RT	1,510,630.5110	2,394,722.6620	MAG
5	15+01.40	15.12' RT	1,509,621.2600	2,394,513.5290	NAIL
6	21+48.91	14.65' RT	1,510,263.2700	2,394,594.0320	NAIL
7	11+54.05	4.42' LT	1,509,362.8450	2,394,280.4380	NAIL
ROADWAY ALIGNMENT					
P.O.T.	10+00.00	0.00'	1,509,255.3931	2,394,169.9547	
P.C.	12+20.33	0.00'	1,509,404.4097	2,394,332.2441	
P.I. 1	15+35.55	70.14' RT	1,509,630.6485	2,394,578.6337	
P.T.	18+50.78	0.00'	1,509,965.1507	2,394,579.0310	
P.C.	21+52.07	0.00'	1,510,266.4395	2,394,579.3888	
P.I. 2	24+08.38	22.99' LT	1,510,427.1024	2,394,579.5796	
P.T.	24+64.69	0.00'	1,510,562.3991	2,394,666.2244	
P.O.T.	26+00.00	0.00'	1,510,676.3431	2,394,739.1947	

DATE	
BY	
PLAN	
NO.	
DATE	
BY	
PROFILE	
NO.	

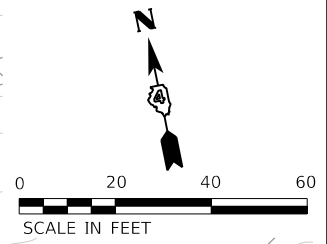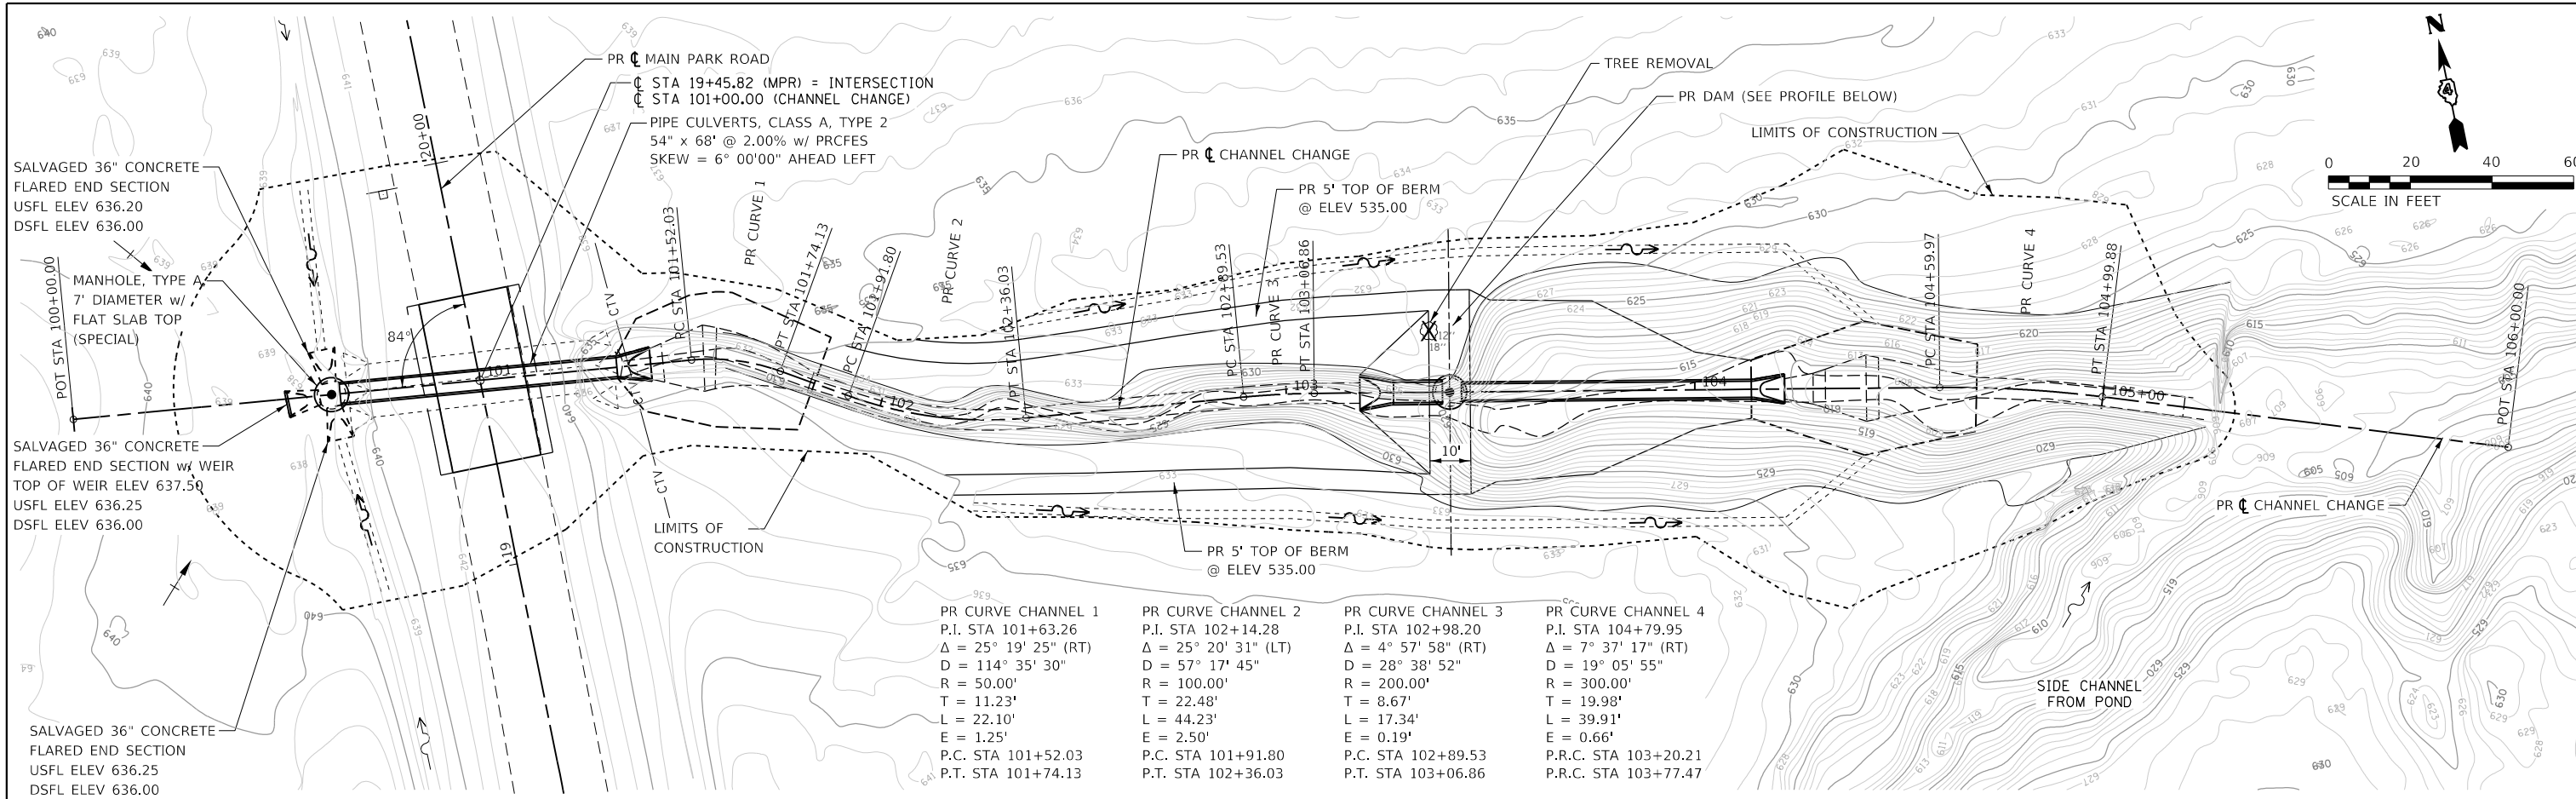

DATE	
BY	
PROFILE	
NO.	
DATE	
BY	
PLAN	
NO.	

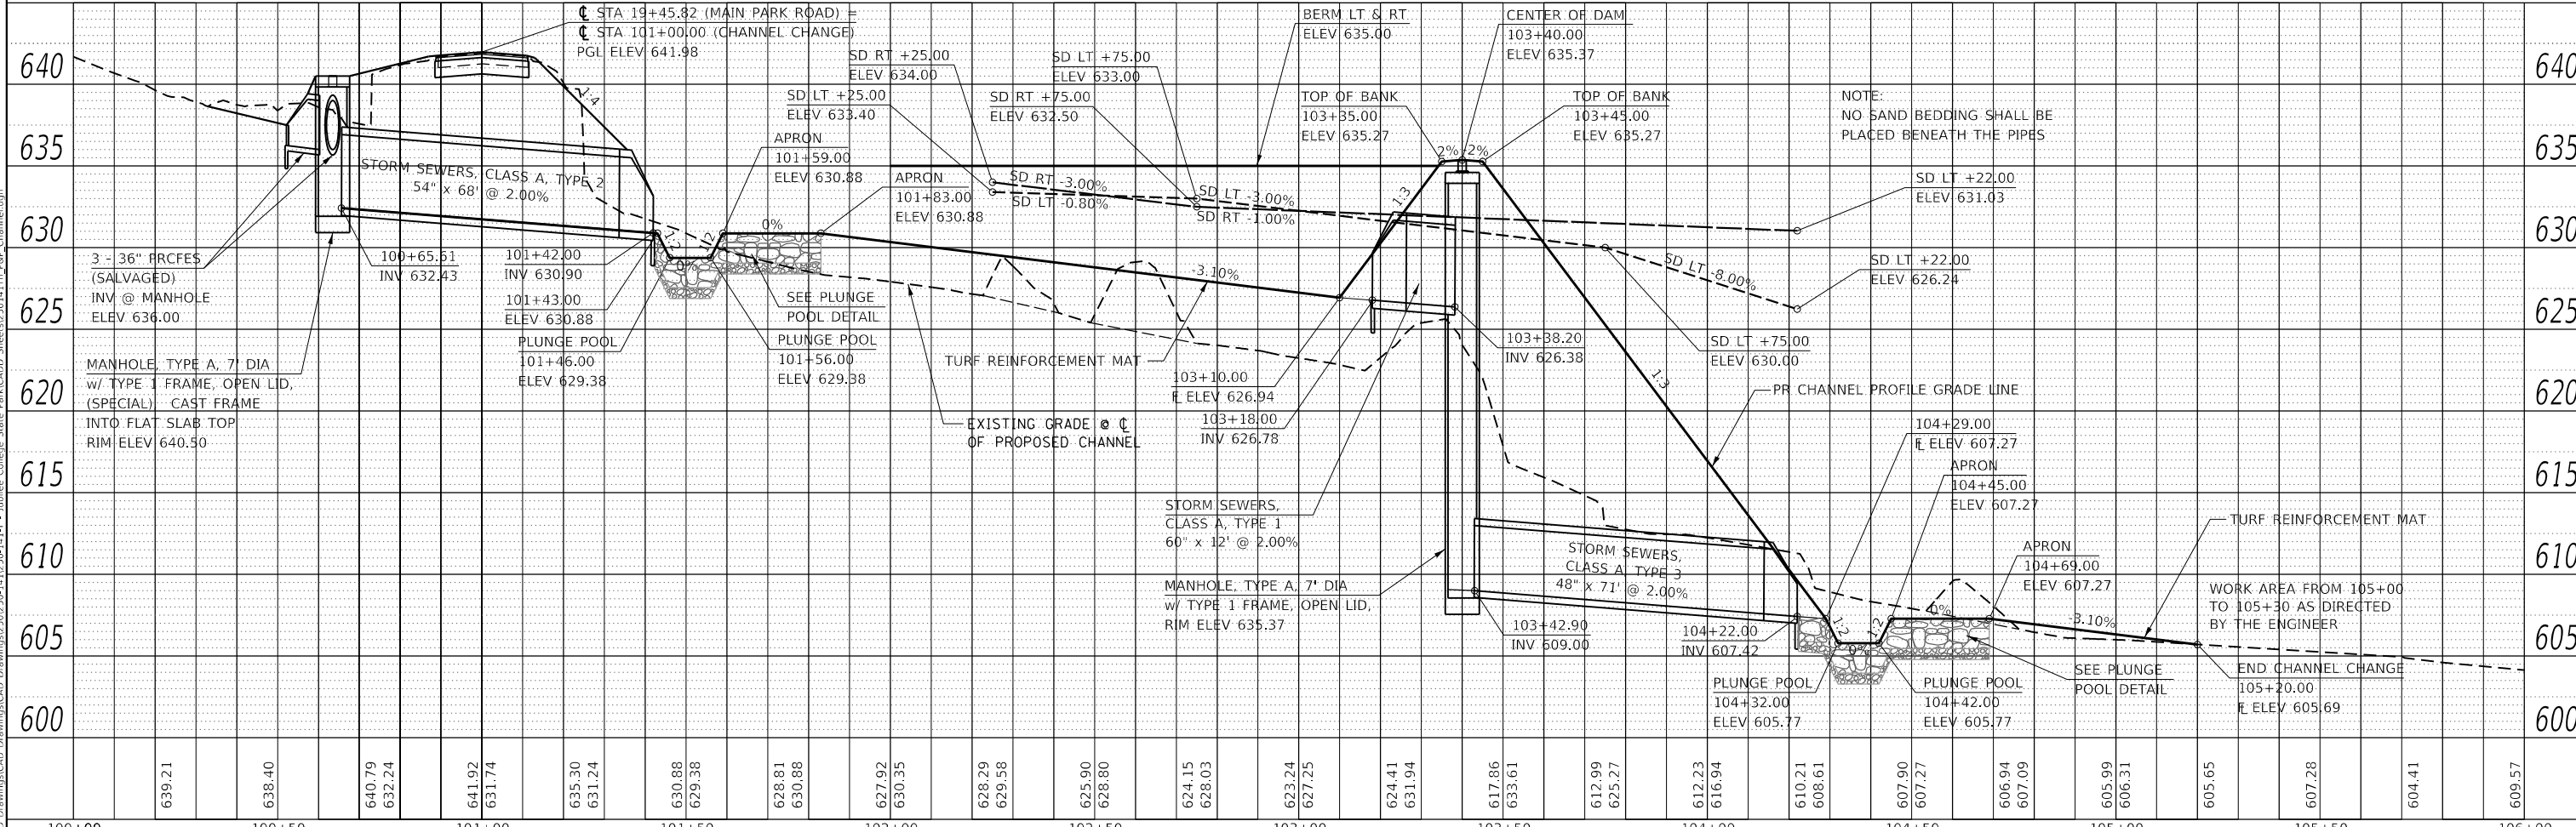

100+00	639.21	638.40	640.79	632.24	641.92	631.74	635.30	631.24	630.88	629.38	628.81	630.88	627.92	630.35	628.29	629.58	625.90	628.80	624.15	628.03	623.24	627.25	624.41	631.94	617.86	633.61	612.99	625.27	612.23	616.94	610.21	608.61	607.90	607.27	606.94	607.09	605.99	606.31	605.65	607.28	604.41	609.57
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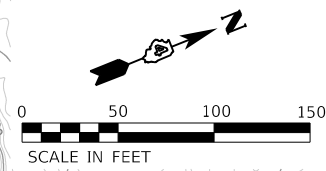
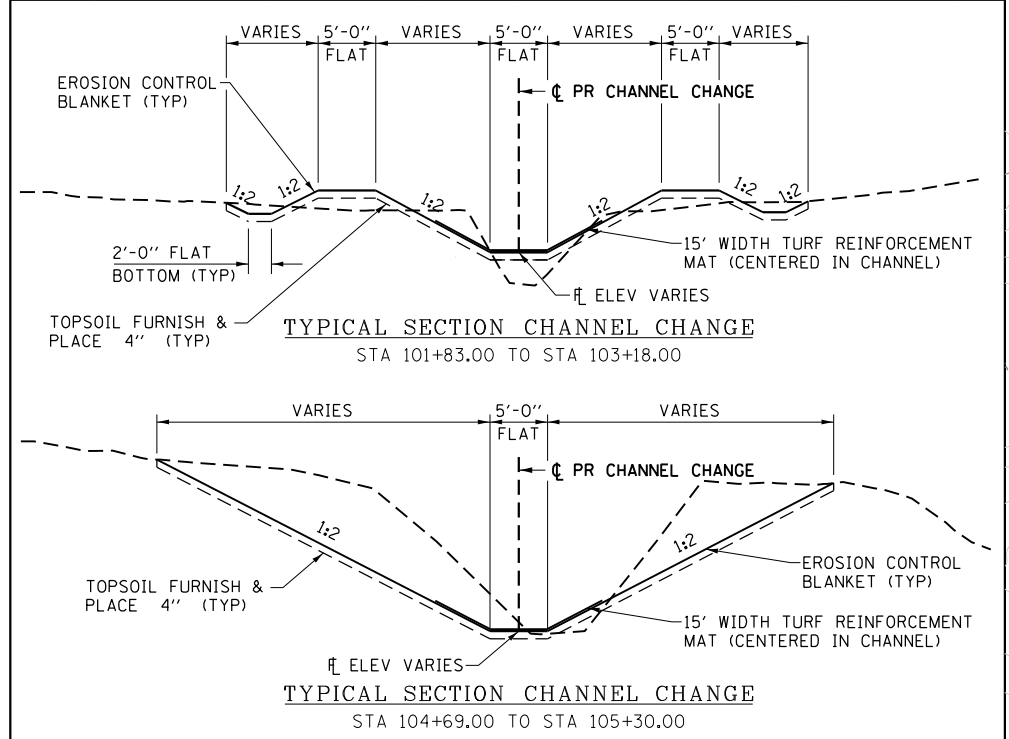
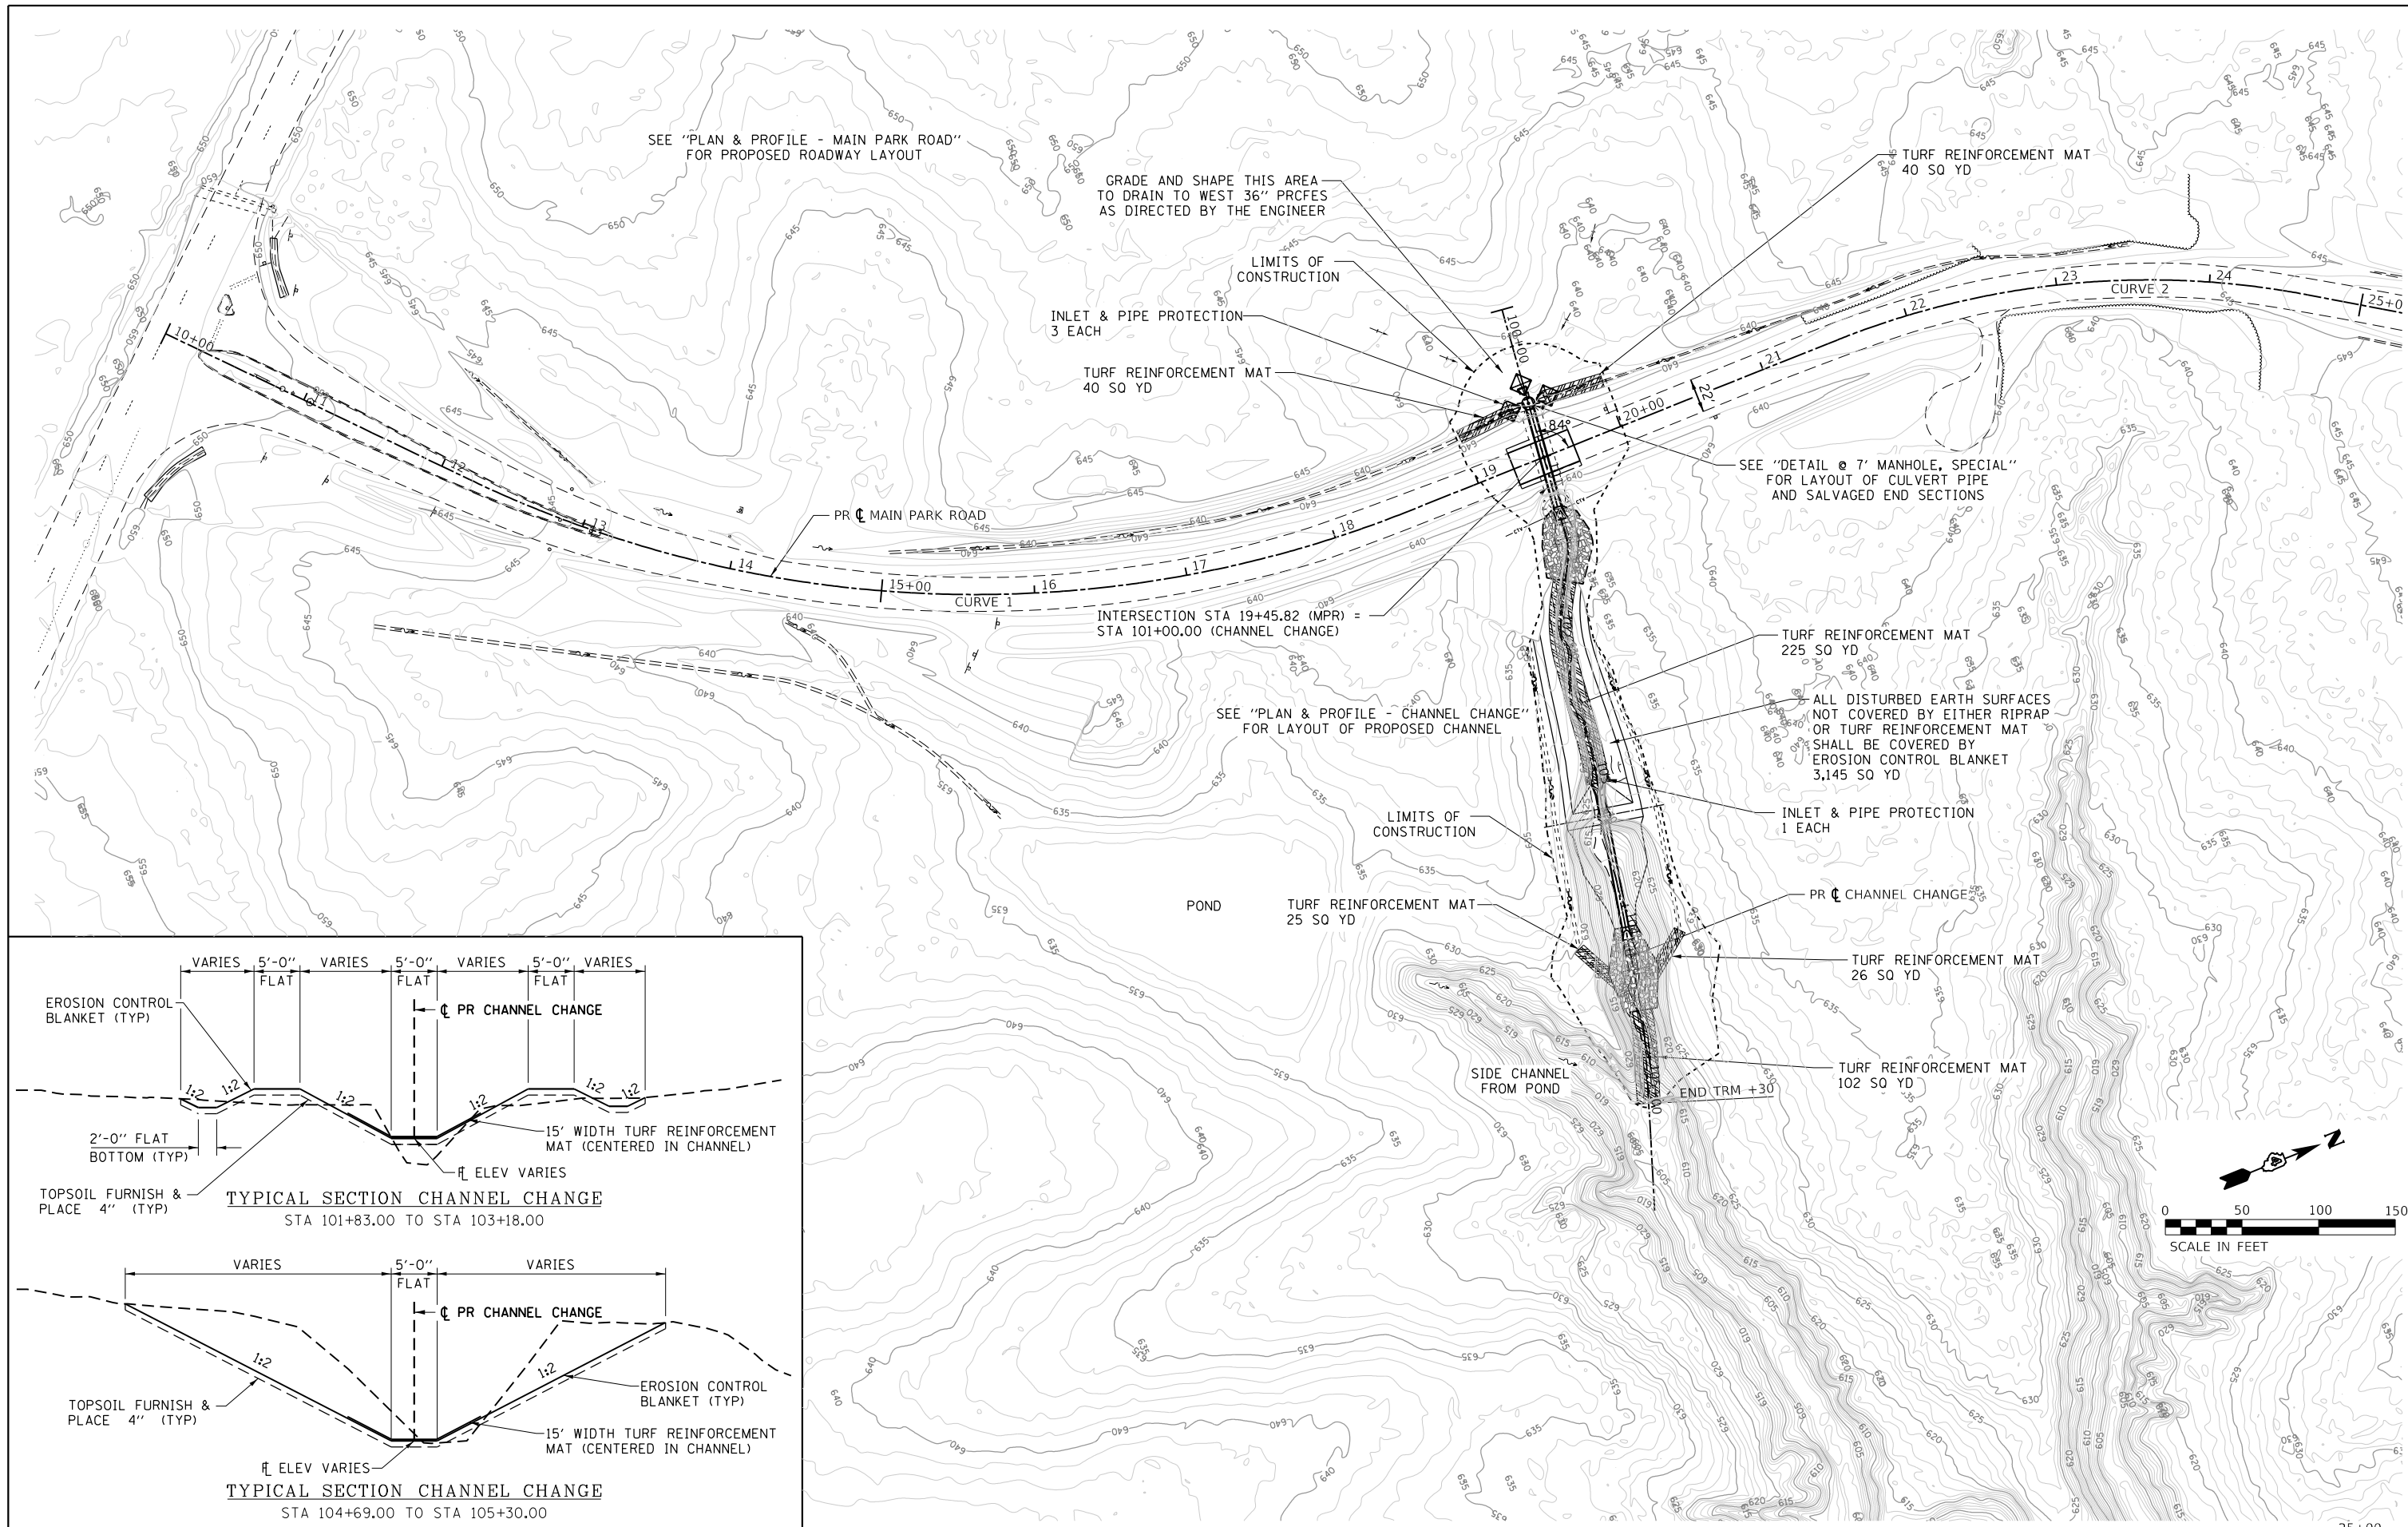
STATE OF ILLINOIS
 DEPARTMENT OF TRANSPORTATION

PLAN & PROFILE - CHANNEL CHANGE
 JUBILEE COLLEGE STATE PARK

USER NAME	= jbeque	DESIGNED	- R.H.D.	REVISED	-
PLOT SCALE	= 40.0000" / in.	DRAWN	- J.E.B.	REVISED	-
PLOT DATE	= 4/7/2021	CHECKED	- R.H.D.	REVISED	-
		DATE	- 04/02/21	REVISED	-

F.A. RTE.	SECTION	COUNTY	TOTAL SHEETS	SHEET NO.
	JUBILEE COLLEGE 2021	PEORIA	24	11
CONTRACT NO. 46926			ILLINOIS FED. AID PROJECT	

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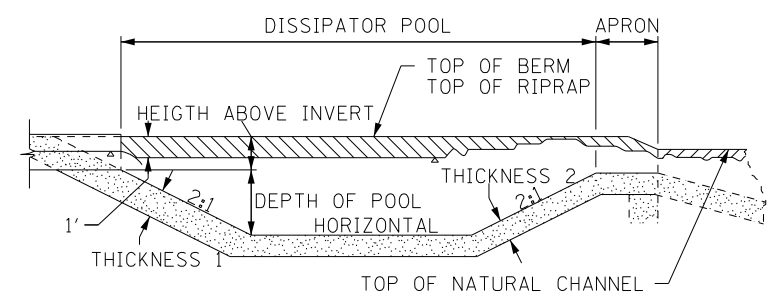
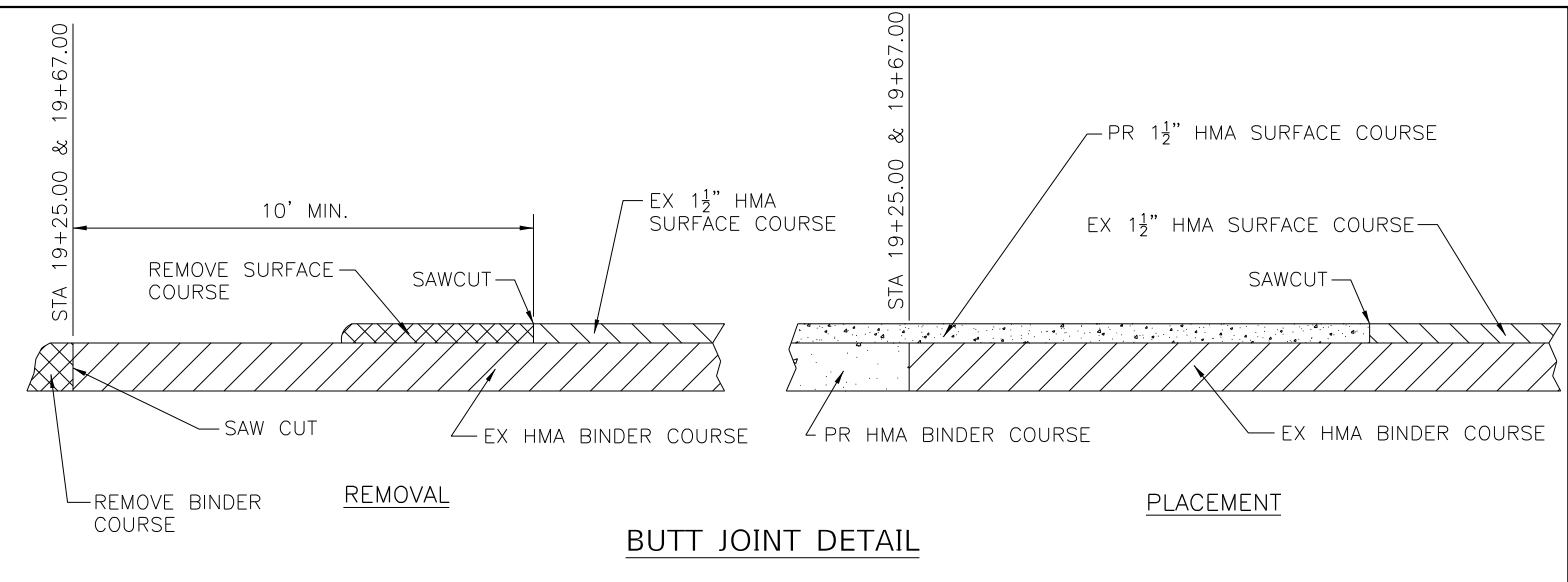
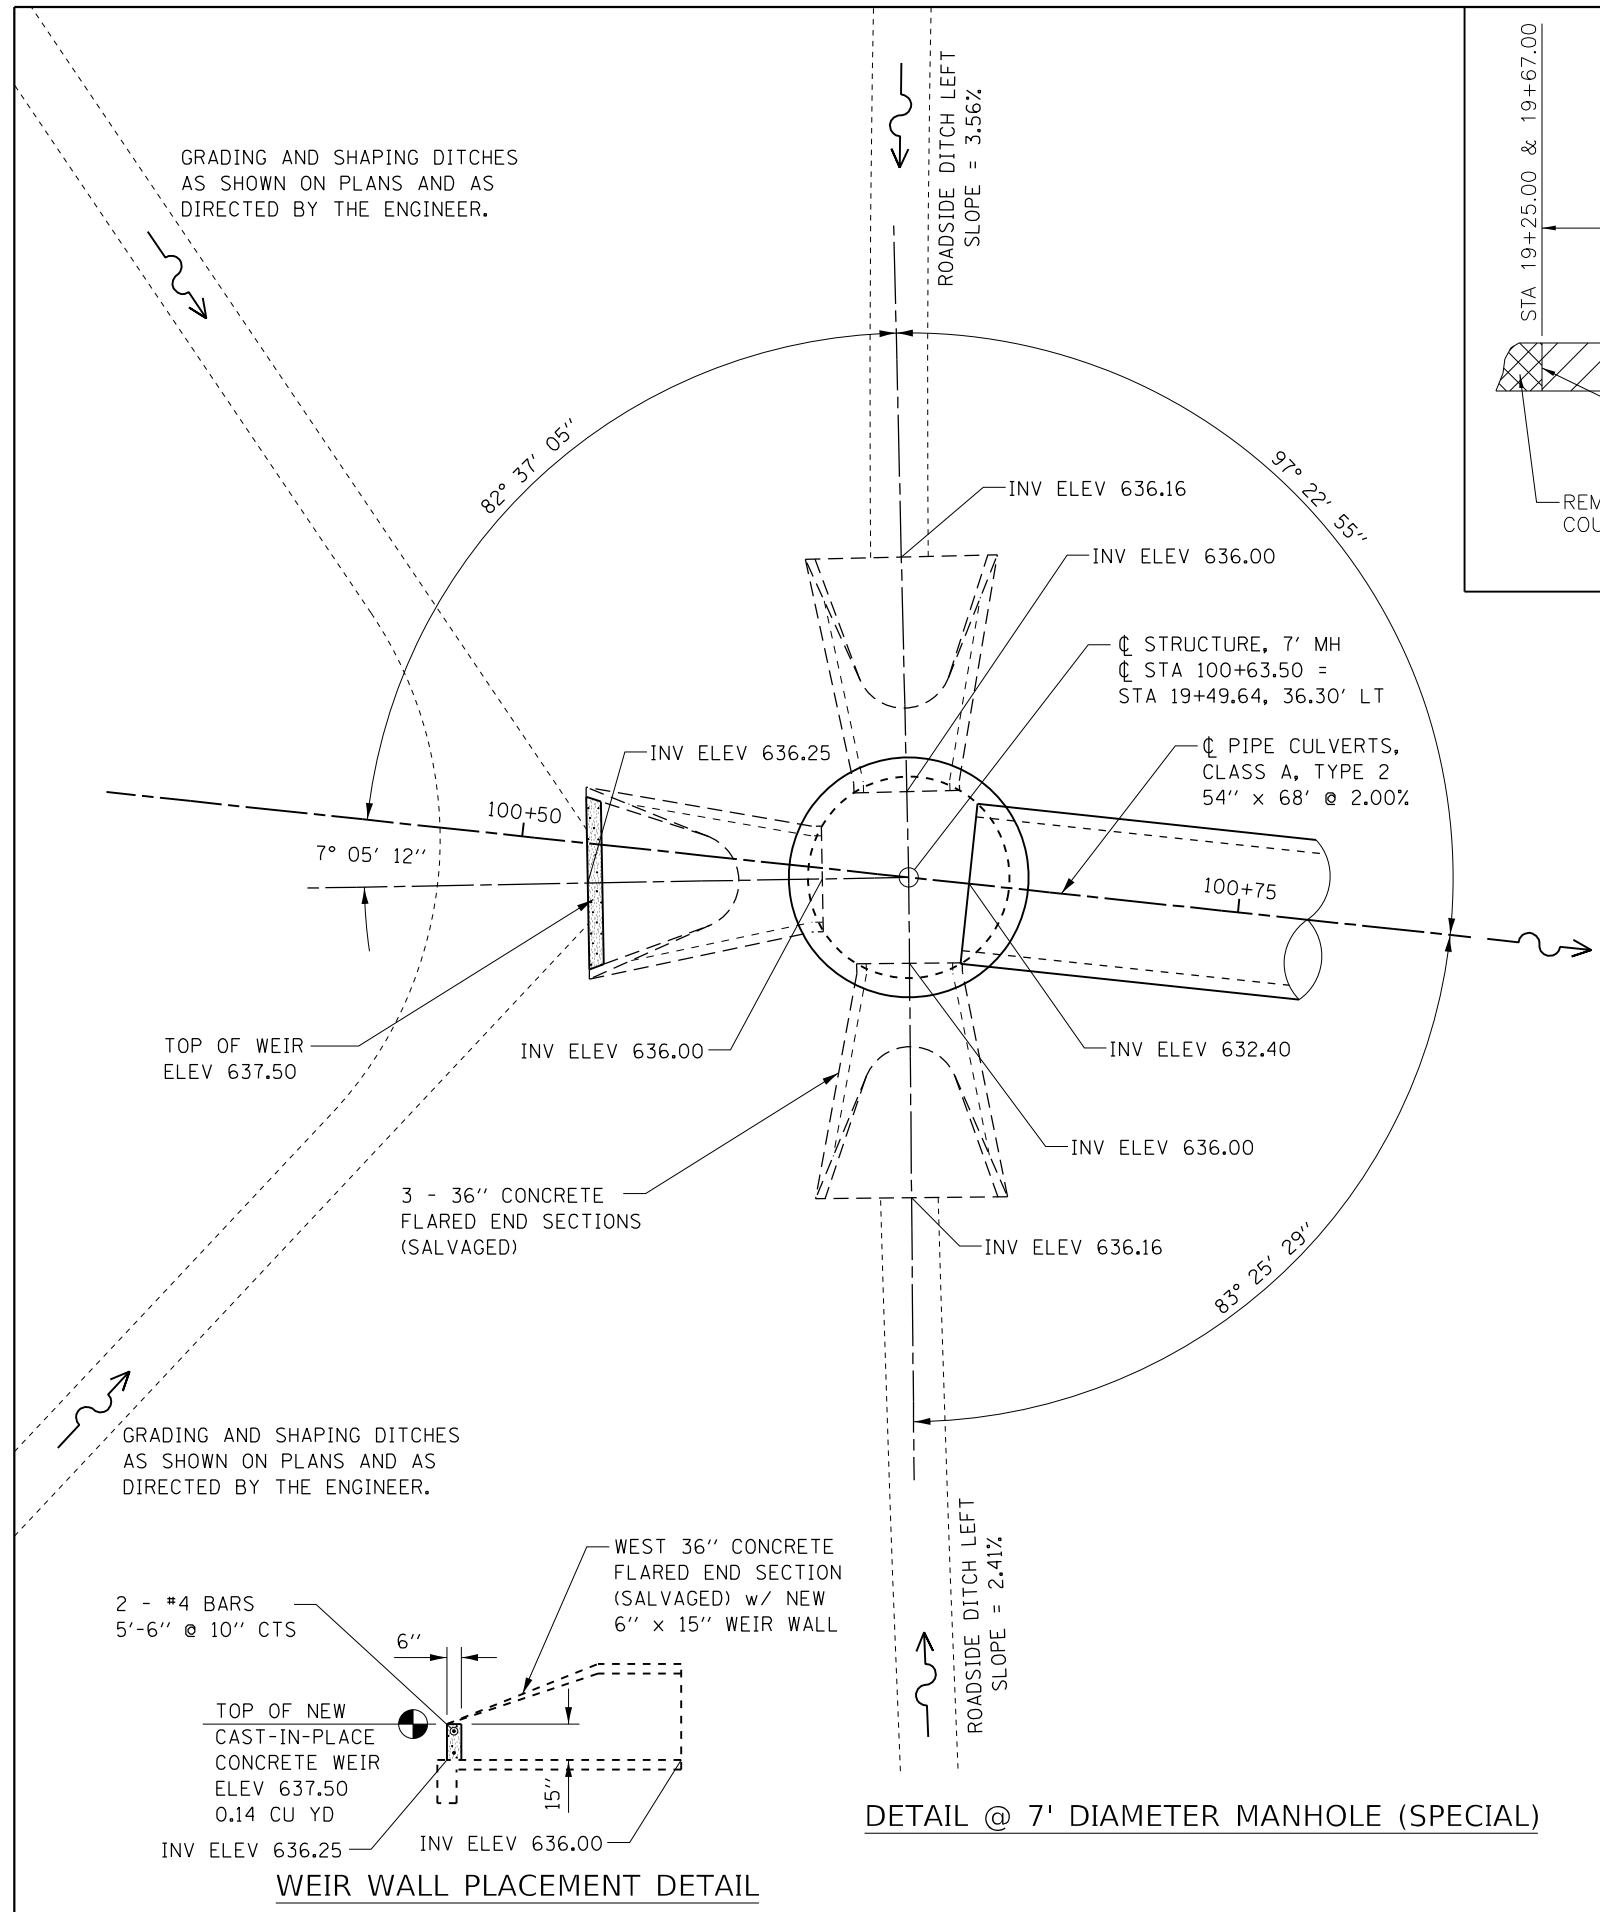


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Default	PLOT SCALE = 100.0000' / 1" =	DRAWN - J.E.B.	REVISED -
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		DATE - 04/02/21	REVISED -


**STATE OF ILLINOIS
DEPARTMENT OF TRANSPORTATION**

EROSION CONTROL PLAN	
SCALE: NTS	SHEET 1 OF 1 SHEETS
STA. N/A	TO STA. N/A

F.A. RTE.	SECTION	COUNTY	TOTAL SHEETS	SHEET NO.
	JUBILEE COLLEGE 2021	PEORIA	24	12
CONTRACT NO. 46926				
ILLINOIS FED. AID PROJECT				



RIPRAP BASIN SIZING									
CHANNEL CHANGE LOCATION STATION	PIPE SIZE	RIPRAP AREA (SQ YD)	POOL LENGTH (FEET)	APRON LENGTH (FEET)	DEPTH OF POOL (FEET)	HEIGHT ABOVE INVERT (FEET)	RIPRAP GRAD.	THICK. 1 (FEET)	THICK. 2 (FEET)
101+34	54"	200	23	24	1.5	2.5	RR5	3.3	2.5
104+16	48"	212	16	24	1.5	2.5	RR5	3.3	2.5

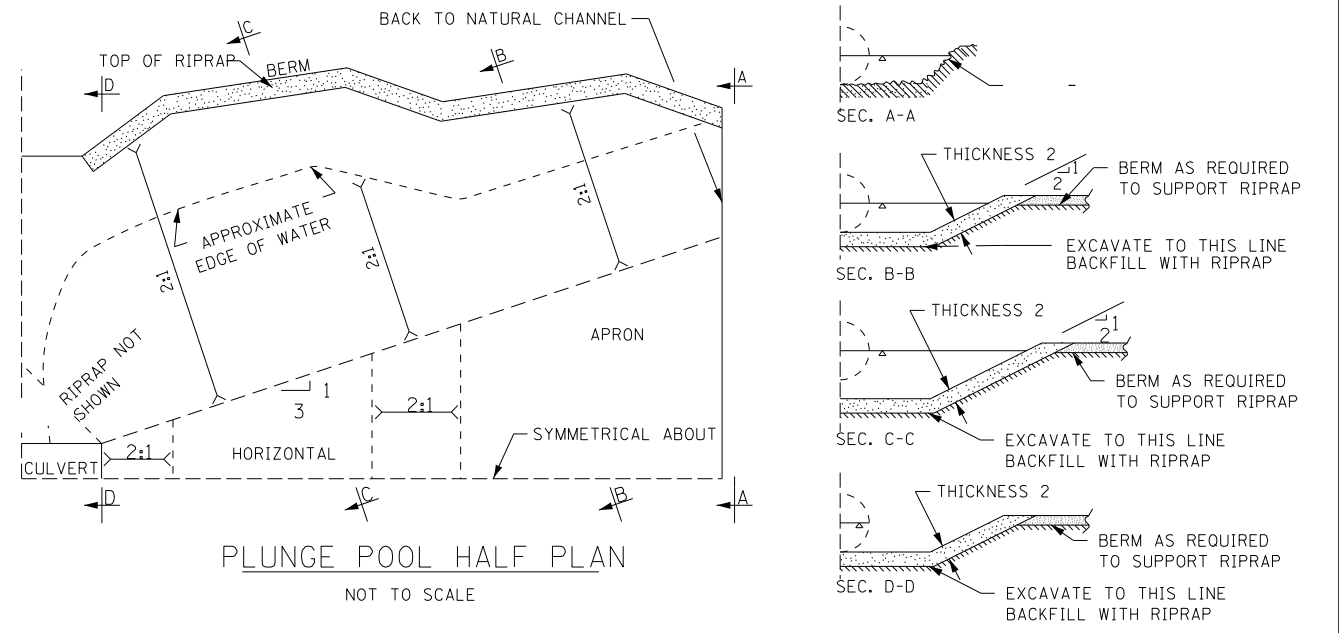

FILE NAME = 250141Tj_Site Details.dgn

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USER NAME = jbeque

PLOT SCALE = 40.0000' / in.

PLOT DATE = 4/7/2021

DESIGNED - R.H.D.

DRAWN - J.E.B.

CHECKED - R.H.D.

DATE - 04/02/21

REVISED -

REVISED -

REVISED -

REVISED -

STATE OF ILLINOIS
DEPARTMENT OF TRANSPORTATION

SITE DETAILS
JUBILEE COLLEGE STATE PARK

SCALE: SHEET 1 OF 1 SHEETS STA. TO STA.

F.A. RTÉ. SECTION COUNTY TOTAL SHEETS SHEET NO.

JUBILEE COLLEGE 2021 PEORIA 24 13



CONTRACT NO. 46926

ILLINOIS FED. AID PROJECT

STA 40+00±
2-TYPE III BARRICADES
10 FT EACH WITH
R112-6030 SIGNS
ATTACHED

EXCESS EARTH EXCAVATION
STOCK PILE SITE AS DIRECTED
BY PARK PERSONNEL

PHASE II SIGNAGE

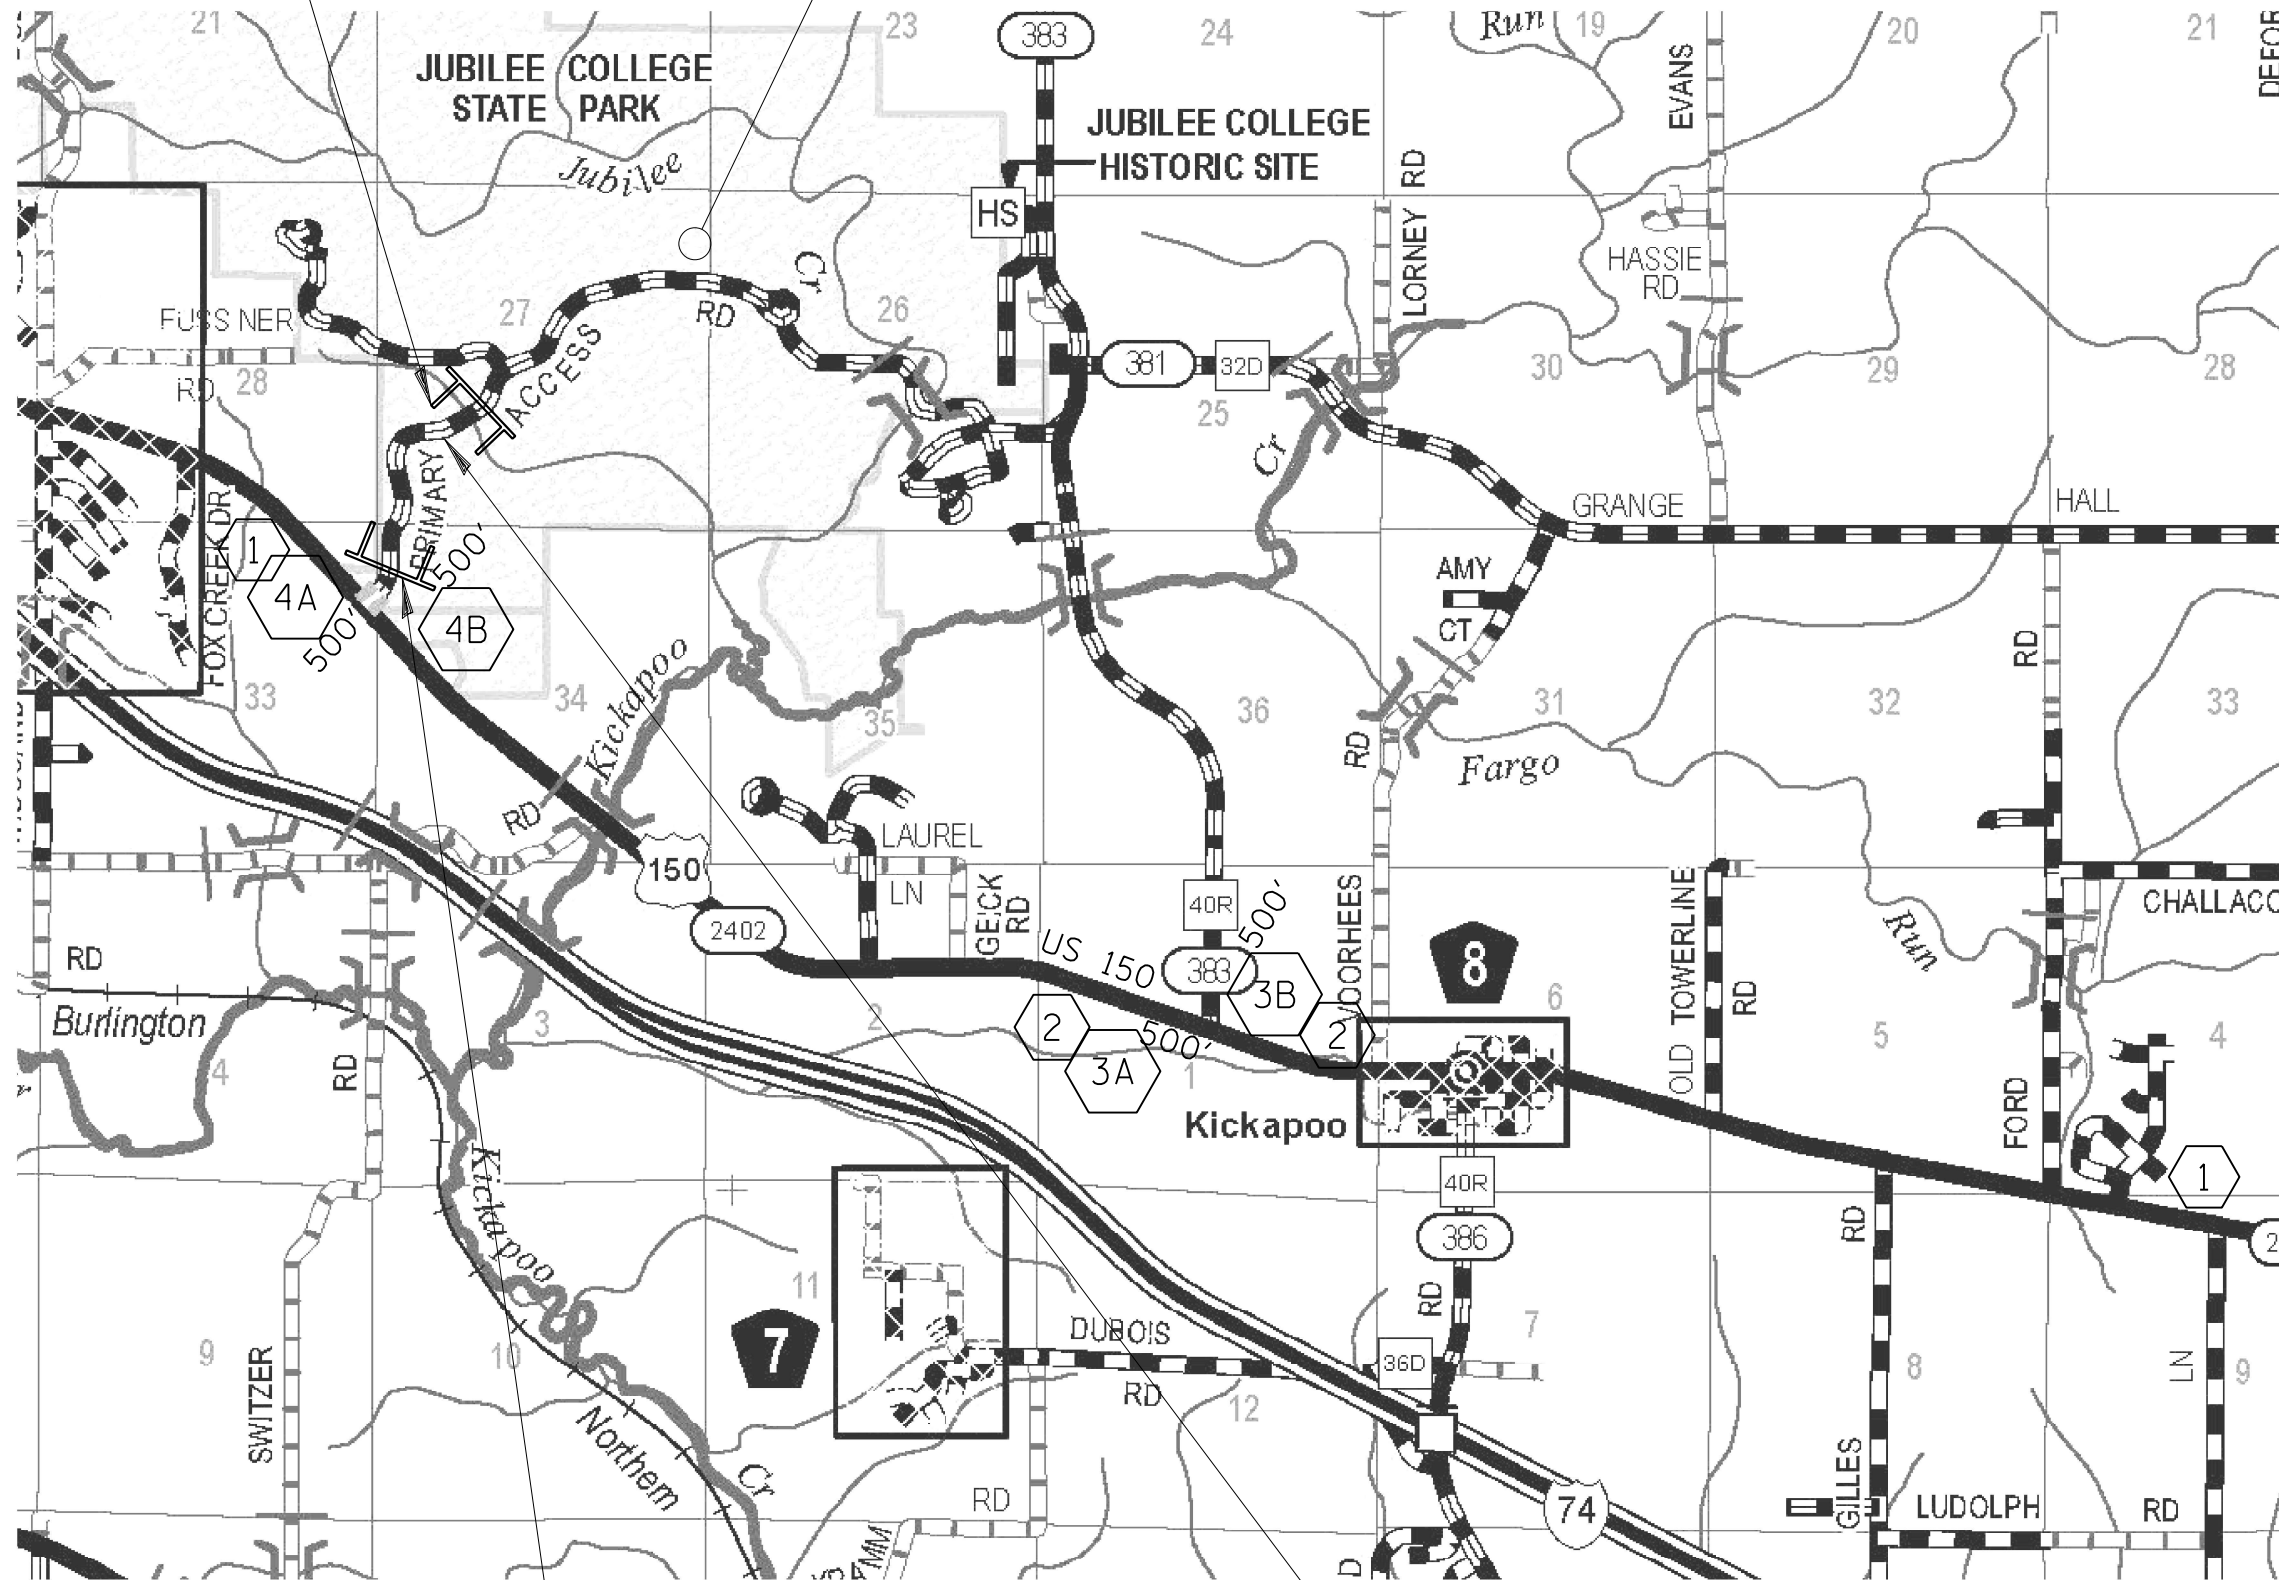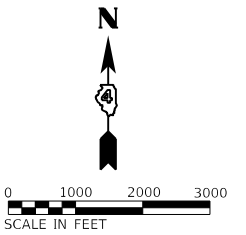

STA 10+50
4-TYPE III BARRICADES
10 FT EACH WITH
R112-6030 SIGNS
ATTACHED

MAIN PARK ROAD (MPR)

TEMPORARY DETOUR SIGNAGE

- 1 JUBILEE COLLEGE STATE PARK VISITORS USE JUBILEE ROAD 3 MILES AHEAD
SIGN 001
(1) SOUTH SIDE OF US 150
(1) NORTH SIDE OF US 150
(SEE DETAIL SHT 18)
- 2 JUBILEE COLLEGE STATE PARK VISITORS USE JUBILEE ROAD 1000 FEET AHEAD
SIGN 002
(1) SOUTH SIDE OF US 150
(1) NORTH SIDE OF US 150
(SEE DETAIL SHT 18)
- 3A ← DETOUR JUBILEE COLLEGE STATE PARK
SIGN 003
(1) SOUTH SIDE OF US 150
(SEE DETAIL SHT 18)
- 3B DETOUR → JUBILEE COLLEGE STATE PARK
SIGN 003
(1) NORTH SIDE OF US 150
(SEE DETAIL SHT 18)
- 4A ← ROAD CLOSED JUBILEE COLLEGE STATE PARK
SIGN 004
(1) SOUTH SIDE OF US 150
(SEE DETAIL SHT 18)
- 4B ROAD CLOSED → JUBILEE COLLEGE STATE PARK
SIGN 004
(1) NORTH SIDE OF US 150
(SEE DETAIL SHT 18)

FILE NAME = 250141TK_Detour_Plan.dgn
Default

USER NAME = jbeque
PLOT SCALE = 60.0000' / in.
PLOT DATE = 4/7/2021

DESIGNED - R.H.D.
DRAWN - J.E.B.
CHECKED - R.H.D.
DATE - 04/02/21

REVISED -
REVISED -
REVISED -
REVISED -


STATE OF ILLINOIS
DEPARTMENT OF TRANSPORTATION

DETOUR PLAN
JUBILEE COLLEGE STATE PARK

SCALE: NTS SHEET 1 OF 1 SHEETS STA. N/A TO STA. N/A

F.A. RTE.	SECTION	COUNTY	TOTAL SHEETS	SHEET NO.
	JUBILEE COLLEGE 2021	PEORIA	24	14
CONTRACT NO. 46926				
ILLINOIS FED. AID PROJECT				

SIGN DETAIL

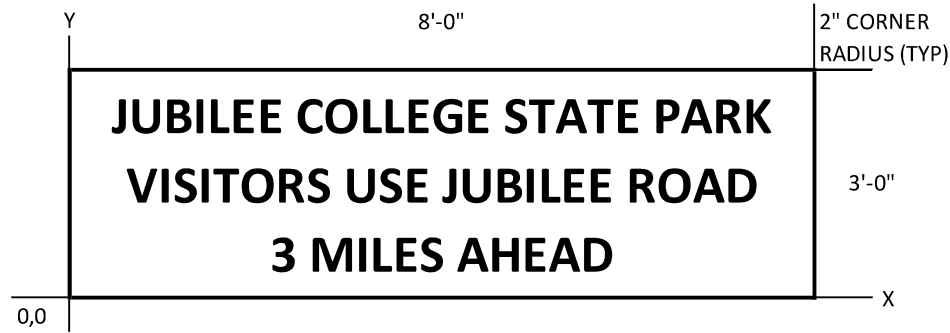


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BORDER WIDTH	0.8"
CORNER RADIUS	2.0"
MOUNTING	OVERHEAD
BACKGROUND	TYPE: REFLECTIVE COLOR: ORANGE
LEGEND/BORDER	TYPE: REFLECTIVE COLOR: BLACK

SYMBOL	X	Y	WID	HT

DIMENSIONS IN INCHES

COORDINATES TO LOWER LEFT CORNERS

SIGN DETAIL

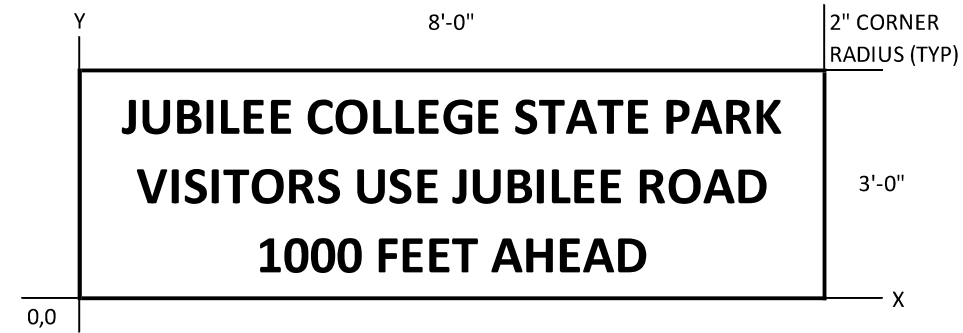

SIGN NUMBER	SIGN 002
WIDTH x HEIGHT	96.0" x 36.0"
BORDER WIDTH	0.8"
CORNER RADIUS	2.0"
MOUNTING	OVERHEAD
BACKGROUND	TYPE: REFLECTIVE COLOR: ORANGE
LEGEND/BORDER	TYPE: REFLECTIVE COLOR: BLACK

SYMBOL	X	Y	WID	HT

DIMENSIONS IN INCHES

COORDINATES TO LOWER LEFT CORNERS


Y FONT	LETTER POSITIONS (X)																		WT LEN					
25.0 D	J	U	B	I	L	E	E	C	O	L	L	E	G	E	S	T	A	T	E	P	A	R	K	
15.0 D	V	I	S	I	T	O	R	S	U	S	E	J	U	B	I	L	E	E	R	O	A	D		
5.0 D	3	M	I	L	E	S	A	H	E	A	D													

DETAILS SIGN 001

Y FONT	LETTER POSITIONS (X)																		WT LEN					
25.0 D	J	U	B	I	L	E	E	C	O	L	L	E	G	E	S	T	A	T	E	P	A	R	K	
15.0 D	V	I	S	I	T	O	R	S	U	S	E	J	U	B	I	L	E	E	R	O	A	D		
5.0 D	1	0	0	0	F	E	E	T	A	H	E	A	D											

DETAILS SIGN 002

SIGN DETAIL

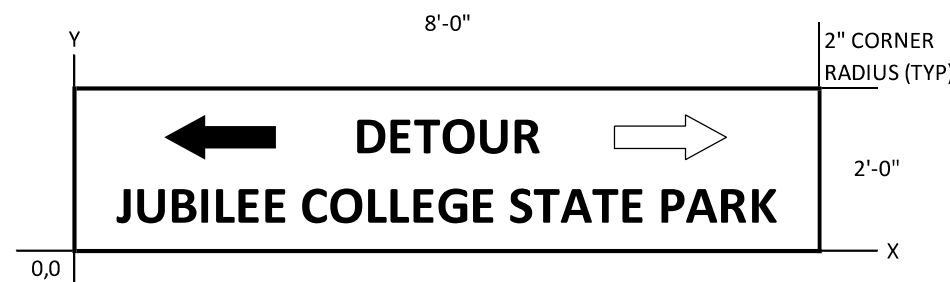

SIGN NUMBER	SIGN 003
WIDTH x HEIGHT	96.0" x 36.0"
BORDER WIDTH	0.8"
CORNER RADIUS	2.0"
MOUNTING	OVERHEAD
BACKGROUND	TYPE: REFLECTIVE COLOR: ORANGE
LEGEND/BORDER	TYPE: REFLECTIVE COLOR: BLACK

SYMBOL	X	Y	WID	HT


SIGN "3A" ARROW LEFT ONLY

SIGN "3B" ARROW RIGHT ONLY

DIMENSIONS IN INCHES

COORDINATES TO LOWER LEFT CORNERS

SIGN DETAIL

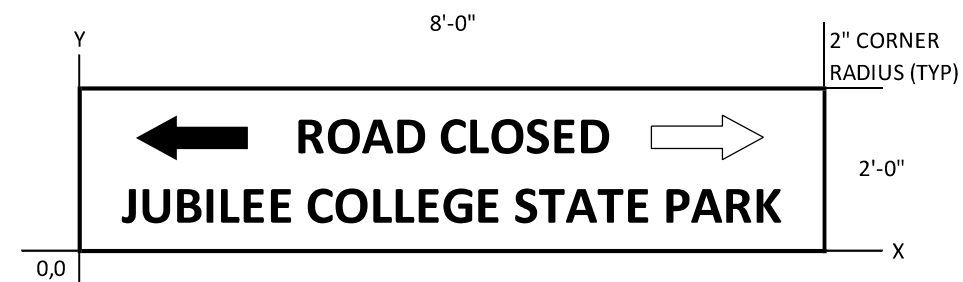

SIGN NUMBER	SIGN 004
WIDTH x HEIGHT	96.0" x 36.0"
BORDER WIDTH	0.8"
CORNER RADIUS	2.0"
MOUNTING	OVERHEAD
BACKGROUND	TYPE: REFLECTIVE COLOR: ORANGE
LEGEND/BORDER	TYPE: REFLECTIVE COLOR: BLACK

SYMBOL	X	Y	WID	HT

SIGN "4A" ARROW LEFT ONLY

SIGN "4B" ARROW RIGHT ONLY

DIMENSIONS IN INCHES

COORDINATES TO LOWER LEFT CORNERS

Y FONT	LETTER POSITIONS (X)																		WT LEN					
25.0 D	D	E	T	O	U	R																		
15.0 D	J	U	B	I	L	E	E	C	O	L	L	E	G	E	S	T	A	T	E	P	A	R	K	

DETAILS SIGN 003


Y FONT	LETTER POSITIONS (X)																		WT LEN					
25.0 D	R	O	A	D	C	L	O	S	E	D														
15.0 D	J	U	B	I	L	E	E	C	O	L	L	E	G	E	S	T	A	T	E	P	A	R	K	

DETAILS SIGN 004

DATE	
BY	
SURVEYED	
PLOTTED	
TEMPLATE	
AREAS CHECKED	
FINAL SURVEY NO.	
NOTE BOOK NO.	
AREAS CHECKED	

DATE	
BY	
SURVEYED	
PLOTTED	
TEMPLATE	
AREAS CHECKED	
ORIGINAL SURVEY NO.	
NOTE BOOK NO.	
AREAS CHECKED	

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USER NAME = jbeque	DESIGNED - R.H.D.	REVISED -
	DRAWN - J.E.B.	REVISED -
PLOT SCALE = 20.0000' / in.	CHECKED - R.H.D.	REVISED -
PLOT DATE = 4/7/2021	DATE - 04/02/21	REVISED -

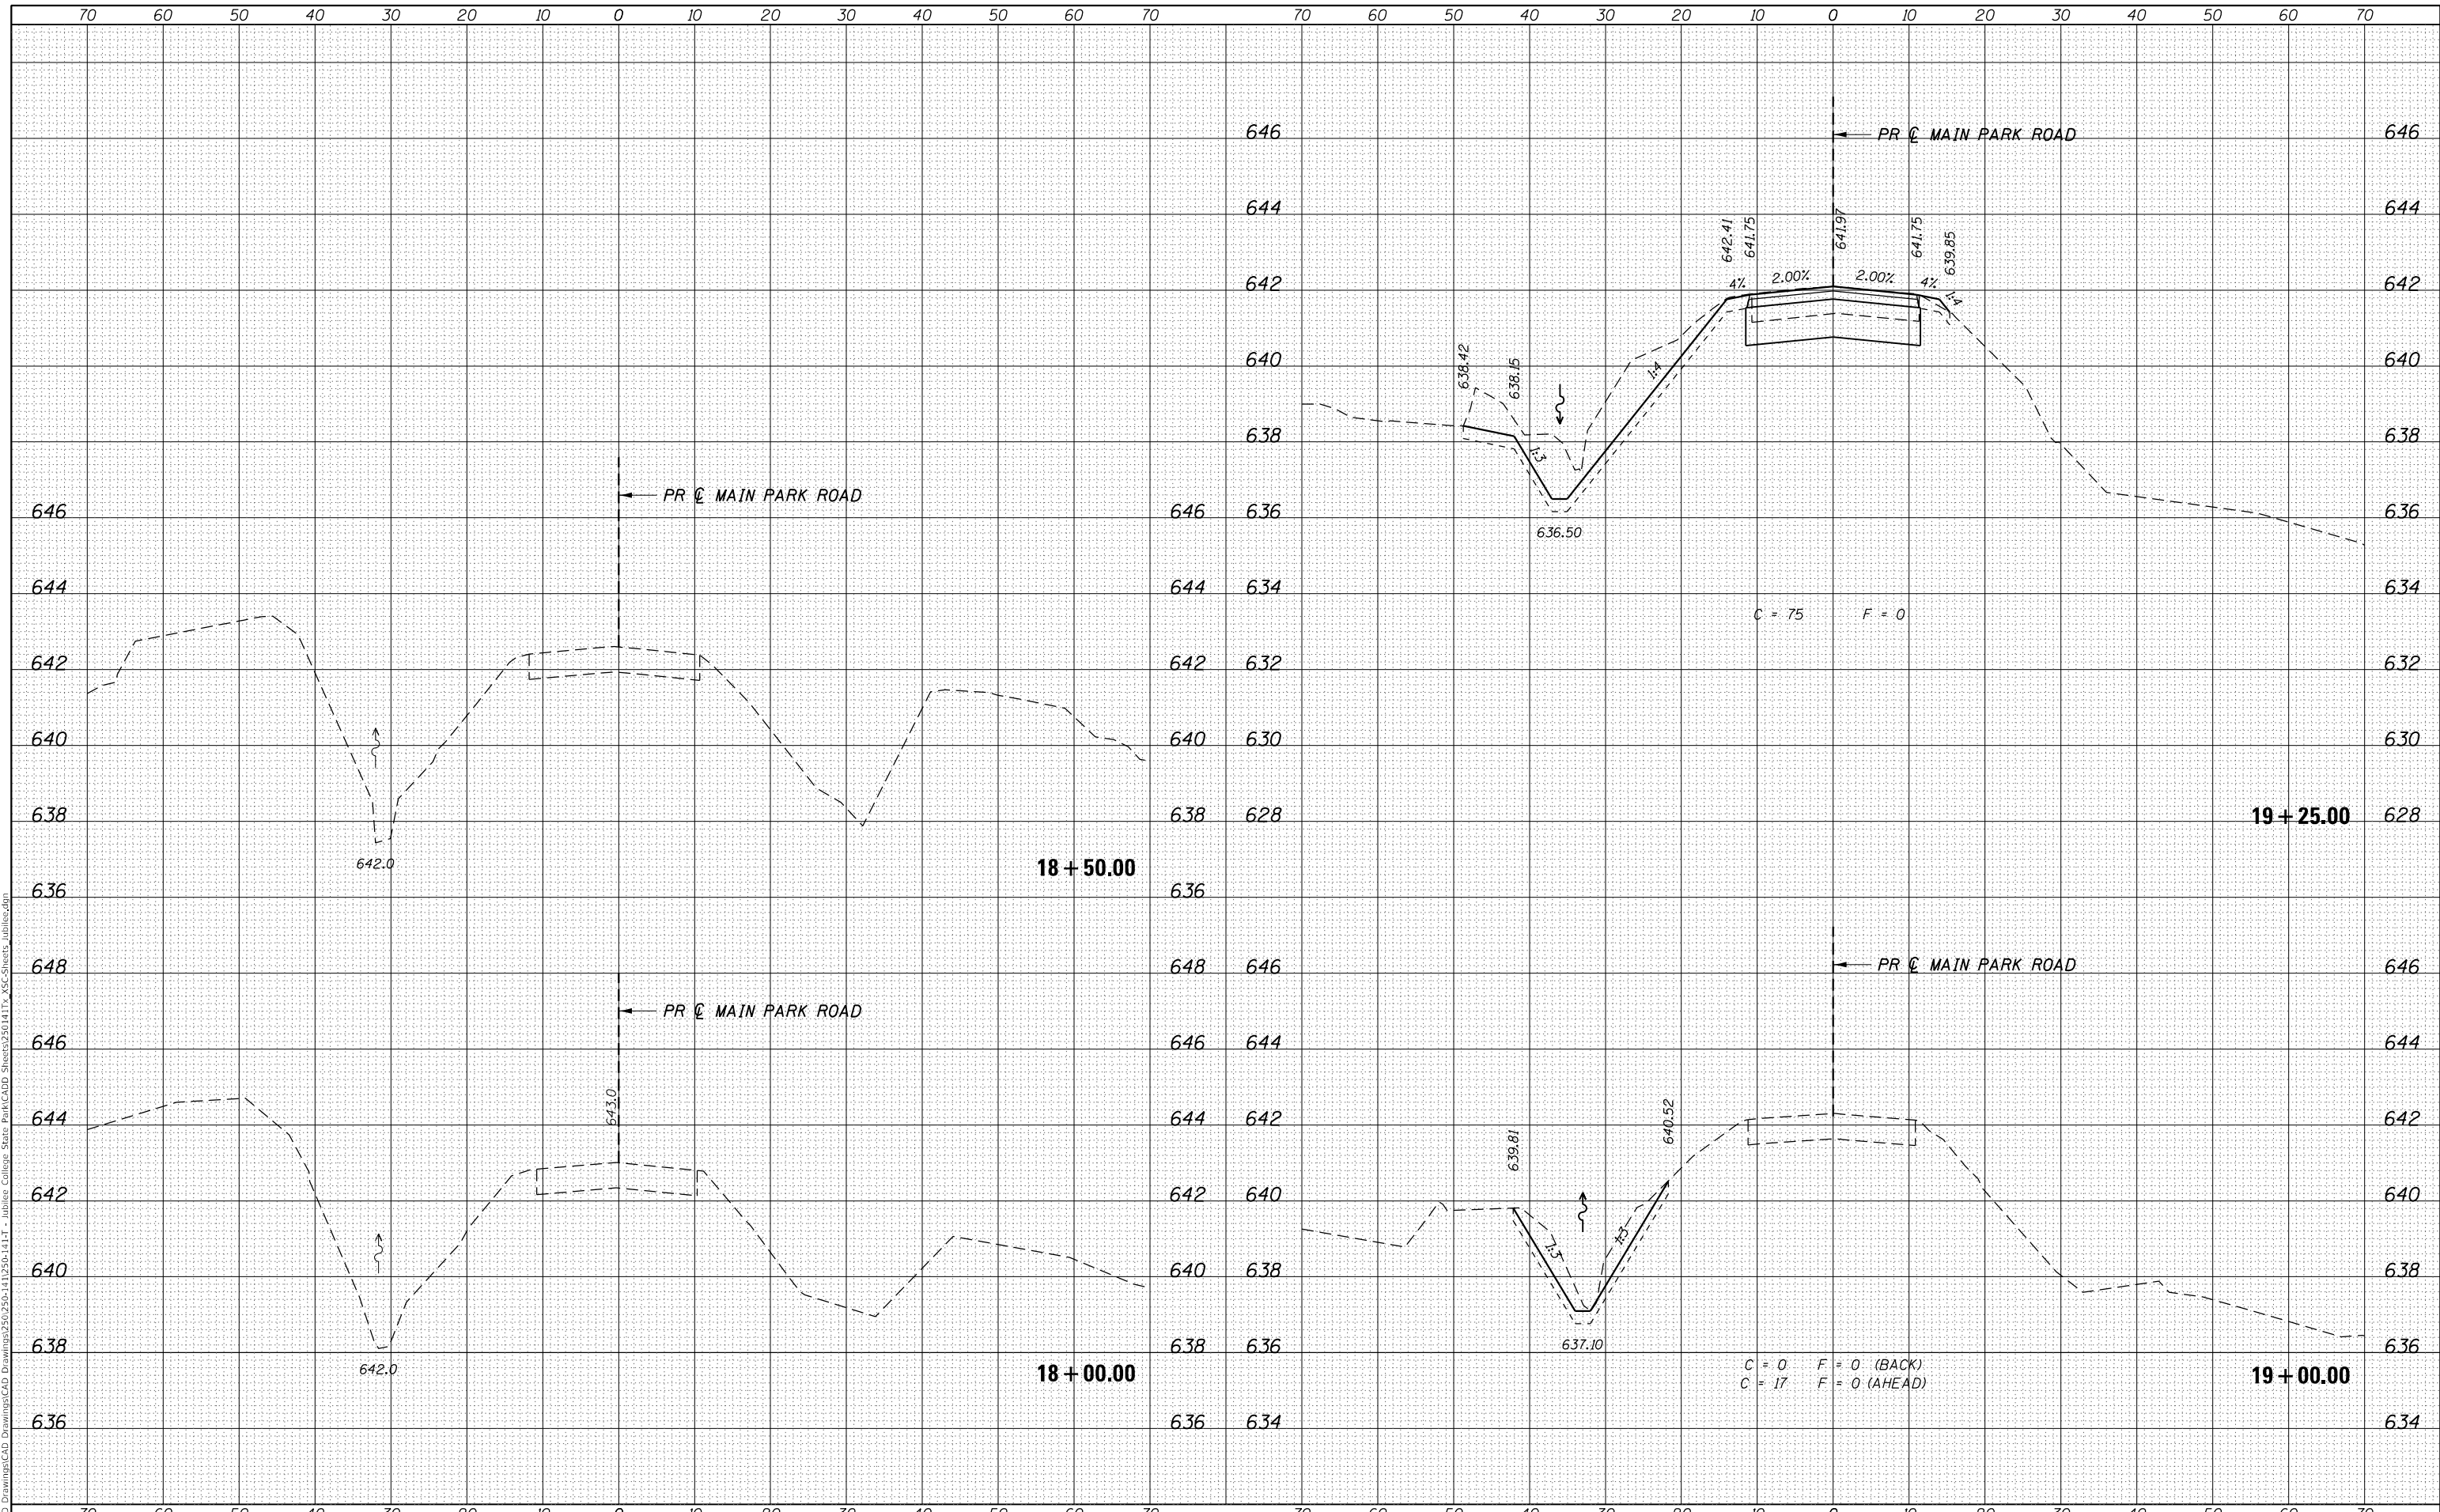**STATE OF ILLINOIS
DEPARTMENT OF TRANSPORTATION**


CROSS SECTIONS - MAIN PARK ROAD	
SCALE:	SHEET 1 OF 2 SHEETS
	STA. 18+00.00 TO STA. 19+25.00

F.A. RTE.	SECTION	COUNTY	TOTAL SHEETS	SHEET NO.
	JUBILEE COLLEGE 2021	PEORIA	24	16
			CONTRACT NO. 46926	
			ILLINOIS FED. AID PROJECT	

DATE	
BY	
FINAL SURVEY	SURVEYED
NOTE BOOK	PLOTTED
NO.	AREAS CHECKED

DATE	
BY	
ORIGINAL SURVEY	SURVEYED
NOTE BOOK	PLOTTED
NO.	AREAS CHECKED

MODEL: Default
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USER NAME	= jbeque
DESIGNED	- R.H.D.
DRAWN	- J.E.B.
CHECKED	- R.H.D.
DATE	- 04/02/21
REVISIONS	
REVISED	-
REVISED	-
REVISED	-
REVISED	-

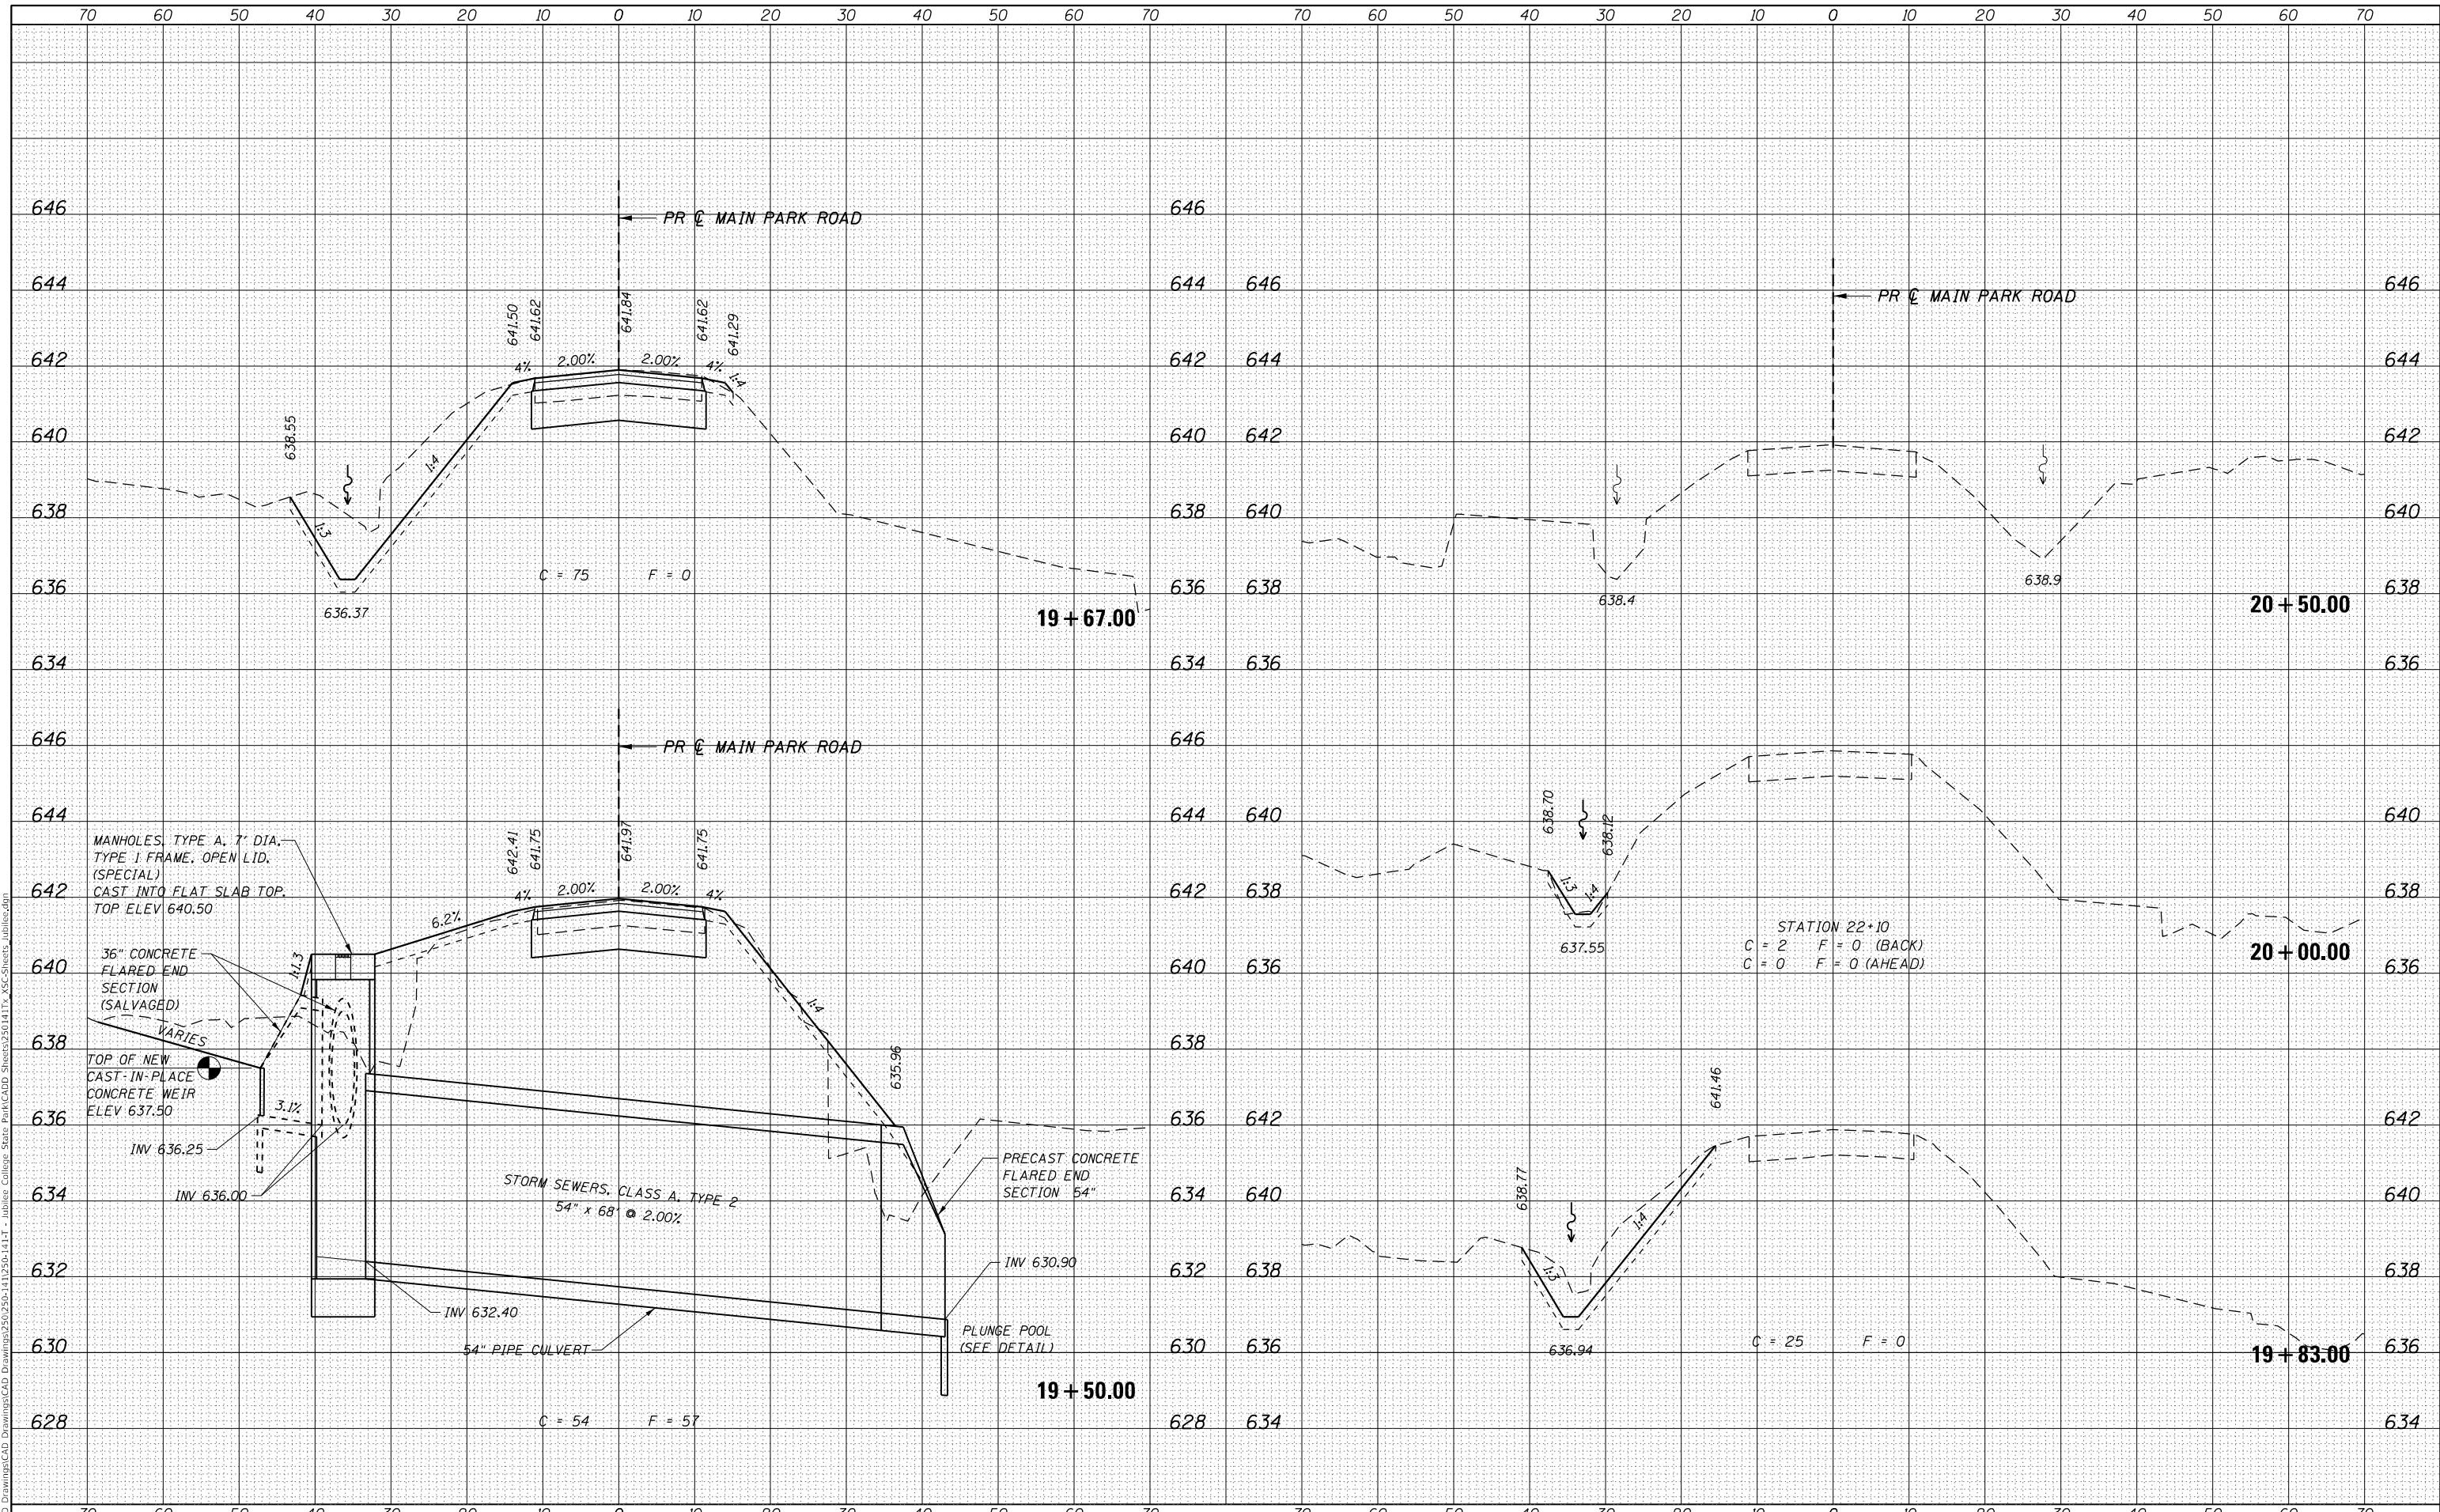STATE OF ILLINOIS
DEPARTMENT OF TRANSPORTATION


CROSS SECTIONS - MAIN PARK ROAD
SCALE: SHEET 2 OF 2 SHEETS STA. 19+50.00 TO STA. 20+50.00

F.A. RTE.	SECTION	COUNTY	TOTAL SHEETS	SHEET NO.
	JUBILEE COLLEGE 2021	PEORIA	24	17
			CONTRACT NO. 46926	
ILLINOIS FED. AID PROJECT				

FINAL SURVEY NO.	SURVEYED PLOTTED	DATE
	NOTE BOOK	
	TEMPLATE	
	AREAS CHECKED	

ORIGINAL SURVEY NO.	SURVEYED PLOTTED	DATE
	NOTE BOOK	
	TEMPLATE	
	AREAS CHECKED	

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USER NAME = jbeque	DESIGNED - R.H.D.	REVISED -
	DRAWN - J.E.B.	REVISED -
PLOT SCALE = 20.0000' / in.	CHECKED - R.H.D.	REVISED -
PLOT DATE = 4/7/2021	DATE - 04/02/21	REVISED -

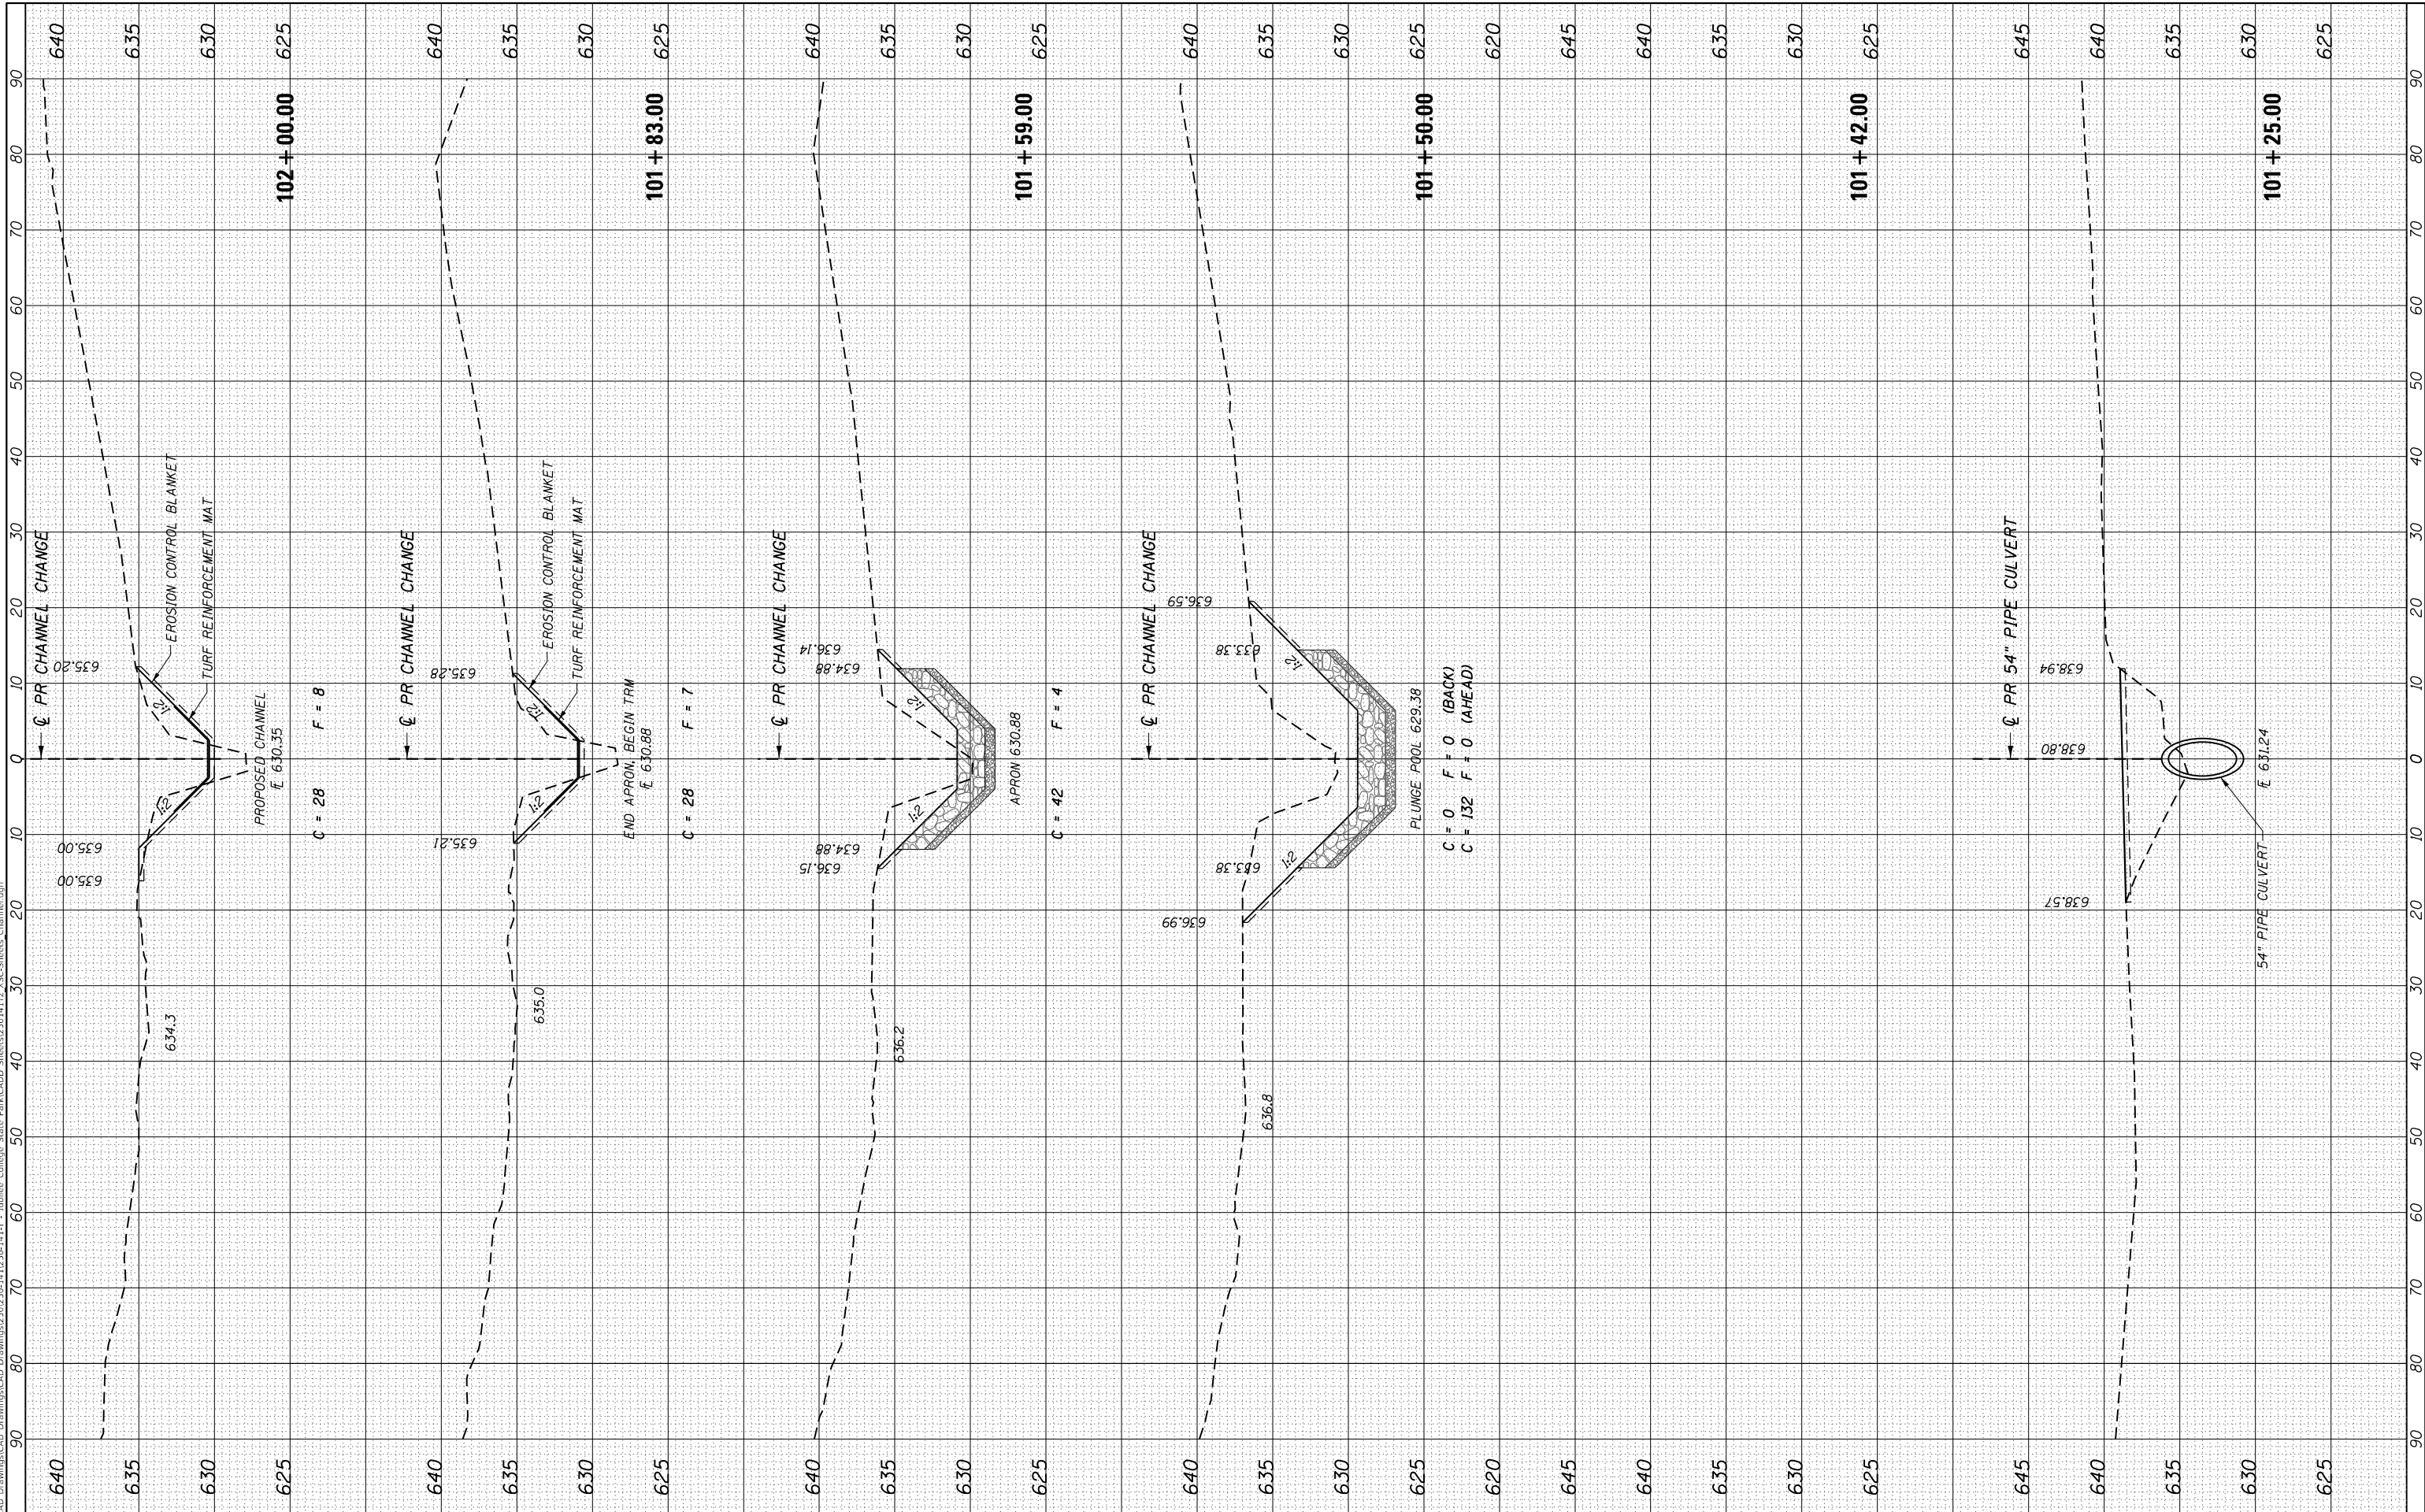**STATE OF ILLINOIS
DEPARTMENT OF TRANSPORTATION**


CROSS SECTIONS - CHANNEL CHANGE	
SCALE:	SHEET 2 OF 7 SHEETS STA. 101+25.00 TO STA. 102+00.00

F.A. RTE.	SECTION	COUNTY	TOTAL SHEETS	SHEET NO.
	JUBILEE COLLEGE 2021	PEORIA	24	19
			CONTRACT NO. 46926	
		ILLINOIS	FED. AID PROJECT	

FINAL SURVEY	SURVEYED	BY	DATE
NOTE BOOK	PLOTTED		
AREAS CHECKED	TEMPLATE		
NO.	AREAS CHECKED		

ORIGINAL SURVEY	SURVEYED	BY	DATE
NOTE BOOK	PLOTTED		
AREAS CHECKED	TEMPLATE		
NO.	AREAS CHECKED		

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USER NAME = jbeque	DESIGNED - R.H.D.	REVISED -
	DRAWN - J.E.B.	REVISED -
PLOT SCALE = 20.0000' / in.	CHECKED - R.H.D.	REVISED -
PLOT DATE = 4/7/2021	DATE - 04/02/21	REVISED -

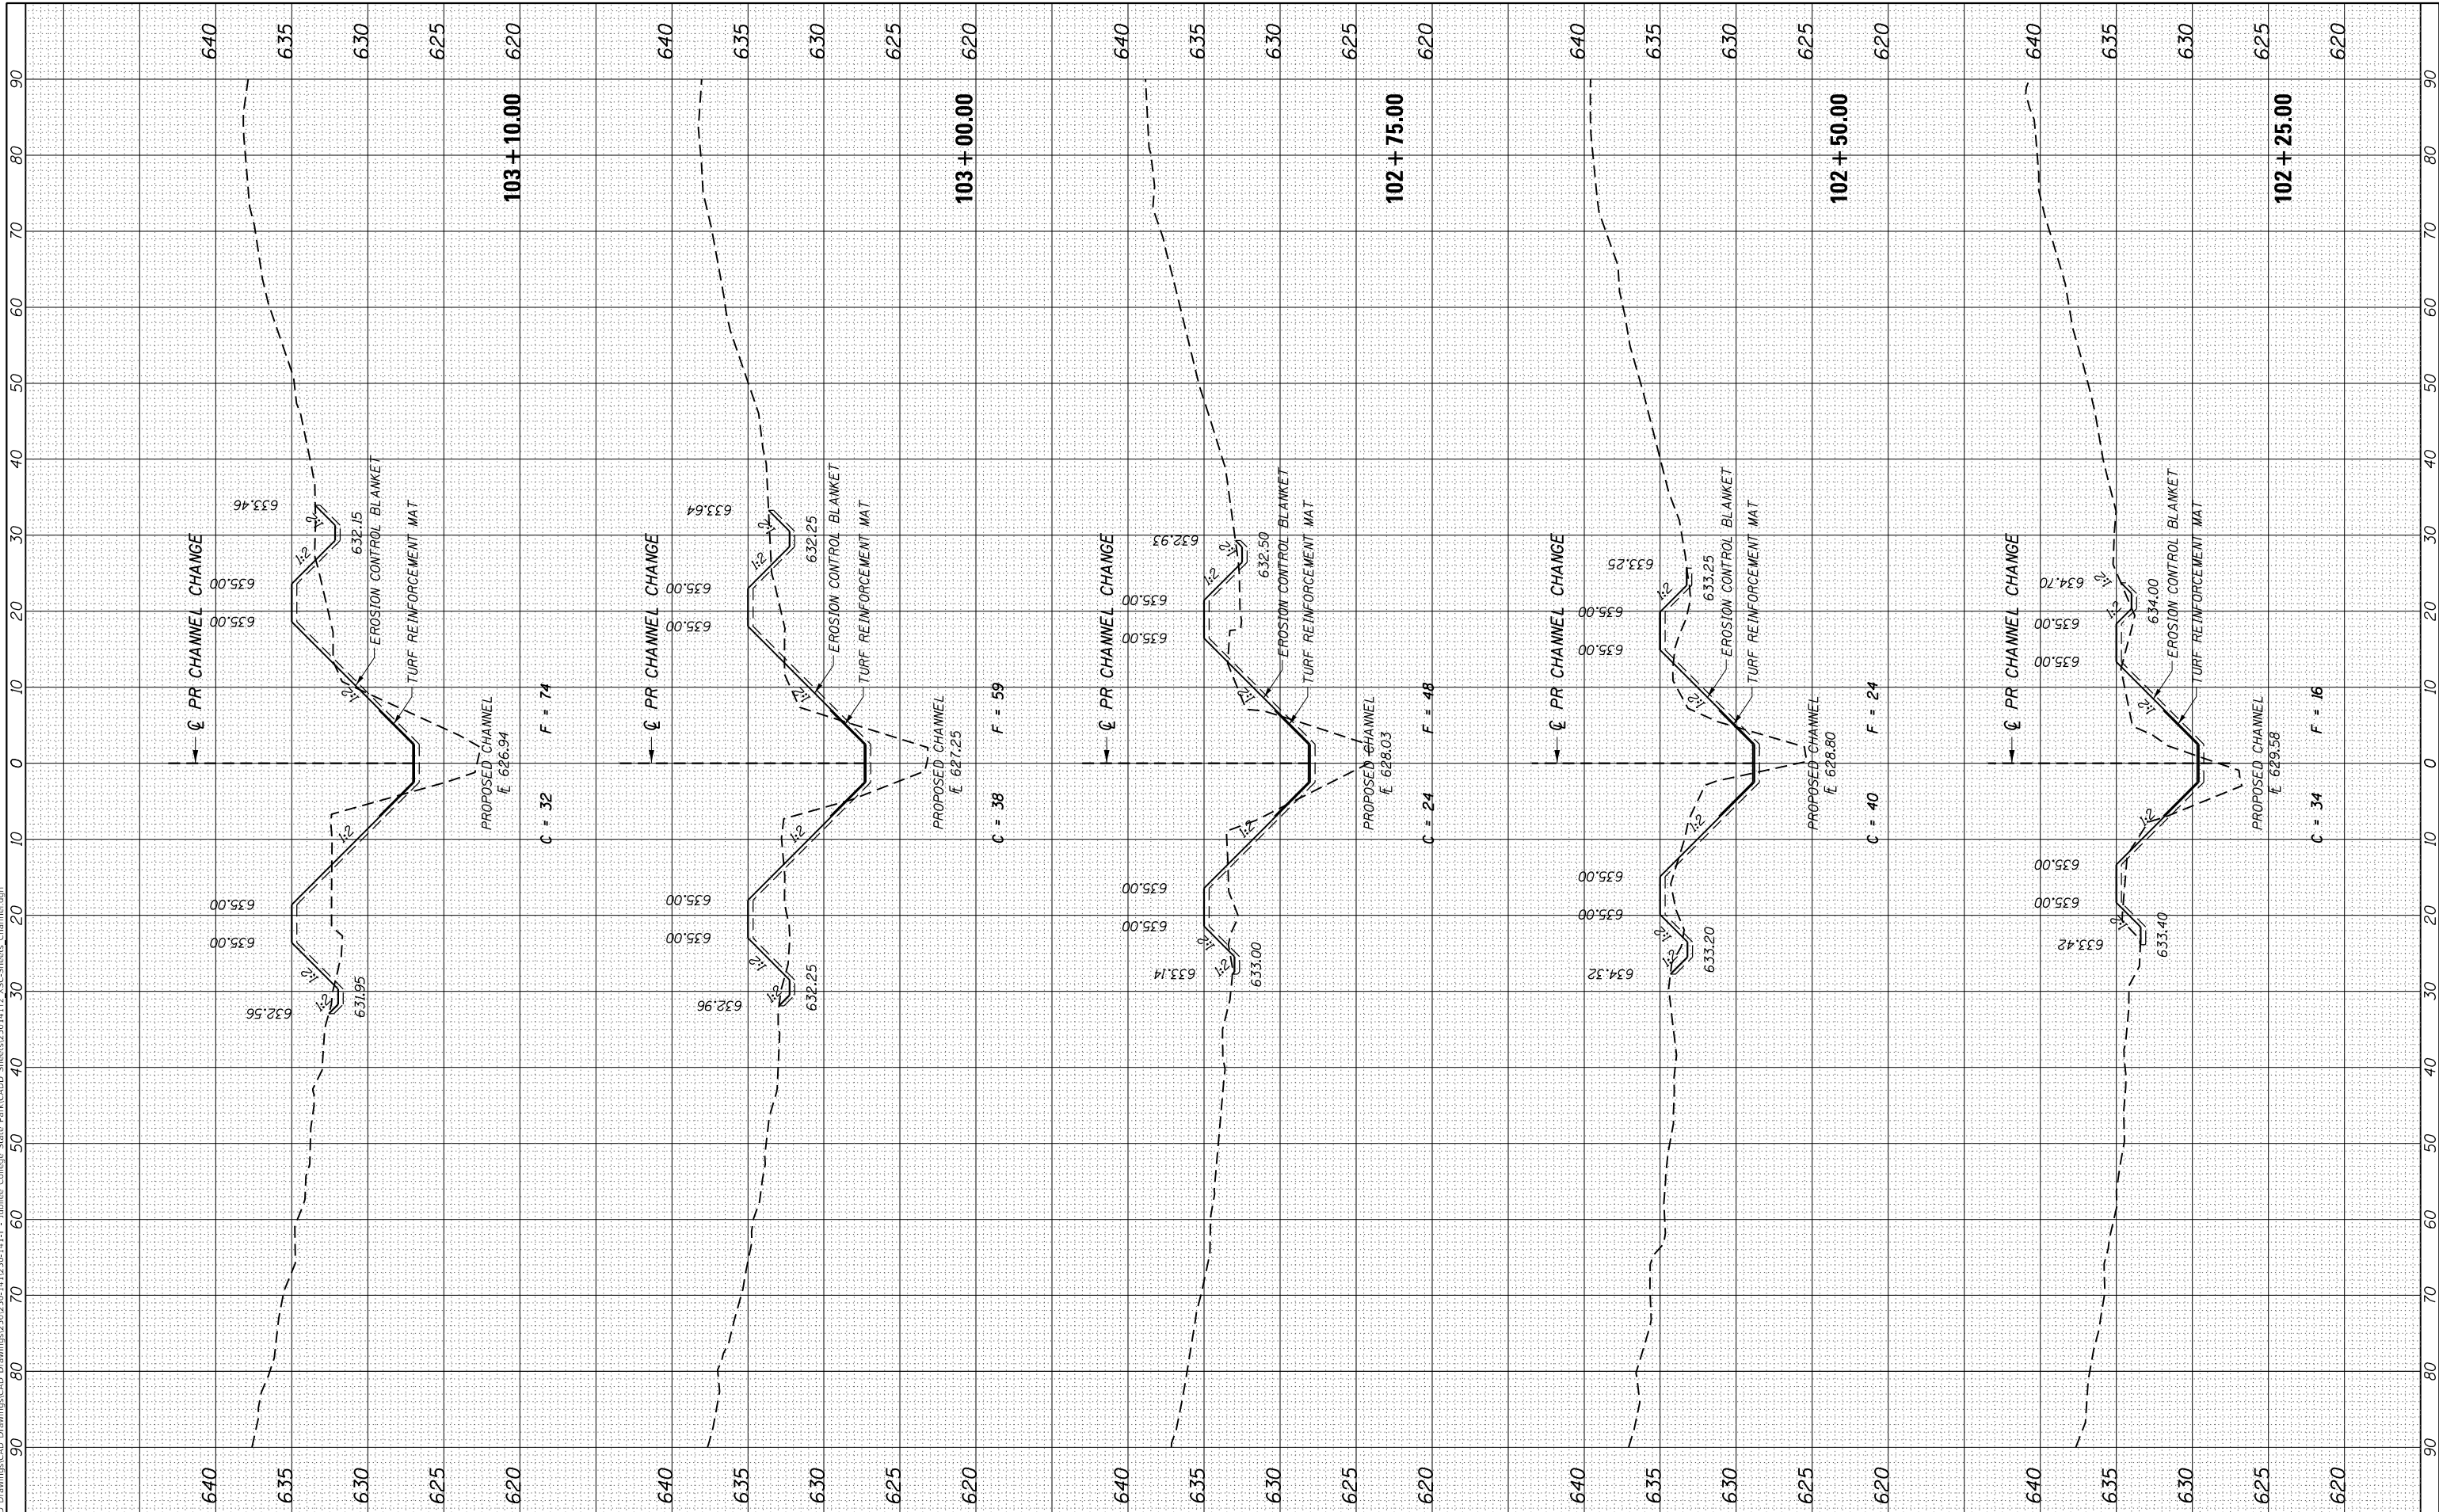**STATE OF ILLINOIS
DEPARTMENT OF TRANSPORTATION**


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SCALE:	SHEET 3 OF 7 SHEETS
	STA. 102+25.00 TO STA. 103+10.00

F.A. RTE.	SECTION	COUNTY	TOTAL SHEETS	SHEET NO.
	JUBILEE COLLEGE 2021	PEORIA	24	20
			CONTRACT NO. 46926	
	ILLINOIS	FED. AID PROJECT		

FINAL SURVEY	SURVEYED	BY	DATE
NOTE BOOK	PLOTTED		
AREAS CHECKED	TEMPLATE		
NO.	AREAS CHECKED		

ORIGINAL SURVEY	SURVEYED	BY	DATE
NOTE BOOK	PLOTTED		
AREAS CHECKED	TEMPLATE		
NO.	AREAS CHECKED		

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USER NAME = jbeque	DESIGNED - R.H.D.	REVISED -
	DRAWN - J.E.B.	REVISED -
PLOT SCALE = 20.0000' / in.	CHECKED - R.H.D.	REVISED -
PLOT DATE = 4/7/2021	DATE - 04/02/21	REVISED -

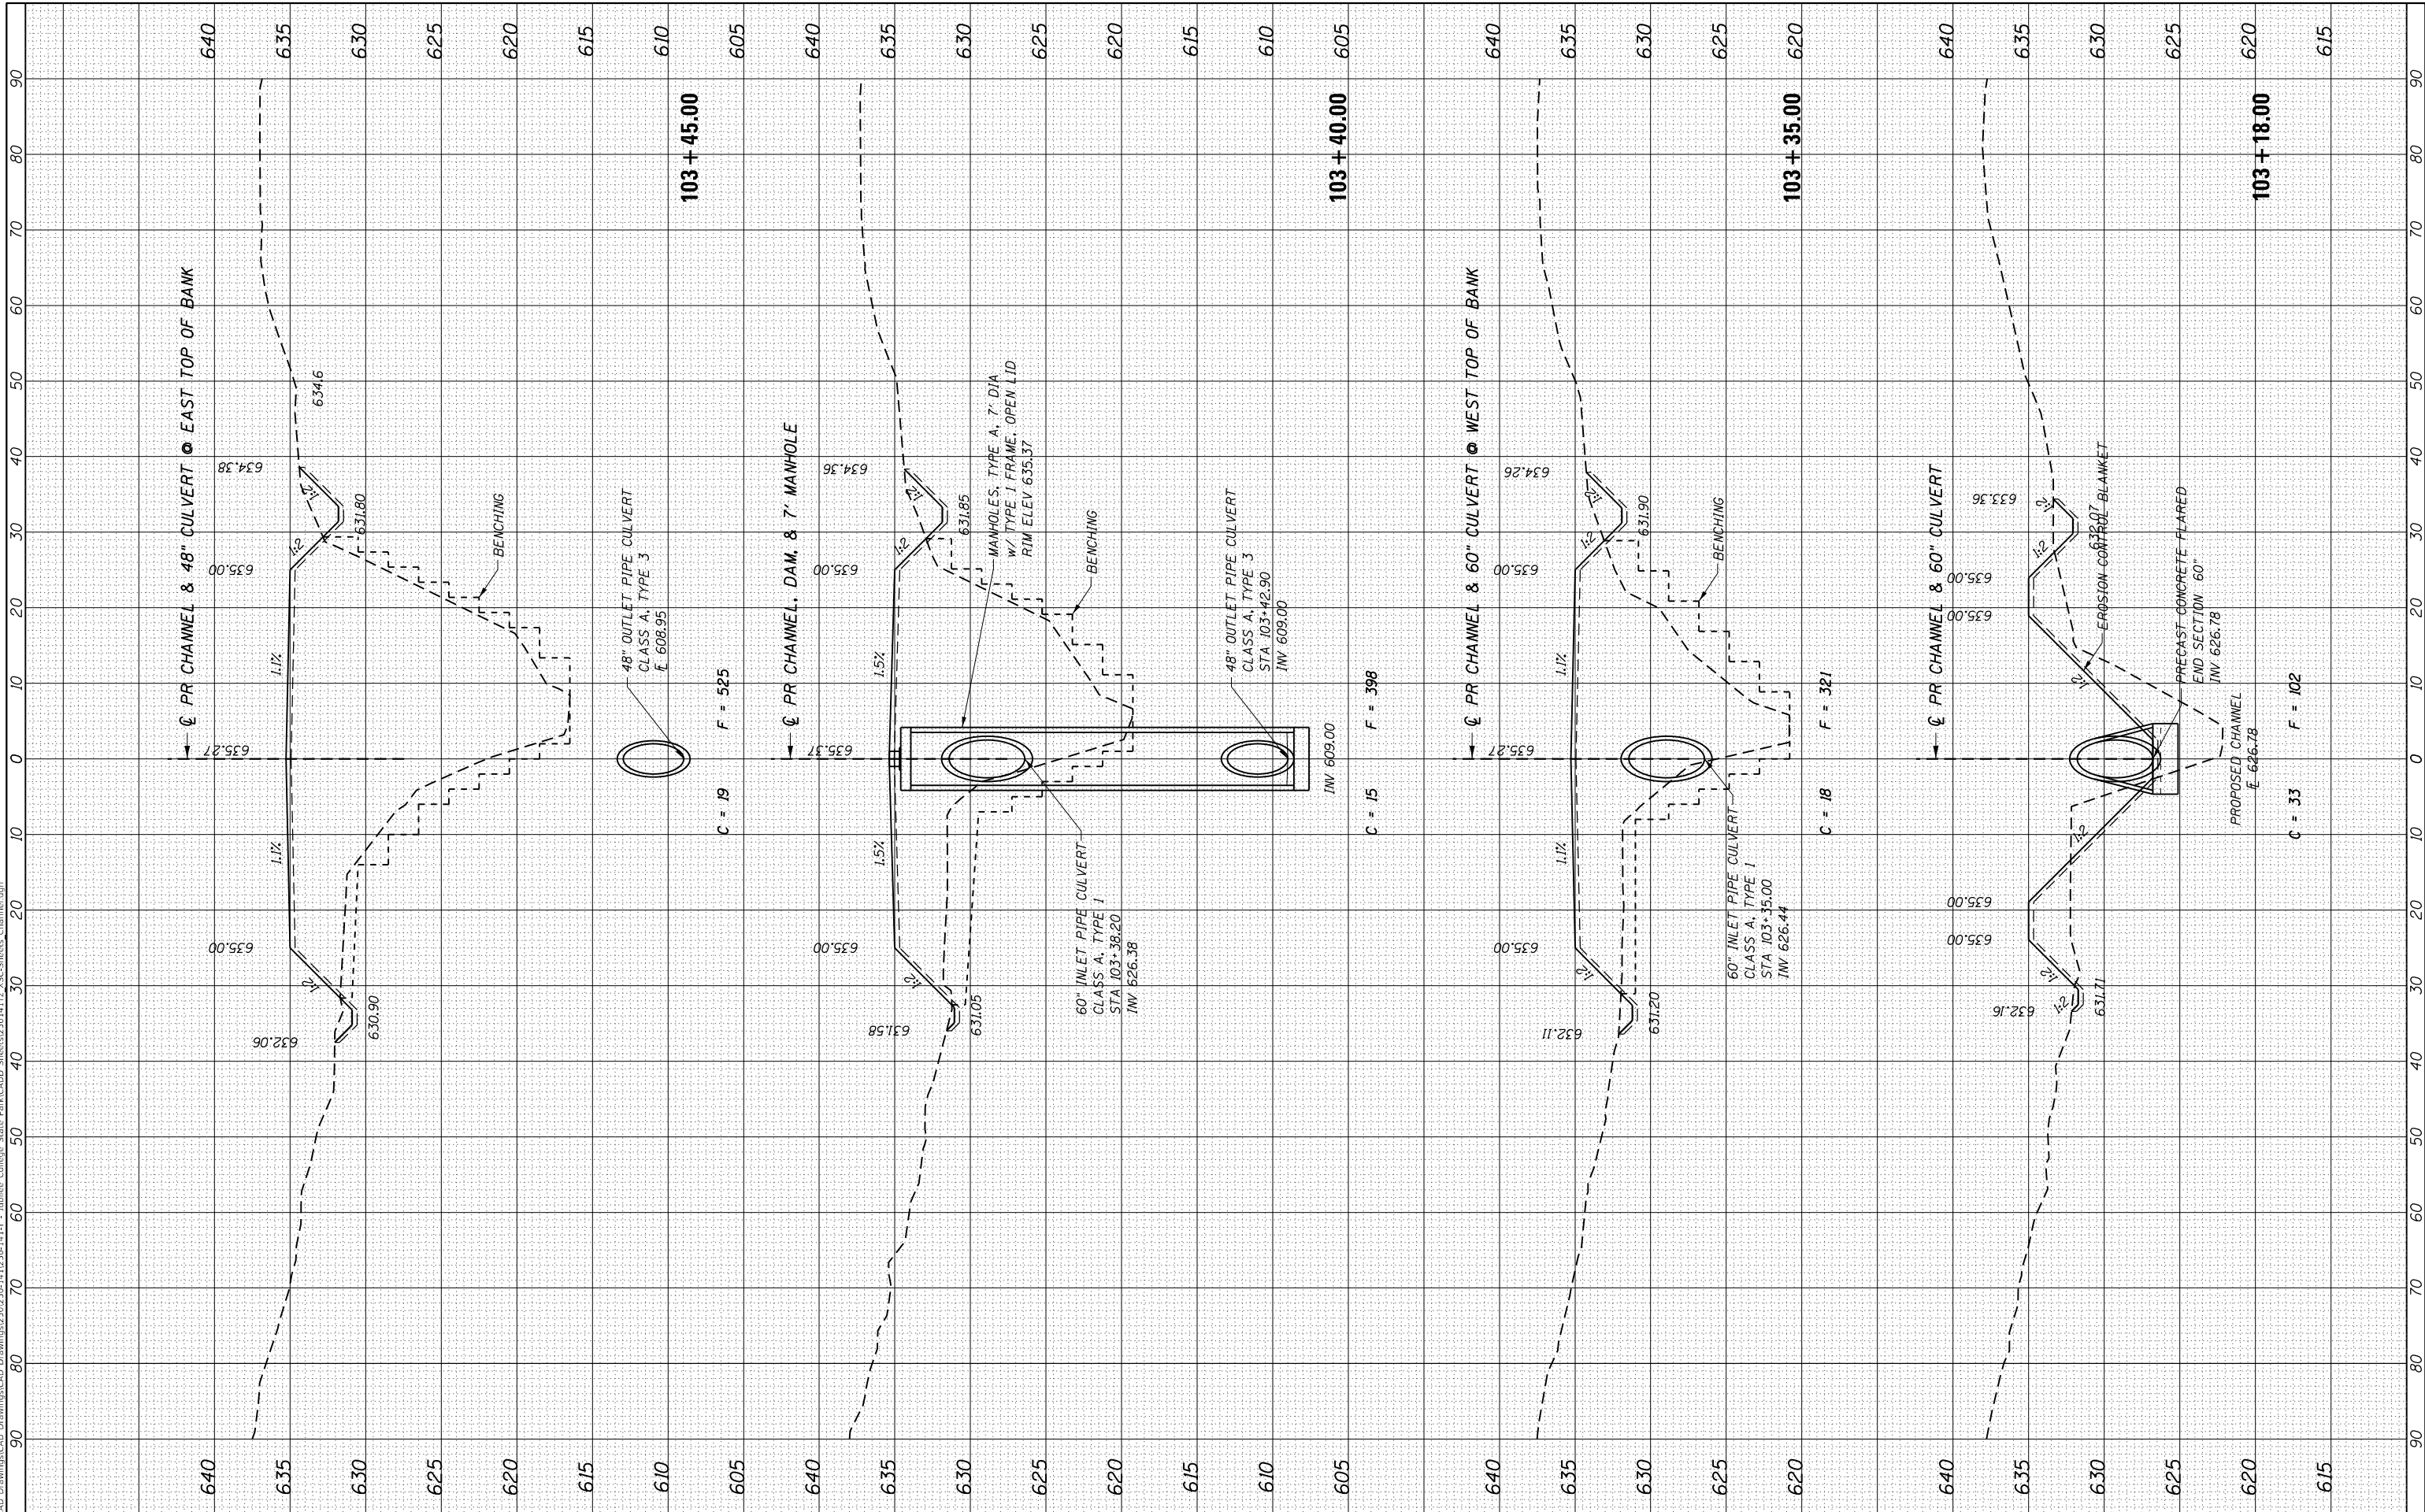**STATE OF ILLINOIS
DEPARTMENT OF TRANSPORTATION**


CROSS SECTIONS - CHANNEL CHANGE	
SCALE:	SHEET 4 OF 7 SHEETS
	STA. 103+18.00 TO STA. 103+45.00

F.A. RTE.	SECTION	COUNTY	TOTAL SHEETS	SHEET NO.
	JUBILEE COLLEGE 2021	PEORIA	24	21
			CONTRACT NO. 46926	
		ILLINOIS	FED. AID PROJECT	

FINAL SURVEY	SURVEYED	BY	DATE
NOTE BOOK	PLOTTED		
AREAS CHECKED	TEMPLATE		
NO.	AREAS CHECKED		

ORIGINAL SURVEY	SURVEYED	BY	DATE
NOTE BOOK	PLOTTED		
AREAS CHECKED	TEMPLATE		
NO.	AREAS CHECKED		

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	DRAWN - J.E.B.	REVISED -
PLOT SCALE = 20.0000' / in.	CHECKED - R.H.D.	REVISED -
PLOT DATE = 4/7/2021	DATE - 04/02/21	REVISED -

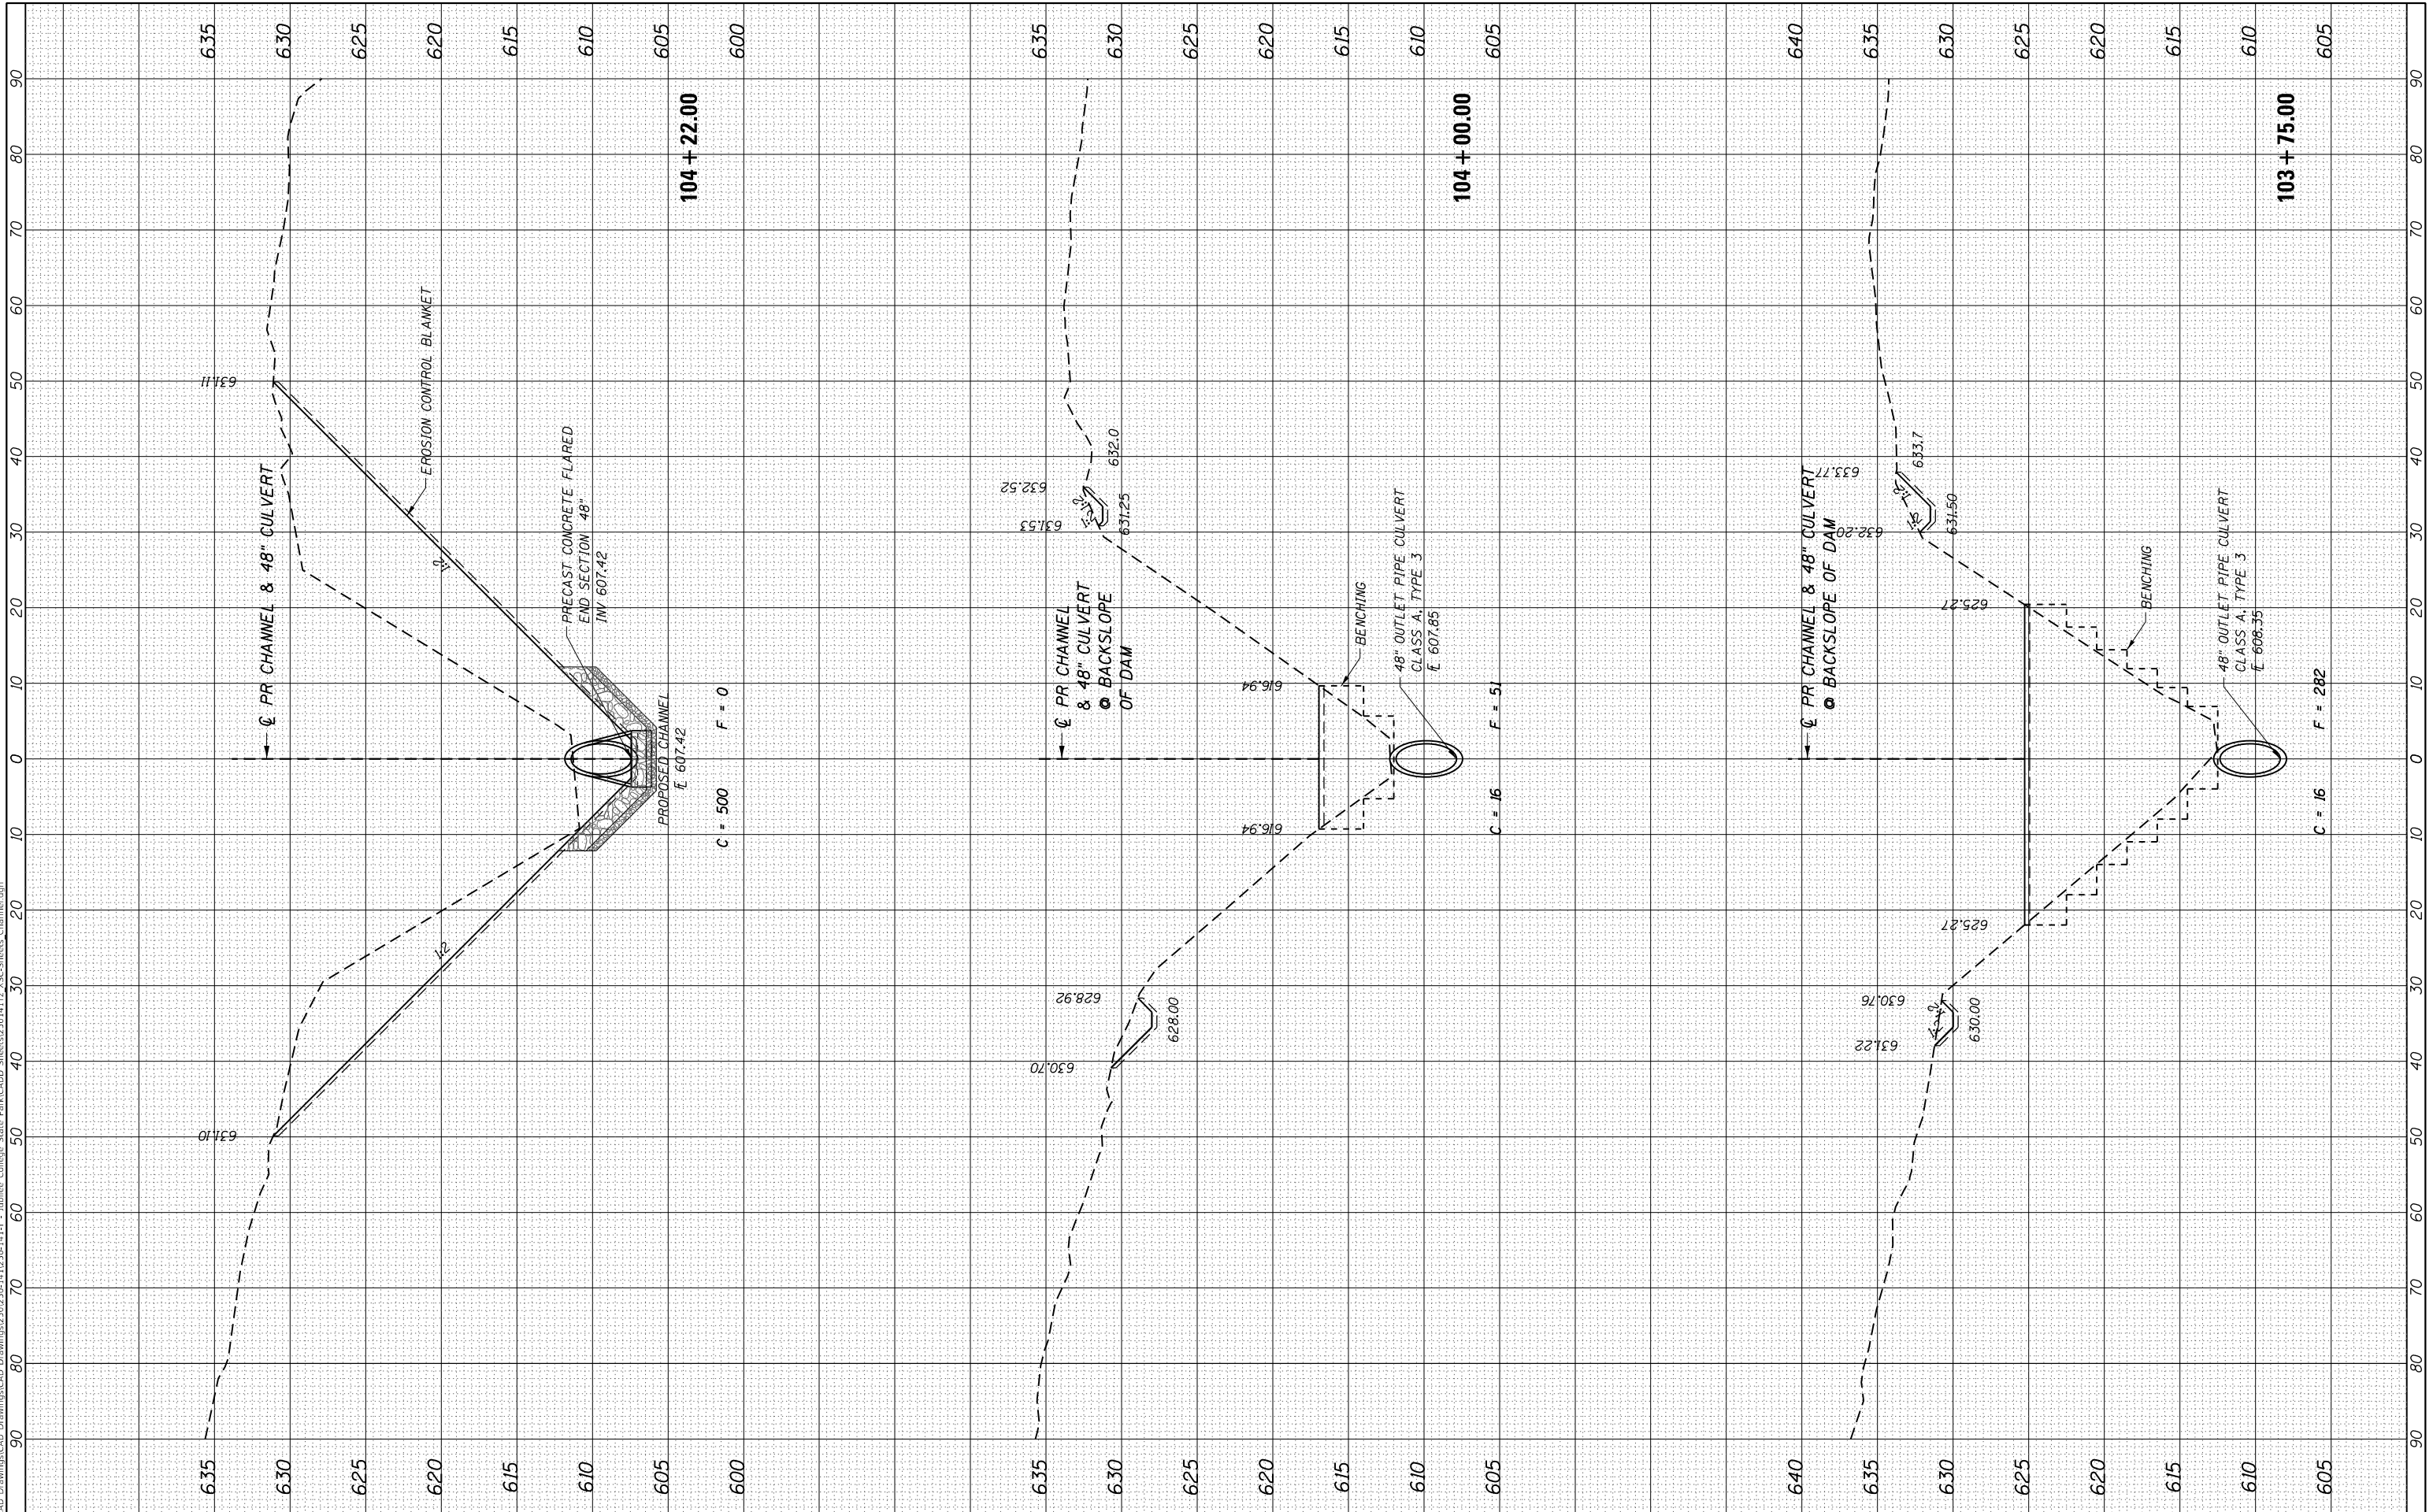STATE OF ILLINOIS
DEPARTMENT OF TRANSPORTATION

CROSS SECTIONS - CHANNEL CHANGE


SCALE: SHEET 5 OF 7 SHEETS STA. 103+75.00 TO STA. 104+22.00

F.A. RTE.	SECTION	COUNTY	TOTAL SHEETS	SHEET NO.
	JUBILEE COLLEGE 2021	PEORIA	24	22
			CONTRACT NO. 46926	
	ILLINOIS	FED. AID PROJECT		

FINAL SURVEY NO.	SURVEYED PLOTTED TEMPLATE AREAS CHECKED	BY	DATE

ORIGINAL SURVEY NO.	SURVEYED PLOTTED TEMPLATE AREAS CHECKED	BY	DATE

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PLOT DATE = 4/7/2021

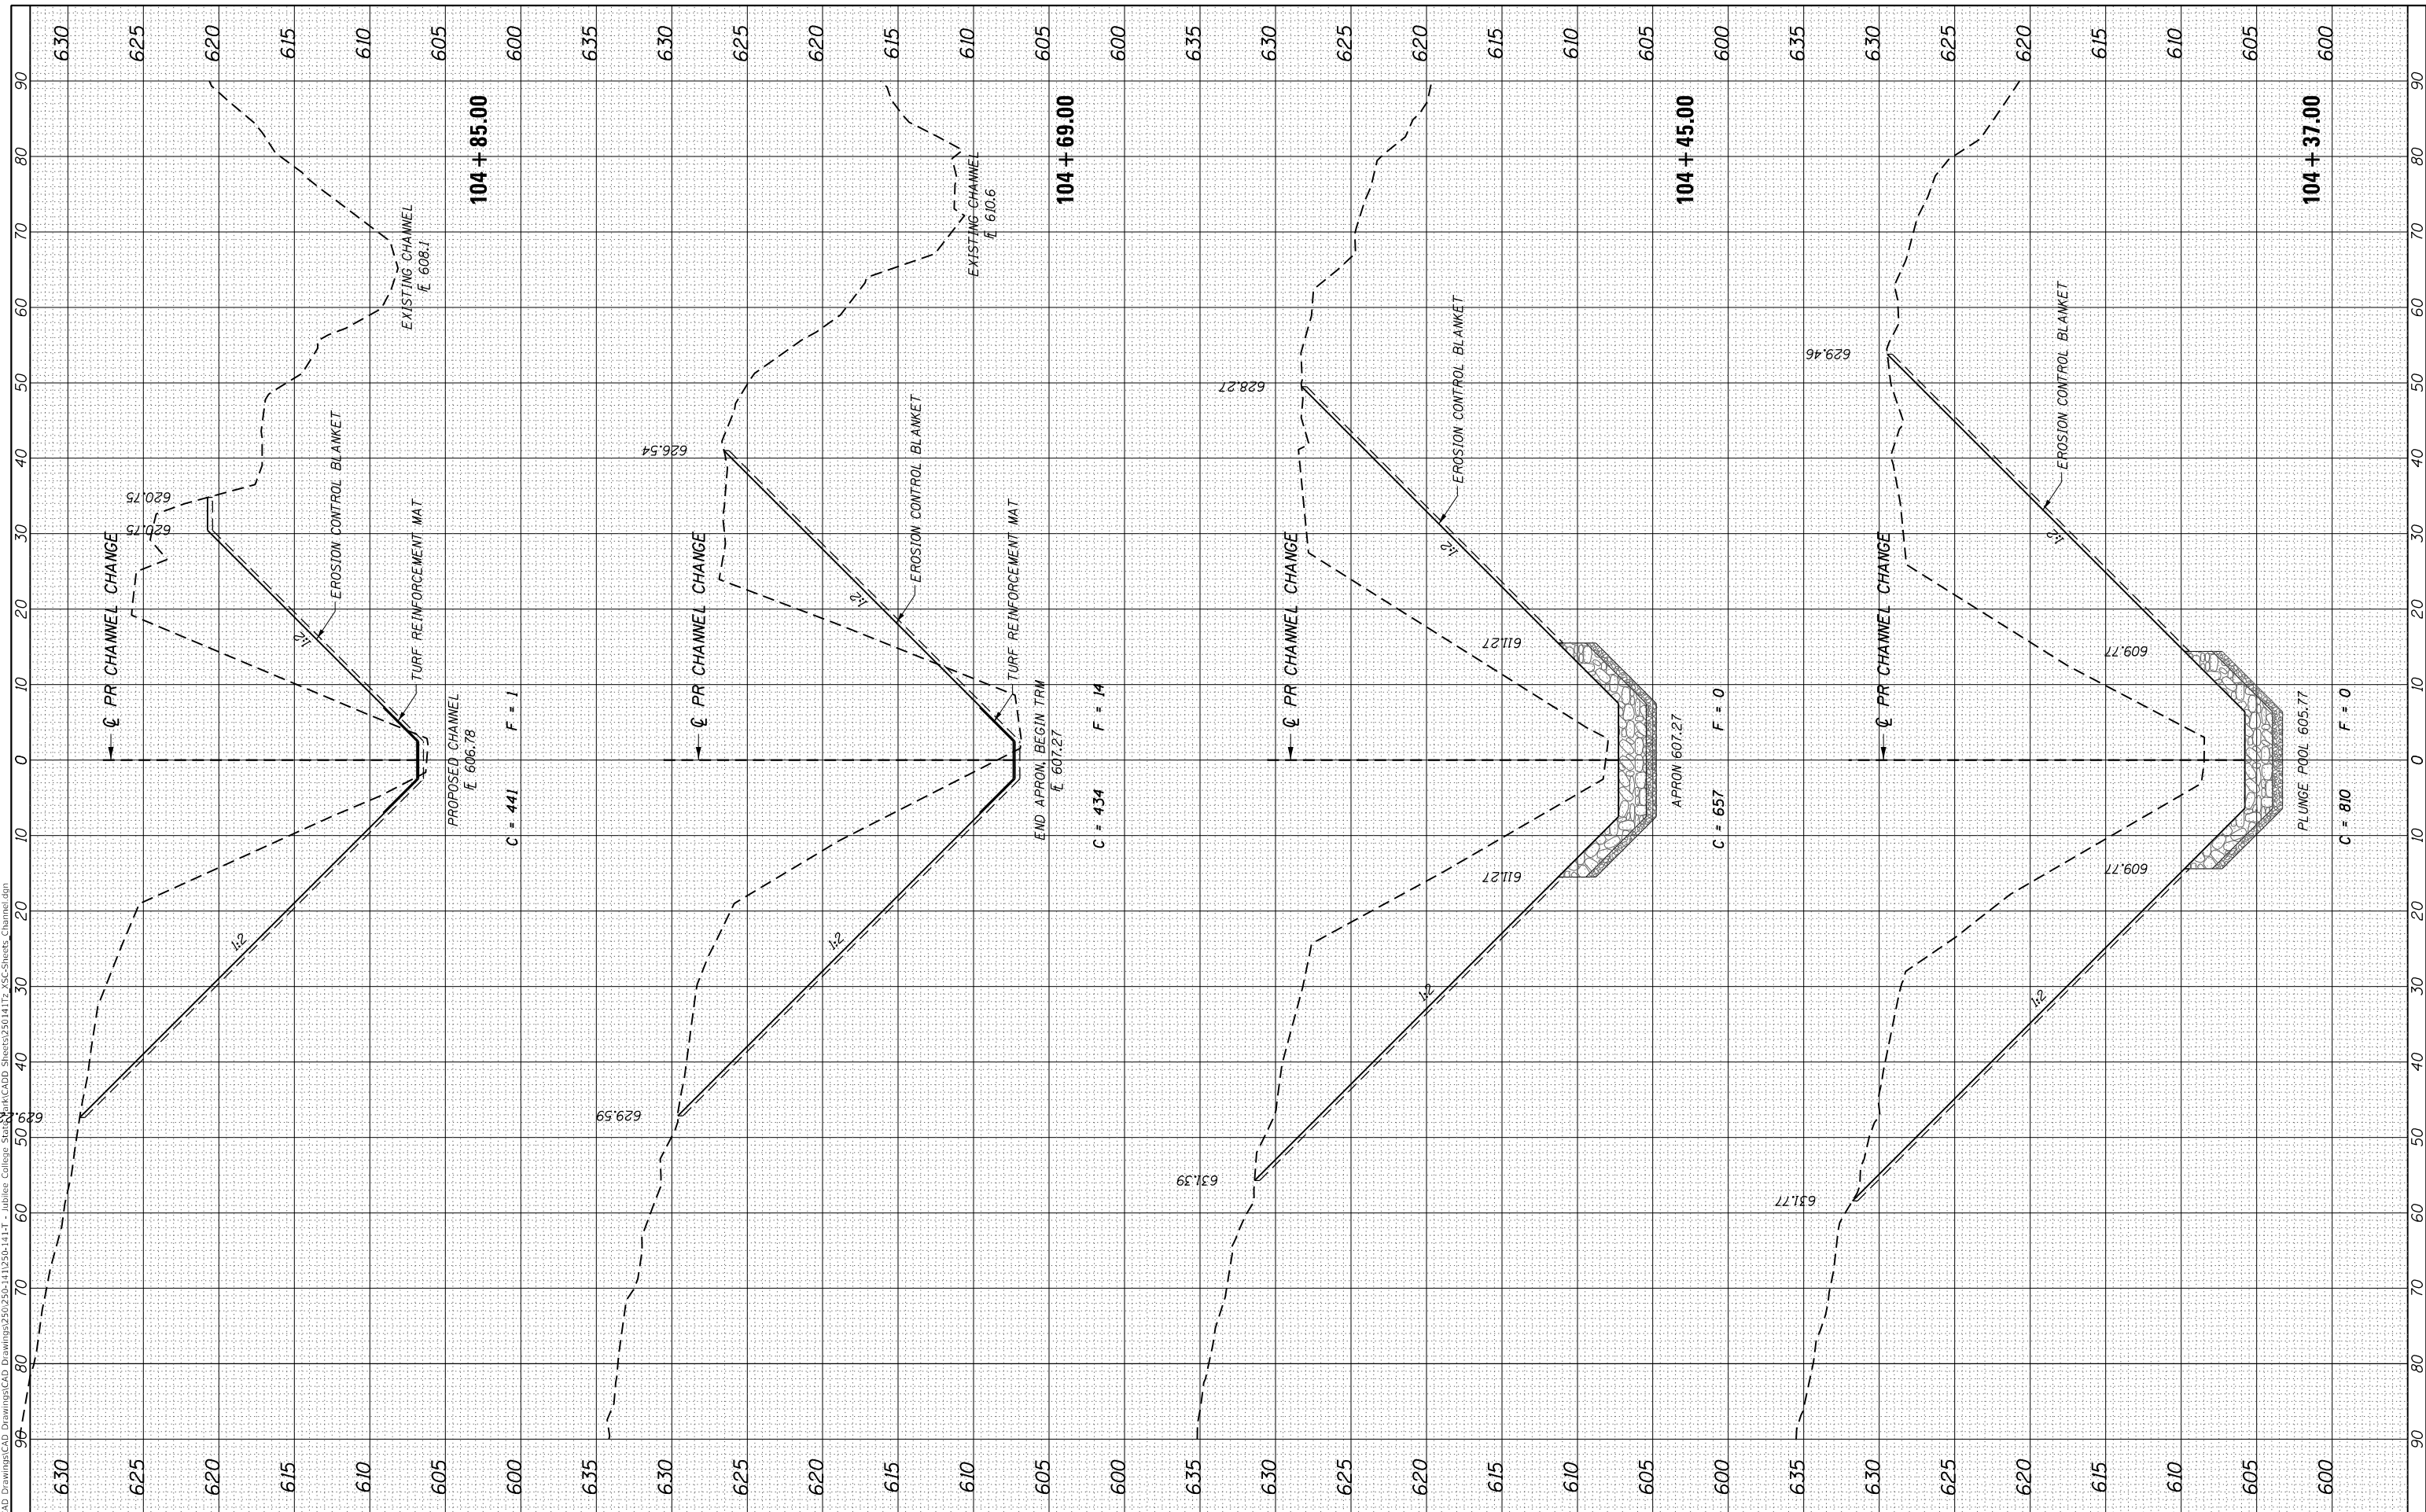

USER NAME = jbeque	DESIGNED - R.H.D.	REVISIONS
	DRAWN - J.E.B.	REVISIONS
	CHECKED - R.H.D.	REVISIONS
	DATE - 04/02/21	REVISIONS

**STATE OF ILLINOIS
DEPARTMENT OF TRANSPORTATION**

CROSS SECTIONS - CHANNEL CHANGE


SCALE: SHEET 6 OF 7 SHEETS STA. 104+37.00 TO STA. 104+85.00

F.A. RTE.	SECTION	COUNTY	TOTAL SHEETS	SHEET NO.
	JUBILEE COLLEGE 2021	PEORIA	24	23
			CONTRACT NO. 46926	
		ILLINOIS	FED. AID PROJECT	

FINAL SURVEY	SURVEYED	BY	DATE
NOTE BOOK	PLOTTED		
NO.	TEMPLATE		
	AREAS CHECKED		

ORIGINAL SURVEY	SURVEYED	BY	DATE
NOTE BOOK	PLOTTED		
NO.	TEMPLATE		
	AREAS CHECKED		

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USER NAME = jbeque	DESIGNED - R.H.D.	REVISED -
	DRAWN - J.E.B.	REVISED -
PLOT SCALE = 20.0000' / in.	CHECKED - R.H.D.	REVISED -
PLOT DATE = 4/7/2021	DATE - 04/02/21	REVISED -

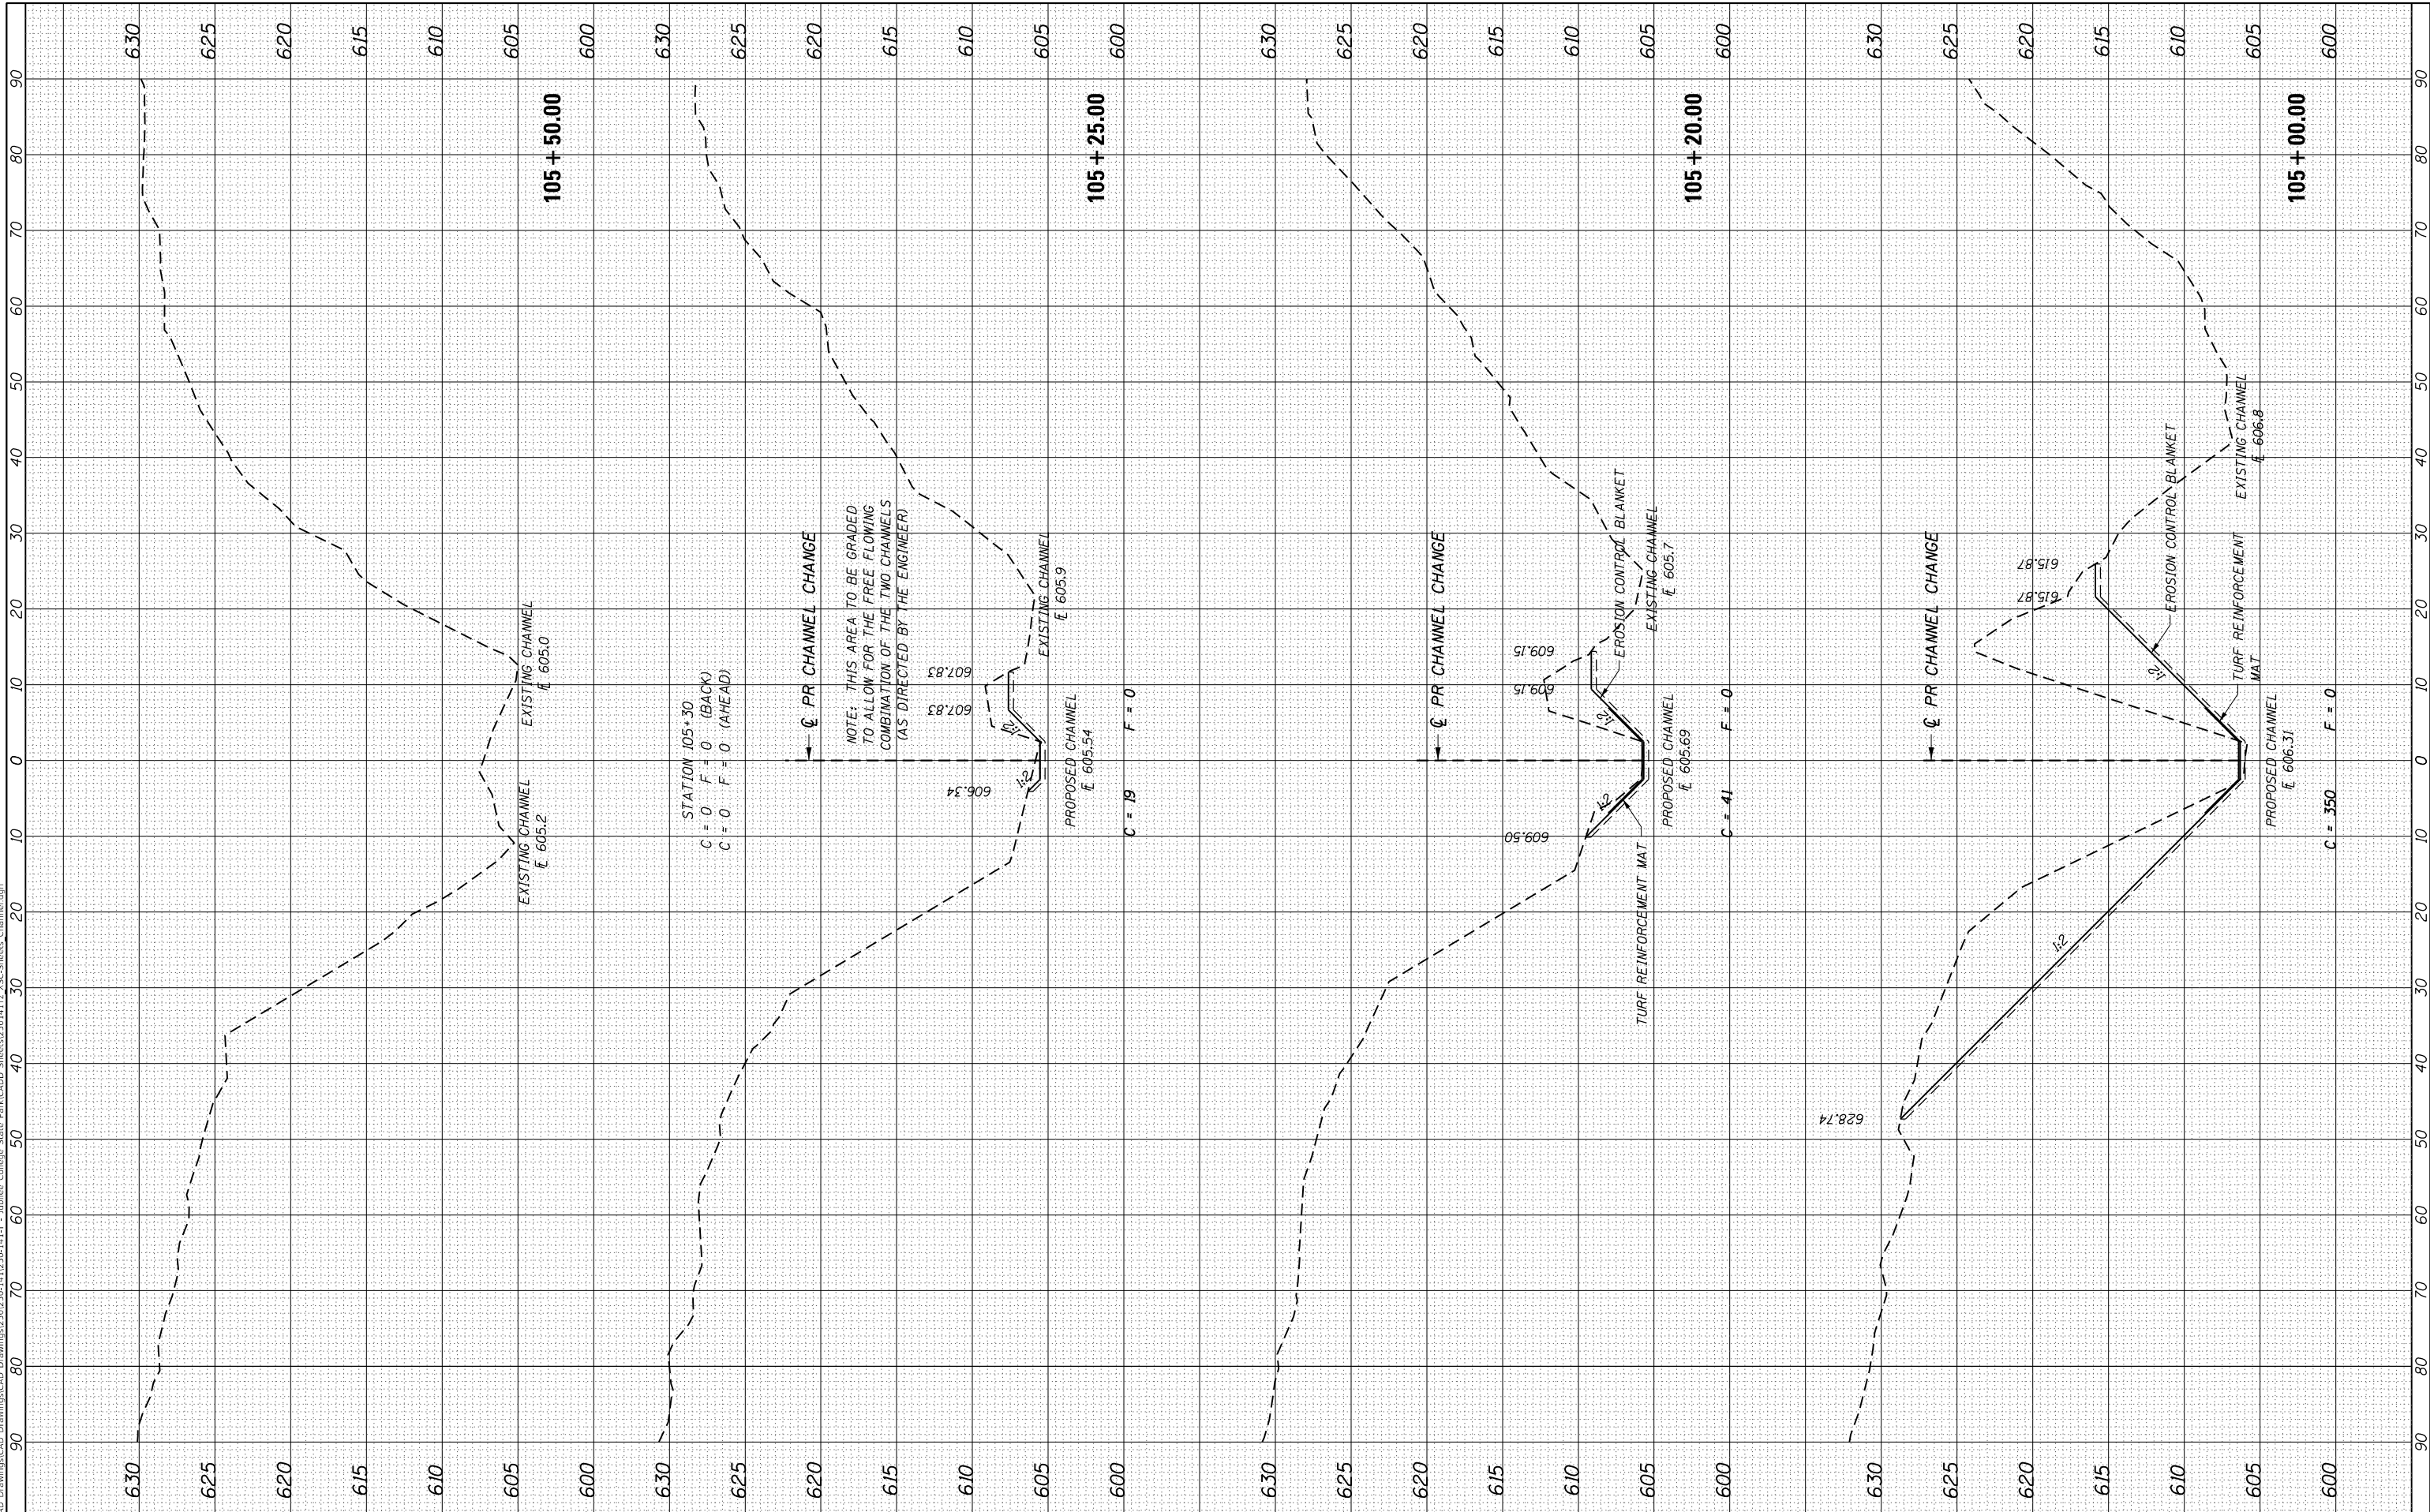**STATE OF ILLINOIS
DEPARTMENT OF TRANSPORTATION**

CROSS SECTIONS - CHANNEL CHANGE

SCALE: SHEET 7 OF 7 SHEETS STA. 105+00.00 TO STA. 105+50.00

F.A. RTE.	SECTION	COUNTY	TOTAL SHEETS	SHEET NO.
	JUBILEE COLLEGE 2021	PEORIA	24	24
			CONTRACT NO. 46926	
	ILLINOIS	FED. AID PROJECT		