06-12-2015 LETTING ITEM 029

STATE OF ILLINOIS DEPARTMENT OF TRANSPORTATION DIVISION OF HIGHWAYS

PLANS FOR PROPOSED FEDERAL AID HIGHWAY

FAU 1713 (CALIFORNIA AVENUE)

167TH STREET TO SUSSEX COURT RESURFACING SECTION No. 14-00045-00-RS PROJECT No. M-4003(486)


CITY OF MARKHAM

COOK COUNTY

C-91-217-15

FOR INDEX OF HIGHWAY STANDARDS AND INDEX OF SHEETS SEE SHEET NO. 2

CALIFORNIA AVENUE URBAN MAJOR COLLECTOR ADT= 2,560 (2014)
POSTED SPEED LIMIT=20 M.P.H.

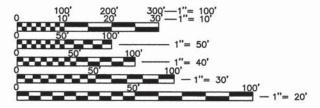

FULL SIZE PLANS HAVE BEEN PREPARED USING STANDARD ENGINEERING SCALES. REDUCED SIZED PLANS WILL NOT CONFORM TO STANDARD SCALES. IN MAKING MEASUREMENTS ON REDUCED PLANS, THE ABOVE SCALES MAY BE USED.

J.U.L.I.E.

JOINT UTILITY LOCATION INFORMATION FOR EXCAVATION 1-800-892-0123 OR 811

PLANS PREPARED BY:

VANTAGE POINT


18311 NORTH CREEK DRIVE SUITE F

TINLEY PARK, IL 60477

VPENG.COM | CIVIL ENGINEERING | LAND PLANNING | SURVEYING

PROFESSIONAL DESIGN FIRM NO.: 184-005786 EXPIRATION DATE: 04/30/2015

CONTRACT NO. 61B65

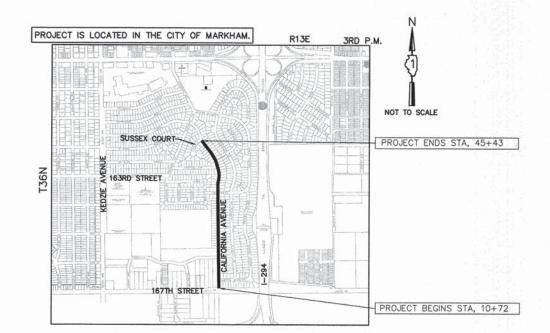

BREMEN TOWNSHIP

GROSS LENGTH OF PROJECT = 3,471 FEET (0.66 MI)

NET LENGTH OF PROJECT = 3,471 FEET (0.66 MI)

	F.A.U. RTE.	SECTION	COUNTY	TOTAL SHEE SHEETS NO.		
	1713	14-00045-00-	RS	COOK	14	1
1	FEDERAL	ROAD DISTRICT NO. 1	ILLINOIS	CONTRAC	T NO. 6	1B65



DEPA	STATE OF ILLINOIS RTMENT OF TRANSPORTATION DIVISION OF HIGHWAYS
APPROVED_	MAYOR, CITY OF MARKHAM
PASSED -	APRIL 8 2015 CHIROSTOPHEZ HOCT DISTRICT 1 ENGINEER OF LOCAL ROADS AND STREETS
RELEASING FOR BID BASED ON LIMITED REVIEW _	Apr. 8 20 15 DEPUTY DIRECTOR OF HIGHWAYS, REGION ONE ENGINEER



ENGINEER ENGINEER

3/13/2015 DATE

WILLIAM J ZALEWSKI ILLINOIS REGISTRATION NO. 062046121 EXPIRATION DATE: 11/30/15

PRINTED BY THE AUTHORITY OF THE STATE OF ILLINOIS

ANTS: VANTAGEPOINT ENGINEERING, LLC (708) 478-4004

SPECIFICATIONS AND SPECIAL PROVISIONS

ALL CONSTRUCTION SHALL BE DONE IN ACCORDANCE WITH THE "STANDARD SPECIFICATIONS FOR ROAD AND BRIDGE CONSTRUCTION", ADOPTED JANUARY 1, 2012; THE "SUPPLEMENTAL SPECIFICATIONS AND RECURRING SPECIAL PROVISIONS", ADOPTED JANUARY 1, 2015; THE LATEST EDITION OF THE "ILLINOIS MANUAL ON UNIFORM TRAFFIC CONTROL DEVICES FOR STREETS AND HIGHWAYS", (IMUTC); THE "STANDARD SPECIFICATIONS FOR TRAFFIC CONTROL ITEMS", SSTC), "THE STANDARD SPECIFICATIONS FOR WATER AND SEWER MAIN CONSTRUCTION IN ILLINOIS" MAY 1996 FIFTH EDITION, THE "DETAILS" IN THE PLANS AND THE "SPECIAL PROVISIONS" INCLUDED IN THE CONTRACT DOCUMENTS.

ALL WORK SHALL BE PERFORMED IN ACCORDANCE WITH APPLICABLE LAWS AND GOVERNMENT AGENCY REGULATIONS AND RULES; AUTHORITIES HAVING JURISDICTION; OSHA REGULATIONS AND RULES; AND ANY APPLICABLE RULES AND REGULATIONS OF THE STATE OF ILLINOIS OR COOK COUNTY AGENCIES. FURTHERMORE, AND AS RELATED TO THE WORK, THE CONTRACTOR SHALL GIVE NOTICES AND COMPLY WITH APPLICABLE LAWS, ORDINANCES, RULES, REGULATIONS, AND LAWFUL ORDERS OF ALL PUBLIC AUTHORITIES BEARING ON THE SAFETY OF PERSONS OR PROPERTY OR THEIR PROTECTION FROM DAMAGE, INJURY OR LOSS.

ANY REFERENCE TO STANDARDS THROUGHOUT THE PLANS OR SPECIAL PROVISIONS SHALL BE INTERPRETED AS THE LATEST IDOT STANDARD.

ALL TRAFFIC CONTROL AND OTHER ADVISORY SIGNS NEEDED FOR CONSTRUCTION ARE TO BE FURNISHED BY THE CONTRACTOR IN ACCORDANCE WITH SECTION 700 OF THE STANDARD SPECIFICATIONS.

UTILITIES

ALL TRAFFIC CONTROL SHALL COOPERATE WITH THE VILLAGE IN ANY UNDERGROUND UTILITY CONSTRUCTION WHICH THE VILLAGE MAY WANT TO PLACE DURING THE CONTRACTOR'S OPERATIONS.

THE CONTRACTOR SHALL BE RESPONSIBLE FOR CONTACTING THE OWNER OF ALL EXISTING FACILITIES THAT THE UTILITIES AND THEIR APPURTENANCES MAY BE LOCATED AND ADJUSTED OR MOVED. IF NECESSARY, PRIOR TO THE START OF CONSTRUCTION OPERATIONS, THE CONTRACTOR SHALL COOPERATE WITH ALL UTILITY OWNERS AS PROVIDED FOR IN THE STANDARD SPECIFICATION.

THE LOCATIONS OF EXISTING DRAINAGE STRUCTURES, STORM AND SANITARY SEWERS, WATER SERVICE LINES AND OTHER UTILITY LINES ARE APPROXIMATE, AND THE VILLAGE DOES NOT GUARANTEE THEIR ACCURACY. THEIR EXACT HORIZONTAL AND VERTICAL LOCATIONS ARE TO BE DETERMINED IN THE FIELD BY THE CONTRACTOR AT HIS OWN EXPENSE.

THE CONTRADCTOR SHALL BE RESPONSIBLE FOR THE PROTECTION OF ALL UNDERGROUND OR SURFACE UTILITIES EVEN THOUGH THEY MAY NOT BE SHOWN ON THE PLANS. ANY UTILITY THAT IS DAMAGED DURING THE CONSTRUCTION SHALL BE REPAIRED OR REPLACED TO THE SATISFACTION OF THE ENGINEER. THIS WORK SHALL BE AT THE CONTRACTORS EXPENSE.

COORDINATION OF ALL UTILITY WORK INVOLVED IN THE CONSTRUCTION AREA WILL BE DISCUSSED AT THE PRECONSTRUCTION CONFERENCE.

BEFORE STARTING ANY EXCAVATION, THE CONTRACTOR SHALL CALL "JULIE" AT 1-800-892-0123 FOR FIELD LOCATIONS OF BURIED ELECTRIC, TELEPHONE, GASS AND CABLE TELEVISION FACILITIES (48 HOUR NOTOFICATION IS REQUITED).

STAKING

THE CONTRACTOR SHALL PROTECT AND CAREFULLY PRESERVE ALL SECTION OR SUBSECTION MONUMENTS OR PROPERTY OR REFERENCE MARKERS UNTIL THE ENGINEER, HIS AGENT OR AN AUTHORIZED SURVEYOR HAS WITNESSED OR OTHERWISE REFERENCED THEIR LOCATIONS.

ALL RADII FOR PROPOSED CURB AND GUTTER ARE TO THE EDGE OF PAVEMENT UNLESS OTHERWISE NOTED. AND SHALL BE AS INDICATED ON THE PLANS, ELEVATIONS SHOWN AT POINT OF CURVE, ETC. IS EDGE OF PAVEMENT OTHERWISE NOTED.

ALL OFFSET LOCATIONS GIVEN ON THE DETAILED PLANS FOR STRUCTURES, ETC. ARE FROM THE PROPOSED BASE LINE OF CONSTRUCTION.

PRIOR TO CONSTRUCTION, THE ENGINEER SHALL MARK THE LIMITS OF PAVING OPERATIONS, INCLUDING THE REMOVAL AND RESURFACING LIMITS, START AND END OF THE PROJECT AND ALL SIDE STREET RADII, ETC.

MISCELLANEOUS

DIMENSIONS: IT SHALL BE THE CONTRACTOR'S RESPONSIBILITY TO VERIFY ALL DIMENSION AND CONDITIONS EXISTING IN THE FIELD PRIOR TO ORDERING MATERIALS AND BEGINNING CONSTRUCTION.

ALL SAWCUTTING SHALL BE INCLUDED IN THE UNIT COST OF REMOVAL ITEMS AND SHALL BE PERFORMED PRIOR TO BEGINNING REMOVAL. ANY ITEMS OF WORK REMOVED PRIOR TO SAWCUTTING WILL N OT BE MEASURED FOR PAYMENT.

PAVEMENT GRADES: THE ELEVATIONS INDICATED ON THE PLANS ARE FINISHED GRADES OF PROPOSED PAVEMENT OF SURFACE COURSE, UNLESS OTHERWISE INDICATED.

RELOCATING EXISTING SIGNS: EXISTING SIGNS WHICH ARE IN CONFLICT WITH PROPOSED IMPROVEMENTS SHALL BE REMOVED AND REINSTALLED UPON COMPLETION OF CONFLICTING IMPROVEMENTS IN ACCORDANCE WITH THE ILLINOIS DEPARTMENT OF TRANSPORTATION "MANUAL OF UNIFORM TRAFFIC CONTROL DEVICES" AND THE "STANDARD SPECIFICATIONS FOR TRAFFIC CONTROL ITEMS". THIS WORK SHALL BE INCLUDED IN THE COST FOR PORTLAND CEMENT CONCRETE SIDEWALK. 5 INCH, SPECIAL.

ANY EXISTING PAVEMENT DAMAGED BY THE CONTRACTOR DURING THE CONSTRUCTION SHALL BE REPLACED/REPAIRED BY THE CONTRACTOR AT HIS/HERS OWN EXPENSE TO THE SATISFACTION OF THE ENGINEER WITH NO ADDITIONAL COMPENSATION TO THE CONTRACTOR.

ALL TRANSITIONS IN CURB HEIGHT SHALL OCCUR OVER 3 FEET ALONG CURB LINE. AT LOCATIONS WHERE CURB TERMINATES, THE LAST 1 FOOT SHALL BE DEPRESSED. DEPRESSED CURB SHALL ALSO BE AT LOCATIONS SHOWN ON THE PLANS AND AS DIRECTED BY THE ENGINEER.

GENERAL NOTES

THE OWNER, THE VILLAGE OF MARKHAM SHALL BE NOTIFIED IN WRITING AT LEAST (3) FULL WORKING DAYS PRIOR TO COMMENCEMENT OF CONSTRUCTION.

THE CONTRACTOR SHALL PROVIDE ALL NECESSARY PROTECTION FOR EXISTING UTILITIES IN CONFORMANCE WITH THE AFFECTED UTILITY COMPANIES REQUIREMENTS AS MAY BE REQUIRED TO PERFORM THE WORK OF THIS CONTRACT.

BEFORE BEGINNING CONSTRUCTION, THE CONTRACTOR SHALL VERIFY THE LINE AND GRADES SHOWN ON THE CONTRACT DRAWINGS. IF THERE ARE ANY DISCREPANCIES FROM WHAT IS SHOWN ON THE CONTRACT DRAWINGS, THE CONTRACTOR SHALL IMMEDIATELY REPORT SAME TO THE OWNER PRIOR TO PERFORMING WORK. CONTRACTOR SHALL BE RESPONSIBLE FOR COORDINATION OF WORK AS REQUIRED.

THE WORK PERFORMED UNDER THIS CONTRACT SHALL IN NO WAY INTERFERE WITH THE NORMAL OPERATION OF ANY EXISTING UTILITY SERVICE. THE CONTRACTOR SHALL FURNISH ALL NECESSARY ITEMS OF EQUIPMENT REQUIRED TO MAINTAIN SUCH NORMAL OPERATION AT NO ADDITIONAL COST TO THE OWNER. THE COST ASSOCIATED FOR THIS WORK SHALL BE CONSIDERED INCLUDED IN THE COST OF THE CONTRACT.

SOIL EROSION PROTECTION SHALL BE IN ACCORDANCE WITH IEPA STANDARDS AND SPECIFICATIONS FOR SOIL EROSION AND SEDIMENT CONTROL. ALL DISTURBED AREAS (NOT IMPERVIOUS IN NATURE) SHALL BE FINE GRADED, TOP SOIL RESTORED (MIN 4 INCHES) AND SEED/MULCH APPLIED UNLESS OTHERWISE SPECIFIED ON THE PLANS.

DETECTABLE WARNINGS, SIDEWALK, COMBINATION CURB AND GUTTER REMOVAL AND REPLACEMENT SHALL BE AS DIRECTED BY ENGINEER.

THE REMOVAL AND/OR REPLACEMENT OF ANY DRIVEWAYS, PAVEMENT, CURB, SIDEWALK, ETC. SHALL BE ACCOMPLISHED BY MEANS OF A SAW CUT JOINT, AT THE DIRECTION OF THE ENGINEER. THIS WORK WILL NT BE PAID FOR SEPARATELY, BUT SHALL BE INCLUDED IN THE COST OF THE VARIOUS ITEMS OF A DAJACENT WORK.

PRIOR TO SUBMITTING A BID, THE PROSPECTIVE BIDDER SHALL THOROUGHLY EXAMINE THE PROVISIONS OF THE CONTRACT, EXAMINE THE SITE OF THE PROPOSED WORK, AND ACQUAINT THEMSELVES WITH ALL THE LOCAL CONDITIONS AFFECTING THE CONTRACT. THE PROSPECTIVE BIDDER SHALL ALSO BE FAMILIAR WITH THE REQUIREMENTS OF THE CONSTRUCTION.

STORM SEWER

WHENEVER, DURING CONSTRUCTION, OPERATIONS ANY LOOSE MATERIAL IS DEPOSITED IN THE FLOW LINE OF DRAINAGE STRUCTURES SUCH THAT THE NATURAL FLOW OF WATER IS OBSTRUCTED, IT SHALL BE REMOVED AT THE CLOSE OF EACH WORKING DAY. AT THE CONCLUSION OF CONSTRUCTION OPERATIONS, ALL UTILITY STRUCTURES SHALL BE FREE FROM DIRT AND DEBRIS. THE WORK SPECIFIED ABOVE WILL NOT BE PAID FOR SEPARATELY BUT SHALL BE INCLUDED IN THE COST FOR CURB AND GUTTER.

ANY EXISTING OR PROPOSED STORM SEWER DAMAGED BY THE CONTRACTOR DURING CONSTRUCTION SHALL BE REPLACED BY THE CONTRACTOR AT NO ADDITIONAL COST.

FRAME ELEVATIONS GIVEN ON THE PLANS ARE ONLY TO ASSIST THE CONTRACTOR IN DETERMINING THE APPROXIMATE OVERALL HEIGHT OF THE STRUCTURE. FRAMES OF ALL NEW, ADJUSTED OR RECONSTRUCTED STRUCTURES SHALL BE ADJUSTED TO THE FINAL ELEVATION OF THE AREA IN WHICH THEY ARE LOCATED AS PART OF THE STRUCTURE, ADJUSTMENT, OR RECONSTRUCTION COST. IT IS THE CONTRACTORS RESPONSIBILITY TO DETERMINE STRUCTURE SIZE.

WHEN EXISTING DRAINAGE OR SEWERAGE FACILITIES ARE DISTURBED, THE CONTRACTOR SHALL PROVIDE AND MAINTAIN TEMPORARY OUTLETS AND CONNECTIONS FOR ALL PUBLIC OR PRIVATE DRAINS, SEWERS, OR CATCH BASINS, HE SHALL PROVIDE FACILITIES TO TAKE ALL STORM WATER WHICH WOULD BE RECEIVED BY THESE FACILITIES AND DISCHARGE SAME. HE SHALL ALSO PROVIDE AND MAINTAIN AN EFFICIENT PUMPING PLANT. IF NECESSARY, AND A TEMPORARY OUTLET, AND BE PREPARED AT ALL TIMES TO DISPOSED OF THE WATER RECEIVED FROM THESE TEMPORARY CONNECTIONS UNTIL SUCH TIME THAT PERMANENT CONNECTIONS WITH SEWERS ARE CONSTRUCTED AND IN SERVICE, THIS WORK SHALL BE CONSIDERED INCLUDED IN THE COST OF COMBINATION CURB AND GUTTER, TYPE M6.12.

DRAINAGE STRUCTURES CONSTRUCTED OVER THE EXISTING STORM SEWER SHALL INCLUDE THE COST TO REMOVE THE NECESSARY PORTION OF THE STORM SEWER.

ALL REMOVAL OR EXCAVATION ITEMS BEING DISPOSED OF AT AN UNCONTAMINATED SOIL FILL OPERATION OR CLEAN CONSTRUCTION AND DEMOLITION DEBRIS (CCDD) FILL SITE SHALL MEET THE REQUIREMENTS OF PUBLIC ACT 96—1416. ALL COSTS ASSOCIATED WITH MEETING THESE REQUIREMENTS SHALL BE INCLUDED IN THE UNIT PRICE COST FOR THE ASSOCIATED REMOVAL OR EXCAVATION ITEMS IN THE CONTRACT. THESE COSTS SHALL INCLUDE BUT ARE NOT LIMITED TO ALL REQUIRED TESTING, LAB ANALYSIS, CERTIFICATION BY A LICENSED PROFESSIONAL ENGINEER, AND STATE AND LOCAL TIPPING FEES.

IDOT STANDARDS

000001-06	STANDARD SYMBOLS, ABBREVIATIONS AND PATTERNS
280001-07	TEMPORARY EROSION CONTROL SYSTEMS
424001-08	PERPENDICULAR CURB RAMPS FOR SIDEWALKS
442201-03 -	CLASS C AND D PATCHES
606001-06 -	CONCRETE CURB TYPE B AND COMBINATION CURB AND GUTTER
701301-04 -	LANE CLOSURE, 2L, 2W, SHORT TIME OPERATIONS
701311-03 -	LANE CLOSURE, 2L, 2W, MOVING OPERATIONS-DAY ONLY
701501-06	URBAN LANE CLOSURE, 2L, 2W, UNDIVIDED
701801-05	SIDEWALK, CORNER OR CROSSWALK CLOSURE
701901-04	TRAFFIC CONTROL DEVICES

INDEX OF SHEETS

1	COVER SHEET
2	GENERAL NOTES
3	SUMMARY OF QUANTITIES
4	TYPICAL SECTIONS
5-8	RESURFACING PLAN
9-14	DETAILS

FILE NAME =	USER NAME =	DESIGNED - TPP	REVISED -	
		DRAWN - JSS	REVISED -	
	PLOT SCALE = 1" = 20'	CHECKED - WJZ	REVISED -	
	PLOT DATE =	DATE - 01/26/15	REVISED -	

STAT	E OF ILLINOIS	
DEPARTMENT	OF TRANSPORTATION	

	CALIFORNIA AVI			SSEX COURT	F.A.U. RTE.	SECTION	COUNTY	TOTAL	SHEE NO.
		STP/LA			1713	14-00045-00-RS	COOK	14	2
		GENERAL	NOTES				CONTRAC	T NO. 61	B65
SCALE:	SHEET NO.	OF SHEETS	STA.	TO STA.	FED. ROA	D DIST. NO. 1 ILLINOIS F	ED. AID PROJECT	M-4003-(4	486)

		SUMMARY OF QUANTITIES	PAVEMENT CONSTRUCTION TYPE CO			
ı.	CODE NO.	ITEM	UNIT	QUANTITY	0005	1
	20101400	NITROGEN FERTILIZER NUTRIENT	POUND	15	15	
_						
\dashv	25200100	SODDING	SQ YD	286	286	
\neg	40600275	BITUMINOUS MATERIALS (PRIME COAT)	POLIND	6 100	6 400	
	,,,,,,,,,,,,,,,,,,,,,,,,,,,,,,,,,,,,,,,	STORMINGS WITHINGS (FINIS GOAT)	POUND	6,180	6,180	
	40600400	MIXTURE FOR CRACKS, JOINTS, AND FLANGEWAYS	TON	4	4	
_						
\dashv	40600625	LEVELING BINDER (MACHINE METHOD), N50	TON	503	503	
_	40600982	HOT-MIX ASPHALT SURFACE REMOVAL - BUTT JOINT	SQ YD	420	400	
		THE THE POPULATION AND THE POPUL	3Q 1D	430	430	
	40603335	HOT-MIX ASPHALT SURFACE COURSE, MIX "D", N50	TON	1,630	1,630	
-	4040000					
\dashv	42400200	PORTLAND CEMENT CONCRETE SIDEWALK 5 INCH	SQ FT	938	938	
\forall	42400800	DETECTABLE WARNINGS	SO ET	120	120	
			SQ FT	120	120	
	XHHOHHOO	PAVEMENT REMOVAL, SPECIAL	SQ YD	771	771	
-	11000150	HOT HAVE ACCUSED OF THE CONTRACT OF THE CONTRA				
-	44000159	HOT-MIX ASPHALT SURFACE REMOVAL, 2 1/2"	SQ YD	11,645	11,645	
\dashv	44000200	DRIVEWAY PAVEMENT REMOVAL	SQ YD	22	22	
\Box		The state of the s	30 10	22	55	
_	44000600	SIDEWALK REMOVAL	SQ FT	1,131	1,131	
\dashv	11001000	0.100 B 2.73.75				
+	44201692	CLASS D PATCHES, TYPE II, 4 INCH	SQ YD	17	17	
\dashv	44201694	CLASS D PATCHES, TYPE III, 4 INCH	SQ YD	47	47	
		The state of the s	SQ TD	47	47	
_	44201696	CLASS D PATCHES, TYPE IV, 4 INCH	SQ YD	163	163	
+	60700705	EDAMES AND LIDE TO BE AD HIGHE				
+	60300305	FRAMES AND LIDS TO BE ADJUSTED	EACH	14	14	
\dashv	67100100	MOBILIZATION	L SUM	1		
			L SOM	1 1	1	
+	70102620	TRAFFIC CONTROL AND PROTECTION, STANDARD 701501	L SUM	1	1	
+	70100640	TRACCIO CONTROL AND PROTECTION OF THE PROTECTION	21 34 5			
+	70102640	TRAFFIC CONTROL AND PROTECTION, STANDARD 701801	L SUM	1	1	
	Z0004510	HOT MIX ASPHALT DRIVEWAY, 3"	SQ YD	22	55	
_						****
+	Z0004562	COMBINATION CURB AND GUTTER REMOVAL AND REPLACEMENT, TYPE M-6.12	FOOT	1,040	1,040)
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STATE OF ILLINOIS	
DEPARTMENT OF TRANSPORTATION	

-	CALIFORNIA A	VENUE	FROM 167	TH ST. TO SU	SSEX COURT
			STP/LAF	0	
		SUMN	MARY OF QU	IANTITIES	
	SHEET NO	OF	SHEETS	STA	TO CTA

SCALE:

FED. ROA	D DIST. NO. 1	ILLINOIS	FED.	AID PROJECT	M-4003-(4	86)
		,		CONTRAC	T NO. 611	B65
1713	14-00045	5-00-RS		COOK	14	3
F.A.U. RTE.	SEC	TION		COUNTY	TOTAL	SHEET NO.

- 1) HOT MIX ASPHALT SURFACE REMOVAL, 2.5", S.Y.
- 2) EXISTING HOT-MIX ASPHALT PAVEMENT TO REMAIN, 2" MINIMUM AFTER MILLING
- 3 EXISTING AGGREGATE BASE TO REMAIN
- (4) CLASS D PATCHES, TYPE I, TYPE II, TYPE III OR TYPE IV, 4" (LOCATIONS AS DIRECTED BY RE), S.Y.
- (5) EXISTING CURB & GUTTER TO BE REMOVED, FT. (LOCATIONS AS DIRECTED BY R.E.)
- (6) EXISTING DRIVEWAY PAVEMENT TO BE REMOVED, S.Y.
- (7) HOT MIX ASPHALT SURFACE COURSE, MIX D, N50 2 1/2", TON
- 8 COMBINATION CONCRETE CURB & GUTTER, M-6.12, FT. (LOCATIONS AS DIRECTED BY R.E.)
- 9 POLYMERIZED LEVELING BINDER (MACHINE METHOD), IL-4.75, N50, 0" 3/4", TON
- (10) HOT MIX ASPHALT SURFACE COURSE, MIX D, N50, 3"
- (11) PAVEMENT REMOVAL, SPECIAL (LOCATION AS EXISTING)


NOTE: CONTRACTOR SHALL MILL BEFORE PATCHING.

MIXTURE TYPE	AIR VOIDS @ NDES
RESURFACING	107 0 50 0
HOT-MIX ASPHALT SURFACE COURSE, MIX "D", N50 (IL-9.5mm) 2 1/2"	4% @ 50 Gyr.
POLYMERIZED LEVELING BINDER (MACHINE METHOD), IL-4.75, N50, 3/4"	3.5% @ 50 Gyr.
DRIVEWAYS	
HOT MIX ASPHALT SURFACE COURSE, MIX "D", N50 (IL-9.5mm) 3"	4% © 50 Gyr.
PATCHING	47 0 70 0
CLASS D PATCHES, TYPE I, II, III OR IV, 4" (HMA BINDER IL-19.0mm)	4% @ 70 Gyr.

THE UNIT WEIGHT USED TO CALCULATE ALL HOT MIX ASPHALT SURFACE MIXTURE QUANTITIES IS 112 LBS/SY/IN.


THE "AC TYPE" FOR POLYMERIZED HMA MIXES SHALL BE "SBS/SBR PG 76-22" AND FOR NON-POLYMERIZED HMA THE "AC TYPE" SHALL BE "PG 64-22" UNLESS MODIFIED BY DISTRICT ONE SPECIAL PROVISIONS.

FOR "PERCENT OF RAP" SEE DISTRICT ONE SPECIAL PROVISIONS.

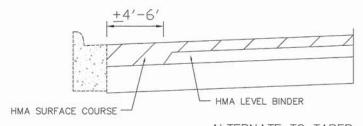

ALTERNATE TO TAPER (NO EXISTING ASPHALT . OVER GUTTER)


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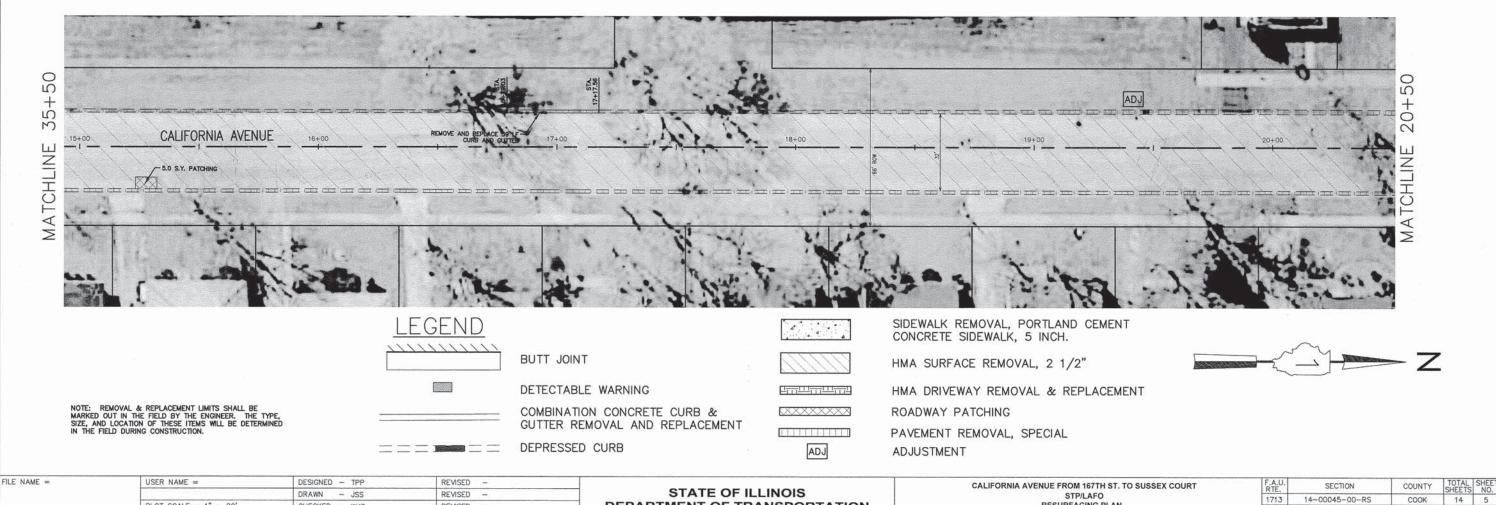

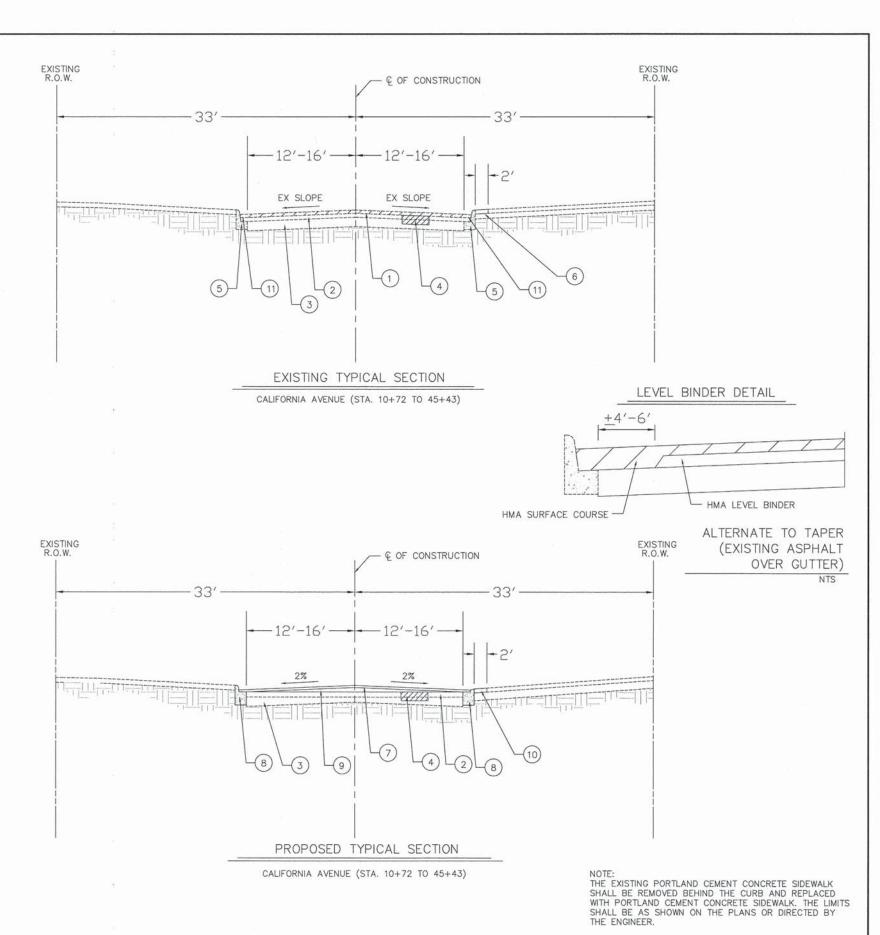
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STATE OF ILLINOIS
DEPARTMENT OF TRANSPORTATION

	CALIFORNIA AVEI	F.A.U. RTE.	SECTION	COUNTY	TOTAL	SHE			
STP/LAFO TYPICAL CROSS SECTIONS					1713	14-00045-00-RS	соок	14	4
	1 1	PICAL CROSS					CONTRAC	T NO. 61E	365
SCALE:	SHEET NO. C	OF SHEETS	STA.	TO STA.	FED. ROA	D DIST. NO. 1 ILLINOIS F	ED. AID PROJECT	M-4003-(4	36)



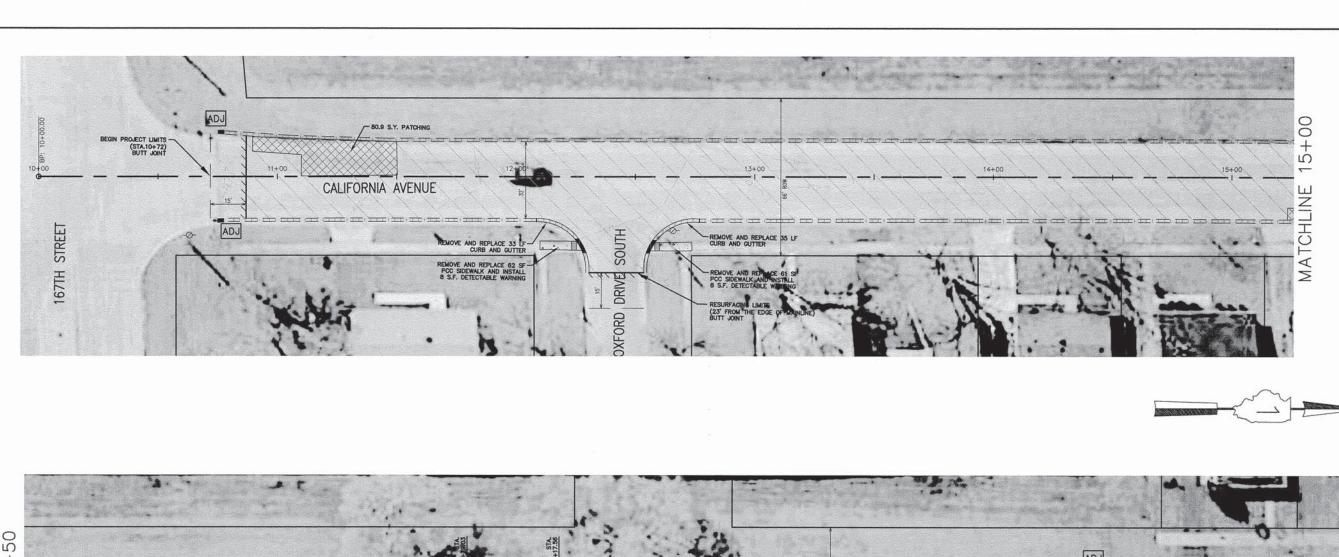

DEPARTMENT OF TRANSPORTATION

PLOT SCALE = 1" = 20'

PLOT DATE =

CHECKED - WJZ

- 01/26/15

DATE

REVISED

REVISED

14-00045-00-RS

FED. ROAD DIST. NO. 1 ILLINOIS FED. AID PROJECT M-4003-(486)


CONTRACT NO. 61B65


1713


RESURFACING PLAN

SHEET NO. OF SHEETS STA.

SCALE:

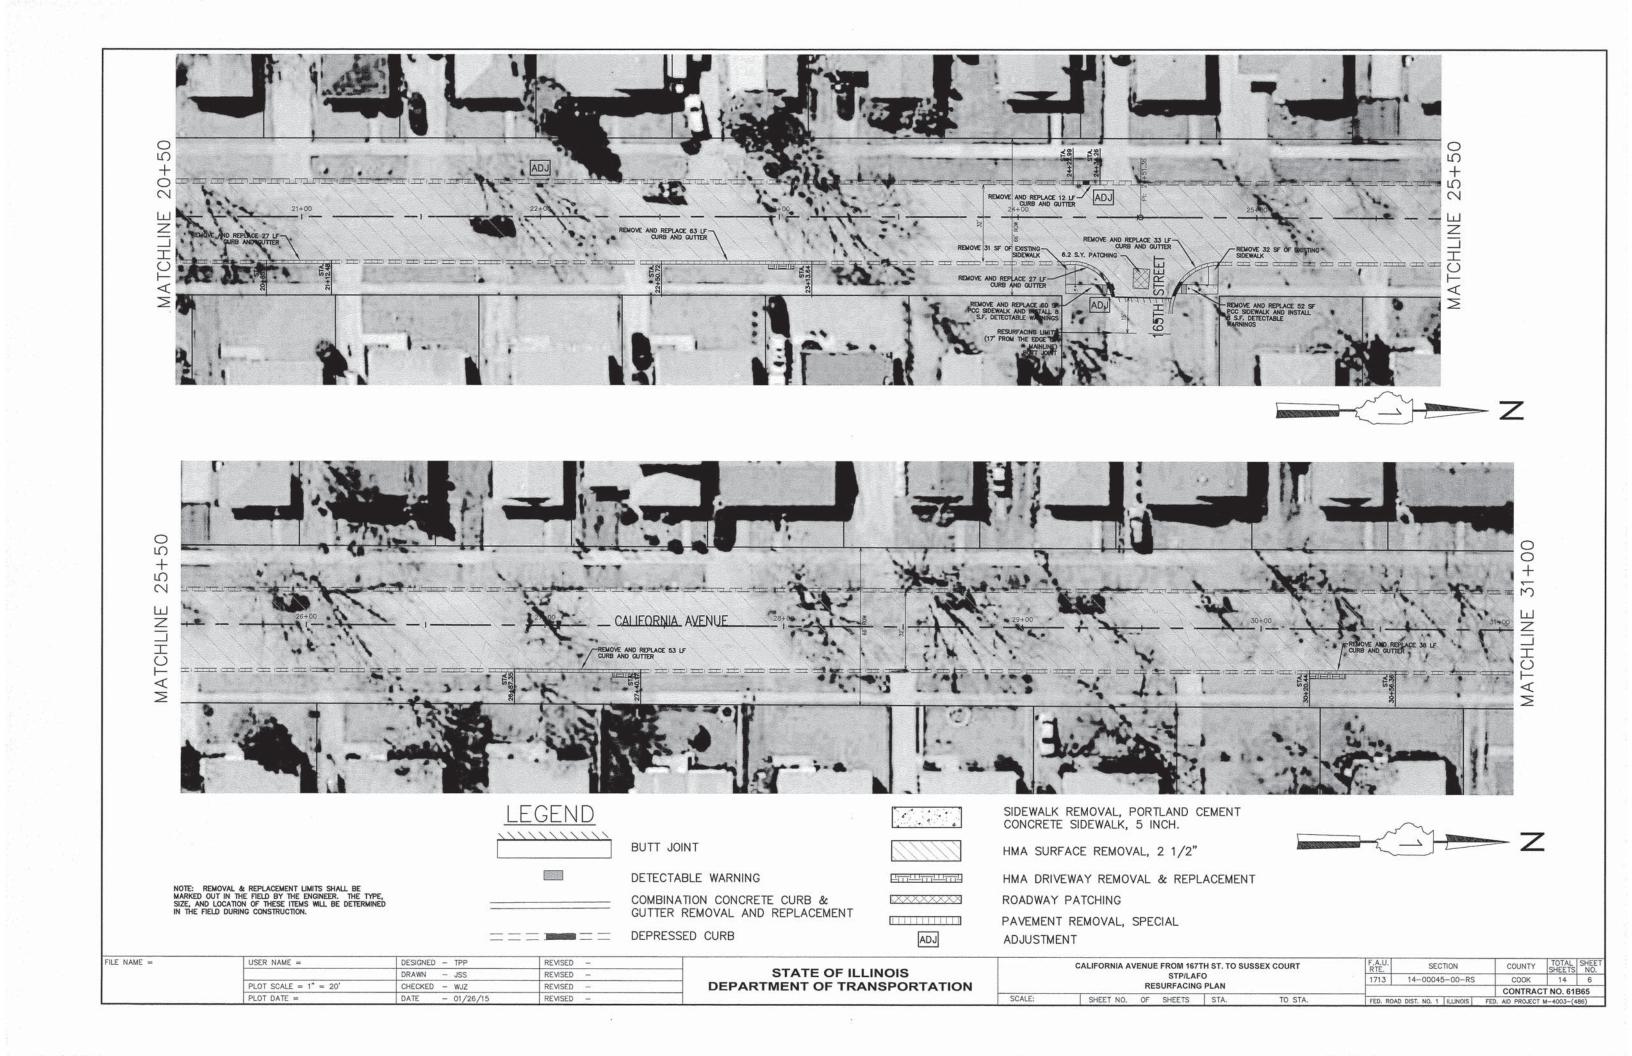

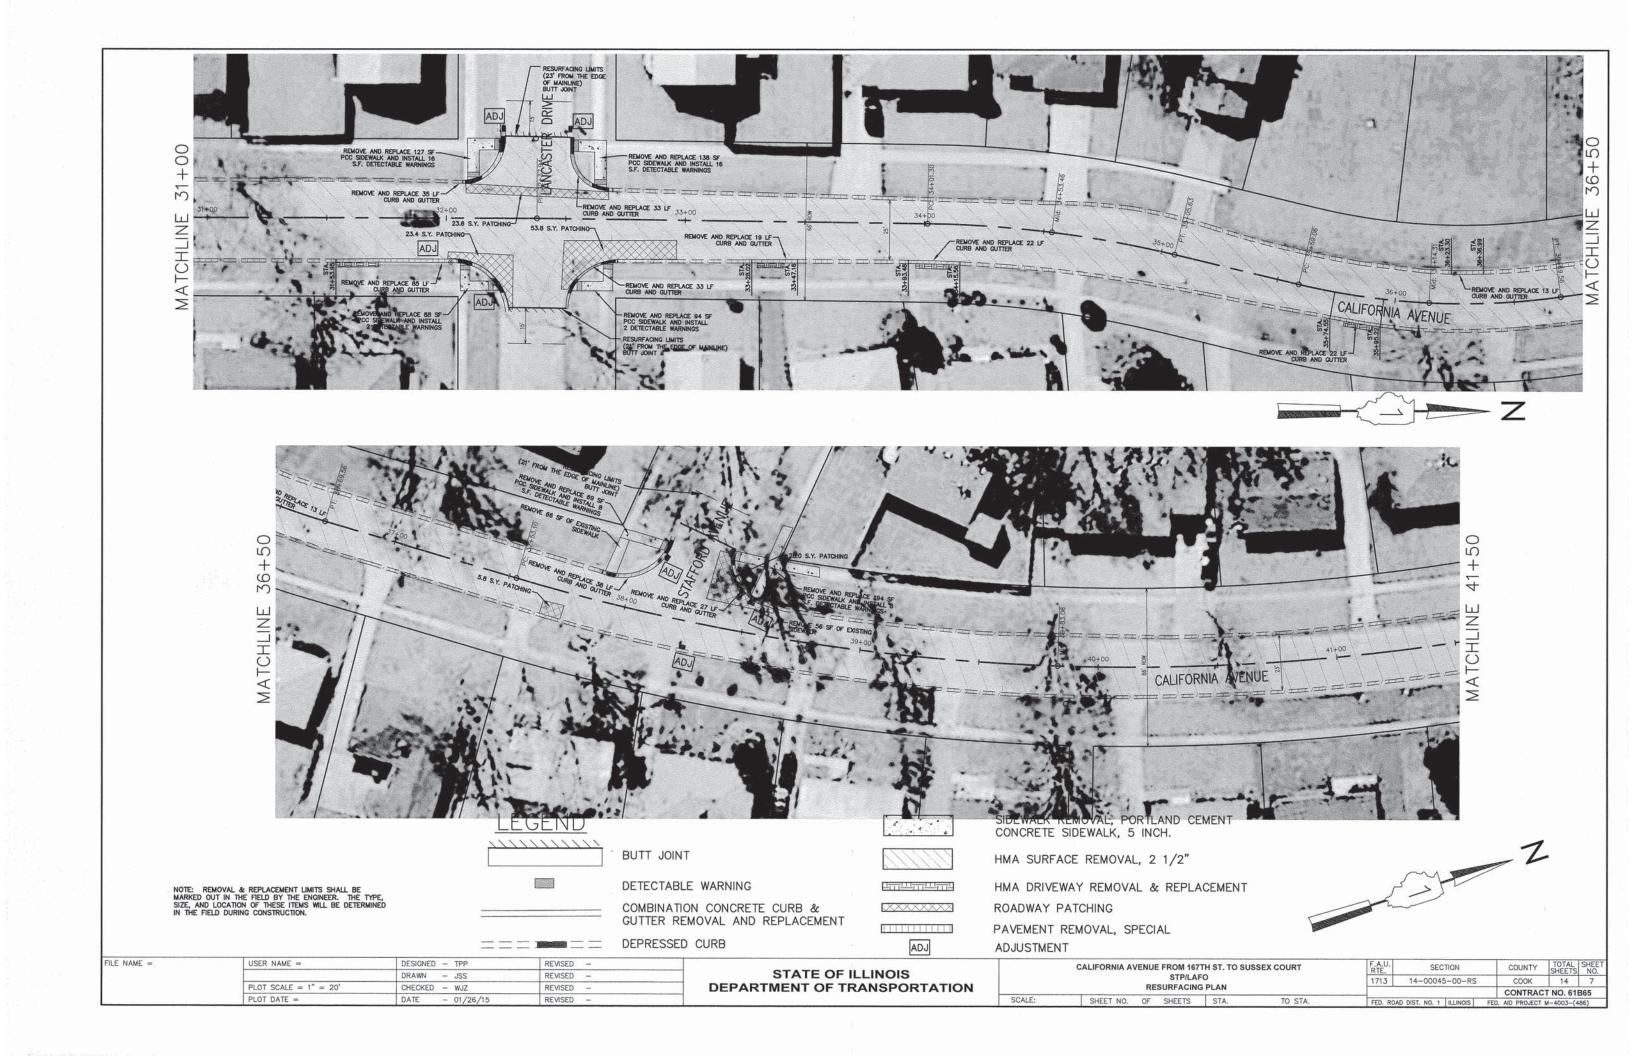

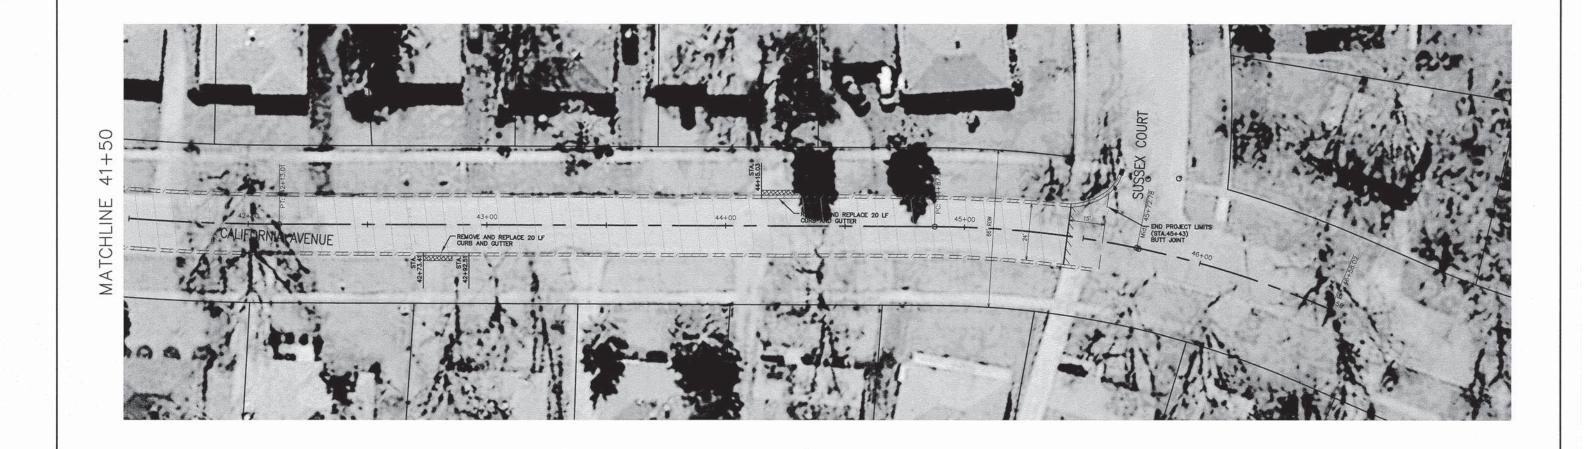

LEGEND

BUTT JOINT


DETECTABLE WARNING

COMBINATION CONCRETE CURB & GUTTER REMOVAL AND REPLACEMENT

DEPRESSED CURB



ADJ

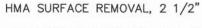

HMA DRIVEWAY REMOVAL & REPLACEMENT

SIDEWALK REMOVAL, PORTLAND CEMENT CONCRETE SIDEWALK, 5 INCH.

ROADWAY PATCHING


PAVEMENT REMOVAL, SPECIAL ADJUSTMENT

NOTE: REMOVAL & REPLACEMENT LIMITS SHALL BE MARKED OUT IN THE FIELD BY THE ENGINEER. THE TYPE, SIZE, AND LOCATION OF THESE ITEMS WILL BE DETERMINED IN THE FIELD DURING CONSTRUCTION.

FILE NAME =	USER NAME =	DESIGNED - TPP	REVISED -	
		DRAWN - JSS	REVISED -	
	PLOT SCALE = 1" = 20'	CHECKED - WJZ	REVISED -	
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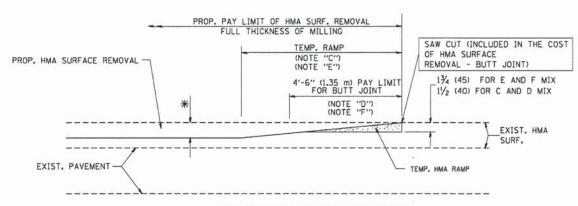
STATE OF ILLINOIS	
DEPARTMENT OF TRANSPORTATION	

	CALIFORNIA AVENUE FROM 167TH ST. TO SUSSEX COURT STP/LAFO RESURFACING PLAN						SECTION	COUNTY	TOTAL	SHEET NO.
							14-00045-00-RS	COOK	14	8
								CONTRAC	T NO. 611	B65
SCALE:	SHEET NO.	OF	SHEETS	STA.	TO STA.	FED. ROAD DIST. NO. 1 ILLINOIS FED. AID PROJECT M-4003-(4				

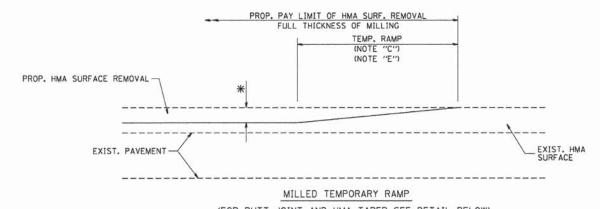

(FOR BUTT JOINT AND HMA TAPER SEE DETAIL BELOW)

OPTION 1




HMA CONSTRUCTED TEMPORARY RAMP

(FOR BUTT JOINT AND HMA TAPER SEE DETAIL BELOW)

OPTION 2

TYPICAL TEMPORARY RAMP

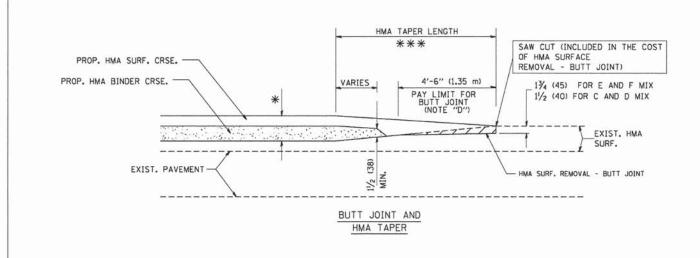


TYPICAL BUTT JOINT AND HMA TAPER FOR MILLING AND RESURFACING

PROP. HMA OR PCC

SURFACE REMOVAL - BUTT JOINT
30'-0" (4.5 m) (NOTE "B")
(NOTE "D")

** * EXIST. PAVEMENT

BUTT JOINT DETAIL

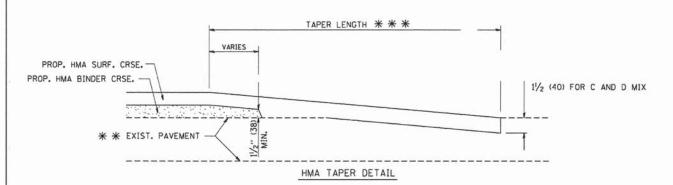

TYPICAL BUTT JOINT AND HMA TAPER FOR RESURFACING ONLY

* * PC CONCRETE, HMA OR HMA RESURFACED PAVEMENT.

NOTES

- A: MAINLINE ROADWAYS AND MAJOR SIDE ROADS.
- : MINOR SIDE ROADS.
- C: THE TEMP. RAMP SHALL BE CONSTRUCTED IMMEDIATELY UPON REMOVAL OF THE EXISTING HMA SURFACE.
- D: THE BUTT JOINT SHALL BE CONSTRUCTED IMMEDIATELY PRIOR TO PLACING THE PROPOSED HMA COURSES.
- E: TAPER THE TEMP. RAMP AT A RATE OF 3'-0" (900 mm) PER 1 INCH (25 mm) OF MILLING THICKNESS.
- F: INSTALLATION AND REMOVAL OF THE 4'-6" (1.35 m) TEMP. RAMP IS INCLUDED IN COST OF HMA SURFACE REMOVAL BUTT JOINT
- G: SEE ARTICLE 406.08 AND 406.14 OF THE STANDARD SPECIFICATIONS FOR "HMA AND/OR PCC SURFACE REMOVAL, BUTT JOINT".
- * SEE TYPICAL SECTIONS FOR MILLING THICKNESS.
- ** * 20'-0" (6.1 m) PER 1 (25) RESURFACING (NOTE "A") 10'-0" (3.0 m) PER 1 (25) RESURFACING (NOTE "B")

BASIS OF PAYMENT:


THE BUTT JOINT WILL BE PAID FOR AT THE CONTRACT UNIT PRICE PER SOUARE YARD (SOUARE METER) FOR "HOT-MIX ASPHALT SURFACE REMOVAL - BUTT JOINT" OR FOR "PORTLAND CEMENT CONCRETE SURFACE REMOVAL- BUTT JOINT".

ALL DIMENSIONS ARE IN INCHES (MILLIMETERS) UNLESS OTHERWISE SHOWN.

FILE NAME =	USER NAME =	DESIGNED - TPP	REVISED	Vi.—Direk
		DRAWN - JSS	REVISED -	
	PLOT SCALE = 1" = 20'	CHECKED - WJZ	REVISED -	
	PLOT DATE =	DATE - 01/26/15	REVISED -	

STATE OF ILLINOIS
DEPARTMENT OF TRANSPORTATION


CALIFORNIA AVENUE FROM 167TH ST. TO SUSSEX COURT							SECTION	COUNTY	TOTAL SHEETS	SHEE NO.
STP/LAFO DETAILS						1713	14-00045-00-RS	COOK	14	9
								CONTRAC	T NO. 618	B65
SCALE:	SHEET NO.	OF	SHEETS	STA.	TO STA.	FED. ROA	M-4003-(4	86)		

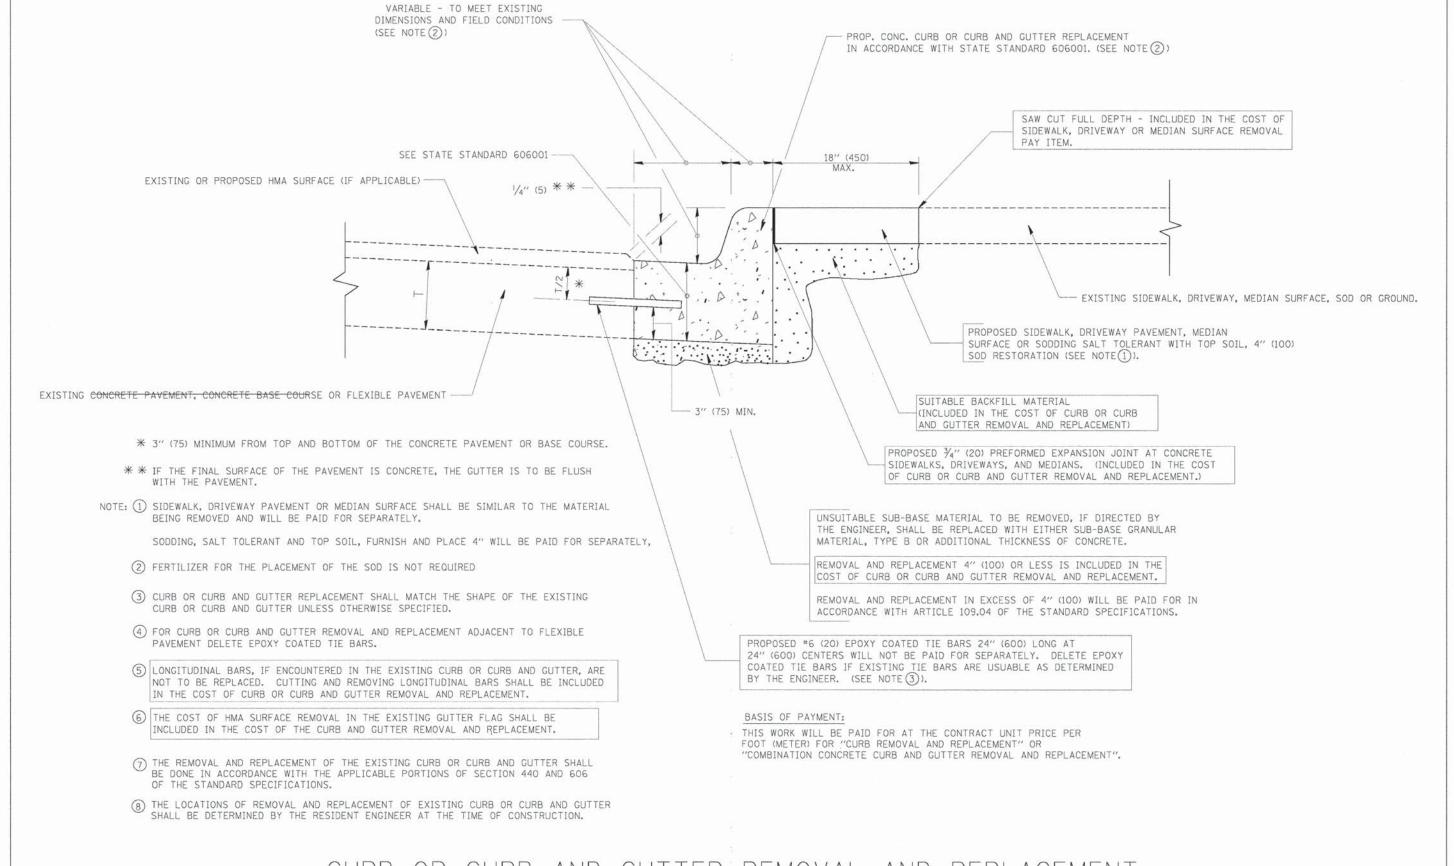

CURB OR CURB AND GUTTER REMOVAL AND REPLACEMENT

ALL DIMENSIONS ARE IN INCHES (MILLIMETERS) UNLESS OTHERWISE SHOWN.

FILE NAME =	USER NAME =	DESIGNED - TPP	REVISED -	07477 07 11 11 11 11	CALIFORNIA AVENUE FROM 167TH ST. TO SUSSEX COURT			EX COURT	F.A.U.	SECTION	COUNTY	TOTAL	SHEET
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1	PLOT SCALE = 1" = 20'	CHECKED - WJZ REVISED - DEPARTMENT OF TRAN	DEPARTMENT OF TRANSPORTATION	ON DETAILS						CONTRACT NO.		65	
	PLOT DATE =	DATE - 01/26/15	REVISED -		SCALE:	SHEET NO. OF SHEETS	STA.	TO STA.	FED. ROA	D DIST. NO. 1 ILLINOIS			

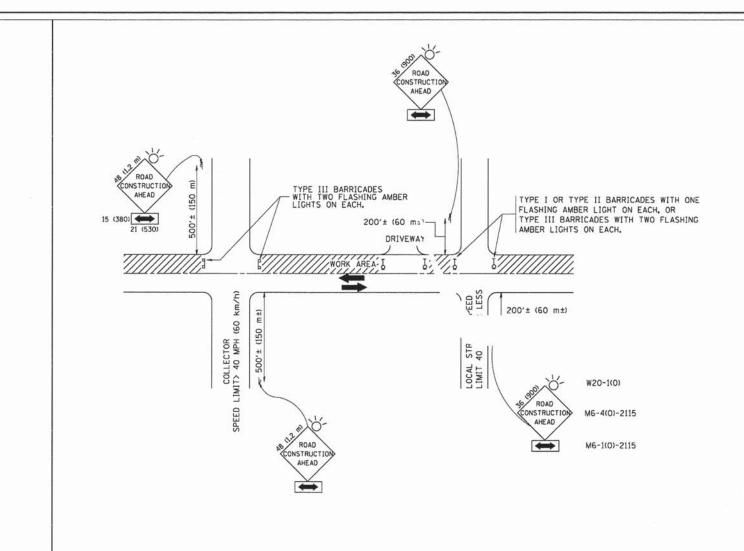

TRAFFIC CONTROL AND PROTECTION FOR SIDE ROADS, INTERSECTIONS, AND DRIVEWAYS

NOTES:

A. FOR NO LANE RESTRICTION ON THE SIDE ROAD OR DRIVEWAYS

- 1. SIDE ROAD WITH A SPEED LIMIT OF 40 MPH (60 km/h) OR LESS AS SHOWN ON THE DRAWING AND AS DIRECTED BY THE ENGINEER:
- O) ONE ROAD CONSTRUCTION AHEAD SIGN 36 x 36 (900×900) WITH A FLASHER AND FLAC MOUNTED ON IT APPROXIMATELY 200' (60 m) IN ADVANCE OF THE MAIN POLITY
- b) THE CLOSED PORTION OF THE MAIN ROUTE SHALL BE PROTECTED BY BLOCKING WITH TYPE I, TYPE II OR TYPE III BARRICADES, 1/3 OF THE CROSS SECTION OF THE CLOSED PORTION.
- SIDE ROAD WITH A SPEED LIMIT GREATER THAN 40 MPH (60 km/h) AS SHOWN ON THE DRAWING AND AS DIRECTED BY THE ENGINEER:
- 0) ONE ROAD CONSTRUCTION AHEAD SIGN 48 \times 48 (1.2 m \times 1.2 m) WITH A FLASHER MOUNTED ON IT APPROXIMATELY 500' (150 m) IN ADVANCE OF THE MAIN ROUTE.
- b) THE CLOSED PORTION OF THE MAIN ROUTE SHALL BE PROTECTED BY BLOCKING WITH TYPE III BARRICADES, 1/2 OF THE CROSS SECTION OF THE CLOSED PORTION.
- WHEN THE SIDE ROAD LIES BETWEEN THE BEGINNING OF THE MAINLINE SIGNING AND THE WORK ZONE, A SINGLE HEADED ARROW (MG-1) SHALL BE USED IN LIEU OF THE DOUBLE HEADED ARROW (MG-4).

B. FOR A LANE CLOSURE ON A SIDE ROAD OR DRIVEWAY:

USE APPLICABLE PORTIONS OF THE TYPICAL APPLICATION OF TRAFFIC CONTROL DEVICES (STD. 701501, STD. 701606 OR THE APPROPRIATE STANDARD), THE SPACING OF SIGNS AND BARRICADES SHALL BE ADJUSTED FOR FIELD CONDITIONS AS DIRECTED BY THE ENGINEER. THE DIRECTIONAL ARROW SHALL BE COVERED OR REMOVED WHEN NO LONGER CONSISTENT WITH THE SIDE ROAD LANE CLOSURE.

- C. ADVANCE WARNING SIGNS ARE TO BE OMITTED ON DRIVEWAY UNLESS OTHERWISE NOTED.
- D. THE TRAFFIC CONTROL AND PROTECTION FOR SIDE ROADS, INTERSECTIONS, AND DRIVEWAYS SHALL BE INCIDENTAL TO THE COST OF SPECIFIED TRAFFIC CONTROL STANDARDS OR ITEMS.

All dimensions are in millimeters (inches) unless otherwise shown.

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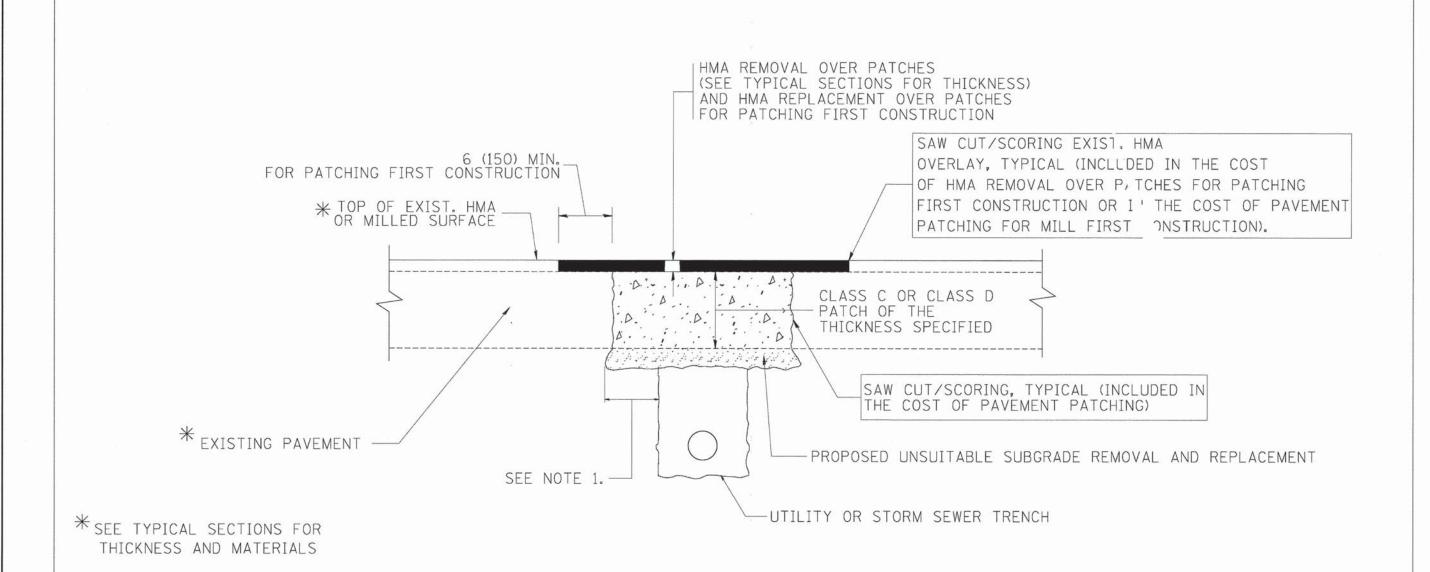
CONTRACT NO. 61B65

COUNTY

COOK

STATE OF ILLINOIS
DEPARTMENT OF TRANSPORTATION

	CALIFORNIA A	F.A.U. RTE.	SECTION				
STP/LAFO DETAILS						1713	14-00045-00-RS
SCALE:	SHEET NO.	OF	SHEETS	STA.	TO STA.	FED ROA	D DIST NO 1 THUNDIST



NOTES:

- 1. THE WIDTH OF THE FULL DEPTH PATCH OVER A TRENCH SHALL BE 12 (300) WIDER ON EACH SIDE OF THE TRENCH.
- 2. FOR METHOD OF MEASUREMENT AND BASIS OF PAYMENT, SEE RECURRING SPECIAL PROVISION "PATCHING WITH HOT-MIX ASPHALT OVERLAY REMOVAL".

SEQUENCE OF CONSTRUCTION (PATCHING FIRST)


- 1. REMOVE THE EXISTING HMA MATERIAL OVER THE AREA TO BE PATCHED.
- 2. REMOVE AND REPLACE WITH CLASS C OR D PATCH.
- 3. REPLACE HMA MATERIAL OVER THE AREA TO BE PATCHED.

SEQUENCE OF CONSTRUCTION (MILLING FIRST)

- 1. MILL HMA FIRST IF THERE IS AT LEAST 41/2 INCHES OR MORE OF HMA MATERIAL ON TOP OF THE EXISTING PAVEMENT OR IF THE PAVEMENT IS FULL DEPTH HMA. A MINIMUM OF 2 INCHES OF HMA MATERIAL SHALL BE IN PLACE AFTER MILLING.
- 2. REMOVE AND REPLACE WITH FULL DEPTH CLASS D PATCHES TO TOP OF MILLED SURFACE.

ALL DIMENSIONS ARE IN INCHES (MILLIMETERS) UNLESS OTHERWISE SHOWN.

FILE NAME =	USER NAME =	DESIGNED - TPP	REVISED -			CALIFORNIA AVENUE FROM 167TH ST. TO SUSSEX COURT	F.A.U.	SECTION	COUNTY	TOTAL	SHEET
		DRAWN - JSS	REVISED -	STATE OF ILLINOIS DEPARTMENT OF TRANSPORTATION	STATE OF ILLINOIS STP/LAFO					SHEETS	NO.
	PLOT SCALE = 1" = 20'	CHECKED - WJZ	REVISED -		DEPARTMENT OF TRANSPORTATION DETAILS				COOK 14		GE.
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NOTES:

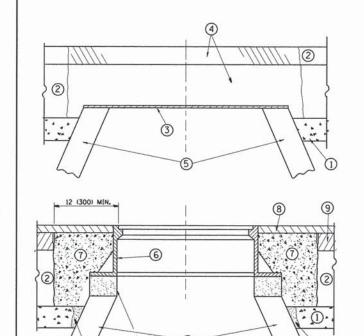EXISTING BROKEN FRAMES AND LIDS SHALL BE REMOVED AND DISPOSED OF BY THE CONTRACTOR AND SHALL BE REPLACED AS DIRECTED BY THE ENGINEER. REPLACEMENT FRAMES AND LIDS WILL BE PAID FOR IN ACCORDANCE WITH ARTICLE 109.04 OF THE STANDARD SPECIFICATIONS UNLESS A SEPARATE PAY ITEM HAS BEEN PROVIDED.

PROPOSED

BRICK. MORTAR, OR CONC.

IF THE EXISTING LIDS ARE OPEN, THE FRAME WILL BE ADJUSTED TO THE ELEVATION OF THE MILLED PAVEMENT SURFACE PRIOR TO THE MILLING OPERATION. THE FRAME WILL NOT BE REMOVED AND COVERED BY THE METAL PLATE.

CITY OF CHICAGO CASTINGS ARE THE PROPERTY OF THE CITY AND THE CONTRACTOR SHALL NOTIFY THE CITY FOR REMOVAL AND DISPOSITION OF THE CASTINGS.

THE METAL PLATE USED TO COVER THE STRUCTURE SHALL REMAIN THE PROPERTY OF THE CONTRACTOR.

WHEN STRUCTURES ARE TO BE ADJUSTED OR RECONSTRUCTED. THE LOWERING AND RAISING OF THE FRAMES AND LIDS WILL NOT BE PAID FOR SEPARATELY BUT WILL BE INCLUDED IN THE COST OF THE CORRESPONDING PAY ITEM.

SCALE:

CONSTRUCTION PROCEDURES

STAGE 1 (BEFORE PAVEMENT MILLING)

- A) REMOVE A MINIMUM OF 12 (300) OF THE PAVEMENT FROM
- AROUND THE STRUCTURE.

 B) REMOVE THE EXISTING FRAME AND LID FROM THE STRUCTURE.
- C) COVER THE STRUCTURE OPENING WITH A 36 (900) DIAMETER METAL PLATE.
- D) BACKFILL WITH CRUSHED STONE AND A MINIMUM 1/2 (40)
 THICK HMA SURFACE MIX APPROVED BY THE ENGINEER.

STAGE 2 (AFTER PAVEMENT MILLING)

- A) REMOVE THE HMA SURFACE MIX AND CRUSHED STONE.
- B) INSTALL THE FRAME AND LID: ADJUST THE FRAME TO ITS FINAL SURFACE ELEVATION.

HE EXISTING

* UNLESS OTHERWISE SPECIFIED IN THE PLANS.

THE PROCEDURE EXPLAINED ABOVE SHALL CONFORM TO THE APPLICABLE PORTIONS OF SECTIONS 353, 406. GO2, AND GO3 OF THE STANDARD SPECIFICATIONS EXCEPT THAT "THE CONTRACTOR SHALL ADJUST THE STRUCTURES TO THE FINISHED PAVEMENT ELEVATION NO MORE THAN 5 CALENDAR DAYS PRIOR TO PLACEMENT OF THE FINAL LIFT OF SURFACE UNLESS APPROVED BY THE

LEGEND

- SUB-BASE GRANULAR MATERIAL
- 6 FRAME AND LID (SEE NOTES)
- 2 EXISTING PAVEMENT
- 7 CLASS PP-1* CONCRETE
- 3 36 (900) DIAMETER METAL PLATE
- (8) PROPOSED HMA SURFACE COURSE
- PROPOSED CRUSHED STONE AND HMA SURFACE MIX (5) EXISTING STRUCTURE
- (9) PROPOSED HMA BINDER COURSE

LOCATION OF STRUCTURES:

THE CONTRACTOR WILL BE REQUIRED TO KEEP A RECORD OF THE LOCATIONS OF THE BURIED STRUCTURES ACCORDING TO THE STATION AND DISTANCE LEFT OR RIGHT OF THE CENTERLINE OF PAVEMENT. UPON COMPLETION OF THE WORK, THE CONTRACTOR WILL DELIVER THE RECORD TO THE ENGINEER.

BASIS OF PAYMENT:

REMOVING FRAMES AND LIDS ON DRAINAGE AND UTILITY STRUCTURES IN THE PAVEMENT PRIOR TO MILLING, AND ADJUSTING TO FINAL GRADE PRIOR TO PLACING THE SURFACE COURSE, WILL BE PAID FOR AT THE CONTRACT UNIT PRICE EACH FOR "FRAMES AND LIDS TO BE ADJUSTED (SPECIAL)."

THIS WORK WILL NOT BE PAID FOR WHEN DRAINAGE AND UTILITY STRUCTURES ARE SPECIFIED FOR PAYMENT AS STRUCTURE RECONSTRUCTION.

NEW FRAMES AND LIDS, WHEN SPECIFIED, WILL BE PAID FOR SEPARATELY.

DETAILS FOR FRAMES AND LIDS ADJUSTMENT WITH MILLING

ALL DIMENSIONS ARE IN INCHES (MILLIMETERS) UNLESS OTHERWISE SHOWN

FILE NAME = USER NAME = DESIGNED - TPP REVISED DRAWN - JSS REVISED PLOT SCALE = 1" = 20' CHECKED - WJZ REVISED PLOT DATE = DATE - 01/26/15 REVISED

STATE OF ILLINOIS **DEPARTMENT OF TRANSPORTATION**

COUNTY TOTAL SHEE NO. COOK 14 13 CALIFORNIA AVENUE FROM 167TH ST. TO SUSSEX COURT SECTION COUNTY STP/LAFO 14-00045-00-RS 1713 CONTRACT NO. 61B65 SHEET NO. OF SHEETS STA. FED. ROAD DIST. NO. 1 | ILLINOIS | FED. AID PROJECT M-4003-(486)

