

STANDARDS 000001-05 001001-01

STATE OF ILLINOIS DEPARTMENT OF TRANSPORTATION DIVISION OF HIGHWAYS LEWIS & CLARK TOWERS

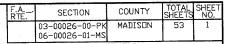

FEDERAL AID PROJECT

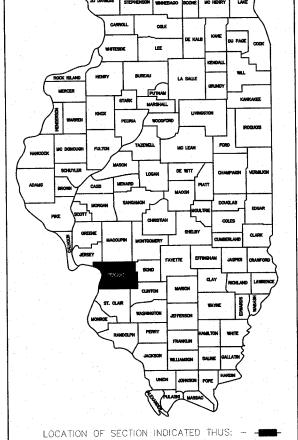

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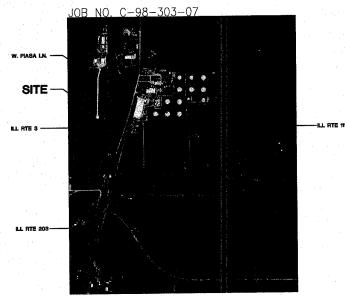
ROOF PLAN REFLECTED CEILING PLAN

EXTERIOR BUILDING ELEVATIONS EXTERIOR BUILDING ELEVATIONS EXTERIOR BUILDING ELEVATIONS

SCENIC BYWAY FUNDS:

SECTION <u>03-00026-00-PK/06</u>-00026-01-MS

VILLAGE OF HARTFORD



LOCATION MAP

NO SCALE



KAI

211 NORTH BROADWAY, SUITE 1900 ST. LOUIS, MO 63102 PH. (314) 241-8188



211 NORTH BROADWAY, SUITE 1900 ST. LOUIS, MO 63102 PH. (314) 241-8188 FAX (314) 241-0125

NUMBER

S.S.E. INC.

138 W. CLINTON PLACE

ST. LOUIS, MO 63122 PH. (314) 965-2233

FAX (314) 965-8269

081-005206

STRUCTURAL ENGINEER

CIVIL ENGINEER/ LAND SURVEY BLOTEVOGEL ASSOC. INC.

2 GINGER CREEK PARKWAY GLEN CARBON, IL 62034 PH. (618) 656-4166 FAX (618) 656-7127



MECHANIGAE DESIGN, & PLUMBING

211 NORTH BROADWAY, SUITE 1900 ST. LOUIS, MO 63102 PH. (314) 241-8188 FAX (314) 241-0125

ILLINOIS DEPARTMENT OF **TRANSPORTATION**

APPROVED DATE. WILLIAM MOORE JR. BOARD PRESIDENT DISTRICT #8 ENGINEER OF LOCAL ROADS & STREETS

DEPUTY DIRECTOR OF HIGHWAYS, BID BASED ON LIMITED REVIEW REGION #5 ENGINEER

> PRINTED BY THE AUTHORITY OF THE STATE OF ILLINOIS

UTILITIES

AMEREN UE (ELEC.) PO BOX 66529 ST. LOUIS, MO 63166 1-800-552-7583

AMEREN IP (GAS)

CHARTER COMMUNICATIONS (CABLE) 1048 STATE ST. EAST ST. LOUIS, IL 62201

1-800-211-4450

SBC (PHONE) 721 MISSOURI AVE EAST ST. LOUIS, IL 62201 618-875-9856

PO BOX 2543 DECATUR, IL 62525 1-800-755-5000

CONTRACT NO. 97331

JURISDICTION OF WOOD RIVER DRAINAGE & LEVEE DISTRICT

543 W. MADISON AVE. WOOD RIVER, IL 62095 (618) 254-7457 (618) 779-9176

MECHANICAL DRAWINGS

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GROUND FLOOR POWER PLAN LANDING ELECTRICAL PLANS LANDING ELECTRICAL PLANS ELECTRICAL SECTIONS

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FIRST FLOOR PLAN - FOUNTAIN PIPING - PLUMBING

FOUNTAIN ISOMETRIC & DETAILS- PLUMBING

LEGEND, SCHEDULES & DETAILS - PLUMBING

FLECTRICAL SYMBOLS AND ABBREVIATIONS

PLUMBING DRAWINGS

GEOTECHNICAL ENGINEER SCI ENGINEERING INC.

15 EXECUTIVE DRIVE, SUITE 4 FAIRVIEW HEIGHTS, IL 62208 PH. (618) 624-6969 FAX (314) 231-6733 FAX (618)

FAX (314) 241-0125

	SUMMARY OF QUANT	ITIE	ES					
COGED PAY ITEM	DESCRIPTION	UNIT	OUANT.	SBIL	ITEP	CONST. TYPE CODE Y 021	VILLAGE 20%	VILLAGE 100%
20200100	EARTH EXCAVATION	CU YD	14.798	7.779.0		11.838.4	2.959.6	
20800150	TRENCH BACKFILL	מץ עם	24.3		24.3	19.4	4.9	
25000910	SEEDING. CLASS 1 (MODIFIED)	ACRE	3.2	2.0	1.2	2.6	0.6	
25001850	SEEDING, CLASS 7 (MODIFIED)	ACRE	0.2	0.2		0.16	0.04	
25100630	EROSION CONTROL BLANKET	SQ YD	749	749.0		599.2	149.6	
25200100	SODDING	SQ YD	376		376.0	300.8	75.2	
28000250	TEMPORARY EROSION CONTROL SEEDING	POUND	1+040	520.0	520.0	832.0	208.0	
28000230	TEMPORARY DITCH CHECKS	EACH	1	1.0		0.8	0.2	
	PERIMETER EROSION BARRIER	FOOT	1.275	830.0	445.0	1.020.0	255.0	
28000400		EACH	2	2.0		1.6	0.4	
28000500	INLET AND PIPE PROTECTION	SO YO	35	22.0	13.0	28.0	7.0	
28100707	STONE DUMPED RIPRAP. CLASS A4	SQ YD	35	22.0	13.0	28.0	7.0	
28200200	FILTER FABRIC	SO YD	6.123	2.722.0	3,401.0	4.898.4	1.224.6	
30200650	PROCESSING MODIFIED SOIL 12"	TON	104	39.0	65.0	83.2	20.8	———
30201500	LIME	,	2.730	1.348.0	1.382.0	2.184.0	546.0	
31100100	SUB-BASE GRANULAR MATERIAL, TYPE A	TON				932.0	233.0	
40300100	BITUMINOUS MATERIALS (PRIME COAT)	GALLON	1.165	575.0	590.0	1		
40603065	HOT MIX ASPHALT BINDER COURSE. IL-19.0. N70	TON	492	243.0	249.0	393.6	98.4	
40603315	HOT MIX ASPHALT SURFACE COURSE. MIX "C". N70	TON	492	243.0	249.0	393.6	98.4	
42300400	PORTLAND CEMENT CONCRETE DRIVEWAY PAVEMENT, 8 INCH	SO YD	265	199.0	66.0	212.0	53.0	
42400100	PORTLAND CEMENT CONCRETE SIDEWALK 4 INCH	SQ FT	10.445	5.856.0	4,589.0	8.356.0	9.267.0	
42400800	DETECTABLE WARNINGS	SO FT	48	8.0	40.0	38.4	9.6	L
542A0229	PIPE CULVERTS. CLASS A. TYPE 1. 24"	FOOT	164	164.0		131.2	32.8	l
54213660	PRECAST REINFORCED CONCRETE FLARED END SECTIONS. 15"	EACH	1		1.0	0.8	0.2	
	PRECAST REINFORCED CONCRETE FLARED END SECTIONS. 24"	EACH	4	4.0		3.2	0.8	
54213669	FLUSH INLET BOX FOR MEDIAN. STANDARD 542546	EACH	1	1	1.0	0.8	0.2	1
54244405		FOOT	87		87.0	69.6	17.4	1
550A0070	STORM SEWERS, CLASS A, TYPE 1, 15"	FOOT	42	42.0		33.6	8.4	
56200900	WATER SERVICE LINE 2 1/2"	FOOT	1.959	947.0	1,012.0	1.567.2	391.8	t
60600605	CONCRETE CURB. TYPE B	FOOT	147	34110	147.0	117.6	29.4	t
60614600	PAVED DITCH (SPECIAL)	L SUM	1 1	0.3810	0.6190	0.8	0.2	
67100100	MOBILIZATION		1			0.8	0.2	
70101700	TRAFFIC CONTROL & PROTECTION	L SUM		0.5	0.5	0.8	0.2	
70102620	TRAFFIC CONTROL & PROTECTION STANDARD TO1501	L SUM	1 43	0.5	0.5	34.4	8.6	
72000100	SIGN PANEL - TYPE 1	SO FT		27.0	16.0			
73000100	WOOD SIGN SUPPORT	FOOT	204	156.0	48.0	163.2	40.8	ļ
78000100	THERMOPLASTIC PAVEMENT MARKING - LETTERS & SYMBOLS	SO FT	98	14.0	84.0	78.4	19.6	_
78000200	THERMOPLASTIC PAVEMENT MARKING - LINE. 4"	FOOT	3.596	1.444.0	2.152.0	2.876.8	719.2	ļ
78000600	THERMOPLASTIC PAVEMENT MARKING - LINE, 12"	FOOT	5	5.0	<u> </u>	4.0	1.0	1
X0322587	CONSTRUCTION ACCESS	EACH	1		1.0	0.8	0.2	
X0323256	REMOVE AND RELOCATE FLAGPOLE	EACH	1		1.0	0.8	0.2	
X5640175	FIRE HYDRANT COMPLETE	EACH	1		1.0	0.8	0.2	L
XX003526	DUCTILE IRON WATER MAIN FITTINGS. 8" X 6" REDUCER	EACH	1	T	1.0	0.8	0.2	1
XX003526	DUCTILE IRON WATER MAIN FITTINGS. 8" 45 DEGREE BEND	EACH	1	1	1.0	0.8	0.2	
	SANITARY SEWER SERVICE 6"	FOOT	43	43.0		34.4	8.6	T
XX003803		L SUM	1	———	1.0	0.8	0.2	1
XX003949	CONSTRUCTION SYAKING	FOOT	265	265.0	 	212.0	53.0	T
XX005452	FENCE RAIL	L SUM	1	0.3295	0.6705	0.8	0.2	1
XX007056	BUILDING	FOOT	633	1	1	506.4	126.6	—
XX007058	FUSION WELDED PIPE, 8" HIGH DENSITY POLYETHYLENE, SDR-11, 160 PSI	EACH	2	 	633.0		0.4	1
XX007059	MANHOLES (LEAKAGE TESTING)			 			0.4	
XX007060	MANHOLES, TYPE A. 4' DIAMETER, WATERPROOF FRAME & BOLTED LID	EACH	2	1	2.0			
XX007061	OUTFALL STRUCTURE	EACH	1 1		2.0		0.2	1
XX007062	REMOVE EXISTING CAP	EACH	1		1.0		0.2	
XX007063	REMOVE EXISTING PLUG	EACH	1	<u> </u>	1.0		0.2	1-
XX007064	WATER MAIN TRACER WIRE	FOOT	340	<u> </u>	1.0		68.0	
XX007065		EACH	1		340-0	0.8	0.2	1_
				T	1.0		1	L
l			1	1	1		1	1

* - SPECIALTY ITEMS

F.A. SECTION COUNTY TOTAL SHEET NO.

03-00026-00-PK MADISON 53 2

CONTRACT #97331

DA NOTES

- 1. EXISTING UTILITIES HAVE BEEN SHOWN ON THE PLANS FROM THE BEST INFORMATION AVAILABLE AND ARE GIVEN FOR THE CONTRACTOR'S CONVENIENCE. THE EXACT LOCATION MAY DIFFER FROM THAT SHOWN. IT IS THE CONTRACTOR'S RESPONSIBILITY TO NOTIFY ALL UTILITIES TO DETERMINE THE EXACT LOCATION. THE CONTRACTOR IS RESPONSIBLE FOR DAMAGE DONE TO ANY UTILITY DURING EXECUTION OF THIS WORK, IT IS UNDERSTOOM AND AGREED THAT THE CONTRACTOR HAS TAKEN THE FOREGOING INTO CONSIDERATION IN PREPARING HIS/HER BID, AND NO ADDITIONAL COMPENSATION WILL BE ALLOWED FOR ANY DELAYS OR INCONVENIENCE CAUSED BY SAME.
- THE CONTRACTOR IS RESPONSIBLE FOR KEEPING THE CONSTRUCTION SITE FREE OF DEBRIS AT ALL TIMES AND SHALL KEEP DIRT/MUD OFF ALL PUBLIC STREETS ADJACENT TO THE CONSTRUCTION SITE.
- 3. ALL DISTURBED AREAS, FOR WHATEVER REASON. SHALL BE SEEDED ACCORDING TO THE SPECIAL PROVISIONS.
- CONSTRUCTION CREWS, EQUIPMENT, TRUCKS, TRAILERS, BACKHOES, ETC. SHALL NOT BE PERMITTED TO PARK WITHIN THE PUBLIC RIGHT-OF-WAY ALONG CONFLUENCE TOWER DRIVE DURING THE CONSTRUCTION OF THIS PROJECT.
- 5. ANY FACILITIES OR APPURTENANCES WHICH ARE THE PROPERTY OF ANY PUBLIC UTILITY LOCATED WITHIN THE LIMITS OF CONSTRUCTION SHALL BE RELOCATED OR ADJUSTED BY THEIR RESPECTIVE DWWERS. THE CONTRACTOR SHALL NOTIFY AND COOPERATE WITH THE OWNERS OF ANY SUCH FACILITY IN THEIR REMOVAL AND REARRANGEMENT DEPERATIONS IN ORDER THAT THESE OPERATIONS AND THE CONSTRUCTION OF THIS PROPOSES IN A REASONABLE MANNER. ALL ROADSIDE OBJECTS (UTILITY POLES, FIRE HYDRANTS, SIGNS, ETC.) SHALL BE RELOCATED TO PROVIDE A MINIMUM OF 2 FEET CLEARANCE, MEASURED FROM THE PROPOSED CONSTRUCTION TO THE NEAR EDGE OF THE OBJECT.
- THE CONTRACTOR SHALL VERIFY ALL DIMENSIONS AND CONDITIONS IN THE FIELD PRIOR TO ORDERING MATERIALS AND COMMENCING CONSTRUCTION.
- 7. THE CONTRACTOR SHALL CONFINE ALL OPERATIONS WITHIN THE CONSTRUCTION LIMITS. ANY AREA DISTURBED BEYOND THESE LIMITS SHALL BE RESTORED TO ITS ORIGINAL CONDITION AT THE CONTRACTOR'S EXPENSE.
- 8. FOR WORK PERFORMED WITHIN THE RIGHT-DF-MAY OF CONFLUENCE TOWER DRIVE. TRAFFIC CONTROL SHALL BE ACCORDING TO 1.D.O.T. HIGHWAY STANDARDS 702001 AND 701301.
- 9. ELEVATION CONVERSION FROM CIVIL DRAWINGS TO ARCHITECTURAL, STRUCTURAL, AND OTHER DRAWINGS IS AS FOLLOWS: EL. $435.50^\circ = \text{EL.} 100^\circ 0^\circ$

211 North Broadway 5ults 1900 Sults 1900 St. Louds Missouri 63102 ph. (314) 541-0125 N. N. E. D. Y fax. (314) 541-0125



"NO COMMITMENTS"

Lewis and clark Memorial Tower

> MOTES OF QUANTITIES


NO. REMARKS DATE

KENNEDY PROJECT N 10-02048

ISSUE DATE
SHEET NO.

0.0

C-01_SUMMARY.dgn 4/29/2008 8:46:49 AM

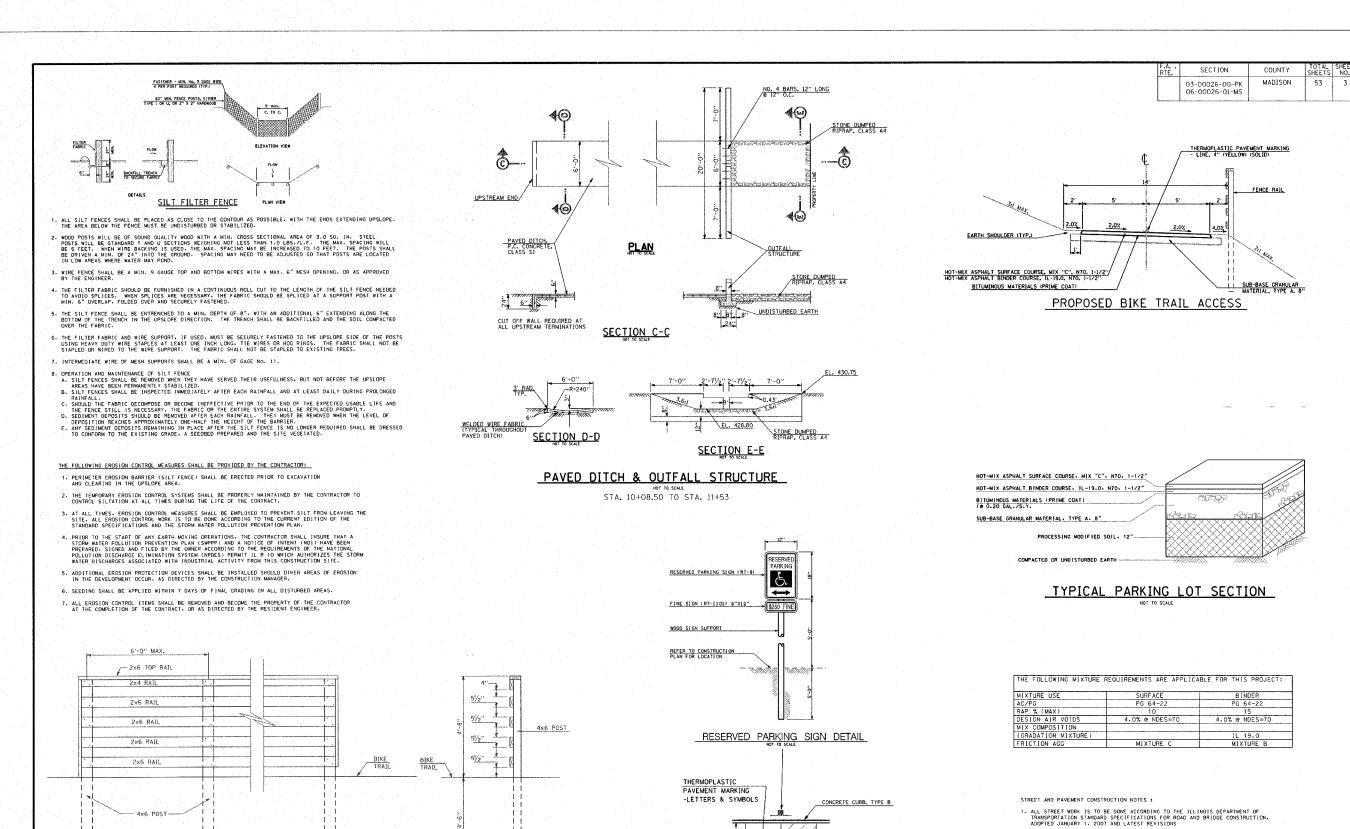

SECTION A-A

INSIDE RAIL ELEVATION

_,NC-02_03_04_DETLS.dgn_4/11/2008-8:28:46 AMT

FENCE RAIL DETAILS

STA. 1+11.40 TO STA. 3+67.13

KENNEDY PROJECT N ISSUE DATE

Lewis and clark Memorial Tower

Broadway Missourt 6 241-8188 541-0125


211 North B Sulte 1900 St. Louis, N ph (314) 24 fax (314) 5

SHEET NO.

 ALL CONCRETE PAVEMENT AND DRIVEWAYS SHALL BE POURED SO THAT NO FINISHED PANEL EXCEEDS 15' ALONG ANY EDGE. UNLESS SHOWN OTHERWISE. 3. ALL CONSTRUCTION JOINTS SHALL BE TIED USING #6 BARS, 30" LONG AT 24" O.C.. SAWED TRANSVERSE JOINTS (1/8" x 2") SHALL BE CREATED AT 15' INTERVALS. BARS ARE NOT REQUIRED. JOINTS TO BE SEALED WITH HOT POURED JOINT SEALER IN ALL CONCRETE CONSTRUCTION.


5. EMBANKMENT SHALL BE PLACED AS REQUIRED IN SECTION 205 OF THE ILLINDIS DEPARTMENT OF TRANSPORTATION STANDARD SPECIFICATIONS FOR ROAD AND BRIDGE CONSTRUCTION-ADDRED JANUARY 1. 2007 AND LATEST REVISIONS. CONTRACTOR SHALL SUBMIT TO THE RESIDENT ENGINEER DUCLMENTATION OF COMPACTION TESTS FOR WRITTEN APPROVAL OF SAID COMPACTION PRIOR TO CONSTRUCTION OF ANY PAVEMENT/SIDEWALD.

CUT SECTIONS SHALL BE PROOF ROLLED AND APPROVED BY THE RESIDENT ENGINEER PRIOR TO CONSTRUCTION OF ANY PAVEMENT/SIDEWALK.

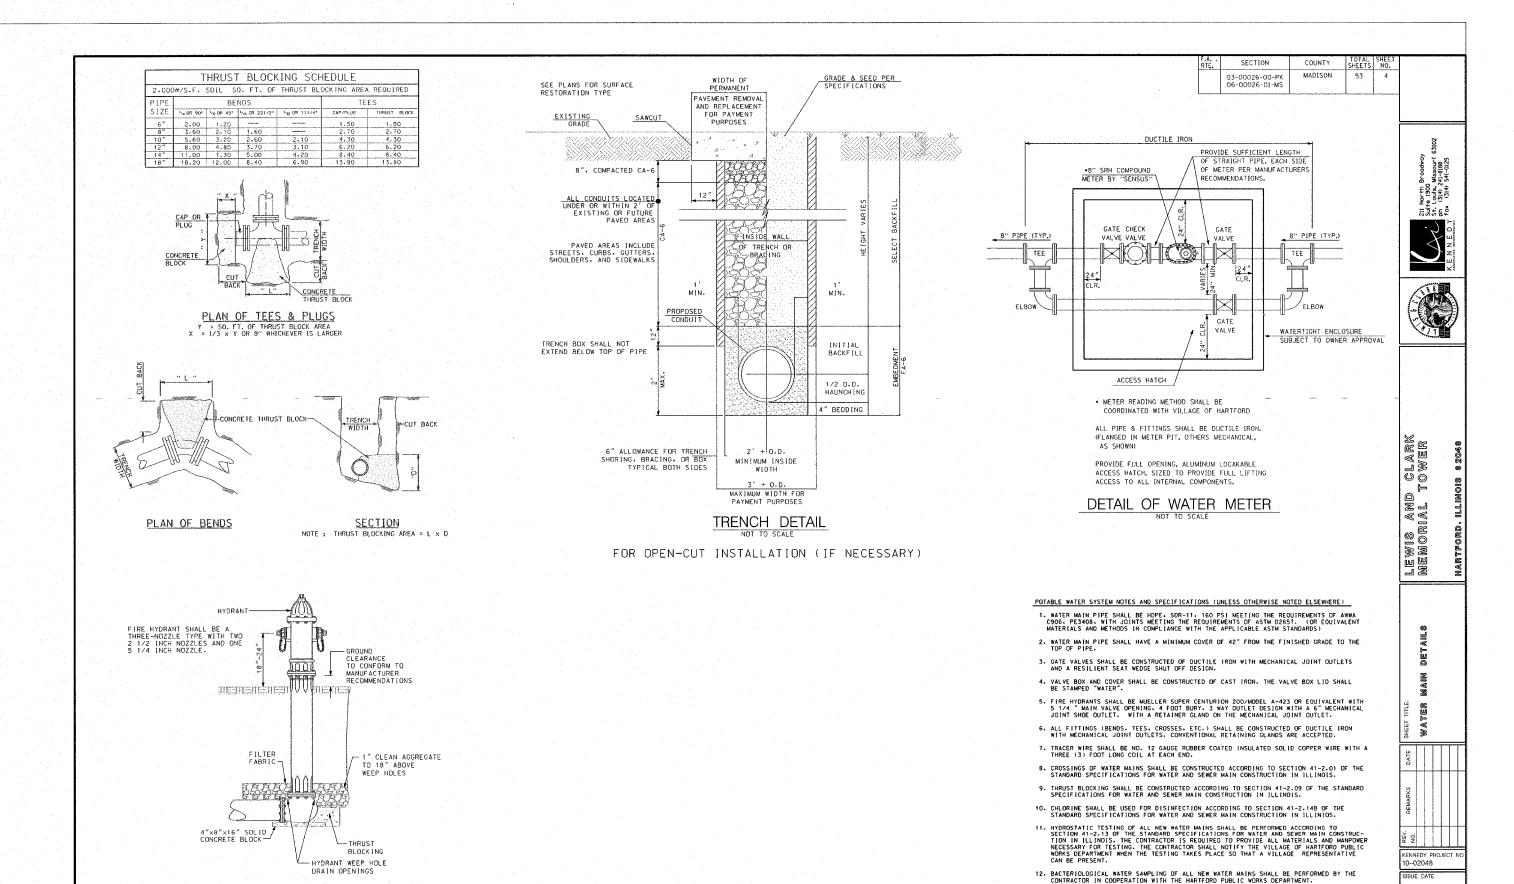

FIRE HYDRANT DETAIL

13. THE HARTFORD PUBLIC WORKS DEPARTMENT SHALL BE RESPONSIBLE FOR TURNING ON THE NEW WATER MAIN EXTENSION AND IT SHALL NOT BE CONSIDERED COMPLETE UNTIL ACCEPTED IN WRITING BY THE VILLAGE OF HARTFORD.

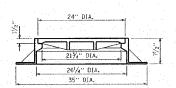

WATERPROOF FRAME AND BOLTED LID

ALL MANHOLE FRAMES AND LIDS SHALL BE NEEMAH TYPE R-1916D, OR EOUTVALENT. THE MANHOLE LID SHALL HAVE A CONCEALED PICKHOLE LESS THAN 1" IN DIA. AND SHALL HAVE CAST IN THE CENTER THE WORD "SANITARY". MASTIC SEALANT SHALL BE APPLIED BETWEEN THE CONCRETE AND FLANGE OF THE FRAME BEFORE THE LID BOLTS ARE TIGHTENED.

3 1/2"

MANHOLE STEP. PLASTIC


STEPS SHALL BE MADE OF


POLYPROPYLENE PLASTIC AND CONFORMING TO O.S.H.A. REQUIREMENTS.

A 1/8" REINFORCING ROD ENCAPSULATED IN A COPOLYMER


STEPS SHALL BE 12" WIDE

WITH 10" LEGS AND 12"O.C.

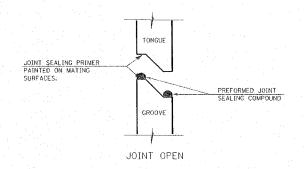


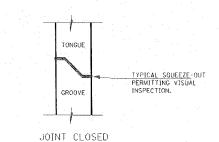

WATER TIGHT JOINT DETAIL

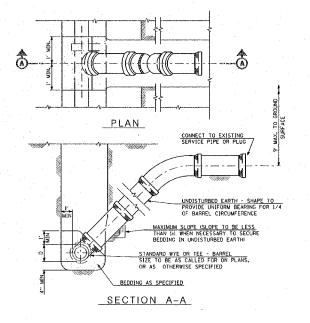

TYPICAL RISER FOR SERVICE LATERAL NOT TO SCALE

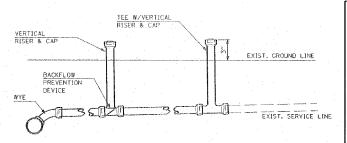

TYPICAL CLEAN OUT DETAIL



211 North Broadway Suite 1900 St. Louis, Missouri 6 ph (314) 241-8188 fax (314) 541-0125

M &

LEWIS AND CLARK MEMORIAL TOWER

in sewer details

SHEET TITLE:

T DATE

REMARKS

KENNEDY PROJECT NO 10-02048

ISSUE DATE

SHEET NO.

GROUND

ADJUST SEE
SECTION 32-3.09
ECCENTRIC TOP OR
STANDARD TOP
AS REQUIRED

WATER TIGHT JOINT


STEPS AT
16" O.C.

GROUT

BOTTOM SLAB: 3500 PSI CONCRETE OR PRECAST REINFORCED CONCRETE SLAB ON 6" SAND CUSHION BOTTOM SLAB, MAY BE PRECAST MONOLITHIC WITH MANHOLE WALL SECTION

SECTION A-A

IF AREA UNDER THE MANHOLE IS DISTURBED DURING CONSTRUCTION, THE BACKFILL SHALL BE THOROUGHLY COMPACTED TO THE SATISFACTION OF THE ENGINEER.

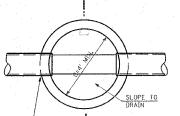

MATERIAL WALL THICKNESS (T)

PRECAST CONC. MIN 1/12 "D" CAST-IN-PLACE CONC. MIN. 6"

(P)

SECTIONAL PLAN

RUBBER GASKETED COUPLINGS FOR SANITARY MANHOLES PER ASTM C-923


STEPS REQUIRED, UNLESS DELETED BY SPECIAL PROVISIONS.


MANHOLE, TYPE A


SEPARATE SANITARY SEWER MANHOLES SUBJECT TO SATURATED SOIL CONDITIONS OR SURFACE SUBMERGENCE SHALL BE EQUIPPED WITH CHIMNEY SEALS AND WATER TIGHT MANHOLE COVERS.


SANITARY SEWER SYSTEM NOTES AND SPECIFICATIONS (UNLESS NOTED OTHERWISE ELSEWHERE)

- 1. ALL SANITARY SEWER WORK SHALL BE COMPLETED ACCORDING TO THE STANDARD SPECIFICATIONS FOR WATER AND SEWER MAIN CONSTRUCTION, IN ILLINOIS, ADOPTED MAY, 1996, AND LATEST REVISIONS.
- 2. SANITARY SEWER PIPE SHALL BE AS SHOWN ON THE CONSTRUCTION PLANS AND AS DESCRIBED IN THE SPECIAL PROVISIONS
- 3. SEWER LINES SHALL BE LOCATED AT LEAST 10 FEET HORIZONTALLY FROM ANY EXISTING OR PROPOSED WATER MAIN OR SERVICE CONNECTION. THE SEWER LINE SHALL BE SEPARATED FROM A WATER MAIN SO THAT ITS CROWN IS A MINIMUM OF 18 INCHES BELOW THE INVERT OF THE WATER MAIN OR SERVICE EXCEPT AS PROVIDED IN THESE PLANS OR IN THE SPECIAL PROVISIONS.
- 4. ALL MANHOLES SHALL BE TYPE "A" IN DESIGN AND 4' MIN. IN DIAMETER. EQUIPPED WITH A-LOCK RUBBER GASKETS. RISERS AND SLABS SHALL BE ACCORDING TO ASTM C478. LIFTING HOLE SHALL BE PROVIDED IN THE BASES AND RISERS. LIFTING HOOKS SHALL BE PROVIDED IN FLAT SLABS. MANHOLE STEPS SHALL BE CONSTRUCTED OF COPOLYMER POLYPROPYLENE PLASTIC.
- 5. MANHOLES (LEAKAGE TESTING)-PRIOR TO PLACING THE COMPLETED SANITARY SYSTEM IN SERVICE. EACH MANHOLE SHALL BE TESTED FOR LEAKAGE ACCORDING TO ASTM C1244-02. FAILING MANHOLES SHALL BE REPAIRED AND RETESTED AS NECESSARY TO ACHIEVE AN ACCEPTABLE RESULT.
- 6. THE CONTRACTOR SHALL BE RESPONSIBLE FOR MAINTAINING THE REQUIRED SLOPE ON ALL SANITARY SEWER PIPE AND THE REQUIRED ELEVATIONS OF ALL MANHOLES. MINIMUM SLOPE FOR ALL SANITARY SEWER SERVICE PIPE SHALL BEY" PER FOOT.
- 7. CONTRACTOR SHALL PROVIDE 48 HOUR NOTICE OF TESTING FOR OBSERVATION BY VILLAGE OF HARTFORD PUBLIC WORKS DEPARTMENT PERSONNEL.
- 8. THE END OF EACH SERVICE LATERAL SHALL BE MARKED WITH A TREATED 2" BY 4" STAKE LEFT AT LEAST 3 FEET ABOVE THE FINISHED GRADE.
- ALL DISTURBED AREAS. FOR WHATEVER REASON. SHALL BE GRADED TO AS NEAR ITS ORIGINAL STATE AND SEEDED ACCORDING TO THE SPECIAL PROVISIONS.
- SEE TRENCH DETAIL, SHEET C-03 FOR SANITARY SEWER INSTALLATION-OPEN CUT INSTALLATION (IF NECESSARY).

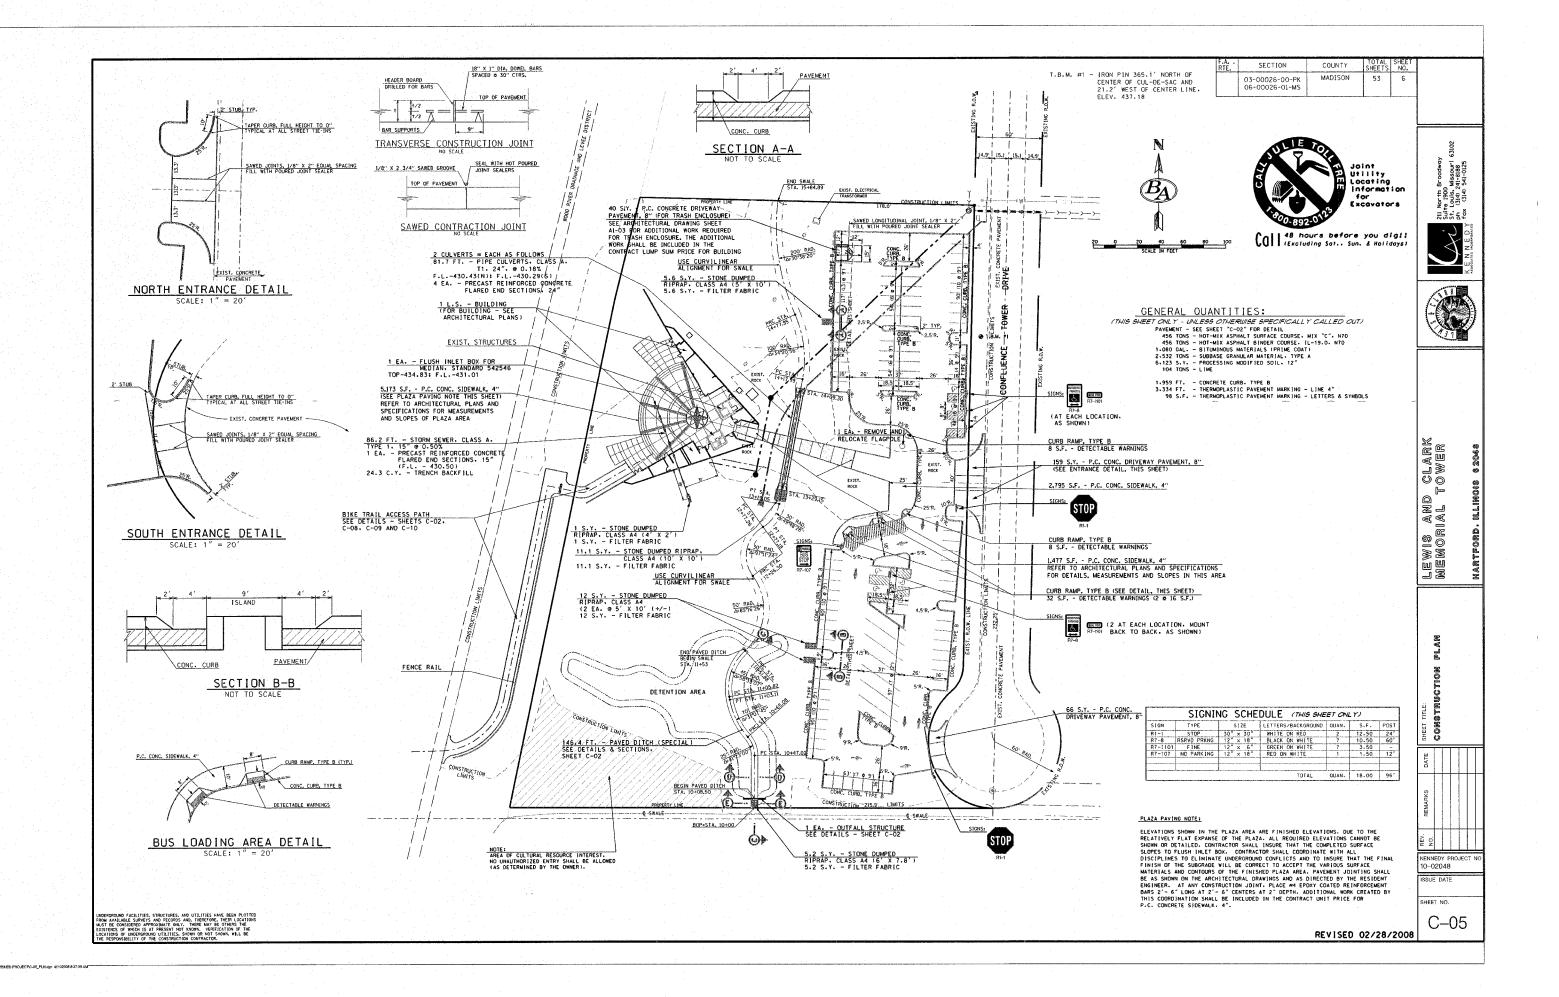


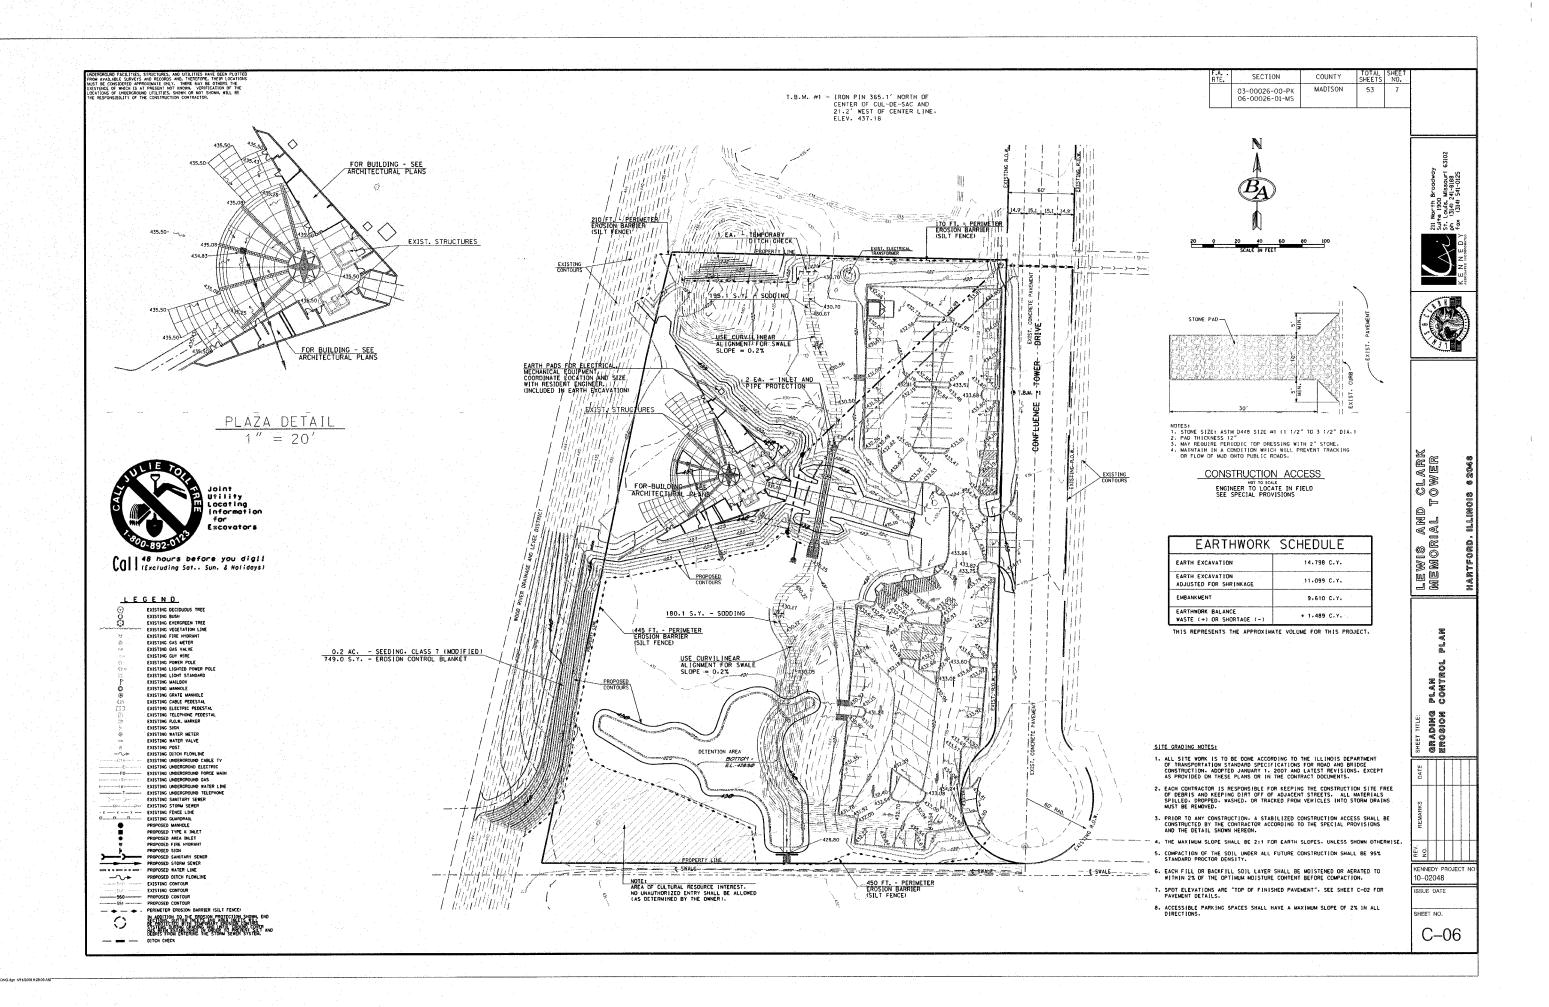

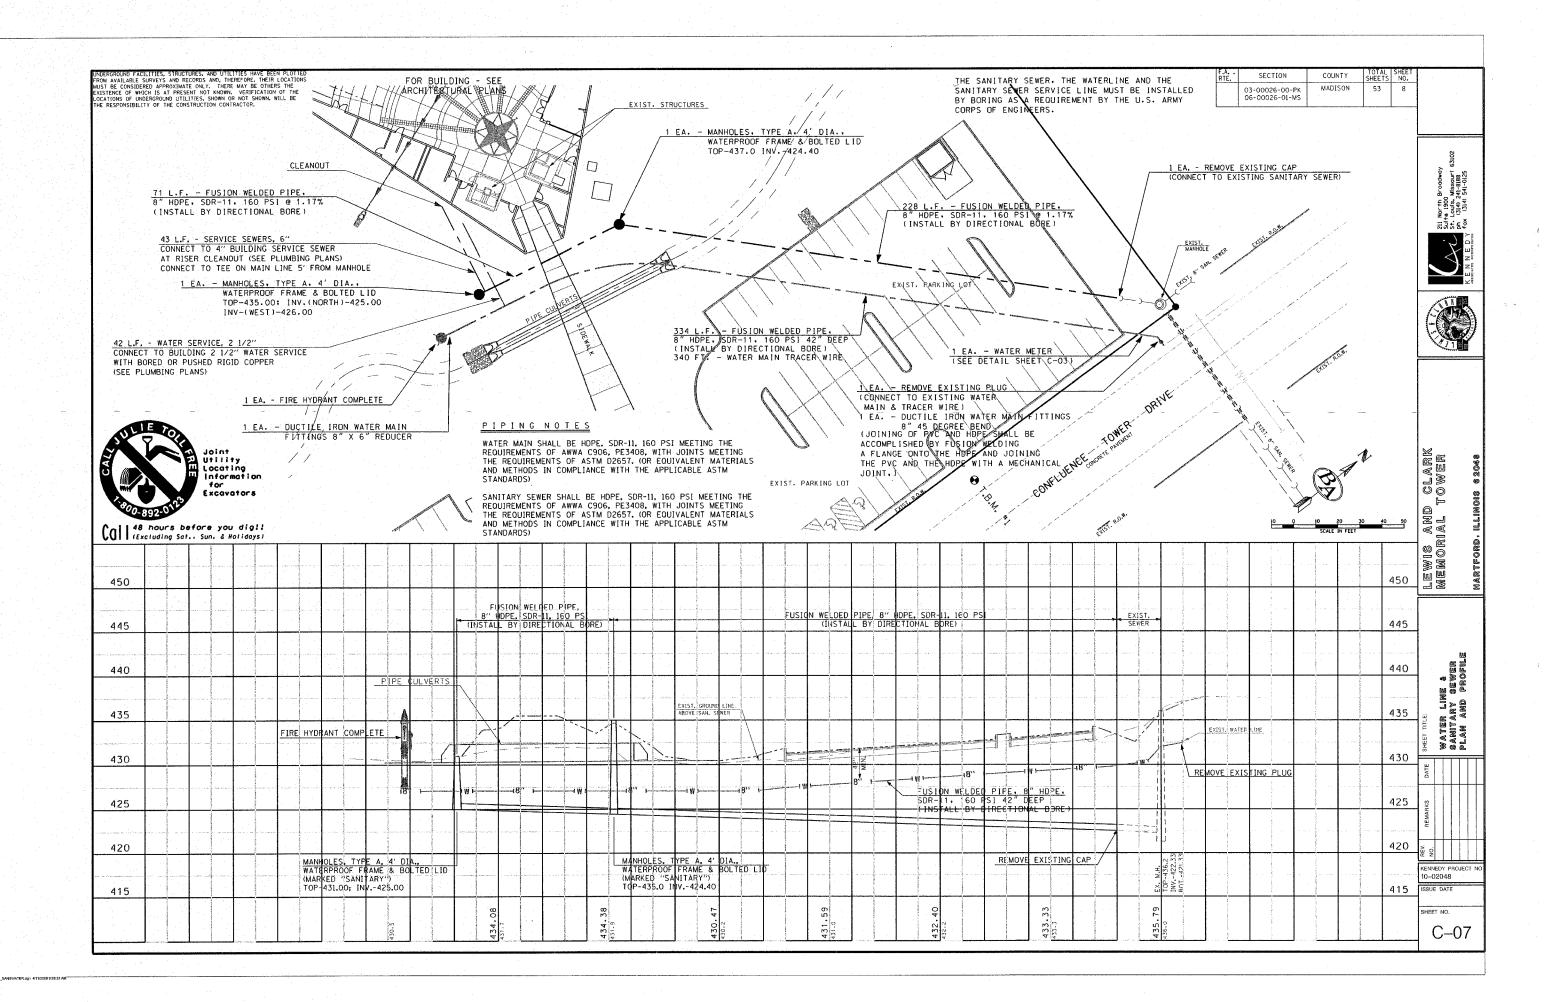

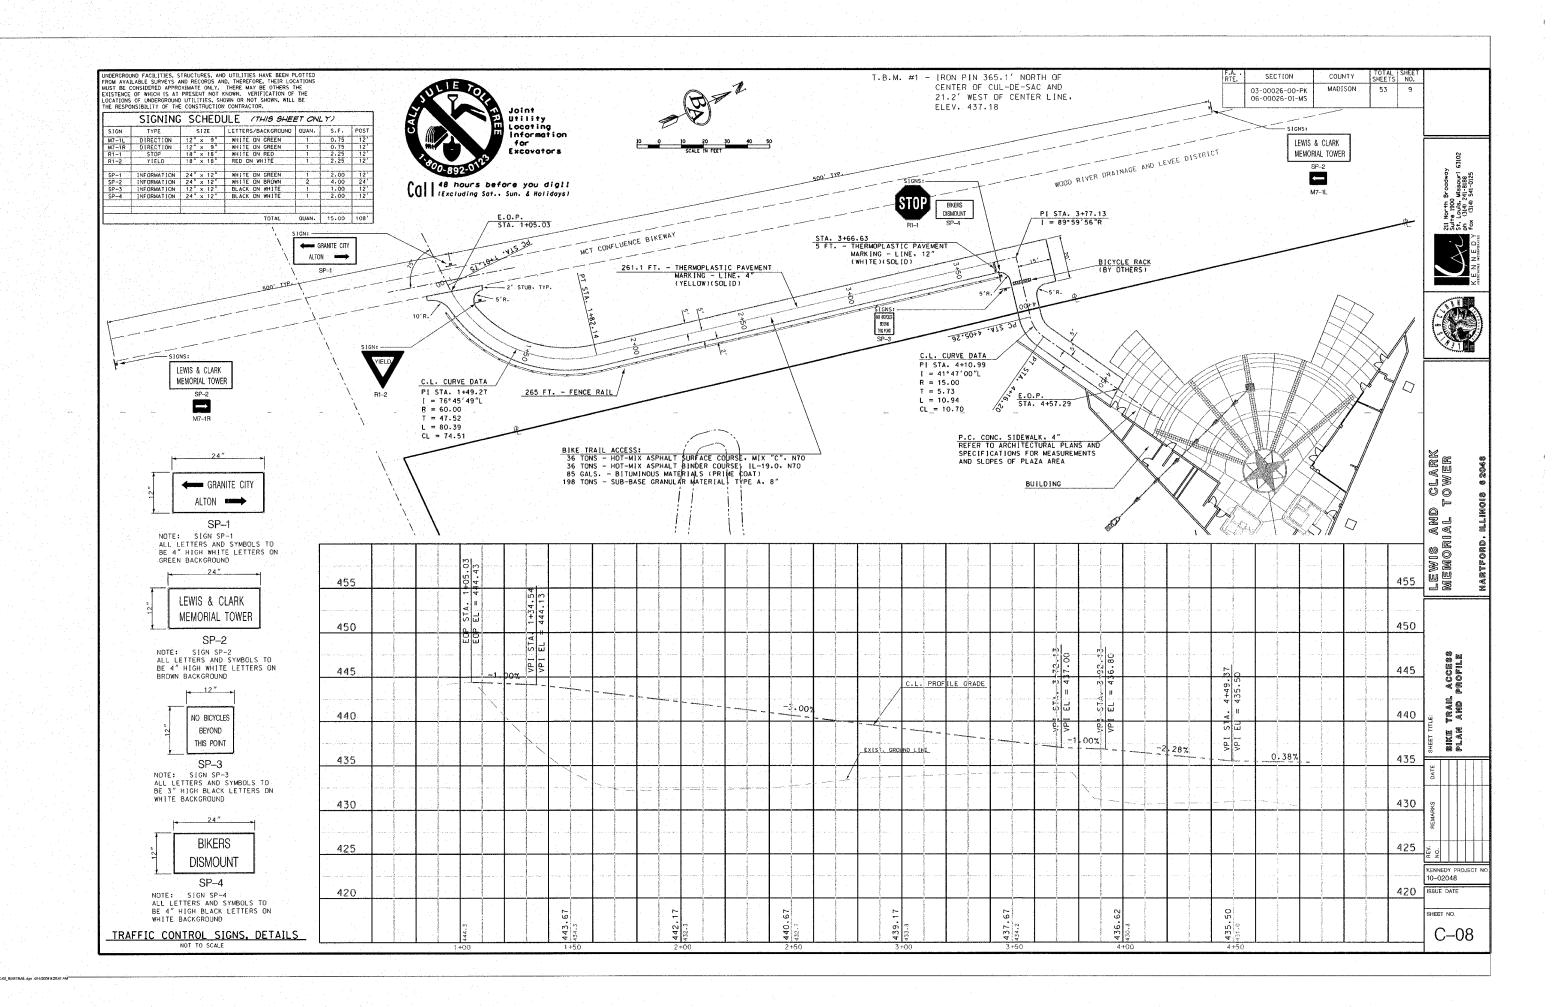

F. Ri	TE.	SECTION	COUNTY	TOTAL	SHEET NO.
		03-00026-00-PK 06-00026-01-MS	MADISON	53	ITO
-					

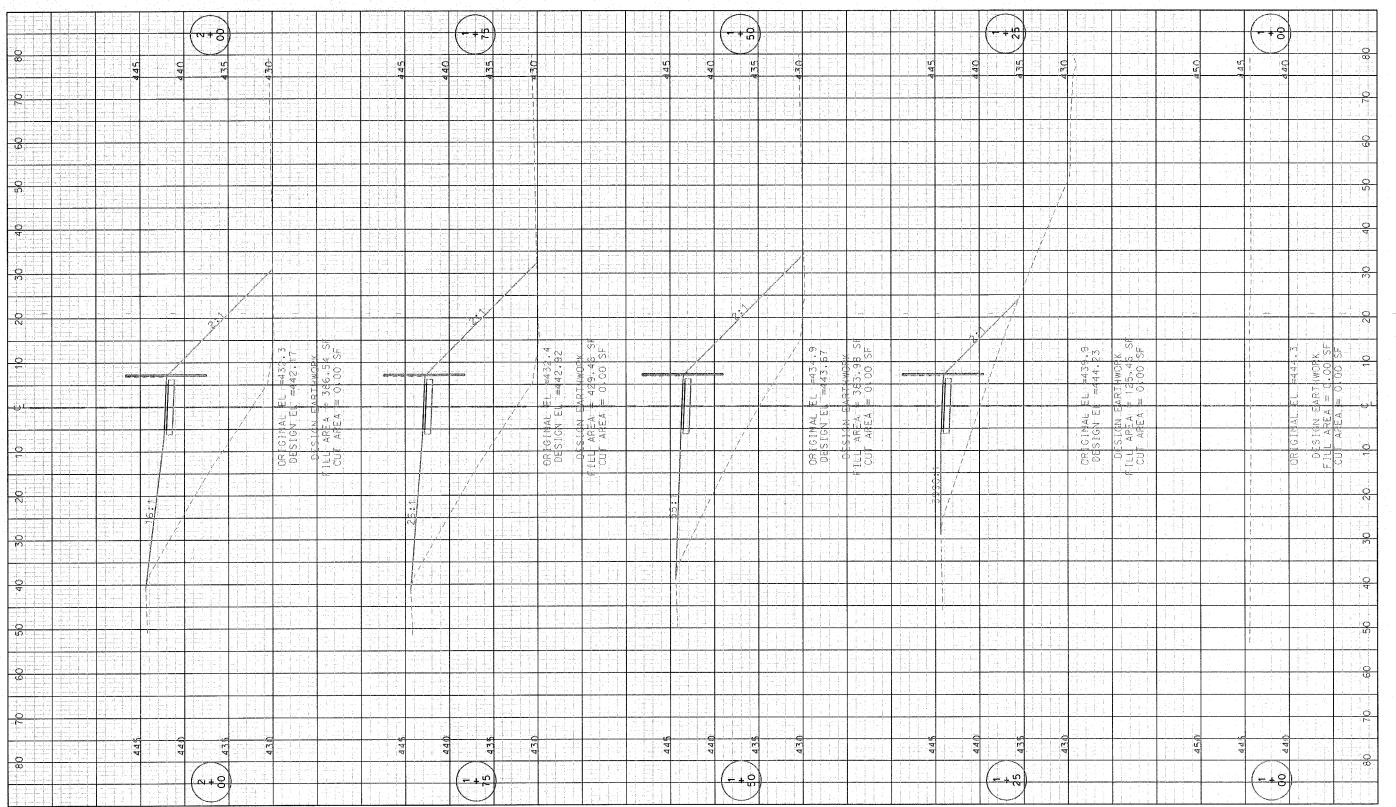

LEWIS AND CLARK MEMORIAL TOWER VILLAGE OF HARTFORD, ILLINOIS

211 North Broodway
Suffe 1900
51, 10416 1900
51, 10416, Missourf 63102
KE N N E DY 104 (314) 241-8188
KE N N E DY 104 (314) 241-8188

140 West Hawthorne Hartford, Illinois 62048


bike trail access cross sections

NO.

KENNEDY PROJECT NO 10-02048

SHEET NO.

F.A. RTE.	SECTION	COUNTY	TOTAL	SHEET NO.
	03-00026-00-PK 06-00026-01-MS	MADISON	53	11

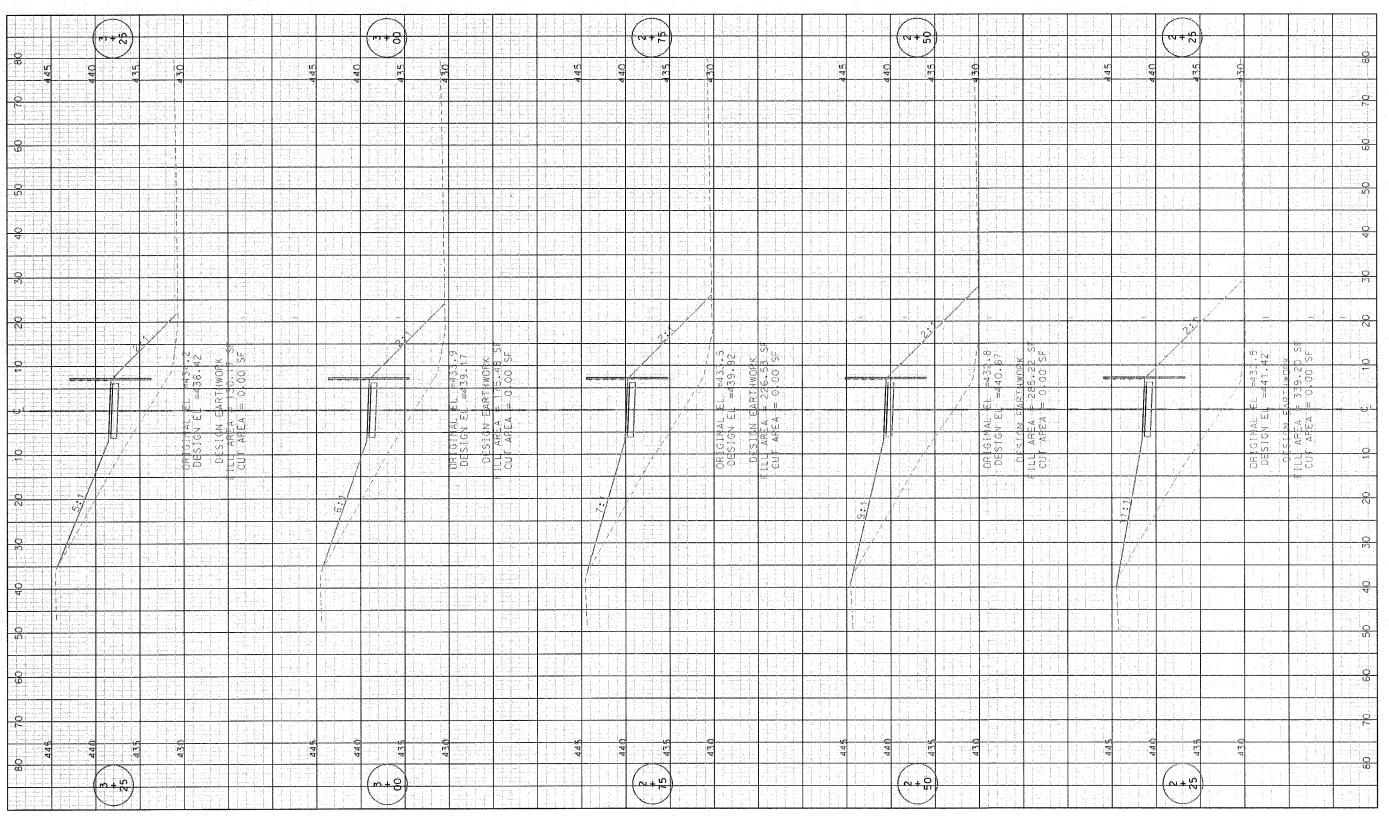

Lewis and clark memorial tower Village of Hartford, Illinois


211 NOTTH Broadway
5.4174 1900 MISSOUR 63102
51.7 1914 241-9125
51.9 1914 241-9125
51.9 1914 241-9125

140 West Hawthorne Hartford, Illinois 62048

bike trail access cross sections

KENNEDY PROJECT NO 10--02048

HEET NO.

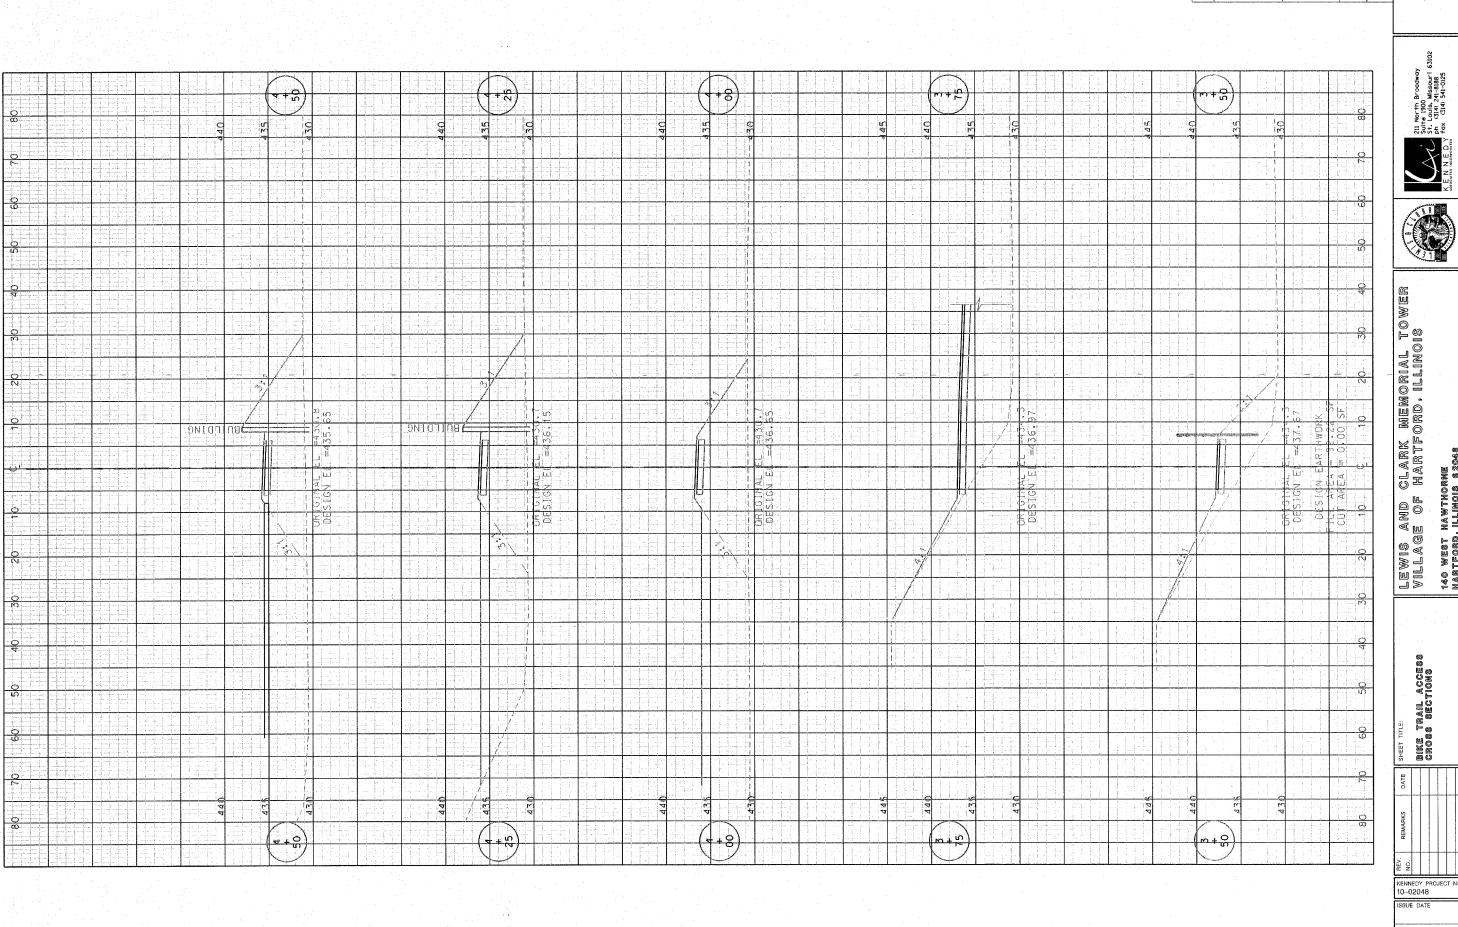

TOTAL SHEET NO. SECTION COUNTY 03-00026-00-PK 06-00026-01-MS MADISON


LEWIS AND CLARK MEMORIAL TOWER VILLAGE OF HARTFORD, ILLINOIS

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bike trail access cross sections


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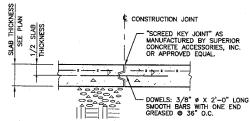
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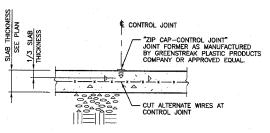
TYPICAL RETAINING WALL CONTROL JOINT AT 20'-0 C/C MAXIMUM (OR AS NOTED)

TYPICAL RETAINING WALL EXPANSION JOINT




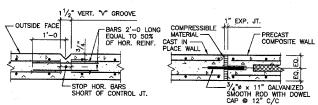


TYP. SLAB ON GRADE CONSTRUCTION JOINT

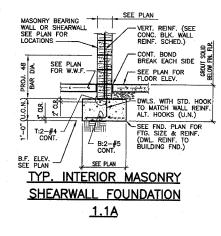

TYP. SLAB ON GRADE CONTROL JOINT CONTROL JOINTS AT 15'-0" O.C. MAXIMUM E.W., OR AS SHOWN ON PLAN

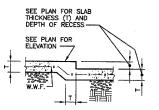

TYP. RECESS AT SLAB ON GRADE

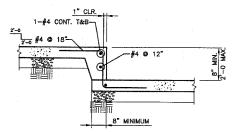


TYPICAL STEP IN SLAB ON GRADE NOTES: 1. SEE PLAN FOR SLAB THICKNESS, SLAB REINFORCING, AND DEPTH OF STEP.

2. SEE DETAIL "A" WHERE TRENCH DRAIN OCCURS.


CONCRETE S	TRENGTH SCHEDULE
MEMBER	28 DAY COMPRESSIVE STRENGTH (fc')
CAST IN PLACE WALL	4,000 PSI
ALL OTHERS INCLUDING: FOOTING, ETC.	3,500 PSI

CONCRETE BLOCK WALL REINFORCING SCHEDULE								
	VERTICAL REINFORCING	HORIZ	ZONTAL REINFO	RCING (GALVAN	IZED)			
THICKNESS	(GROUT SOLID)	TYPE	SIDE ROD	CROSS ROD	SPACING			
6*	#4 @ 24" (2'-6 LAP)	LADDER	0.148*ø	0.148 " ø	16"			
8"	#5 @ 32" (2'-6 LAP)	LADDER	0.188"ø	0.148 " ø	16"			
12"	#6 @ 32" (3'-0 LAP)	LADDER	0.188″ø	0.148*ø	16*			


NOTE: FOOTING DOWELS TO MATCH WALL REINFORCING (TYP. U.N.O.).

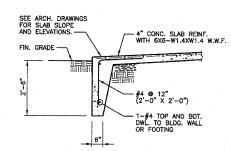


TYPICAL FROSTWALL

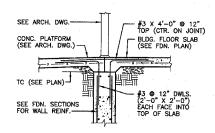

TYPICAL TOP OF WALL AT DOORWAY

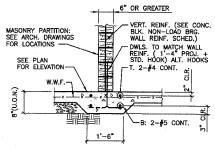

TYPICAL NON-LOAD BEARING MASONRY PARTITION FOUNDATION

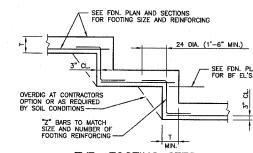

TYP. FOOTING STEP

DESIGN INFORMATION

- 1. BUILDING CODE: BOCA 1999 2. FLOOR LIVE LOADS (PSF): N/A

- 1. BUILDING CODE: BOCA 1999
 2. FLOOR LIVE LOADS (PSF): N/A
 3. ROOF LIVE LOAD (PSF): 30
 4. ROOF SNOW LOAD:
 A. GROUND SNOW LOAD (PSF), Pg = 20
 B. FLATROOF SNOW LOAD (PSF), Pf = 14
 C. SNOW EXPOSURE FACTOR, Ce = 0.9
 D. SNOW MEPORTANCE FACTOR, I = 1.0
 E. ROOF THERMAL FACTOR, Ct = 1.0
 E. ROOF THERMAL FACTOR, Ct = 1.0
 E. ROOF THERMAL FACTOR, Ct = 1.0
 C. WIND LOAD:
 A. BASIC WIND SPEED (MPH): 70
 B. WIND LOAD:
 DO CONTROL CONTROL

GENERAL NOTES

IN FIELD LAYOUT AND SHOP DETAILING, THE CONTRACTOR MUST VERIFY AND COORDINATE DIMENSIONS ON ARCHITECTURAL, MECHANICAL AND STRUCTURAL DRAWINGS AND REPORT ANY DISCREPANCIES TO THE ARCHITECT. ALL EXISTING DIMENSIONS AND CONDITIONS MUST BE FIELD VERIFIED BY CONTRACTOR.

FOUNDATIONS

- FOOTINGS HAVE BEEN PROPORTIONED FOR A NET MAXIMUM BEARING PRESSURE OF 2500 P.S.F. FOR ISOLATED COLUMN FOOTINGS & 2000 P.S.F. FOR CONTINUOUS FOOTINGS.
- FOOTINGS MUST EXTEND 2'-6 BELOW FINISHED GRADE, AND ARE TO BEAR ON UNDISTURBED SOIL OR ENGINEERED COMPACTED FILL.

GENERAL CONCRETE NOTES

- REINFORCING BARS SHALL CONFORM TO ASTM A615, GRADE 60 STEEL, UNLESS NOTED OTHERWISE.
- 3. ALL DETAILING, FABRICATION AND PLACEMENT OF BARS AND ALL DEPAIRING AND AND PLACEMENT OF BARS AND THEIR SUPPORT IN THE FORMS WITH ACCESSORIES, UNLESS NOTED OTHERWISE, MUST FOLLOW THE ACI "MANUAL OF STANDARD PRACTICE FOR DETAILING REINFORCE CONCRETE STRUCTURES". (ACI 315 LATEST). REINFORCING STEEL PLACING DRAWINGS WILL MEET THE FOLLOWING MINIMUM REQUIREMENTS IN ADDITION TO THOSE STATED ABOVE:
- A. REINFORCING PLACING DRAWINGS FOR SLABS, BEAMS, JOISTS ETC. WILL BE SHOWN ON PLANS DRAWN TO A MINIMUM SCALE OF 1/8" = 1'-0". MINIMUM SHEET SIZE WILL BE 24" X 36".
- B. REINFORCING FOR FOUNDATION WALLS, RETAINING WALLS, SHEAR WALLS ETC. WILL BE SHOWN ON ELEVATIONS DRAWN TO A MINIMUM SCALE OF 1/4" = 1'-0".
- C. REINFORCING FOR BEAMS, COLUMNS AND SLABS MUST BE CLEARLY SHOWN IN SCHEDULES SIMILAR TO THOSE ON THE STRUCTURAL DRAWINGS. COMPUTER FRINT—OUTS ATTACHED TO LARGER SHEETS AND REPRODUCED AS SHOP DRAWINGS WILL NOT BE PERMITED.
- D. LOCATION OF REINFORCING NOT CLEARLY DESCRIBED IN SCHEDULED FORMAT MUST BE REFERENCED ON PLACING PLANS.
- CONCRETE COVER OVER MAIN REINFORCING SHALL BE AS FOLLOWS: FOOTINGS 3", COLLUMNS AND BEAMS 2", SOLID SLASS 1" AND WALLS 2" WHERE EXPOSED TO WEATHER OR GROUND AND 1" FOR INTERIOR SURFACES.
- ALL BARS IN WALLS AND GRADE BEAMS AND TEMPERATURE BARS IN SLABS SHALL LAP A MINIMUM OF 30 DIAMETERS (24" MIN). SEE PLAN FOR SPECIAL REQUIREMENTS FOR BEAMS, COLUMNS, ETC. ANY SPLICE OF BARS OTHER THAN SHOWN ON PLANS MUST HAVE PRIOR APPROVAL OF THE ENGINEER.
- WELDED WIRE FABRIC MUST LAP A MINIMUM OF 1'-0" AND SHALL EXTEND 1'-0" INTO SUPPORTING BEAMS AND WALLS UNLESS EXPANSION JOINT IS CALLED FOR. WELDED WIRE FABRIC SHALL BE PLACED ON TOP OF ALL OTHER BARS, SLEEVES, CONDUITS, ETC.
- PROVIDE THE FOLLOWING ADDITIONAL REINFORCING UNLESS OTHERWISE CALLED FOR ON STRUCTURAL PLANS;
- A. 2-#5 BARS EACH SIDE OF 12" OR LARGER OPENINGS IN SLABS AND WALLS.
 B. CORNER BARS (2'-0" X 2'-0") IN OUTER FACE OF ALL CONCRETE WALLS AND GRADE BEAMS TO MATCH SIZE AND SPACING OF BARS IN WALL OR BEAM.
 C. WALLS, UNLESS NOTED OTHERWISE, #4012" EACH WAY, EACH FACE AND 2-#5 TOP AND BOTTOM.
- 8. ALL DOWELS MUST BE IN POSITION BEFORE PLACING CONCRETE PUSHING BARS INTO FRESHLY PLACED CONCRETE IS NOT ACCEPTABLE. PROVIDE ADDITIONAL SUPPORT BARS AS NECESSARY TO KEEP DOWELS IN PLACE.
- ALL STRUCTURAL STEEL MUST BE PROTECTED BY 3" OF CONCRETE WHERE EARTH WOULD OTHERWISE BE IN CONTACT WITH STEEL.
- ALL ABUTTING CONC. SHALL BE DOWELED TOGETHER UNLESS POURED MONOLITHIC. DOWELS SHALL BE EQUAL IN SIZE AND SPACING TO THE REINFORCING IN THE ABUTTING MEMBERS.
- 11. WHEN FOUNDATION WALLS SPAN FROM GROUND FLOOR TO FIRST FLOOR, BOTH GROUND FLOOR SLAB AND FIRST FLOOR SLAB MUST BE IN PLACE BEFORE BACKFILL IS PLACED, UNLESS NOTED OTHERWISE.
- UNLESS NOTED OTHERWISE.

 2. THE ARCHITECTURAL, MECHANICAL AND ELECTRICAL DRAWINGS MUST BE REFERRED TO FOR ALL FLOOR, ROOF AND WALL REQUIREMENTS SUCH AS SLEEVES, OUTLET BOXES, ANCHORS, VENT OPENINGS, ETC., THAT MAY BE REQUIRED. HOLES OR NOTCHES WILL NOT BE ALLOWED IN ANY CONCRETE FRAMING UNLESS SIZE AND LOCATION HAVE BEEN APPROVED BY THE ENGINEER.
- 13. WHERE EPOXY DOWELS ARE INDICATED, INSTALL PER MANUFACTURERS RECOMMENDATIONS WITH ITW RAMSET/REDHEAD EPCON EPOXY SYSTEM, SIMPSON EPOXY-TIE ADHESIVE OR ANCHOR-IT EPOXY SYSTEM.

ABBREVIATION LIST

ABBREVATION LIST

BD = BOTTOM OF PECK
BF = BOTTOM OF POOTING
BP = BEAM POCKET
BS = BRICK SHELF
BW = BOTTOM OF WALL
CJP = COMPLETE JOINT
PENETRATION
CP = COLUMN POCKET
CS = CONCRETE SHELF
SW = SHEAR WALL
TC = TOP OF CONCRETE
TF = TOP OF FOOTING
TP = TOP OF POOTING
TP = TOP OF STEEL
TW = TOP OF WALL
UNO = UNLESS NOTED
OTHERWISE



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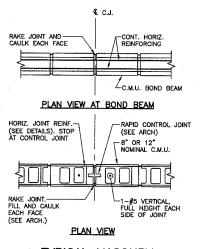
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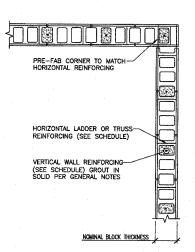
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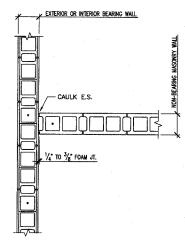
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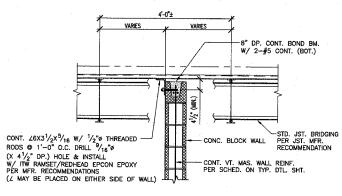
TYPICAL MASONRY WALL CONTROL JOINT SEE MASONRY NOTE #17 FOR LOCATION OF CONTROL JOINTS.




TYP. REINFORCED MASONRY WALL




TYP. INTERSECTION @ BEARING & NON-BEARING MASONRY WALLS NOTE; NON-BEARING MASONRY WALLS SHOWN ON ARCHITECTURAL PLANS ONLY.



TYPICAL MASONRY SHEARWALL CONNECTION @ ROOF DECK

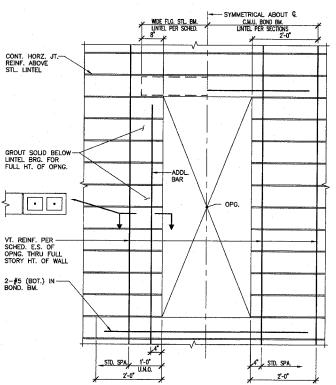

TYP. REINFORCING @ MASONRY WALL OPENING

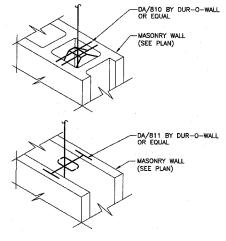

MASONRY WALL VERTICAL BAR POSITIONER

GENERAL CONCRETE MASONRY NOTES

- CONCRETE MASONRY UNITS (CMU) SHALL BE LIGHTWEIGHT CELLULAR UNITS CONFORMING TO ASTM CGO, GRADE N-1. CONCRETE MASONRY UNIT STRENGITH SHALL BE NO LESS THAN 2800 PSI ON THE NET AREA IN ACCORDANCE WITH ASTM C140, & AN UNIT WEIGHT NOT EXCEEDING 105 PCF. ALL AGGREGATE SHALL CONFORM TO ASTM C-331. SEE SPECIFICATIONS.
- DESIGN COMPRESSIVE STRENGTH OF CONCRETE MASONRY (F'M) = 2000 PSI.
- 3. MORTAR SHALL CONFORM TO ASTM C270. MORTAR SHALL BE TYPE S. GROUT SHALL CONFORM TO ASTM C-476.
- BOND BEAMS AND REINFORCED MASONRY WALLS SHALL BE FILLED WITH GROUT, NOT MORTAR, WHERE SHOWN.
- 5. FOUNDATION DOWELS MAY BE SLOPED NO MORE THAN 1:6 TO ALIGN WITH WALL CAVITIES OR VERTICAL CMU CORES.
- SPLICED REINFORCING SHALL BE LAPPED 48 BAR DIAMETERS OR 24", WHICHEVER IS GREATER, UNLESS OTHERWISE SHOWN ON DRAWINGS. ALL SPLICES SHALL BE WIRED TOGETHER.
- VERTICAL REINFORCING BARS SHALL HAVE A MINIMUM CLEARANCE OF 3/4" FROM MASONRY AND SHALL BE HELD IN POSITION TOP AND BOTTOM AND AT INTERVALS NOT EXCEEDING 4"-0". ACCESSORIES FOR SUCH SUPPORT SHALL BE USED.
- REINFORCING SHALL BE SECURED IN PLACE AND INSPECTED PRIOR TO ANY GROUTING.
- 9. VERTICAL GROUTING SHALL BE LOW LIFT OR HIGH LIFT AS FOLLOWS:
- A. LOW LIFT GROUTING SHALL BE USED FOR ALL CAVITY WALLS AND MAY BE USED FOR ALL WALLS AT THE OPTION OF THE CONTRACTOR. LIFTS SHALL NOT EXCEED 5'-0" IN HEIGHT.
- B. HIGH LIFT GROUTING IS PERMISSIBLE ONLY FOR SINGLE WYTHE WALLS AND SHALL NOT EXCEED ONE STORY IN HEIGHT. CLEAN OUT HOLES SHALL BE PROVIDED AT THE BASE OF EACH GROUTED CELL. SEE SPECIAL DETAIL.
- GROUTING SHALL BE STOPPED 1-1/2" BELOW THE TOP OF A COURSE TO FORM A KEY AT THE JOINT.
- 11. GROUTING OF MASONRY BEAMS OR LINTELS SHALL BE DONE IN ONE CONTINUOUS OPERATION.
- 12. CONTRACTOR SHALL PROVIDE TEST REPORTS ON MASONRY UNITS SHOWING UNIT WEIGHT, COMPRESSIVE STRENGTH, ABSORPTION, VOLUME CHANGE AND SHRINKAGE PER ASTM C90 NO LATER THAN 1S WORKING DAYS PRIOR TO THE COMMENCEMENT OF MASONRY CONSTRUCTION.
- 13. HORIZONTAL JOINT REINFORCEMENT SHALL BE AT 16" O.C.
- 14. PROVIDE #4 X 3'-0" DOWELS AT 48" C.C. FROM FOUNDATION INTO MASONRY WALL UNLESS NOTED OTHERWISE. PROJECT 1'-4" INTO MASONRY WALL.
- 15. HORIZONTAL JOINT REINFORCING SHALL STOP AT CONTROL JOINTS.
- 16. REINFORCING IN BOND BEAMS SHALL RUN CONTINUOUS THRU CONTROL JOINTS.
- 17. PROVIDE CONTROL JOINTS IN EXTERIOR CONCRETE BLOCK WALLS AT LOCATIONS SHOWN ON ARCHITECTURAL DRAWINGS, IN LINE WITH CONTROL JOINTS IN BRICK, UNLESS NOTED OTHERWISE. FOR ALL BEARING WALLS, PROVIDE CONTROL JOINTS AT A MAXIMUM OF 24 —0" CENTER TO CENTER, UNLESS NOTED OTHERWISE.
- CONTRACTOR TO PROVIDE ADEQUATE BRACING FOR ALL MAS. WALLS UNTIL PERMANENT SUPPORT STRUCTURES ARE IN PLACE.

REINF.---

TYP. CLEAN OUT DET. FOR HIGH LIFT GROUT

-BOND BEAM @ ROOF TOP OF PARAPET-TOP OF FOUNDATION

> TYPICAL WALL ELEVATION SHOWING REINFORCING AT MASONRY OPENING

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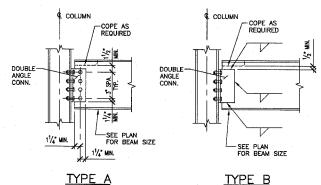
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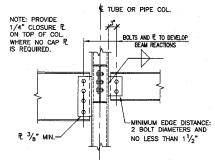


TYPICAL BEAM TO WIDE FLANGE COLUMN CONNECTION

NOTES:
1. EITHER TYPE "A" OR "B" CONNECTION IS ACCEPTABLE.

- 1. EITHER TYPE "A" OR "B" CONNECTION IS ACCEPTABLE.
 2. BOLTS TO BE A325 (TYPE N) 3/4" DIAMETER MIN.
 3. WELDS TO BE A.W.S. E70 ELECTRODE.
 4. SEE SPECIFICATIONS FOR ADDITIONAL REQUIREMENTS.
 5. CONNECTIONS SHALL BE SIZED PER ALS.C. (9TH EDITION) "UNIFORM LOAD TABLES" FOR END REACTIONS OR REACTIONS SHOWN ON PLAN, WHICHEVER IS HIGHER.
 6. ONE SIDED CONNECTIONS WILL NOT BE PERMITTED.
 7. MIN. CONNECTION ANGLE THICKNESS 5/16".
 8. SEE SCHEDULE "A" FOR MIN. NUMBER OF BOLTS IN A ROW FOR EACH BM. SIZE.

SCHEDULE A								
BEAM DEPTH	6"	8",10"	12",14"	16",18"	21",24"	27",30"	33",36"	
MINIMUM NO. OF BOLTS	2	2	3	4	5	6	7	



TYPICAL BEAM TO TUBE OR PIPE **COLUMN CONNECTION**

TUBE COLUMN SHOWN, PIPE COLUMN SIMILAR. USE STD. SHEAR & CONNECTION.

- NOTES:

 1. MUST COMPLY WITH TABLE "X", 9TH EDITION, NO EXCEPTIONS.

 2. BOLTS TO BE A325 (TYPE N) 3/4"0 MIN.


 3. WELDS TO BE AWS. E70 ELECTRODE.

 4. SEE SPECIFICATIONS FOR ADDITIONAL REQUIREMENTS.

 5. CONNECTIONS SHALL BE SIZED PER A.I.S.C. "UNIFORM LOAD CONSTANT" (9th Ed.) TABLE FOR END REACTIONS OR REACTIONS SHOWN ON PLAN, WHICHEVER IS HIGHER.

 6. SEE SCHEDULE "A" FOR MIN. NUMBER OF BOLTS IN A ROW FOR EACH BEAM SIZE.


SCHEDULE A								
BEAM DEPTH	6"	8",10"	12",14"	16",18"	21",24"	27",30"	33",36"	
MINIMUM NO. OF BOLTS	2	2	3	4	5	6	7	

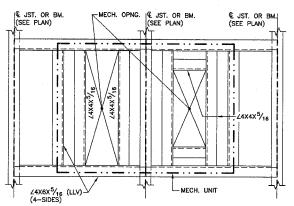


TYPICAL ANGLE FRAME AROUND MECHANICAL OPENINGS IN ROOF

: 1. COPE VERTICAL LEG OF ANGLE AND FIELD WELD TO TOP OF JOIST OR BEAM; OR FIELD WELD INTO SIDE OF JOIST TOP CHORD OR BEAM WEB.

2. COORDINATE LOCATION, SIZE AND OPNSS. OF MECH. UNIT WITH MECH. DWGS. NOTE: 1

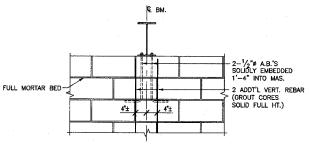

TYP. BEAM BEARING PERPENDICULAR TO MASONRY WALL WITHOUT BEARING PLATE

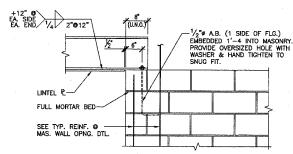

TYP. BEAM BEARING PARALLEL TO MASONRY WALL WITHOUT BEARING PLATE (SEE TYP, REINFORCING AT MASONRY WALL OPENING FOR BALANCE OF INFO.

GENERAL STEEL NOTES

- I. ALL STRUCTURAL STEEL AND DETAILS SHALL COMPLY WITH
 THE LATEST AISC "SPECIFICATION FOR DESIGN, FABRICATION AND
 ERECTION OF STRUCTURAL STEEL FOR BUILDINGS". ALL
 STRUCTURAL STEEL SHALL COMPLY WITH THE FOLLOWING
 UNLESS NOTED OTHERWISE IN THE SPECIFICATIONS:
 A. CHANNEL SHAPES, PLATES, ANGLES & BARS ASTM A36.
 B. WIDE FLANGE SHAPES ASTM A992 GRADE 50.
 C. STEEL TUBE (RECTANGULAR OR SQUARE) ASTM A500, GRADE B.
 D. STEEL PIPE (ROUND) ASTM A53, TYPE E OR S.
- 2. THE FRAME OF STEEL SKELETON BUILDINGS SHALL BE ERECTED AND BRACED IN ACCORDANCE WITH THE AISC "CODE OF STANDARD PRACTICE", SUCH BRACING SHALL BE LEFT IN PLACE AS LONG AS MAY BE REQUIRED FOR SAFETY.
- PLACE AS LONG AS MAY BE REQUIRED FOR SAFETT.

 3. SHOP AND FIELD CONNECTIONS ARE TO BE BOLTED WITH HIGH STRENGTH BOLTS OR WELDED, UNLESS NOTED OTHERWISE. ALL END CONNECTIONS SHALL BE DESIGNED ON BASIS OF AISC LOAD SPAN TABLES WITH SPECIAL CONSIDERATION GIVEN TO CONCENTRATED LOADS NEAR ENDS OF BEAMS, MINIMUM DESIGN LOAD TO BE 10,000 LOS, BOLTS TO BE 3/4* DIAMETER ASTM A325 (TYPE N) WITH MINIMUM 2 BOLTS PER CONNECTION. SLIP CRITICAL BOLTS ARE TO BE USED FOR CROSSBRACE CONNECTIONS TO BEAMS & COLUMNS & FOR BEAM END CONNECTIONS THAT TRANSFER BRACE LOADS TO COLUMNS.
- SHEAR TAB CONNECTIONS (EXCEPT THOSE EXACTLY THE SAME AS IN THE AISC NINTH EDITION TABLE X) WILL NOT BE PERMITTED. THERE WILL BE NO EXCEPTIONS.
- 5. SHOP AND FIELD WELDING SHALL CONFORM TO THE A.W.S. D1.1 "STRUCTURAL WELDING CODE".
- ALL COLUMN BASE PLATES SHALL BE SET ON SHIMS TRUE AND LEVEL. BASE PLATES SHALL BE SOLIDLY GROUTED WITH EMBECO GROUT UNDER THE ENTIRE BASE PLATE AREA.
- ANCHOR BOLTS SHALL BE 3/4" HEADED BOLTS (A307) OR ASTM F1554 A36 THREADED RODS W/ WELDED NUTS. EXTEND 1'-0" INTO CONCRETE WHERE POSSIBLE, & BE HELD 21/2" MINIMUM FROM OUTSIDE FACE OF CONCRETE. ALL ANCHOR BOLTS SHALL BE HELD 11/2" MINIMUM FROM EDGE OF BASE PLATE WHERE POSSIBLE. PROVIDE A MINIMUM OF $4-^3/_4{}^{\prime\prime}$ DIAMETER ANCHOR BOLTS AT EACH COLUMN, UNLESS NOTED OTHERWISE.
- WHERE EPOXY ANCHORS ARE INDICATED, INSTALL PER MANUFACTURERS RECOMMENDATIONS WITH ITW RAWSET/REDHEAD EPOON EPOXY SYSTEM, SIMPSON EPOXY-TIE ADHESIVE OR U S ANCHOR HS 200 EPOXY SYSTEM.
- PROVIDE 8" SOLID MASONRY UNDER MASONRY BEARING ENDS OF ALL STRUCTURAL STEEL. SOLID BEARING IS TO EXTEND A MINIMUM OF 8" PAST EACH SIDE OF FLANCE OR BEARING PLATE. BEAMS AND LINTELS TO BEAR A MINIMUM OF 8" ON MASONBY.
- PROVIDE 2-1/2" DIAMETER ANCHOR BOLTS EMBEDDED 1'-4" INTO MASONRY AND GROUTED SOLID AT BEARING ENDS OF ALL BEAMS SPANNING PERPENDICULAR TO SUPPORTING WALL.
- MASONRY WALLS, UNLESS NOTED OTHERWISE, SHALL HAVE A WBX10 + 1/4" PLATE LINTEL OVER ALL OPENINGS GREATER THAN 1'-4" IN LENGTH.
- 12. SUPPORT OF STAIR STRINGERS ON MASONRY WALLS IS TO BE IN DIRECT BEARING ON SOLID OR GROUTED MASONRY (U.N.O.).

GENERAL STEEL JOIST NOTES

- ALL STEEL JOISTS, BRIDGING AND DETAILS SHALL COMPLY WITH THE LATEST STEEL JOIST INSTITUTE "STANDARD SPECIFICATIONS AND LOAD TABLES" FOR DESIGN, FABRICATION, AND ERECTION.
- LOCATE ONE ADDITIONAL ROW OF BOTTOM CHORD BRIDGING ADJACENT TO FIRST BOTTOM CHORD PANEL POINTS AT ALL ROOF JOISTS.
- JOISTS SHALL BE ERECTED WITHIN A MAXIMUM HORIZONTAL ALIGNMENT TOLERANCE OF 1" IN 25'-0".
- ALL STEEL ROOF JOISTS SHALL BE DESIGNED FOR A MINIMUM NET UPLIFT OF 10 PSF.
- PROVIDE SPECIAL DEPTH ENDS, EXTENDED ENDS, OUTRIGGERS, HEADERS, CEILING EXTENSIONS, ANCHORS, ETC. AS REQUIRED BY DRAWING AND SPECIFICATIONS.
- 6. PROVIDE 8" OF SOLID MASONRY UNDER MASONRY BEARING ENDS OF STEEL JOISTS. SOLID MASONRY TO RUN CONTINUOUSLY AT BEARING ELEVATION.
- EXTRA WEBS MUST BE FIELD APPLIED AT ALL CONCENTRATED LOADS NOT OCCURING AT JOIST PANEL POINTS.

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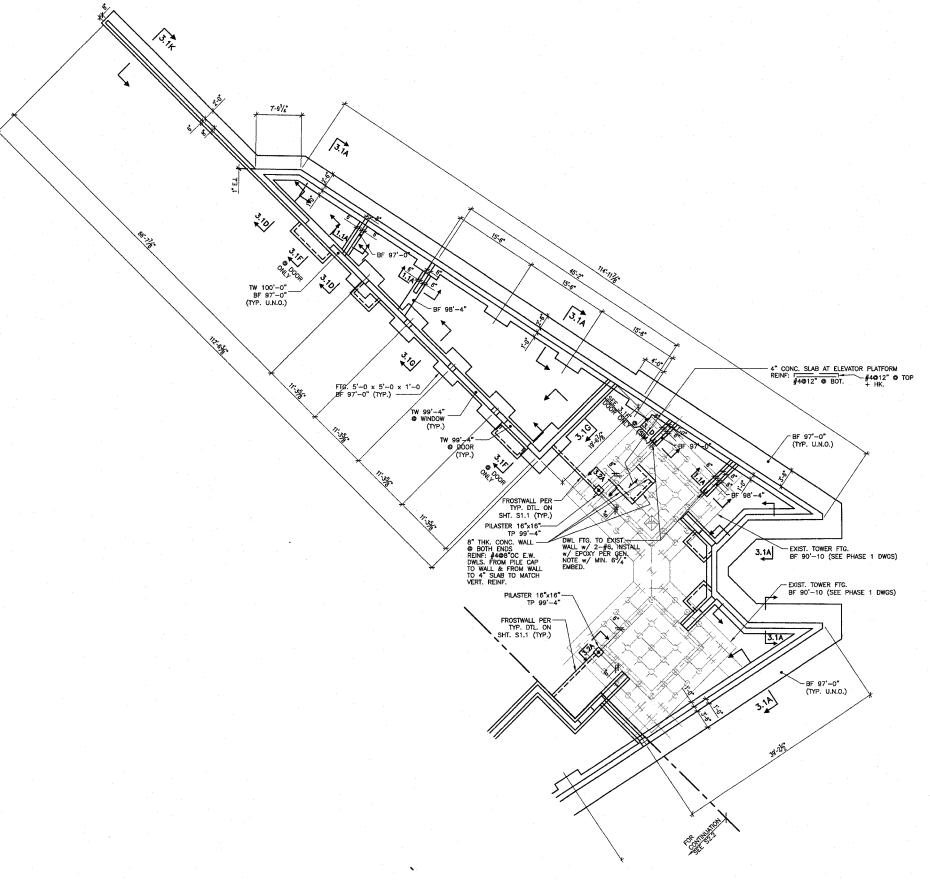
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ISSUE DATE ti-APRIL-08 SHEET NO

S1.3

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PARTIAL FOUNDATION PLAN 1/8"=1'-0

NOTES: 1. FIN. FLR. EL. 100'-0 (U.N.O.).

2. FLR. CONSTR: 4" CONC. SLAB ON GRANULAR FILL. REINF. SLAB W/ 6X6-W1.4XW1.4 W.W.F.

OR STRUX 90/40 FIBER REINF. BY GRACE CONSTR. PRODUCTS © THE DOSAGE
RATE OF 3.5 lbs./cuble yd. PER W.R. GRACE SPECS. (OR EQUAL) — U.N.O.

211 N. Broadway Surte 1900 St. Louis, MO 63102 (314) 241-8188 X (314) 241-0125

Clark Memorial Tower

OF HARTFORD, ILLINOIS ILLINOIS 62049

AND LEWIS AR VILLAGE HARTFORD, II


PARTIAL FOUNDATION PLAN

DATE

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ISSUE DATE 11-APRIL-08

S2.1

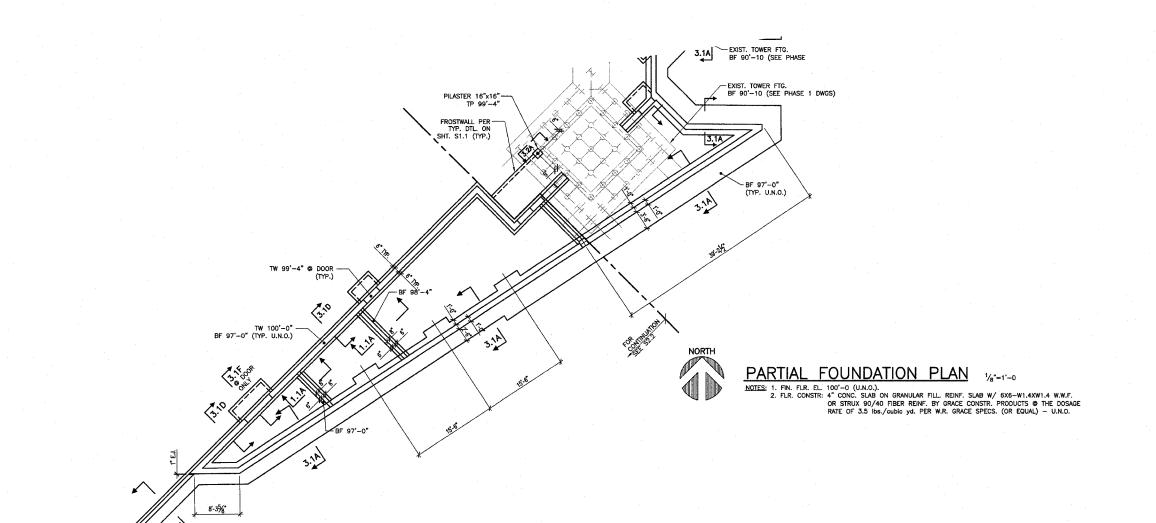

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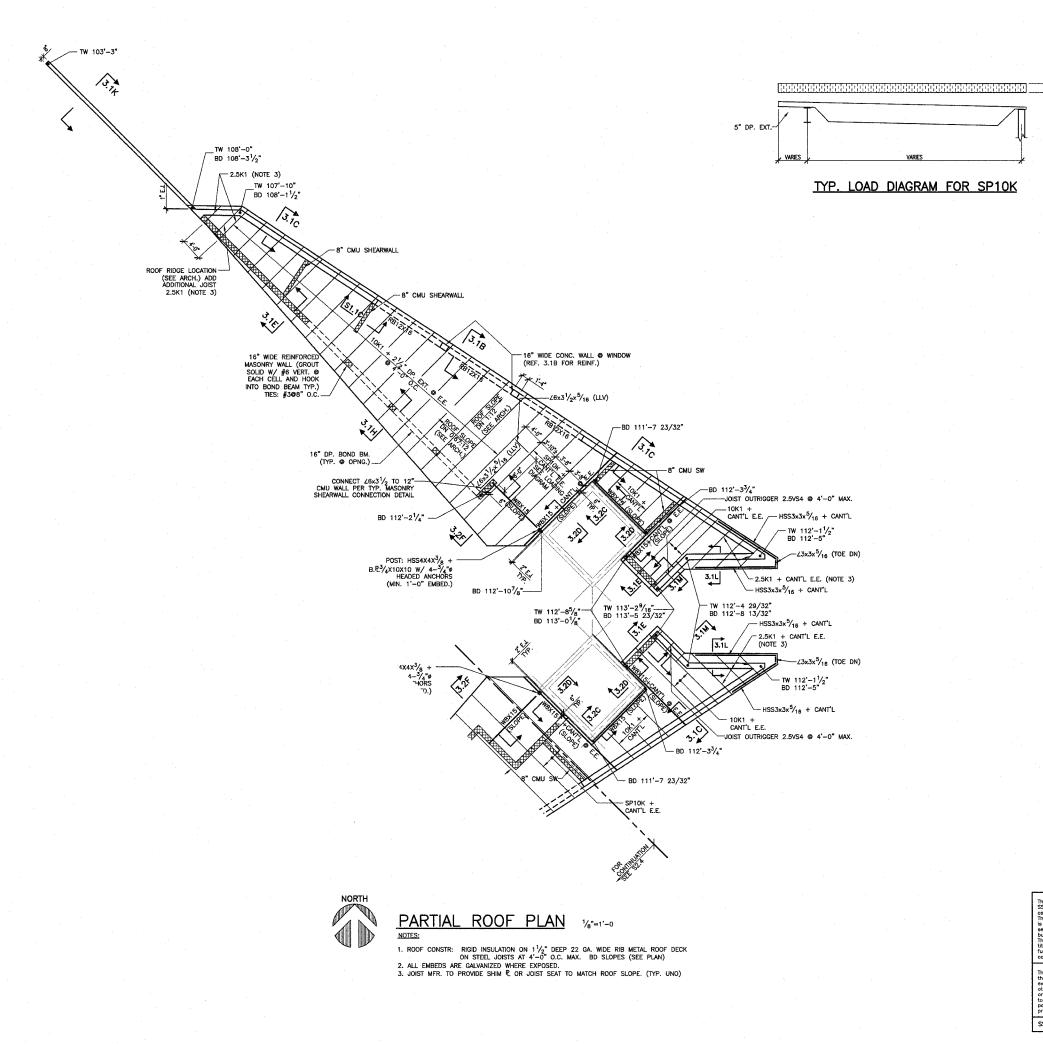
LEWIS AND CLARK MEMORIAL TOWER VILLAGE OF HARTFORD, ILLINOIS Hartford, Ilinois 62049

PARTIAL FOUNDATION PLAN

ISSUE DATE 11-APRIL-08

KENNEDY PROJECT NO KAIN 10-02048

SHEET NO **S2.2**



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MEMORIAL TOWER ILLINOIS

OF HARTFORD, Illinois 62049

CLARK AND VILLAGE Hartford, I rewis

PLAN ROOF PARTIAL

-		 	
DATE			
HEMARKS			
REV. NO.			


KENNEDY PROJECT NO KAI: 10-02048

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188UE DATE 11-APRIL-08

SSE PROJECT NO: 02111

S2.3

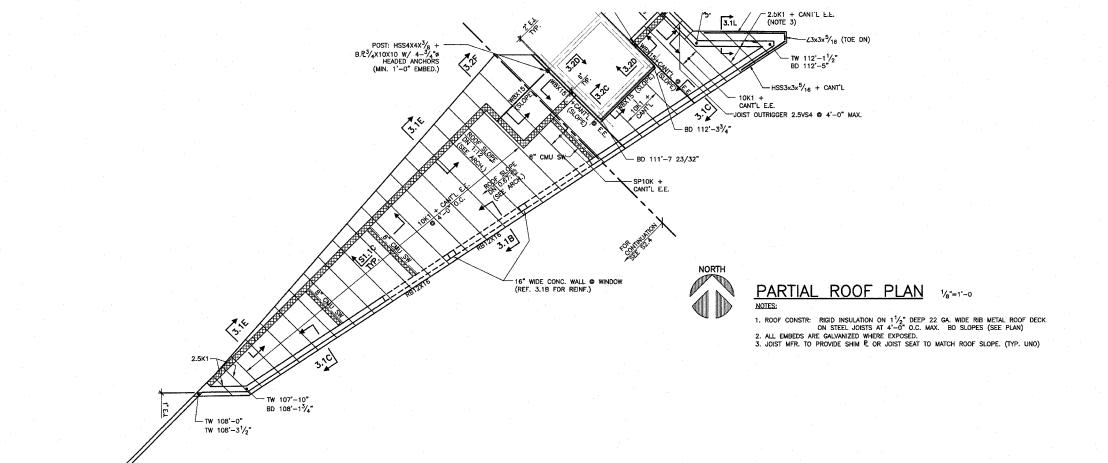

TW 103'-3"

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Lewis and clark memorial tower VILLAGE OF HARTFORD, ILLINOIS Hartford, Illinois 62049

PARTIAL ROOF PLAN


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₹			


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KENNEDY PROJECT NO KAI® 10-02048

ISSUE DATE 11-APRIL-08 SHEET NO

S2.4



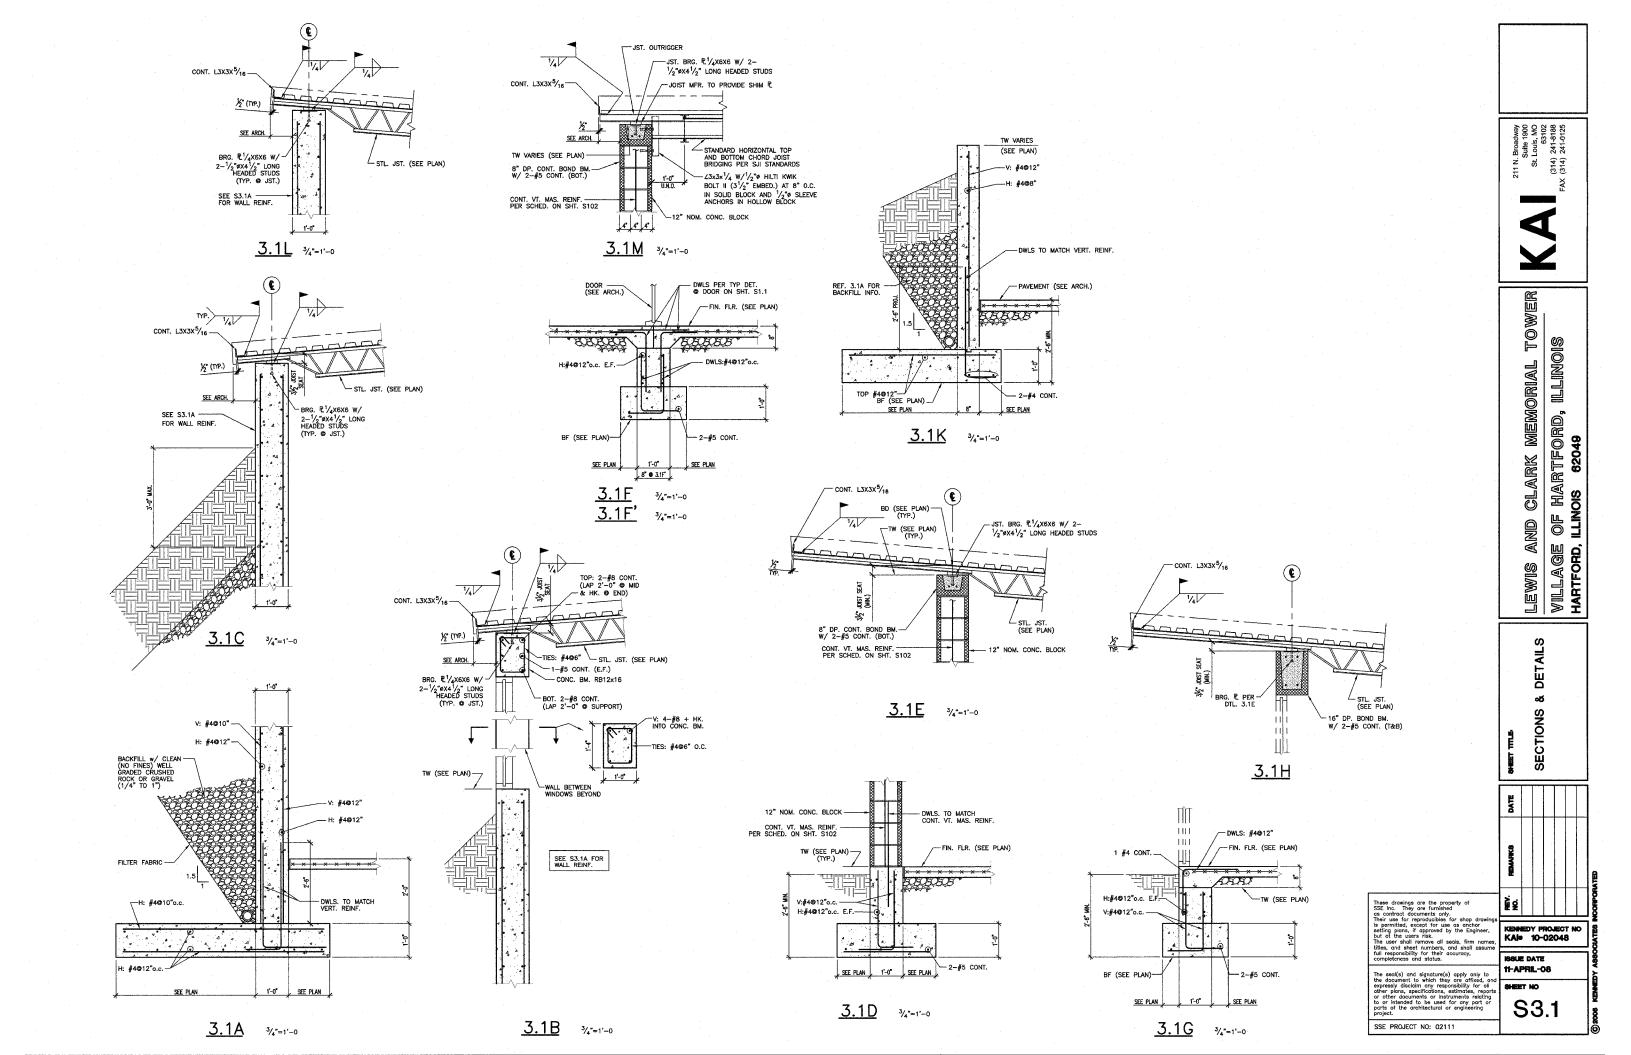

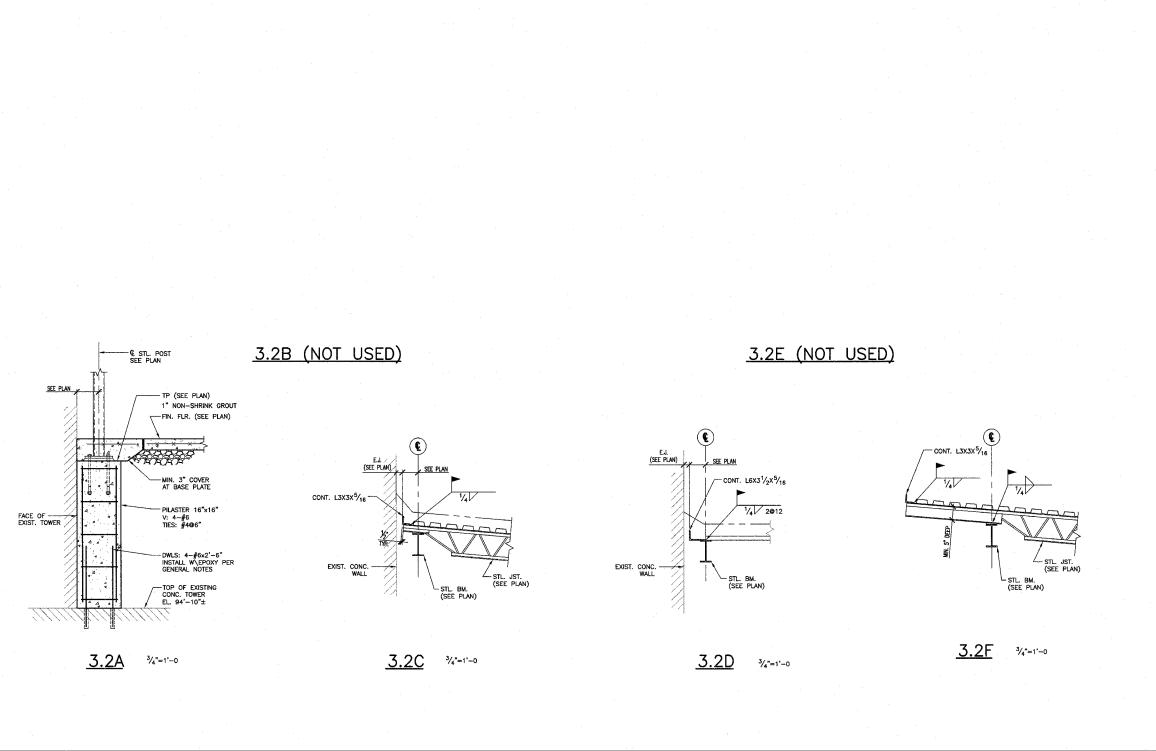211 N. Broadway Suite 1900 St. Louis, MO 63102 (314), 241-8188 FAX (314), 241-0125 Lewis and clark memorial tower Village of Hartford, Illinois Hartford, Illnois 62049 SECTIONS & DETAILS KENNEDY PROJECT NO KAI® 10-02048 ISSUE DATE 11-APRIL-08 SHEET NO \$3.2 SSE PROJECT NO: 02111

* **

PLAN NORTH

LEVEE

OVERALL SITE PLAN (REFERENCE ONLY)

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LEWIS AND CLARK MEMORIAL TOWER VILLAGE OF HARTFORD, ILLINOIS 62049


SHET THE OVERALL SITE PLAN FOR REFERENCE ONLY

REV. REMARKS DATE NO.

KENNEDY PROJECT NO KAI= 10-02048


ISSUE DATE APRIL 11, 2008 SHEET NO


A1-02

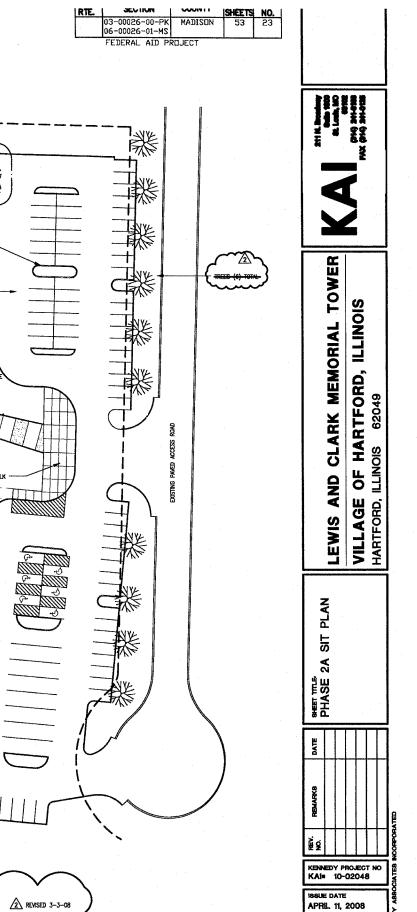


SHEET NO

A1-03

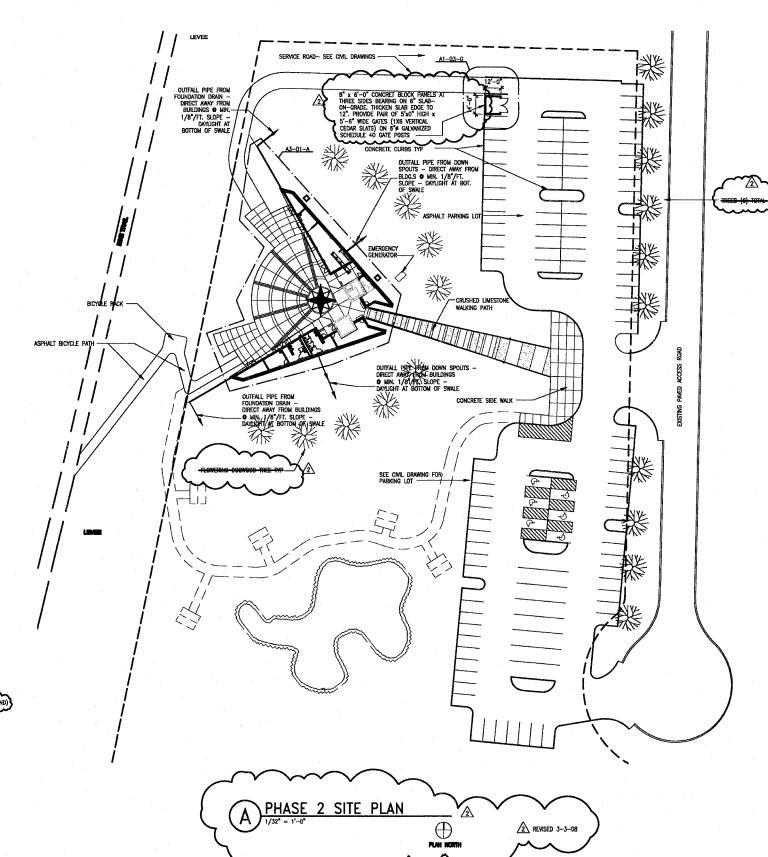


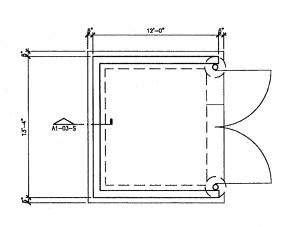

DUMPSTER ENCLOSURE

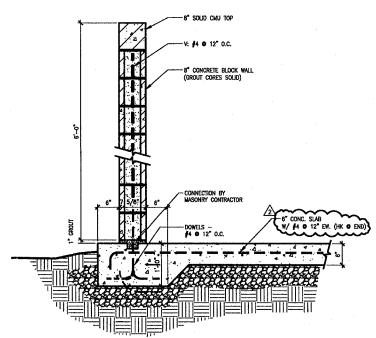

DUMPSTER ENCLOSURE

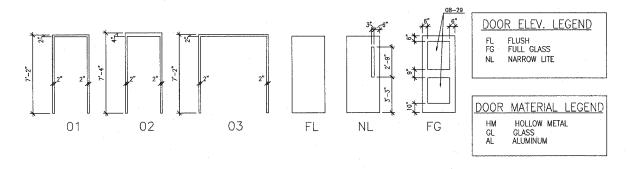

FRAME ELEVATION

TYP. MOUNTING HEIGHTS
1/4"=1'-0"

1-1/2"=1'-0"

DOOR ELEVATIONS

10-10/

10-46

C1

DOOR TYPE SCHEDULE REMARKS DOOR DOOR FRAME DOOR DOOR TYPE ELEV. MATERIAL ELEV. RATING 01 FL В Ni.. HM/GL 01 PROVIDE PATTERNED GLASS IN LITE FG AL/GL 01 INSTALL TEMPERED INSULATED GLASS INSTALL FIRE-RATED GLASS @ LITE NL HM/GL 01 1/2 HOUR FL 02 НМ FG AL/GL 03 INSTALL TEMPERED INSULATED GLASS 03 FL НМ

	F.A.	SECTION	COUNTY	TOTAL	SHEET NO.
1		03-00026-00-PK 06-00026-01-MS		53	24
ı		FEDERAL AID P	ROJECT		

GENERAL NOTES:

1. ALL DOOR DIMENSIONS ARE $3'-0" \times 7'-0"$ UNLESS NOTED OTHERWISE. 2. SEE FINISH SCHEDULE FOR DOOR AND FRAME FINISHES.

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LEWIS AND CLARK MEMORIAL TOWER VILLAGE OF HARTFORD, ILLINOIS 62049

KEYED NOTES:

04-22 8" CONCRETE MASONRY UNIT

04-23 6" CONCRETE MASONRY UNIT

04-62 COMPRESSIBLE FILLER 10-10 TACTILE SIGN PLATE

10-25 ACCESSIBLE TOILET TISSUE DISPENSER

10-26 36" GRAB BAR

10-27 42" GRAB BAR

10-29 ACCESSIBLE SOAP DISPENSER 10-31 ACCESSIBLE SANITARY NAPKIN DISPOSAL

10~42 MIRROR

10-46 UTILITY SHELF WITH HOOKS

10-50 ELECTRIC HAND DRYER 15-11 ACCESSIBLE WATER CLOSET


D1


SC SEALED CONCRETE


STAINED CONCRETE STC HIGH PERFORMANCE COATING


ACOUSTICAL PANEL

FINISH	SCHEDULE					
ROOM NO.	ROOM NAME	FLOOR	WALLS	CEILING FINISH	CEILING HEIGHT	REMARKS
					,	
101	MECHANICAL	SC			VARIES	PAINT DOORS & FRAMES WITH HPC
102	VENDING	STC	HPC	AP/HPC	VARIES	
103	GIFT SHOP	STC	HPC	AP/HPC	VARIES	
104	CONTROL DESK	STC	HPC	AP/HPC	VARIES	
105	LOBBY	*		HPC	VARIES	*COLORED CONC PART OF PLAZA PAVING
106	ELEVATOR MECHANICAL	SC			VARIES	PAINT DOORS & FRAMES WITH HPC
107	ELECTRICAL	SC			VARIES	PAINT DOORS & FRAMES WITH HPC
108	PUMPS	SC			VARIES	PAINT DOORS & FRAMES WITH HPC
109						NOT USED
110	WOMEN	SC	HPC	HPC	VARIES	PAINT DOORS & FRAMES WITH HPC
111	MEN	SC	HPC	HPC	VARIES	PAINT DOORS & FRAMES WITH HPC
112	ELECTRICAL / JANITOR	SC			VARIES	PAINT DOORS & FRAMES WITH HPC
113	STORAGE	SC			VARIES	PAINT DOORS & FRAMES WITH HPC
	OF U. FR. DOWODETE		<u> </u>			

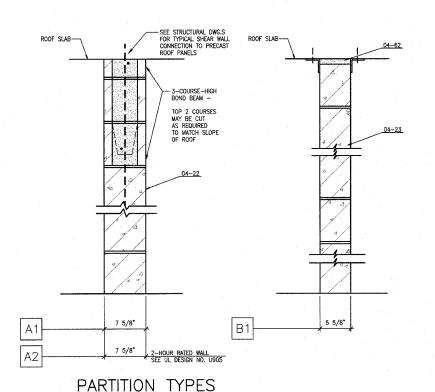

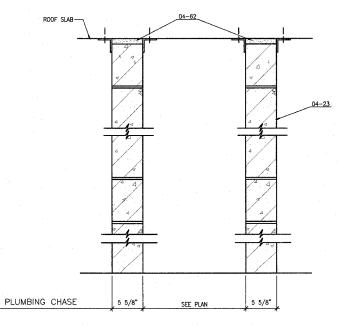

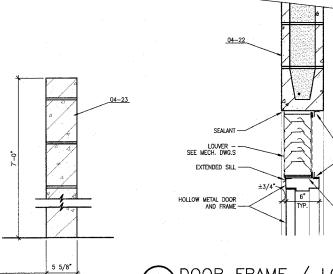

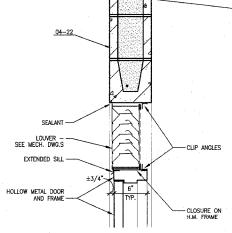


DOOR FRAME LOUVER DETAIL

KENNEDY PROJECT NO KAI: 10-02048

WOUNTING HEIGHTS/ PARTITION TYPES DOOR INFORMATION

APRIL 11, 2008

A2-01

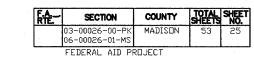

Note: Remove temporary elevator machine enclosure as required. (Temporary enclosure shall remain as long as possible to reduce the chances of damaging elevator equipment.)


Broadway Suite 1900 Louis, MO 63102 241-8188 241-0125 211 N. Broadv Suite 19 St. Louis, I

(314)

CLARK MEMORIAL TOWER ILLINOIS

OF HARTFORD, ILLINOIS 62049 AND VILLAGE HARTFORD, I

LEWIS SHEET THEE FLOOR PLAN AND ENLARGED RESTROOM PLAN

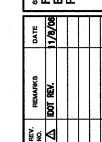


KENNEDY PROJECT NO KAI# 10-02048

ISSUE DATE APRIL 11, 2008

SHEET NO

A3-01

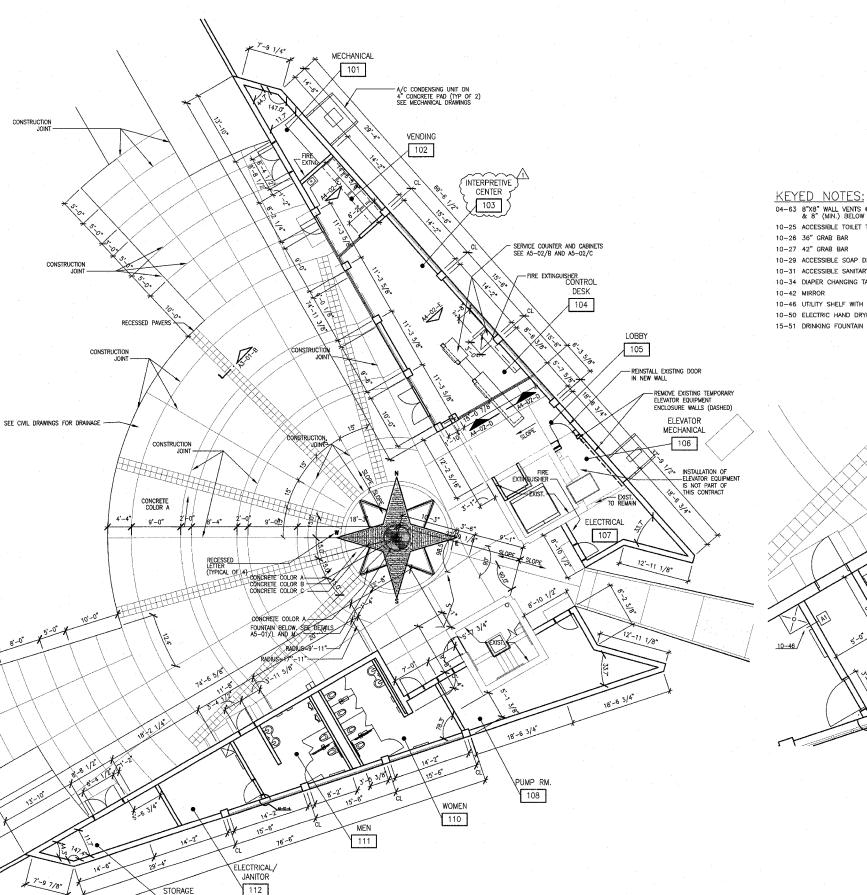

04-63 8"X8" WALL VENTS @ 8" ABOVE FLOOR & 8" (MIN.) BELOW ROOF PANELS. 10-25 ACCESSIBLE TOILET TISSUE DISPENSER 10-26 36" GRAB BAR 10-27 42" GRAB BAR

10-29 ACCESSIBLE SOAP DISPENSER 10-31 ACCESSIBLE SANITARY NAPKIN DISPOSAL 10-34 DIAPER CHANGING TABLE

10-42 MIRROR

10-46 UTILITY SHELF WITH HOOKS 10-50 ELECTRIC HAND DRYER

15-51 DRINKING FOUNTAIN

10-25 10-34

B) ENLARGED RESTROOM PLAN PLAN NORTH

STORAGE

COUNTY SECTION 03-00026-00-PK 06-00026-01-MS MADISON FEDERAL AID PROJEC Note: Remove temporary elevator machine enclosure as required. (Temporary enclosure shall remain as long as possible to reduce the chances of damaging elevator equipment.)

- EXISTING TOWER


- GUTTER & DOWNSPOUTS (TYP.)

TOTAL SHEET NO. 53 26

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LEWIS AND CLARK MEMORIAL TOWER VILLAGE OF HARTFORD, ILLINOIS 62049

SHET TILE. ROOF PLAN

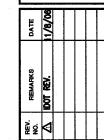


KENNEDY PROJECT NO KAI# 10-02048


ISSUE DATE APRIL 11, 2008

SHEET NO


A3-02

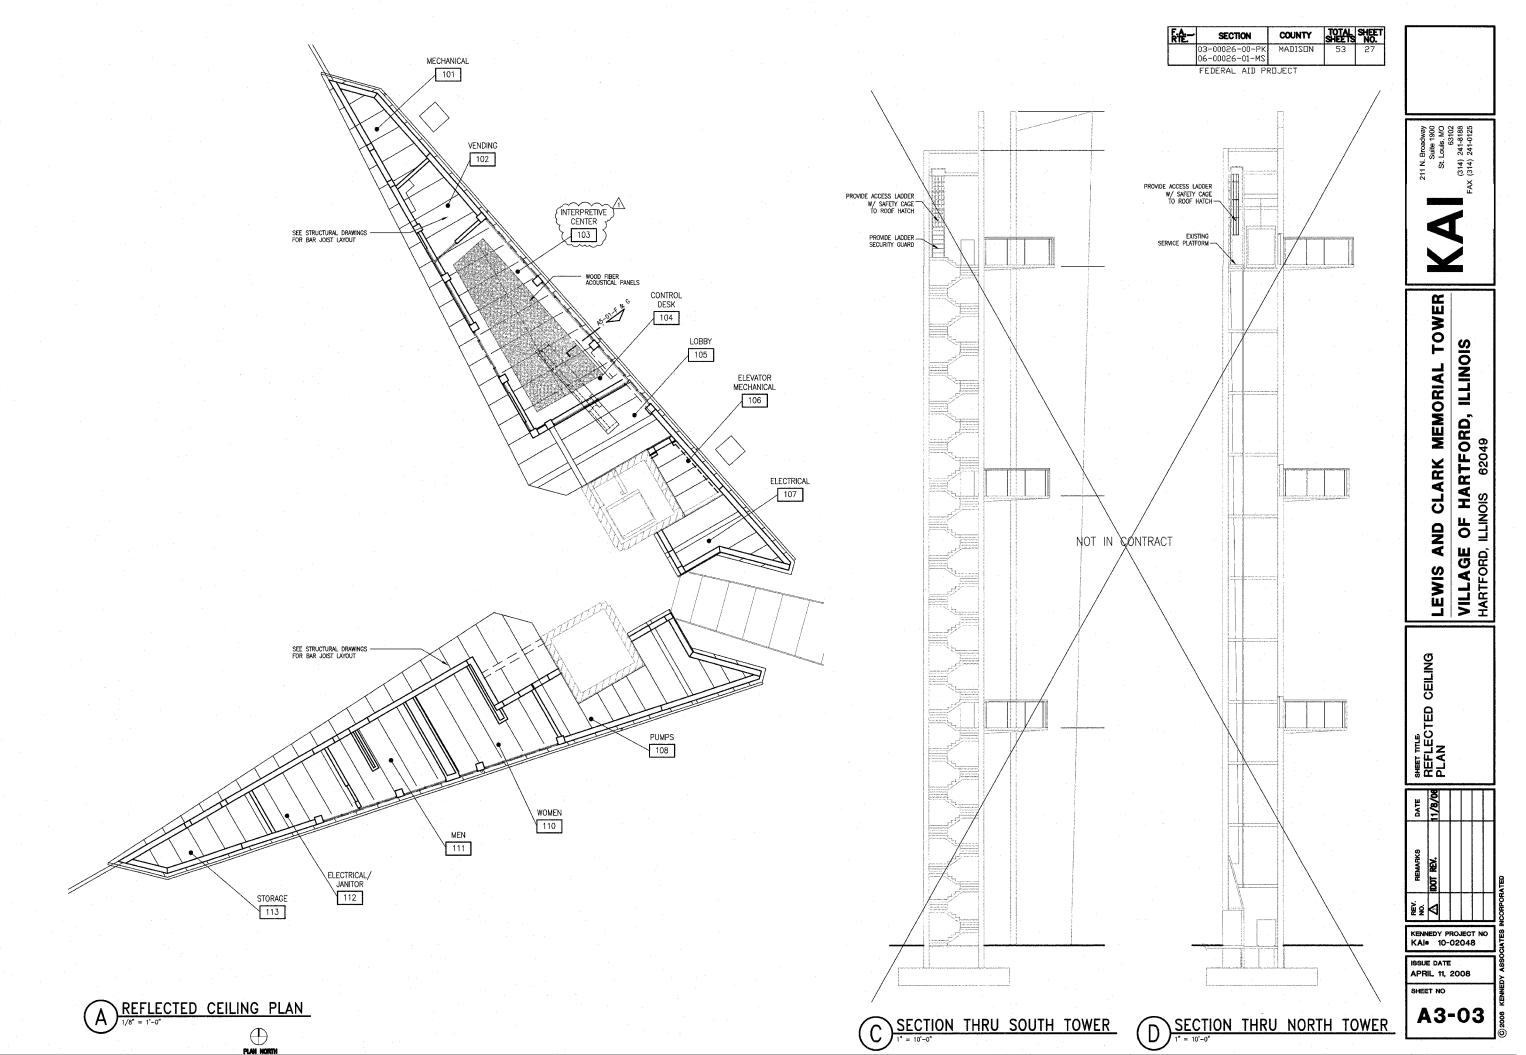

awing Stamp Information

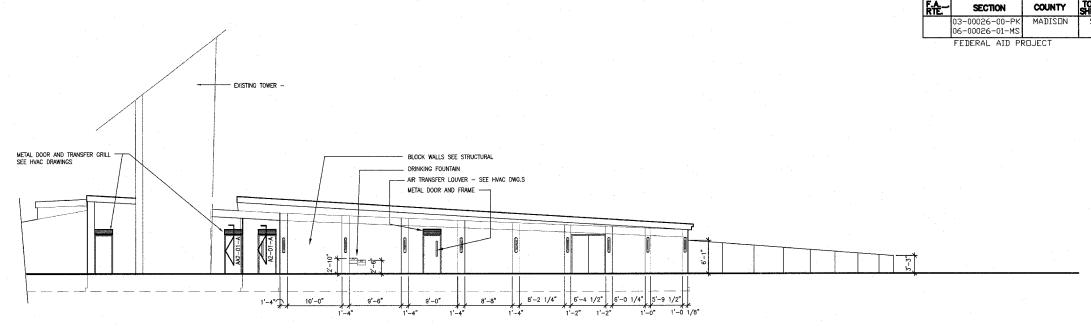



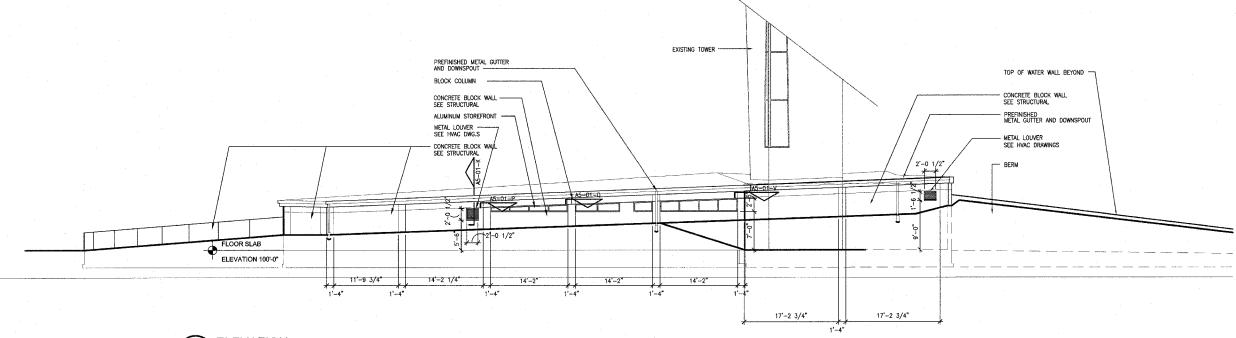

B ELEVATION
1/8"=1'-0"



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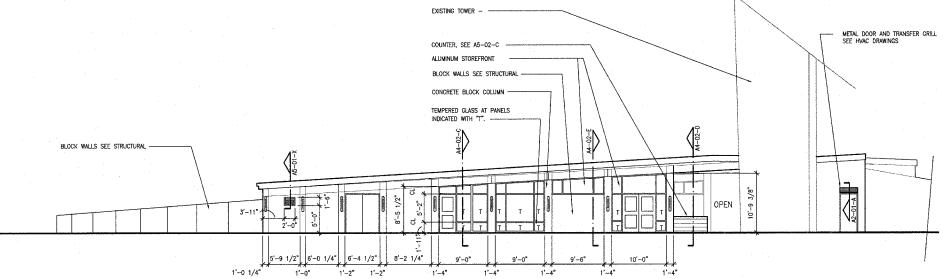
LEWIS AND CLARK MEMORIAL TOWER VILLAGE OF HARTFORD, ILLINOIS 62049

EXTERIOR ELEVATIONS


KENNEDY PROJECT NO KAI® 10-02048

ISSUE DATE APRIL 11, 2008


SHEET NO A4-01




NORTH BUILDING PLAZA ELEVATION

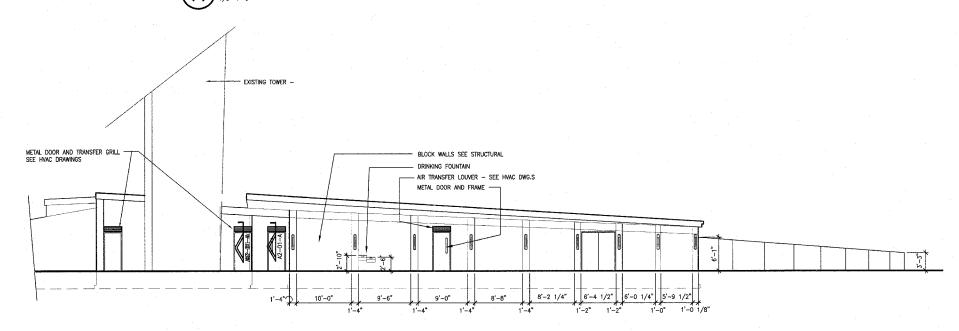



SOUTH BUILDING PLAZA ELEVATION

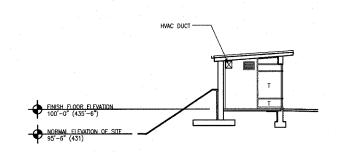


SECTION AT NORTH BUILDING

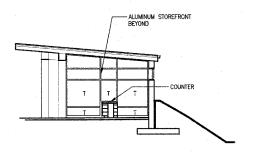

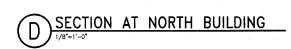

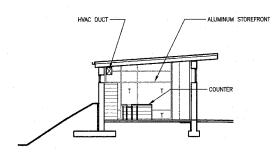

SECTION AT NORTH BUILDING

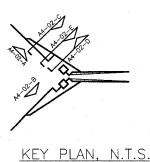

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LEWIS AND CLARK MEMORIAL TOWER VILLAGE OF HARTFORD, ILLINOIS HARTFORD, ILLINOIS 62049


SHEET TILE.
EXTERIOR BUILDING
ELEVATIONS


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DATE			
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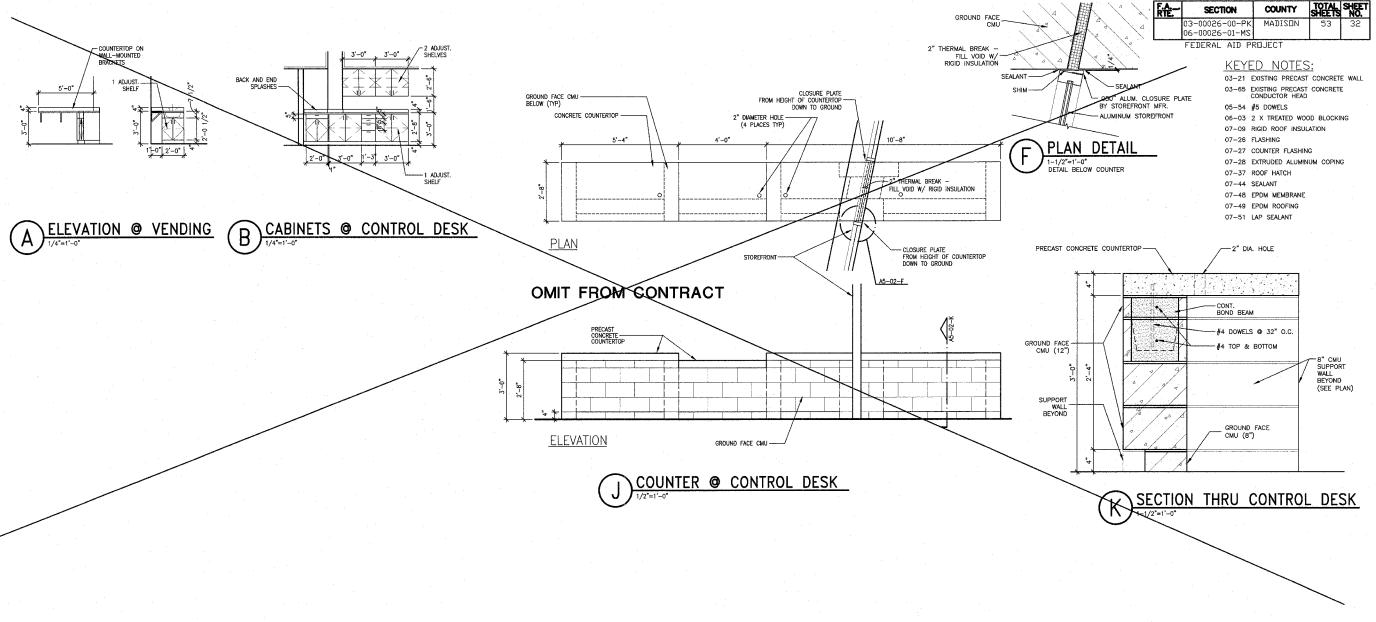
KAI 10-02048

ISSUE DATE APRIL 11, 2008 SHEET NO

A4-02



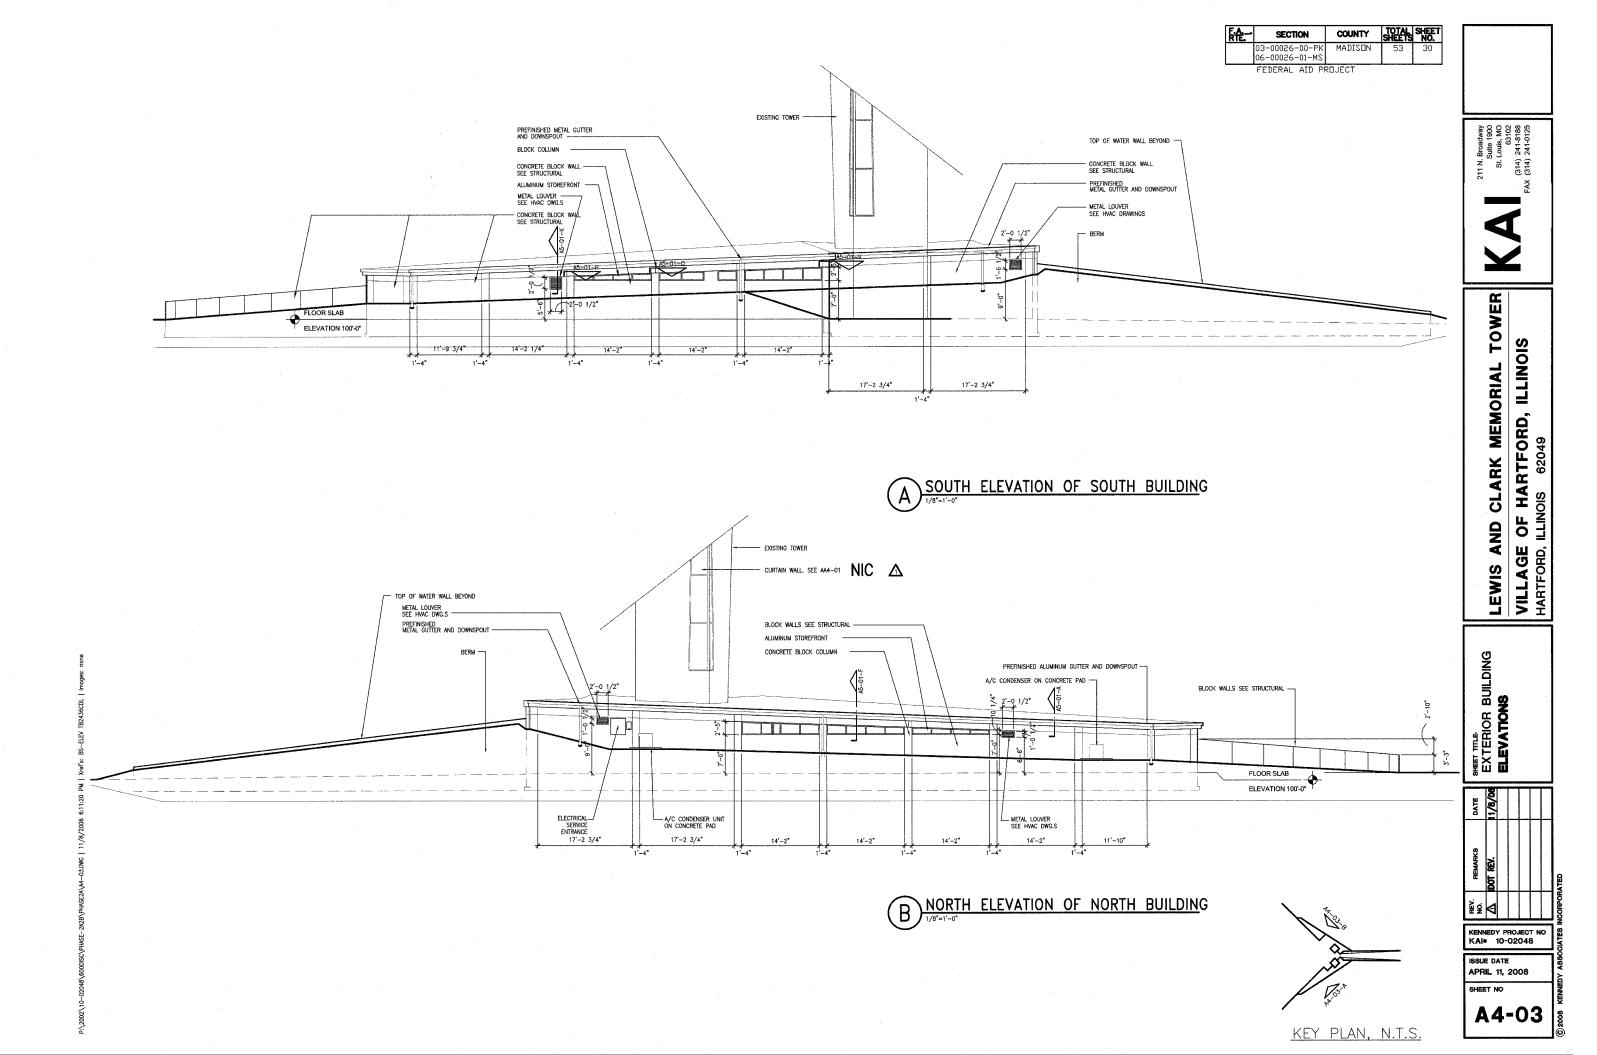

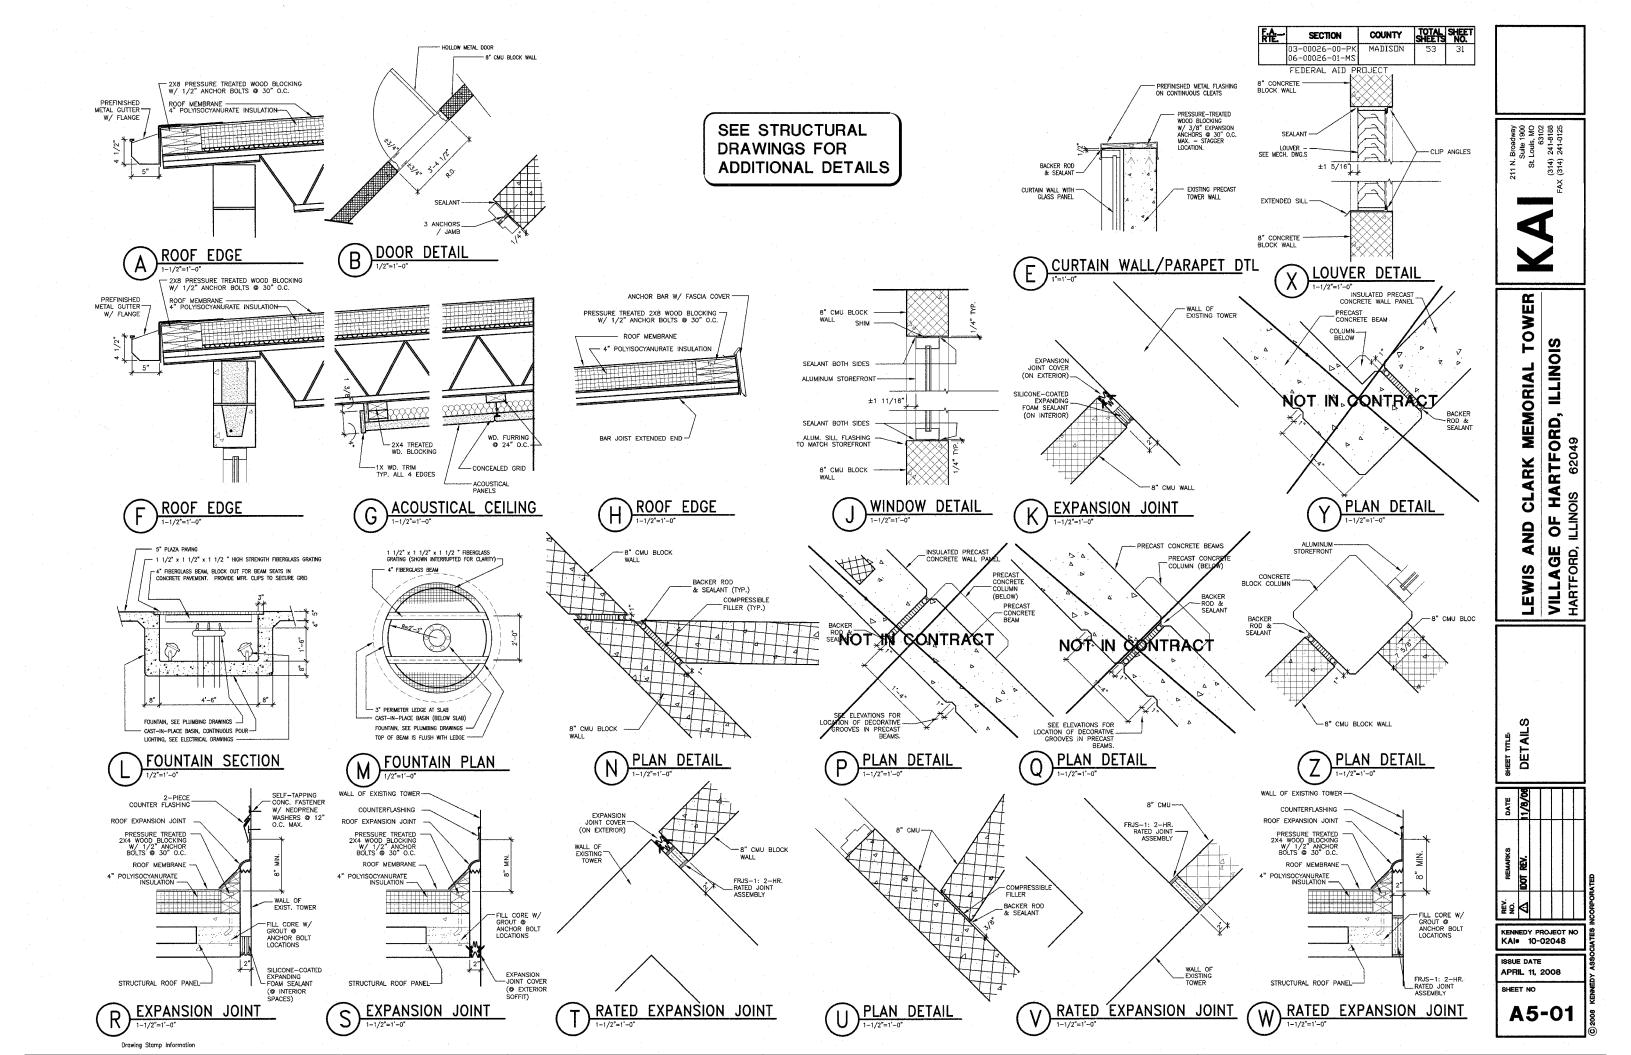

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LEWIS AND CLARK MEMORIAL TOWER VILLAGE OF HARTFORD, ILLINOIS 62049

SHEET TITLE DETAILS

KENNEDY PROJECT NO KAI# 10-02048

APRIL 11, 2008

A5-02

F.A.	SECTION	COUNTY	TOTAL SHEETS	SHEE NO.
	03-00026-00-PK 06-00026-01-MS	MADISON	53	33

FEDERAL AID PROJECT

GENERAL NOTES: 1. THESE DRAWINGS ARE DIAGRAMMATIC IN NATURE, ALL WORK IS TO BE COORDINATED BETWEEN ALL TRADES

2. ALL DUCTWORK, EQUIPMENT AND PIPING IS TO BE INSTALLED IN ACCORDANCE WITH ALL PERTINENT CODES AND SMACNA SEISMIC DESIGN REQUIREMENTS.

3. DUCT SIZES SHOWN ARE SHEETMETAL SIZES WITH 1"

KEYED NOTES:

- \$\sqrt{1}\rightarrow \text{service access for filter maintenance.}
- PROVIDE A 1" TYPE "L" COPPER CONDENSATE DRAIN PIPE AND EXTEND TO FLOOR DRAIN WITH A DOWNTURN 45' ELBOW. PROVIDE THREADED BRASS PLUG CLEANOUTS AT EACH CHANGE OF DIRECTION.
- PROVIDE A 0'-4" THICK CONCRETE PAD THAT EXTENDS 0'-4" BEYOND EACH EDGE OF THE EQUIPMENT. SECURE CONDENSING UNIT TO PAD WITH STAINLESS STEEL CONCRETE ANCHORS AND SCREWS.
- PROVIDE 90 ELBOW WITH TURNING VANES AND SIZE TO MATCH CONNECTION OF AHU-1.
- $\begin{picture}(60,0) \put(0,0){\line(0,0){100}} \put(0,0){\line(0,0){100$
- PROVIDE AN ADJUSTABLE WEIGHTED BAROMETRIC RELIEF DAMPER. ADJUST WEIGHTS TO MAINTAIN A SLIGHTLY POSITIVE BUILDING PRESSURIZATION.
- MOUNT TOP OF TRANSFER GRILLES SO THAT THEY ARE LEVEL WITH GRILLE "B" ON OPPOSITE WALL.
- (8) PROVIDE A SEVEN DAY PROGRAMMABLE HEATING/COOLING THERMOSTAT WITH WHITE METAL LOCKABLE THERMOSTAT GLIARD.
- SUCTION AND LIQUID REFRIGERANT PIPING SIZED BY CONDENSING UNIT MANUFACTURER.
- interlock damper to open with activation of ef-1. Provide an 20 gage galvanized plenum to mount damper.
- PROVIDE A 1" TYPE "L" COPPER CONDENSATE DRAIN PIPE AND EXTEND DOWN INTERIOR WALL AND PENETRATE AT 0'-6" ABOVE FINISHED GRADE AND TERMINATE WITH A 45' DOWNTURN ELBOW. PROVIDE THREADED BRASS PLUG CLEANOUTS AT EACH CHANGE OF DIRECTION.
- MOUNT AC-1 AT AN ELEVATION THAT ALLOWS FOR PROPER CONDENSATE DRAINAGE AND MAINTENANCE.
- (3) INTERLOCK DAMPER TO OPEN WITH ACTIVATION OF EXISTING EXHAUST FAN IN JANITOR'S 112. PROVIDE AN 20 GAGE GALVANIZED PLENUM TO MOUNT DAMPER.
- PROVIDE A LOW VOLTAGE HEATING ONLY THERMOSTAT WITH WHITE METAL LOCKABLE GUARD.
- PROVIDE NEW OPENING WITH NEW DUCT CONNECTION TO EXISTING 10"x10" EXHAUST DUCT. EXTEND NEW DUCT THROUGH OPENING AND CONNECT TO NEW REGISTER, "C".
- INTERLOCK DAMPER TO OPEN WITH ACTIVATION OF EF-2.
 PROVIDE AN 20 GAGE GALVANIZED PLENUM TO MOUNT
 DAMPER
- MOUNT TOP OF GRILLE AT 1'-6" BELOW STRUCTURE. EXTEND DUCTWORK INTO CHASE AND LEAVE END OPEN TO SPACE.
- MOUNT TOP OF GRILLE AT 1'-6" BELOW STRUCTURE. EXTEND DUCTWORK INTO CHASE AND LEAVE END OPEN TO SPACE.
- 19 FLEXIBLE CONNECTORS.

211 N. Broadway Suite 1900 St. Louis, MO 63102 (314) 241-8188 AX (314) 241-0125



Yes Z

LEWIS AND CLARK MEMORIAL TOWI VILLAGE OF HARTFORD, ILLINOIS HARTFORD, ILLINOIS 62049

SHEET TITLES
MECHANICAL
FLOOR PLAN


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DATE	11-08-06			
REMARKS	IDOT SUBMISSION			
REV.	◁			

KENNEDY PROJECT NO KAI* 10-02048

ISSUE DATE APRIL 11, 2008

SHEET NO

M3-01

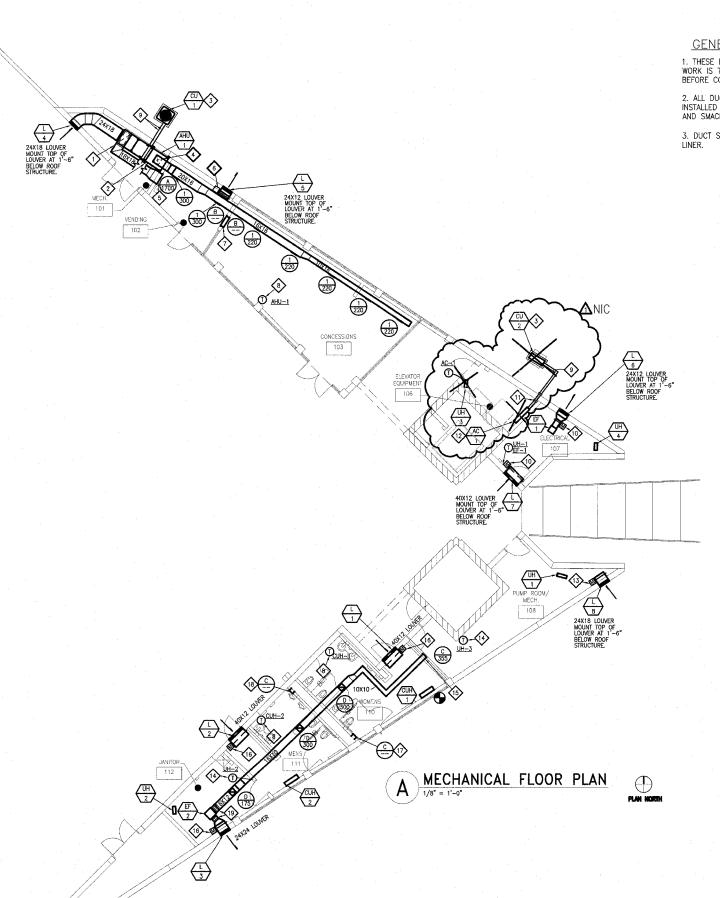

FEDERAL AID PROJECT

			E	LECTRIC	HE	AT	ER					
MARK	AREA	MFR.	MODEL	TYPE	CFM	KW	STEPS	мвн	ELECTRI	CAL	OPER.	NOTES
CUH UH	SERVED		WOBLE		H/L		SILIS	IVIDIT	V/PH/HZ	FLA (MCA)	WT. LBS.	MOTES
UH-1	PUMP/MECH.	MARKEL	5100	WALL-MOUNT	400	10	1	34.1	208/3/60	20.8	55	1,7,8,9,10
UH-2	JANITOR	MARKEL	5100	WALL-MOUNT	400	3.3	1	11.5	208/3/60	6.9	30	1,7,8,9,10
- ∪H=3	ELEV. EQUIP.	MARKEL	5100	WALL-MOUNT	400	3.3	7	11.5	200/3/00	6.9	30	1,7,8,9,10
UH-4	ELECT.	MARKEL	5100	WALL-MOUNT	400	3.3	1	11.5	208/3/60	6.9	30	1,7,8,9,10
CUH-1	WOMEN'S	MARKEL	633306	FLOOR-MOUNT	250/230	6	2	20.4	208/3/60	17.6	118	1,2,3,4,5,6
CUH-2	MEN'S	MARKEL	6333-06	FLOOR-MOUNT	250/230	6	2	20.4	208/3/60	17.6	118	1,2,3,4,5,6

NOTES

V/PH/HZ

208/3/60 1 THRU 12

1.) 3-POLE CIRCUIT BREAKER/DISCONNECT
2.) 1" PLEATED MEDIA FILTER
3.) KICK SPACE PEDESTAL

5.) NON SPACE PEDESTAL 4.) FRONT INLET/TOP OUTLET 5.) FACTORY MOUNTED TRANSFORMER 6.) INTEGRAL THERMOSTAT 7.) WALL BRACKET WITH DUST SHIELD

MODEL

EF-1 ELECTRICAL COOK 60SQN-B ILC 175

EXHAUST FAN

EF-2 TOL./PUMP COOK 120SQN-B ILC 1130 .35 1370 BELT 12.5 1/4 115/1/60 5.8 193 1,2,3,4,5,6,7,8,9,10,11,1

8.) OSHA FAN GUARD
9.) LOW VOLTAGE THERMOSTAT
10.) TRANSFORMER AND CONTACTOR

RPM DRIVE SONES

ŝ					
-	-				
1					
_	<u> </u>	NIC	7		

ELECTRIC HEATING COIL CAPACITIES

ELECTRICAL AIR PD "WC

208/3/60 .02

TOT. EAT LAT MBH DB DB

.56 58 56 88 17

ARFA

SERVED

MFR.

MARK

(EF)

EF = 2 TOL./PUMP COOK 120SON—B ILC 1130 .35 1.

**NOTES:
1.) PRE-WIRED DISCONNECT SWITCH 7.) 115V MOTORIZED DAMPER
2.) EXTENDED LUBRICATION LINES 8.) FLANGED INLET
3.) THERMAL OVERLOAD MOTOR 9. FLANGED UNILET
4.) SPRING VIBRATION ISOLATION HANGERS 10.) INLET COMPRESSION FLANGE
5.) OHSA GUARD/MOTOR COVER 11.) OUTLET COMPRESSION FLANGE
6.) 24 HOUR TIME CLOCK 12.) INLET/OUTLET FLEXIBLE DUCT CONNECTORS

TYPE CFM E.S.P. (" WC)

.25 1754 BELT 9.4 1/6 115/1/60

TYPE:
ILC - INLINE CENTRIFUGAL EXHAUST OR SUPPLY FAN

ELECTRICAL

V/PH/HZ FLA (MCA)

NOTE: FANS SELECTED BASED UPON A MEDIUM DRIVE LOSS FOR BELT DRIVEN MODELS. FANS ALSO SELECTED AT AN ALTITUDE OF 496 FT AND 70°F.

NOTES

4.4 145 1,2,3,4,5,6,8,10,12

OPER WT. LBS.

			-					Ε	LEV	/AT(OR	RO	MC	UNIT	•					
MARK		REA RVED	MF	R	M	ODEL.	NO CF		SP S	ENS.	TOT. D		TES E EFRIG. TYPE	ELEC. RE			TRICAL H/HZ	INDOOR FLA	OPER. WT. LBS.	NOTES
AC1	ELEVATOR	EQUIPMENT	CARR	IER	38	8NE018	72	6	- [18.6	67	R22	18,000	1/10	208,	/1/60	.4	27.5	1,2
2.) REFRIG	PROCESSOR C ERANT LINE SE	T SIZEÓ BY	MANUFACTURER												÷				_	
					AIR	CO	OLE	D	CO	ND	ENS	ING	UN	IT			**************************************			
MADIC						CO			CO			ING ENSER			ELECTRI	CAL	ODED	NOTES		
MARK	UNIT SERVED	MFR.	MODEL		LING CAP.			CO QTY.	MPRES TONS	SSOR	COND QTY.		UNIT SEER	REFR.	ELECTRI V/PH/HZ	CAL FLA (MCA)	OPER. WT. LBS.	NOTES		
		CARRIER	38BRG036	COO	CAP.	O.A. DES. AMB *F	TEMP. MIN. AMB	CO QTY.	MPRES TONS	SSOR QTY.	COND QTY.	HP EACH	UNIT	REFR.	V/PH/HZ 208/3/60	FLA (MCA)	WT. LBS. 186	NOTES 1,2,3,4,5,6,7,8	,9,10,11	
(CÜ)	SERVED			COO CAP. MBH	CAP.	O.A. DES. AMB	MIN. AMB	CO QTY.	MPRES TONS EACH	SSOR QTY.	COND QTY.	HP EACH	- UNIT SEER	REFR. R-	V/PH/HZ	FLA (MCA)	WT. LBS.		,9,10,11	-∆ NIC

AIR HANDLING UNIT

CFM DB WB MBH MBH DB WB DB

MOD. 95 78 33.5 36.8 78 65

DX COOLING COIL CAPACITIES

LAT AIR T WB PD N

60 58

OUTDOOR AIR

8.) 6" BASE RAIL (NEOPRENE PAD BETWEEN FLOOR AND RAIL)
9.) BELT GUARD
10.) FACTORY-MOUNTED STARTER AND DISCONNECT
11.) COZ SENSOR MOUNTED IN RETURN AIR DUCT
12.) SEVEN DAY PROGRAMMABLE THERMOSTAT

SUPPLY FAN

2.17 1.00 3

NOM TSP ESP CFM "WC "WC

MFR.

AREA

SERVED

CONCESSIONS/VENDING

NOTES:

1.) DX COOLING COIL.
2.) ELECTRIC HEATING COIL.
3.) COIL ACCESS SECTION
4.) SUPPLY FAN SECTION
5.) ANGLE FILTER MIXING BOX WITH 2" CARBON FILTERS
6. EXTENDED LUBRICATION LINES
7.) 2" SPRING ISOLATORS ON FAN

MARK

(CU)

MODEL

<u> </u>		sι	JPPL'	Y DIF	FUS	ERS				(2)	EXHA	UST /	RETU	JRN /	TRAI	NSFER	GR	ILLES	
PLAN MARK	MANUFACTURER & MODEL NO.	NECK SIZE	FACE SIZE	MOUNT	MATE~ RIAL	ACCES- SORIES	FINISH	TYPE	NOTES	PLAN MARK	MANUFACTURER MODEL NO.	NECK SIZE	FACE SIZE	MOUNT	MATE- RIAL	ACCES- SORIES	FINISH	TYPE	NOTES
1	TITUS 300FS	12X10	14X12	DUCT SIDEWALL	AL.	vc	BWE	DD		A	TITUS 350FL	24X24	-	DRYWALL SIDEWALL	AL	VC	BWE	FAB	
										В	TITUS 350FL	24X20	-	DRYWALL SIDEWALL	AL.	_	BWE	FAB	
										С	TITUS 350FL	10X10	_	DRYWALL SIDEWALL	AL	vc	BWE	FAB	
										D	TITUS 350FL	12X12	_	DUCT SIDEWALL	AL.	VC	BWE	FAB	

MARK	K MFR. MODEL		SIZE HxWxD	FUNCTION		MATE	RIAL	FREE AREA	EFFECTIVENESS RATIO	STATIC PRESS.	NOTES	
(FRAME	BLADE	FINISH	VELOCITY	%	DROP		
L-1	RUSKIN	EME520DD	12X40X5	INTAKE	ALUM.	ALUM.	CLEAR. ANODIZED	500	99.3	.04	1	
L-2	RUSKIN	EME520DD	12X40X5	INTAKE	ALUM.	ALUM.	CLEAR. ANODIZED	500	99.3	.04	1	
L-3	RUSKIN	EME520DD	24X24X5	EXHAUST	ALUM.	ALUM.	CLEAR. ANODIZED	500	99.3	.04	1	
L-4	RUSKIN	EME520DD	18X24X5	INTAKE	ALUM.	ALUM.	CLEAR. ANODIZED	500	99.3	.04	1	
L-5	RUSKIN	EME520DD	12X24X5	EXHAUST	ALUM.	ALUM.	CLEAR. ANODIZED	500	99.3	.05	1	
L-6	RUSKIN	EME520DD	12X24X5	EXHAUST	ALUM.	ALUM.	CLEAR. ANODIZED	500	99.3	.05	1	
L-7	RUSKIN	EME520DD	12X40X5	. INTAKE	ALUM.	ALUM.	CLEAR. ANODIZED	500	99.3	.04	1	
L8	RUSKIN	EME520DD	18X24X5	INTAKE	ALUM.	ALUM.	CLEAR. ANODIZED	500	99.3	.04	1	

H.V.A	.C. DAMPE	R SPEC	IFICATIO	NS	
MANUFACTURER	RUSKIN	RUSKIN	RUSKIN	RUSKIN	RUSKIN
MODEL	MD25	MD35	CD60	CD50	CD102
DAMPER TYPE	BALANCING OVER 12"	BALANCING OVER 12"	CONTROL	CONTROL	CONTROL
FUNCTION	BALANCING 12"H DUCT AND UNDER	BALANCING 13"H DUCT AND OVER	RETURN AIR	OUTSIDE AIR INTAKE	FAN DISCHARGE
SHAPE	RECTANGULAR	RECTANGULAR	RECTANGULAR	RECTANGULAR	RECTANGULAR
MAX. PRESSURE ("WG)	2" (36"W)	2" (36"W)	6.2" (48"W)	6.2"	12.0*
MAX. VELOCITY (FPM)	1500	1500	4000	4000	4000
MAX. PD @ MAX VELOCITY (24X24, 24"DIA)	0.05 "W G	0.05*WG	0.03"WG	0.02 WG	0.01*WG
LEAKAGE @ 1"WG (CFM/SQ.FT.)	-	80@1.0"WG	2.0@1.0*WG	2.0@1.0"WG	8.5@1.0*WG
BLADE MATERIAL	GALV. STEEL	GALV, STEEL	GALV. STEEL	ALUMINUM	ALUMINUM
BLADE CONSTRUCTION	8" WIDE 16 GAGE REINFORCED	8" WIDE 16 GAGE REINFORCED	14 GAGE ROLL FORMED	6" WIDE 6063—T5 EXTRUDED	7.75" WIDE 0.080 6063- EXTRUDED
BLADE TYPE	SINGLE SKIN	SINGLE SKIN	AIRFOIL	AIRFOIL	AIRFOIL
BLADE SEAL MATERIAL	NONE	NONE	NEOPRENE	NEOPRENE	SILICONE RUBBER
FRAME MATERIAL	GALV. STEEL	GALV. STEEL	GALV. STEEL	ALUMINUM	GALV. STEEL
FRAME CONSTRUCTION	5"X1" 16 GAGE	5"X1" 16 GAGE	16 GAGE HAT CHANNEL	5"X1" 0.125" EXTRUDED	10"X2" 12 GA. STEEL CHANNEL
AXLE MATERIAL	STEEL	STEEL	Plated Steel	PLATED STEEL	PLATED STEEL
AXLE DIAMETER	3/8" SQUARE	3/8" SQUARE	1/2"	1/2"	3/4"
BEARING MATERIAL (TYPE)	SYNTHETIC	SYNTHETIC	STAINLESS STEEL	SYNTHETIC	STAINLESS STEEL
NOTES					_

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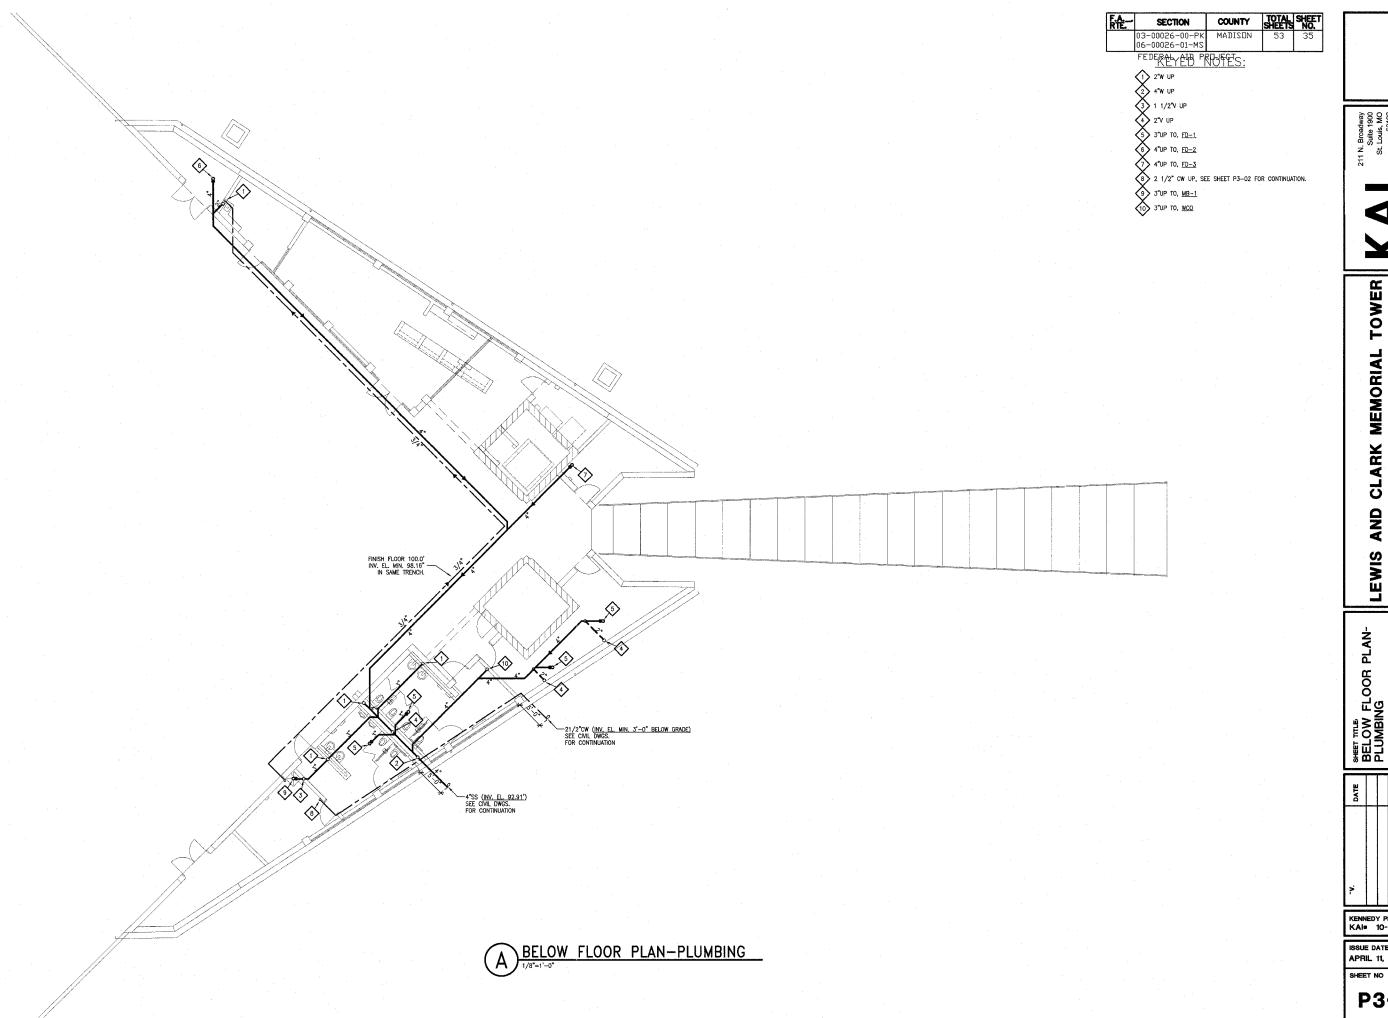
AND CLARK MEMORIAL TOWER OF HARTFORD, ILLINOIS ILLINOIS 62049 VILLAGE HARTFORD, I LEWIS

SHEET TITE
MECHANICAL
SCHEDULES

KENNEDY PROJECT NO KAI* 10-02048

ISSUE DATE APRIL 11, 2008

SHEET NO M3-02



211 N. Broadway Suite 1900 St. Louis, MO 63102 (314) 241-8188 FAX (314) 241-0125


VILLAGE OF HARTFORD, ILLINOIS HARTFORD, ILLINOIS 62049

SHET TILE BELOW FLOOR PLAN-PLUMBING

KENNEDY PROJECT NO KAI® 10-02048

ISSUE DATE APRIL 11, 2008

P3-01

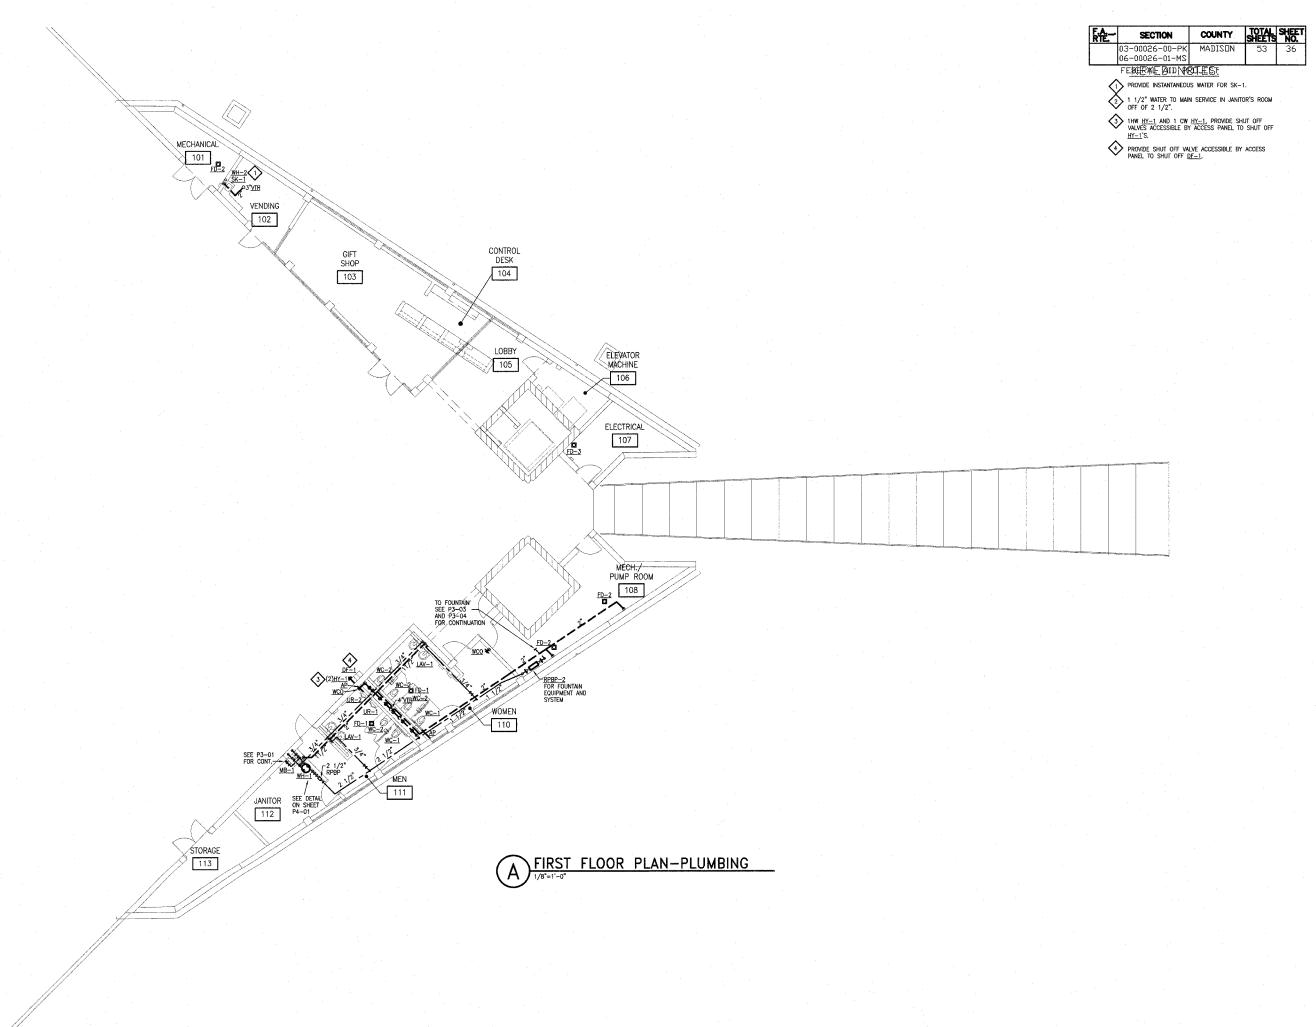

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LEWIS AND CLARK MEMORIAL TOWER VILLAGE OF HARTFORD, ILLINOIS HARTFORD, ILLINOIS 62049


SHET TILE FIRST FLOOR PLAN-PLUMBING

KENNEDY PROJECT NO KAI* 10-02048

ISSUE DATE APRIL 11, 2008

SHEET NO

P3-02

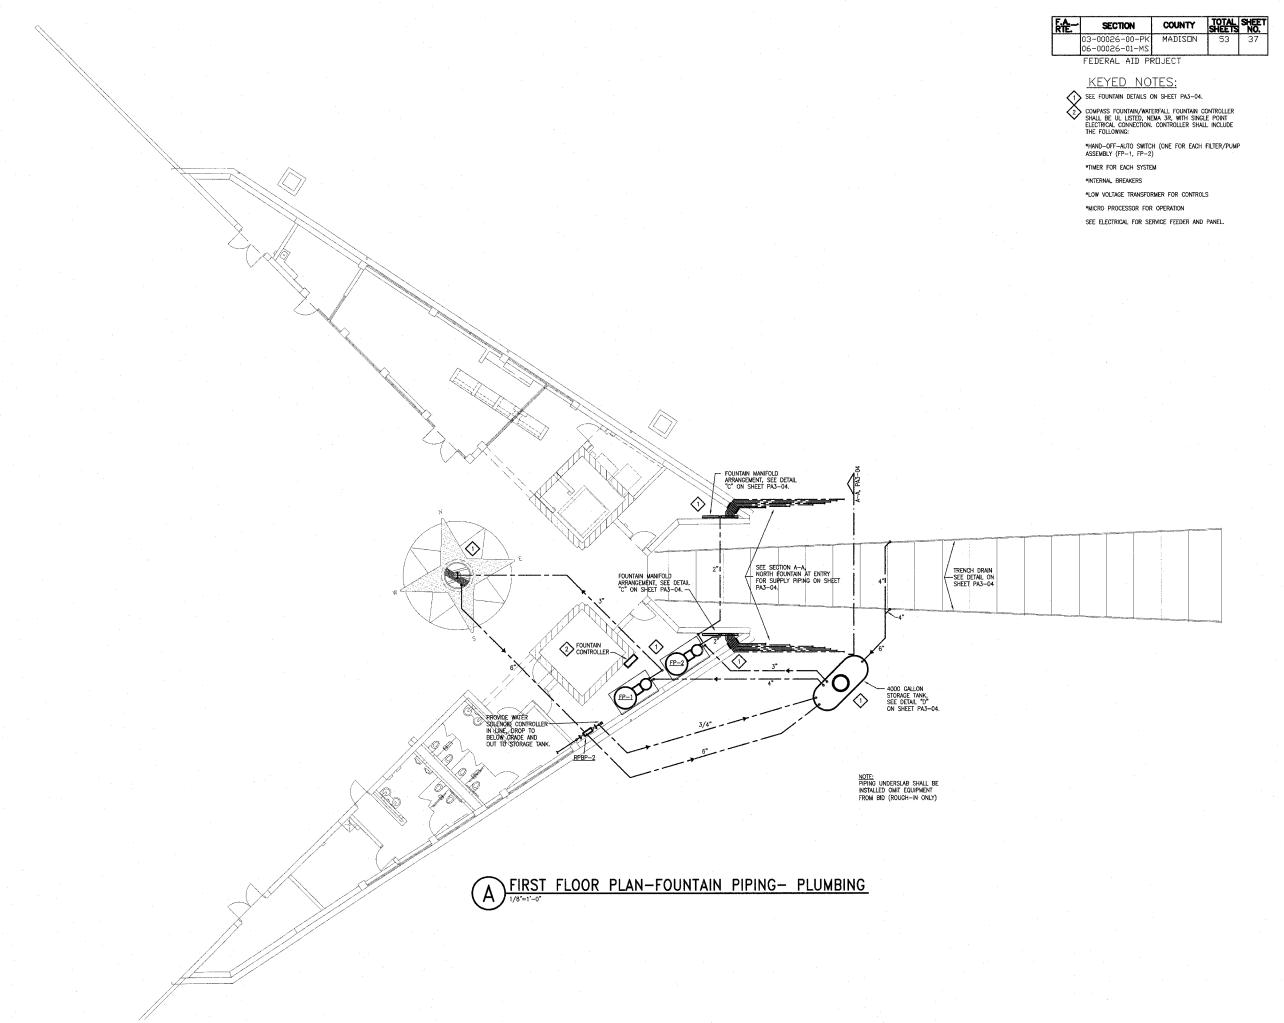

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LEWIS AND CLARK MEMORIAL TOWER

VILLAGE OF HARTFORD, ILLINOIS HARTFORD, ILLINOIS 62049


SHET THE FIRST FLOOR PLAN-FOUNTAIN PIPING-PLUMBING

KENNEDY PROJECT NO KAI# 10-02048


ISSUE DATE APRIL 11, 2008

SHEET NO

P3-03

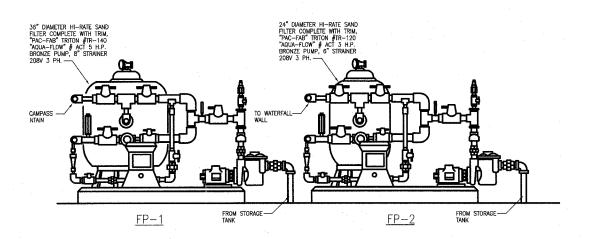


FUTURE FILTER PUMP PIPING ARRANGEMENT

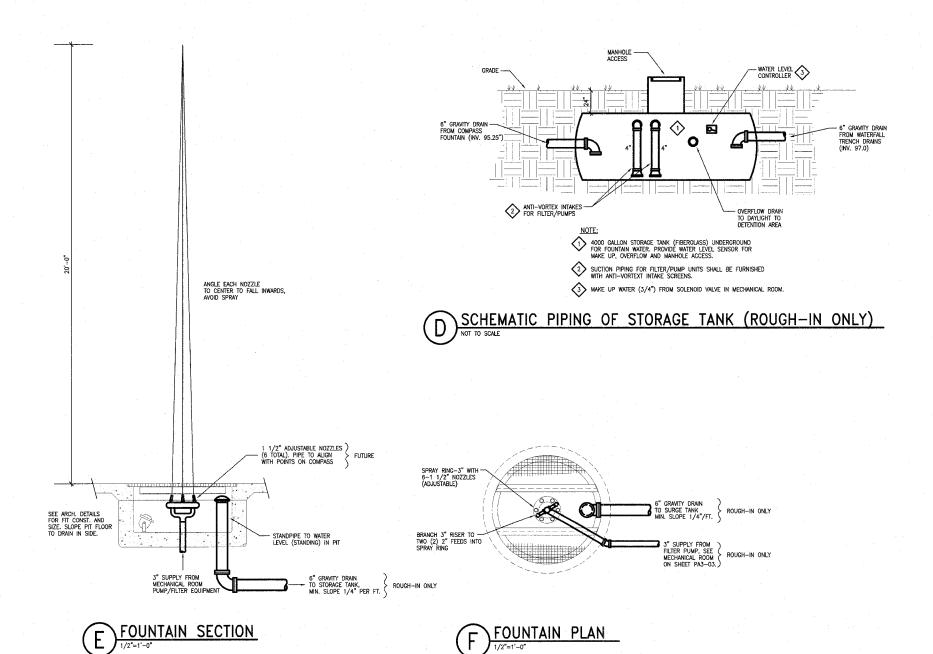

COUNTY SECTION 03-00026-00-PK 06-00026-01-MS FEDERAL AID PROJECT

NOTE: PROVIDE AIR FITTING ON SYSTEM TO BLOW OUT FOR FREEZING PROTECTION.

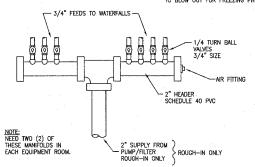


FUTURE FOUNTAIN MANIFOLD ARRANGEMENT

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LEWIS AND CLARK MEMORIAL TOWER VILLAGE OF HARTFORD, ILLINOIS HARTFORD, ILLINOIS 62049

•ಶ SHET THE FOUNTAIN ISOMETRIC 8 DETAILS-PLUMBING

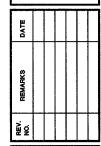

KENNEDY PROJECT NO KAI# 10-02048

ISSUE DATE APRIL 11, 2008

SHEET NO


P3-04


MARK	DESCRIPTION	WASTE	TRAP	VENT	COLD WATER	HOT WATER	REMARKS	
WC-1	WATER CLOSET, WALL HUNG	4"		2°	11/2"	-	ADA, 17"A.F.F., ELEC. FLUSH VALVE	
WC-2	WATER CLOSET, WALL HUNG	4"		2"	11/2"	-	15"A.F.F., ELEC. FLUSH VALVE	
UR1	URINAL, WALL HUNG	2"		2"	1"	-	ADA, 17"A.F.F., ELEC. FLUSH VALVE	
UR-2	URINAL, WALL HUNG	2"	_	2"	1"		24"A.F.F., ELEC. FLUSH VALVE	KOHLER#K-5016-ET/SLOAN#186-1.0ES-S
LAV-1	LAVATORY	2"	11/2"	11/2"	1/2"	1/2"	ADA, ELEC. FAUCET	
DF-1	DRINKING FOUNTAIN	11/2"		11/4"	1/2"		(ADULT) ADA, 40"/36"A.F.F.	RN WILLIAMS#BF~5000 FP
MB1	MOP BASIN, FLOOR SET	3"		2"	3/4"	3/4"	MANUAL FAUCET	STERN WILLIAMS#SB-902/T-10-VB/T-35/T-40/B
HY-1	HYDRANT				3/4"	-	RECESSED, FREEZE PROOF	RECESSED, FREEZE PROOF
SK-1	SINGLE BOWL SINK	2"	11/2*	11/2"	1/2"	1/2"	MAN. FAUCET	ELKAY#DE-11515/S-23

	DRAIN SCHEDULE						
MARK	MANUFACTURER	MODEL NO.	OUTLET SIZE	STRAINER MATERIAL	REMARKS		
FD1	J.R.SMITH	2010	3"	NICKEL BRONZE	TOILET ROOM		
FD-2	J.R.SMITH	2110	4"	CAST IRON	MECHANICAL ROOM AND MECH./PUMP ROOM		
FD-3	J.R.SMITH	3710SC	4"	CAST IRON	ELEVATOR SUMP IN ELECTRICAL ROOM		
NOTE:							

			MISCE	LLANEOU	S EQUIPMENT
MARK	MANUFACTURER	MODEL NO.	CONNECTIONS	INSTALLATION	USE/LOCATION
RPBP-1	FEBCO	860	21/2"	HORIZONTAL	DOMESTIC WATER/MECHANICAL ROOM
RPBP-2	FEBCO	860	. 1"	HORIZONTAL	FOUNTAIN/MECHANICAL ROOM
SP-1	STANCOR	SE50	2"	IN PIT	SUMP PUMP/ELEVATOR PIT
NOTE:					

MARK MANUFAC	THEE						***************************************	,
	JIONER	MODEL NO.	STORAGE	RECOVERY	ELEMENT	VOLT/PH	REMARKS	
WH-1 BRADFORD	WHITE LD	-WH30L3-1C015	30 GAL.	6 GPH	1.5KW	120/1	JANITOR CLOSET	*****
WH-2 BRADFORD	WHITE ES	S-4000-1-S-10		-	4.1 KW	208/3	UNDER SK-1	

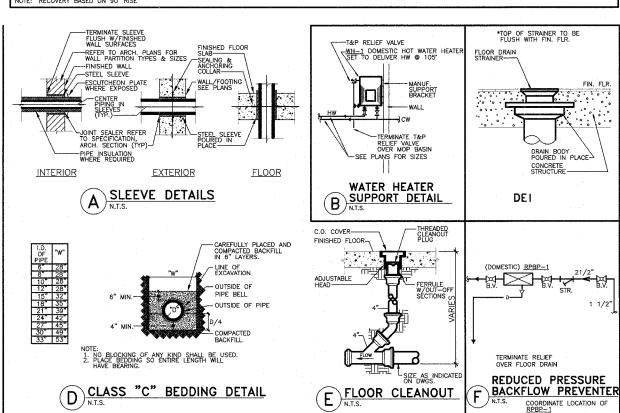

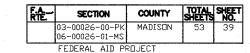


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CLARK MEMORIAL TOWER HARTFORD, ILLINOIS

LEWIS AND CLARK MEMONIC VILLAGE OF HARTFORD, HARTFORD, ILLINOIS 62049

SHEET THE LEGEND, SCHEDULES AND DETAILS PLUMBING

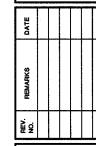


KENNEDY PROJECT NO KAI® 10-02048

ISSUE DATE APRIL 11, 2008

EET NO

P4-01

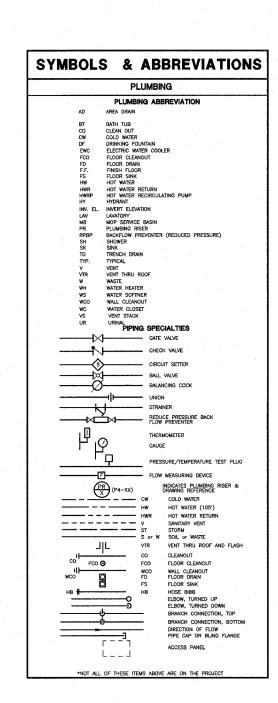

GENERAL NOTES

- 1. REFER TO ARCHITECTURAL REFLECTED CEILING PLANS FOR EXACT LOCATION OF CEILING MOUNTED ELECTRICAL EQUIPMENT (LIGHT FIXTURES, OCCUPANCY SENSORS, ETC.)
- 2. REFER TO ARCHITECTURAL DRAWINGS FOR ELEVATION DRAWINGS INDICATING THE EXACT LOCATION OF WALL MOUNTED INTERIOR AND EXTERIOR LIGHT FIXTURES.
- 3. IN GENERAL, CONDUIT ROUTING SHOWN ON THE DRAWINGS IS DIAGRAMMATIC. ACTUAL CONDUIT ROUTING SHALL BE DETERMINED IN THE FIELD.
- 4. WALL MOUNTED STARTERS, DISCONNECT SWITCHES, COMBINATION STARTERS, ETC. SHALL BE INSTALLED AT 48" TO THE CENTERLINE OF THE DEVICE UNLESS OTHERWISE NOTED ON THE DRAWINGS.
- 5. AT THE ROUGH-IN FOR ALL WALL HEIGHT PHONES, PROVIDE A BLANK COVER PLATE ON THE OUTLET BOX.
- 6. NOT ALL SYMBOLS ARE USED IN EACH PHASE OF THIS PROJECT.


ABBREVIATIONS

ADDKE	VIATIONS
A	AMPERE(S)
AIC.	AMPERE INTERRUPTING CAPACITY
AC	ALTERNATING CURRENT
AF	AMP FUSE
AWG	AMERICAN WIRE GUAGE
AS	AMP SWITCH
CATV	CABLE TELEVISION
CCTV	CLOSED CIRCUIT TELEVISION
CKT	CIRCUIT
CONTR	CONTRACTOR
C/B	CIRCUIT BREAKER
COND	CONDUCTOR
CONN	CONNECTION
C	CONDUIT
CONT	CONTROL
ELEC	ELECTRICAL
EMER	EMERGENCY
EWC	ELECTRIC WATER COOLER
F	FUSED
FACP	FIRE ALARM CONTROL PANEL
FLA	FULL LOAD AMPS
FURN	FURNISHED
G	GROUND
GFI	GROUND FAULT INTERRUPTING
HD	HEAVY DUTY
HID	HIGH INTENSITY DISCHARGE
HPS	HIGH PRESSURE SODIUM
IMC	INTERMEDIATE METAL CONDUIT
INC	INCANDESCENT
INST	INSTALLED
KW	KILOWATTS
KVA	KILOVOLT AMPERES
MCA	MINIMUM CIRCUIT AMPACITY
MCB	MAIN CIRCUIT BREAKER
MCC	MOTOR CONTROL CENTER
MCM	THOUSAND CIRCULAR MILS
	MAIN LUGS ONLY
MTD	MOUNTED
NEC	NATIONAL ELECTRICAL CODE
NF	NON FUSED
NL	NIGHT LIGHT
Р	POLE
PF	POWER FACTOR
PH	PHASE
PNL	PANEL
PRI	PRIMARY
PVC	POLYVINYLCHLORIDE
REC	RECEPTACLE
RECEP	RECEPTACLE
SEC	SECONDARY
SURF	SURFACE
SWBD	SWITCHBOARD
SWBT	SOUTHWESTERN BELL TELEPHONE
SYM	SYMMETRICAL
TELE	TELEPHONE
	TEMPORARY
THD	TOTAL HARMONIC DISTORTION
	TRANSFORMER
	TELEPHONE TERMINAL BOARD
	TELEVISION
UH	UNIT HEATER
٧	VOLTS
VA	VOLTAMPS
	VIDEO TERMINAL BOARD
₩	WATTS


WEATHERPROOF

LIGHT FIXTURE DESIGNATION MATRIX

LIGHT FIXTURE - SYMBOL VARIES.

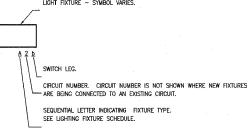

MISCELLANEOUS

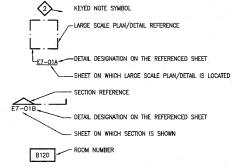

FA-	SECTION	COUNTY	TOTAL SHEETS	SHEET NO.
	03-00026-00-PK 06-00026-01-MS		53	. 40

FEDERAL AID PROJECT

DUPLEX RECEPTACLE - "GFI" INDICATES GROUND FAULT

PROTECTED" BY UPSTREAM GFI DEVICE ON SAME CIRCUIT,

INTERRUPTING WITH TEST AND RESET BUTTONS, "P" INDICATES "GFI

DOUBLE DUPLEX RECEPTACLE INSTALLED ABOVE COUNTERTOP (42"

(42" WHERE NO COUNTERTOP)

DOUBLE DUPLEX RECEPTACLE

JUNCTION BOX SINGLE POLE SWITCH

3-WAY LIGHT SWITCH

MANUAL MOTOR STARTER

LIGHTING CONTACTOR

INTERCOM

POWER SUPPLY

CEILING MOUNTED OCCUPANCY SENSOR

LIGHTING CONTROL RELAY PANEL

DIMMER SWITCH

ര

€7-3

R

М

PS

WIRING DEVICES

Ġ CEILING MOUNTED DOWNLIGHT DISCONNECT SWITCH - "WP" DENOTES WEATHERPROOF Ó Ю WALL MOUNTED LIGHT FIXTURE FLECTRIC MOTOR CEILING MOUNTED FLUORESCENT FIXTURE 0 SINGLE RECEPTACLE

DUPLEX RECEPTACLE CEILING MOUNTED FLUORESCENT FIXTURE CONNECTED TO DUPLEX RECEPTACLE INSTALLED ABOVE COUNTERTOP

- FLUORESCENT STRIP LIGHT

CEILING MOUNTED EXIT SIGN WITH EMERGENCY BATTERY PACK EXTERIOR FLOODLIGHT - ARROW INDICATES AIMING DIRECTION 0


> --POLE MOUNTED SITE LIGHTING LUMINAIRE

LIGHTING

ROLL ARD

0

DISTRIBUTION EQUIPMENT

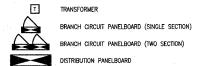

CONDUIT STUB

TRANSFORMER

ADJUSTABLE SPEED DRIVE

PRE WIRED CONTROL PANEL

CURRENT TRANSFORMERS

GROUND FAULT PROTECTION

COMBINATION MAGNETIC STARTER/DISCONNECT SWITCH

MOTOR - NUMBER WITHIN SYMBOL DENOTES HORSEPOWER RATING

DISCONNECT SWITCH

MAGNETIC STARTER

GROUND

FUSE SWITCH ► G — — GROUND BUS ► N - NEUTRAL BUS ASD

느

38

б

 \boxtimes

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 $\geq \leq$

(GFP)

ONE LINE/WIRING/CONDUIT

CONDUIT INSTALLED CONCENTED WITHIN WALLS AND ABOVE CERTING

	CONDON INSTALLED CONCEALED WITHIN WALLS AND ADOVE CEILING.		
	CONDUIT INSTALLED BELOW GRADE, SLAB OR FLOOR		
#	WIRING HOMERUN TO PANELBOARD — SHORT STROKE INDICATES PHASE CONDUCTOR,		VOICE/DATA
	LONG STROKE INDICATES NEUTRAL CONDUCTOR, LONG STROKE WITH DOT INDICATES EQUIPMENT GROUND CONDUCTOR	₩w	TELEPHONE JACK OUTLET ROUGH-IN - "W" ADJACENT TO DEVICE DENOTES WALL HEIGHT PHONE
0	CONDUIT UP	A	VOICE/DATA JACK OUTLET ROUGH-IN - DESK HEIGHT
	CONDUIT DOWN	⋈ c	VOICE/DATA JACK OUTLET ROUGH-IN - ABOVE COUNTER
3	CONDUIT CAPPED		

FIRE ALARM

E4 75	FIRE ALARM STROBE LIGHT - NUMBER INDICATES CANDELA SETTING
⊡ 475	FIRE ALARM COMBINATION HORN/STROBE LIGHT — NUMBER INDICATES CANDELA SETTING —
F	FIRE ALARM PULL STATION
FACP	FIRE ALARM CONTROL PANEL
 —⊚	DUCT MOUNTED SMOKE DETECTOR WITH SAMPLING TUBE
©	CEILING MOUNTED SMOKE DETECTOR
Θ	HEAT DETECTOR

TS TAMPER SWITCH FS FLOW SWITCH СМ CONTROL MODULE

MONITOR MODULE

NOT ALL SYMBOLS AND ABBREVIATIONS ARE USED IN EACH PHASE OF THIS PROJECT.

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S St. L St. L (314) (314) (314)



TOWER ILLINOI

MEMORIAL OF HARTFORD, ILLINOIS 62049 CLARK AND VILLAGE HARTFORD, S EWI


S ELECTRICAL SYMBOL AND ABBREVIATIONS

KENNEDY PROJECT NO KAI# 10-02048

ISSUE DATE APRIL 11, 2008

SHEET NO

E1-01

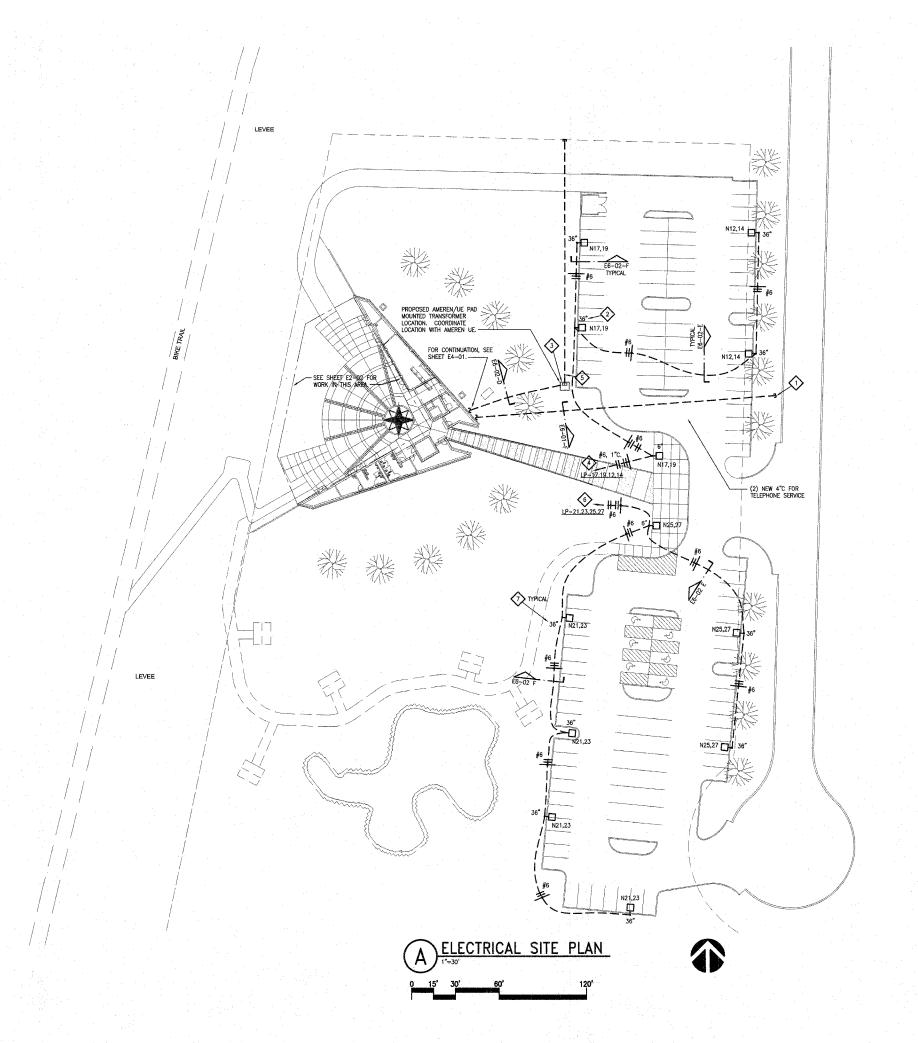

TOTAL SHEET SHEETS NO. SECTION COUNTY 03-00026-00-PK 06-00026-01-MS

FEDERAL AID PROJECT

KEYED NOTES

- CONDUIT SHALL BE EXTENDED TO PROPERTY LINE, CAPPED AND LABELED TELEPHONE, AND STAKED FOR LOCATION.
- DIMENSION DENOTES HEIGHT OF CONCRETE BASE ABOVE GRADE. TYPICAL FOR ALL POLES. SEE DETAILS ON SHEET 66-02 FOR ADDITIONAL INFORMATION.
- 3 E.C. SHALL FURNISH AND INSTALL TRANSFORMER PAD. SEE DETAIL B, SHEET E6-02.
- EXTEND AND CONNECT TO PANEL VIA CONTACTOR C1. SEE SHEET E4-01 FOR CONTACTOR LOCATION.
- \$\(\) (2) 5" UNDERGROUND PVC CONDUITS FOR PRIMARY SERVICE ENTRANCE. EXTEND TO PROPERTY LINE AND CAP OFF BELOW GRADE. PROVIDE IN ACCORDANCE WITH AMEREN UE REQUIREMENTS.
- EXTEND AND CONNECT TO PANEL VIA CONTACTOR, SEE SHEET E4-01 FOR LOCATION OF CONTACTOR C2.
- 7) DIMENSION DENOTES HEIGHT OF CONCRETE BASE ABOVE GRADE. TYPICAL FOR ALL POLES. SEE DETAIL A ON SHEET E6-02 AND DETAIL E ON SHEET E6-01 FOR ADDITIONAL INFORMATION.

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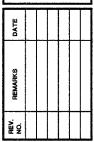


TOWER

VILLAGE OF HARTFORD, ILLINOIS HARTFORD, ILLINOIS 62049 CLARK MEMORIAL AND

SHEET TITLE.
ELECTRICAL SPLAN

LEWIS





KENNEDY PROJECT NO KAI* 10-02048

APRIL 11, 2008

SHEET NO

E2-01

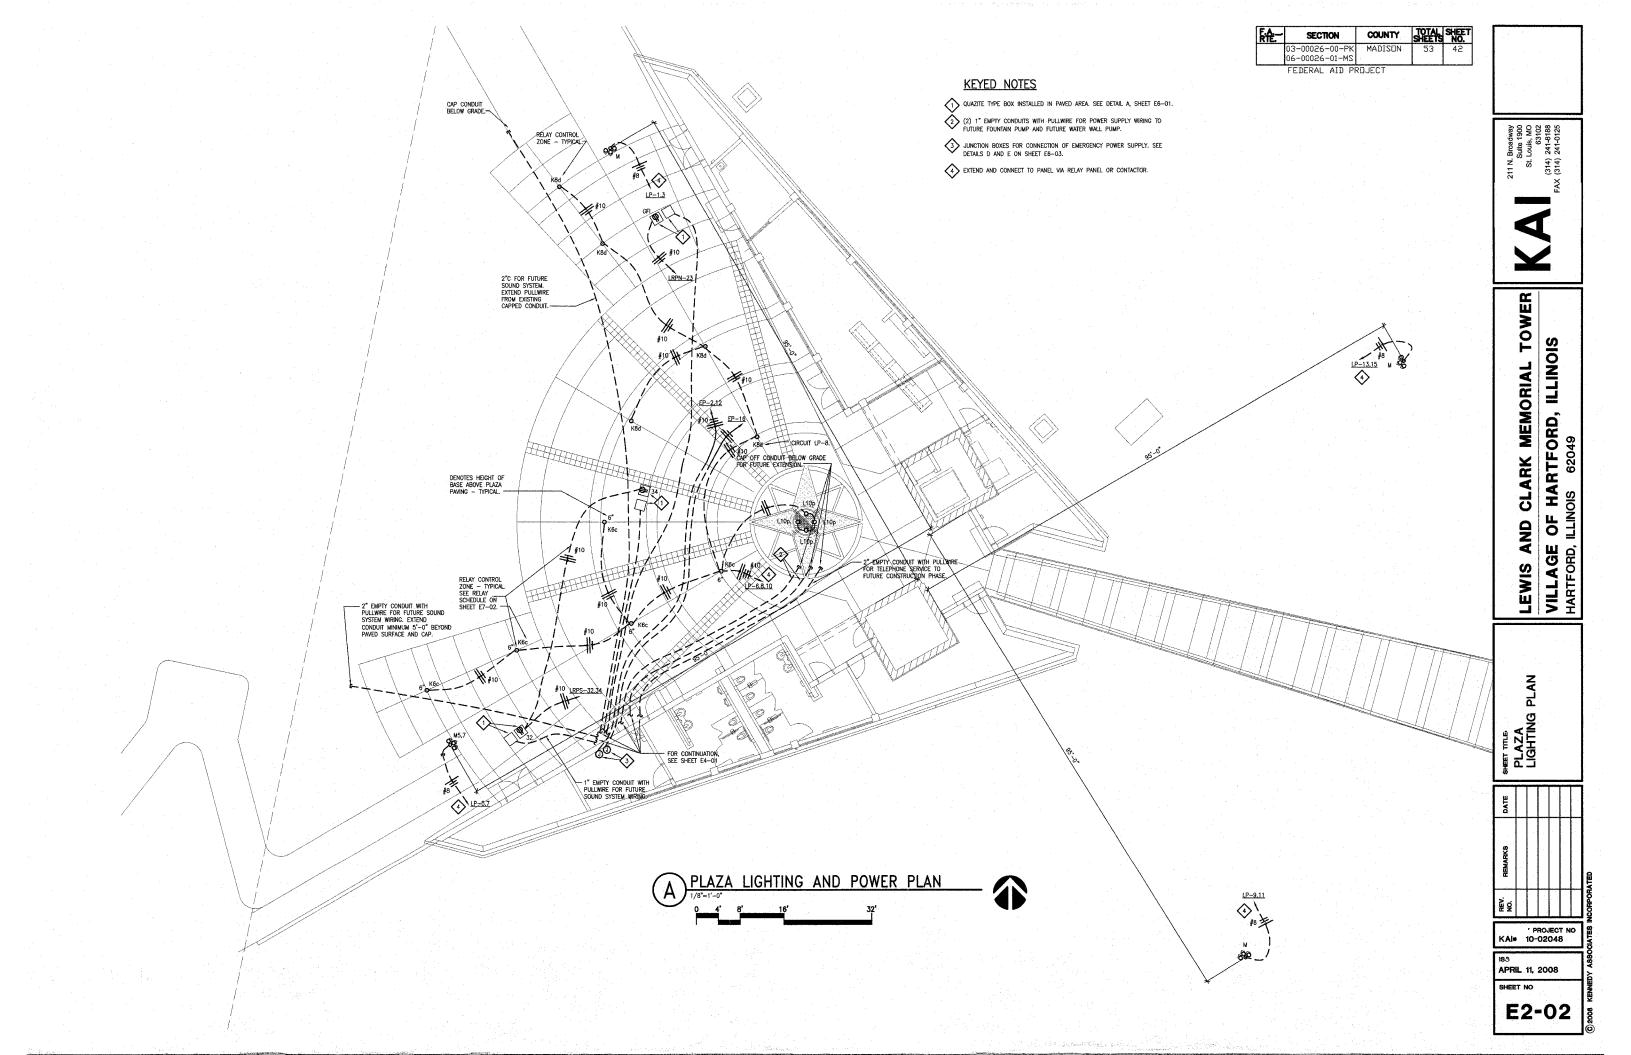

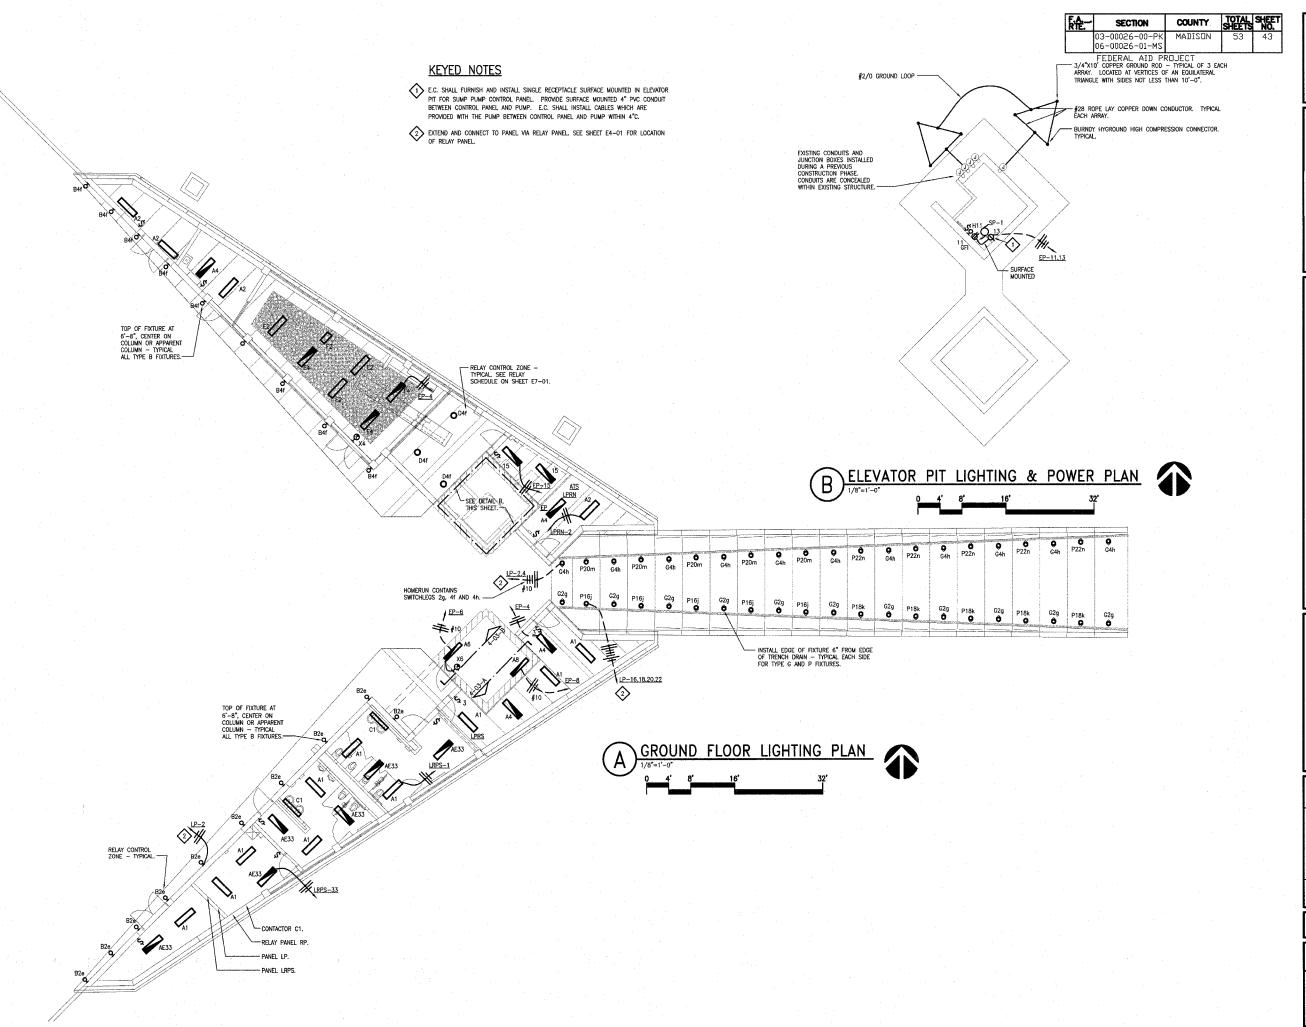


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LEWIS AND CLARK MEMORIAL TOWER ILLINOIS

OF HARTFORD, I VILLAGE HARTFORD, I

SHET TILE.
GROUND FLOOR
LIGHTING PLAN

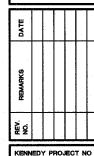



KENNEDY PROJECT NO KAI: 10-02048

ISSUE DATE APRIL 11, 2008

SHEET NO

E3-01

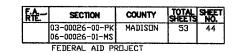

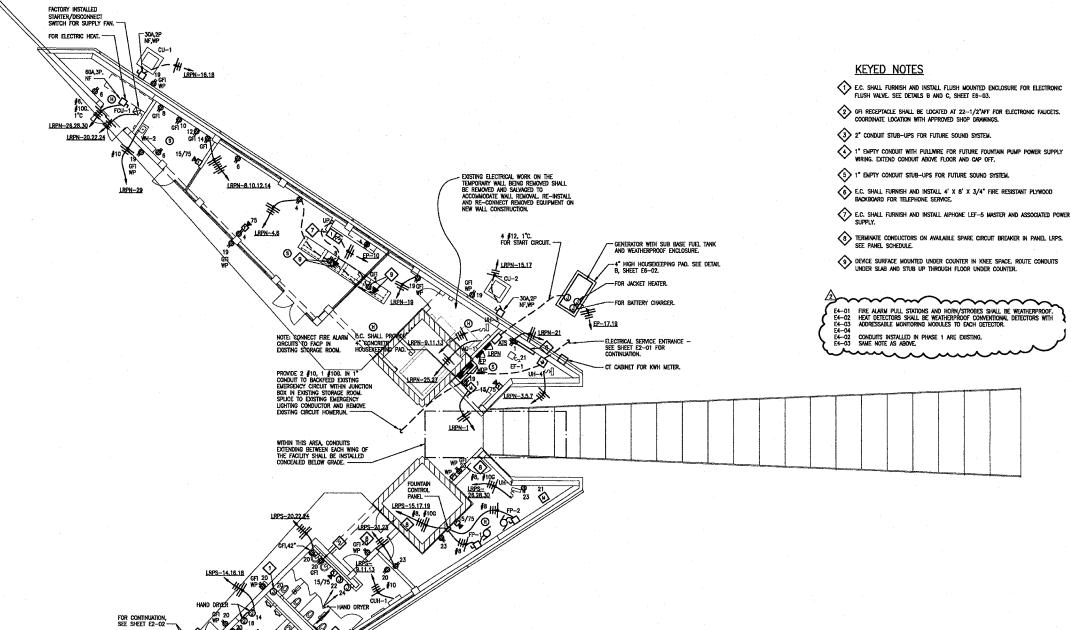

GROUND FLOOR POWER PLAN

TELEPHONE SERVICE ENTRANCE SEE SHEET E2-01 FOR CONTINUATION.

R. LOAD, NO. OF LO

ND CLARK MEMORIAL TOWER
OF HARTFORD, ILLINOIS
ILLINOIS 62049 AND LEWIS AN VILLAGE HARTFORD, II

GROUND FLOOR
POWER PLAN

KENNEDY PROJECT NO KAI® 10-02048

ISSUE DATE APRIL 11, 2008


SHEET NO

E4-01

FÆ.	SECTION	COUNTY	TOTAL SHEETS	SHEET NO.
	03-00026-00-PK 06-00026-01-MS		53	45
	FEDERAL AID PR	ROJECT		

KEYED NOTES

E.C. SHALL FURNISH AND INSTALL AIPHONE LE—DA OUTDOOR WEATHERPROOF INTERCOM STATION WITHIN EXISTING ROUGH—IN INSTALLED DURING PHASE 1 CONSTRUCTION. PROVIDE A 4 CONDUCTOR 18 AWG STP CABLE WIRING HOMERUN FROM EACH STATION TO THE MASTER STATION IN THE GIFT SHOP. SEE SHEET E4—01 FOR LOCATION OF MASTER STATION.

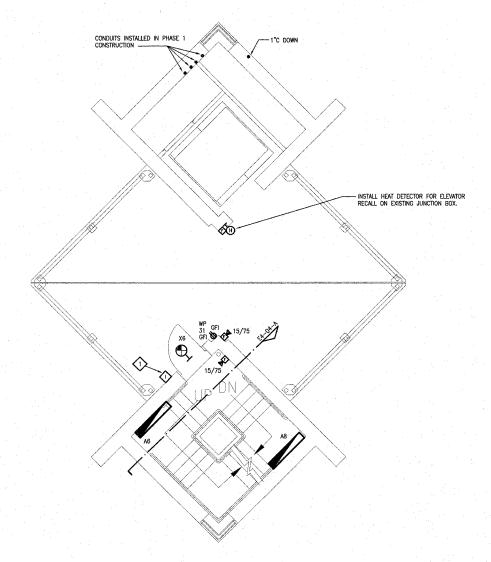

B SECOND LANDING ELECTRICAL PLAN



211 N. Broadway Suite 1900 St. Louis, MO 63102 (314) 241-8188 FAX (314) 241-0125


LEWIS AND CLARK MEMORIAL TOWER
VILLAGE OF HARTFORD, ILLINOIS
HARTFORD, ILLINOIS 62049

SHEET TILE.
LANDING ELECTRICAL
PLANS

KENNEDY PROJECT NO KAI= 10-02048

ISSUE DATE APRIL 11, 2008

E4-02

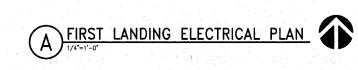

INSTALL HEAT DETECTOR FOR ELEVATOR RECALL ON EXISTING JUNCTION BOX.

CONDUITS INSTALLED IN PHASE 1
CONSTRUCTION

FA.	SECTION	COUNTY	TOTAL SHEETS	SHE
1	03-00026-00-PK 06-00026-01-MS		53	46

FEDERAL AID PROJECT


KEYED NOTES

E.C. SHALL FURNISH AND INSTALL AIPHONE LE-DA OUTDOOR WEATHERPROOF INTERCOM STATION WITHIN EXISTING ROUGH-IN INSTALLED DURING PHASE 1 CONSTRUCTION.

2 SEE DETAILS F AND G ON SHEET E6-01.

EXISTING JUNCTION BOX AND CONDUIT FOR LIGHTNING PROTECTION INSTALLED DURING PHASE 1. ROUTE DOWN CONDUCTOR DOWN TO GROUND ARRAY.

- LIGHTNING PROTECTION CONDUCTOR SECURED TO ROOF.

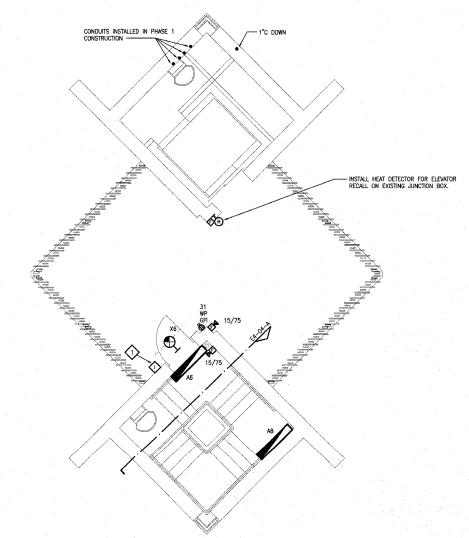

THIRD LANDING ELECTRICAL PLAN



EXISTING SPARE JUNCTION BOX AND CONDUIT INSTALLED DURING PHASE 1. ROUTE LIGHTNING PROTECTION DOWN CONDUCTOR DOWN TO GROUND ARRAY.

JUNCTION BOX AND 3/4"C DOWN FOR FUTURE FIRE ALARM ACCESS INSTALLED WITH PHASE 1.

SPARE JUNCTION BOX AND 3/4"C DOWN INSTALLED WITH PHASE 1.

ROOF LANDING ELECTRICAL PLAN

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Suite 1900
St. Louis, MO
63102
(314) 241-8188
FAX (314) 241-0125


LEWIS AND CLARK MEMORIAL TOWER VILLAGE OF HARTFORD, ILLINOIS 62049

SHEET TILE.
LANDING ELECTRICAL
PLANS

KENNEDY PROJECT NO KAI: 10-02048

ISSUE DATE APRIL 11, 2008 SHEET NO

E4-03

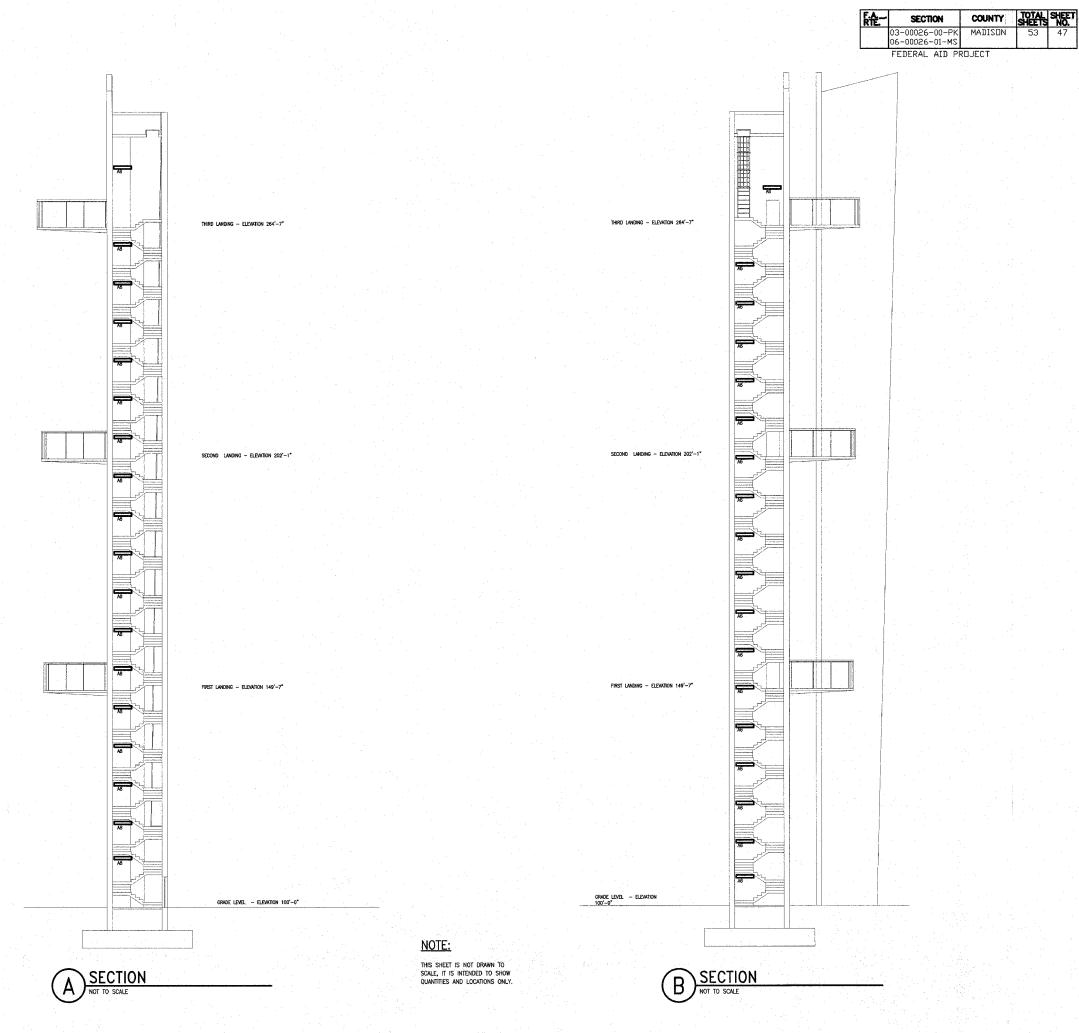

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LEWIS AND CLARK MEMORIAL TOWER VILLAGE OF HARTFORD, ILLINOIS 62049 VILLAGE HARTFORD, I

SHEET TITLE
ELECTRICAL SECTIONS


KENNEDY PROJECT NO KAI# 10-02048

ISSUE DATE APRIL 11, 2008 SHEET NO

E4-04

MADISON	53	48
2		
	MADISON	

FEDERAL AID PROJECT

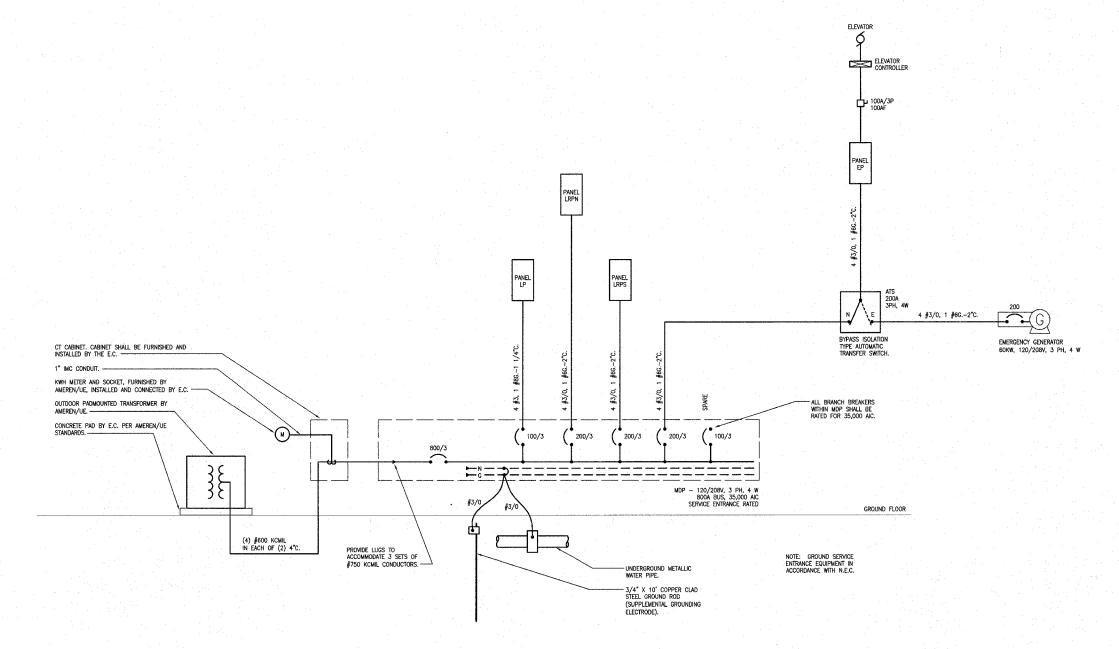

ONE LINE DIAGRAM

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LEWIS AND CLARK MEMORIAL TOWER VILLAGE OF HARTFORD, ILLINOIS 62049


SMET TITLE
ONE LINE DIAGRAM

KENNEDY PROJECT NO KAI* 10-02048


ISSUE DATE APRIL 11, 2008

SHEET NO

E5-01

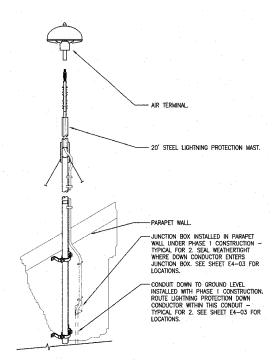


LIGHTNING PROTECTION MOUNTING

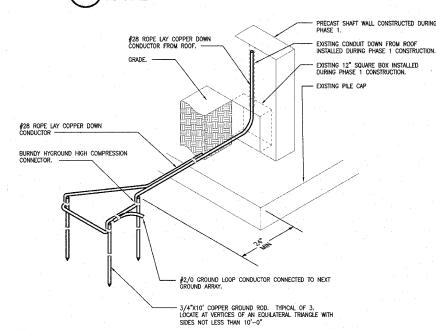



LIGHTNING PROTECTION GROUND ARRAY


The Control of the Control

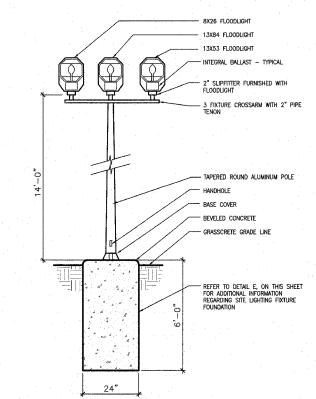

FLOODLIGHTING FIXTURE "TYPE M"

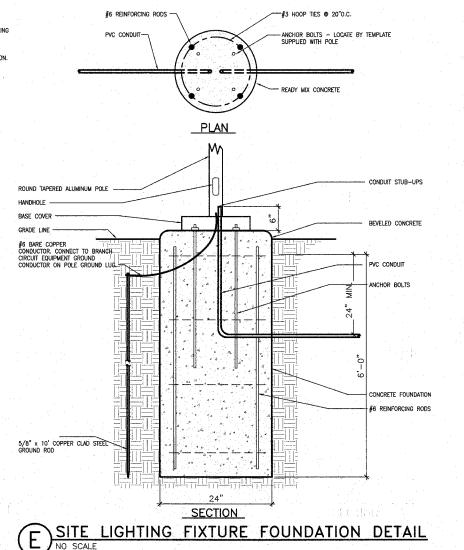

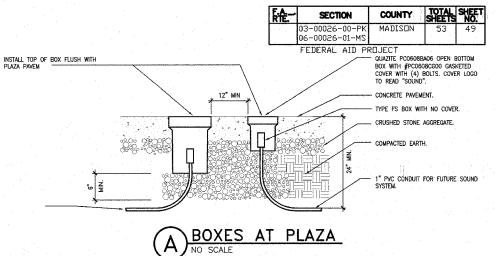

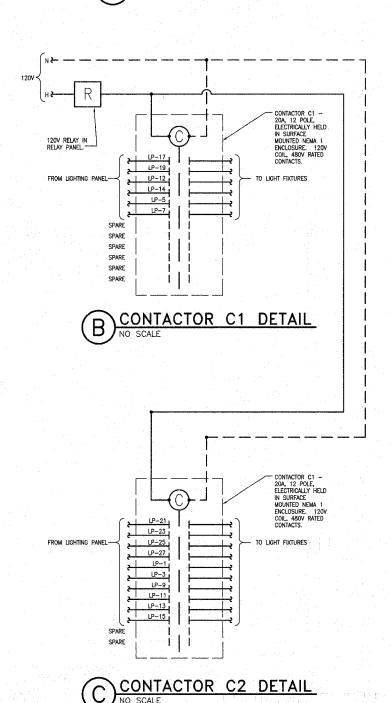




ILLINOIS

AND CLARK MEMORIAL TOWER OF HARTFORD, ILLINOIS 62049 VILLAGE HARTFORD, LEWIS

DETAILS SHEET TILLE.
ELECTRICAL I

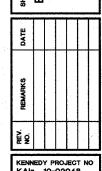


KENNEDY PROJECT NO KAI* 10-02048


ISSUE DATE APRIL 11, 2008 SHEET NO

E6-01

SECONDARY SERVICE ENTRANCE DUCTBANK NO SCALE

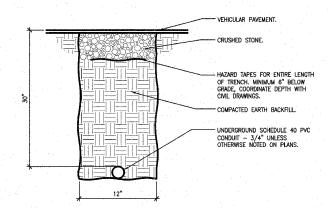


CONDUIT TRENCH UNDER VEHICULAR PAVEMENT

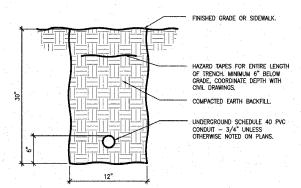


CONDUIT TRENCH IN GRASS OR UNDER SIDEWALK
NO SCALE

TOTAL SHEET SHEETS NO. 53 50 SECTION COUNTY 03-00026-00-PK MADISON

FEDERAL AID PROJECT

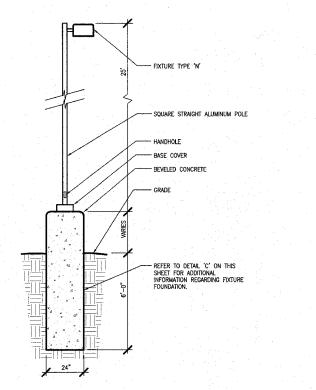

SITE LIGHTING FIXTURE DETAIL "TYPE N"

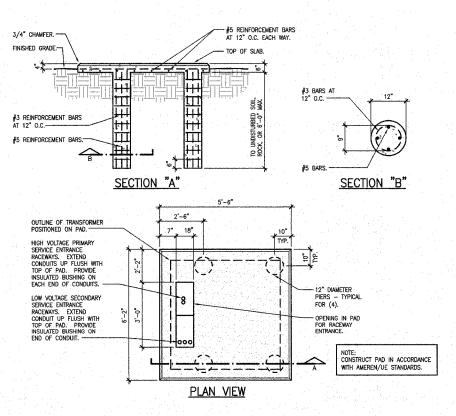

B TRANSFORMER PAD DETAIL

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LEWIS AND CLARK MEMORIAL TOWER VILLAGE OF HARTFORD, ILLINOIS HARTFORD, ILLINOIS 62049


SHEET TITLE
ELECTRICAL DETAILS

KENNEDY PROJECT NO KAI# 10-02048


ISSUE DATE APRIL 11, 2008

SHEET NO


E6-02

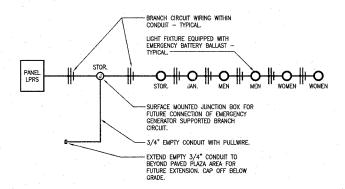


LIFE SAFETY LIGHTING

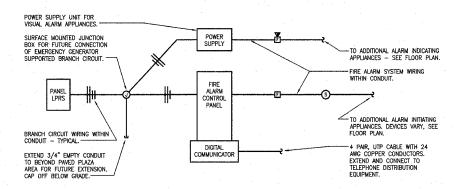


FIRE ALARM SYSTEM SCHEMATIC

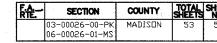


FEDERAL AID PROJECT

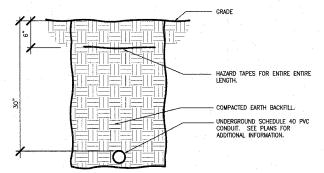


TELEPHONE SERVICE ENTRANCE

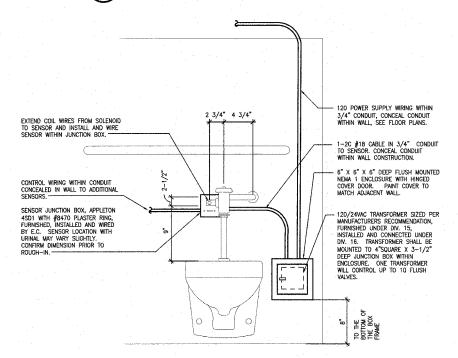

FLUSH VALVE DETAIL FOR WATER CLOSETS AND URINALS NO SCALE

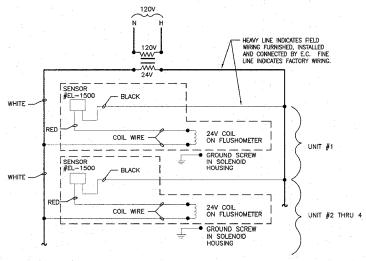

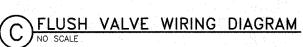


Suite 1900 Suite 1900 Louis, MO 63102) 241-8188 S St. L (314) 2 (314) 2

MEMORIAL TOWER ILLINOIS OF HARTFORD, ILLINOIS 62049 CLARK AND LEWIS AN VILLAGE HARTFORD, I

SHET THE.

ELECTRICAL DETAILS

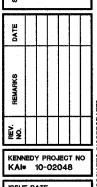

ISSUE DATE **APRIL 11, 2008** SHEET NO

E6-03

RELAY PANEL "RP"								
RELAY NUMBER	PANEL AND CIRCUIT NUMBER	RELAY CONTROL ZONE	CONTROL ZONE LOCATION	PRIMARY CONTROL SOURCE	SECONDARY CONTROL SOURCES	NOTES		
1	LP-41	a	Coil in Contactor C1	PC	none	1		
2	LP-41	b	Coil in Centactor C2	PC	TC	2		
3	LP-6	ç	South Plaza Ltg.	P¢	notie	3		
4	LP-8	d	North Plaza Ltg.	PC	none	3		
5	LP-2	е .	Exterior Bldg. Ltg.	PC	none	3		
6	LP-4	f	Exterior Bldg. Ltg.	PC	none	3		
7	LP-2	g	Water Wall Lighting	PC	TC	2		
8	LP-4	h	Water Wall Lighting	PC	TC	2		
9	LP-16	j.	Water Wall Lighting	PC	TC	2		
10	LP-18	k	Water Wall Lighting	PC	TC	2		
11	LP-20	m	Water Wall Lighting	PC	TC	2		
12	LP-22	n	Water Wall Lighting	PC	TC	2		
13	LP-10	Þ	Fountain Lighting	PC	TC	2		
14	spare relay	q						
15	spare relay	r						
16	spare relay	s						
17	spare relay	t						
18	spare relay	u						
19	spare relay	V						
20	spare relay	w						
21	spare relay	×						
22	spare relay	У						
23	spare relay	Z						
24	spare relay	aa						
25	space for spare relay	- bb						
26	space for spare relay	cc						
27	space for spare relay	dd						
28	space for spare relay	ee						
29	space for spare relay	ff						
30	space for spare relay	gg						
31	space for spare relay	hh						
32	enges for engre relay	ii ii	1					

CONTROL SOURCE LEGEND
PC = PHOTOCELL
TC = TIME CLOCK (within relay panel controller)

NOTES

Note 1 - Photocell controls coil of contactor (via relay) to turn lights "ON" and "OFF" (dusk to dawn operation).

Note 2 - Photocell controls soil of contactor (via relay) to turn lights "ON", time clock controls soil of contactor (via relay) to turn lights "OFF".

Note 3 - Photocell controls relay to turn lights "ON" and "OFF" (dusk to dawn operation).

NOTE

EXISTING RELAY PANEL FURNISHED UNDER A PREVIOUS CONSTRUCTION PHASE. ALL RELAYS ARE EXISTING, RELAYS 3 AND 5 ARE UTILIZED FROM A PREVIOUS CONSTRUCTION PHASE AND ARE TO REMAIN. ALL OTHER EXISTING RELAYS ARE FOR NEW LOADS INSTALLED AS PART OF THIS CONTRACT.

FÆ-	SECTION	COUNTY	TOTAL SHEETS	SHEET NO.
	03-00026-00-PK	MADISON	53	52
	06-00026-01-MS			

FEDERAL AID PROJECT

				LIGHTIN	G FIXTURE SCHEDULE		
TYPE	VOLTS	FIXTURE TYPE	MOUNTING	LAMPS	REFLECTOR/DIFFUSER	FEATURES	APPROVED MANUFACTURERS
A	120	4'x1' FLUORESCENT VANDAL RESISTANT	SURFACE — WALL EXISTING ROUGH—IN IN STAIR TOWER — SEE ELEVATIONS FOR ADDITIONAL INFORMATION	(2) F32T8/TL835 PLUS/ALTO	.156 CLEAR PRISMATIC ACRYLIC LENS	16 GUAGE STEEL HOUSING, ELECTRONIC O' START COLD WEATHER BALLAST, WHITE POWER COAT FINISH	FAILSAFE FWS-232-120-EB81 LITHONIA DAYERITE COLUMBA
AE	120	4'x1' FLUORESCENT VANDAL RESISTANT WITH EMERGENCY BATTERY BALLAST	SURFACE — CEILING / WALL ON EXISTING ROUGH—IN IN STAIR TOWER — SEE ELEVATIONS FOR ADDITIONAL INFORMATION	(2) F32T8/TL835 PLUS/ALTO	.156 CLEAR PRISMATIC ACRYLIC LENS	16 GUAGE STEEL HOUSING, ELECTRONIC O' START COLD WEATHER BALLAST, WHITE POWER COAT FINISH, BODINE B50 EMERGENCY BATTERY BALLAST	FAILSAFE FWS-232-120-EB81-B50 LITHONIA DAYPRITE COLUMIBA
В	120	FLUORESCENT WALL SCONCE	SURFACE - WALL	(1) PL-L 36W/830	OPAL GLASS DIFFUSER	ELECTRONIC BALLAST WITH -15' STARTING, CUSTOM COLOR	BEGA 4482P
C .	120	4'x1' FLUORESCENT VANDAL RESISTANT	SURFACE - WALL	(2) F032/830/EC0	.156 CLEAR PRISMATIC ACRYLIC LENS	16 GUAGE STEEL HOUSING, ELECTRONIC O' START COLD WEATHER BALLAST, WHITE POWER COAT FINISH	FAILSAFE FWW-232-120-EB81 LITHONIA DAYPRITE COLUMIBA
D	120	COMPACT FLUORESCENT SURFACE DOWNLIGHT	SURFACE — CEILING	(1) PL-T 42W/830	.225 BOROSILICATE GLASS	CAST ALUMINUM HOUSING, ELECTRONIC O' START BALLAST, BLACK FINISH, DUAL VOLTAGE BALLAST	FAILSAFE RDS-12-42CT-DT-BK LITHONIA DAYPRITE COLUMIDA
E	120	4'-0" LINEAR FLUORESCENT	SURFACE — CEILING	(1) F54T5/830/H0	SEMI SPECULAR ALUMINUM REFLECTOR WITH ACRYLIC LINEAR DIFFUSING LENS	20 GUAGE STEEL HOUSING, RECTANGULAR PROFILE, ELECTRONIC BALLAST, SINGLE CIRCUIT, TITANIUM SILVER FINISH	FOCAL POINT FMEC-4-1T5HO-1C-120-S-CM-TS
F	120	2'-0" LINEAR FLUORESCENT	SURFACE — CEILING	(1) F24T5/830/H0	SEMI SPECULAR ALUMINUM REFLECTOR WITH ACRYLIC LINEAR DIFFUSING LENS	20 GUAGE STEEL HOUSING, RECTANGULAR PROFILE, ELECTRONIC BALLAST, SINGLE CIRCUIT, TITANIUM SILVER FINISH	FOCAL POINT FMEC-2-1T5HO-1C-120-S-CM-TS
G	120	HID INGROUND LANDSCAPE FIXTURE	INGROUND	(1) CDM35/T6/830	BOROSILICATE LENS WITH CAST ALUMINUM GUARD	DIE CAST ALUMINUM HOUSING, HIGH POWER FACTOR BALLAST, SINGLE 60' OPENING, BLACK FINISH	BEGA 8714MH
н	120	COMPACT FLUORESCENT FIXTURE	SURFACE — WALL 36" ABOVE THE BOTTOM OF THE PIT	(1) PL-C 15MM 22W	POLYCARBONATE GLOBE	DIE CAST ALUMINUM HOUSING, DARK BRONZE FINISH, NORMAL POWER FACTOR BALLAST, UL LISTED WET LOCATION	HALO H2432BZ CAPRI PWY14 (FOR 2XCFT7W/G23 FLUORESCENT) LITHONIA WPCW—22DTT PRESCOLITE WB13—2
J		NOT USED					
К	120	HIÐ LIGHT COLUMN	POLE MOUNTED SEE DETAIL ?, SHEET E6-01	(1) CDM150/T6/830	ANODIZED ALUMINUM REFLECTOR	STAINLESS STEEL FINISH, IP66	LUMEC-SCHREDER NEC-150MH-120-SS
L . ·	120	INCANDESCENT UNDERWATER FLOOD LIGHT	GROUND MOUNTED SEE DETAIL ON DRAWINGS	(1) 35AR111/SSP4	-	PROVIDE FIXTURE MANUFACTURER'S TRANSFORMER, WATTAGE AS REQUIRED.	LUMASCAPE LS285A-3 OR APPROVED EQUAL:
M .	208	HID FLOODLIGHT ASSEMBLY	POLE MOUNTED SEE DETAIL D, SHEET E6-01	(1) MH1000/U FOR EACH FLOODLIGHT	IES BEAM 8X26 - SPOT 154" TILT IES BEAM 13X53 - FLOOD 140" TILT IES BEAM 13X84 - FLOOD 122" TILT	ALUMINUM POLE WITH THREE HEAD BRACKET, DECORATIVE BASE COVER, 2" SUPPRITTER MOUTING FOR FLOODLIGHT, FOUR SIDE SHIELD, BLACK FINISH	STERNER 595-SF-4S-924-H-208-E STERNER 595-SF-4S-1250-H-208-E STERNER 595-SF-4S-1270-H-208-E HAPCO 51-007 POLE AND 63-006 ARM
N	208	HID SITE LIGHTING LUMINAIRE	POLE MOUNTED SEE DETAIL A SHEET E6-02, AND DETAIL E SHEET E6-01	(1) MH400/U	SEGMENTED ALUMINUM TYPE 3	ALUMINUM POLE, UL LISTED WET LOCATION, CASKETED, PLATINUM SILVER FINISH, HIGH POWER FACTOR BALLAST	KIM 1A-AR3-400MH208-PSP-PSA25-5188 GARDCO GULLWING INVUE
Р	120	IN-GROUND FLOODLIGHT	GROUND	(1) 70W METAL HALIDE	GRIP GLASS	=	LUMASCAPE LS343-22N5X1Q4-CG-HT OR APPROVED EQUAL
X	120	SINGLE FACE EXIT SIGN	SURFACE - WALL	LIGHT EMITTING DIODES FURNISHED WITH THE FIXTURE	-	SINGLE FACE, RED LETTERS ON WHITE BACKGROUND, UL LISTED OUTDOOR WET LOCATION, DIE CAST ALUMINUM HOUSING	FAILSAFE XLH-1-RW

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LEWIS AND CLARK MEMORIAL TOWER VILLAGE OF HARTFORD, ILLINOIS 62049

SHEET THE LIGHTING FIXTURE SCHEDULE

KENNEDY PROJECT NO KAI: 10-02048

ISSUE DATE APRIL 11, 2008

SHEET NO

E7-01

PANELBOARD - MOUNTING - ALC, RATING -	SURFAC	<u> </u>				LTAGE PHASE WIRE			120	-	AN		100	. SP -	EUIAL FE	ATURES -	
LOAD DESCRIPTION			(VA)			AKER	CROUIT		PH.	CIRCUIT		AKER		LOAD			LOAD DESCRIPTION
EOFD DESCRIPTION	LIGHT	RECEP.	HVAC	MISC.	AMP	FOLES	untoon	A	BC		POLES	AMP	LIGHT	RECEP.	HVAC	MSC.	
IWFLOODLIGHT	1650				20°	2	1.		4		1.1.	20	912				EXTERIOR ENTRY LIGHTIN
IFFT EOODGIOTTI	1650			120			3		- 50		1	20*	742				EXTERIOR BYTRY LIGHTIN
W PLOOD LIGHT	1650			-	201	2	- 5	133		6	1	20	925				PLAZALIGHTING SOUT
N PLOODEIGHT	1650				1 20	1 1	. 7		210	3	1	20	925	I			PLAZA LIGHTING NOR
E BLOODLIGHT	1650				20×	2	. 8	200	93	10	1	20°	1000				FOUNTAIN LIGHTE
EALOODEGII	1650				1 20		11	100		12	2	20	500	1			PARKING LOT LIGHTING NORT
E FLOODLIGHT	1650				20*	2	1.3		3.13	14	1 -	20	500				
E PLOQUEIGI II	1650				1 20	1 *	15	100	- 100	16	1	20	1000				WATER WALL FLOODLIGHTS
ARKING LOT LIGHTING NORTH	1500				20	2	17	188	28	18	1.	20	1000				WATER WALL FLOODLIGHTS
WAKING TO LIGHTING MOKTH	1500				20	1 2	19	- 5	00.6	20	1	20	1000				WATER WALL FLOODLIGHTS
PARKING LOT LIGHTING SOUTH	750			T.	20*	. 2	21	90	15	22	1	20	1000				WATER WALL FLOODLIGHTS
ARKING LUT LIGHTING SOUTH	750				20"	1.2	23	100	21	24	1	20		1			SPARE
PARKING LOT LIGHTING SOUTH	750			1	20*	2	25		98.3	26	1	20					SPARE
PARKING LUT EIGH IING SUUTH	750				20"	1 4	27	822	ES.	28	1	20					SPARE
SPARE					20	1	29	20	an "	30	1	20		1		-	SPARE
SPARE					20	1	31	-		32	1	20					SPARE
SPARE					20	1	33	898		34	1	20		1			SPARE
SPARE					20	1	35	188	39	36	1 1	20					SPARE
SPARE	·			1	20	1	37		30.00	38	1	20				-	SPARE
SPARE					20	1	39	588	- 13	40	1	20				1	SPARE
CONTACTORS C1 AND C2	100			1	20	1	41	TO	30	42	1	20					SPARE
IOTES: ALL CIRCUIT BREAKERS'S ISTERISK (*) BEHIND THE AMPER													SE 2B CO	INTRACT	THE LOA	O IDENTI	FIED AT BREAKERS WITH AN

PANELBOARD -	E				VC	LTAGE	208	/ 1	20		AN	PEUS	200	SP	CIAL FE	ATURES -	***************************************
MOUNTING-		E	•			PHASE					AN	PMCB		-			
ALC, RATING						WIRE	4	-			AN	PMLO	200	-			
LOAD DESCRIPTION	T	LOAD	(VA)		BRE	AKER	CIRCUIT	3 P		CLUT	BRE	UKER!		LOAD	(VA)		LOAD DESCRIPTION
EONO DESCRIPTION	LIGHT	RECEP.	HVAC	MISC.	AMP	POLES	01100011	AB	C		POLES	AMP	LIGHT	RECEP.	HVAC	MSC.	EOAD DESCRIPTION
				9384			1	300	9395	2	1	20		1		1200	FIRE ALARM CONTROL PANE
BLEVATOR		-		9384	100	3	3	200	330	4	1	20	1026				GROUND FLOOR LIGHTING - N
				9384	1		- 5	14.4		6	1	20	1260				STAIR TOWER LIGHTIN
ELEVATOR REMOTE MONITOR				1800	15	1	7	100	100	8	- 1	20	1266				STAIR TOWER LIGHTIN
ELEVATOR CAB LIGHTING	500				15	1	9		200	10	1	20		200			INTERCOMPOWER SUPPL
ELEVATOR PIT & RECEPTACLE	250				20	1	11			12	1	20				750	AV APPLIANCE POWER SUPPL
ELEVATOR SUMP PUMP		200		1	20	1	13	170	100	14	1 .	20					SPARE
ELEVATOR MACHINE ROOM	200	200			20	1	15	122		16	1	20	1000				GROUND FLOOR LIGHTING - S
GEN, BATT, CHARGER	-			1000	20	1	17	teny de o		18	1	20					SPARE -
GEN. JACKET HEATER				1000	20	1	19	100	1578	20	1	20					SPARE
SPARE					20	1	21	461	120	22	. 1 .	20	T				SPARE
SPARE	T				20	1	23	100		24	1	20					SPARE
SPARE					20	1	25	2.5	466	26	1 .	20					SPARE
SPARE				T	20	1	27	100		28	1 :	20					SPARE
SPARE					20	1	29	11.00		30	1	20					SP#RE
SPARE		T	l		20	1	31	130		32	1	20					SPARE
SPARE				1	. 20	1	33	1		34	1	20					SPARE
SPARE					. 20	. 1	35			36	1 1	20					SPARE
SPARE			1		20	1	37.	- 89		38	1	20					SPARE
SPARE	T				20	1	39	233		40	1	20	I				SPARE
SPARE					20	1	41	Section	9	42	1	20		-			SPARE
NOTES:																	
i																	
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	TURES -	CIAL FEA	SPE	200	P BUS	AM		120	-7	208	LTAGE	VO				LRPS	PANELBOARD -
					PMCB	AM				3	PHASE				Ē	SURFAC	MOUNTING -
				200	PMLO	AM			_	4	WRE					22.000	A.I.C. RATING
LOAD DESCRIPTION		(VA)	LOAD		KER	BREA	CIRCUIT	PH.		CIRCUIT	AKER	BRE		(VA)	LOAD		LOAD DESCRIPTION
LONG DESCRIPTION	MISC.	HVAC	RECEP.	LIGHT	- AMP	POLES	CIRCOII	ВС	Α	CHECUIT	POLES	AMP	MISC.	HVAC	RECEP.	LIGHT	LOAD DESCRIPTION
RECEPTAC			1000		20	1	2	3 ()		- 1	1	20				770	IGHTING
EF-2 AND DAME		900			20	1	4	638	100	3	T	ļ—		2000			
SP/					20	1	6	33		5	3	25		2000			ABINET UNIT HEATER CUH-2
		1100					8		L	7				2000 .			
UNIT HEATER U		1100			20	3	10	. 186	200	9				2000			
		1100					12		260	11	3	25		2000			ABINET UNIT HEATER CUH-1
HAND DR'			2300		20	1	- 14		L	13	<u></u>			2000			
HAND DR'			2300		20	1	16	22	283	15			3276				
MOTORIZED DAMPE		400			20	1	18		192	17	3	40*	3276				CUNTAIN PUMPS FP-1 & FP-2
RECEPTAC			1400		20	1	20		_	19			3276			1	
HAND DR'			2300		20	1	22	22	1993	21	1.	20'	1000				NOTORIZED DAMPER
HAND DR'			2300		20	1	24	ш_	100	23	1	20*			800		ECEPTACLES
		3333					26	100	_	25	. 1	20	L			<u></u>	PARE
UNIT HEATER U		3333			40*	3	28	25	100	27	1	20					PARE
		3333					30	a	. 63	29	1	20					PARE
RECEPTABLE - FOOD WARM			1000		20	1.	32	444	1_	31	1	20"			600	<u> </u>	LATFORM RECEPTACLES
RECEPTACLE AT POD			200		20	1	34	- 88	300	33	_1_	20**				360	IFE SAPETY LIGHTING
	3000				20	1	36	8	6803	35	1	20**	1000				IRE ALARM CONTROL PANEL
WATER HEATER W	3000				20	1	38			37	1	20**	1000			T	V APPLIANCE PWR. SUPPLY
	3000				20	1	40	32		39	1	20					PARE
SPARE					20	1	42	S	133	41	1	20*	500				OUNTAIN CONTROL PANEL
SPARE				-	20	1	44		Ι.	43	1	20				T	SPARE
SPARE					20	1	46	_ 33	123	45	1	20				1	SPARE
SPARE					20	1	48	94	334	47	1	20					SPARE
SPARE					20	1	50	. 1	Ш.	49	1	20					SPARE
SPARE					. 20	1	52	373	133	51	1	20			:		SPARE
SPARE					20	1	54			63	1	20	(T	SPARE
SPARE					20	1	56		T	55	1	20					SPARE
SPARE					20	1	58	- 90	50	57	1	20					SPARE
SPARE					20	1	60			59	1	20					SPARE
SPARE					20	1	62	de		61	1	20				T	SPARE
SPARE					20	1	64	(30)	985	63	1	20	-				SPARE
SPARE					20	1	66	10	P)S	65	, ,	20				T	SPARE
SPARE					20	1	89	(C) (П	67	1	20					SPARE
SPARÉ					20	1	70	200		69	- 1	20				-	SPARE
SPARE					20	1	72	22	100	71	1	20				T	SPARE
SPARE					20	1	74		Т	73	- 1	20				T	SPARE
SPARE					20	1	76		東 夏	75	1	20				T	SPARE
SPARE					20	1	78	2		77	1	20					SPARE
SPARÉ					20	1	80	10 (80	T	79	1	20				1	SPARE
SPARE					20	1	82	339	333	81	1	20				T	SPARE
SPARE					20	1	84	628	100	83	1	20					SPARE

PANELBOARD -	LRPN				VC	LTAGE	208	/ 1	20		AM	P BUS	200	SP	ECIAL FE	ATURES -	- "
MOUNTING -	SURFAC	É				PHASE	3			-	AM	PMCB		-			
A.I.C. RATING -	22,000					WIRE	4	-			AM	IP MLO	200	-			
LOAD DESCRIPTION			(VA)			AKER	GROUT	3 P		CIRCUIT	BRE		L	LOA			LOAD DESCRIPTION
LOND DECOME TION	LIGHT	RECEP.	HVAC	MISC.	AMP	POLES		AB	C		POLES	AMP	LIGHT	RECEP.	HVAC	MISC.	
EF-1 AND DAMPER			500		20	1	1	18		2	1	20	500				LIGHTIN
		·	1100				3	200	100	4	1	20		800			RECEPTACLE
UNIT HEATER UH-4			1100		20	3	5	25.0		6	1	20	L	800			RECEPTACLE
			1100	1	1	l	7	- 28		- 8	1	20				1500	VENDING MACHIN
			1100			1	9	8.97	142	10	1	20				1500	VENDING MACHIN
UNIT HEATER UH-3			1100		20	3	11	E8 89	3	12	1	.50				1500	VENDING MACHIN
			1100		1		13	1 13		14	1	20				1500	VENDING MACHIN
CONDENSING UNIT CU-2	-		915		20	2	15	953	0.00	16	2	20			1248		CONDENSING UNIT CU-
			915			-		20		18	1 -				1248		1
RECEPTACLES	1	1200			20	1	19	- 88	100	20					1272		
PHONE RECEPTACLE		400			20	1	21	100	180	22	3	20			1272		AR HANDLING UNIT ANU-
RECEPTACLE - FOOD WARMING		1000			20	1	23	300	9	24	1				1272		7
AIR CONDITIONER AC-1						2	25	1 100		26					5666		
MIR CONDITIONER MC-1					1	1 4		2670	200	28	3	60			5666		AR HANDLING UNIT AHU-1 (HEAT
WH-2			3000		30	1	29	3003	3	30	1 1				5666		1
SUMP PUMP			200	-	20	1	31	12	100	32	1	20					SPARE
SPARE		T			20	1	33	156	100	34	1	20					SPARE
SPARE					20	1	35	NA 63	1	36	1	20				T	SPARE
SPARE					20	1	37	1 33		38	1	20		1			SPARE
SPARE					20	- 4	39	929		40	1	20				1.0	SPARE
SPARE		1 2			20	1	41	100	7	42	1	20				-	SPARE
NOTES:														:			

紀	SECTION	COUNTY	TOTAL	SHEET NO.
	03-00026-00-PK 06-00026-01-MS		53	53

FEDERAL AID PROJECT

	EQUIPMENT DATA SCHEDULE																					
UNE	MARK	EQUIPMENT	EQUIPMENT	FURN.			OR OR ENT DATA				ONNECT T EQUIPI				STARTE	R	-		REMOT CONTRO			(5) ¹
NO.	\ominus	DESCRIPTION	LOCATION	BY (DIV.)	① HP/KW	VOLTS/ PHASE	FLA	INST. BY	CONN. BY	② TYPE	FURN. BY	INST. BY	CONN. BY	③ TYPE	FURN. BY	INST. BY	CONN. BY	4) TYPE	FURN. BY	INST. BY	CONN. BY	REMARKS
1	CUH-1	CABINET UNIT HEATER	WOMEN'S RESTROOM	15	6 KW	208/3	17.6	15	16	CB	15	FAC	16	1	~	-		-	-			-
2	CUH-2	CABINET UNIT HEATER	MEN'S RESTROOM	15	6 KW	208/3	17.6	15	16.	CB	. 15	FAC	16	-	-	-	-	-	-	-	- 1	-]
3	UH-1	UNIT HEATER	PUMP/MECH-ROOM	15	10 KW	208/3	20.8	15	16	NF	15	FAC	16	-	-	_		_	-	_	-	_
4	UH-2	UNIT HEATER	JANITOR	15	3.3 KW	208/3	6.9	15	16	NF	15	FAC	16	-	-	-	-	-	-		-	_
5	UH-3	UNIT HEATER	ELEV MACHINE ROOM	15	3.3 KW	208/3	6.9	15	16	, NF	15	FAC	16									
6	UH-4	UNIT HEATER	ELECTRICAL ROOM	15	3.3 KW	208/3	6.9	15	16	NF	15	FAC	16		-	-	-	•	-		~ '	-
7																						
8	EF~1	EXHAUST FAN	ELECTRICAL ROOM	15	1/6 HP	120/1	-	15	16	NF	15	FAC	16	-	-	-	-		-	-		-
9	EF-2	EXHAUST FAN	TOILET ROOMS	15	1/4 HP	120/1	-	15	16	NF .	15	FAC	16	***	~		-	TC	16	16	16	-
10			-																			
11	FCU-1	AIR HANDLING UNIT	CONCESSIONS	15	3 HP .	208/3	-	15	16	-	-	-	-	PWCP	15	FAC	16		-	-	-	
12	FCU-1	AIR HANDLING UNIT — HEAT	CONCESSIONS	15	17 KW	208/3		15	16	NF	16	16	16	-	-		-	-	-	-	-	
13																						
14	AC-1	AIR CONDITIONER	ELEV MACHINE ROOM	15	-	208/1	.5 MCA	15	16	NF	16	16	16	-	-	-	-	-				
15					<u> </u>																	
16	CU-1	CONDENSING UNIT	AHU-1	15		208/3	15 MCA	15	16	NF,WP	16	16	16	-	-	-	-	-	-	-	-	
17	CU-2	CONDENSING UNIT	AC-1	15	-	208/1	11 MCA	15	16	NF,WP	16	16	16	***			~	. =	-		_	
18,										- '										-	-	
19		COUNTY DIND			7 (10	209/7		15	46	NE.				-		-	-	-	-	-		
20	FP-1	FOUNTAIN PUMP		15	3 HP	208/3	-	15	16	NF.	16	16	16									
21	FP-2	FOUNTAIN PUMP	_	15	5 HP	208/3	-	15	16	NF	16	16	: 16									
23	WH-1	WATER HEATER		15	1.5 KW	120/1	_	15	16	S	16	16	16	. –	_		_		_		_	
24	WH-2			15	3 KW	120/1	_	15	16	_	-	-	-		_	_	_	_	_	_	_	-
25	SP-1	WATER HEATER SUMP PUMP		15	1/2 HP	120/1	_	15	16	_	_		-	PWCP	15	16	16		_		_	
26	31 - 1	SOME TOWN		15	./2	120/1		10						1 1101	- 10							
27	~~~																					
28			<u> </u>					-						-							-	
29																						
30														-								
31		 	-									L										
32														<u> </u>								
33																						
- 34																						
35																						
36																						
37																						
38																						•
. 39																						
40																						
																		7				

1 HORSEPOWER (HP) IS SHOWN UNLESS KILLOWATTS (KW) ARE CALLED OUT.

2) DISCONNECT TYPES:

CB = CIRCUIT BREAKER
F = FUSED
NF = NON FUSED
S = SWITCH (TOGGLE)
WP = WEATHERPROOF
FAC = FACTORY

3 STARTER TYPES:

COMB = COMBINATION MAGNETIC FVNR
WITH FUSIBLE DISCONNECT SWITCH
FVNR = FULL VOLTAGE NON-REVERSING
MAN = MANUAL STARTER
PWCP = PRE-WIRED CONTROL PANEL
WITH INTEGRAL FVNR MAGNETIC
STARTER AND DISCONNECT SWITCH
SOS = STAR DELTA STARTER
VSD = VARMBLE SPEED DRIVE
2SZW = 2 SPEED, 2 WINDING MAGNETIC
STARTER


4 REMOTE CONTROL: BAS = BUILDING AUTOMATION SYSTEM
FAI = FIRE ALARM INTERLOCK
FST = FIRESTAT
INT = INTERLOCK WITH OTHER
EQUIPMENT
RAD = REMOTE ALARM DEVICE
RPB = REMOTE START—STOP PUSH
BUITON
SSC = START—STOP CONTACT
TC = TIME CLOCK
TS = THERMOSTAT 5 REMARKS:

1. EMERGENCY POWER.
2. 2 SPEED, 2 WINDING MOTOR.
3. STAND—BY UNIT.
4. VARIABLE SPEED DRIVE WITH PRE-WIRED STAFTER AND INTEGRAL DISCONNECT SWITCH.

211 N. Broadway Suite 1900 St. Louis, MO 63102 (314) 241-8188 X (314) 241-0125

LEWIS AND CLARK MEMORIAL TOWER VILLAGE OF HARTFORD, ILLINOIS 62049

SHET TILE.
EQUIPMENT DATA
SCHEDULE

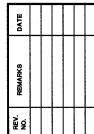

KENNEDY PROJECT NO KAI# 10-02048

ISSUE DATE APRIL 11, 2008

SHEET NO

E7-02