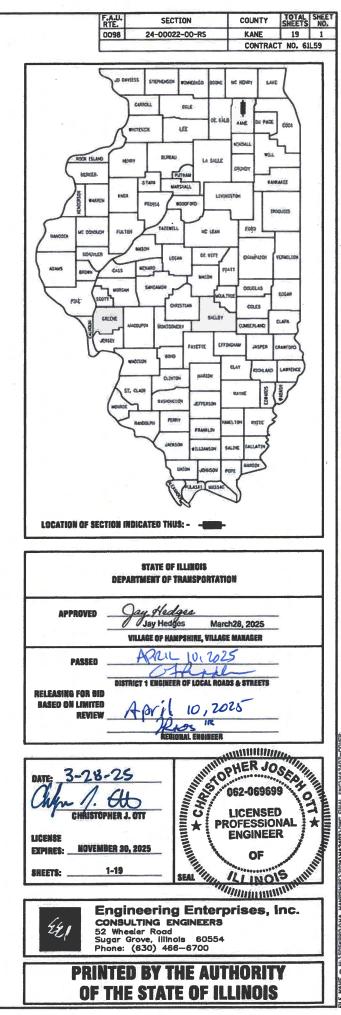


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GENERAL NOTES

SPECIFICATIONS, STANDARDS, AND SPECIAL PROVISIONS

ALL CONSTRUCTION SHALL BE DONE IN ACCORDANCE WITH THE 'STANDARD SPECIFICATIONS FOR ROAD AND BRIDGE CONSTRUCTION," ADOPTED JANUARY 1, 2022 (HEREINAFTER REFERRED TO AS THE STANDARD SPECIFICATIONS), THE "SUPPLEMENTAL SPECIFICATIONS AND RECURRING SPECIAL PROVISIONS," ADOPTED JANUARY 1, 2025, THE LATEST EDITION OF THE "ILLINOIS MANUAL ON UNIFORM TRAFFIC CONTROL DEVICES FOR STREETS AND HIGHWAYS", THE "STANDARD SPECIFICATIONS FOR WATER & SEWER MAIN CONSTRUCTION IN ILLINOIS", SEVENTH EDITION, THE CODES AND ORDINANCES OF THE VILLAGE OF HAMPSHIRE, ILLINOIS, THE DETAILS IN THE PLANS AND THE SPECIAL PROVISIONS INCLUDED IN THE CONTRACT DOCUMENTS.

ALL TRAFFIC CONTROL AND OTHER ADVISORY SIGNS NEEDED FOR CONSTRUCTION ARE TO BE FURNISHED BY THE CONTRACTOR IN ACCORDANCE WITH ARTICLE 107.14 OF THE STANDARD SPECIFICATIONS

THE CONTRACTOR SHALL AT ALL TIMES PROVIDE PROTECTION FOR TRAFFIC AS CALLED FOR IN THE APPLICATION OF TRAFFIC CONTROL DEVICES, THE STANDARD SPECIFICATIONS, THE SPECIAL PROVISIONS AND THE PLANS

UTILITIES

THE CONTRACTOR SHALL COOPERATE WITH THE OWNER IF ANY UTILITY IMPROVEMENTS ARE REQUIRED WITHIN THE DURATION OF THE CONTRACT.

THE CONTRACTOR SHALL BE RESPONSIBLE FOR CONTACTING THE OWNERS OF ALL UTILITIES PRIOR TO CONSTRUCTION TO DETERMINE THE LOCATION OF ALL EXISTING AND PROPOSED UTILITY EQUIPMENT. THE CONTRACTOR SHALL COOPERATE WITH ALL UTILITY OWNERS AS PROVIDED FOR IN THE STANDARD SPECIFICATIONS IF UTILITY RELOCATION, ADJUSTMENT, OR PROTECTION IS NECESSARY.

THE LOCATION OF EXISTING DRAINAGE STRUCTURES, STORM SEWERS, WATER MAINS, SANITARY SEWERS, FIELD TILES AND ANY OTHER PUBLIC OR PRIVATE UTILITIES AS SHOWN ON THE PLANS IS APPROXIMATE AND NOT NECESSARY COMPLETE: THEIR EXACT LOCATION IS TO BE DETERMINED IN THE FIELD BY THE CONTRACTOR.

BEFORE STARTING ANY EXCAVATION, THE CONTRACTOR SHALL CALL "JULIE" (JOINT UTILITY LOCATION INFORMATION FOR EXCAVATION) AT (800) 892-0123 FOR FIELD LOCATIONS OF BURIED UTILITIES (48 HOURS NOTIFICATION IS REQUIRED)

IF EXISTING UTILITY LINES OF ANY NATURE ARE ENCOUNTERED WHICH CONFLICT IN LOCATION WITH NEW CONSTRUCTION, THE CONTRACTOR SHALL NOTIFY THE ENGINEER SO THAT THE CONFLICT MAY BE RESOLVED.

UNDER NOT CIRCUMSTANCES SHALL THE CONTRACTOR OPERATE ANY VALVES OR HYDRANTS.

STAKING

ALL OFFSET LOCATIONS GIVEN ON THE DETAILED PLANS ARE FROM THE CENTERLINE AS SHOWN ON THE PLANS.

MISCELLANEOUS

THE THICKNESS OF ASPHALT MIXTURES SHOWN IN THE PLANS ARE NOMINAL. DEVIATIONS MAY OCCUR DUE TO IRREGULARITIES IN THE SURFACES OR BASES ON WHICH THE ASPHALT MIXTURES ARE TO BE PLACED.

IT IS THE CONTRACTOR'S RESPONSIBILITY TO ASCERTAIN EXISTING FIELD CONDITIONS BEFORE BIDDING ON THIS CONTRACT.

WHERE NEW WORK MEETS EXISTING FEATURES TO REMAIN, THE CONTRACTOR SHALL FIELD CHECK ALL DIMENSIONS AND ELEVATIONS BEFORE PROCEEDING WITH CONSTRUCTION. IMMEDIATELY NOTIFY THE ENGINEER OF ANY DISCREPANCIES.

THE CONTRACTOR WILL BE REQUIRED TO COMPLY WITH ALL STATE REGULATIONS REGARDING AIR. WATER AND NOISE POLLUTION. THE CONTRACTOR IS PROHIBITED FROM BURNING ANY MATERIAL WITHIN OR ADJACENT TO THE IMPROVEMENT.

THE ENGINEER IS NOT RESPONSIBLE FOR THE CONSTRUCTION MEANS, METHODS, TECHNIQUES, SEQUENCES OR PROCEDURES, TIME OF PERFORMANCE, PROGRAMS OR FOR ANY SAFETY PRECAUTIONS USED BY THE CONTRACTOR. THE CONTRACTOR IS SOLELY RESPONSIBLE FOR EXECUTION OF THEIR WORK IN ACCORDANCE WITH THE CONTRACT DOCUMENTS AND SPECIFICATIONS.

FOR STABILIZATION, ALL TYPE III BARRICADES WILL REQUIRE A MINIMUM OF FOUR SAND BAGS PER BARRICADE

THE CONTRACTOR SHALL MAINTAIN EXISTING SIDE STREET AND DRIVEWAY ACCESS TO EACH ABUTTING PROPERTY AT ALL TIMES DURING CONSTRUCTION OF THE PROJECT UNLESS OTHERWISE NOTED ON THE PLANS OR DIRECTED BY THE ENGINEER.

THE CONTRACTOR SHALL DISPOSE OF AND REMOVE FROM THE SITE EACH DAY ALL CURB, GUTTER, AND PAVEMENT.

THE STORAGE OF EQUIPMENT AND/OR MATERIALS WITHIN THE RIGHT-OF-WAY OF ANY STREET SHALL REQUIRE PRIOR APPROVAL OF THE ENGINEER.

COMBINATION CONCRETE CURB AND GUTTER REMOVAL AND REPLACEMENT AS SHOWN ON THE PLANS IS FOR INFORMATIONAL PURPOSES ONLY, ACTUAL LOCATIONS AND QUANTITIES ARE TO BE DETERMINED AND MARKED BY THE ENGINEER PRIOR TO CONSTRUCTION.

ALL EXISTING SIGNS (INCLUDING THOSE LOCATED ON UTILITY/LIGHT POLES) THAT DO NOT CONFLICT WITH THE IMPROVEMENTS SHALL REMAIN IN PLACE UNLESS DIRECTED BY THE ENGINEER.

CONTRACTOR SHALL TAKE PRECAUTION BY PRESERVING EXISTING TREES WITHIN THE RIGHT OF WAY. IF ANY DAMAGE OCCURS, TREES SHALL BE REPLACED IN KIND PER ARTICLE 201.07 REPAIR OR REPLACEMENT OF EXISTING PLANT MATERIAL REQUIREMENT STATED HEREIN.

ALL NITROGEN. PHOSPHOROUS AND POTASSIUM FERTILIZER NUTRIENTS HAVE BEEN INTENTIONALLY OMITTED FROM THE CONTRACT ON THE SODDING APPLICATION.

COMMITMENTS

THE PAVEMENT ELEVATION ADJACENT TO THE FLOODPLAIN WILL NOT CHANGE. FLOODPLAIN IS FROM STA 100+64 TO STA 115+03.

CONSTRUCTION WILL NOT TAKE PLACE UNTIL AFTER COON CREEK DAYS HAVE BEEN COMPLETED. COON CREEK DAYS ARE FROM AUGUST 7TH-10TH.

IDOT HIGHWAY STANDARDS

HEET. NO.	IDC	DT DISTRICT ONE
10.	(BD-08)	FRAMES AND LID
11.	(BD-22)	PAVEMENT PATCH PAVEMENT
12.	(BD-24)	CURB OR CURB A
13.	(BD-32)	BUTT JOINT AND
14.	(TC-10)	TRAFFIC CONTROL SIDE ROADS, INTE DRIVEWAYS
15.	(TC-11)	RAISED REFLECTIN (SNOW-PLOW RES
16.	(TC-13)	TYPICAL PAVEMEN
17.	(TC-14)	TRAFFIC CONTROL TURN BAYS (TO
18.	(TC-16)	SHORT TERM PAV AND SYMBOLS

000001-08	STANDARD SYMBOLS, ABBREVIATIONS, AND PATTERNS
280001-07	TEMPORARY EROSION CONTROL SYSTEMS
442201-03	CLASS C AND D PATCHES
604001-05	FRAME AND LIDS TYPE 1
604006-05	FRAME AND GRATE TYPE 3
606001-08	CONCRETE CURB TYPE B AND COMBINATION CONCRETE CURB AND GUTTER
701006-05	OFF-RD OPERATIONS, 2L, 2W, 15'(4.5M) TO 24" (600MM) FROM PAVEMENT EDGE
701011-04	OFF-RD MOVING OPERATIONS, 2L, 2W, DAY ONLY
701301-04	LANE CLOSURE, 2L, 2W, SHORT TIME OPERATIONS

701311-03 LANE CLOSURE, 2L, 2W, MOVING OPERATIONS - DAY ONLY

- URBAN LANE CLOSURE 2L, 2W, UNDIVIDED 701501-06
- 701502-09 URBAN LANE CLOSURE 2L, 2W, WITH BIDIRECTIONAL LEFT TURN I ANF
- 701901-10 TRAFFIC CONTROL DEVICES
- 780001-05 TYPICAL PAVEMENT MARKINGS

CONSULTING ENGINEERS	DESIGNED - DRAWN -	REVISED – REVISED –	STATE OF ILLINOIS	G		NOTES	,	HWAY
52 Wheeler Road Sugar Grove, Illinois 60554	CHECKED -	REVISED -	DEPARTMENT OF TRANSPORTATION		A	ND INI	DEX UI	2 2HF
	DATE -	REVISED -		SCALE: N.T.S.	SHEET 1	OF	1 SHE	ETS S

SHEET NO.	SHEET DESCRIPTION
1.	COVER SHEET

TYPICAL SECTIONS

RESURFACING PLAN

2.

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19.

10.-19.

INDEX OF SHEETS

GENERAL NOTES, HIGHWAY STANDARDS AND INDEX OF SHEETS SUMMARY OF QUANTITIES

LEGEND

HOT-MIX ASPHALT SURFACE REMOVAL, 3.75" AND RESURFACING

HOT-MIX ASPHALT SURFACE REMOVAL, BUTT-JOINT

COMB CONC C&G REMOVAL AND REPLACEMENT

IDOT DISTRICT 1 DETAILS

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AND GUTTER REMOVAL AND

HMA TAPER DETAILS AND PROTECTION FOR ERSECTIONS, AND

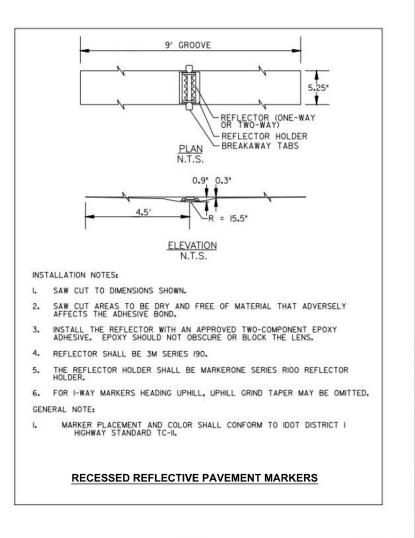
IVE PAVEMENT MARKERS SISTANT)

INT MARKINGS

AND PROTECTION AT REMAIN OPEN TO TRAFFIC)

VEMENT MARKING LETTERS

(TC-22) ARTERIAL ROAD INFORMATION SIGN



NAY STANDARDS SHEETS		F.A.U. RTE.	F.A.U. SECTION RTE. 0098 24-00022-00-RS		TOTAL SHEETS	SHEET NO.	
		0098			19	2	
				7.55 Fr	CONTRACT	NO. 61L	59
TS	STA.	TO STA.		ILLINOIS FED. A	ID PROJECT		

CODE NUMBER	ITEM DESCRIPTION	UNIT	ROADWAY 75% FEDERAL 25% LOCAL 0005
			0000
21101615	TOPSOIL FURNISH AND PLACE, 4*	SQ YD	70
25200110	SODDING, SALT TOLERANT	SQ YD	70
25200200	SUPPLEMENTAL WATERING	UNIT	6
		-	
28000250	TEMPORARY EROSION CONTROL SEEDING	POUND	20
28000510	INLET FILTERS	EACH	20
40600290	BITUMINOUS MATERIALS (TACK COAT)	POUND	5,065
40600370	LONGITUDINAL JOINT SEALANT	FOOT	1,864
40600400	MIXTURE FOR CRACKS, JOINTS, AND FLANGEWAYS	TON	5
40600982	HOT-MIX ASPHALT SURFACE REMOVAL - BUTT JOINT	SQ YD	75
40603080	HOT-MIX ASPHALT BINDER COURSE, IL-19.0, N50	TON	950
40604060	HOT-MIX ASPHALT SURFACE COURSE, IL-9.5, MIX "D", N50	TON	635
44000164	HOT-MIX ASPHALT SURFACE REMOVAL, 3 3/4"	SQ YD	7,500
44000500	COMBINATION CURB AND GUTTER REMOVAL	FOOT	300
60255500	MANHOLES TO BE ADJUSTED	EACH	1

* INDICATES SPECIALTY ITEM

Engineering Enterprises, Inc.		DESIGNED -	REVISED -					F.A.U.	SECTION	COUNTY	SHEETS	SHEET I
44	CONSULTING ENGNEERS 52 Wheeler Road Sugar Grave, Illinois 60554	DRAWN -	REVISED -	STATE OF ILLINOIS DEPARTMENT OF TRANSPORTATION	SUMMARY OF QUANTITIES			0098	24-00022-00-RS	KANE	19	3
-21		CHECKED -	REVISED -					<u> </u>		CONTRACT N	NO. 6115	59
	630.466.6700 / www.eeiweb.com	DATE -	REVISED -		SCALE: N.T.S.	SHEET 1 OF 3 SHEETS STA.	TO STA.		ILLINDIS FED. AI	ID PROJECT		

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			ROADWAY
CODE NUMBER	ITEM DESCRIPTION	UNIT	75% FEDERAL 25% LOCAL 0005
60260100	INLETS TO BE ADJUSTED	EACH	20
60404300	FRAMES AND GRATES, TYPE 3	EACH	2
60406100	FRAMES AND LIDS, TYPE 1, CLOSED LID	EACH	1
60604400	COMBINATION CURB AND GUTTER, TYPE B-6.18	FOOT	300
67100100	MOBILIZATION	L SUM	1
70102620	TRAFFIC CONTROL AND PROTECTION, STANDARD 701501	L SUM	1
70102622	TRAFFIC CONTROL AND PROTECTION, STANDARD 701502	L SUM	1
70300100	SHORT TERM PAVEMENT MARKING	FOOT	1,800
70300150	SHORT TERM PAVEMENT MARKING REMOVAL	SQ FT	600
78000100	THERMOPLASTIC PAVEMENT MARKING - LETTERS AND SYMBOLS	SQ FT	182
78000200	THERMOPLASTIC PAVEMENT MARKING - LINE 4"	FOOT	5,656
78000400	THERMOPLASTIC PAVEMENT MARKING - LINE 6"	FOOT	426
70000400			
78000600	THERMOPLASTIC PAVEMENT MARKING - LINE 12"	FOOT	337
	THERMOPLASTIC PAVEMENT MARKING - LINE 24"	FOOT	24
78000650		FOUT	24

* INDICATES SPECIALTY ITEM

	Engineering Enterprises, Inc.	DESIGNED -	REVISED -					F.A.U.	SECTION	COUNTY	TOTAL	HEET
440	CONSULTING ENGINEERS	DRAWN -	REVISED -	STATE OF ILLINOIS DEPARTMENT OF TRANSPORTATION	SUMMARY OF QUANTITIES			0098	24-00022-00-RS	KANE	19	4
52 When Sugar G	Szymeeter Road Sugar Grove, Illinois 60554	CHECKED -	REVISED -						CONTRACT		RACT NO. 611.59	
· · ·	630.466.6700 / www.eeiweb.com	DATE -	REVISED ~		SCALE: N.T.S.	SHEET 2 OF 3 SHEETS STA.	TO STA.	i	ILLINOIS FED. /	ND PROJECT		0

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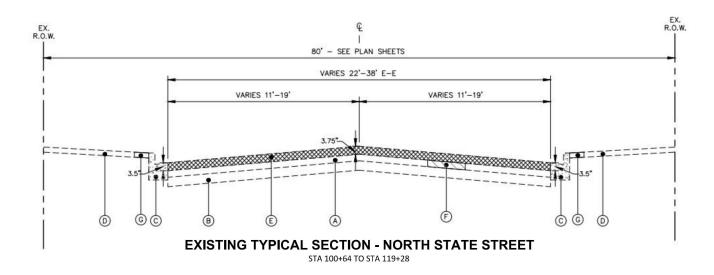
	CODE NUMBER	ITEM DESCRIPTION	UNIT	ROADWAY 75% FEDERAL 25% LOCAL 0005
	78300200	RAISED REFLECTIVE PAVEMENT MARKER REMOVAL	EACH	100
L	X4421002	PARTIAL DEPTH PATCHING (SPECIAL)	SQ YD	528
	X7200061	TEMPORARY INFORMATION SIGNING	SQ FT	77.1
*	X7810300	RECESSED REFLECTIVE PAVEMENT MARKER	EACH	100


* INDICATES SPECIALTY ITEM

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HOT-MIX ASPHALT MIXTURE REQUIREMENTS

OPERATION	MIXTURE TYPE	AIR VOIDS @ NDES	QMP
PAVEMENT RESURFACING	HOT-MIX ASPHALT SURFACE COURSE, IL-9.5, MIX "D", N50, 1.5" HOT-MIX ASPHALT BINDER COURSE, IL-19.0, N50, 2.25"	4% @ 50 GYR. 4% @ 50 GYR.	LR1030-2 LR1030-2
PARTIAL DEPTH PATCHING (SPECIAL)	HOT-MIX ASPHALT BINDER COURSE, IL-19.0, N70, 6"	4% @ 70 GYR.	LR1030-2
	QMP DESIGNATION: QUALITY CONTROL/QUALITY ASSURANCE (QC/QA) 1030-2.	PER LR	
	THE UNIT WEIGHT TO CALCULATE ALL HMA SURFACE MIXTURE QUANT 112 LBS/SQ YD/IN	ITIES IS	
	THE "AC TYPE" FOR POLYMERIZED HMA MIXES SHALL BE "SBS/SBR I AND FOR NON-POLYMERIZED HMA THE "AC TYPE" SHALL BE "PG 64 UNLESS MODIFIED BY RECLAIMED MATERIALS SPECIFICATIONS.	PG 76-22" -22".	

4

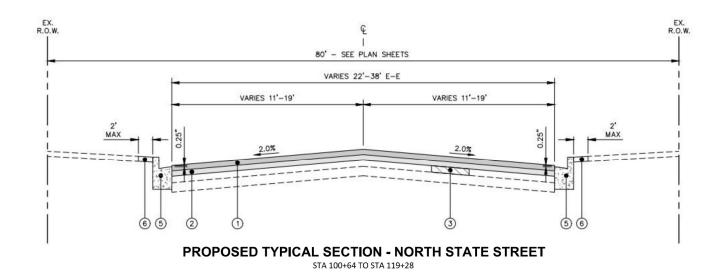EXISTING LEGEND

A EXISTING HOT-MIX ASPHALT PAVEMENT (15")

(B) EXISTING AGGREGATE BASE COURSE (4" - 7") C EXISTING COMBINATION CONCRETE CURB & GUTTER. B6.18

PARTIAL DEPTH PATCHING (SPECIAL) - REMOVAL (LOCATIONS TO BE DETERMINED BY ENGINEER)

E HOT-MIX ASPHALT SURFACE REMOVAL, 3.75"

D EXISTING PARKWAY

G EXISTING SOD-REMOVAL

-	Engineering Enterprises, Inc.	DESIGNED -	REVISED -							F.A.U.	SECTION	COUNTY	SHEETS	SHEET
CONSULTING ENGINEERS 52 Wheeler Road Sugar Grove, Illinois 60554 630.466.6700 / www.eeiweb.com	CONSULTING ENGINEERS	DRAWN -	REVISED -	STATE OF ILLINOIS			TYPIC/	AL SECTIONS		0098	24-00022-00-RS	KANE	19	6
	52 Wheeler Road Sugar Grove, Illinois 60554	CHECKED -	REVISED -	DEPARTMENT OF TRANSPORTATION								CONTRACT	NO. 61	L59
		DATE -	REVISED -		SCALE: N.T.S.	SHEET 1	OF 1	1 SHEETS STA. N/A	TO STA. N/A		ILLINOIS FED. A	ID PROJECT		

PROPOSED LEGEND


1	HOT-MIX ASPHALT SURFACE COURSE, IL-9.5, MIX "D", N50, 1.5"
2	HOT-MIX ASPHALT BINDER COURSE, IL-19.0, N50, 2.25"
3	PARTIAL DEPTH PATCHING (SPECIAL), 6" (LOCATIONS TO BE DETERMINED BY ENGINEER)
4	COMBINATION CONCRETE CURB AND GUTTER REMOVAL AND REPLACEMENT (SPOT REMOVAL AND REPLACEMENT AS DIRECTED BY THE ENGINEER)


5 TOPSOIL AND SODDING, SALT TOLERANT


NOTES: THE PATCHING QUANTITIES HAVE BEEN ESTIMATED BASED ON FIELD OBSERVATIONS DURING DESIGN, ACTUAL QUANTITIES TO BE DETERMINED DURING CONSTRUCTION.

NO PROPOSED WORK WILL TAKE PLACE OUTSIDE OF THE R.O.W.

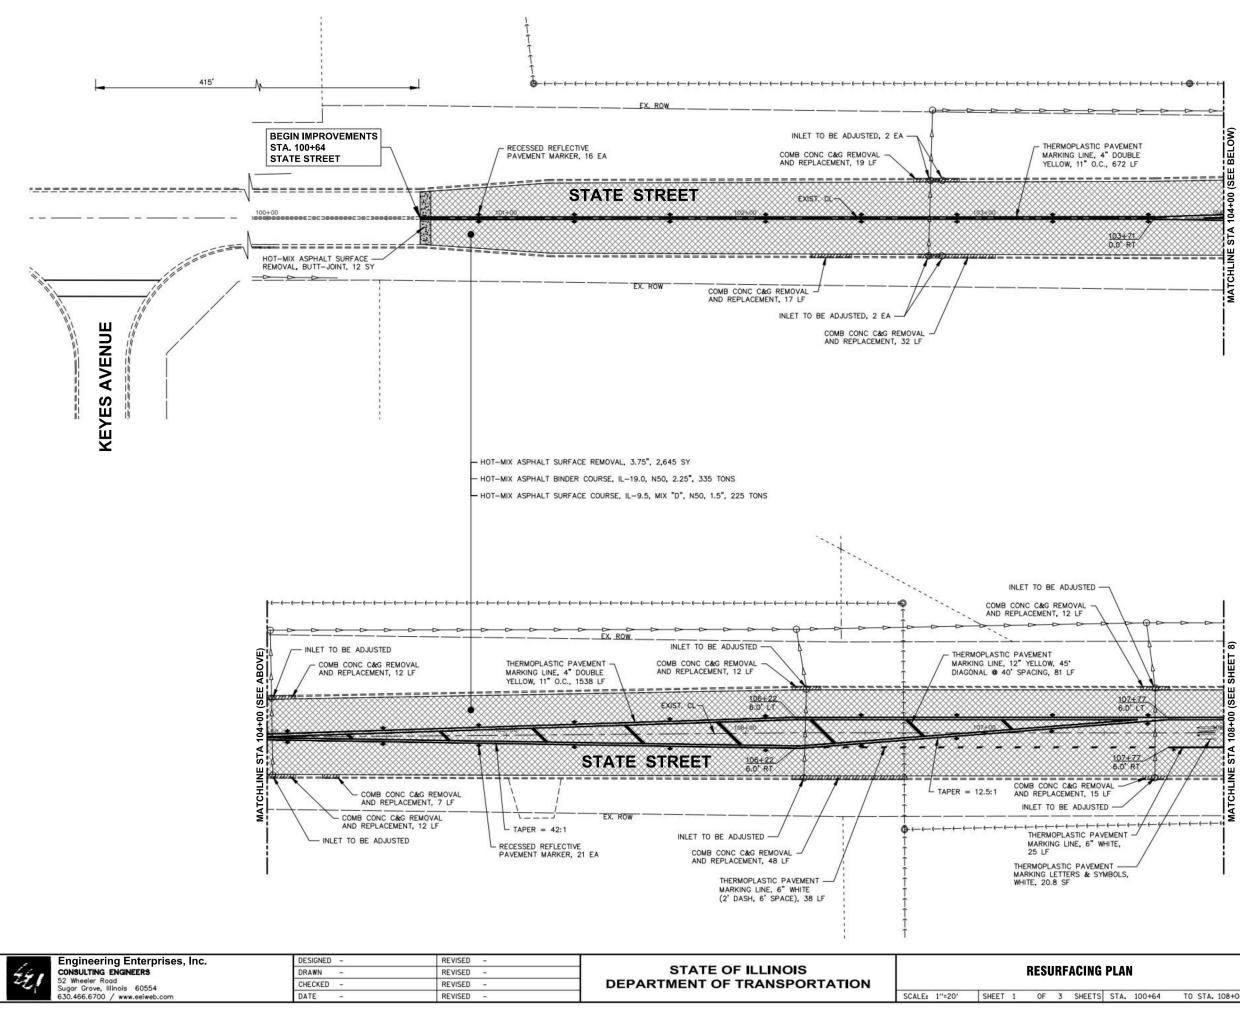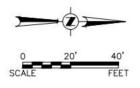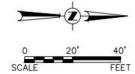LONGITUDINAL JOINT SEALANT SHALL BE PLACED UNDER THE SURFACE LIFT.







NOTES: ANY SOILS GENERATED FROM CURB REPAIRS SHALL REMAIN ON SITE IN THE RIGHT-OF-WAY. ANY SUCH SOIL SHALL BE PLACED IN THE PARKWAY NEAR STA 115+50 TO 119+00 LEFT AND AS DIRECTED BY THE ENGINEER.

LEGEND


HOT-MIX ASPHALT SURFACE REMOVAL, 3.75" AND RESURFACING


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HOT-MIX ASPHALT SURFACE REMOVAL, BUTT-JOINT

COMB CONC C&G REMOVAL AND REPLACEMENT


	F.A.U. RTE.	F.A.U. SECTION		TOTAL	SHEET NO.
NG PLAN	0098	24-00022-00-RS	KANE	19	7
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1	Engineering Enterprises, Inc.	DESIGNED -	REVISED -					F.A.U. RTE.	SECTION	COUNTY	TOTAL	SHEEL
221	CONSULTING ENGINEERS	DRAWN -	REVISED -	STATE OF ILLINOIS		RESURFACING PLAN		0098	24-00022-00-RS	KANE	19	9 8
	Sugar Grove, Illinois 60554	CHECKED -	REVISED -	DEPARTMENT OF TRANSPORTATION		•				CONTRACT	NO. 6IL	59
		DATE -	REVISED -		SCALE: 1"=20'	SHEET 3 OF 3 SHEETS STA. 116+00	TO STA. 119+28		ILLINOIS FED.	AID PROJECT		ath

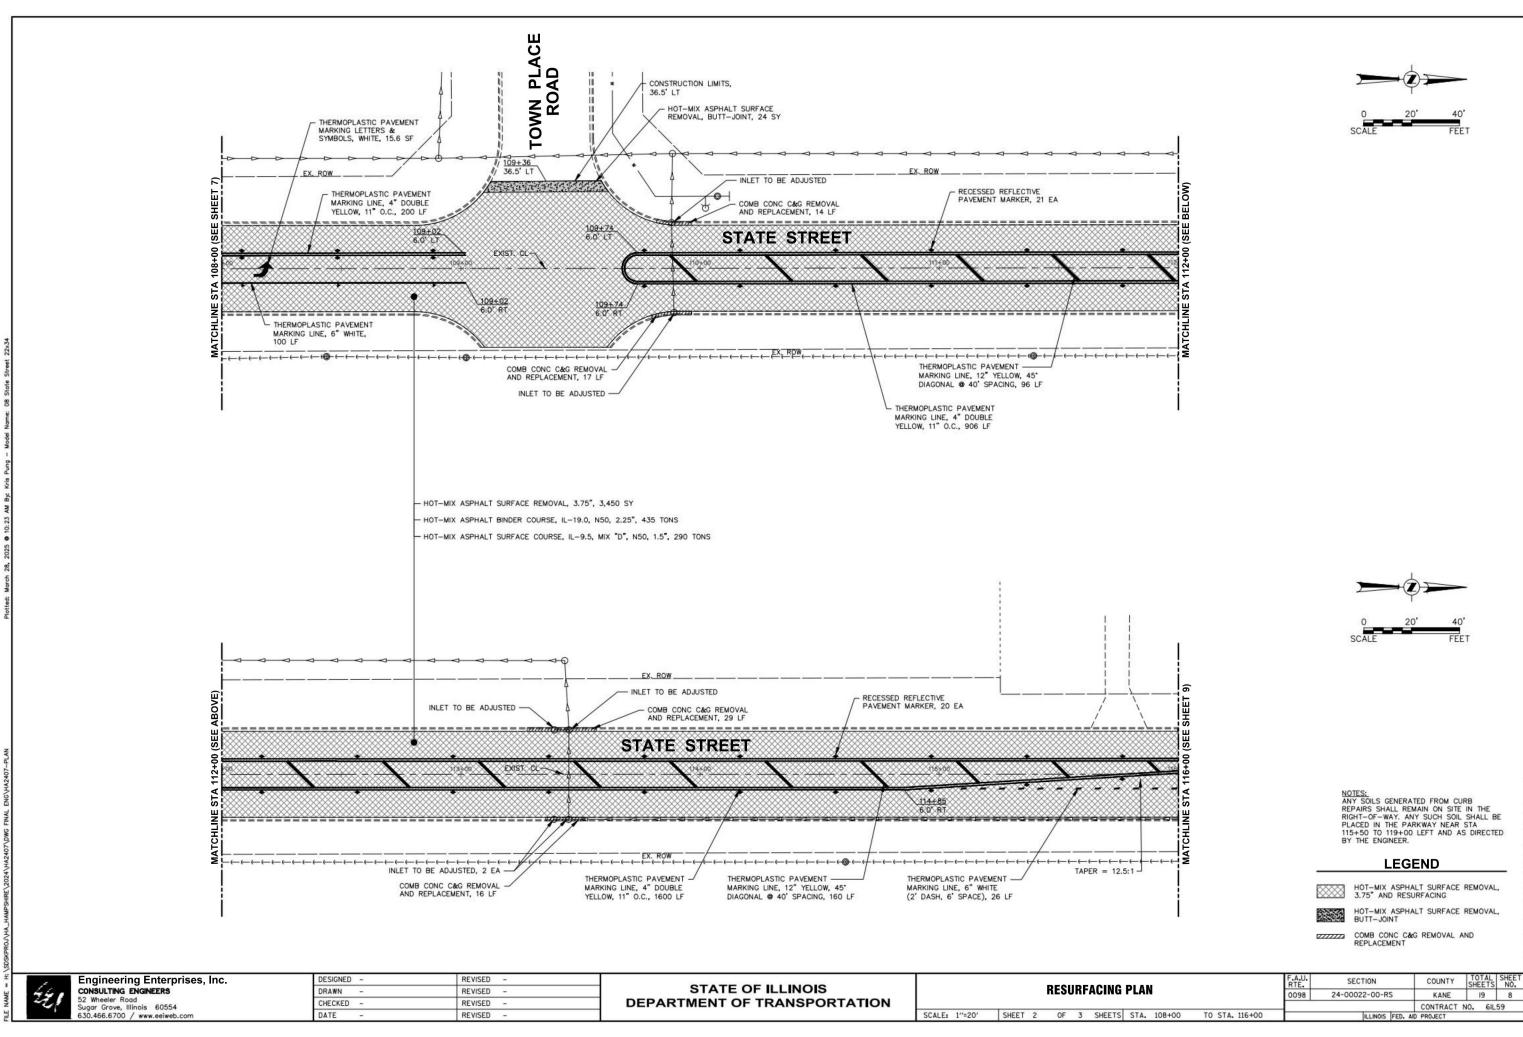

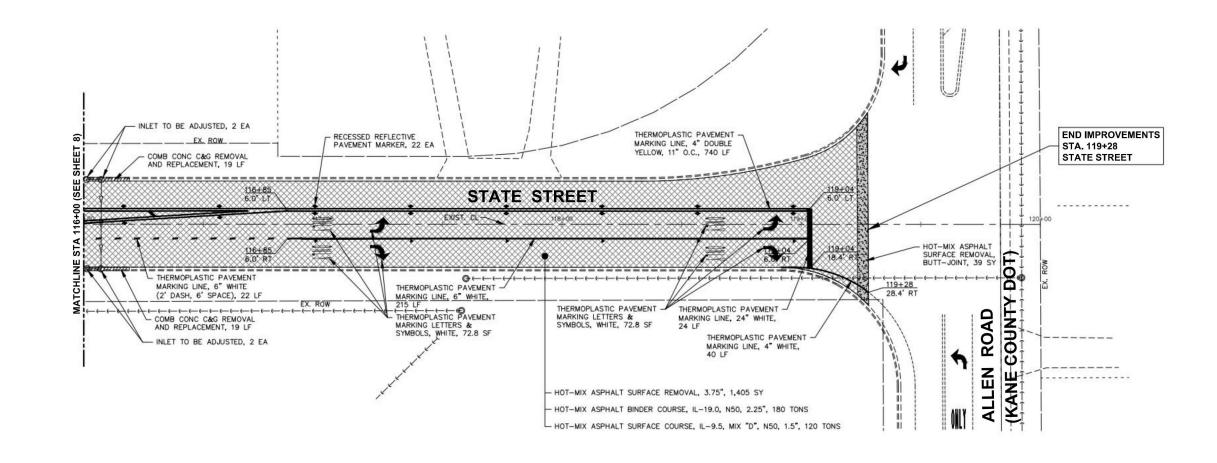NOTES: ANY SOILS GENERATED FROM CURB REPAIRS SHALL REMAIN ON SITE IN THE RIGHT-OF-WAY. ANY SUCH SOIL SHALL BE PLACED IN THE PARKWAY NEAR STA 115+50 TO 119+00 LEFT AND AS DIRECTED BY THE ENGINEER.

LEGEND

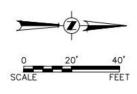HOT-MIX ASPHALT SURFACE REMOVAL, 3.75" AND RESURFACING



HOT-MIX ASPHALT SURFACE REMOVAL, BUTT-JOINT

COMB CONC C&G REMOVAL AND REPLACEMENT

CONSTRUCTION PROCEDURES

- STAGE 1 (BEFORE PAVEMENT MILLING) AROUND THE STRUCTURE. C) COVER THE STRUCTURE OPENING WITH A 36 (900) DIAMETER
 - METAL PLATE. AFTER MILLING).
- STAGE 2 (AFTER PAVEMENT MILLING)

 - FINAL SURFACE ELEVATION.

 - * UNLESS OTHERWISE SPECIFIED IN THE PLANS.

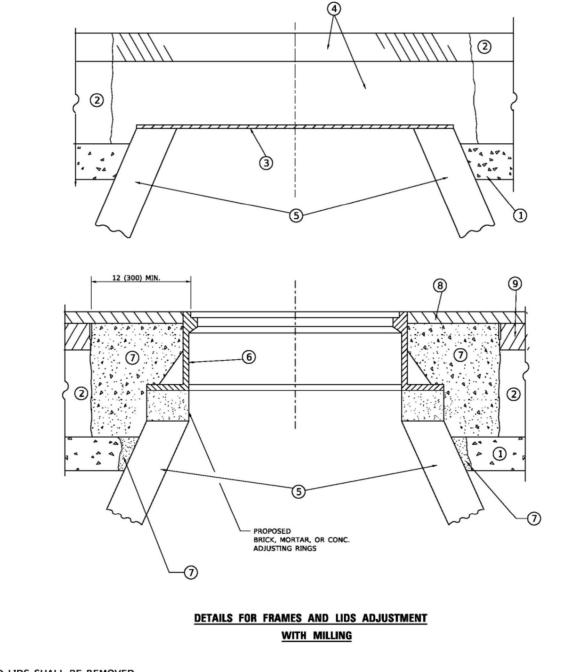
THE PROCEDURE EXPLAINED ABOVE SHALL CONFORM TO THE APPLICABLE PORTIONS OF SECTIONS 353, 406, 602, AND 603 OF THE STANDARD SPECIFICATIONS EXCEPT THAT "THE CONTRACTOR SHALL ADJUST THE STRUCTURES TO THE FINISHED PAVEMENT ELEVATION NO MORE THAN 5 CALENDAR DAYS PRIOR TO PLACEMENT OF THE FINAL LIFT OF SURFACE UNLESS APPROVED BY THE ENGINEER."

- 1 SUB-BASE GRANULAR
- 2 EXISTING PAVEMENT
- (3) 36 (900) DIAMETER METAL PLA
- PROPOSED CRUSHED STONE AN HMA SURFACE MIX
- (5) EXISTING STRUCTURE

LOCATION OF STRUCTURES

BASIS OF PAYMENT

- (SPECIAL)."
- RECONSTRUCTION.
- 3. NEW FRAMES AND LIDS, WHEN SPECIFIED, WILL BE PAID FOR SEPARATELY.



NOTES

- 1. EXISTING BROKEN FRAMES AND LIDS SHALL BE REMOVED AND DISPOSED OF BY THE CONTRACTOR AND SHALL BE REPLACED AS DIRECTED BY THE ENGINEER. REPLACEMENT FRAMES AND LIDS WILL BE PAID FOR IN ACCORDANCE WITH ARTICLE 109.04 OF THE STANDARD SPECIFICATIONS UNLESS A SEPARATE PAY ITEM HAS BEEN PROVIDED.
- 2. IF THE EXISTING LIDS ARE OPEN, THE FRAME WILL BE ADJUSTED TO THE ELEVATION OF THE MILLED PAVEMENT SURFACE PRIOR TO THE MILLING OPERATION. THE FRAME WILL NOT BE REMOVED AND COVERED BY THE METAL PLATE.
- 3. CITY OF CHICAGO CASTINGS ARE THE PROPERTY OF THE CITY AND THE CONTRACTOR SHALL NOTIFY THE CITY FOR REMOVAL AND DISPOSITION OF THE CASTINGS.
- 4. THE METAL PLATE USED TO COVER THE STRUCTURE SHALL REMAIN THE PROPERTY OF THE CONTRACTOR.
- 5. THE CONTRACTOR SHALL REMOVE ALL TRAFFIC CONTROL DEVICES BY THE END OF EACH WORK SHIFT.

USER NAME = Lawrence.DeManche	DESIGNED - R. SHAH	REVISED - R. BORO 03-09-11			DETAILS FOR	F.A.U. BTE	SECTION	COUNTY TO	TAL SHEET
	DRAWN -	REVISED - R. BORO 12-06-11	STATE OF ILLINOIS			0098	24-00022-00-RS	KANE	19 10
PLOT SCALE = 100.0000 ' / in.	CHECKED -	REVISED - K. SMITH 11-18-22	DEPARTMENT OF TRANSPORTATION	FRAMES AND	LIDS ADJUSTMENT WITH MILLING		BD600-03 (BD-08)	CONTRACT NO	O. 61L59
PLOT DATE = 9/15/2023	DATE - 10-25-94	REVISED - K. SMITH 09-15-23		SCALE: NONE SHEET 1	OF 1 SHEETS STA. TO STA.			AID PROJECT	

A) REMOVE A MINIMUM OF 12 (300) OF THE PAVEMENT FROM B) REMOVE THE EXISTING FRAME AND LID FROM THE STRUCTURE.

D) BACKFILL WITH CRUSHED STONE AND HMA SURFACE MIX APPROVED BY THE ENGINEER. (MIN. 3 (80) HMA TO REMAIN

A) REMOVE THE HMA SURFACE MIX AND CRUSHED STONE. B) INSTALL THE FRAME AND LID; ADJUST THE FRAME TO ITS C) THE SURROUNDING SPACE SHALL BE FILLED WITH CLASS PP-2* CONCRETE TO THE ELEVATION OF THE SURFACE OF THE EXISTING BASE COURSE OR THE BINDER COURSE.

LEGEND

	6 FRAME AND LID (SEE NOTES)
	(7) CLASS PP-2* CONCRETE
ND	(8) PROPOSED HMA SURFACE COURSE
	(9) PROPOSED HMA BINDER COURSE

THE CONTRACTOR WILL BE REQUIRED TO KEEP A RECORD OF THE LOCATIONS OF THE BURIED STRUCTURES ACCORDING TO THE STATION AND DISTANCE LEFT OR RIGHT OF THE CENTERLINE OF PAVEMENT. UPON COMPLETION OF THE WORK, THE CONTRACTOR WILL DELIVER THE RECORD TO THE ENGINEER.

1. REMOVING FRAMES AND LIDS ON DRAINAGE AND UTILITY STRUCTURES IN THE PAVEMENT PRIOR TO MILLING, AND ADJUSTING TO FINAL GRADE PRIOR TO PLACING THE SURFACE COURSE, WILL BE PAID FOR AT THE CONTRACT UNIT PRICE EACH FOR "FRAMES AND LIDS TO BE ADJUSTED

2. THIS WORK WILL NOT BE PAID FOR WHEN DRAINAGE AND UTILITY STRUCTURES ARE SPECIFIED FOR PAYMENT AS STRUCTURE

4. WHEN STRUCTURES ARE TO BE ADJUSTED OR RECONSTRUCTED, THE LOWERING AND RAISING OF THE FRAMES AND LIDS WILL NOT BE PAID FOR SEPARATELY BUT WILL BE INCLUDED IN THE COST OF THE CORRESPONDING PAY ITEM.

ALL DIMENSIONS ARE IN INCHES (MILLIMETERS) UNLESS OTHERWISE SHOWN

METHOD OF MEASUREMENT

REFER TO SECTION 442 OF THE STANDARD SPECIFICATIONS FOR ROAD AND BRIDGE CONSTRUCTION AND THE RECURRING SPECIAL PROVISION "PATCHING WITH HOT-MIX ASPHALT OVERLAY REMOVAL."

BASIS OF PAYMENT

- 1. REFER TO SECTION 442 OF THE STANDARD SPECIFICATIONS FOR ROAD AND BRIDGE CONSTRUCTION AND THE RECURRING SPECIAL PROVISION "PATCHING WITH HOT-MIX ASPHALT OVERLAY REMOVAL."
- 2. SAW CUT/SCORING OF EXISTING HMA OVERLAY IS INCLUDED IN THE COST OF PAVEMENT PATCHING.
- 3. SAW CUT/SCORING OF EXISTING PAVEMENT IS INCLUDED IN THE COST OF PAVEMENT PATCHING.

HMA REMOVAL OVER PATCHES $oldsymbol{ imes}$ AND HMA REPLACEMENT OVER PATCHES FOR PATCHING FIRST CONSTRUCTION 6 (150) MIN. -SAW CUT/SCORING EXIST. HMA FOR PATCHING FIRST CONSTRUCTION OVERLAY, TYPICAL. TOP OF EXIST. HMA -OR MILLED SURFACE Δ D ·D. CLASS C OR CLASS D Δ PATCH OF THE · D. THICKNESS SPECIFIED لدتني حرائي والواليوني حرائي وتوالي 12 (300) SAW CUT/SCORING, TYPICAL EXISTING PAVEMENT PROPOSED UNSUITABLE SUBGRADE REMOVAL AND REPLACEMENT UTILITY OR STORM SEWER TRENCH (IF PATCH IS DUE TO UTILITY OR SEWER WORK, THE WIDTH OF THE FULL DEPTH PATCH SHALL BE 12 (300) WIDER ON EACH SIDE OF THE TRENCH).

★ SEE TYPICAL SECTIONS FOR THICKNESS AND MATERIALS


SEQUENCE OF CONSTRUCTION (PATCHING FIRST)

- 1. REMOVE THE EXISTING HMA MATERIAL OVER THE AREA TO BE PATCHED.
- 2. REMOVE AND REPLACE WITH CLASS C OR D PATCH.
- 3. REPLACE HMA MATERIAL OVER THE AREA TO BE PATCHED.


SEQUENCE OF CONSTRUCTION (MILLING FIRST)

- 1. MILL HMA FIRST IF THERE IS AT LEAST 41/2 INCHES OR MORE OF HMA MATERIAL ON TOP OF THE EXISTING PAVEMENT OR IF THE PAVEMENT IS FULL DEPTH HMA. A MINIMUM OF 2 INCHES OF HMA MATERIAL SHALL BE IN PLACE AFTER MILLING.
- 2. REMOVE AND REPLACE WITH FULL DEPTH CLASS D PATCHES TO TOP OF MILLED SURFACE.

USER NAME = Lawrence.DeManche	DESIGNED - R. SHAH	REVISED - R. BORO 01-01-07			PAVEMENT PATCHING FOR		F.A.U. BTE	SECTION	COUNTY	TOTAL SHEET SHEETS NO
	DRAWN -	REVISED - R. BORO 09-04-07	STATE OF ILLINOIS		HMA SURFACED PAVEMENT		0098	24-00022-00-RS	KANE	19 11
PLOT SCALE = 100.0000 ' / in.	CHECKED -	REVISED - K. ENG 10-27-08	DEPARTMENT OF TRANSPORTATION		HWA SURFACED PAVEWENT		BD	400-04 (BD-22)	CONTRACT	NO. 61L59
PLOT DATE = 11/18/2022	DATE - 10-25-94	REVISED - K. SMITH 11-18-22		SCALE: NONE	SHEET 1 OF 1 SHEETS STA.	TO STA.		ILLINOIS FED. A	AID PROJECT	

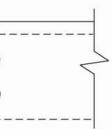

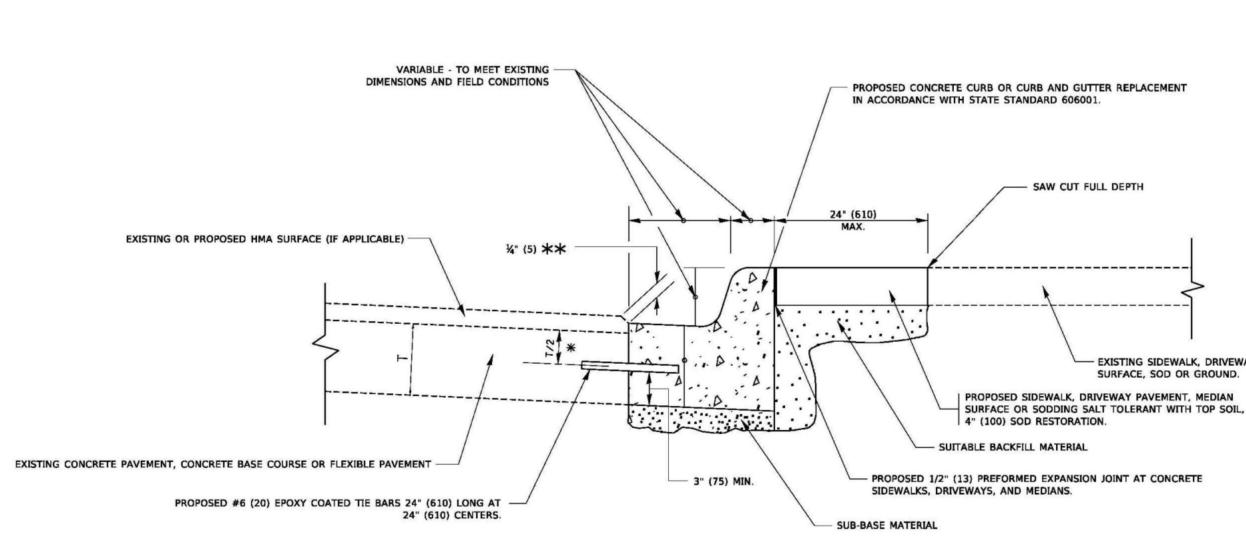ALL DIMENSIONS ARE IN INCHES (MILLIMETERS) UNLESS OTHERWISE SHOWN.



★ 3" (75) MINIMUM FROM TOP AND BOTTOM OF THE CONCRETE PAVEMENT OR BASE COURSE.

** IF THE FINAL SURFACE OF THE PAVEMENT IS CONCRETE, THE GUTTER IS TO BE FLUSH WITH THE PAVEMENT.


CURB OR CURB AND GUTTER REMOVAL AND REPLACEMENT

	USER NAME = footemj	DESIGNED - A. HOUSEH	REVISED - A. ABBAS 03-21-97			CURB OR CURB AND GUTTER		F.A.U. RTE.	SECTION	COUNTY	TOTAL SHEET SHEETS NO.
		DRAWN -	REVISED - M. GOMEZ 01-22-01	STATE OF ILLINOIS		REMOVAL AND REPLACEMENT		0098	24-00022-00-RS	KANE	19 12
	PLOT SCALE = 50.0000 ' / in.	CHECKED -	REVISED - R. BORO 12-15-09	DEPARTMENT OF TRANSPORTATION		REMUVAL AND REPLACEMENT		B	0600-06 (BD-24)	CONTRACT	NO. 61L59
	PLOT DATE = 7/11/2019	DATE - 03-11-94	REVISED - K. SMITH 07-11-19	SCAL	SCALE: NONE	SHEET 1 OF 1 SHEETS STA.	TO STA.			AID PROJECT	

EXISTING SIDEWALK, DRIVEWAY, MEDIAN SURFACE, SOD OR GROUND.



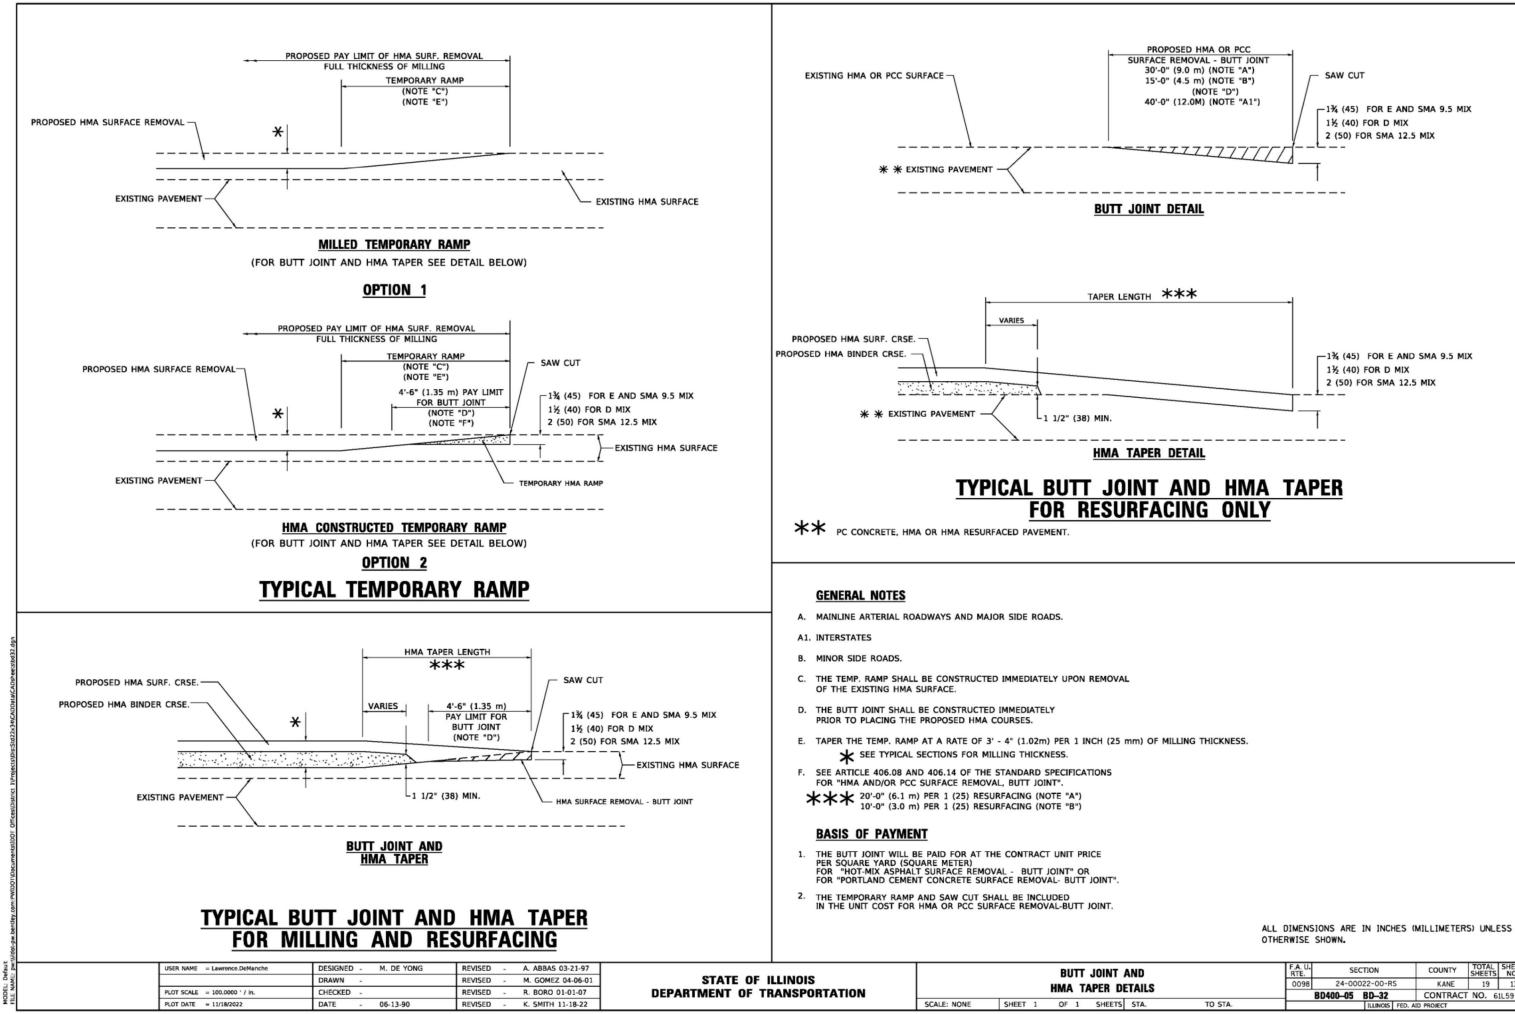
ALL DIMENSIONS ARE IN INCHES (MILLIMETERS) UNLESS OTHERWISE SHOWN.




r /	T AND Details		F.A. U. RTE.	SECTION	COUNTY	TOTAL SHEETS	SHEET NO.				
DE			0098	24-00022-00-RS	KANE	19	13				
	JETAILS			BD400-05 BD-32	CONTRACT	NO. 6	1L59				
тs	STA.	TO STA.	ILLINOIS FED. AID PROJECT								

The first of the second
NOTES:
 SIDE ROAD WITH A SPEED LIMIT OF 40 MPH (60 km/h) OR LESS AS SHOWN ON THE DRAWING AND AS DIRECTED BY THE ENGINEER:
 a) ONE "ROAD CONSTRUCTION AHEAD" SIGN 36 x 36 (900x900) WITH A F MOUNTED ON IT APPROXIMATELY 200' (60 m) IN ADVANCE OF THE MAI
b) THE CLOSED PORTION OF THE MAIN ROUTE SHALL BE PROTECTED BY BLOCKING WITH TYPE I, TYPE II OR TYPE III BARRICADES, 1/3 OF THE CROSS SECTION OF THE CLOSED PORTION.
 SIDE ROAD WITH A SPEED LIMIT GREATER THAN 40 MPH (60 km/h) AS SHOWN ON THE DRAWING AND AS DIRECTED BY THE ENGINEER:
a) ONE "ROAD CONSTRUCTION AHEAD" SIGN 48 x 48 (1.2 m x 1.2 m) WIT FLASHER MOUNTED ON IT APPROXIMATELY 500' (150 m) IN ADVANCE OF THE MAIN ROUTE.
THE CLOSED PORTION OF THE MAIN ROUTE SHALL BE PROTECTED BY b) BLOCKING WITH TYPE III BARRICADES, 1/2 OF THE CROSS SECTION OF THE CLOSED PORTION.
3. CONES MAY BE SUBSTITUTED FOR BARRICADES OR DRUMS AT HALF THE SPACING DURING DAY OPERATIONS. CONES SHALL BE A MINIMUM OF 28 (7) IN HEIGHT.
WHEN THE SIDE ROAD LIES BETWEEN THE BEGINNING OF THE MAINLINE 4. SIGNING AND THE WORK ZONE, A SINGLE HEADED ARROW (M6-1) SHALL BE USED IN LIEU OF THE DOUBLE HEADED ARROW (M6-4).

USER NAME = Lawrence.DeManche	DESIGNED - L.H.A.	REVISED - T. RAMMACHER 01-06-00		TRAFFIC CONTROL AND PROTECTION FOR	F.A.U.	SECTION	COUNTY	TOTAL SHEET
	DRAWN -	REVISED - A. SCHUETZE 07-01-13	STATE OF ILLINOIS		0098	24-00022-00-RS	KANE	19 14
PLOT SCALE = 100.0000 ' / in.	CHECKED -	REVISED - A. SCHUETZE 09-15-16	DEPARTMENT OF TRANSPORTATION	SIDE ROADS, INTERSECTIONS, AND DRIVEWAYS		TC-10	CONTRACT	NO. 61L59
PLOT DATE = 5/3/2024	DATE - 06-89	REVISED - D. SENDERAK 05-03-24		SCALE: NONE SHEET 1 OF 1 SHEETS STA. TO STA.		ILLINOIS FED. AI	D PROJECT	

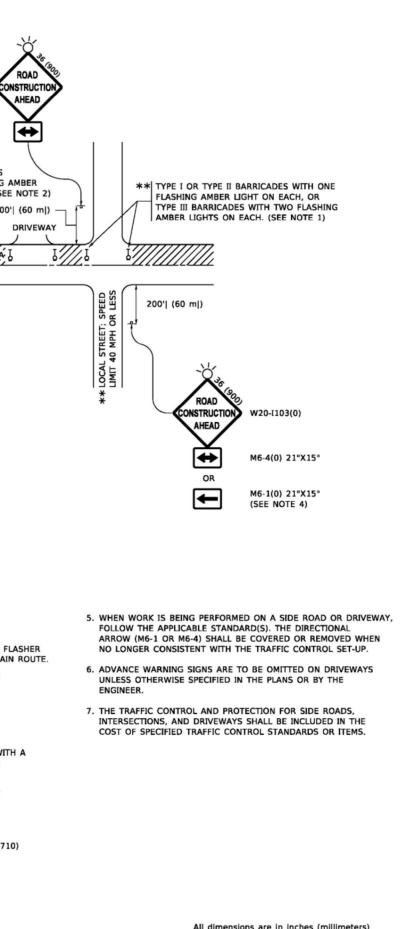


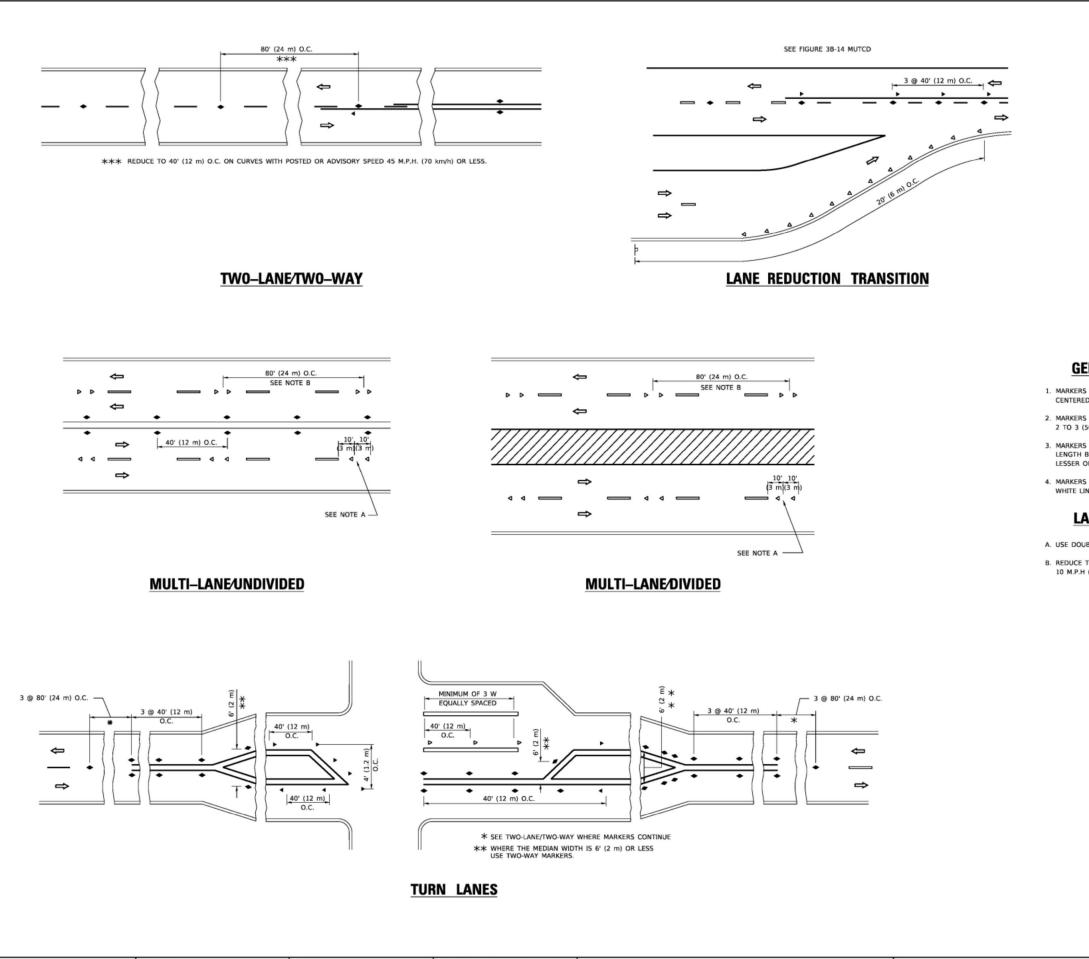All dimensions are in inches (millimeters) unless otherwise shown.



USER NAME = footemj	DESIGNED -	REVISED - T. RAMMACHER 03-12-99			т	VDICAL	APPLICA
	DRAWN -	REVISED - T. RAMMACHER 01-06-00	STATE OF ILLINOIS		-		
PLOT SCALE = 50.0000 ' / in.	CHECKED -	REVISED - C. JUCIUS 09-09-09	DEPARTMENT OF TRANSPORTATION	RAISED REFLE	ECTIVE PAV	EMENI	MARKER
PLOT DATE = 3/4/2019	DATE -	REVISED - C. JUCIUS 07-01-13		SCALE: NONE	SHEET 1	OF 1	SHEETS

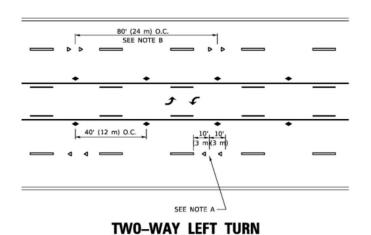EL: Default NAME: pw://JL



GENERAL NOTES

- 1. MARKERS USED WITH DASHED LINES SHALL BE CENTERED IN THE GAP BETWEEN SEGMENTS.
- 2. MARKERS USED ADJACENT TO SOLID LINES SHALL BE OFFSET 2 TO 3 (50 TO 75) TOWARD TRAFFIC AS SHOWN.
- MARKERS THROUGH TANGENTS LESS THAN 500' (150 m) IN LENGTH BETWEEN CURVES SHALL BE INSTALLED AT THE LESSER OF THE TWO CURVE SPACINGS.
- 4. MARKERS ARE TO BE USED ADJACENT TO BOTH SOLID WHITE LINES IN DUAL LEFT TURN LANES

LANE MARKER NOTES

A. USE DOUBLE LANE LINE MARKERS SPACED AS SHOWN.

B. REDUCE TO 40' (12 m) O.C. ON CURVES WHERE ADVISORY SPEEDS ARE 10 M.P.H (20 km/h) LOWER THAN POSTED SPEEDS.

SYMBOLS

- YELLOW STRIPE
- WHITE STRIPE
- ONE-WAY AMBER MARKER
- ONE-WAY CRYSTAL MARKER (W/O)
- TWO-WAY AMBER MARKER


DESIGN NOTES

- 1. DOUBLE LANE LINE MARKERS SHALL BE USED UNLESS SPECIFIED OTHERWISE.
- 2. EXCEPT AS SHOWN ON THE LANE REDUCTION TRANSITION AND FREEWAY EXIT RAMP DETAIL, MARKERS ARE NOT TO BE SPECIFIED ON RIGHT EDGE LINES.
- THE EXACT MARKER LIMITS, SPACING, AND COLOR SHALL BE INCLUDED IN THE PLANS WHEN STANDARD SPECIFICATIONS ARE NOT BEING USED.
- MARKERS SHOULD NOT BE USED ALONGSIDE CURBS EXCEPT FOR EXTREMELY SHORT SECTIONS OF CURBS WHERE NOT MORE THAN TWO MARKERS WOULD BE INVOLVED.


All dimensions are in inches (millimeters) unless otherwise shown.


TYPIC	TYPICAL APPLICATIONS					SECTION	COUNTY	TOTAL SHEETS	SHEET NO.
/EMENT MARKERS (SNOW-PLOW RESISTAN				OW_PLOW RESISTANT)	0098	24-00022-00-RS	KANE	19	15
A FIAIFI	(EMENT MARKERS (SNOW-PLOW RESISTANT)					TC-11	CONTRACT	NO. 6	1L59
OF 1 SHEETS STA. TO STA.						ILLINOIS FED. AI	D PROJECT		


VIL084EBIDI	THE ROAD WHICH IT CROSSES				FOR FURTHER DETAILS ON PAVEMENT MARKING REFER TO STANDARD SPECIFICATIONS FOR ROAD AND BRIDGE CONSTRUCTION AND STATE STANDARD 780001.		mensions are in inches (milli s otherwise shown.	meters)	
M	USER NAME = footemj	DESIGNED - EVERS	REVISED - C. JUCIUS 09-09-09		DISTRICT ONE	F.A.U.	SECTION	COUNTY	TOTAL SHEET
AME		DRAWN -	REVISED - C. JUCIUS 07-01-13	STATE OF ILLINOIS	TYPICAL PAVEMENT MARKINGS	0098	24-00022-00-RS	KANE	19 16
R N	PLOT SCALE = 50.0000 ' / in.	CHECKED -	REVISED - C. JUCIUS 12-21-15	DEPARTMENT OF TRANSPORTATION	ITPICAL PAVEMENT MARKINGS		TC-13	CONTRACT	T NO. 61L59
Ē	PLOT DATE = 3/4/2019	DATE - 03-19-90	REVISED - C. JUCIUS 04-12-16		SCALE: NONE SHEET 1 OF 2 SHEETS STA. TO STA.		ILLINOIS FED. A	ID PROJECT	

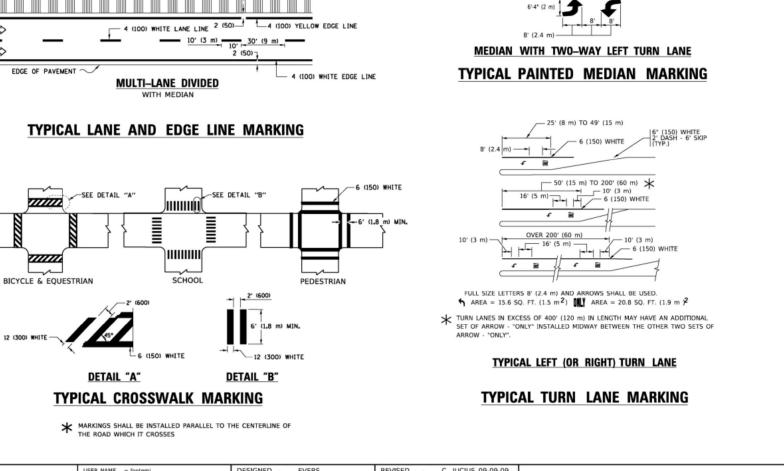





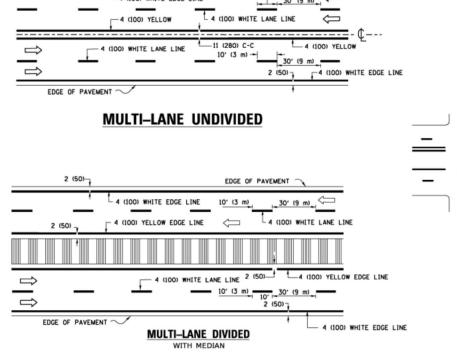


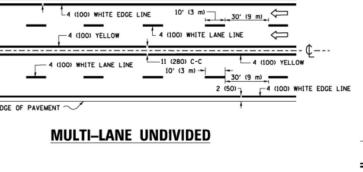

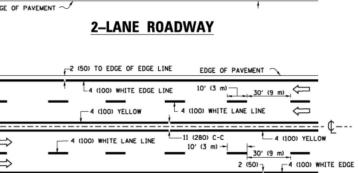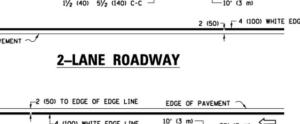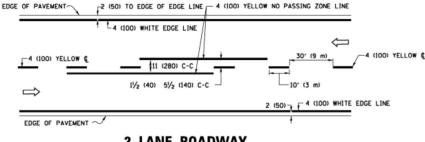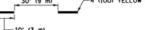





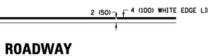












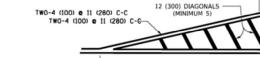















NO DIAGONALS

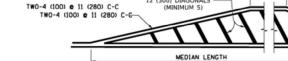



TWO-4 (100) YELLOW @ 11 (280) C-C -

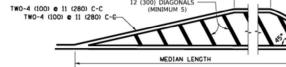


DIAGONAL LINES.

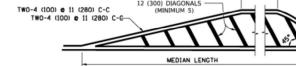

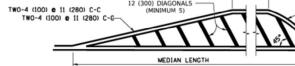

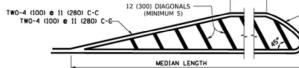

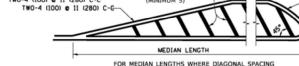





CANNOT BE ATTAINED, USE 5 (FIVE) EQUALLY SPACED

150' (45 m) C-C (MORE THAN 45MPH (70 km/h))

DIAGONAL LINE SPACING: 50' (15 m) C-C (LESS THAN 30MPH (50 km/h)) 75' (25 m) C-C 30MPH (50 km/h) TO 45MPH (70 km/h))

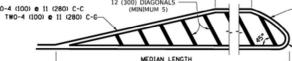
MEDIANS OVER 4' (1.2 m) WIDE

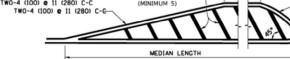
- 4 (100) YELLOW

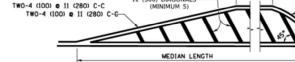
TWO-4 (100) YELLOW @ 11 (280) C-C

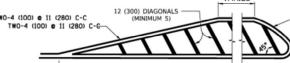
A MINIMUM OF TWO PAIRS OF TURN ARROWS SHALL BE USED, WHITE IN COLOR. ADDITIONAL PAIRS SHALL BE PLACED AT 200' (60 m) TO 300' (90 m) INTERVALS.









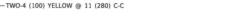












4 (100) YELLOW LINES (5½ (140) C-C)

4 (100) YELLOW LINES

(5½ (140) C-C)

4' (1.2 m) OUTSIDE TO

OUTSIDE OF LINES

8 (200) WHITE

12 (300) WHITE DIAGONALS

8 (200) WHITE -

ISLAND OFFSET FROM PAVEMENT EDGE

5

TYPICAL ISLAND MARKING

TYPE OF MARKING

CENTERLINE ON MULTI-LANE UNDIVIDED PAVEMENT

CENTERLINE ON 2 LANE PAVEMENT

DOTTED LINES (EXTENSIONS OF CENTER, LANE OR TURN LANE MARKINGS)

NO PASSING ZONE LINES: FOR ONE DIRECTION FOR BOTH DIRECTIONS

LANE LINES

EDGE LINES

STOP LINES

PAINTED MEDIANS

GORE MARKING AND CHANNELIZING LINES

RAILROAD CROSSING

SHOULDERS > 8')

2 ARROW COMBINATION

LEFT AND U TURN

J TURN ARROW

SHOULDER DIAGONALS (REQUIRED FOR

TURN LANE MARKINGS

TWO WAY LEFT TURN MARKING

CROSSWALK LINES (PEDESTRIAN) A. DIAGONALS (BIKE & EQUESTRIAN) B. LONGITUDINAL BARS (SCHOOL)

ISLAND AT PAVEMENT EDGE

- 2 (50)

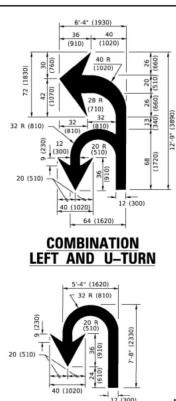
(50)

RAISED


ISLAND

8 (200) WHITE -

@ 10' (3 m) OR LESS SPACING



U-TURN

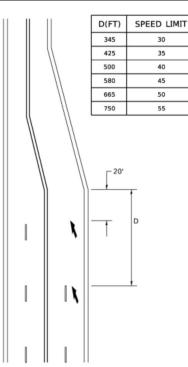



LANE REDUCTION TRANSITION

★ LANE REDUCTION ARROWS REQUIRED AT SPEEDS OF 45 MPH OR GREATER OR WHEN SPECIFIED IN PLANS.

WIDTH OF LINE	PATTERN	COLOR	SPACING / REMARKS
4 (100)	SKIP-DASH	YELLOW	10' (3 m) LINE WITH 30' (9 m) SPACE
2 @ 4 (100)	SOLID	YELLOW	11 (280) C-C
4 (100) 2 @ 4 (100)	SOLID SOLID	YELLOW YELLOW	5½ (140) C-C FROM SKIP-DASH CENTERLINE 11 (280) C-C OMIT SKIP-DASH CENTERLINE BETWEEN
4 (100) 5 (125) ON FREEWAYS	SKIP-DASH SKIP-DASH	WHITE WHITE	10' (3 m) LINE WITH 30' (9 m) SPACE
SAME AS LINE BEING EXTENDED	SKIP-DASH	SAME AS LINE BEING EXTENDED	2' (600) LINE WITH 6' (1.8 m) SPACE
4 (100)	SOLID	YELLOW-LEFT WHITE-RIGHT	OUTLINE MEDIANS IN YELLOW
6 (150) LINE; FULL SIZE LETTERS & SYMBOLS (8' (2.4m))	SOLID	WHITE	SEE TYPICAL TURN LANE MARKING DETAIL
2 @ 4 (100) EACH DIRECTION 8' (2.4m) LEFT ARROW	SKIP-DASH AND SOLID IN PAIRS	YELLOW	10' (3 m) LINE WITH 30' (9 m) SPACE FOR SKIP-DASH; 5½ (140) C-C BETWEEN SOLID LINE AND SKIP-DASH LINE SEE TYPICAL TWO-WAY LEFT TURN MARKING DETAIL
2 @ 6 (150) 12 (300) @ 45° 12 (300) @ 90°	SOLID SOLID SOLID	WHITE WHITE WHITE	NOT LESS THAN 6' (1.8 m) APART 2' (600) APART 2' (600) APART 5EE TYPICAL CROSSWALK MARKING DETAILS.
24 (600)	SOLID	WHITE	PLACE 4' (1.2 m) IN ADVANCE OF AND PARALLEL TO CROSSWALK, IF PRESENT. OTHERWISE, PLACE AT DESIRED STOPPING POINT. PARALLEL TO CROSSROAD CENTERLINE, WHERE POSSIBLE
2 @ 4 (100) WITH 12 (300) DIAGONALS @ 45° NO DIAGONALS USED FOR 4' (1.2 m) WIDE MEDIANS	SOLID	YELLOW: TWO WAY TRAFFIC WHITE: ONE WAY TRAFFIC	11 (280) C-C FOR THE DOUBLE LINE SEE TYPICAL PAINTED MEDIAN MARKING.
8 (200) WITH 12 (300) DIAGONALS @ 45°	SOLID	WHITE	DIAGONALS: 15' (4.5 m) C-C (LESS THAN 30MPH (50 km/h)) 20' (6 m) C-C 30MPH (50 km/h) TO 45MPH (70 km/h)) 30' (9 m) C-C (OVER 45MPH (70 km/h))
24 (600) TRANSVERSE LINES; "RR" IS 6' (1.8 m) LETTERS; 16 (400) LINE FOR "X"	SOLID	WHITE	SEE STATE STANDARD 780001 AREA OF: "X"=3.6 SQ. FT. (0.33 m / ² EACH "X"=54.0 SQ. FT. (5.0 m / ²
12 (300) @ 45°	SOLID	WHITE - RIGHT YELLOW - LEFT	50' (15 m) C-C (LESS THAN 30MPH (50 km/h)) 75' (25 m) C-C (30 MPH (50 km/h) TO 45MPH (70 km/h)) 150' (45 m) C-C (OVER 45MPH (70 km/h))
SEE DETAIL	SOLID	WHITE	16.3 SF
SEE DETAIL	SOLID	WHITE	30.4 SF

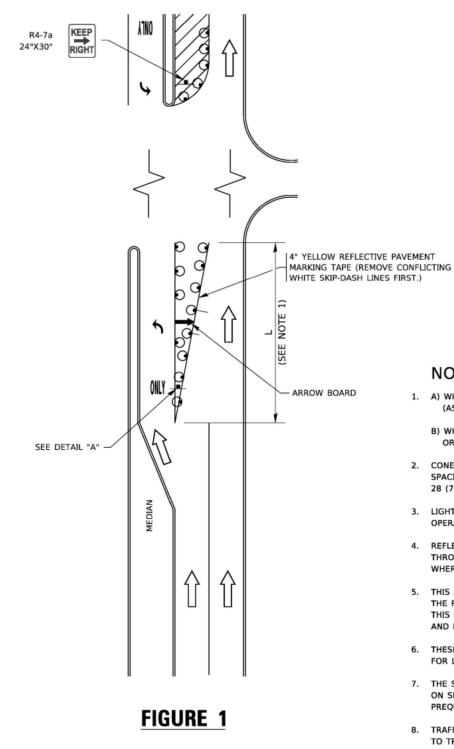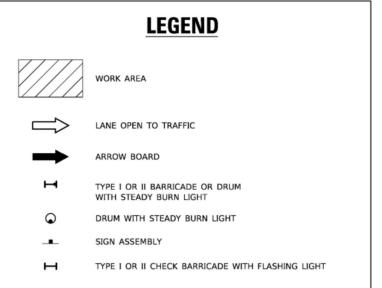
TURN BAY ENTRANCE AT START **OF LANE CLOSURE TAPER**






NOTES:

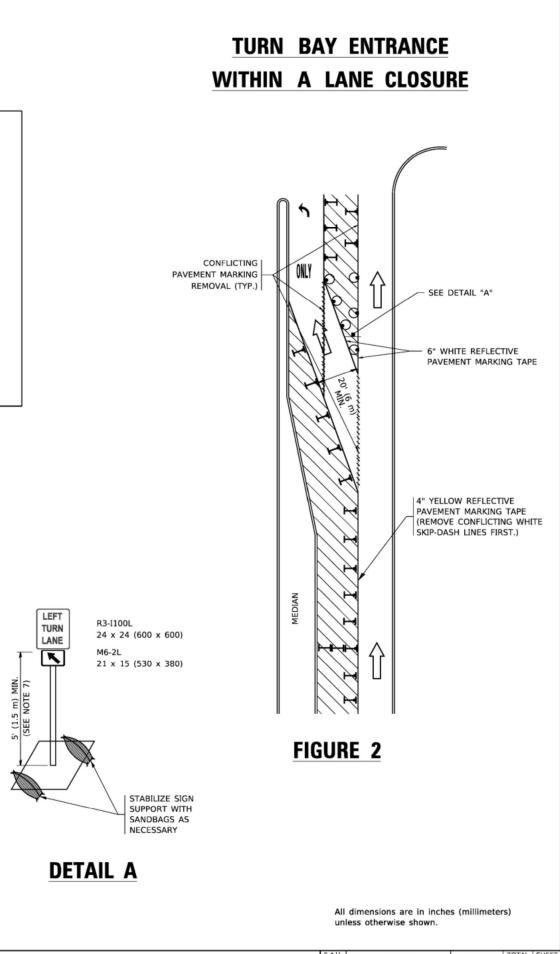- 1. A) WHEN "L" IS ≤ THE STORAGE LENGTH OF THE TURN LANE (AS SHOWN IN FIG. 1), USE FIGURE 1.
- B) WHEN "L" IS > THE STORAGE LENGTH OF THE TURN LANE OR THE TURN LANE IS WITHIN THE LANE CLOSURE, USE FIGURE 2.
- 2. CONES MAY BE SUBSTITUTED FOR BARRICADES OR DRUMS AT HALF THE SPACING DURING DAY OPERATIONS. CONES SHALL BE A MINIMUM OF 28 (710) IN HEIGHT.
- 3. LIGHTS WILL NOT BE REQUIRED ON BARRICADES OR DRUMS FOR DAY OPERATIONS. ALL LIGHTS SHALL BE MONODIRECTIONAL.
- 4. REFLECTIVE TEMPORARY PAVEMENT MARKINGS SHALL BE PLACED THROUGHOUT THE BARRICADED AREAS OF EACH TURN BAY AS SHOWN WHERE THE CLOSURE TIME IS GREATER THAN FOURTEEN (14) DAYS.
- 5. THIS APPLICATION ALSO APPLIES WHEN WORK IS BEING PERFORMED IN THE RIGHT LANE(S) AND THE RIGHT TURN BAY IS TO REMAIN OPEN. UNDER THIS CONDITION, "RIGHT TURN LANE" R3-I100R 24 x 24 (600 x 600) AND M6-2R 21 x 15 (530 x 380) SHALL BE USED.
- 6. THESE CONTROLS SHALL SUPPLEMENT MAINLINE TRAFFIC CONTROL FOR LANE CLOSURES.
- 7. THE SIGNS SHALL BE MOUNTED ABOVE THE BARRICADES/DRUMS ON SEPARATE SIGN SUPPORTS THAT MEET NCHRP 350 OR MASH PREQUIREMENTS.
- 8. TRAFFIC CONTROL AND PROTECTION AT TURN BAYS (TO REMAIN OPEN TO TRAFFIC) SHALL BE INCLUDED IN THE COST OF SPECIFIED TRAFFIC CONTROL STANDARDS OR ITEMS.




USER NAME = footemj	DESIGNED -	T. RAMMA	CHER 09-08-9	REVISED	- R. BORO 09-14-09		TRAF	FIC CONTR			CTION AT T	TIRN RAVS	F.A.J.	SECTION	COUNTY	TOTAL SHEETS	HEET
	DRAWN -	. A. HO	DUSEH 11-07-95	REVISED	- A. SCHUETZE 07-01-13	STATE OF ILLINOIS	TRAFFIC CONTROL AND PROTECTION AT TURN BAYS (TO REMAIN OPEN TO TRAFFIC)		0098	24-00022-00-RS	KANE	19	17				
PLOT SCALE = 50.0000 * / in.	CHECKED -	. A. HO	DUSEH 10-12-96	REVISED	- A. SCHUETZE 09-15-16	DEPARTMENT OF TRANSPORTATION				TC-14	CONTRACT		59				
PLOT DATE = 3/4/2019	DATE -	T. RAMMA	CHER 01-06-04	REVISED	-		SCALE: NONE	SHEET 1	OF 1	SHEET	S STA.	TO STA.		ILLINOIS FED. A	ID PROJECT		

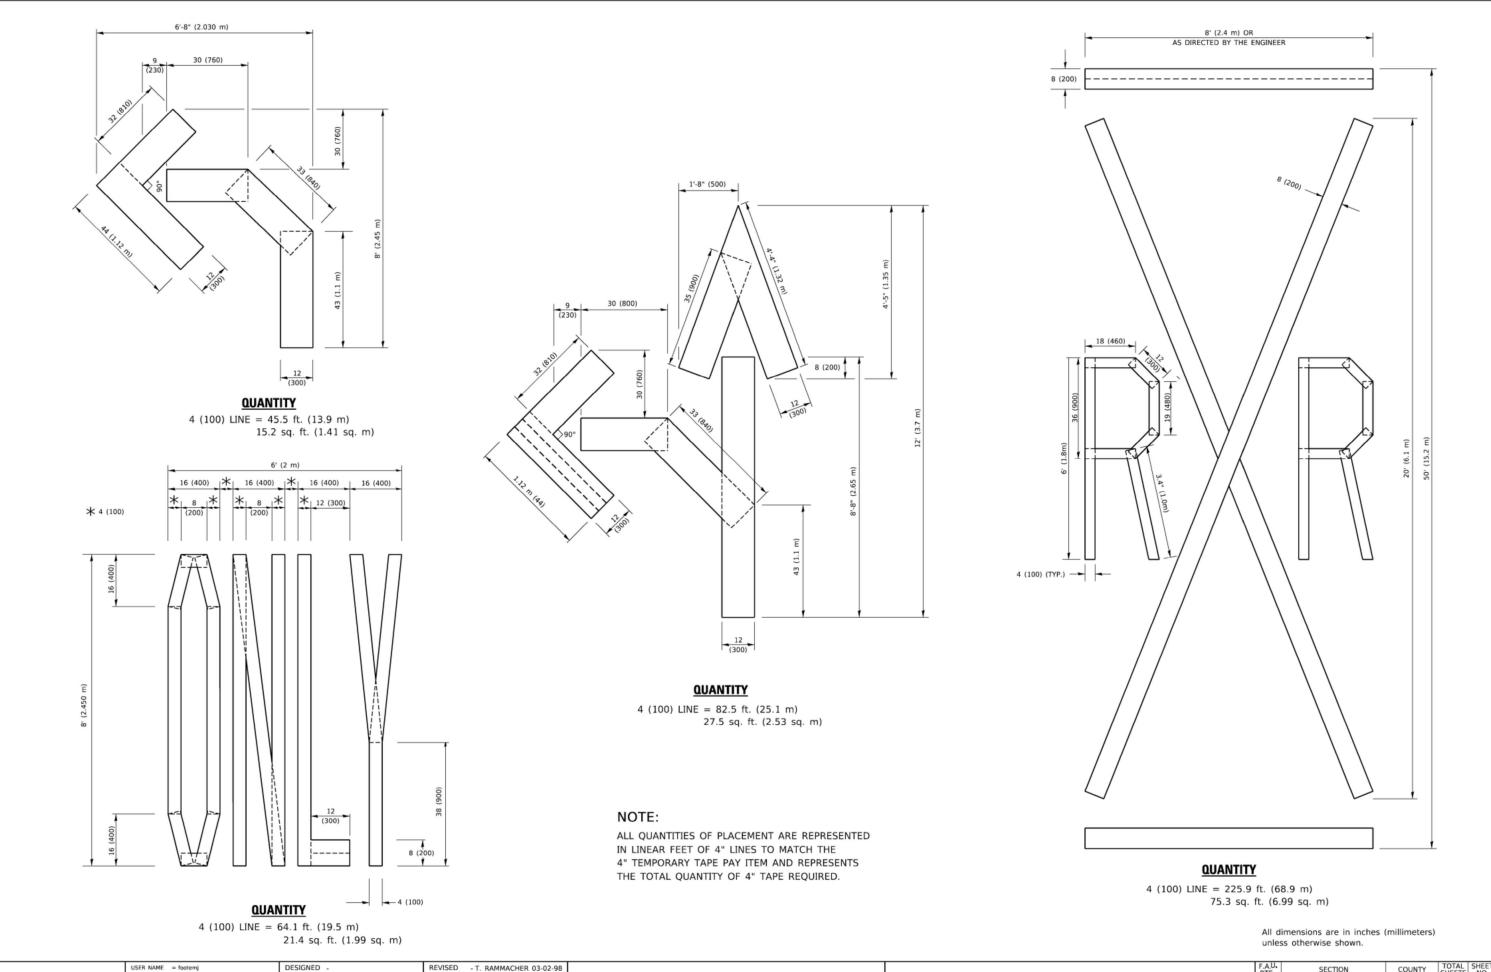

USER NAME = footemj	DESIGNED -	REVISED - T. RAMMACHER 03-02-98		1				
	DRAWN -	REVISED - E. GOMEZ 08-28-00	STATE OF ILLINOIS	SHORT TE	ERM P	PAVEMENT	MAR	KING
PLOT SCALE = 50.0068 ' / in.	CHECKED -	REVISED - E. GOMEZ 08-28-00	DEPARTMENT OF TRANSPORTATION					
PLOT DATE = 3/4/2019	DATE - 09-18-94	REVISED - A. SCHUETZE 09-15-16		SCALE: NONE	SHEET	1 OF	1 SH	IEETS
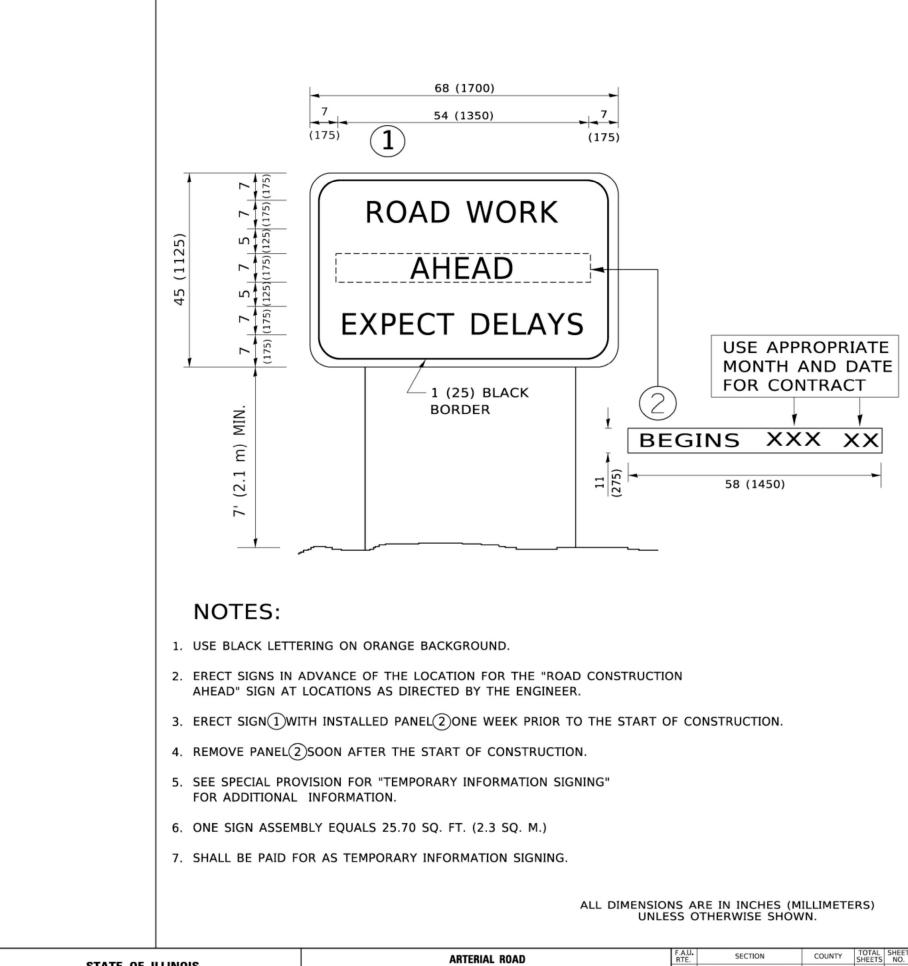
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NG LETTERS AND		SYMBOLS	0098	0098 24-00022-00-RS			KANE	19	18
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USER NAME – footemj	DESIGNED -	REVISED - R. MIRS 09-15-97				ARTE	RIAL RO			F.A.U.	SECTION	COUNTY	TOTAL	SHEET
	DRAWN -	REVISED - R. MIRS 12-11-97	STATE OF ILLINOIS						ŀ	0098	24-00022-00-RS	KANE	19	19
PLOT SCALE = 50.0000 ° / in.	CHECKED -	REVISED -T. RAMMACHER 02-02-99	DEPARTMENT OF TRANSPORTATION	INFORMATION SIGN				TC-22	CONTRACT	TRACT NO. 61L5				
PLOT DATE = 3/4/2019	DATE -	REVISED - C. JUCIUS 01-31-07		SCALE: NONE	SHEET 1	OF 1	SHEETS	STA.	TO STA.		ILLINOIS FED. AID PROJE			