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UTILITY CONTACTS

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CABLE TELEVISION: JEFF JAMISON 4450 KISHWAUKEE STREET ROCKFORD, ILLINOIS 61109 (224) 229-4612

WATER/SEWER:
WATER AND SEWER COMMISSION 337 S. HANCOCK AVENUE FREEPORT, ILLINOIS 61032 (815) 232-6017

ROADWAY - TRANSPORTATION: CITY OF FREEPORT DENNIS CARR DIRECTOR OF PUBLIC WORKS 314 W. STEPHENSON STREET FREEPORT, ILLINOIS 61032 (815) 297-1166




811 or 1-800-892-0123 TOLL FREE

PLANS FOR PROPOSED (ITEP) PROJECT


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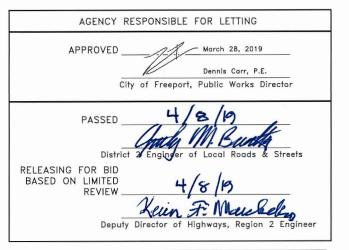
CONTRACT NO. 85674



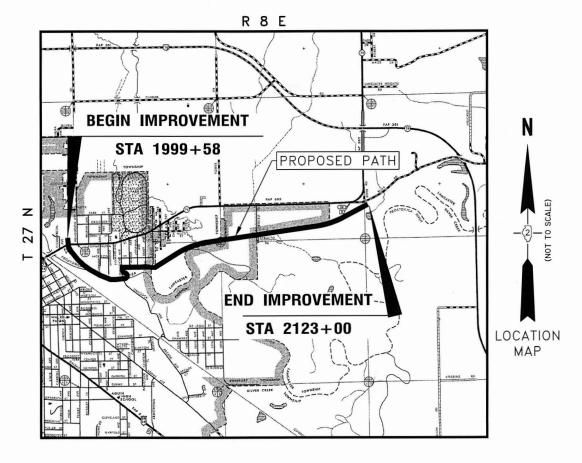

DISTRICT 2



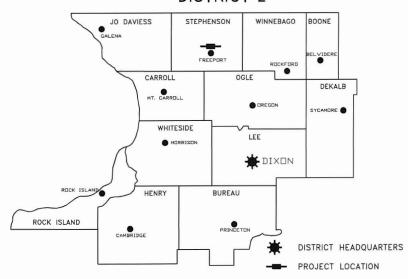

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 $\frac{\text{PROJECT LENGTH}}{\text{GROSS LENGTH}} = 12,148 \text{ FT} = 2.30 \text{ MILES}$

OMISSIONS: STRUCTURE #104 STA. 2087+89 TO STA. 2088+05

STA. 2018+91.87 = 2+79.19 € SHERIDAN RD.

<u>STRUCTURE LOCATIONS:</u> STRUCTURE 103 = 2059+12.04 TO 2060+35.12



SHEETS All Except 03,32,33 DATE SIGNED 3/28/19 DATE SIGNED 11/30/19 EXPIRES



DATE SIGNED 3/28/19 EXPIRES 11/30/20



McCLURE PROJECT NO: 04-28-14-054

GENERAL NOTES

- ALL CONSTRUCTION SHALL BE IN ACCORDANCE WITH THE ILLINOIS DEPARTMENT OF TRANSPORTATION "STANDARD SPECIFICATIONS FOR ROAD AND BRIDGE CONSTRUCTION", APRIL 1, 2016 AND "SUPPLEMENTAL SPECIFICATIONS AND RECURRING SPECIAL PROVISIONS" JANUARY 1, 2019 EDITION WHERE APPLICABLE.
- 2. THE CONTRACTOR SHALL SUBMIT A PROGRESS SCHEDULE TOGETHER WITH A LIST OF SUPPLIERS AND SUBCONTRACTORS AT THE PRE-CONSTRUCTION MEETING.
- 3. THE CONTRACTOR WILL BE REQUIRED TO COMPLY WITH ALL STATE REGULATIONS REGARDING AIR, WATER, AND NOISE POLLUTION. HE WILL NOT BE ALLOWED TO BUILD FIRES ON THE SITE.
- 4. IT IS THE CONTRACTOR'S RESPONSIBILITY TO ASCERTAIN EXISTING FIELD CONDITIONS BEFORE BIDDING ON THIS PROJECT, ORDERING MATERIALS, OR BEGINNING CONSTRUCTION, PARTICULARLY AS THEY RELATE TO LUMP SUM PAY ITEMS.
- 5. THE CONTRACTOR SHALL OBTAIN ALL NECESSARY PERMITS PRIOR TO COMMENCING WORK ON THIS PROJECT. PERMITS HAVE BEEN GRANTED FOR THIS PROJECT BY THE CORPS OF ENGINEERS, AND DIVISION OF WATER RESOURCES. COPIES ARE AVAILABLE FOR INSPECTION AT THE CONTRACTOR'S REQUEST.
- 6. WHERE SECTION OR SUBSECTION MONUMENTS ARE ENCOUNTERED, THE ENGINEER SHALL BE NOTIFIED BEFORE SUCH MONUMENTS ARE REMOVED OR DISTURBED. THE CONTRACTOR SHALL PROTECT AND CAREFULLY PRESERVE ALL PROPERTY MARKERS, MONUMENTS AND RIGHT OF WAY PINS UNTIL THE OWNER, AN AUTHORIZED SURVEYOR, OR AGENT HAS WITNESSED OR OTHERWISE REFERENCED THEIR LOCATION. THE CONTRACTOR WILL BE RESPONSIBLE FOR HAVING AN AUTHORIZED SURVEYOR RE-ESTABLISH ANY SECTION OR SUBSECTION MONUMENTS DESTROYED BY HIS OPERATIONS WITH NO ADDITIONAL COMPENSATION BEING ALLOWED. REPLACEMENT OF MONUMENTS SHALL BE DETERMINED BY THE ENGINEER.
- THE CONTRACTOR SHALL KEEP EXISTING ROADWAYS AND PAVEMENTS FREE OF MUD AND OTHER DEBRIS AND SHALL INSTITUTE DUST CONTROL
 MEASURES DURING CONSTRUCTION.
- 8. SEE CROSS-SECTIONS FOR SPECIAL DITCHES AND GRADING DETAILS.
- 9. NO OVERHAUL HAS BEEN COMPUTED AND NONE SHALL BE PAID FOR FROM ANY SOURCE.
- 10. SOD AND TOPSOIL SHALL BE REMOVED IN THE PATH AND SHOULDER AREAS, AND MAY BE USED IN CONSTRUCTING THE SIDESLOPES OR FILL AREAS ADJACENT TO THE SHOULDER. THE CONTRACTOR SHALL ALSO BE RESPONSIBLE FOR PROPERLY DISPOSING OF ALL SUITABLE AND UNSUITABLE MATERIAL, AWAY FROM THE JOB SITE, THAT IS IN EXCESS OF WHAT IS REQUIRED OR REJECTED AS EMBANKMENT FILL BY THE ENGINEER. THE COST FOR ADDITIONAL HANDLING AND DISPOSAL OF SUCH MATERIAL SHALL BE CONSIDERED INCLUDED IN THE "SHAPING AND GRADING ROADWAY" PAY ITEM.
- 11. THE CONTRACTOR SHALL CONFINE WORK ACTIVITIES TO THE CONSTRUCTION LIMITS AS DEFINED ON THE TYPICAL SECTIONS AND CROSS SECTIONS. AREAS DISTURBED OUTSIDE THE CONSTRUCTION LIMITS WILL BE RESTORED AT THE CONTRACTOR'S OWN EXPENSE.
- 12. THE CONTRACTOR SHALL PLACE EROSION CONTROL AND SEED ALL DISTURBED AREAS WITHIN THE PROJECT LIMITS USING SEEDING, CLASS 1 OR CLASS 4 AS INDICATED ON THE PLANS OR AS DIRECTED BY THE ENGINEER. STRAW MULCH SHALL BE APPLIED AT THE RATE OF 2 TONS PER ACRE OVER SEEDED AREAS. FERTILIZER SHALL BE APPLIED AT A RATE OF 180 POUNDS OF FERTILIZER NUTRIENTS PER ACRE AT A 1:1:1 RATIO.
- 13. THE FINAL TOP 4 INCHES OF SOIL IN ANY AREAS DISTURBED BY THE CONTRACTOR MUST BE A COHESIVE SOIL CAPABLE OF SUPPORTING VEGETATION.
- 14. ONLY THOSE TREES DESIGNATED BY THE ENGINEER AND MARKED IN THE FIELD SHALL BE REMOVED. THE CONTRACTOR WILL PROTECT ALL REMAINING TREES FROM DAMAGE DUE TO HIS OPERATIONS. BRUSH AND WOODY PLANTS ALONG THE EDGE OF THE PATH WHICH NEED TO BE REMOVED MAY BE CHIPPED AND LEFT ON THE SLOPES AS MULCH. THIS ITEM IS PAID FOR AS SELECTIVE CLEARING.
- 15. ALL EXISTING SIGNS, GATES, AND TRAFFIC CONTROL SIGNS LOCATED ALONG THE PROPOSED PATH SHALL BE REMOVED AND DISPOSED OF BY THE CONTRACTOR WITH THE EXCEPTION OF UTILITY WARNING SIGNS OR ANY OTHER SIGNS DESIGNATED BY THE ENGINEER TO REMAIN IN PLACE. THE COST FOR REMOVING AND DISPOSING OF SUCH SIGNS AND GATES, SHOWN OR NOT SHOWN ON THE PLANS, SHALL BE INCLUDED IN THE "CLEARING AND GRUBBING" PAY ITEM.
- 16. THE CONTRACTOR SHALL USE CARE IN GRADING OR EXCAVATING NEAR ALL EXISTING ITEMS WHICH ARE NOT INDICATED TO BE REMOVED.

 ANY DAMAGE DONE TO EXISTING ITEMS BY THE CONTRACTOR'S OPERATIONS SHALL BE REPAIRED BY THE CONTRACTOR AT HIS OWN EXPENSE.
- 17. REMOVAL ITEMS CONFORMING TO SECTION 440 OF THE STANDARD SPECIFICATIONS SHALL BE SAWED PRIOR TO BEING REMOVED. ALL JOINTS BETWEEN THE PORTION REMOVED AND THAT LEFT IN PLACE SHALL BE SAWED TO SUCH A DEPTH THAT A CLEAN, NEAT EDGE WILL RESULT WITH NO SPALLING TO THE REMAINING PORTION. THE COST OF SAWING FOR REMOVAL ITEMS AND OTHER LOCATIONS INDICATED ON THE PLANS SHALL BE CONSIDERED INCLUDED IN THE ITEM BEING REMOVED. ADDITIONAL SAWING OR RE—SAWING MAY BE REQUIRED AS DIRECTED BY THE ENGINEER IF THE NEAT EDGE IS DAMAGED BY THE CONTRACTOR PRIOR TO PAVING WITH NO ADDITIONAL COMPENSATION BEING ALLOWED.
- 18. THE CONTRACTOR SHALL BE RESPONSIBLE FOR THE PROTECTION OF ALL UNDERGROUND OR SURFACE UTILITIES. ANY UTILITY THAT IS DAMAGED DURING CONSTRUCTION SHALL BE REPAIRED TO THE SATISFACTION OF THE ENGINEER OR THE OWNER, OR REPLACED. THIS WORK SHALL BE AT THE CONTRACTOR'S OWN EXPENSE. UTILITIES SHOWN ON THE PLANS ARE FOR ILLUSTRATIVE PURPOSES ONLY AND NO GUARANTEE OF THEIR ACCURACY IS MADE OR INFERRED. THE LOCATIONS OF EXISTING UTILITIES AS SHOWN ON THE DRAWINGS REPRESENT DATA RECEIVED FROM VARIOUS SOURCES. IT IS NOT GUARANTEED TO BE CORRECT OR ALL-INCLUSIVE. THE CONTRACTOR SHALL CONDUCT HIS OWN INVESTIGATION INTO THE LOCATION, SIZE, DEPTH, AND NATURE OF ANY AND ALL EXISTING UTILITIES, WHICH MAY INTERFERE WITH THE WORK UNDER THIS CONTRACT. ANY EXISTING UTILITIES THAT ARE TO REMAIN IN SERVICE SHALL BE FULLY PROTECTED BY THE CONTRACTOR AND ANY DAMAGE CAUSED BY THE CONSTRUCTION OPERATIONS SHALL BE IMMEDIATELY REPAIRED AT NO ADDITIONAL COST. THE CONTRACTOR SHALL BE RESPONSIBLE FOR PROTECTING UTILITY PROPERTY DURING CONSTRUCTION OPERATIONS AS OUTLINED IN ARTICLE 107.39 OF THE STANDARD SPECIFICATIONS. THE J.U.L.I.E. TELEPHONE NUMBER IS 811 OR (800)-892-0123. A MINIMUM OF 48 HOURS ADVANCE NOTICE IS REQUIRED FOR ALL NON-EMERGENCY WORK.
- 19. THE COST OF MAKING SEWER CONNECTIONS TO EXISTING OR PROPOSED STORM SEWERS, DRAINAGE STRUCTURES, AND APPURTENANCES SHALL BE CONSIDERED INCLUDED IN THE VARIOUS CONTRACT BID PRICES FOR THE SPECIFIED ITEMS.

- 20. WHENEVER THE PROPOSED BIKE PATH INTERSECTS AN EXISTING SIDE ROAD OR STREET, THE PATH SHALL MATCH EXISTING GRADE AT CROSSING.
- 21. ANY RAILROAD TIE AND/OR RAILS FOUND WITHIN THE GRADING LIMITS SHALL BE REMOVED AND DISPOSED OF AT AN APPROVED WASTE SITE.
- 22. WHERE NGS BENCH MARKS SHOWN ON THE PLANS WILL BE DISTURBED BY CONSTRUCTION THE ENGINEER WILL RESET A NEW MONUMENT IN THE NEW WORK. THE CONTRACTOR SHALL NOT DISTURB THE BENCH MARK UNTIL THE ENGINEER HAS REFERENCED IT.
- 23. SCALE APPLIES TO FULL SIZE DRAWINGS.
- 24. THE BRIDGES IN THIS SECTION HAVE BEEN DESIGNED FOR AND ARE RATED AT 20,000 LBS (H-10) GROSS VEHICLE WEIGHT. IF THE CONTRACTOR MUST CROSS A BRIDGE WITH A LOAD EXCEEDING 20,000 LBS G.V.W., A RUN AROUND OR ALTERNATE ACCESS MUST BE USED.
- 25. BITUMINOUS MATERIALS (PRIME COAT) SHALL BE APPLIED AT A RATE OF 0.375 LB/SQ YD ON AGGREGATE SURFACES, AND BITUMINOUS MATERIALS (TACK COAT) SHALL BE APPLIED AT 0.025 LB/SQ FT ON HMA LIFTS.

LEGEND

⊙ *	DECIDUOUS TREE EVERGREEN TREE		EXISTING PROPOSED
	EXISTING SIGN PROPOSED SIGN		EASEMENT LINE RIGHT-OF-WAY LINE
- 	UTILITY POLE TELEPHONE PEDESTAL		SECTION LINE CENTER LINE
UTV	ELECTRIC TRANSFORMER EXISTING CABLE TELEVISION LINE		WETLAND FENCE
OE	EXISTING OVERHEAD ELECTRIC LINE EXISTING GAS MAIN	◎	EXISTING BRUSHLINE EXISTING MANHOLE
OT	EXISTING UNDERGROUND TELEPHONE LINE EXISTING OVERHEAD/TELEPHONE LINE	$\begin{array}{c} - \rangle \\ \hline - \rangle \\ \hline - \rangle \\ \hline \end{array}$	EXISTING STORM SEWER PROPOSED STORM SEWER
6W	EXISTING WATER MAIN EXISTING VALVE AND VAULT	>	EXISTING SANITARY SEWER EXISTING INLET TYPE 700
⊗	EXISTING VALVE AND BOX EXISTING FIRE HYDRANT ASSEMBLY		EXISTING INLET TYPE 6-A EXISTING INLET SPECIAL
	EXISTING ELECTRIC HANDHOLE EXISTING BUILDING	/X	TREE REMOVAL PERIMETER EROSION BARRIE
	CONCRETE PAVEMENT REMOVAL	—-w	TURBIDITY BARRIER
	BITUMINOUS PAVEMENT REMOVAL		



JSER NAME:	DESIGNED:	REVISED:	
	CHECKED:	REVISED:	
PLOT SCALE:	DRAWN: ATH	REVISED:	
PLOT DATE: 3/27/2019	CHECKED: WLK	REVISED:	

STATE OF ILLINOIS CITY OF FREEPORT

GENERAL NOTES		SECTION		COUNTY	TOTAL SHEETS	
FREEPORT PEC PATH	N.A.	15-00163-00-	3 <i>T</i>	STEPHENSON	92	02
THELI OH TECTAM		FREEPORT		CONTRACT N	10. 856.	74
SHEET NO. OF SHEETS		# LINOIS	FFD 4	ID PROJECT -		

PREFABRICATED STEEL BRIDGE GENERAL NOTES

(BRIDGE 103)

- 1. THE DESIGN AND FABRICATION OF THE PEDESTRIAN BRIDGE SUPERSTRUCTURE SHALL COMPLY WITH THE REQUIREMENTS OF THE "AASHTO GUIDE SPECIFICATIONS FOR DESIGN OF PEDESTRIAN BRIDGES", THE "AASHTO STANDARD SPECIFICATIONS FOR HIGHWAY BRIDGES" (17th EDITION), THE AMERICAN INSTITUTE OF STEEL CONSTRUCTION (AISC) AND SHALL ALSO BE IN CONFORMANCE WITH THE CURRENT IDOT GUIDE BRIDGE SPECIAL PROVISION, GBSP 33, "PEDESTRIAN TRUSS SUPERSTRUCTURE".
- THE CONTRACTOR SHALL SUBMIT SHOP DRAWINGS IN ACCORDANCE WITH GBSP 33 TO THE ENGINEER PRIOR TO BEGINNING FABRICATION AND PRIOR TO THE CONSTRUCTION OF THE CONCRETE SUBSTRUCTURE IN THE FIELD.
- 3. IT SHALL BE THE RESPONSIBILITY OF THE CONTRACTOR TO VERIFY ALL DIMENSIONS AND CONDITIONS EXISTING IN THE FIELD PRIOR TO CONSTRUCTION AND ORDERING MATERIALS.
- 4. STAKED LOCATIONS OF THE ABUTMENTS, PIERS AND PILE/DRILLED SHAFT LOCATIONS, AS APPLICABLE, WILL BE CHECKED IN THE FIELD BY THE ENGINEER. THE CONTRACTOR SHALL BE RESPONSIBLE FOR CONTACTING THE ENGINEER 48 HRS PRIOR TO THE START OF THIS WORK.
- 5. THE DRILLED SHAFT FOUNDATIONS SHALL BE CONSTRUCTED TO THE DEPTH SHOWN ON THE PLANS OR AS DIRECTED BY THE ENGINEER. THIS WORK SHALL CONFORM TO SECTION 516 OF THE "STANDARD SPECIFICATIONS FOR ROAD AND BRIDGE CONSTRUCTION" BY THE ILLINOIS DEPARTMENT OF TRANSPORTATION, LATEST EDITION.
- 6. THE CONCRETE SUBSTRUCTURE SHALL BE CONSTRUCTED, AS SHOWN, IN ACCORDANCE WITH THE "AASHTO STANDARD SPECIFICATIONS FOR HIGHWAY BRIDGES" AND SECTION 503 OF THE CURRENT EDITION OF THE "IDOT STANDARD SPECIFICATIONS FOR ROAD AND BRIDGE CONSTRUCTION". ABUTMENT SEATS SHALL BE SLOPED FOR DRAINAGE BETWEEN BEARING LOCATIONS.
- 7. REINFORCEMENT BARS SHALL CONFORM TO THE REQUIREMENTS OF ASTM A 706M GRADE 420. SEE SPECIAL PROVISIONS. REINFORCEMENT BARS DESIGNATED (E) SHALL BE EPOXY COATED OR AS INDICATED BY SPECIFIC PLAN SHEET PER STRUCTURE. COVER FROM THE FACE OF CONCRETE TO THE FACE OF REINFORCING BARS SHALL BE 2" MINIMUM UNLESS OTHERWISE SHOWN.
- 8. ALL EXPOSED EDGES OF CONCRETE SUBSTRUCTURE SHALL HAVE A ¾" x 45° CHAMFER, EXCEPT AS SHOWN OTHERWISE. CHAMFERS ON VERTICAL EDGES SHALL BE CONTINUED A MINIMUM OF 5 INCHES BELOW FINISHED GROUND LEVEL. EXPOSED CONCRETE SHALL RECEIVE A 'NORMAL' FINISH WHICH SHALL BE INCLUDED WITH THE CONTRACT UNIT COST FOR CONCRETE STRUCTURES.
- 9. ALL STRUCTURAL STEEL SHALL CONFORM TO THE REQUIREMENTS OF SECTION 1006 OF THE IDOT STANDARD SPECIFICATIONS, ASTM A847 FOR COLD FORMED WELDED SQUARE AND RECTANGULAR TUBING, AASHTO M270M 345W FOR ATMOSPHERIC CORROSION RESISTANT STRUCTURAL STEEL, AS APPLICABLE, UNLESS OTHERWISE SHOWN ON THE PLANS OR APPROVED BY THE ENGINEER.
- 10. BRIDGE DECK SHALL BE 3" THICK TREATED TIMBER PLANK. THE TREATED TIMBER DECKING SHALL BE #1 GRADE SOUTHERN YELLOW PINE OR SELECT STRUCTURAL FIR. TIMBER MATERIAL AND PRESERVATIVE TREATMENT SHALL BE IN ACCORDANCE WITH SECTION 1007 OF THE IDOT STANDARD SPECIFICATIONS (CREOSOTE OIL WILL NOT BE ALLOWED). TIMBER PLANKS SHALL BE SECURELY FASTENED WITH 1.25 IN. MINIMUM DIAMETER CARRIAGE BOLTS. A MINIMUM OF TWO BOLTS WILL BE REQUIRED AT EACH OUTER SUPPORT AND THE CENTER SUPPORT SO THAT THE TIMBER IS SUPPORTED BY THE STEEL STRUCTURE.
- 11. WELDING SHALL BE PERFORMED IN ACCORDANCE WITH "THE AMERICAN WELDING SOCIETY" (AWS). ALL WELDERS SHALL BE QUALIFIED IN ACCORDANCE WITH AWS D1.5-88 (ANSI/AASHTO/AWS D1.5-88) "BRIDGE WELDING CODE".
- 12. UNLESS OTHERWISE NOTED, WELDED CONNECTIONS SHALL BE FILLET WELDS PROPERLY SIZED TO THE THICKNESS OF THE LIGHTEST GAGE MEMBER IN THE CONNECTION AND SHALL BE DESIGNED IN ACCORDANCE WITH THE STRUCTURAL WELDING CODE STEEL ANSI/AWS D1.1. METAL THICKNESS SHALL BE IN ACCORDANCE WITH THE PROVISIONS OF ARTICLE 10.8 OF THE "AASHTO STANDARD SPECIFICATIONS FOR HIGHWAY BRIDGES", EXCEPT THAT THE MINIMUM THICKNESS OF CLOSED STRUCTURAL TUBING MEMBERS SHALL BE 0.25in.
- 13. THE PEDESTRIAN BRIDGE DESIGN SHALL BE BASED ON THE COMBINATIONS OF THE FOLLOWING LOADS WHICH WILL PRODUCE MAXIMUM CRITICAL MEMBER STRESSES.
- A. 85 psf UNIFORM LIVE LOADING ON THE FULL DECK AREA REDUCED PER "AASHTO GUIDE SPECIFICATION FOR DESIGN OF PEDESTRIAN BRIDGES", SECTION 1.2.1.1 OR ONE H-10 VEHICLE LOAD. THE LOAD SHALL BE DISTRIBUTED AS A TWO AXLE VEHICLE WITH 80% OF LOAD ON THE REAR AXLE. THE AXLES SHALL BE SPACED 14ft APART.
- B. 35 psf WIND LOAD ON THE FULL HEIGHT OF THE BRIDGE, AS IF ENCLOSED.
 C. 20 psf UPWARD FORCE APPLIED AT THE WINDWARD QUARTER POINT OF THE TRANSVERSE BRIDGE WIDTH (AASHTO 3.15.3).

- 14. BRIDGE CAMBER SHALL BE USED TO OFFSET DEAD LOAD DEFLECTION TO MATCH PROPOSED PROFILE GRADE LINE AS SHOWN ON THE PLANS. ALL VERTICAL TRUSS MEMBERS SHALL BE PERPENDICULAR TO THE GROUND (HORIZON) AFTER THE BRIDGE IS ERECTED AND DEAD LOADS APPLIED.
- 15. VERTICAL DEFLECTION DUE TO LIVE LOADS SHALL NOT EXCEED 1/500 OF SPAN LENGTH. HORIZONTAL DEFLECTION DUE TO WIND LOAD SHALL NOT EXCEED 1/500 OF SPAN LENGTH.
- 16. VIBRATIONS SHALL BE IN ACCORDANCE WITH "AASHTO GUIDE SPECIFICATIONS FOR DESIGN OF PEDESTRIAN BRIDGES". ARTICLE 1.3.2.
- 17. TOP CHORD HEIGHT SHALL BE A MINIMUM OF 3.85 feet ABOVE THE BRIDGE DECK AND SHALL SERVE AS THE TOP RAIL ON OPEN TRUSSES.
- 18. A 2 IN. x 4 IN. WOODEN RUB RAIL SHALL BE INSTALLED ON THE INSIDE OF OPEN TRUSSES AT 3.5 FEET ABOVE THE BRIDGE DECK. COST OF THE RAIL SHALL BE CONSIDERED INCLUDED IN THE CONTRACT UNIT PRICE FOR PEDESTRIAN TRUSS SUPERSTRUCTURE.
- 19. TUBULAR STEEL OR ANGLE SAFETY RAILS OF SELF-WEATHERING STEEL SHALL BE INSTALLED BELOW THE WOODEN RUB RAIL OR HANDRAIL ON THE INSIDE OF THE TRUSS. THE SAFETY RAILS SHALL BE SPACED SO THAT THE CLEAR OPENING BETWEEN RAILS DOES NOT EXCEED 6 IN.. COST OF THE RAILS SHALL BE CONSIDERED INCLUDED IN THE CONTRACT UNIT PRICE FOR PEDESTRIAN TRUSS SUPERSTRUCTURE.
- 20. A STEEL TOE PLATE OF SELF-WEATHERING STEEL SHALL BE INSTALLED ABOVE THE WOOD DECKING ON THE INSIDE OF THE TRUSS. COST OF THE PLATE SHALL BE CONSIDERED INCLUDED IN THE CONTRACT UNIT PRICE FOR PEDESTRIAN TRUSS SUPERSTRUCTURE.
- 21. THE PROFILE OF THE PATH AT THE BRIDGE INTERFACE SHALL BE COORDINATED DURING CONSTRUCTION TO PROVIDE AN ACCEPTABLE TRANSITION BETWEEN THE PATH AND THE BRIDGE.
- 22. THE CONTRACTOR SHALL VERIFY SIZE AND LOCATION OF ANCHOR BOLTS, AS PER BRIDGE MANUFACTURE'S SPECIFICATIONS, PRIOR TO ORDERING AND SETTING BOLTS INTO CAST—IN—PLACE CONCRETE CAPS OR DRILLING AND EPOXY GROUTING BOLTS INTO CONCRETE CAPS. SPACE CAP REINFORCEMENT TO MISS ANCHOR BOLTS. ANCHOR BOLTS SHALL CONFORM TO ARTICLE 1006.09 OF THE IDOT STANDARD SPECIFICATIONS.
- 23. LAYOUT OF THE SLOPE AND STREAM BANK PROTECTION SYSTEM MAY BE VARIED TO SUIT GROUND CONDITIONS IN THE FIELD OR AS DIRECTED BY THE ENGINEER. RIP RAP SHALL BE OF THE SIZE SPECIFIED ON THE PLANS AND SHALL BE IN ACCORDANCE WITH SECTION 281 OF THE IDOT STANDARD SPECIFICATIONS. EXCAVATION AND BEDDING FOR RIP RAP WILL NOT BE PAID FOR SEPARATELY BUT SHALL BE CONSIDERED AS INCLUDED IN THE CONTRACT UNIT PRICE FOR STONE RIP RAP. CLASS A5.
- 24. THE CONTRACTOR SHALL REMOVE ALL ELEMENTS OF THE EXISTING STRUCTURE(S) AS SHOWN ON THE PLANS AND IN ACCORDANCE WITH SECTION 501 OF THE IDOT STANDARD SPECIFICATIONS. ALL DEBRIS RESULTING FROM CONSTRUCTION OPERATIONS SHALL BE PROPERLY DISPOSED OF OFF-SITE. REMOVAL AND DISPOSAL OF UNSALVAGEABLE MATERIAL SHALL CONFORM TO THE REQUIREMENTS OF SECTION 202.03 OF THE IDOT STANDARD SPECIFICATIONS. THIS WORK SHALL BE CONSIDERED INCLUDED IN THE CONTRACT UNIT PRICE FOR REMOVAL OF EXISTING STRUCTURES AND NO ADDITIONAL COMPENSATION WILL BE ALLOWED.
- 25. SOIL BORING INFORMATION HAS BEEN PROVIDED BY TERRACON DATED FEBRUARY 2008 AND ASSUME A MAXIMUM NET ALLOWABLE BEARING PRESSURE OF 478.8 kPa (10ksf). IF FIELD CONDITIONS DIFFER GREATLY FROM THIS INFORMATION CONTACT THE ENGINEER.
- 26. STRUCTURE EXCAVATION SHALL BE IN ACCORDANCE WITH SECTION 502 OF THE IDOT STANDARD SPECIFICATIONS AND WILL NOT BE PAID FOR AS A SEPARATE ITEM BUT SHALL BE CONSIDERED AS INCLUDED IN THE CONTRACT UNIT PRICE FOR CONCRETE STRUCTURES OF EACH APPROPRIATE STRUCTURE.
- 27. REFER TO BRIDGE SHEETS FOR ADDITIONAL NOTES AND DETAILS.
- 28. DELIVERY OF THE PREFABRICATED BRIDGE IS ASSUMED TO BE BY NORMAL OVER-THE-ROAD TRACTOR TRAILER EQUIPMENT TO AN EASILY ACCESSIBLE LOCATION. UNLOADING OF THE DELIVERY TRUCKS (ASSUMED 3 SECTIONS), TRANSFERRING BRIDGE SECTIONS FROM ACCESSIBLE LOCATION TO POINT OF ERECTION FOR BRIDGE WILL BE AT CONTRACTORS EXPENSE AND CONSIDERED INCIDENTAL TO BRIDGE SUPERSTRUCTURE.



USER NAME:	DESIGNED:	REVISED:
	CHECKED:	REVISED:
PLOT SCALE:	DRAWN: ATH	REVISED:
PLOT DATE: 3/27/2019	CHECKED: WLK	REVISED:

SUMMARY OF QUANTITIES

CONSTRUCTION CODE 0028

*	SPECIAL	PROVISIO.
**	SPECIAL	TY ITEM

			15-00163-00-BT - FREEPORT PEC PATH		
SP	SI	ITEM#	PAY ITEM NAME	UNIT	TOTAL
*		20100110	TREE REMOVAL (6 TO 15 UNITS DIAMETER)	UNIT	536.0
*		20100210	TREE REMOVAL (OVER 15 UNITS DIAMETER)	UNIT	437.0
	**	20101400	NITROGEN FERTILIZER NUTRIENT	POUND	210.4
	**	20101500	PHOSPHORUS FERTILIZER NUTRIENT	POUND	210.4
	**	20101600	POTASSIUM FERTILIZER NUTRIENT	POUND	210.4
*		20200100	EARTH EXCAVATION	CU YD	4,944.2
		20400800	FURNISHED EXCAVATION	CU YD	1,971.6
		20700220	POROUS GRANULAR EMBANKMENT	CU YD	15.0
		20800150	TRENCH BACKFILL	CU YD	7.6
		21101615	TOPSOIL FURNISH AND PLACE, 4"	SQ YD	1,259.
	**	25000210	SEEDING, CLASS 2A	ACRE	1.0
	**	25000300	SEEDING, CLASS 3	ACRE	1.5
	**	25100125	MULCH, METHOD 3	ACRE	1.6
	**	25100630	EROSION CONTROL BLANKET	SQ YD	3,676.0
		28000250	TEMPORARY EROSION CONTROL SEEDING	POUND	467.2
		28000305	TEMPORARY DITCH CHECKS	FOOT	200.0
		28000400	PERIMETER EROSION BARRIER	FOOT	2,000.0
		28000500	INLET AND PIPE PROTECTION	EACH	24
		28100109	STONE RIP RAP, CLASS A5	SQ YD	653.0
		28100709	STONE DUMPED RIP RAP, CLASS A5	SQ YD	785.0
		28200200	FILTER FABRIC	SQ YD	1,438.0
		35101400	AGGREGATE BASE COURSE, TYPE B	TON	5,268.
*		40200800	AGGREGATE SURFACE COURSE, TYPE B	TON	458.3
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SP	SI	ITEM#	PAY ITEM NAME	UNIT	TOTAL
*		40600275	BITUMINOUS MATERIALS (PRIME COAT)	POUND	7,333.2
		40800050	INCIDENTAL HOT-MIX ASPHALT SURFACING	TON	365.0
		42400200	PORTLAND CEMENT CONCRETE SIDEWALK 5 INCH	SQ FT	2,033.2
		42400800	DETECTABLE WARNINGS	SQ FT	100.0
		44000100	PAVEMENT REMOVAL	SQ YD	404.0
		44000500	COMBINATION CURB AND GUTTER REMOVAL	FOOT	62.0
		44000600	SIDEWALK REMOVAL	SQ FT	408.0
*		44200065	PAVEMENT PATCHING, TYPE II, 6 INCH	SQ YD	10.0
*		44200069	PAVEMENT PATCHING, TYPE III, 6 INCH	SQ YD	9.0
		48101498	AGGREGATE SHOULDERS, TYPE B 4"	SQ YD	3,648.9
*		50100100	REMOVAL OF EXISTING STRUCTURES	EACH	1
		50105220	PIPE CULVERT REMOVAL	FOOT	64.0
		50300225	CONCRETE STRUCTURES	CU YD	17.0
		50800105	REINFORCEMENT BARS	POUND	2,370.0
		51201800	FURNISHING STEEL PILES HP14X73	FOOT	150.0
	•	51202305	DRIVING PILES	FOOT	150.0
		51203800	TEST PILES STEEL HP 14X73	EACH	1
*		51500100	NAME PLATES	EACH	1
		52100520	ANCHOR BOLTS, 1"	EACH	8
		54213657	PRECAST REINFORCED CONCRETE FLARED END SECTIONS 12"	EACH	2
		54213669	PRECAST REINFORCED CONCRETE FLARED END SECTIONS 24"	EACH	. 2
		54213681	PRECAST REINFORCED CONCRETE FLARED END SECTIONS 36"	EACH	1
		542A1069	PIPE CULVERTS, CLASS A, TYPE 2 24"	FOOT	100.0

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USER NAME:	DESIGNED:	REVISED:	
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PLOT SCALE:	DRAWN: ATH	REVISED:	
PLOT DATE: 3/27/2019	CHECKED: WLK	REVISED:	

STATE	0F	ILLINOIS
CITY O	F FI	REEPORT

SUMMARY OF QUANTITIES	-	SECTIO	SECTION	
FREEPORT PEC PATH	N.A.	15-00163-	00	
INELIUM ILUIAM	CITY OF	FREEPORT		
SHEET NO OF SHEETS		0.00	MOI	

SUMMARY OF QUANTITIES

CONSTRUCTION CODE 0028

*	SPECIAL	PROVISIO.
**	SPECIAL	TY ITEM

15-00163-00-BT - FREEPORT PEC PATH					
SP	SI	ITEM#	PAY ITEM NAME	UNIT	TOTAL
		542A1093	PIPE CULVERTS, CLASS A, TYPE 2 48"	FOOT	5.0
		550A0340	STORM SEWERS, CLASS A, TYPE 2 12"	FOOT	86.0
*		60609800	COMBINATION CONCRETE CURB AND GUTTER, TYPE M-6.18	FOOT	42.0
*		60610400	COMBINATION CONCRETE CURB AND GUTTER, TYPE M-6.24	FOOT	42.0
	**	66900200	NON-SPECIAL WASTE DISPOSAL	CU YD	1,671.0
	**	66900530	SOIL DISPOSAL ANALYSIS	EACH	10
	**	6690100	REGULATED SUBSTANCES PRE-CONSTRUCTION PLAN	LSUM	1
	**	66901002	ON-SITE MONITORING OF REGULATED SUBSTANCES	CAL DAY	9
	**	66901003	REGULATED SUBSTANCES FINAL CONSTRUCTION REPORT	LSUM	1
		67100100	MOBILIZATION	LSUM	1
	**	72000100	SIGN PANEL - TYPE 1	SQ FT	127.3
	**	72800100	TELESCOPING STEEL SIGN SUPPORT	FOOT	30.0
	**	73000100	WOOD SIGN SUPPORT	FOOT	405.0
	**	73100100	BASE FOR TELESCOPING STEEL SIGN SUPPORT	EACH	. 2
	**	78000400	THERMOPLASTIC PAVEMENT MARKING - LINE 6"	FOOT	80.0
	**	78000650	THERMOPLASTIC PAVEMENT MARKING - LINE 24"	FOOT	100.0
	**	78001110	PAINT PAVEMENT MARKING - LINE 4"	FOOT	1,145.0
	**	78001130	PAINT PAVEMENT MARKING - LINE 6"	FOOT	40.0
	秋本	78001180	PAINT PAVEMENT MARKING - LINE 24"	FOOT	50.0
	**	78200011	BARRIER WALL REFLECTOR, TYPE C	EACH	12
*	**	89502385	REMOVE EXISTING CONCRETE FOUNDATION	EACH	1
	**	A2000116	TREE, ACER X FREEMANII AUTUMN BLAZE (AUTUMN BLAZE FREEMAN MAPLE), 2" CALIPER, BALLED AND BURLAPPED	EACH	34

			15-00163-00-BT - FREEPORT PEC PATH		
SP	SI	ITEM#	PAY ITEM NAME	UNIT	TOTAL
	**	A2008116	TREE, TILIA CORDATA GREENSPIRE (GREENSPIRE LITTLE LEAF LINDEN), 2" CALIPER, BALLED AND BURLAPPED	EACH	34
*		X0100003	CLEARING AND GRUBBING	SQ YD	4,414.7
*		X0301797	GATE REMOVAL	EACH	2
*		X0322508	PEDESTRIAN TRUSS SUPERSTRUCTURE	SQ FT	1,482.0
*	**	X0325714	FLASHING BEACON, POST MOUNTED SOLAR POWERED INSTALLATION	EACH	2
*	**	X0327008	REMOVE AND RELOCATE SIGN (SPECIAL)	EACH	1
*		X0327036	BIKE PATH REMOVAL	SQ YD	54.0
*		X0327423	CONNECTION TO EXISTING CULVERT	EACH	1
	**	X0327979	PAVEMENT MARKING REMOVAL - GRINDING	SQ FT	7.0
*		X0350805	FOLD DOWN BOLLARDS	EACH	- 6
*		X2020105	GRADING AND SHAPING BIKEWAY	UNIT	10.3
*		X6024504	INLETS, TYPE B, WITH FRAME AND GRATE, SPECIAL	EACH	3
*		X7010216	TRAFFIC CONTROL AND PROTECTION, (SPECIAL)	LSUM	1
*		XX006345	TURBIDITY BARRIER	FOOT	.438.0
*	**	XX006653	FENCE (SPECIAL)	FOOT	359.0
*		XX006821	CONCRETE TRUCK WASHOUT	LSUM	1
*		Z0013798	CONSTRUCTION LAYOUT	LSUM	1
*		Z0022800	FENCE REMOVAL	FOOT	28.0
*		Z0055905	TEMPORARY CONSTRUCTION FENCE	FOOT	216.0
*		Z0048900	RAILROAD TRACK REMOVAL	FOOT	76.0
*		Z0064600	SELECTIVE CLEARING	ACRE	0.1
*	**	Z0078000	WOOD RAIL	FOOT	32.0

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		CHECKED:	REVISED:	
	PLOT SCALE:	DRAWN: ATH	REVISED:	
	PLOT DATE: 4/2/2019	CHECKED: WLK	REVISED:	

STATE	0F	ILLINOIS
CITY 0	F FF	REEPORT

SUMMARY OF QUANTITIES (2) $oxedsymbol{oxed}$	-	SE
FREEPORT PEC PATH	N.A.	15-001
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SHEET NO. OF SHEETS		

PAY CODE	ITEM		QUANTITY
20100110	TREE REMOV	/AL (6 TO 15 UNITS DIAMETER) OFFSET/COMMENTS	UNIT
	2004+69.8	13.2' RT	12.0
	2006+65.9	8.8' LT	14.0
	2016+64.8	8.3' LT	10.0
	2016+77.1	8.0' LT	10.0
	2017+12.7	3.8' LT	10.0
	2017+25.1	1.5' LT	8.0
	2017+35.2	1.1' LT / 2@10"	20.0
	2017+45.7	3.8' RT / 3@12"	36.0
	2024+02.7	27.7' RT	15.0
	2024+02.8	22.5' RT	15.0
	2024+04.1	18.9' RT	10.0
	2024+71.0	12.1' LT	8.0
	2024+94.3	14.0' RT	10.0
	2025+08.8	15.6' RT	10.0
	2025+10.6	11.9' RT	7.0
	2025+15.6	21.7' RT	15.0
	2025+16.9	15.2' RT	15.0
	2040+90.3	20.0' RT	6.0
	2041+51.3	15.2' RT	6.0
	2058+46.2	10.3' LT / 2@6", 9", 12"	33.0
	2058+55.3	8.1' RT	6.0
	2058+57.3	12.5' RT / 7",9",10"	26.0
	2058+58.0	12.5' LT / 2@6", 2@7", 2@ 8", 2@9"	60.0
	2058+99.0	23.3' LT / 7",8",9"	24.0
	2059+02.6	7.9' LT / 6", 15"	21.0
	2058+94.9	24.1' RT	15.0
	2059+02.3	26.9' RT / 8",9",15"	32.0
	2059+09.7	29.7' RT / 6",12"	18.0
	2059+29.4 2060+30.3	26.8' RT / 8",15" 12.4' LT	23.0 6.0
	2060+30.3	12.4° LT 41.6° RT	6.0 15.0
	2060+43.2	41.6 KT 13.3' LT	8.0
	2060+92.4	15.3 LT 15.4' LT	12.0
			12.0
	TOTAL		536.0
PAY CODE	ITEM		QUANTITY
	ITEM	/AL (OVER 15 UNITS DIAMETER) OFFSET/COMMENTS	
	TREE REMOV	OFFSET/COMMENTS	QUANTITY
	TREE REMOV STATION 2004+83.6	OFFSET/COMMENTS 11.8' RT	QUANTITY UNIT 16.0
	TREE REMOV STATION 2004+83.6 2006+71.7	OFFSET/COMMENTS 11.8' RT 10.9' LT	QUANTITY UNIT 16.0 18.0
	TREE REMOV STATION 2004+83.6 2006+71.7 2013+56.5	OFFSET/COMMENTS 11.8' RT 10.9' LT 13.4' LT FELLED TREE (3@16")	QUANTITY UNIT 16.0 18.0 48.0
	TREE REMOV STATION 2004+83.6 2006+71.7	OFFSET/COMMENTS 11.8' RT 10.9' LT	QUANTITY UNIT 16.0 18.0
	TREE REMOV STATION 2004+83.6 2006+71.7 2013+56.5 2017+58.8	OFFSET/COMMENTS 11.8' RT 10.9' LT 13.4' LT FELLED TREE (3@16") 6.3' LT	QUANTITY UNIT 16.0 18.0 48.0 16.0
	TREE REMOV STATION 2004+83.6 2006+71.7 2013+56.5 2017+58.8 2019+27.0	OFFSET/COMMENTS 11.8' RT 10.9' LT 13.4' LT FELLED TREE (3@16") 6.3' LT 20.0' LT FELLED TREE	QUANTITY UNIT 16.0 18.0 48.0 46.0 46.0 48.0
	TREE REMOV STATION 2004+83.6 2006+71.7 2013+56.5 2017+58.8 2019+27.0 2024+67.1	OFFSET/COMMENTS 11.8' RT 10.9' LT 13.4' LT FELLED TREE (3@16") 6.3' LT 20.0' LT FELLED TREE 9.9' LT	QUANTITY UNIT 16.0 18.0 48.0 16.0 48.0 39.0
	TREE REMOV STATION 2004+83.6 2006+71.7 2013+56.5 2017+58.8 2019+27.0 2024+67.1 2024+77.2	OFFSET/COMMENTS 11.8' RT 10.9' LT 13.4' LT FELLED TREE (3@16") 6.3' LT 20.0' LT FELLED TREE 9.9' LT 1.0' RT	QUANTITY UNIT 16.0 18.0 48.0 16.0 48.0 39.0 52.0
	TREE REMOV STATION 2004+83.6 2006+71.7 2013+56.5 2017+58.8 2019+27.0 2024+67.1 2024+77.2 2024+77.6	OFFSET/COMMENTS 11.8' RT 10.9' LT 13.4' LT FELLED TREE (3@16") 6.3' LT 20.0' LT FELLED TREE 9.9' LT 1.0' RT 12.1' LT	QUANTITY UNIT 16.0 18.0 48.0 16.0 48.0 39.0 52.0 24.0
	TREE REMOV STATION 2004+83.6 2006+71.7 2013+56.5 2017+58.8 2019+27.0 2024+67.1 2024+77.2 2024+77.6 2024+85.7	OFFSET/COMMENTS 11.8' RT 10.9' LT 13.4' LT FELLED TREE (3@16") 6.3' LT 20.0' LT FELLED TREE 9.9' LT 1.0' RT 12.1' LT 18.9' RT	QUANTITY UNIT 16.0 18.0 48.0 16.0 48.0 39.0 52.0 24.0 24.0
	TREE REMOV STATION 2004+83.6 2006+71.7 2013+56.5 2017+58.8 2019+27.0 2024+67.1 2024+77.2 2024+77.6 2024+80.3	OFFSET/COMMENTS 11.8' RT 10.9' LT 13.4' LT FELLED TREE (3@16") 6.3' LT 20.0' LT FELLED TREE 9.9' LT 1.0' RT 12.1' LT 18.9' RT 17.4' RT	QUANTITY UNIT 16.0 18.0 48.0 16.0 48.0 20.0
	TREE REMOV STATION 2004+83.6 2006+71.7 2013+56.5 2017+58.8 2019+27.0 2024+67.1 2024+77.6 2024+85.7 2024+90.3 2025+13.2	OFFSET/COMMENTS 11.8' RT 10.9' LT 13.4' LT FELLED TREE (3@16") 6.3' LT 20.0' LT FELLED TREE 9.9' LT 1.0' RT 12.1' LT 18.9' RT 17.4' RT 19.6' RT	QUANTITY 16.0 18.0 48.0 16.0 48.0 39.0 52.0 24.0 24.0 20.0 20.0
	TREE REMOV STATION 2004+83.6 2008+71.7 2018+56.5 2017+58.8 2019+27.0 2024+67.1 2024+77.2 2024+77.6 2024+85.7 2024+90.3 2025+13.2 2025+14.8	OFFSET/COMMENTS 11.8' RT 10.9' LT 13.4' LT FELLED TREE (3@16") 6.3' LT 20.0' LT FELLED TREE 9.9' LT 1.0' RT 12.1' LT 18.9' RT 17.4' RT 19.6' RT 11.8' RT	QUANTITY 16.0 18.0 48.0 16.0 48.0 39.0 52.0 24.0 24.0 20.0 20.0 24.0
	TREE REMOV STATION 2004+83.6 2006+71.7 2013+56.5 2017+56.8 2019+27.0 2024+67.1 2024+77.6 2024+77.6 2024+85.7 2024+90.3 2025+13.2 2025+14.8 2058+63.7	OFFSET/COMMENTS 11.8' RT 10.9' LT 13.4' LT FELLED TREE (3@16") 6.3' LT 20.0' LT FELLED TREE 9.9' LT 1.0' RT 12.1' LT 18.9' RT 17.4' RT 19.6' RT 11.8' RT 13.7' LT	QUANTITY UNIT 16.0 18.0 48.0 16.0 48.0 24.0 24.0 20.0 20.0 24.0 22.0
	TREE REMOV STATION 2004+83.6 2006+71.7 2013+56.5 2017+58.8 2019+27.0 2024+67.1 2024+77.6 2024+85.7 2024+90.3 2025+13.2 2025+14.8 2058+63.7 2059+13.8	OFFSET/COMMENTS 11.8' RT 10.9' LT 13.4' LT FELLED TREE (3@16") 6.3' LT 20.0' LT FELLED TREE 9.9' LT 1.0' RT 12.1' LT 18.9' RT 17.4' RT 19.6' RT 11.8' RT 13.7' LT 13.7' LT	QUANTITY 16.0 18.0 48.0 16.0 48.0 39.0 52.0 24.0 20.0 20.0 24.0 20.0 21.0
PAY CODE 20100210	TREE REMOV STATION 2004+83.6 2006+71.7 2013+56.5 2017+58.8 2019+27.0 2024+67.1 2024+77.6 2024+85.7 2024+90.3 2025+13.2 2025+14.8 2058+63.7 2059+13.8 2060+43.9	OFFSET/COMMENTS 11.8' RT 10.9' LT 13.4' LT FELLED TREE (3@16") 6.3' LT 20.0' LT FELLED TREE 9.9' LT 1.0' RT 12.1' LT 18.9' RT 17.4' RT 19.6' RT 11.8' RT 13.7' LT 13.7' LT	QUANTITY 16.0 18.0 48.0 16.0 48.0 39.0 52.0 24.0 24.0 20.0 20.0 22.0 17.0 30.0
	TREE REMOV STATION 2004+83.6 2006+71.7 2013+56.5 2017+58.8 2019+27.0 2024+67.1 2024+77.2 2024+77.6 2024+85.7 2024+85.7 2024+85.7 2025+13.2 2025+14.8 2058+63.7 2059+13.8 2060+43.9 2060+73.0	OFFSET/COMMENTS 11.8' RT 10.9' LT 13.4' LT FELLED TREE (3@16") 6.3' LT 20.0' LT FELLED TREE 9.9' LT 1.0' RT 12.1' LT 18.9' RT 17.4' RT 19.6' RT 11.8' RT 13.7' LT 13.7' LT	QUANTITY 16.0 18.0 48.0 16.0 48.0 39.0 52.0 24.0 20.0 20.0 20.0 24.0 17.0 30.0 19.0
20100210	TREE REMOV STATION 2004+83.6 2006+71.7 2013+56.5 2017+58.8 2019+27.0 2024+67.1 2024+77.2 2024+77.6 2024+85.7 2024+85.7 2024+85.7 2025+13.2 2025+14.8 2058+63.7 2059+13.8 2060+43.9 2060+73.0	OFFSET/COMMENTS 11.8' RT 10.9' LT 13.4' LT FELLED TREE (3@16") 6.3' LT 20.0' LT FELLED TREE 9.9' LT 1.0' RT 12.1' LT 18.9' RT 17.4' RT 19.6' RT 11.8' RT 13.7' LT 13.7' LT	QUANTITY 16.0 18.0 48.0 16.0 48.0 39.0 52.0 24.0 20.0 20.0 20.0 24.0 17.0 30.0 19.0
20100210 20100210	TREE REMOV STATION 2004+83.6 2006+71.7 2013+56.5 2017+58.8 2019+27.0 2024+67.1 2024+77.6 2024+85.7 2024+90.3 2025+13.2 2025+14.8 2058+63.7 2059+13.8 2060+43.9 2060+73.0 TOTAL	OFFSET/COMMENTS 11.8' RT 10.9' LT 13.4' LT FELLED TREE (3@16") 6.3' LT 20.0' LT FELLED TREE 9.9' LT 1.0' RT 12.1' LT 18.9' RT 17.4' RT 19.6' RT 11.8' RT 13.7' LT 13.7' LT	QUANTITY 16.0 18.0 48.0 16.0 48.0 39.0 52.0 24.0 20.0 24.0 20.0 24.0 30.0 17.0 30.0 19.0
20100210 20100210	TREE REMOV STATION 2004+83.6 2006+71.7 2013+56.5 2017+58.8 2019+27.0 2024+67.1 2024+77.6 2024+85.7 2024+90.3 2025+13.2 2025+14.8 2060+43.9 2060+73.0 TOTAL ITEM NITROGEN F STATION	OFFSET/COMMENTS 11.8' RT 10.9' LT 13.4' LT FELLED TREE (3@16") 6.3' LT 20.0' LT FELLED TREE 9.9' LT 1.0' RT 12.1' LT 18.9' RT 17.4' RT 19.6' RT 11.8' RT 13.7' LT 13.7' LT 13.0' LT 19.0' LT	QUANTITY 16.0 18.0 48.0 16.0 48.0 39.0 52.0 24.0 20.0 24.0 20.0 24.0 30.0 17.0 30.0 19.0 437.0 QUANTITY
	TREE REMOV STATION 2004+83.6 2006+71.7 2013+56.5 2017+56.8 2019+27.0 2024+67.1 2024+77.2 2024+77.6 2024+85.7 2024+90.3 2025+13.2 2025+13.2 2025+13.2 2025+13.0 TOTAL ITEM NITROGEN F STATION 1999+58.0	OFFSET/COMMENTS 11.8' RT 10.9' LT 13.4' LT FELLED TREE (3@16") 6.3' LT 20.0' LT FELLED TREE 9.9' LT 1.0' RT 12.1' LT 18.9' RT 17.4' RT 19.6' RT 11.8' RT 13.7' LT 13.7' LT 13.0' LT 19.0' LT ERTILIZER NUTRIENT OFFSET 2000+03.0 LT/RT	QUANTITY UNIT 16.0 18.0 48.0 16.0 48.0 39.0 52.0 24.0 20.0 20.0 24.0 22.0 17.0 30.0 19.0 QUANTITY POUNDS 0.7
20100210 20100210	TREE REMOV STATION 2004+83.6 2006+71.7 2013+56.5 2017+58.8 2019+27.0 2024+67.1 2024+77.6 2024+85.7 2024+90.3 2025+13.2 2025+14.8 2060+43.9 2060+73.0 TOTAL ITEM NITROGEN F STATION	OFFSET/COMMENTS 11.8' RT 10.9' LT 13.4' LT FELLED TREE (3@16") 6.3' LT 20.0' LT FELLED TREE 9.9' LT 1.0' RT 12.1' LT 18.9' RT 17.4' RT 19.6' RT 11.8' RT 13.7' LT 13.7' LT 13.0' LT 19.0' LT	QUANTITY 16.0 18.0 48.0 16.0 48.0 39.0 52.0 24.0 20.0 24.0 20.0 24.0 30.0 17.0 30.0 19.0 437.0 QUANTITY
20100210 20100210	TREE REMOV STATION 2004+83.6 2006+71.7 2013+56.5 2017+58.8 2019+27.0 2024+67.1 2024+77.2 2024+77.6 2024+80.3 2025+14.8 2059+63.7 2059+13.8 2060+73.0 TOTAL ITEM NITROGEN F STATION 1999+58.0 2002+46.0	OFFSET/COMMENTS 11.8' RT 10.9' LT 13.4' LT FELLED TREE (3@16") 6.3' LT 20.0' LT FELLED TREE 9.9' LT 1.0' RT 12.1' LT 18.9' RT 17.4' RT 19.6' RT 11.8' RT 13.7' LT 13.7' LT 13.0' LT 19.0' LT ERTILIZER NUTRIENT OFFSET 2000+03.0 LT/RT 2028+59.0	QUANTITY UNIT 16.0 18.0 48.0 16.0 48.0 20.0 24.0 20.0 24.0 20.0 24.0 30.0 19.0 437.0 QUANTITY POUNDS 0.7 67.8
20100210 20100210	TREE REMOV STATION 2004+83.6 2006+71.7 2013+56.5 2017+58.8 2019+27.0 2024+67.1 2024+77.6 2024+77.6 2024+85.7 2024+90.3 2025+14.8 2055+13.2 2055+13.8 2060+73.0 TOTAL ITEM NITROGEN F STATION 1999+58.0 2002+46.0 2039+08.0 SHERIDAN A	OFFSET/COMMENTS 11.8' RT 10.9' LT 13.4' LT FELLED TREE (3@16") 6.3' LT 20.0' LT FELLED TREE 9.9' LT 1.0' RT 12.1' LT 18.9' RT 17.4' RT 19.6' RT 11.8' RT 13.7' LT 13.7' LT 13.0' LT 19.0' LT ERTILIZER NUTRIENT OFFSET 2000+03.0 LT/RT 2028+59.0 2123+00.0 VE	QUANTITY UNIT 16.0 18.0 48.0 16.0 48.0 39.0 52.0 24.0 20.0 20.0 22.0 17.0 30.0 19.0 QUANTITY POUNDS 0.7 67.8 135.3
20100210 20100210	TREE REMOV STATION 2004+83.6 2006+71.7 2013+56.5 2017+58.8 2019+27.0 2024+67.1 2024+77.6 2024+85.7 2024+90.3 2025+13.2 2025+13.8 2058+63.7 2059+13.8 2060+73.0 TOTAL ITEM NITROGEN F STATION 1999+58.0 2002+46.0 2039+08.0	OFFSET/COMMENTS 11.8' RT 10.9' LT 13.4' LT FELLED TREE (3@16") 6.3' LT 20.0' LT FELLED TREE 9.9' LT 1.0' RT 12.1' LT 18.9' RT 17.4' RT 19.6' RT 11.8' RT 13.7' LT 13.7' LT 13.0' LT 19.0' LT ERTILIZER NUTRIENT OFFSET 2000+03.0 LT/RT 2028+59.0 2123+00.0	QUANTITY UNIT 16.0 18.0 48.0 16.0 48.0 20.0 24.0 20.0 24.0 20.0 24.0 30.0 19.0 437.0 QUANTITY POUNDS 0.7 67.8

PAY CODE				
20101500	PHOSPHOROL STATION	JS FERTILIZER	NUTRIENT OFFSET	POUNDS
	2002+46.0	2000+03.0 2028+59.0 2123+00.0	LT/RT	0.7 67.8 135.3
	SHERIDAN AV 0+00.0	E 2+79.0		6.6
	TOTAL			210.4
PAY CODE	ITEM			QUANTIT
20101600	POTASSIUM F STATION	ERTILIZER NU	TRIENT OFFSET	POUNDS
	2002+46.0	2000+03.0 2028+59.0 2123+00.0	LT/RT	0.7 67.8 135.3
	SHERIDAN AV 0+00.0	E 2+79.0		6.6
	TOTAL			210.4
PAY CODE	ITEM			QUANTIT
	DODOUS CDAN	IULAR EMBAN	KMENT	
20700220	STATION		OFFSET	CU YD
20700220			OFFSET WEST ABUTMENT EAST ABUTMENT	7.5 7.5
20700220	STATION 2059+08.5		WEST ABUTMENT	7.5
20700220	STATION 2059+08.5 2060+32.0		WEST ABUTMENT	7.5 7.5 15.0
	STATION 2059+08.5 2060+32.0 TOTAL	FILL	WEST ABUTMENT	7.5 7.5 15.0
PAY CODE	STATION 2059+08.5 2060+32.0 TOTAL ITEM TRENCH BACKI	FILL	WEST ABUTMENT EAST ABUTMENT	7.5 7.5 15.0 QUANTIT
PAY CODE	STATION 2059+08.5 2060+32.0 TOTAL ITEM TRENCH BACKI STATION 2018+45.3 2023+84.1	FILL	WEST ABUTMENT EAST ABUTMENT	7.5 7.5 15.0 QUANTIT CU YD 3.1 2.4
PAY CODE	STATION 2059+08.5 2060+32.0 TOTAL ITEM TRENCH BACKI STATION 2018+45.3 2023+84.1 2024+82.3	FILL	WEST ABUTMENT EAST ABUTMENT	7.5 7.5 15.0 QUANTIT CU YD 3.1 2.4 2.1
PAY CODE 20800150	STATION 2059+08.5 2060+32.0 TOTAL ITEM TRENCH BACKI STATION 2018+45.3 2023+84.1 2024+82.3 TOTAL		WEST ABUTMENT EAST ABUTMENT OFFSET	7.5 7.5 15.0 QUANTIT CU YD 3.1 2.4 2.1
PAY CODE 20800150 PAY CODE	STATION 2059+08.5 2060+32.0 TOTAL ITEM TRENCH BACKI STATION 2018+45.3 2023+84.1 2024+82.3 TOTAL ITEM TOPSOIL FURN STATION 1999+58.0 1999+58.0	ISH AND PLAC 2000+03.5 2000+03.5	WEST ABUTMENT EAST ABUTMENT OFFSET E, 4" OFFSET LT RT	7.5 7.5 15.0 QUANTIT CU YD 3.1 2.4 2.1 7.6 QUANTIT SQ YD 10.5 9.7
PAY CODE 20800150 PAY CODE	STATION 2059+08.5 2060+32.0 TOTAL ITEM TRENCH BACKI STATION 2018+45.3 2023+84.1 2024+82.3 TOTAL ITEM TOPSOIL FURN STATION 1999+58.0	ISH AND PLAC 2000+03.5	WEST ABUTMENT EAST ABUTMENT OFFSET E, 4" OFFSET LT RT LT	7.5 7.5 15.0 QUANTIT CU YD 3.1 2.4 2.1 7.6 QUANTIT
PAY CODE 20800150 PAY CODE	STATION 2059+08.5 2060+32.0 TOTAL ITEM TRENCH BACKI STATION 2018+45.3 2023+84.1 2024+82.3 TOTAL ITEM TOPSOIL FURN STATION 1999+58.0 1999+58.0 2002+49.9 SHERIDAN	2000+03.5 2000+03.5 SHERIDAN 2023+73.0	WEST ABUTMENT EAST ABUTMENT OFFSET LT RT LT LT	7.5 7.5 15.0 QUANTIT CU YD 3.1 2.4 2.1 7.6 QUANTIT SQ YD 10.5 9.7 420.3 163.6
PAY CODE 20800150 PAY CODE	STATION 2059+08.5 2060+32.0 TOTAL ITEM TRENCH BACKI STATION 2018+45.3 2023+84.1 2024+82.3 TOTAL ITEM TOPSOIL FURN STATION 1999+58.0 1999+58.0 2002+49.9	ISH AND PLAC 2000+03.5 2000+03.5 SHERIDAN	WEST ABUTMENT EAST ABUTMENT OFFSET E, 4" OFFSET LT RT LT	7.5 7.5 15.0 QUANTIT CU YD 3.1 2.4 2.1 7.6 QUANTIT SQ YD 10.5 9.7 420.3

PAY CODE	ITEM			QUANTITY
25000210	SEEDING, CLASS STATION	 S 2A	OFFSET	ACRE
		2000+03.0 2028+59.0	LT/RT LT/RT	0.1 0.8
	SHERIDAN AVE 0+00.0	2+79.0	LT/RT	0.1
	TOTAL			1.0
PAY CODE	ITEM			QUANTIT
25000300	SEEDING, CLASS STATION	3 3	OFFSET	ACRE
	2039+08.0	2123+00.0	LT/RT	1.5
	TOTAL			1.5
PAY CODE	ITEM			QUANTIT
25100125	MULCH, METHOE STATION) 3	OFFSET	ACRE
	2039+08.0	2123+00.0	LT/RT	1.5
	SHERIDAN AVE 0+00.0	2+79.0	LT/RT	0.1
	TOTAL			1.6
PAY CODE	ITEM			QUANTIT
25100630	EROSION CONTR	OL BLANKET	OFFSET	SQ YD
		2000+03.0 2028+59.0	LT/RT	32.8 3,643.2
	TOTAL			3,676.0
PAY CODE	ITEM			QUANTIT
28000250	TEMPORARY ER	OSION CONTRO	DL SEEDING OFFSET	POUNDS
	2002+46.0	2000+03.0 2028+59.0 2123+00.0	LT/RT LT/RT LT/RT	1.4 150.6 300.6
	SHERIDAN AVE 0+00.0	2+79.0	LT/RT	14.6

EARTHWORK SCHEDULE LOCATED ON SHEETS 43 & 44



USER NAME:	DESIGNED:	REVISED:
	CHECKED:	REVISED:
PLOT SCALE:	DRAWN: ATH	REVISED:
PLOT DATE: 3/27/2019	CHECKED: WLK	REVISED:

STATE	0F	ILLINOIS
CITY 0	F FF	REEPORT

SCHEDULE OF QUANTITIES FREEPORT PEC PATH		SECTION	COUNTY	TOTAL SHEETS	SHEE NO.
		15-00163-00-BT	STEPHENSON	92	06
		FREEPORT	CONTRACT N	0. 856.	74
SHEET NO. OF SHEETS		ILLINOIS SED A	UD DROJECT -		

_	PAY CODE	ITEM			QUANTITY
	28000400	PERIMETER EROSION BARRIER STATION 2016+00.0 2026+00.0		OFFSET/DESCRIPTION 17' RT & VAR	FOOT 2,000.0
		TOTAL			2,000.0

PAY CODE	ITEM		QUANTITY
28000500	INLET AND PIPE PROTECTION		
	STATION	OFFSET	EACH
	2017+96.3	39.8 LT	1
	2018+73.6	27.6 RT	1
	2019+26.9	20.1' RT	1
	2023+82.9	13.9' LT	1
	2023+86.1	22.5 RT	1
	2024+79.2	36.8 RT	1
	2024+84.5	11.8' LT	1
	2080+84.4	32.7' RT	1
	2081+18.0	31.6' RT	1
	2081+20.5	45.8' RT	1
	2081+21.2	18.2' RT	1
	2087+89.4	39.8' LT	1
	2087+95.4	49.72' RT	1
	2088+00.5	49.6' RT	1
	2097+49.0	21.0' LT	1
	2097+49.0	21.0' RT	1
	2111+14.1	25.1' LT	1
	2111+15.6	21.8' RT	1
	2118+56.2	9.1' LT	1
	2118+56.2	10.9' RT	1
	2122+33.7	20.0' RT	1
	2122+53.7	20.0' RT	1
	2122+45.2	20.0' LT	1
	2122+65.2	20.0' LT	1
	TOTAL		24

28100109	STONE RIP R	AP, CLASS A5	OFFSET	SQ YD
	2018+63.0	2019+55.7	31.8' RT	283.0
	2023+73.7	2024+09.9	7.0' LT	40.0
	2023+73.7	2024+89.0	13.1' RT	330.0
	TOTAL			653.0
PAY CODE	ITEM			QUANTITY
28100709	STONE DUMF	PED RIP RAP, CLA	ASS A5	
	STATION		OFFSET	SQ YD
	2059+08.5	2060+32.0	BRIDGE #103	785.0
	TOTAL			785.0

PAY CODE	ITEM			QUANTITY
TAT GODE	110141			20/111111
28200200 FILTER FABRIC				
	STATION		OFFSET	SQ YD
	2018+63.0	2019+55.7	31.8' RT	283.0
	2023+73.7	2024+09.9	7.0' LT	40.0
	2023+73.7	2024+89.0	13.1' RT	330.0
	2059+08.5	2060+32.0	BRIDGE #103	785.0
	TOTAL			1,438.0
PAY CODE	ITEM			QUANTITY
35101400	AGGREGATE BA	ASE COURSE,	ТҮРЕ В	
	STATION		OFFSET	TONS
	1999+58.00	2000+03.48	PATH	23.8
	2000+03.48	2000+11.39	PAD	8.7
	2000+56.54	2000+67.27	PAD	10.7
	2002+45.48	2018+71.00	PATH	849.6
	SHERIDAN ACCI	ESS	PATH	132.6
	SHERIDAN ACCI	ESS RAMP	PAD	7.0
	SHERIDAN INTE	RSECTION	PATH	35.8
	2019+12.67	2023+73.73	PATH	241.0
	2023+73.73	2024+60.61	HANCOCK BRIDGE	30.3
	2024+60.61	2028+59.48	PATH	208.5
	2028+59.48	2028+69.09	PAD	2.5
	2039+08.31	2059+08.50	PATH	995.7
	2060+32.00	2080+73.15	PATH	1,016.0
	2080+73.15	2080+88.53	PAD	3.8
	STRUCTO RD IN	TERSECTION	PATH	31.0
	2081+08.60	2081+23.99	PAD	3.8
	2081+23.99	2081+73.99	PATH	24.9
	2081+73.99	2087+89.98	PATH	245.3
	2087+89.98	2123+00.00	PATH	1,397.8
	TOTAL			5,268.7
PAY CODE	ITEM			QUANTITY
40200800	AGGREGATE SU	JRFACE COUR		
	STATION		OFFSET/COMMENT	TONS
	2039+08.0	2059+08.5	*10' PATH	124.0
	2060+32.0	2080+89.0	*10' PATH	126.8
	2081+09.0	2087+90.0	*8' PATH	33.5
	2001100.0	2007 - 00.0	0 171111	

	2061+09.0	2007+90.0	o PAIN	33.5
	2088+04.0	2123+00.0	*8' PATH	174.0
	TOTAL			458.3
PAY CODE	ITEM			QUANTITY
40600275	BITUMINOUS	MATERIALS (PRI	ME COAT)	
	STATION		OFFSET	POUNDS
	1999+58.0	2000+03.0		113.7
	2002+46.0	2023+74.0		5,322.7
	2024+61.0	2028+59.0		1,032.9
	STRUCTO RD			155.7
	0+00.0	2+72.2	SHERDIAN AVE	708.2
	TOTAL			7,333.2

PAY CODE	ITEM			QUANT
40800050	INCIDENTAL HOSTATION	OT-MIX ASPHAL	T SURFACING OFFSET	TONS
	1999+58.0	2000+03.0		6.0
	2002+46.0	2023+74.0		265.0
	2024+61.0	2028+59.0		51.0
	STRUCTO RD			8.0
	0+00.0	2+72.2	SHERDIAN AVE	35.0
	TOTAL			365.0
PAY CODE	ITEM			QUANT
42400200	PORTLAND CE	MENT CONCRE	TE SIDEWALK - 5 INCH	
	STATION		OFFSET	SQ F
	2000+03.5	2000+11.5	STEPHENSON ST NORTH	174.0
	2000+56.6	2000+64.7	STEPHENSON ST SOUTH	234.0
	2023+73.7	2024+60.6	HANCOCK BRIDGE	1,216
	2028+59.5	2028+69.1	ALBUM ST	100.9
	2080+73.1	2028+88.5	STRUCTO RD WEST	153.5
	2081+08.6	2081+24.0	STRUCTO RD EAST	153.9
	TOTAL			2,033
PAY CODE	ITEM			QUANT
42400800	DETECTABLE STATION	WARNINGS	OFFSET	SQ F
	SIATION		OFFSET	301
	2000+09.4	2000+11.4	LT/RT	20.0
	2000+56.4	2000+58.4	LT/RT	20.0
	2028+64.6	2028+66.6	LT/RT	20.0
	2080+86.2	2080+88.2	STRUCTO RD STRUCTO RD	20.0
	2081+09.0 TOTAL	2081+11.0	STRUCTO RD	20.0
	IOIAL			100.
PAY CODE	ITEM			QUANT
44000100	PAVEMENT RE	EMOVAL		
	STATION		OFFSET	SQ Y
	2027+44.3	2028+52.0	20.0' RT (CONCRETE)	189.
	2028+54.6	2028+90.0	9.6' LT - 7.6' RT (HMA)	25.0
	2039+08.3	2040+12.5	0' LT - 25.2' LT (HMA)	190.
	TOTAL			404.
PAY CODE	ITEM			QUANT
44000500	COMBINATION STATION	CURB AND GU	TTER REMOVAL OFFSET	FOO'
	2000+13.9		LT/RT	22.0
	2000+54.1		LT/RT	20.0
	2028+54.5	2028+74.0	11.5' LT	20.0
	2020+34.5			
	TOTAL			62.0



PAY CODE ITEM

USER NAME:	DESIGNED:	REVISED:
	CHECKED:	REVISED:
PLOT SCALE:	DRAWN: ATH	REVISED:
PLOT DATE: 3/27/2019	CHECKED: WLK	REVISED:

QUANTITY

STATE	0F	ILLINOIS
CITY 0	F FI	REEPORT

SCHEDULE OF QUANTITIES (2) FREEPORT PEC PATH		SECTION	COUNTY	TOTAL SHEETS	SHEL
		15-00163-00-BT	STEPHENSON	92	07
		FREEPORT	CONTRACT N	0. 8567	74
SHEET NO. OF SHEETS		ILLINOIS FED. A	ND PROJECT -		

### AUTOMOSE SIDEWALK REMOVAL STATION OFFSET 174 of 223 of 2000+84.7 LTRT 174 of 223 of 2000+86.8 2000+84.7 LTRT 174 of 223 of 2000+86.8 2000+84.7 LTRT 174 of 223 of 2000+86.8 2000+84.7 LTRT 174 of 408.0 of 2200+84.7 LTRT 174 of 408.0 of 2200+84.1 LTRT 5.0 of 2000+84.1 LTRT 1.0 of 2000+84.1 LTRT 1.0 of 2000+84.1 LTRT 1.0 of 2000+84.1 LTRT 2.0 of 84.1 LTRT 2.0 of 8	PAY CODE	ITEM				QUANTITY
PAY CODE TIEM	44000600			OFFSET		SQ FT
PAY CODE TIEM						
A420065		TOTAL				408.0
STATION	PAY CODE	ITEM				QUANTITY
PAY CODE TIEM COUNTITY	44200065		TYPE II,			SQ YD
PAY CODE TEM QUANTITY						
A4200069		TOTAL				10.0
STATION	PAY CODE	ITEM				QUANTITY
TOTAL 9.0	44200069		TYPE III,			SQ YD
PAY CODE ITEM QUANTITY 48101498		SE QUAD OF HANCOCK	C AND AL	BUM		9.0
### AGGREGATE SHOULDERS, TYPE B 4"		TOTAL				9.0
STATION	PAY CODE	ITEM				QUANTITY
2039+08.0 2059+08.5 RT	48101498		RS, TYPE			SQ YD
2060+32.0 2080+89.0 LT 454.5 2080+32.0 2080+89.0 RT 454.0 2081+99.0 2087+90.0 LT 151.5 2081+09.0 2087+90.0 LT 151.7 776.9 2088+04.0 2123+00.0 RT 2088+04.0 2088+04.0 2123+00.0 RT 2088+04.0 20						
2060+32.0 2080+89.0 RT 454.0 2081+09.0 2087+90.0 LT 151.5 15						
2081+09.0 2087+90.0 RT 151.7 776.9 2088+04.0 2123+00.0 RT 776.9 77		2060+32.0 2080+8	9.0	RT		454.0
2088+04.0 2123+00.0 RT 776.9						
2088+04.0 2123+00.0 RT 776.9						
PAY CODE ITEM QUANTITY 50100100 REMOVAL OF EXISTING STRUCTURES STATION COMMENTS EACH 2058+76.0 EX BRIDGE #102 1 TOTAL 1 PAY CODE ITEM QUANTITY 50105220 PIPE CULVERT REMOVAL STATION OFFSET STATION OFFSET FOOT 2017+97.1 40.5' LT 2018+47.7 1.0' RT 64.0 PAY CODE ITEM QUANTITY 50300225 CONCRETE STRUCTURES STATION OFFSET CU YD 2059+08.5 2060+32.0 BRIDGE #103 17.0						
REMOVAL OF EXISTING STRUCTURES STATION COMMENTS EACH		TOTAL				3,648.9
STATION COMMENTS EACH	PAY CODE	ITEM				QUANTITY
2058+76.0 EX BRIDGE #102 1	50100100					FACIL
TOTAL 1 1 1 1 1 1 1 1 1						
50105220				EX BRIDGE #102		
S10105220						
STATION OFFSET STATION OFFSET FOOT	PAY CODE	ITEM				QUANTITY
### TOTAL 64.0 PAY CODE ITEM QUANTITY 50300225	50105220			STATION	OFFSET	FOOT
PAY CODE ITEM QUANTITY 50300225 CONCRETE STRUCTURES STATION OFFSET CU YD 2059+08.5 2060+32.0 BRIDGE #103 17.0			5' LT	2018+47.7	1.0' RT	64.0
50300225 CONCRETE STRUCTURES STATION OFFSET CU YD 2059+08.5 2060+32.0 BRIDGE #103 17.0		TOTAL				64.0
STATION OFFSET CU YD 2059+08.5 2060+32.0 BRIDGE #103 17.0	PAY CODE	ITEM				QUANTITY
	50300225		ES	OFFSET		CU YD
TOTAL 17.0		2059+08.5 2060+	32.0	BRIDGE #103		17.0
		TOTAL				17.0

QUANTITY
POUND
2,370.0
2,370.0
QUANTITY
FOOT
150.0
150.0
QUANTITY
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PAY CODE	ITEM				QUANTITY
54213657	PRECAST REINF STATION	SECTIONS 12"	EACH		
	2023+86.1 2024+79.2		22.5 RT 36.8 RT		1 1
	TOTAL				2
PAY CODE	ITEM				QUANTITY
54213669	PRECAST REINF	ORCED CONCE	RETE FLARED END OFFSET	SECTIONS 24"	EACH
	2017+96.3 2018+73.6		39.8 LT 27.6 RT		1 1
	TOTAL				2
PAY CODE	ITEM				QUANTITY
54213681	PRECAST REINF	ORCED CONCR	RETE FLARED END OFFSET	SECTIONS 36"	EACH
	2019+26.9		20.1' RT		1
	TOTAL				1
PAY CODE	ITEM				QUANTITY
542A1069	PIPE CULVERT				
	STATION	OFFSET	STATION	OFFSET	FOOT
	2017+96.3	39.8 LT	2018+73.6	27.6 RT	100.0
	TOTAL				100.0
PAY CODE	ITEM				QUANTITY
542A1093	PIPE CULVERT STATION	S, CLASS A, T OFFSET	YPE 2 48" STATION	OFFSET	FOOT
	2111+14.1	25.1 LT	2111+14.2	20.1 LT	5.0
	TOTAL				5.0
PAY CODE	ITEM				QUANTITY
550A0340	STORM SEWER	RS, CLASS A, 1 OFFSET	TYPE 2 12" STATION	OFFSET	FOOT
	2023+84.0	17.1 LT	2023+83.6	15.8 LT	5.0
	2023+83.1 2024+84.0	11.9 LT 9.9 LT	2023+86.1 2024+79.2	22.5 RT 36.8 RT	34.0 47.0
		0.0 21	202 11 10.2	00.0111	
	TOTAL				86.0



USER NAME:	DESIGNED:	REVISED:
	CHECKED:	REVISED:
PLOT SCALE:	DRAWN: ATH	REVISED:
PLOT DATE: 3/27/2019	CHECKED: WLK	REVISED:

STATE	0F	ILLINOIS
CITY 0	F FI	REEPORT

SCHEDULE OF QUANTITIES (3)	_	SECTION	COUNTY	TOTAL SHEETS	SHEE NO
FREEPORT PEC PATH	N.A.	15-00163-00-BT	STEPHENSON	92	08
THEELONI TEOTATH	CITY OF	FREEPORT	CONTRACT N	0. 8567	74
SHEET NO. OF SHEETS		ILLINOIS FED A	ID PROJECT -		

PAY CODE	ITEM			QUANTITY
60609800	COMBINATION STATION	CONCRETE CUR	RB AND GUTTER, TYPE M-6.18 OFFSET	FOOT
	2028+54.5 SE QUAD OF I	2028+74.0 HANCOCK AND A	11.5' LT ALBUM	20.0 22.0
	TOTAL			42.0
PAY CODE	ITEM			QUANTITY
60610400	COMBINATION STATION	CONCRETE CUR	RB AND GUTTER, TYPE M-6.24 OFFSET	FOOT
	2000+11.4 2000+56.6		E STEPHENSON ST E STEPHENSON ST	22.0 20.0
	TOTAL			42.0
PAY CODE	ITEM			QUANTITY
72000100	SICNI DANIEI	TVDE 1		
72000100	SIGN PANEL STATION	OFFSET	SIGN TYPE	SQ FT
	2000+02.4	265.3' LT	W11-15	6.25
	2000+02.6	15.3' LT	W11-15	6.25
	2000+02.6 2000+58.7	15.3' LT 267.2' RT	W16-7P W11-15	2.00 6.25
	2000+56.7	267.2 KT 17.2' RT	W11-15	6.25
	2000+59.1	17.2' RT	W16-7P	2.00
	2000+70.8	10.9' LT	R1-1	2.25
	2002+50.5 2002+81.8	RT LT	R5-3 R1-2	4.00 2.25
	2002+61.6	RT	W1-2L	2.25
	2026+01.3	LT	W1-2R	2.25
	2028+59.9	RT	R1-1	2.25
	2028+59.9	RT	D11-1	3.00
	2028+59.9 2029+50.0	RT LT	M6-1 D11-1	0.75 3.00
	2029+50.0	LT	M6-1	0.75
	2032+00.0	RT	D11-1	3.00
	2032+00.0	RT	M6-3	0.75
	2032+00.0 2032+00.0	LT LT	D11-1 M6-3	3.00 0.75
	2034+20.0	RT	D11-1	3.00
	2034+20.0	RT	M6-3	0.75
	2034+20.0	LT	D11-1	3.00
	2034+20.0 2037+75.0	LT RT	M6-3 W14-2	0.75 4.00
	2037+75.0	RT	D11-1	3.00
	2037+75.0	RT	M6-3	0.75
	2039+08.3	LT	D11-1	3.00
	2039+08.3	LT DT	M6-2	0.75
	2039+08.3 2039+08.3	RT RT	D11-1 M6-2	3.00 0.75
	2039+08.3	RT	R5-3	4.00
	2080+75.0	LT	R5-3	4.00
	2080+81.0	RT	R1-1	2.25
	2081+19.8 2081+22.6	LT RT	R1-1 R5-3	2.25 4.00
	2081+22.6	RT	W5-4A	2.25
	2107+50.5	LT	W11-15	2.25
	2107+50.5	LT	W11-15P	1.50
	2107+70.5 2107+70.5	RT RT	W11-15 W11-15P	2.25 1.50
	2112+36.9	LT	W11-15	2.25
	2112+36.9	LT	W11-15P	1.50
	2112+65.3	RT	W11-15	2.25
	2112+65.3	RT	W11-15P	1.50
	2122+38.3 2122+38.3	LT LT	W11-15 W11-15P	2.25 1.50
	2122+57.8	RT	W11-15	2.25
	2122+57.8	RT	W11-15P	1.50
	SHERIDAN AL 0+20.7	LIGNMENT RT	R5-3	4.00
		171		
	TOTAL			127.3

PAY CODE	ITEM		QUANTITY
72800100	TELESCOPING STEEL SIGN STATION	SUPPORT OFFSET	FOOT
	2000+58.7 2000+59.1	267.2' RT 17.2' RT	15.0 15.0
	TOTAL		30.0
PAY CODE	ITEM		QUANTITY
73000100	WOOD SIGN SUPPORT STATION	OFFSET	FOOT
	2000+02.4	265.3' LT	15.0
	2000+02.6	15.3' LT	15.0
	2000+70.8 2002+50.5	10.9' LT RT	15.0 15.0
	2002+81.8	LT	15.0
	2024+53.7	RT	15.0
	2026+01.3	LT	15.0
	2028+59.9	RT	15.0
	2029+50.0	LT	15.0
	2032+00.0	LT	15.0
	2032+00.0	RT	15.0
	2034+20.0	LT	15.0
	2034+20.0	RT	15.0
	2037+75.0	RT	15.0
	2039+08.3	LT	15.0
	2039+08.3	RT LT	15.0
	2080+75.0 2080+81.0	RT	15.0 15.0
	2081+19.8	LT	15.0
	2081+22.6	RT	15.0
	2107+50.5	LT	15.0
	2107+70.5	RT	15.0
	2112+36.9	LT	15.0
	2112+65.3	RT	15.0
	2122+38.3	LT	15.0
	2122+57.8	RT	15.0
	OUEDIDAN ALIONIMENT		
	SHERIDAN ALIGNMENT 0+20.7	RT	15.0
	TOTAL		405.0
	TOTAL		405.0
PAY CODE	ITEM.		QUANTITY
- PAT CODE	ITEM		QUANTITY
73100100	BASE FOR TELESCOPING S' STATION	TEEL SIGN SUPPORT OFFSET	EACH
	2000+58.7 2000+59.1	267.2' RT 17.2' RT	1 1
	TOTAL		2
PAY CODE	ITEM		QUANTITY
78000400	THERMOPLASTIC PAVEMEN STATION	T MARKING - LINE 6" OFFSET/COMMENTS	FOOT
	2000+13.9 2000+54.1	CROSSWALK	80.0
	TOTAL		80.0

7800650	THERMOPLASTI	C PAVEMENT	MARKING - LINE 24"	
700000	STATION	017112	OFFSET/COMMENTS	FOO ⁻
	2000+13.9	2000+54.1	CROSSWALK	100.0
	TOTAL			100.0
PAY CODE	ITEM			QUANT
78001110	PAINT PAVEMEI	NT MARKING -	LINE 4"	
	STATION		OFFSET/COMMENTS	FOO'
	1999+58.0 2000+65.0	2000+03.5 2002+46.0	CENTERLINE 3' DASH/9' SKIP LT & RT / EDGE LINE	12.0 362.0
	2000+65.0	2028+59.5	CENTERLINE 3' DASH/9' SKIP	699.0
	SHERDIAN AVE 0+00.0	2+79.0	CENTERLINE 3' DASH/9' SKIP	72.0
	TOTAL			1,145.
PAY CODE	ITEM			QUANT
78001130	PAINT PAVEMEI	NT MARKING -	LINE 6"	
	STATION		OFFSET/COMMENTS	F00
	2080+88.9	2081+08.9	CROSSWALK	40.0
	TOTAL			40.0
PAY CODE	ITEM			QUANT
78001180	PAINT PAVEMEI	NT MARKING -	LINE 24"	
	STATION		OFFSET/COMMENTS	FOO
	2080+88.9	2081+08.9	CROSSWALK	50.0
	TOTAL			50.0
PAY CODE	ITEM			QUANT
78200011	BARRIER WALL STATION	REFLECTOR,	TYPE C OFFSET/COMMENTS	EAC
	2059+08.5	2060+32.0	BRIDGE #103	12
	TOTAL			12
PAY CODE	ITEM			QUANT
PAY CODE 89502385	ITEM REMOVE EXISTI	NG CONCRETI	E FOUNDATION	QUANT
		NG CONCRETI	E FOUNDATION OFFSET	
	REMOVE EXISTI	NG CONCRETI		QUANT EACI 1



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120 S 1ST STREET PH: 815.956.6400		CHECKED:	REVISED:
ROCKFORD, IL 61350 www.imegcorp.com FORMERLY	PLOT SCALE:	DRAWN: ATH	REVISED:
McClure	PLOT DATE: 3/27/2019	CHECKED: WLK	REVISED:
FILE NAME AND PATH: \\AD.KJWW.COM\KJWW\K	JWW\OFFICES\MCCLURE\ROCKFORD\PROJECTS\H—DRIVE TF	RANS\14-054-PECPATH-FREEPORT\DESIGN\DRA	WINGS\14-054 QUANTITIES.DWG

STATE	0F	ILLINOIS
CITY O	F FI	REEPORT

SCHEDULE OF QUANTITIES (4)	_	SECTION	COUNTY	TOTAL SHEETS	SHEE NO
FREEPORT PEC PATH	N.A.	15-00163-00-BT	STEPHENSON	92	09
THEELONI TEOTATH	CITY OF	FREEPORT	CONTRACT N	0. 8567	74
SHEET NO. OF SHEETS		ILLINOIS FED A	ID PROJECT -		

PAY CODE	ITEM			QUANTITY
A2000116	MAPLE), 2" CALII		TUMN BLAZE (AUTUMN BLAZE FREEMAN AND BURLAPPED	EACH
	STATION		OFFSET	EACH
	TOTAL	IONS TO BE L	DETERMINED IN THE FIELD	34
	TOTAL			34
PAY CODE	ITEM			QUANTITY
A2008116			SPIRE (GREENSPIRE LITTLE LEAF AND BURLAPPED OFFSET	EACH
	VARIOUS LOCAT	IONS TO BE D	DETERMINED IN THE FIELD	34
	TOTAL			34
PAY CODE	ITEM			QUANTITY
X0100003	CLEARING AND O	GRUBBING	OFFSET	SQ YD
	2040+32.0	2065+91.0	7' LT & RT	3,980.7
	SHERIDAN AVE 0+00.0	2+79.0	7' LT & RT	434.0
	TOTAL			4,414.7
PAY CODE	ITEM			QUANTITY
X0301797	GATE REMOVAL STATION		OFFSET	EACH
	2019+37.1 2035+63.0			1 1
	TOTAL			2
PAY CODE				
	ITEM			QUANTITY
X0322508	PEDESTRIAN TR	USS SUPER S		
X0322508	PEDESTRIAN TR STATION		OFFSET	SQ FT
X0322508	PEDESTRIAN TR	USS SUPER S 2060+32.0		
X0322508	PEDESTRIAN TR STATION 2059+08.5		OFFSET	SQ FT 1,482.0
X0322508	PEDESTRIAN TR STATION 2059+08.5		OFFSET	SQ FT 1,482.0
PAY CODE	PEDESTRIAN TRISTATION 2059+08.5 TOTAL ITEM FLASHING BEAC	2060+32.0	OFFSET	SQ FT 1,482.0 1,482.0
	PEDESTRIAN TRI STATION 2059+08.5 TOTAL	2060+32.0	OFFSET BRIDGE #103	SQ FT 1,482.0 1,482.0
PAY CODE	PEDESTRIAN TRISTATION 2059+08.5 TOTAL ITEM FLASHING BEACINSTALLATION	2060+32.0	OFFSET BRIDGE #103 DUNTED, SOLAR POWERED	SQ FT 1,482.0 1,482.0 QUANTITY
PAY CODE	PEDESTRIAN TRESTATION 2059+08.5 TOTAL ITEM FLASHING BEAC INSTALLATION STATION 2000+02.40	2060+32.0	OFFSET BRIDGE #103 DUNTED, SOLAR POWERED OFFSET 73.8' LT	SQ FT 1,482.0 1,482.0 QUANTITY EACH 1
PAY CODE	PEDESTRIAN TRISTATION 2059+08.5 TOTAL ITEM FLASHING BEAC INSTALLATION STATION 2000+02.40 2000+58.70	2060+32.0	OFFSET BRIDGE #103 DUNTED, SOLAR POWERED OFFSET 73.8' LT	SQ FT 1,482.0 1,482.0 QUANTITY EACH 1
PAY CODE X0325714 PAY CODE	PEDESTRIAN TRISTATION 2059+08.5 TOTAL ITEM FLASHING BEAC INSTALLATION STATION 2000+02.40 2000+58.70 TOTAL	2060+32.0	OFFSET BRIDGE #103 DUNTED, SOLAR POWERED OFFSET 73.8' LT 97.2' RT	SQ FT 1,482.0 1,482.0 QUANTITY EACH 1 1 2
PAY CODE X0325714	PEDESTRIAN TRISTATION 2059+08.5 TOTAL ITEM FLASHING BEAC INSTALLATION STATION 2000+02.40 2000+58.70 TOTAL	2060+32.0	OFFSET BRIDGE #103 DUNTED, SOLAR POWERED OFFSET 73.8' LT 97.2' RT	SQ FT 1,482.0 1,482.0 QUANTITY EACH 1 1 2

PAY CODE	ITEM		QUANTITY
X0327036	BIKE PATH REMOVAL STATION	OFFSET	SQ YD
	1999+58.0 2000+03.5		54.0
	TOTAL		54.0
PAY CODE	ITEM		QUANTITY
X0327423	CONNECTION TO EXISTING CULV	ERT OFFSET	EACH
	2111+14.1	25.1' LT	1
	TOTAL		1
PAY CODE	ITEM		QUANTITY
X0327979	PAVEMENT MARKING REMOVAL STATION	- GRINDING OFFSET	SQ FT
	2000+27.2 2000+29.6	LT/RT LT/RT	3.5 3.5
	TOTAL		7.0
PAY CODE	ITEM		QUANTITY
X0350805	FOLD DOWN BOLLARDS STATION	OFFSET	EACH
	2035+63.0 2035+63.0 2035+63.0	9.3' RT 0' RT 7.5' LT	1 1 1
	SHERDIAN AVENUE	7.5 [1	ı
	0+35.0 0+35.0	5' RT 0' RT	1 1
	0+35.0	5' LT	1
	TOTAL		6
PAY CODE	ITEM		QUANTITY
X2020105	GRADING AND SHAPING BIKEW, STATION	AY OFFSET	UNIT
	2081+24.0 2091+51.0	LT/RT	10.3
	TOTAL		10.3
PAY CODE	ITEM		QUANTITY
X6024504	INLETS, TYPE B, WITH FRAME A STATION	ND GRATE, SPECIAL OFFSET	EACH
	2019+26.6 2023+82.9	10.0' LT 13.9' LT	1 1
	2024+84.5 TOTAL	11.8' LT	3
DAY CODE	ITEM		QUANTITY
PAY CODE	ITEM		QUANTITY
XX006345	TURBIDITY BARRIER STATION	OFFSET	FOOT
	2058+48.2 2058+83.6 2060+36.2 2060+64.3	54.4' RT to 57.2' LT 52.2' RT to 53.0' LT	256.0 182.0
	TOTAL		438.0

PAY CODE	ITEM			QUANTITY
XX006653	FENCE (SPEC STATION	IAL)	OFFSET	FOOT
	2019+37.0	2022+96.0	19.0' LT	359.0
	TOTAL			359.0
PAY CODE	ITEM			QUANTITY
Z0022800	FENCE REMO	VAL	OFFSET	FOOT
	2019+37.1		20' LT - 8' RT	28.0
	TOTAL			28.0
PAY CODE	ITEM			QUANTITY
Z0055905	TEMPORARY (CONSTRUCTION	FENCE OFFSET	FOOT
	2024+63.7	2027+40.4	24.2' LT to 16.4' LT	216.0
	TOTAL			216.0
PAY CODE	ITEM			QUANTITY
Z0048900	RAILROAD TRA	ACK REMOVAL	OFFSET	FOOT
	2080+68.0 2107+59.0	2081+06.0 2107+69.3	LT/RT LT/RT	38.0 38.0
	TOTAL			76.0
PAY CODE	ITEM			QUANTITY
Z0064600	SELECTIVE CL STATION	EARING	OFFSET	ACRE
	2012+12.0	2016+25.0	0' RT to 8' RT	0.1
	TOTAL			0.1
				QUANTITY
PAY CODE	ITEM			
PAY CODE Z0078000	WOOD RAIL STATION		OFFSET/COMMENTS	FOOT
PAY CODE Z0078000	WOOD RAIL	2059+09.6 2059+09.6 2060+41.3 2060+41.3	OFFSET/COMMENTS NW CORNER BRIDGE #103 SW CORNER BRIDGE #103 NE CORNER BRIDGE #103 SE CORNER BRIDGE #103	FOOT 8.0 8.0 8.0 8.0



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PLOT DATE: 4/2/2019	CHECKED: WLK	REVISED:

STATE	0F	ILLINOIS
CITY 0	F FI	REEPORT

HEDULE OF QUANTITIES (5)	-	SE	CTION		COUNTY	TOTAL SHEETS	SHEE NO.
FREEPORT PEC PATH		15-0016	3-00-	BT	STEPHENSON	92	10
		FREEPORT			CONTRACT N	0. 856.	74
SHEET NO. OF SHEETS			ILLINOIS	FFD A	ND PROJECT -		

OVERALL PROJECT CONTROL



BENCHMARKS

	BENCHMARKS				
NO.	NO. DESCRIPTION				
BM 781	USGS Disk in west end of top step at the south entrance to post office building in Freepot at NEX N. Chicago Ave and E. Exchange St.	779.75			
BM 1	RR Spike in Power Pole ±75 Northwest of Stephenson St. Bridge over Pecatonica River	766.22			
BM 2	South Bonnet Bolt on Fire Hydrant at the Northeast corner of Commercial and Stephenson St. (US Hwy. 75)	761.55			
ВМ 3	BM 3 Southeast Bonnet Bolt on top flange of Fire Hydrant at Northwest corner of Sherman St. and Stephenson St.(US Hwy. 75)				
BM 4 RR Spike in Power Pole at Northeast corner of Mary Ave. and Album Street. 2037+73± 20'± LT. RR Spike in Tree near Bridge 103 south side of old Railroad bed. 2058+57± 22'± RT. BM 301 Cut "x" in North Bolt on 6 foot diameter Metal Comed Electrical Pole 2066+66± 19'± RT. Chiseled square on Sanitary Manhole Rim at Northwest corner of Structo Rd. and railroad bed. 2080+60± 43'± LT.		756.27			
		753.19			
		757.61			
		756.21			
BM 303	BM 303 RR Spike in Power Pole #2360 Sta. 2104+19± 13'± Rt.				
BM 304	RR Spike in Power Pole #2350 Sta. 2138+35± 5'± Lt.	758.47			



NOTES

- 1. COORDINATES ARE BASED ON STATE PLANE COORDINATES.
- 2. BENCHMARK ELEVATIONS ARE BASED ON NAVD 88 TAKEN FROM NGS CONTROL (PID NH 0646; DES 781 USGS)
- 3. EXISTING PROPERTY CORNERS TO BE PROTECTED (SEE GENERAL NOTES)
- 4. THE CONTRACTOR SHALL VERIFY ALL SURVEY CONTROL BEFORE USING AND REPORT ANY DISCREPENCIES TO THE ENGINEER.


◆IM	EG
120 S 1ST STREET	PH: 815.956.6400
ROCKFORD, IL 61350	www.imegcorp.com
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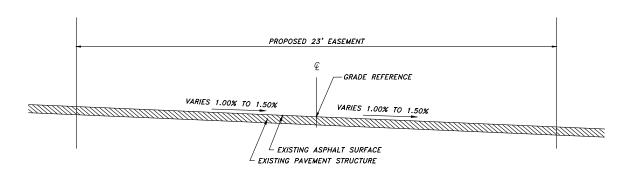
STATE OF ILLINOIS CITY OF FREEPORT

 OVERALL PROJECT CONTROL FREEPORT PEC PATH
 SECTION
 COUNTY SHEETS
 TOTAL SHEET SHEETS
 SHEET SHEET SHEETS
 NO.


 SHEET NO.
 OF
 SHEETS
 CITY OF FREEPORT
 CONTRACT NO.
 85674



EXISTING SECTION IL 75 - (STA 2000+00 TO 2000+67)

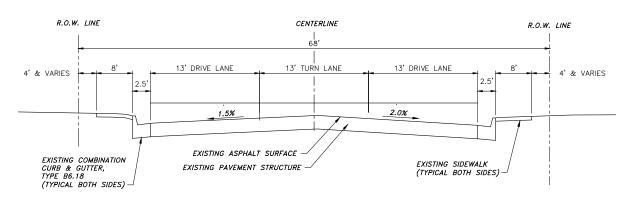


EXISTING SECTION - (2000+73 TO 2002+46)

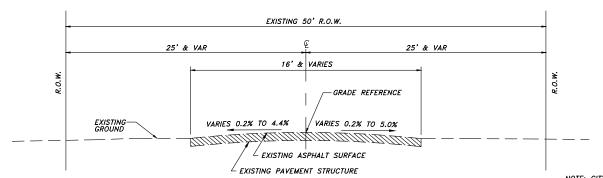


E. ALBUM STREET SECTION - (STA 2028+74 TO 2039+08)
(SHARED USE FACILITY 2,000 ADT)


NOTE: CITY OF FREEPORT TO INSTALL 25 MPH SPEED LIMIT SIGNS REFER TO PLAN + PROFILE SHEETS FOR OTHER REQUIRED PATH SIGNAGE

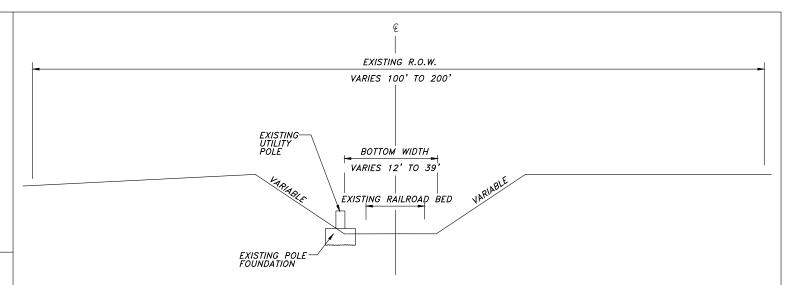


EXISTING CUT SECTION ALONG FORMER RAILROAD EMBANKMENT

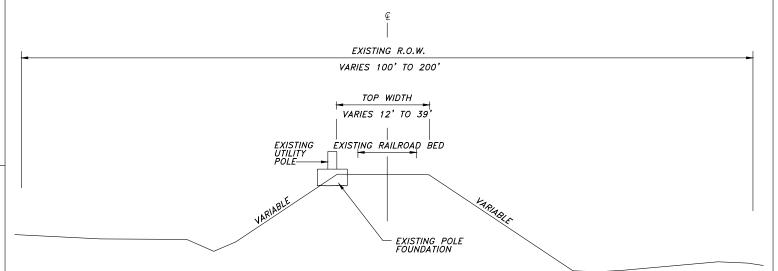

EXISTING FILL SECTION ALONG FORMER RAILROAD EMBANKMENT

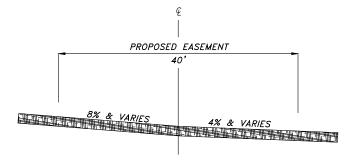

EXISTING SECTION BEYOND RAILROAD R.O.W. - (2144+00 TO 2151+01)

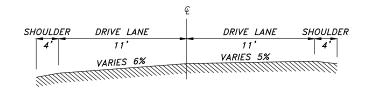


EXISTING SECTION OF RIVER RD

◆I M	EG
120 S 1ST STREET	PH: 815.956.6400
ROCKFORD, IL 61350	www.imegcorp.com
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CIDENDES INC.	McClure

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STATE	0F	ILLINOIS	
CITY 0	F FF	REEPORT	

TYPICAL SECTIONS - EXISTING FREEPORT PEC PATH		SEC
		15-0016
THEELONI TECTATII	CITY OF	FREEPORT

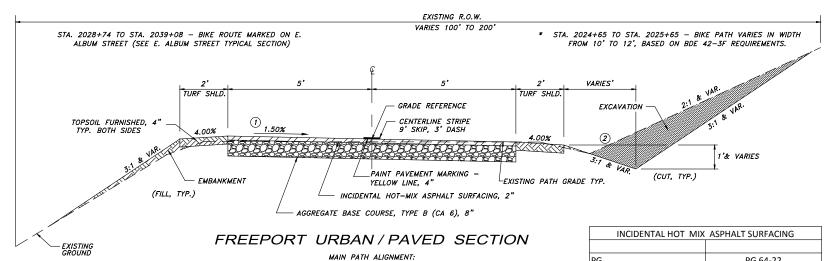

STA. 1999+58 TO STA. 2000+03 - NORTH OF STEPHENSON ST


STA. 2000+65 TO STA. 2002+46 - PATH MARKED ACROSS EXISTING CONCRETE PARKING LOT

* STA. 2002+46 TO STA. 2023+74 - SOUTH OF STEPHENSON ST. TO HANCOCK BRIDGE


STA. 2024+61 TO STA. 2028+59 - HANCOCK BRIDGE TO ALBUM ST

SHERIDAN AVE. ALIGNMENT: STA. 0+00 TO STA. 2+79

INCIDENTAL HOT MIX ASPHALT SURFACING		
PG	PG 64-22	
DESIGN AIR VOIDS	4.0 % @ N50	
MIXTURE COMPOSITION	IL 9.5 FG	
(GRADATION MIXTURE)		
FRICTION AGGREGATE	С	
20 YEAR ESAL	NA	
MIX UNIT WEIGHT	112 lbs/sy/inch	

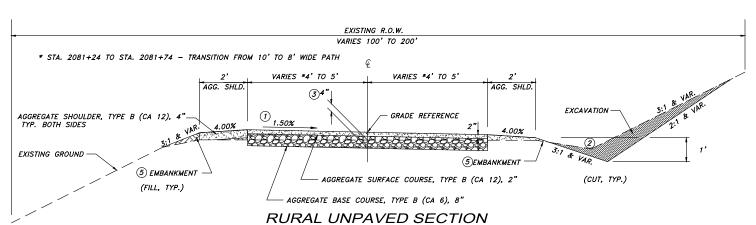


STA. 2039+08 TO STA. 2058+58.5 - ALBUM ST. TO CURRIER CREEK (10' WIDE) STA. 2060+82 TO STA. 2080+73 - CURRIER CREEK TO STRUCTO RD. (10' WIDE) STA. 2091+51 TO STA. 2123+00 - (8' WIDE)

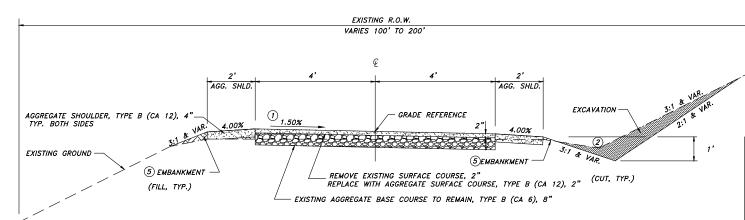

GRADING & SHAPING BIKEWAY


(SEE SPECIAL PROVISIONS)


STA. 2081+24 TO STA. 2091+51 - 2" SURFACE & SHOULDER ONLY EAST OF STRUCTO RD (8' WIDE)

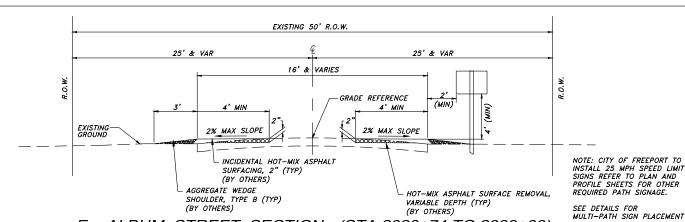

E. ALBUM STREET SECTION - (STA 2028+74 TO 2039+08)

(SHARED USE FACILITY< 2,000 ADT)

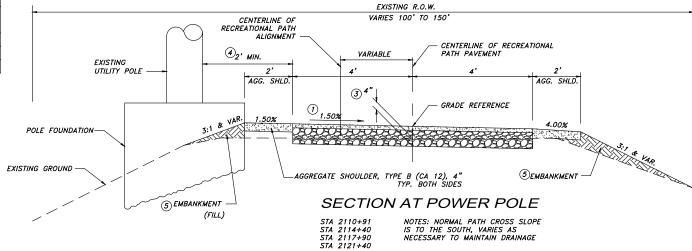

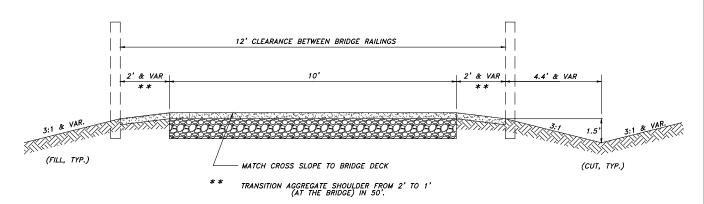

APPROACH SECTION AT BRIDGE #103

SEE FREEPORT URBAN/PAVED SECTIONS FOR ADDITIONAL DETAILS AND NOTES STA. 2058+58.5 TO STA. 2060+82 (EXCLUDING BRIDGE STRUCTURE)

NOTES:


- ① TYPICAL PATH CROSS SLOPE IS TOWARD PECATONICA RIVER OR SOUTHERLY & AWAY FROM POWER POLES. REVERSE SLOPE AS SHOWN IN THE CROSS SECTIONS. TRANSITION LENGTH SHALL BE 50' MINIMUM DISTANCE WHEN REVERSING SLOPE.
- 2) VARIES AS NECESSARY TO MAINTAIN DRAINAGE. CONSULT CROSS SECTIONS FOR SPECIAL DITCH CUTS.
- 3 NOMINAL 4" SURFACE ORGANIC MATERIAL IS TO BE REMOVED AND USED TO BUILD SHOULDERS. THIS REMOVAL IS TO BE PAID FOR AS PART OF SHAPING AND GRADING ROADWAY.
- (4) CLEARANCE AT POLES IS 2' TO EITHER THE FOUNDATION RING OR THE FACE OF POLE IF NO FOUNDATION RING IS PRESENT.
- (5) EMBANKMENT AS SHOWN WILL NOT BE PAID FOR SEPARATELY, BUT IS THE RESULT OF GRADING AND SHAPING ROADWAY. IF FILL MATERIAL MUST BE BROUGHT FROM A REMOTE LOCATION, IT WILL BE PAID AS EARTH EXCAVATION (FOR EMBANKMENT EXCAVATED WITHIN THE PATH RIGHT-OF-WAY) OR FURNISHED EXCAVATION. (IF PROVIDED FROM A REMOTE SOURCE).



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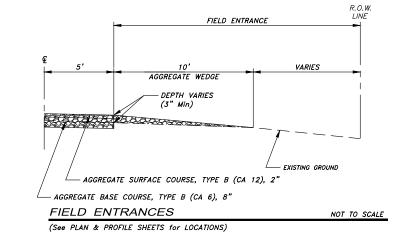
STATE OF ILLINOIS CITY OF FREEPORT

FILE NAME AND PATH: \\AD.KJWW.COM\KJWW\\GYFICES\MCCLURE\ROCKFORD\PROJECTS\H-DRIVE TRANS\14-054-PECPATH-FREEPORT\DESIGN\DRAWINGS\14-054 TYPSECT.DWG

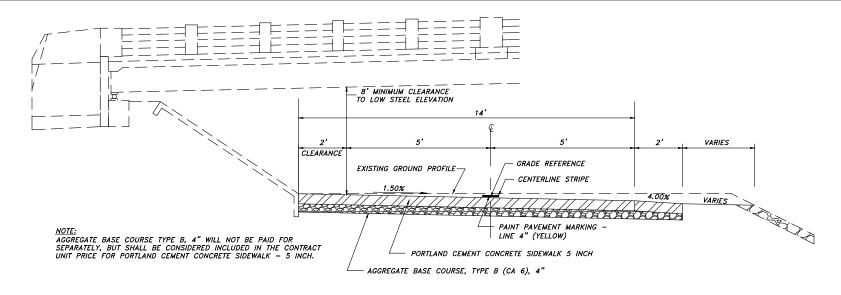


CONCRETE PAVED SECTION UNDER HANCOCK AVE. BRIDGE


STA. 2023+74 TO STA. 2024+61





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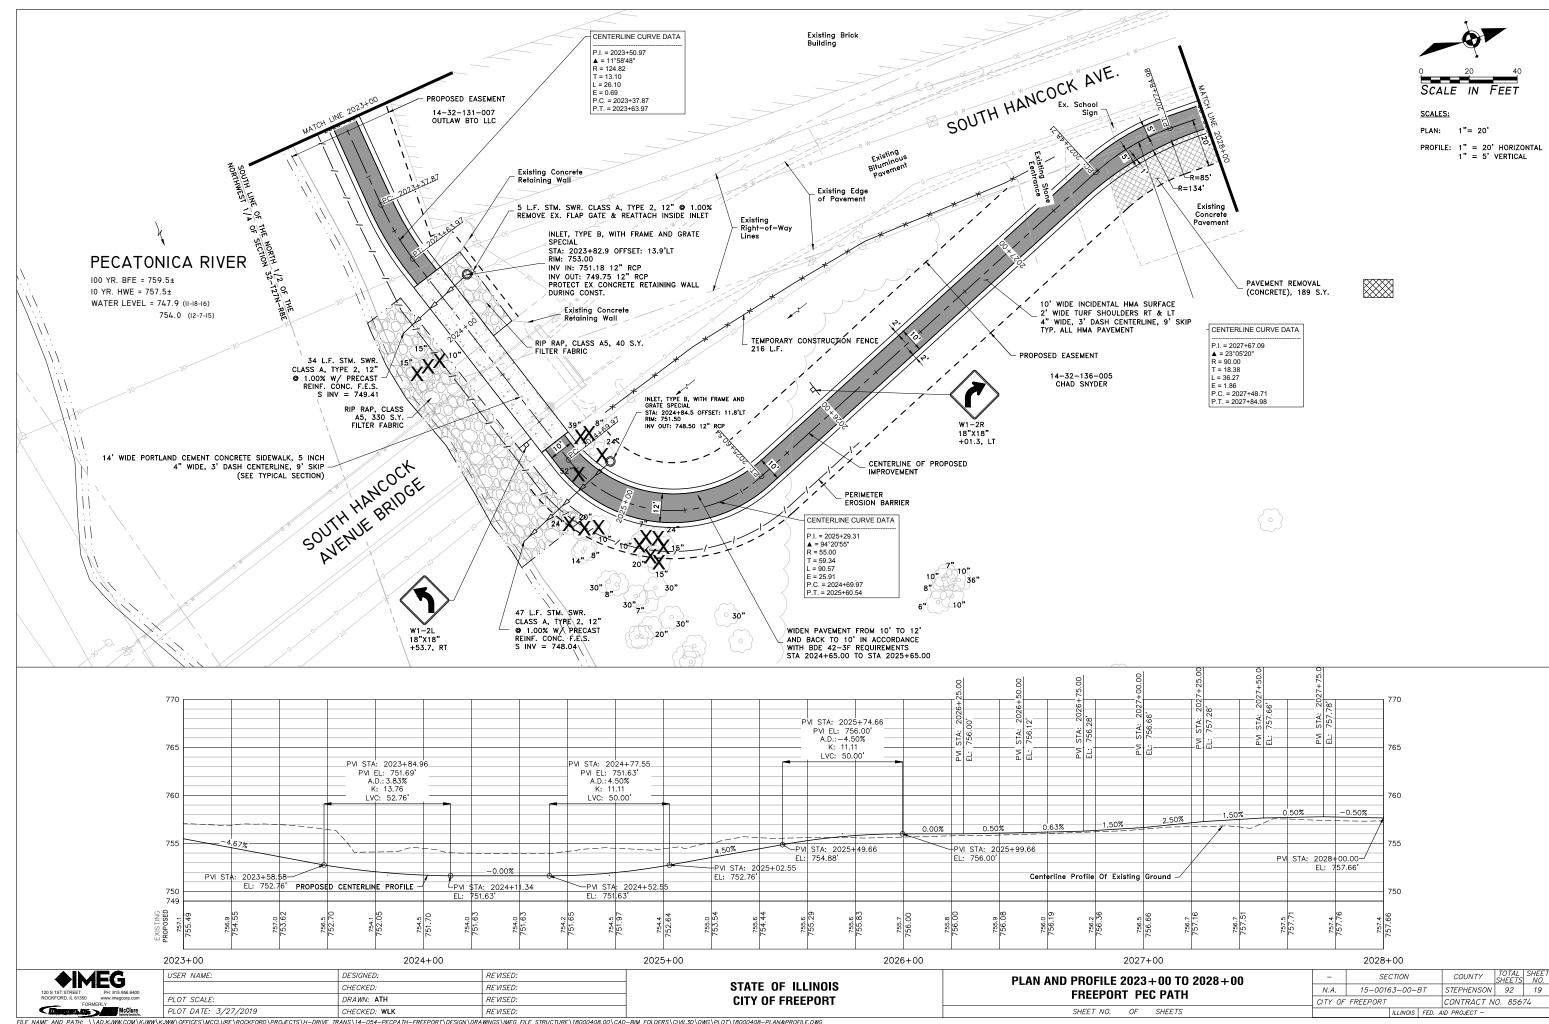
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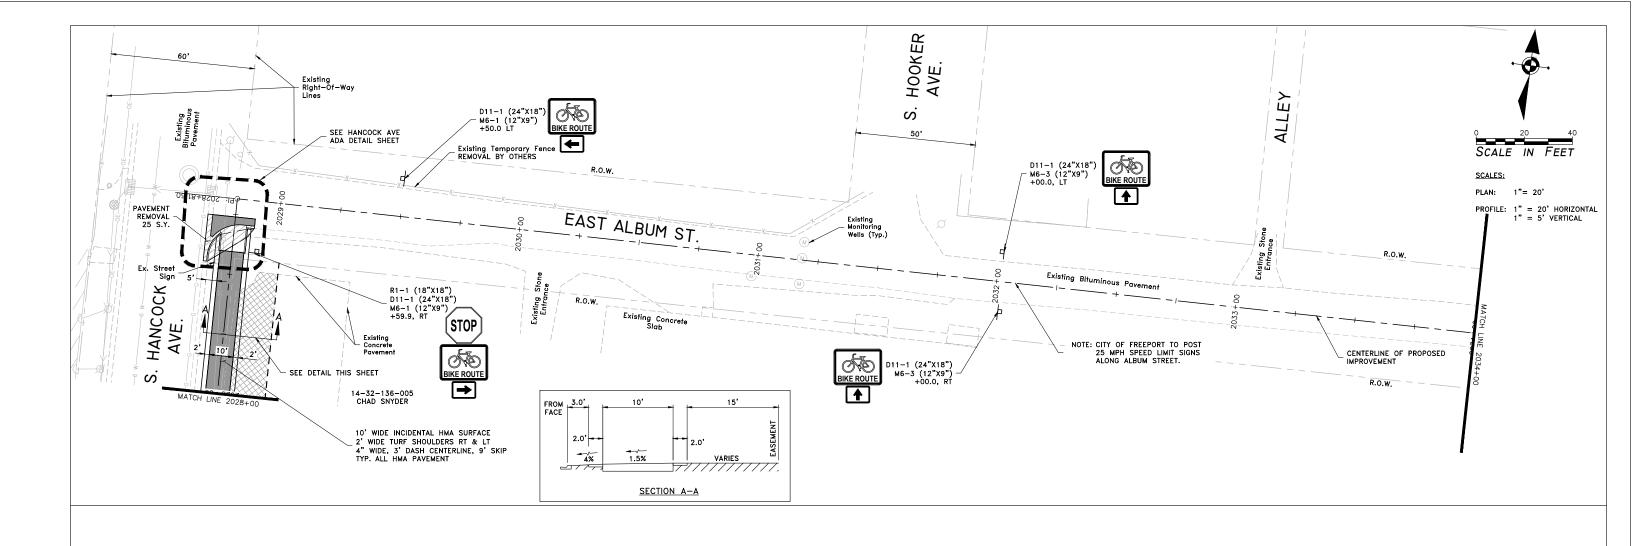





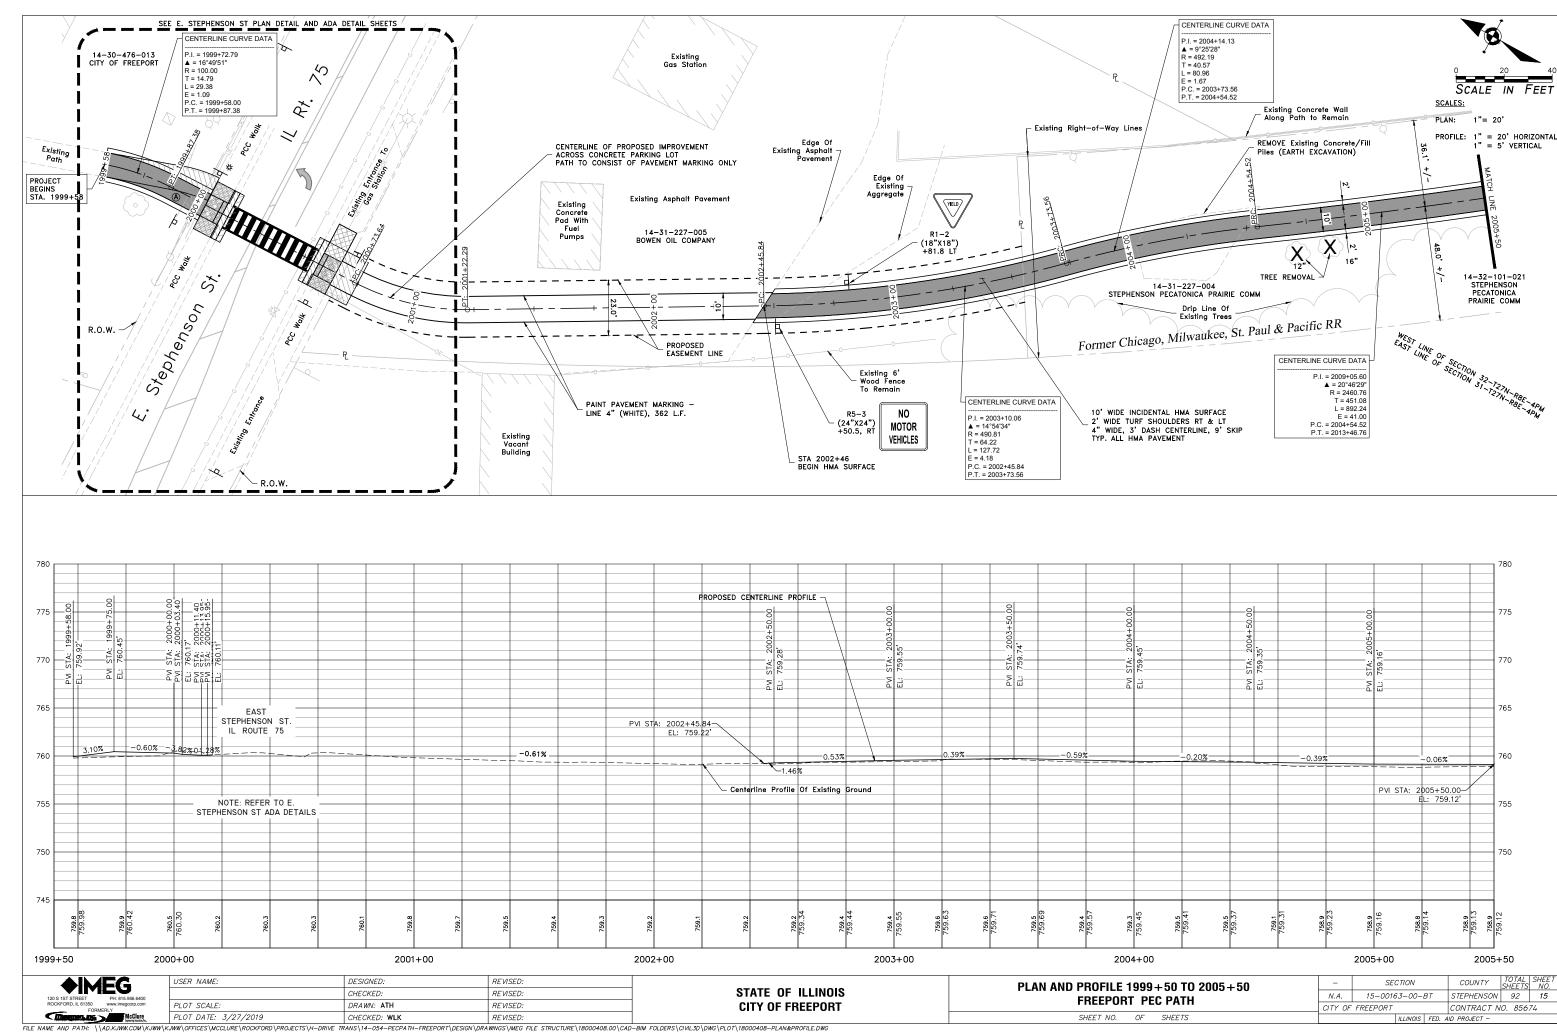


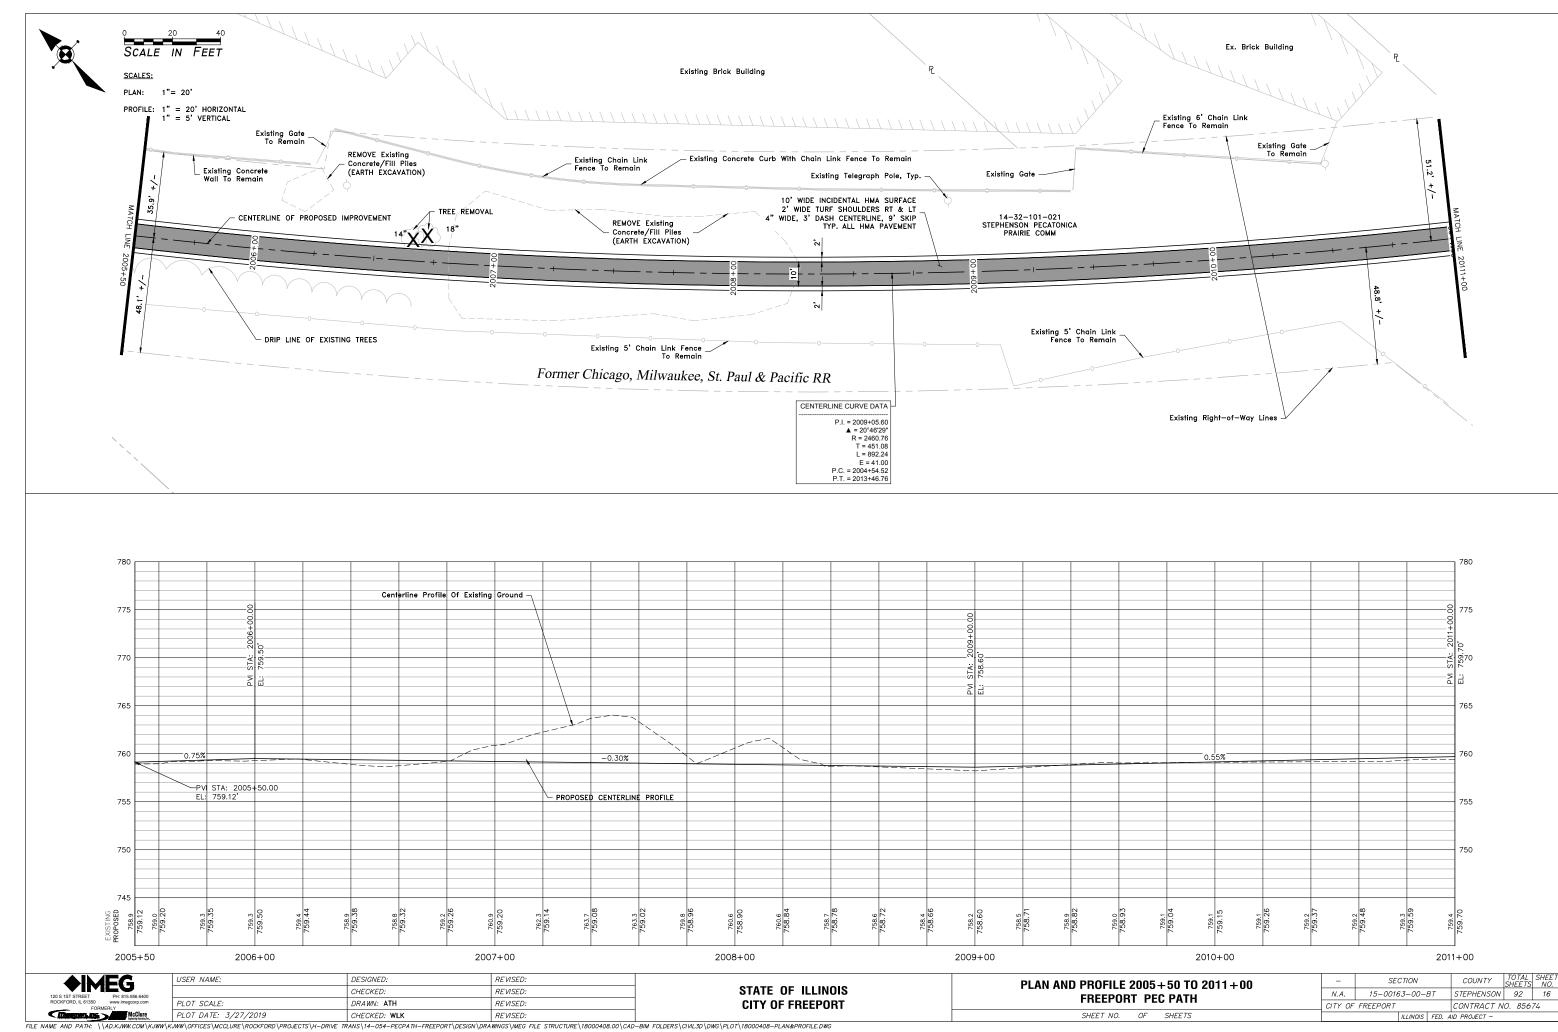


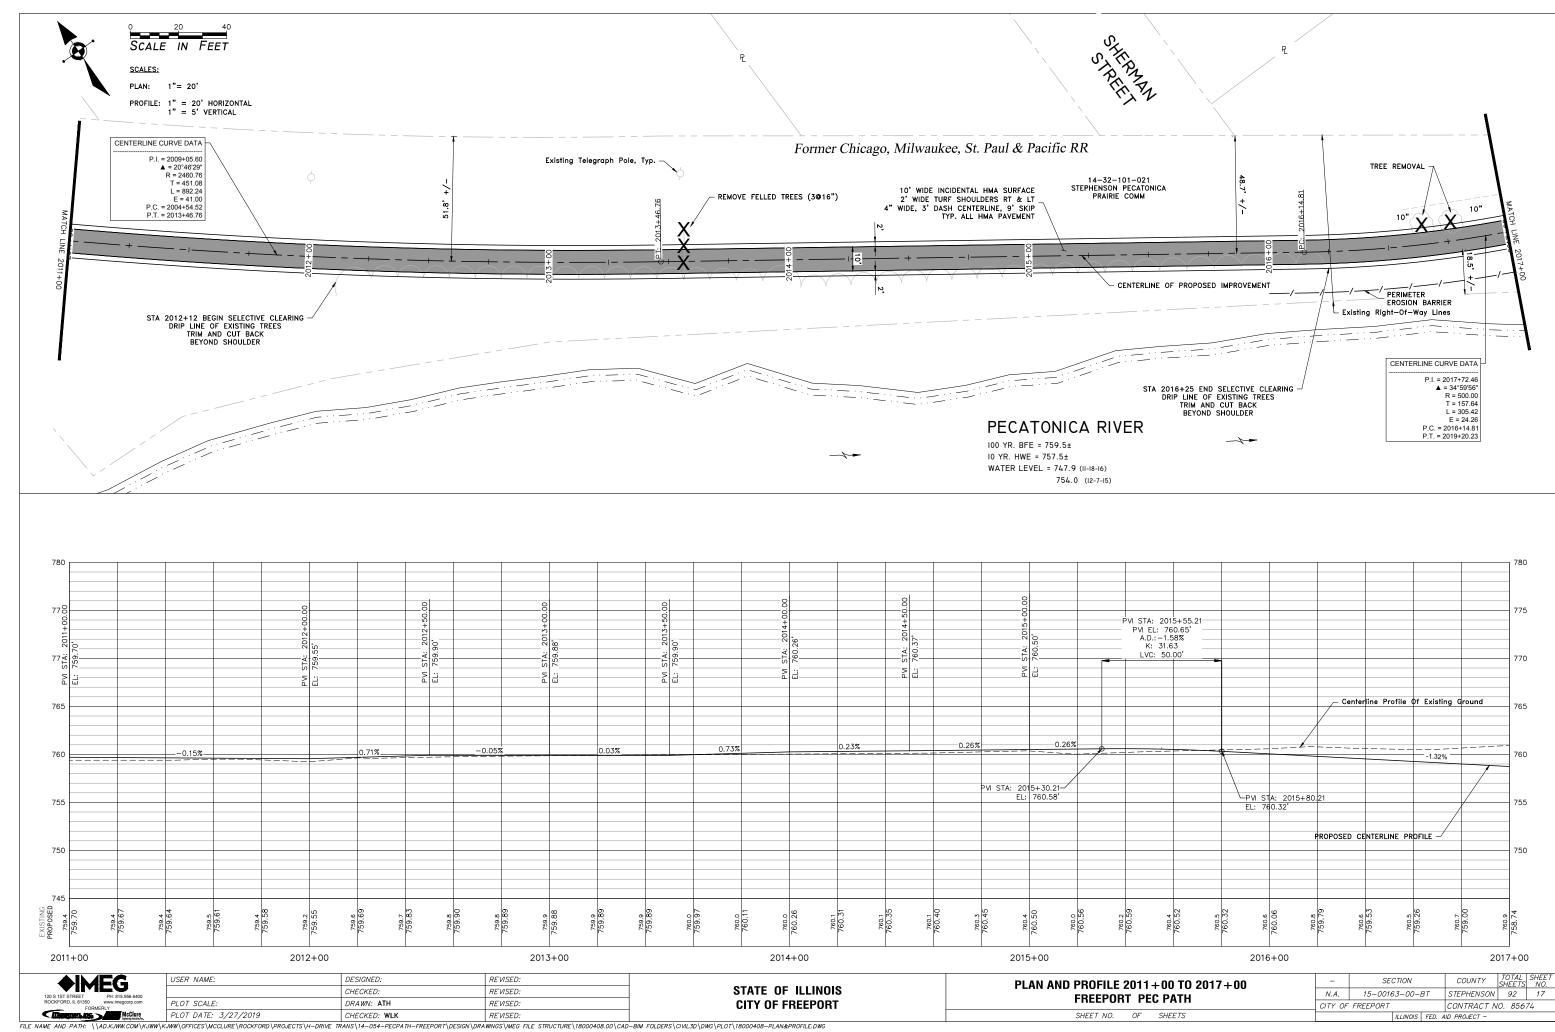

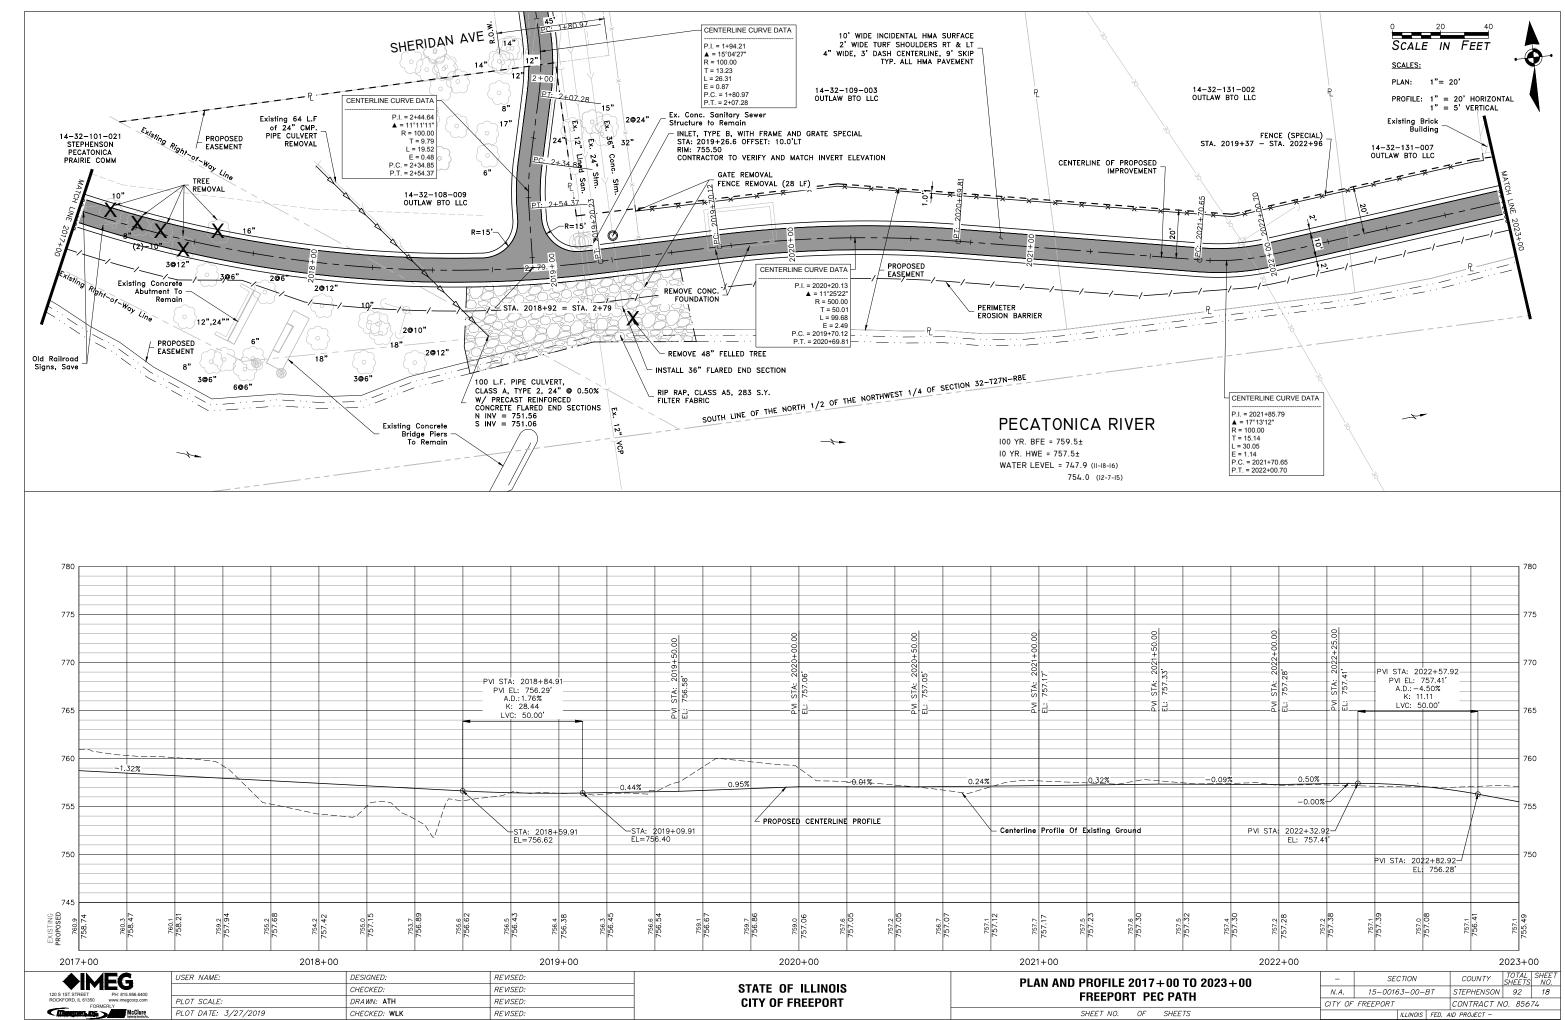

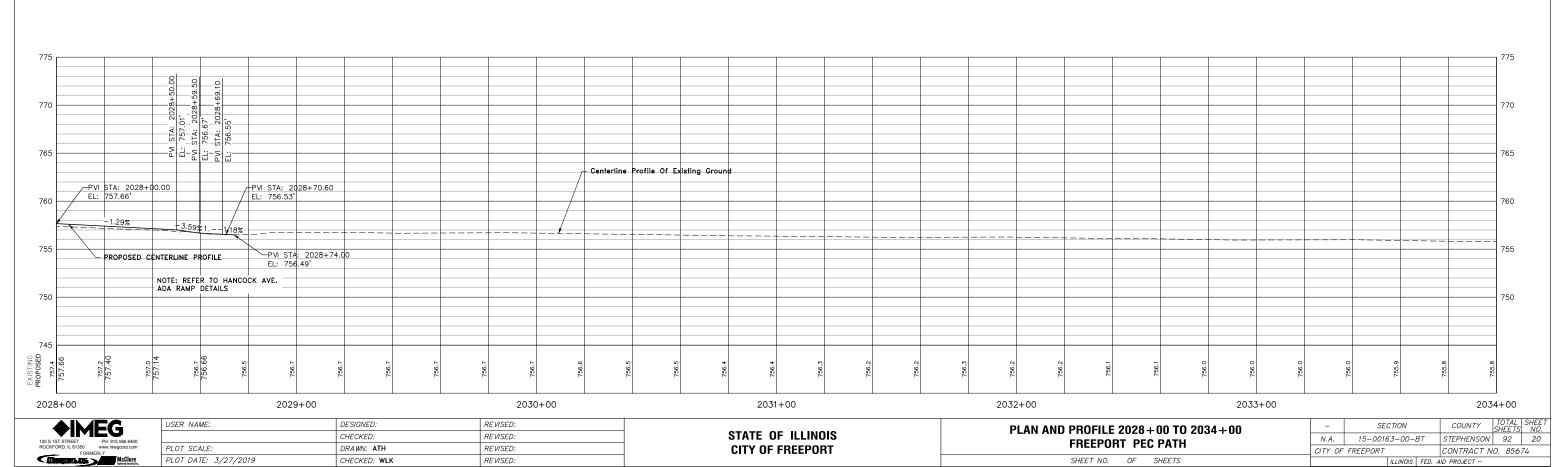

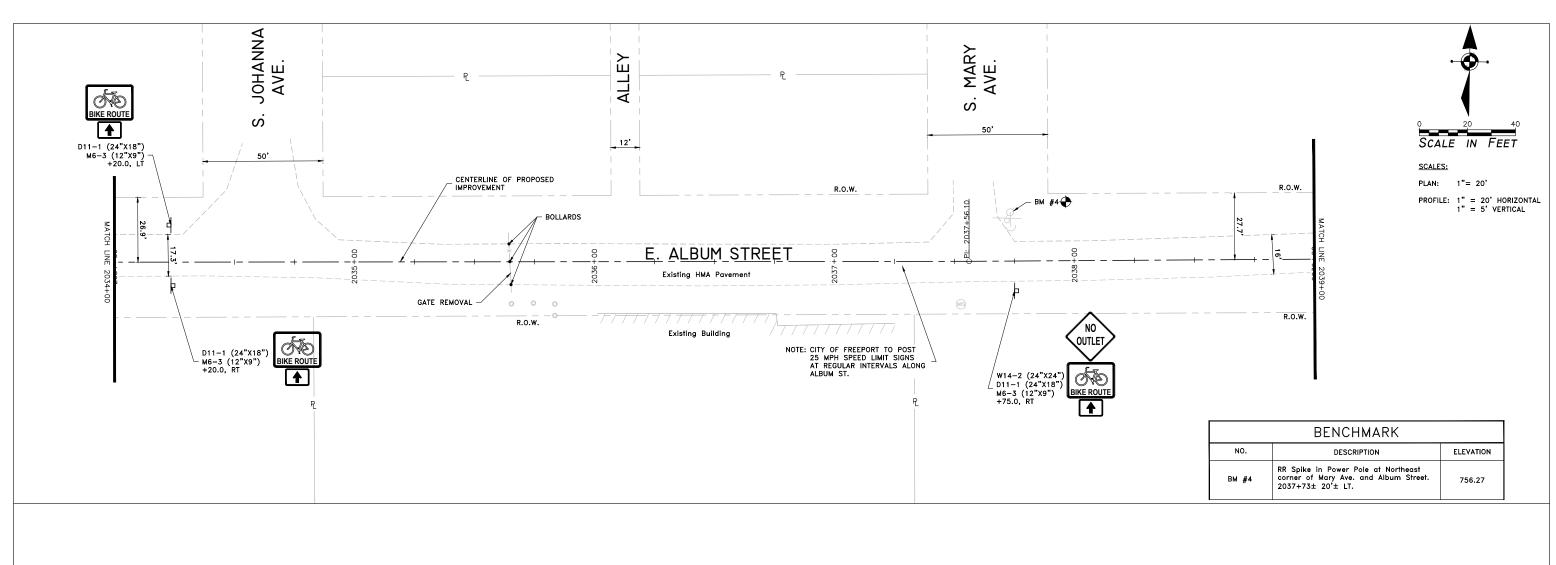

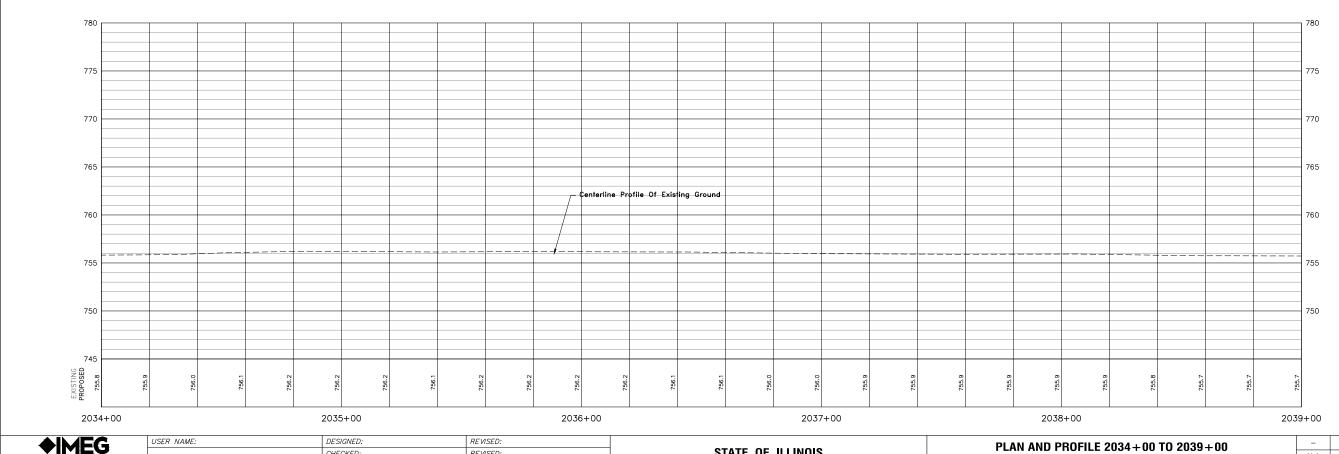

STATE OF ILLINOIS

CITY OF FREEPORT

COUNTY TOTAL SHEETS NO.
STEPHENSON 92 21

CONTRACT NO. 85674

SECTION

15-00163-00-BT

ILLINOIS FED. AID PROJECT -

CITY OF FREEPORT

PLAN AND PROFILE 2034+00 TO 2039+00

FREEPORT PEC PATH

SHEET NO. OF SHEETS

DESIGNED:

CHECKED:

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CHECKED: WLK

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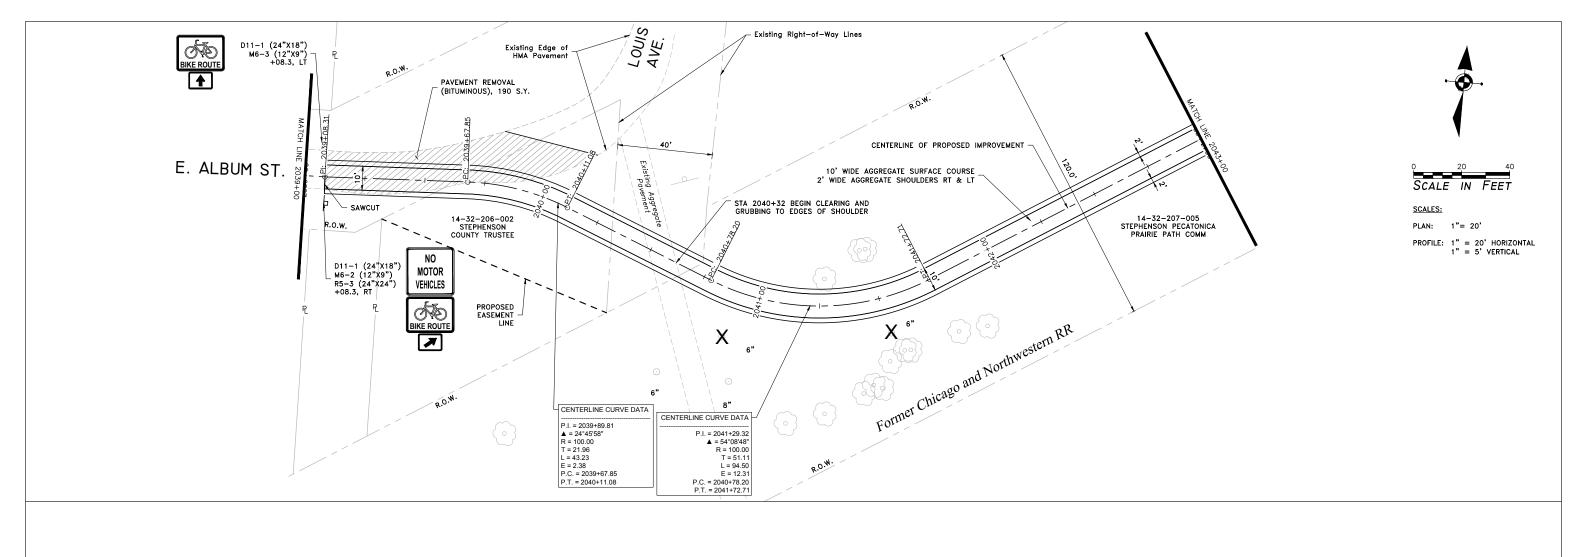
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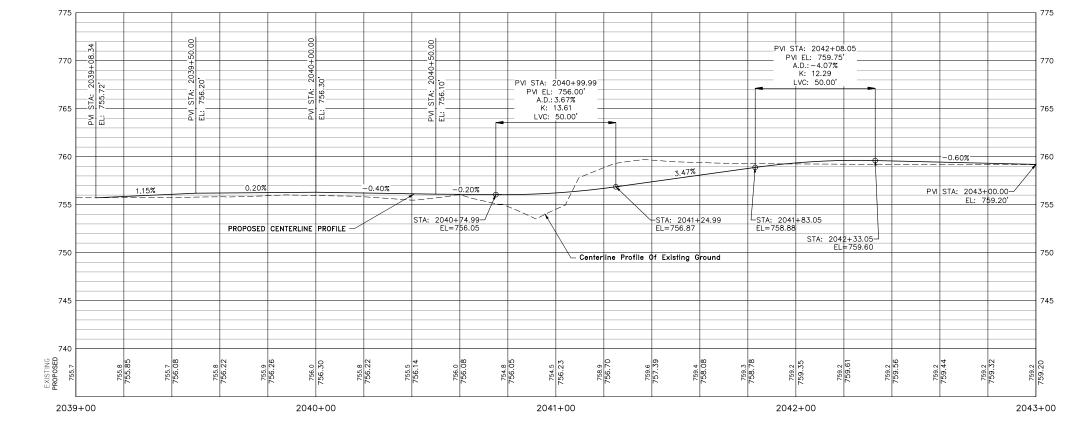
REVISED:

USER NAME:

PLOT SCALE:

PLOT DATE: 3/27/2019





STATE OF ILLINOIS

CITY OF FREEPORT

COUNTY TOTAL SHEETS NO.
STEPHENSON 92 22

CONTRACT NO. 85674

SECTION

15-00163-00-BT

ILLINOIS FED. AID PROJECT -

CITY OF FREEPORT

PLAN AND PROFILE 2039+00 TO 2043+00

FREEPORT PEC PATH

SHEET NO. OF SHEETS

DESIGNED:

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DRAWN: ATH

CHECKED: WLK

USER NAME:

PLOT SCALE:


PLOT DATE: 3/27/2019


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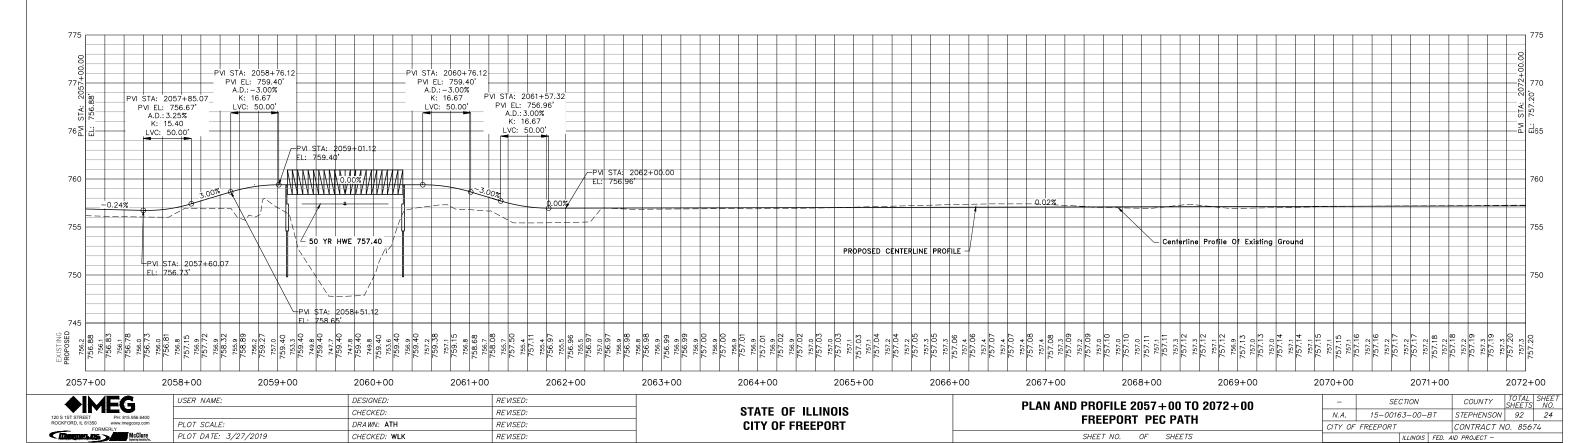
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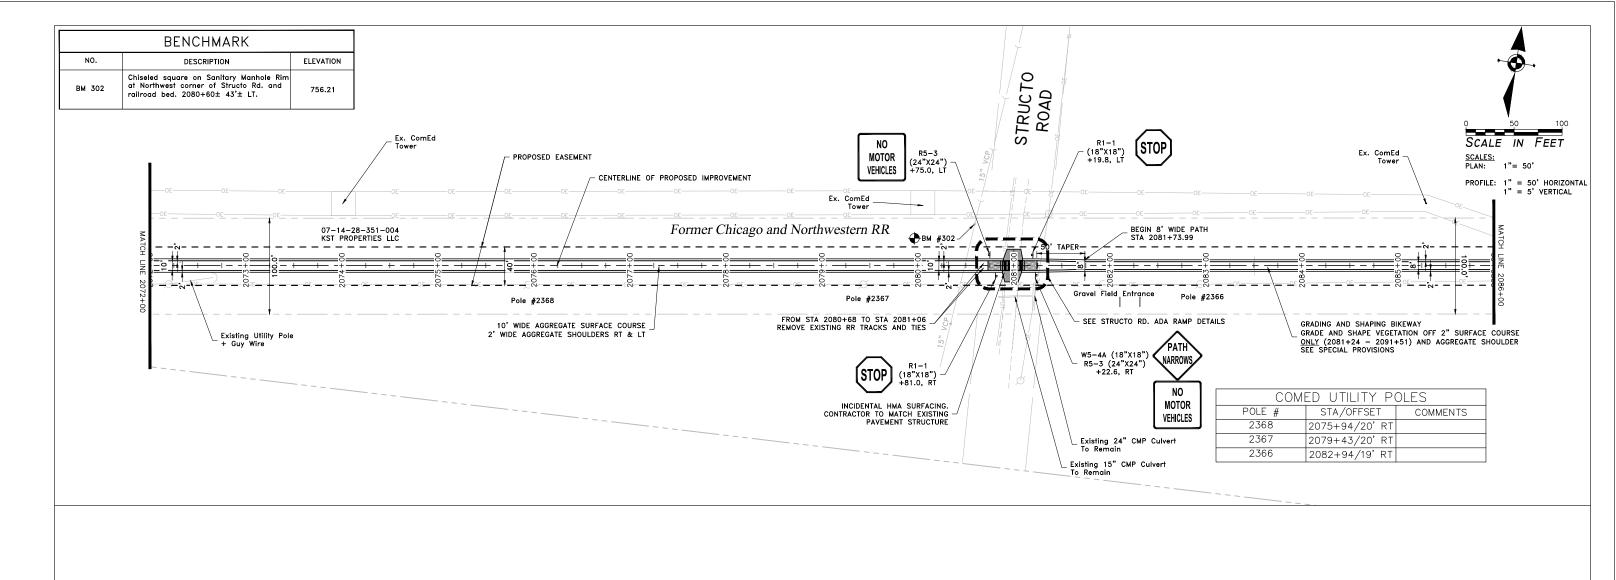
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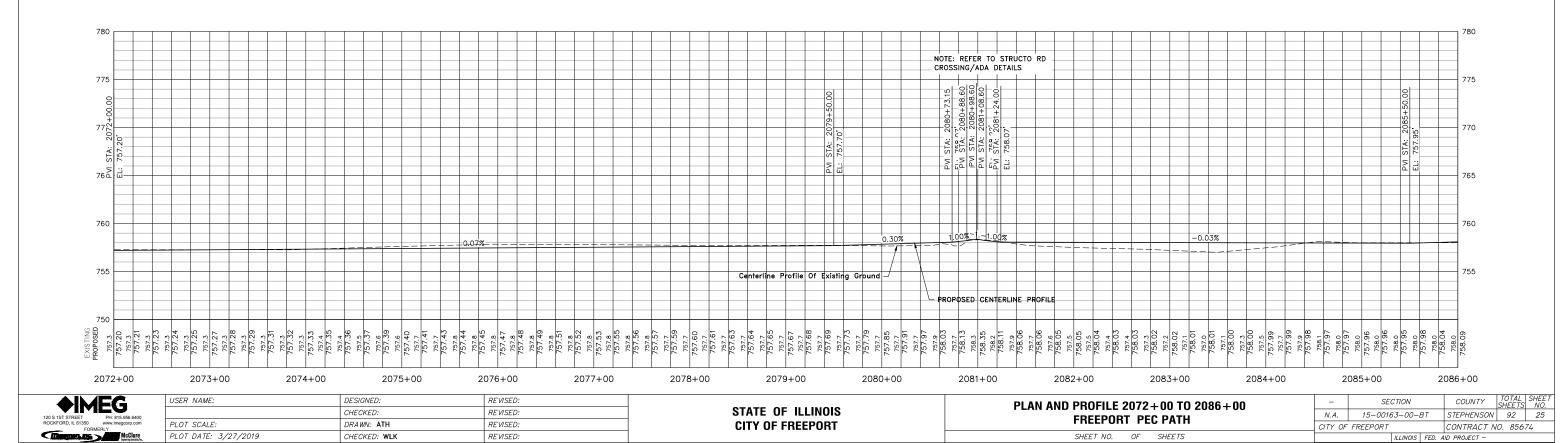
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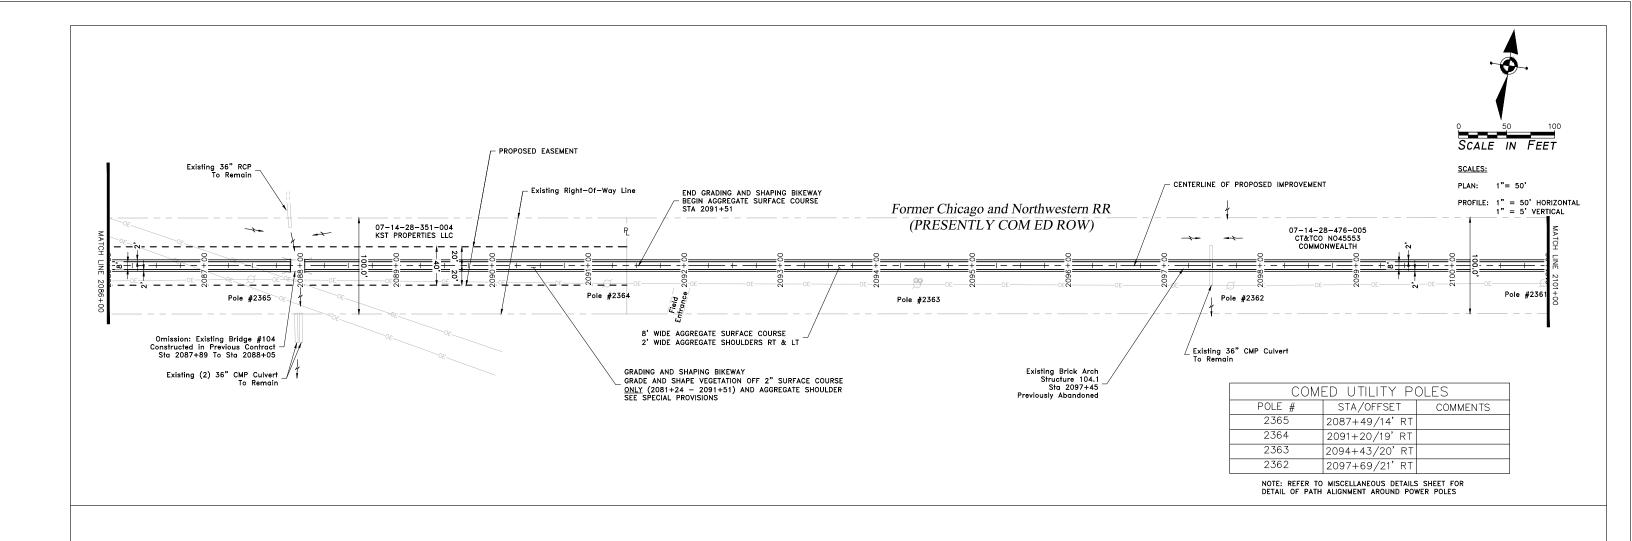











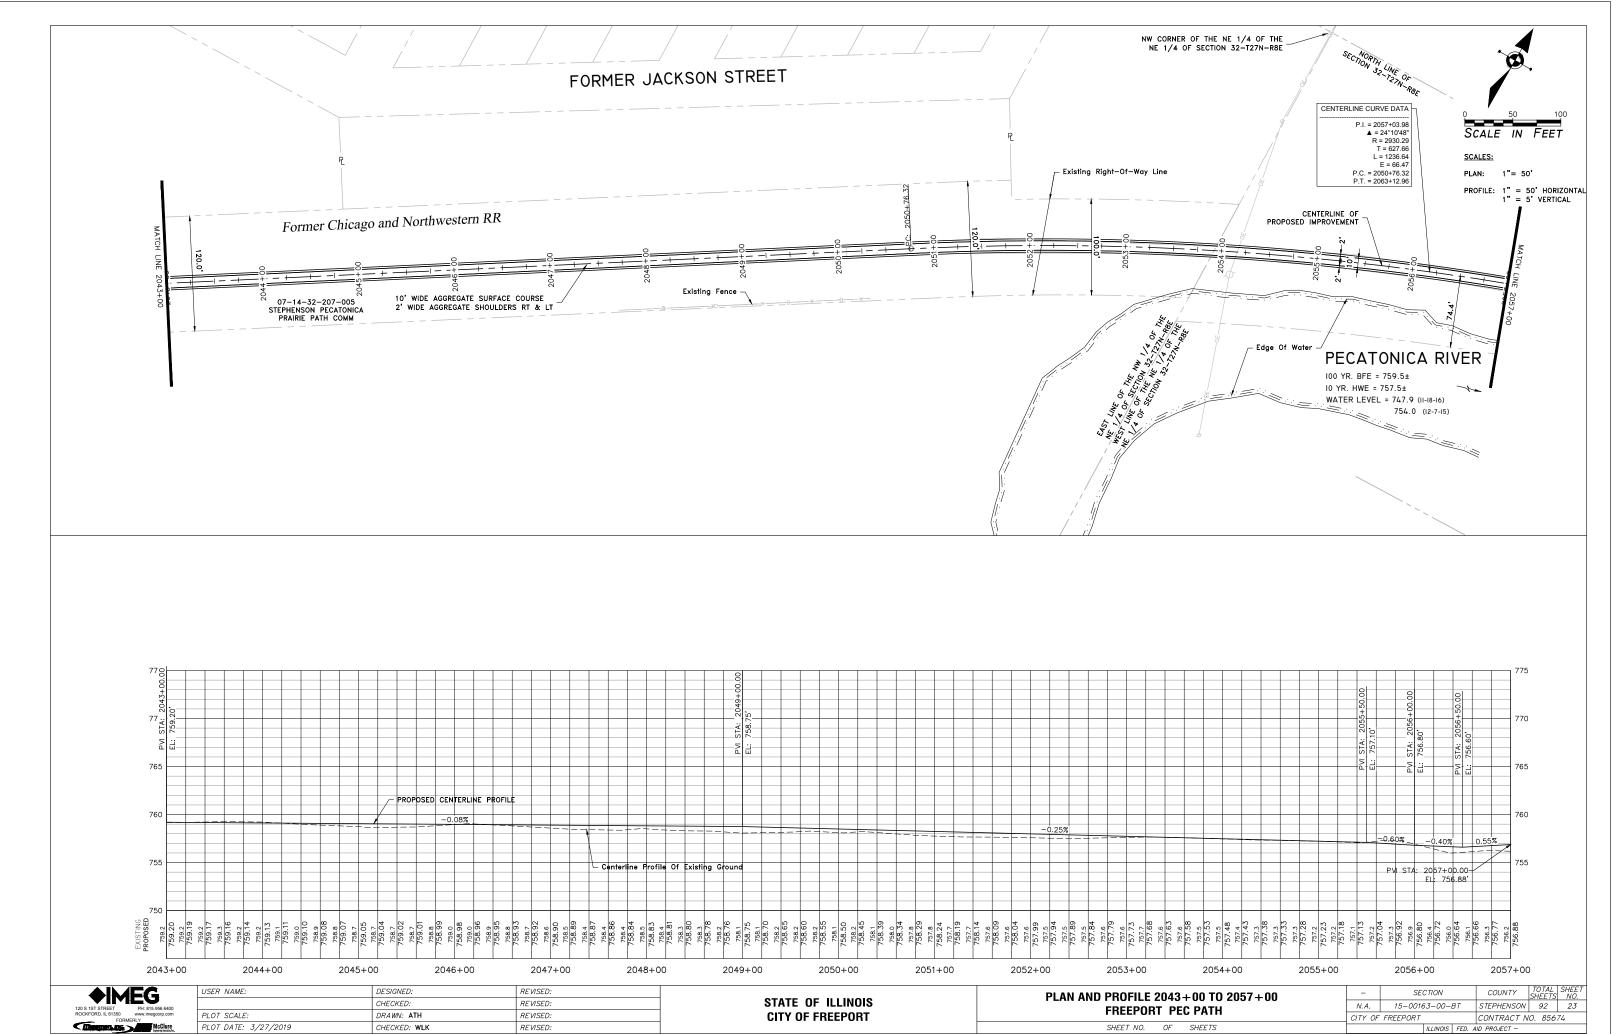


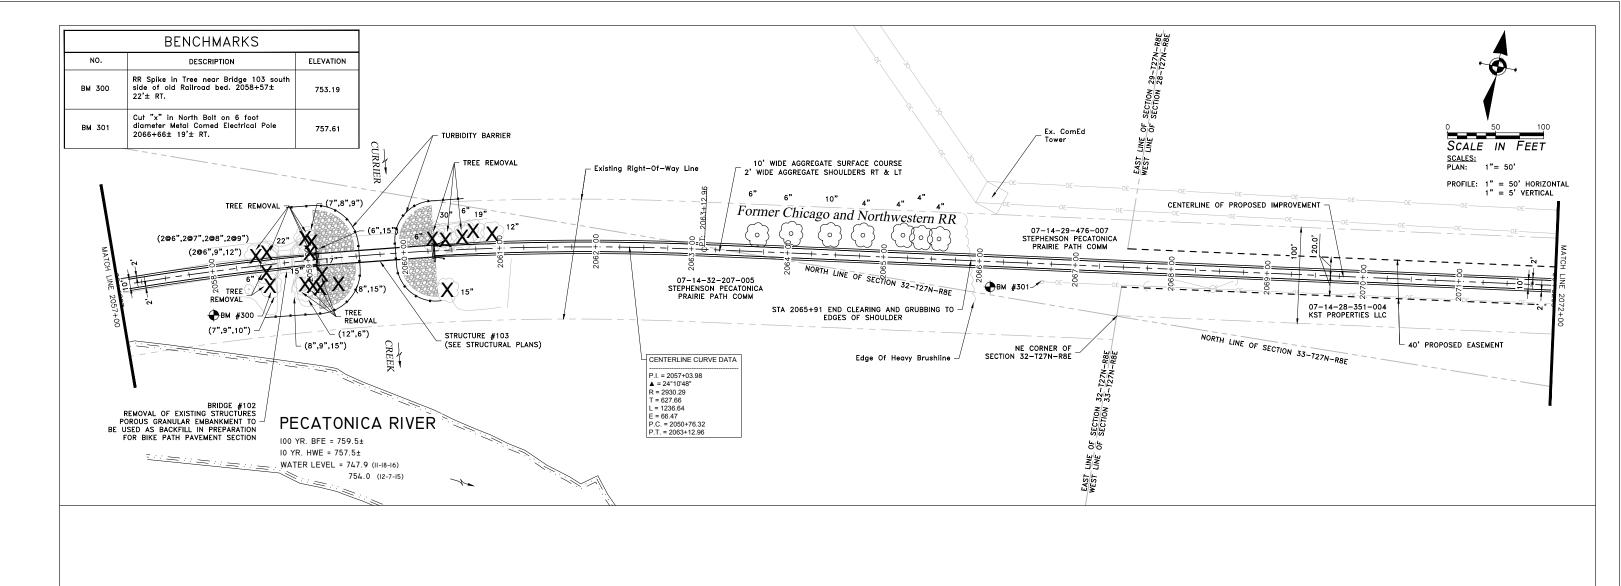


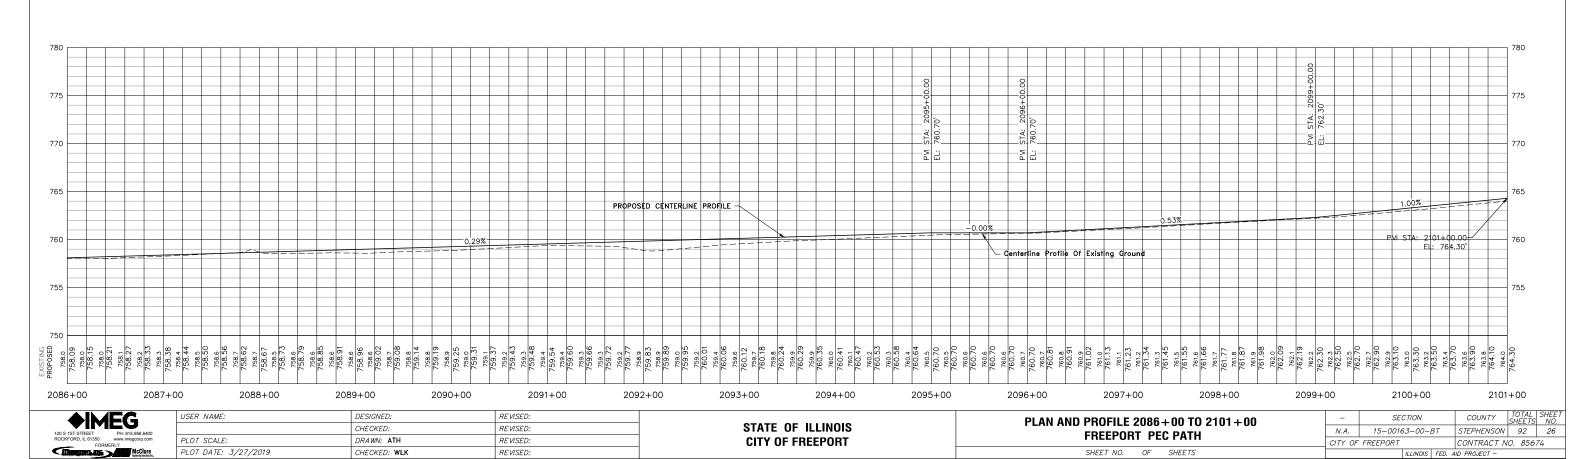


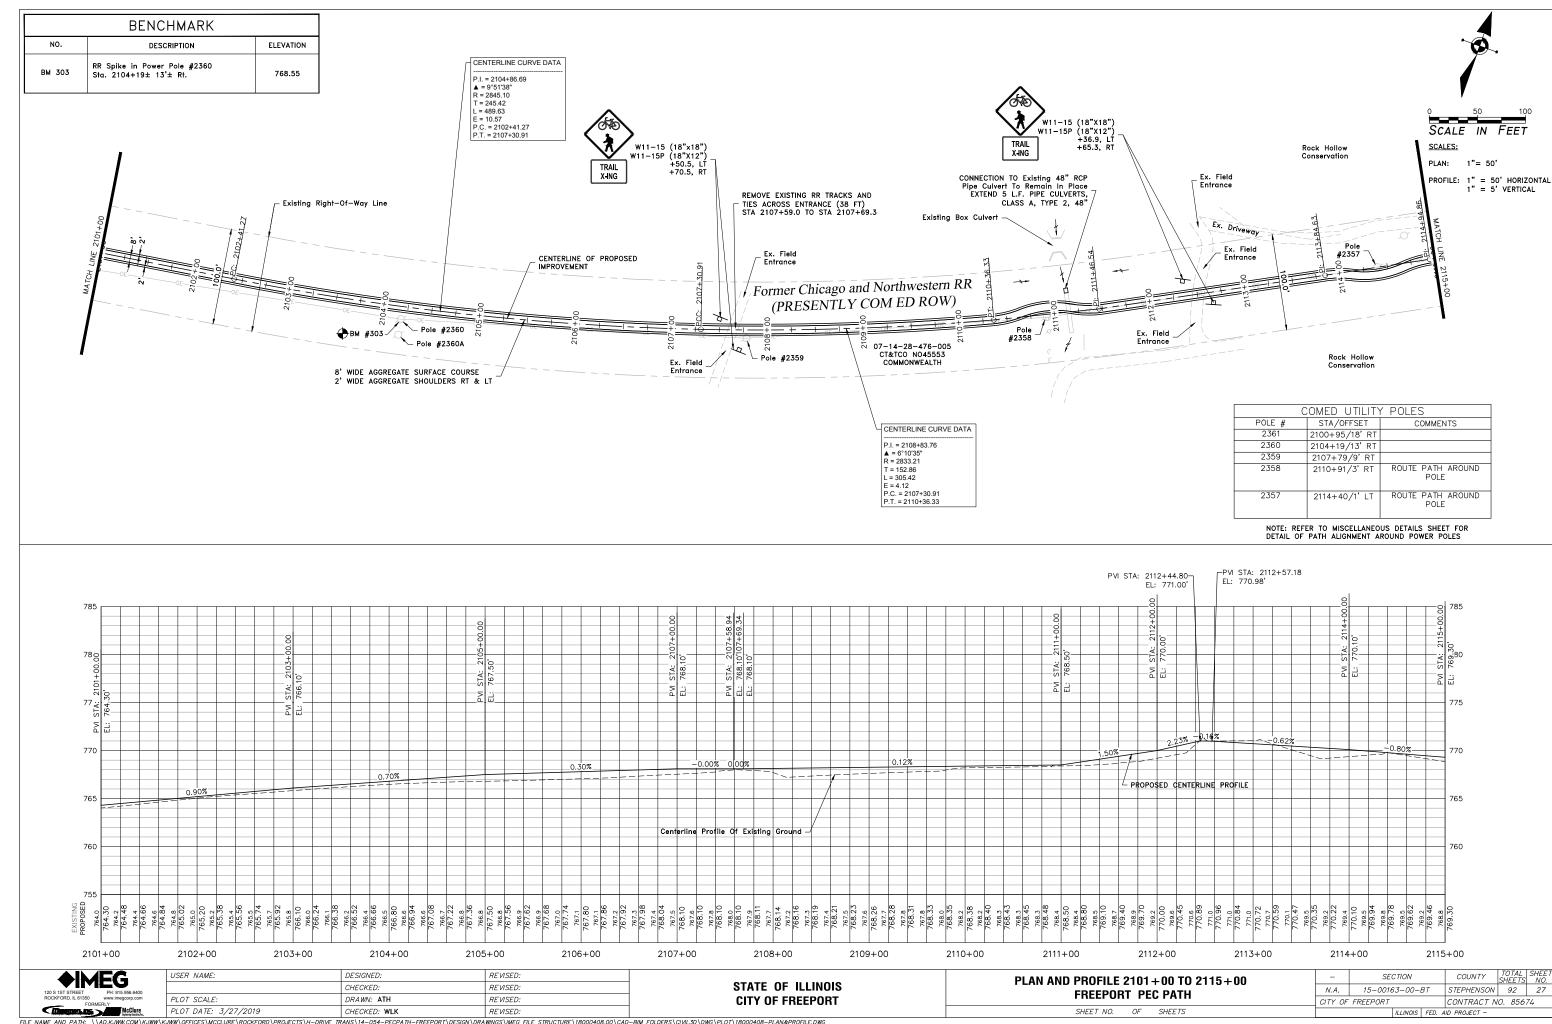

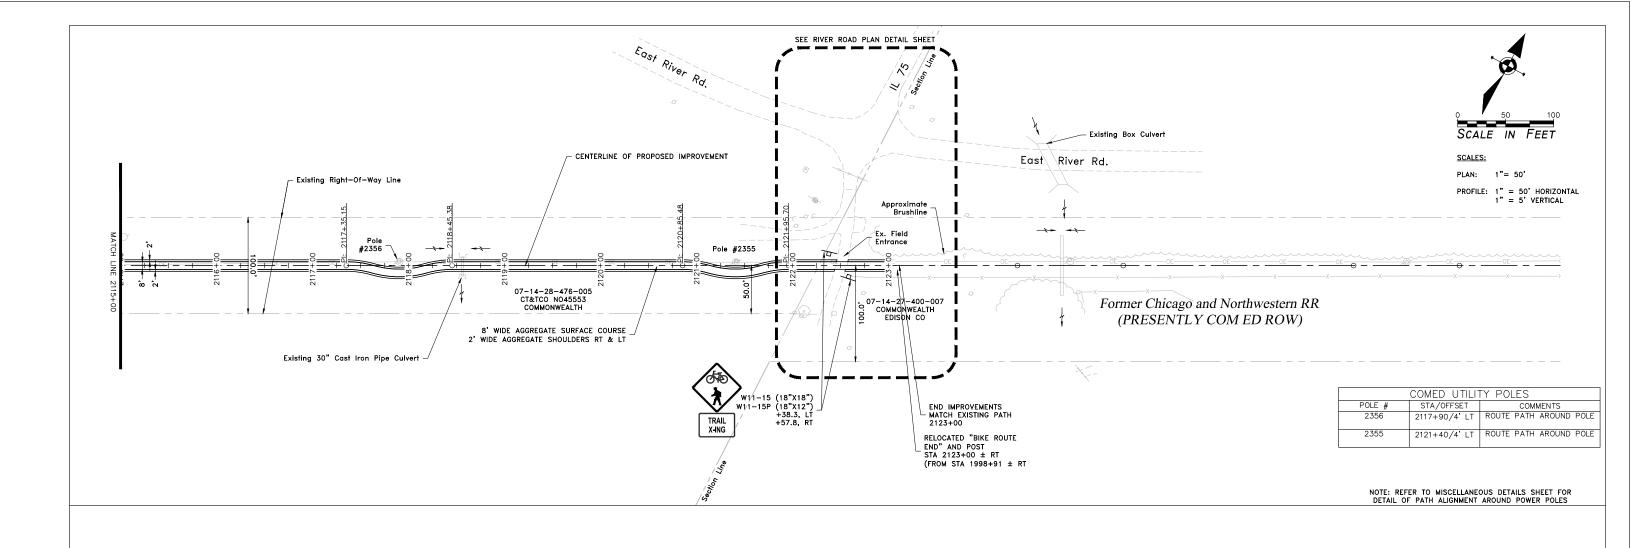

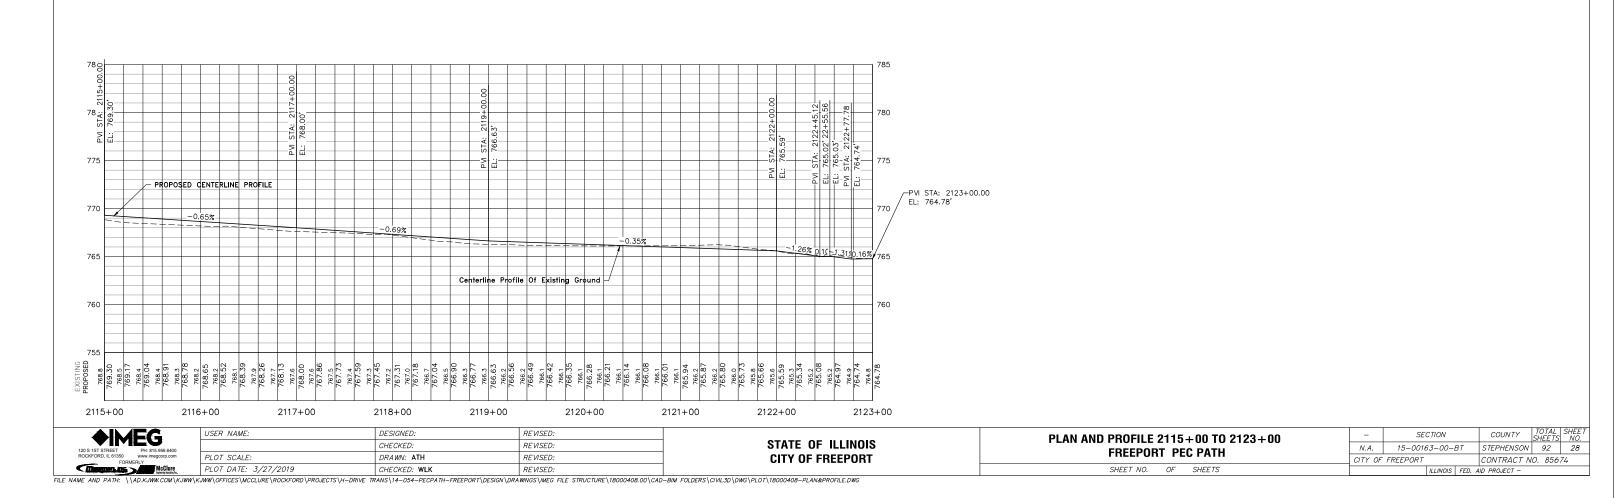

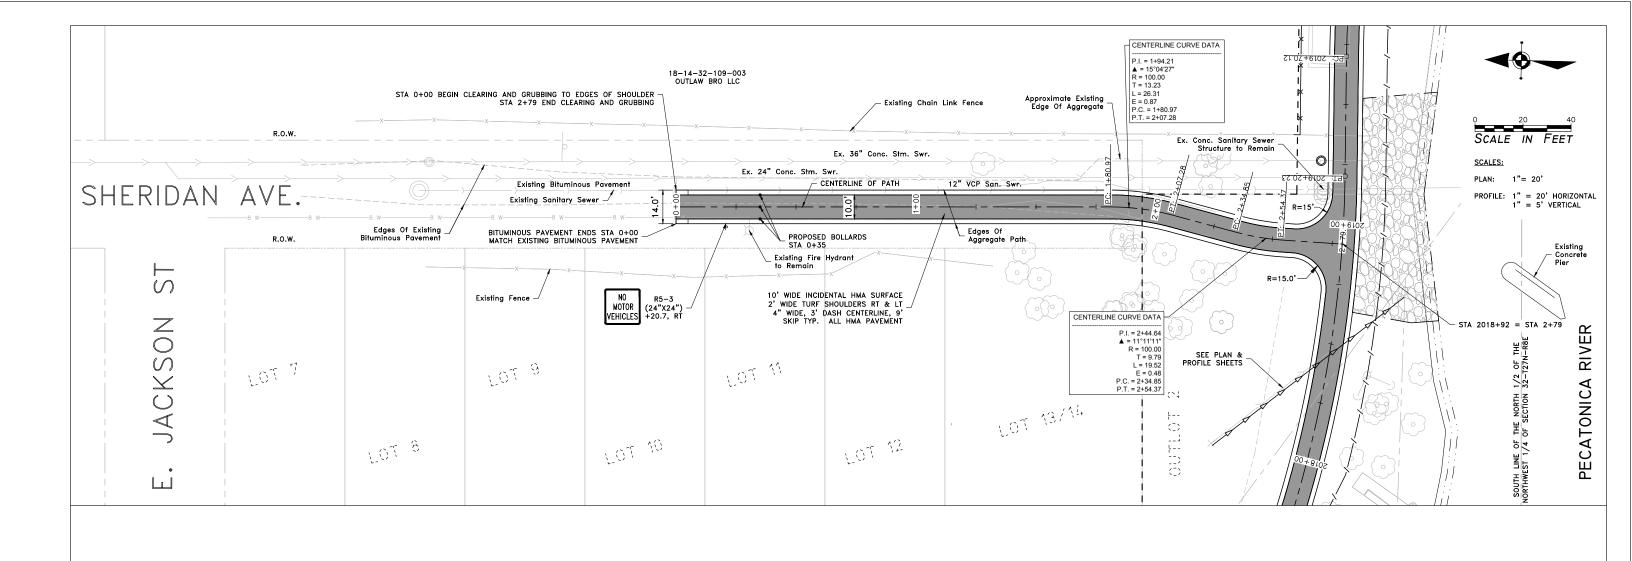

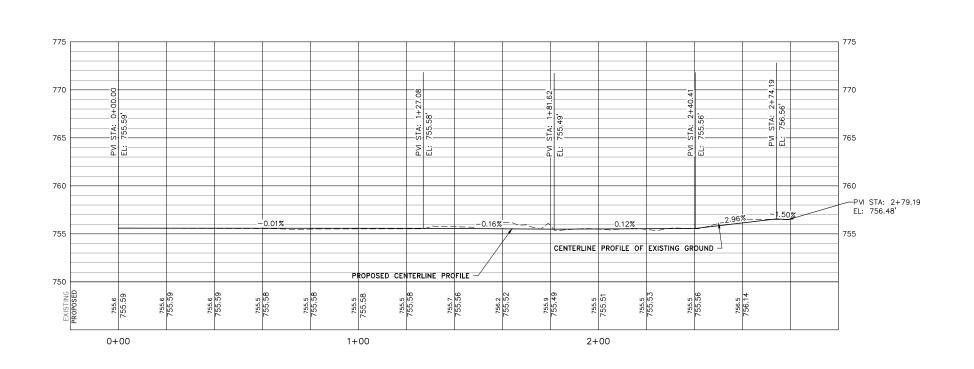

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PLOT DATE: 3/27/2019	CHECKED: WLK	REVISED:	

STATE OF ILLINOIS CITY OF FREEPORT


PLAN AND PROFILE SHERIDAN AVE. 0+00 TO 2+79
FREEPORT PEC PATH


SHEET NO. OF SHEETS


- SECTION COUNTY TOTAL SHEET NO.

N.A. 15-00163-00-BT STEPHENSON 92 29

CITY OF FREEPORT CONTRACT NO. 85674

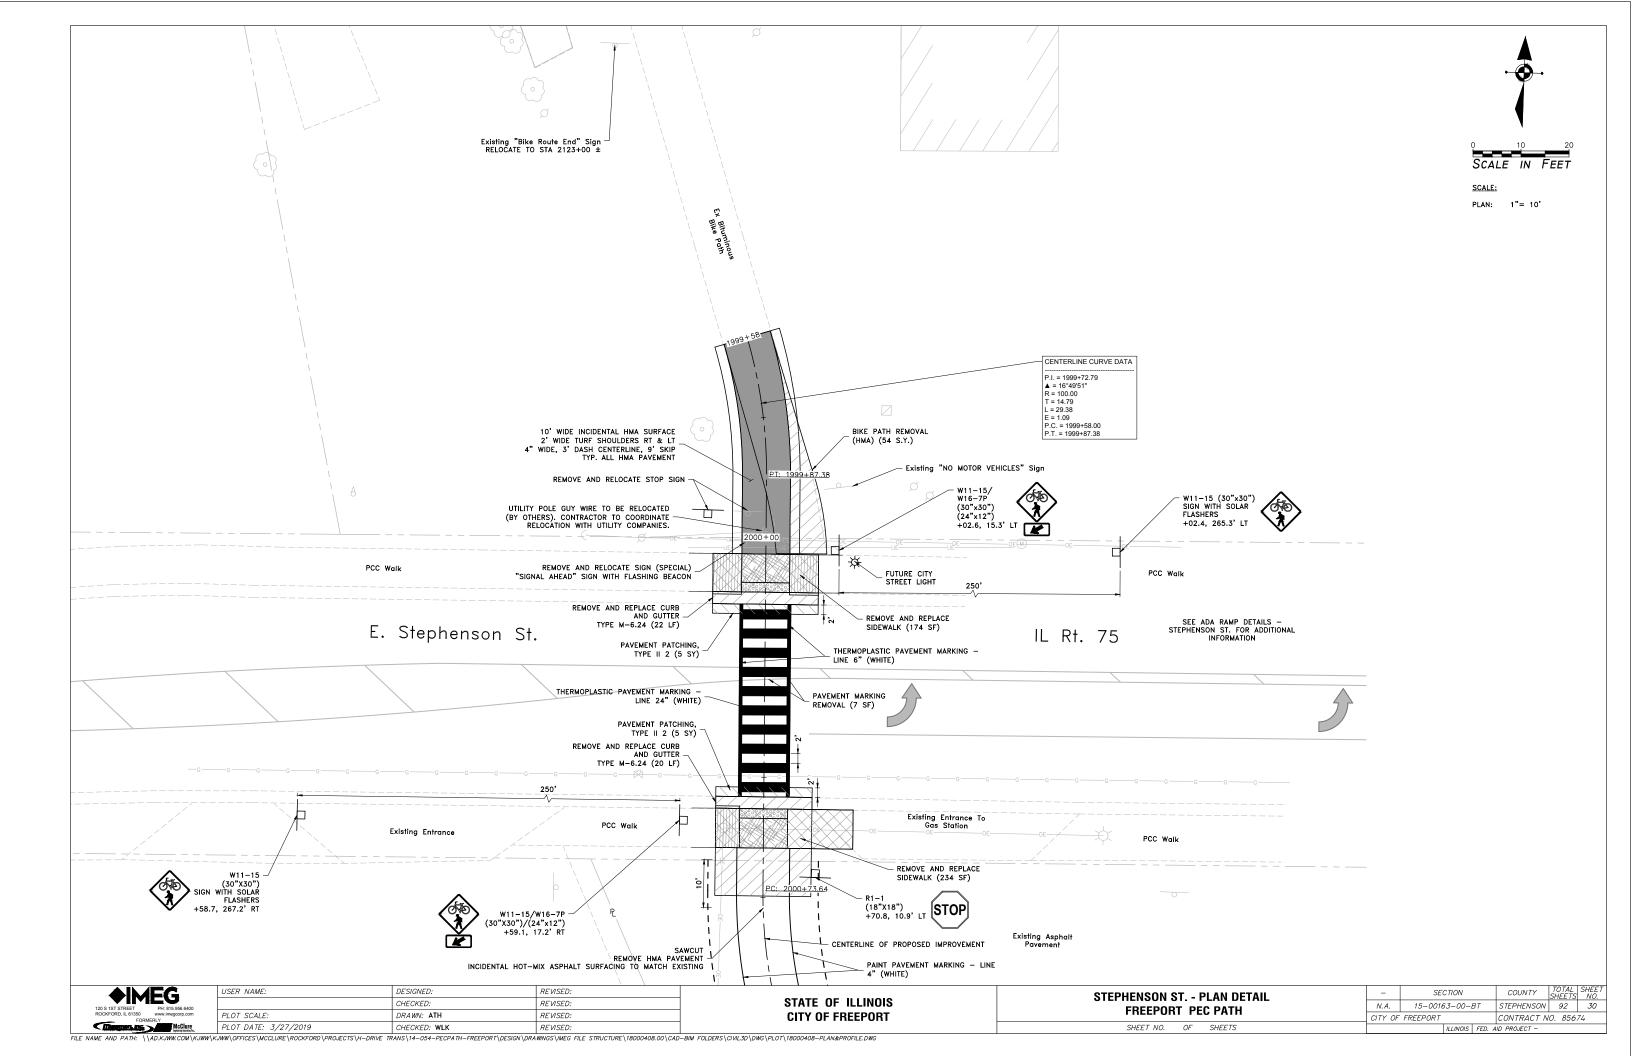

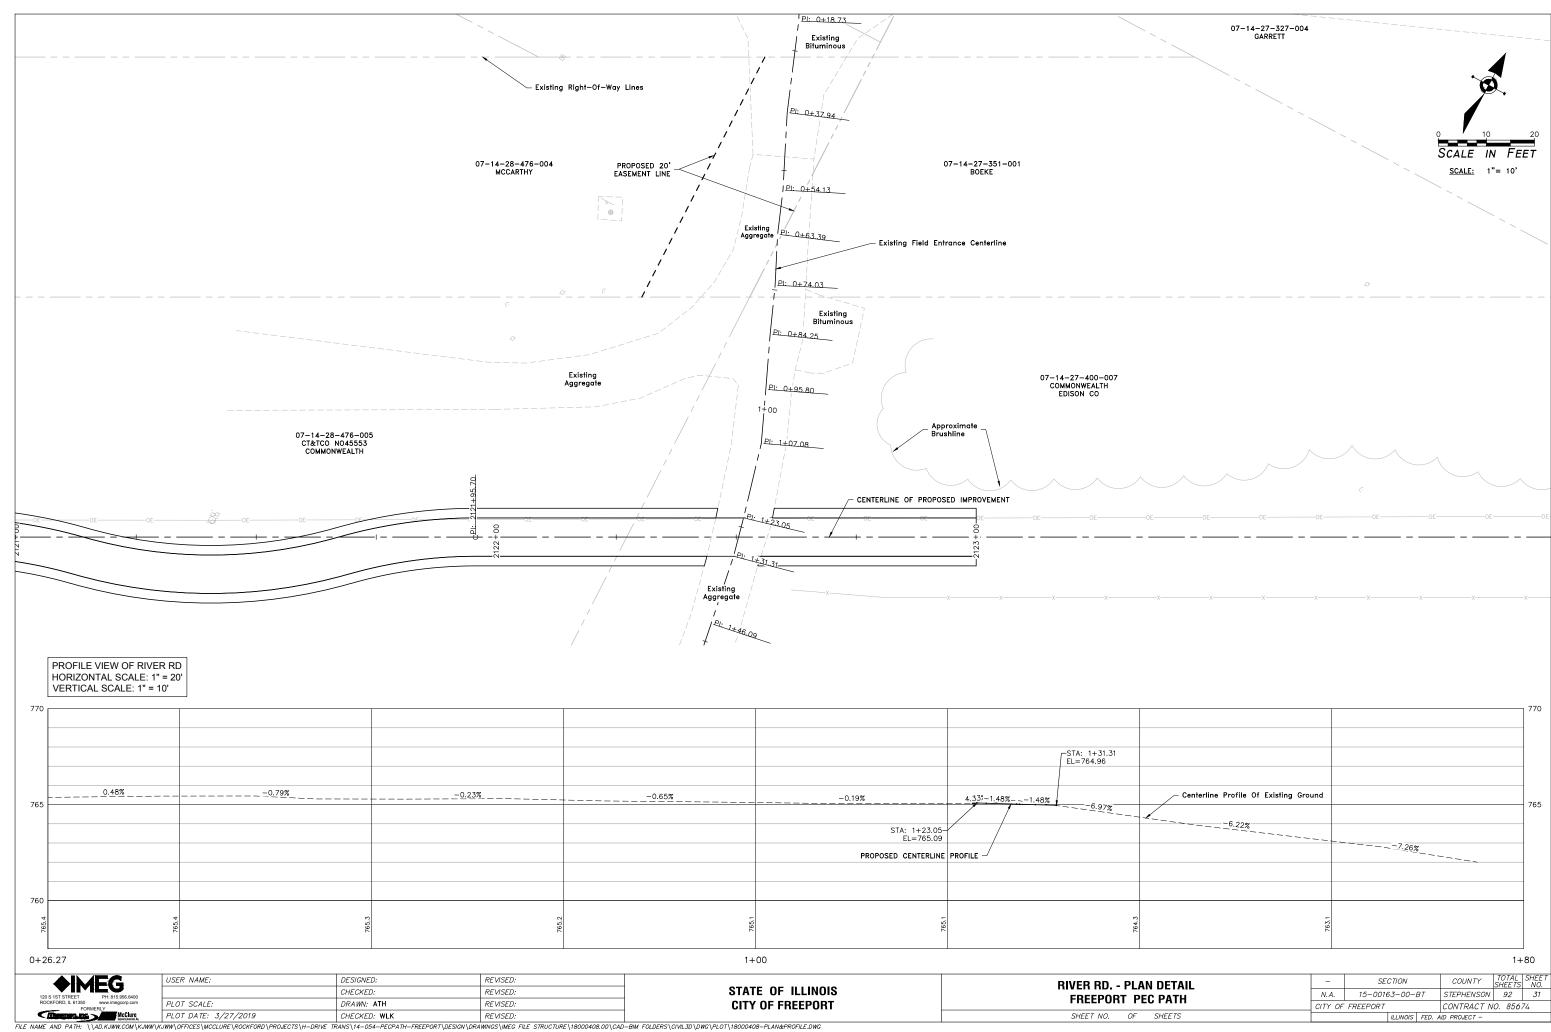

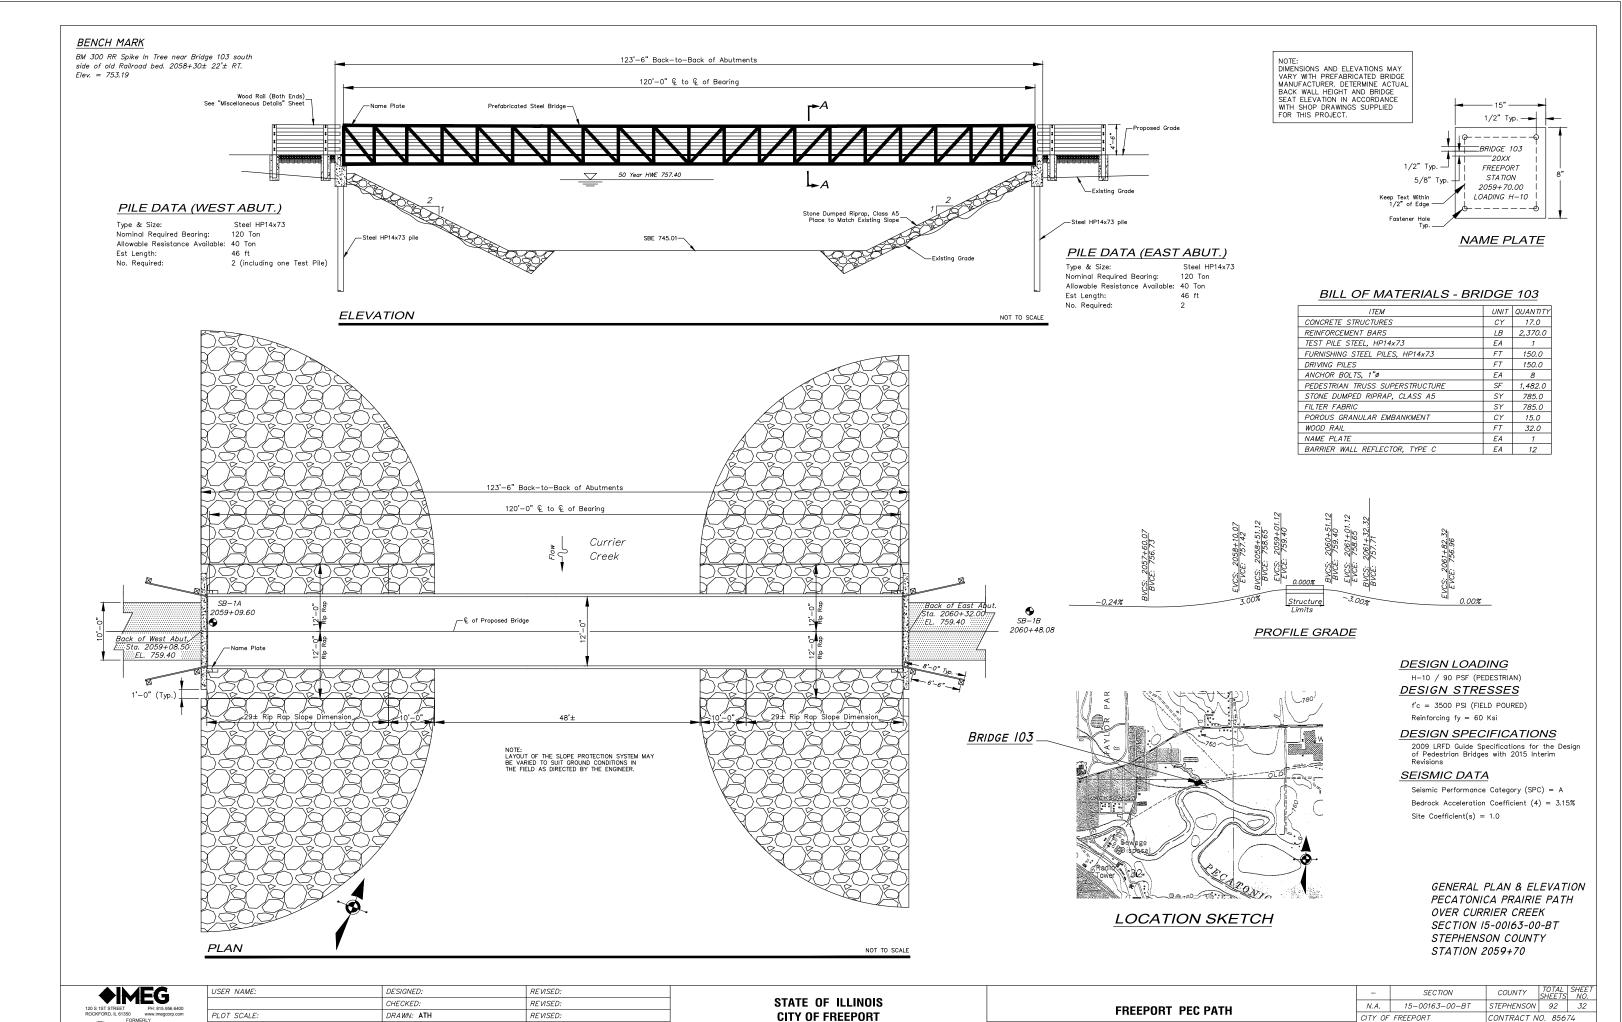


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ILLINOIS FED. AID PROJECT -

REVISED:

CHECKED: WLK

PLOT DATE: 3/27/2019

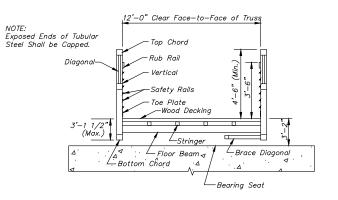

SECTION A-A

NOT TO SCALE

-Stone Dumped Riprap, Class A5

TYPICAL STONE RIPRAP TREATMENT


NOT TO SCALE

NOTE:
DIMENSIONS AND ELEVATIONS MAY
VARY WITH PREFABRICATED BRIDGE
MANUFACTURER. DETERMINE ACTUAL
BACK WALL HEIGHT AND BRIDGE
SEAT ELEVATION IN ACCORDANCE
WITH SHOP DRAWINGS SUPPLIED
FOR THIS PROJECT.

BILL OF MATERIAL FOR BOTH ABUTMENTS


Bar	No.	Size	Length	Shape
h	16	#5	16'-0"	
h ₁	8	#5	6'-0"	_
h ₂	48	#5	5'-0"	_
р	28	#6	16'-0"	
S	32	#5	11'-2"	
S1	32	#5	11'-4"	П
u	20	#6	7'-4"	П
*v	24	#5	6'-4"	
Reinforcement Bars		LB	2,370.0	
Concrete Structures			CY	17.0
Anchor Bolts		EA	8	

* Cut v Bars to Fit Top of Wall Taper

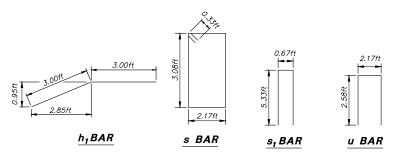

3'-0" 16'-0" 3'-0" 16 - #5 s . Bars at 12" cts. -4 - #5 h , Bars (2 Per Side) 6-#5 v Bars* (3 Per Face) © of Path and Bridge - #16 h₂ Bars (6 Per Face) 4 - #6 p Bars (Top Face) 6 - #6 p Bars Even Spaces (3 Per Face) (Bott. Face) 5 – #6 u Bars 16 - #5 s Bars at 12" cte 2'-0" *Cut v Bars to Fit Top of Wall Taper


SECTION B-B

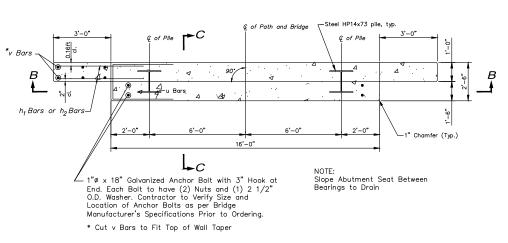



PLAN NOT TO SCALE

BRIDGE 103 NOTES

- "BRIDGE GENERAL NOTES" SHEET FOR ADDITIONAL PREFABRICATED STEEL BRIDGE GENERAL NOTES.
- 2. ALL TREE REMOVAL AND SELECTIVE BRUSH CLEARING SHALL BE IN ACCORDANCE WITH THE PLANS AND SPECIAL PROVISIONS OR AS DIRECTED BY THE ENGINEER. TREE REMOVAL AND SELECTIVE CLEARING WILL BE MEASURED AND PAID FOR AT THE CONTRACT UNIT PRICE FOR THE APPROPRIATE IEM.
- 3. CONTRACTOR SHALL PROVIDE NAME PLATE CONSTRUCTION DETAILS WITH THE SHOP DRAWINGS SUBMITTAL. NAME PLATES SHALL BE OF SIMILAR MATERIAL AND ATTACHED TO THE TRUSS SUPERSTRUCTURE ON THE RIGHT HAND SIDE OF APPROACH END WHILE LOCKING IN THE DIRECTION OF INCREASING STATIONING REFER TO NAME PLATE DETAIL FOR APPROXIMATE SIZE AND MINIMUM BRIDGE DATA REQUIRED.

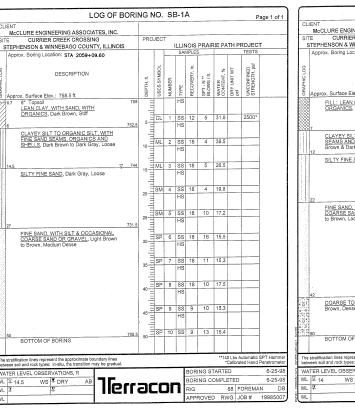

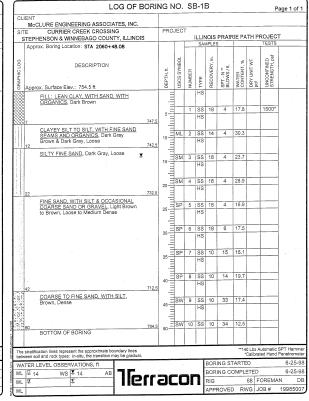

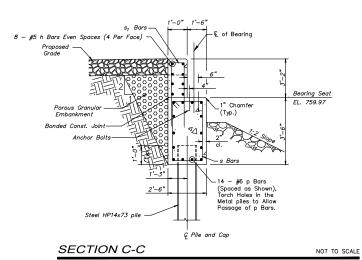


BRIDGE DETAILS PECATONICA PRAIRIE PATH OVER CURRIER CREEK SECTION 15-00163-00-BT STEPHENSON COUNTY STATION 2060+75





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PLOT DATE: 3/27/2019	CHECKED: WLK	REVISED:

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FREEPORT PEC PATH		SECTION	COUNTY	TOTAL SHEETS	SHEET NO.
		15-00163-00-BT	STEPHENSON	92	33
		FREEPORT	CONTRACT N	0. 856.	74
SHEET NO. OF SHEETS		ILLINOIS FED.	ND PROJECT -		



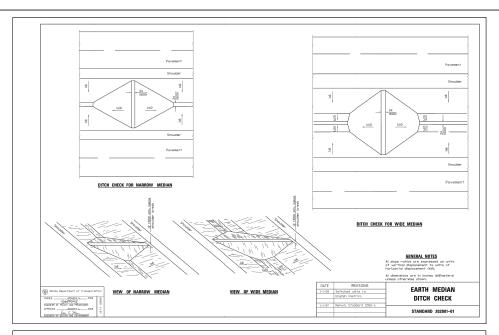

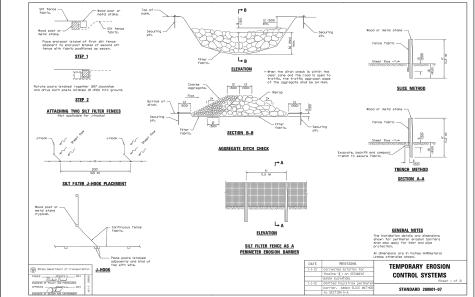

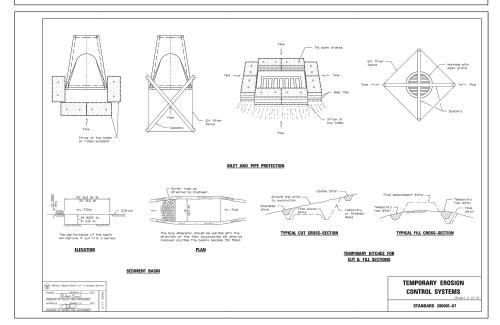TOPSOIL / SEEDING

- 1. DISTURBED AREAS ARE LOCATIONS WHERE THE CONTRACTOR'S OPERATIONS HAVE DAMAGED EXISTING GROUND COVER AND/OR TOPSOIL OUTSIDE OF THE LIMITS OF CONSTRUCTION AS SHOWN IN THE PLANS. SEEDING OF THESE DISTURBED AREAS IS INCLUDED IN ALL THE OTHER PROJECT PAY ITEMS AND NO ADDITIONAL COMPENSATION IS ALLOWED.
- 2. THE FINAL TOP 4 INCHES OF SOIL IN ANY AREA MUST BE A COHESIVE SOIL CAPABLE OF SUPPORTING VEGETATION.
- 3. FERTILIZER SHALL BE APPLIED AT A RATE OF 180 LB/AC TO ALL DISTURBED AREAS AND INCORPORATED INTO THE SEEDBED PRIOR TO SOWING THE SEED.
- 4. THE CONTRACTOR SHALL SEED ALL AREAS WITHIN THE LIMITS OF CONSTRUCTION WITH SEEDING, CLASS 1 OR CLASS 4, WHERE INDICATED, IN ACCORDANCE WITH IDOT STANDARD SPECIFICATIONS OR AS APPROVED BY THE ENGINEER.

MAINTENANCE NOTES

ALL BMP MEASURES STATED ON THIS STORM WATER POLLUTION PREVENTION MAP AND PLAN SHALL BE MAINTAINED IN FULLY FUNCTIONAL CONDITION UNTIL NO LONGER REQUIRED FOR A COMPLETED PHASE OF WORK OR FINAL STABILIZATION OF THE ROADWAY PROJECT. ALL EROSION AND SEDIMENTATION CONTROL MEASURES SHALL BE CHECKED AND ENTERED INTO AN INSPECTION RECORD LOG BY A QUALIFIED PERSON AT LEAST ONCE EVERY SEVEN (7) CALENDAR DAYS AND WITHIN 24 HOURS OF THE END OF A 0.5" RAINFALL EVENT, AND CLEANED AND REPAIRED IN ACCORDANCE WITH THE FOLLOWING.

- 1. INLET PROTECTION DEVICES AND BARRIERS SHALL BE REPAIRED OR REPLACED IF THEY SHOW SIGNS OF UNDERMINING, OR DETERIORATION.
- 2. ALL SEEDED AREAS SHALL BE CHECKED REGULARLY TO SEE THAT A GOOD STAND IS ACHIEVED AND MAINTAINED. AREAS SHOULD BE FERTILIZED, WATERED, MULCHED AND RESEEDED AS NEEDED.


4th

- 3. SILT FENCES SHALL BE REPAIRED TO THEIR ORIGINAL CONDITIONS IF DAMAGED. SEDIMENT SHALL BE REMOVED FROM THE SILT FENCES WHEN IT REACHES ONE—HALF THE HEIGHT OF THE SILT
- 4. THE CONSTRUCTION AREA ACCESSES SHALL BE MAINTAINED IN A CONDITION WHICH WILL PREVENT TRACKING OR FLOW OF MUD ONTO PAVED ROAD SURFACES OR OUTSIDE WORK AREA. THIS MAY REQUIRE PERIODIC ROAD SWEEPING.

STORMWATER POLLUTION PREVENTION

- 1. THE STORMWATER POLLUTION PREVENTION PLAN IS COMPRISED OF THE PLAN DRAWING MAPS, SWPPP PLAN NARRATIVE SPECIFICATIONS, THE PERMIT AND ALL SUBSEQUENT REPORTS AND
- 2. ALL CONTRACTORS AND SUBCONTRACTORS INVOLVED WITH STORM WATER POLLUTION PREVENTION SHALL OBTAIN A COPY OF THE STORM WATER POLLUTION PREVENTION PLAN, ILLINOIS EPA NPDES GENERAL PERMIT AND BECOME FAMILIAR WITH THEIR CONTENTS.
- 3. CONTRACTOR SHALL IMPLEMENT BEST MANAGEMENT PRACTICES (BMP) AS REQUIRED BY THE SWPPP. ADDITIONAL BEST MANAGEMENT PRACTICES SHALL BE IMPLEMENTED AS DICTATED BY CONDITIONS AT NO ADDITIONAL COST TO OWNER THROUGHOUT ALL PHASES OF CONSTRUCTION.
- 4. BEST MANAGEMENT PRACTICES (BMP'S) AND CONTROLS SHALL CONFORM TO FEDERAL, STATE, OR LOCAL REQUIREMENTS OR MANUAL OF PRACTICE, AS APPLICABLE. CONTRACTOR SHALL IMPLEMENT ADDITIONAL CONTROLS AS DIRECTED BY PERMITTING AGENCY OR OWNER.
- 5. GENERAL CONTRACTOR SHALL DENOTE ON PLAN THE TEMPORARY PARKING AND STORAGE AREA WHICH SHALL ALSO BE USED AS THE EQUIPMENT MAINTENANCE AND CLEANING AREA.
- ALL WASH WATER (CONCRETE TRUCKS, VEHICLE CLEANING, EQUIPMENT CLEANING, ETC.) SHALL BE DETAINED AND PROPERLY TREATED OR DISPOSED.
- 7. QUALIFIED PERSONNEL SHALL INSPECT DISTURBED AREAS OF THE CONSTRUCTION SITE WHICH HAVE NOT YET BEEN FINALLY STABILIZED, STRUCTURAL CONTROL MEASURES, AND LOCATIONS WHERE VEHICLES AND EQUIPMENT ENTER AND EXIT THE SITE. SUCH INSPECTIONS SHALL BE CONDUCTED AT LEAST ONCE EVERY SEVEN (7) CALENDAR DAYS AND WITHOU 24 HOURS OF THE END OF A STORM THAT IS 0.5 INCHES OR GREATER OR EQUIVALENT SNOWFALL.
- 8. SUFFICIENT OIL AND GREASE ABSORBING MATERIALS AND OIL CONTAINMENT FLOATING BOOMS SHALL BE MAINTAINED ON SITE OR READILY AVAILABLE TO CONTAIN AND CLEAN-UP FUEL OR CHEMICAL SPILLS AND LEAKS.
- 9. TEMPORARY SEEDING THIS ITEM WILL BE APPLIED TO ALL BARE AREAS EVERY SEVEN DAYS TO MINIMIZE THE AMOUNT OF EXPOSED SURFACE AREAS. EARTH STOCKPILES SHALL BE TEMPORARILY SEEDED IF THEY ARE TO REMAIN UNUSED FOR MORE THAN 14 DAYS. WITHIN THE CONSTRUCTION LIMITS, AREAS WHICH MAY BE SUSCEPTIBLE TO EROSION AS DETERMINED BY THE ENGINEER SHALL REMAIN UNDISTURBED UNTIL FULL SCALE CONSTRUCTION IS UNDERWAY TO PREVENT UNNECESSARY SOIL EROSION. BARE AND SPARSELY VEGETATED GROUND IN HIGHLY ERODIBLE AREAS AS DETERMINED BY THE ENGINEER SHALL BE TEMPORARILY SEEDED AT THE BEGINNING OF CONSTRUCTION WHERE NO CONSTRUCTION WHERE AND CONSTRUCTION WHERE AND CONSTRUCTION WHERE AND SPARSELY SEEDED AT THE BEGINNING OF CONSTRUCTION WHERE NO CONSTRUCTION ACTIVITIES ARE EXPECTED WITHIN ?
- 10. DISTURBED PORTIONS OF THE SITE WHERE CONSTRUCTION ACTIVITY HAS PERMANENTLY STOPPED SHALL BE PERMANENTLY SEEDED. THESE AREAS SHALL BE SEEDED NO LATER THAN 7 DAYS AFTER THE LAST CONSTRUCTION ACTIVITY OCCURRING IN THESE AREAS.
- 11. ALL MATERIALS SPILLED, DROPPED, WASHED, OR TRACKED FROM VEHICLES ONTO ROADWAY OR INTO STORM DRAINS MUST BE REMOVED IMMEDIATELY.
- 12. CONTRACTORS OR SUBCONTRACTORS WILL BE RESPONSIBLE FOR REMOVING SEDIMENT THAT MAY HAVE COLLECTED IN THE STORM SEWER DRAINAGE SYSTEMS IN CONJUNCTION WITH THE STABILIZATION OF THE SITE.
- 13. SLOPES SHALL BE LEFT IN A ROUGHENED CONDITION DURING THE GRADING PHASE TO REDUCE RUNOFF VELOCITIES AND EROSION.
- 14. DUE TO THE GRADE CHANGES DURING THE DEVELOPMENT OF THE PROJECT, THE CONTRACTORS SHALL BE RESPONSIBLE FOR ADJUSTING THE EROSION CONTROL MEASURES (SILT FENCES, DITCH CHECKS, ETC.) TO PREVENT EROSION.
- 15. ALL CONSTRUCTION SHALL BE STABILIZED AT THE END OF EACH WORKING DAY. THIS INCLUDES BACKFILLING OF TRENCHES FOR UTILITY CONSTRUCTION AND PLACEMENT OF GRAVEL OR HMA PAVING FOR ROAD CONSTRUCTION
- 16. INLET PROTECTION MUST BE PROVIDED AND MAINTAINED FOR ALL PROPOSED INLETS UNTIL FINAL GRADES HAVE BEEN ESTABLISHED.
- 17. THE EROSION CONTROL MEASURES INDICATED ON THE DRAWING MAPS ARE THE MINIMUM
- 18. TEMPORARY SLOPES AND GROUND SHALL BE MAINTAINED IN ROUGHENED STATE AS A BMP TO DISCOURAGE RILL EROSION.

SITE LOCATION MAP (NOT TO SCALE)

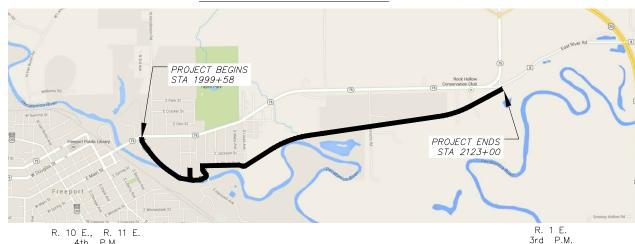


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STATE OF ILLINOIS **CITY OF FREEPORT**

SECTION STORM WATER POLLUTION PREVENTION PLAN N.A. FREEPORT PEC PATH CITY OF FREEPORT SHEET NO. OF SHEETS

COUNTY SHÉÉTS 15-00163-00-BT STEPHENSON 92 34 CONTRACT NO. 85674



GENERAL NOTES:

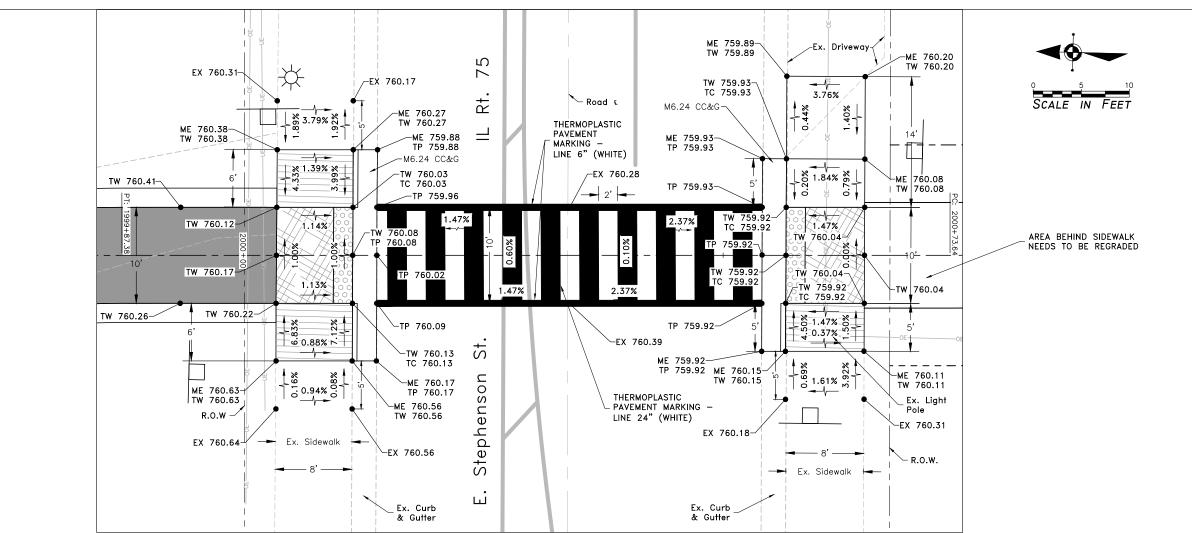- 1. ALL DETECTABLE WARNINGS ARE 24" WIDE. MEASURED FROM
- 2. ALL RAMP SLOPES EQUAL TO OR GREATER THAN 1:20 REQUIRE AN UPPER LEVEL LANDING A MINIMUM OF 5' LONG. UPPER LEVEL LANDINGS ARE NOT REQUIRED FOR RAMP SLOPES FLATTER THAN 1:20.
- 3. MAXIMUM SLOPE OF SIDEWALK RAMP SHALL NOT EXCEED 12:1 OR SHALL BE A MAXIMUM LENGTH OF 15 FEET.
- 4. 6" WIDE VARIABLE HEIGHT CURB ALONG SIDEWALK SHALL BE MEASURED AND PAID AS PORTLAND CEMENT CONCRETE SIDEWALK.
- 5. DETECTABLE WARNINGS ASSUME THE USE OF PREFABRICATED TILE WITH NO FIELD CUTTING REQUIRED. RADII TILE SHALL BE USED WHERE MORE THAN 8' OF WIDTH IS REQUIRED.

CURB RAMP STANDARDS INCLUDE:
424001 PERPENDICULAR CURB RAMPS FOR SIDEWALKS 424006 DIAGONAL CURB RAMPS FOR SIDEWALKS CORNER PARALLEL CURB RAMPS FOR SIDEWALKS

424021 DEPRESSED CORNER FOR SIDEWALKS

DETECTABLE WARNINGS

LEVEL LANDING (MAX. GRADE = 2.00%)

(MIN SLOPE = 1:20 - 5.00%) (MAX SLOPE = 1:12 - 8.33%) (MAX LENGTH = 15') RUNNING SLOPE




ABBREVIATIONS USED ON THIS SHEET

ME = MATCH EXISTING TC = TOP OF CURB ELEVATION
TP = TOP OF PAVEMENT ELEVATION

HMA

TW = TOP OF WALK ELEVATION

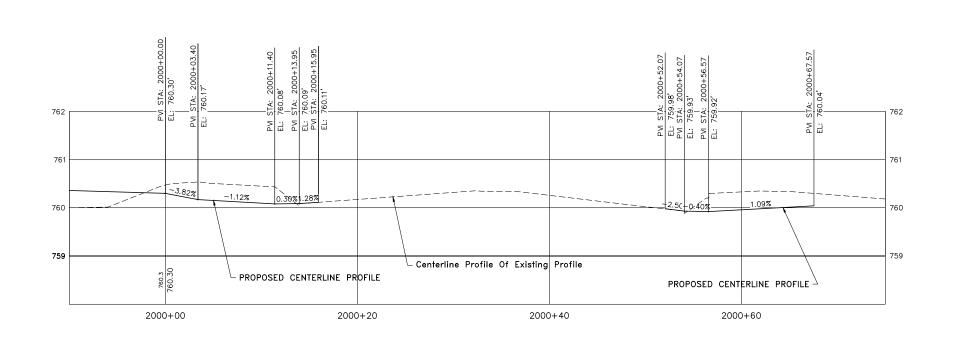

HORIZONTAL SCALE I" = 5' VERTICAL SCALE I" = I'


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ROCKFORD, IL 61350	www.imegcorp.com
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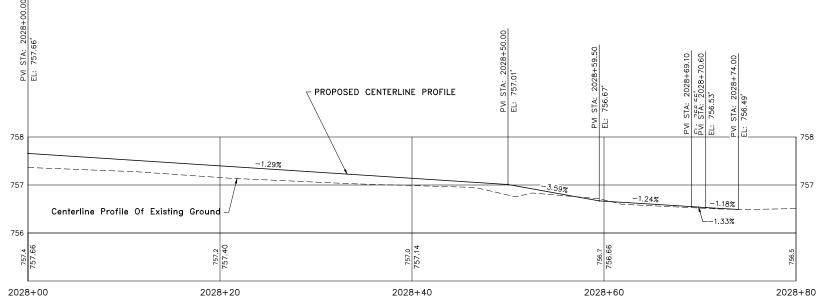
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STATE OF ILLINOIS CITY OF FREEPORT

ADA RAMP DETAILS - STEPHENSON ST. FREEPORT PEC PATH SHEET NO. OF SHEETS

SECTION TOTAL SHEE SHEETS NO. 15-00163-00-BT STEPHENSON 92 35 CITY OF FREEPORT CONTRACT NO. 85674 ILLINOIS FED. AID PROJECT -




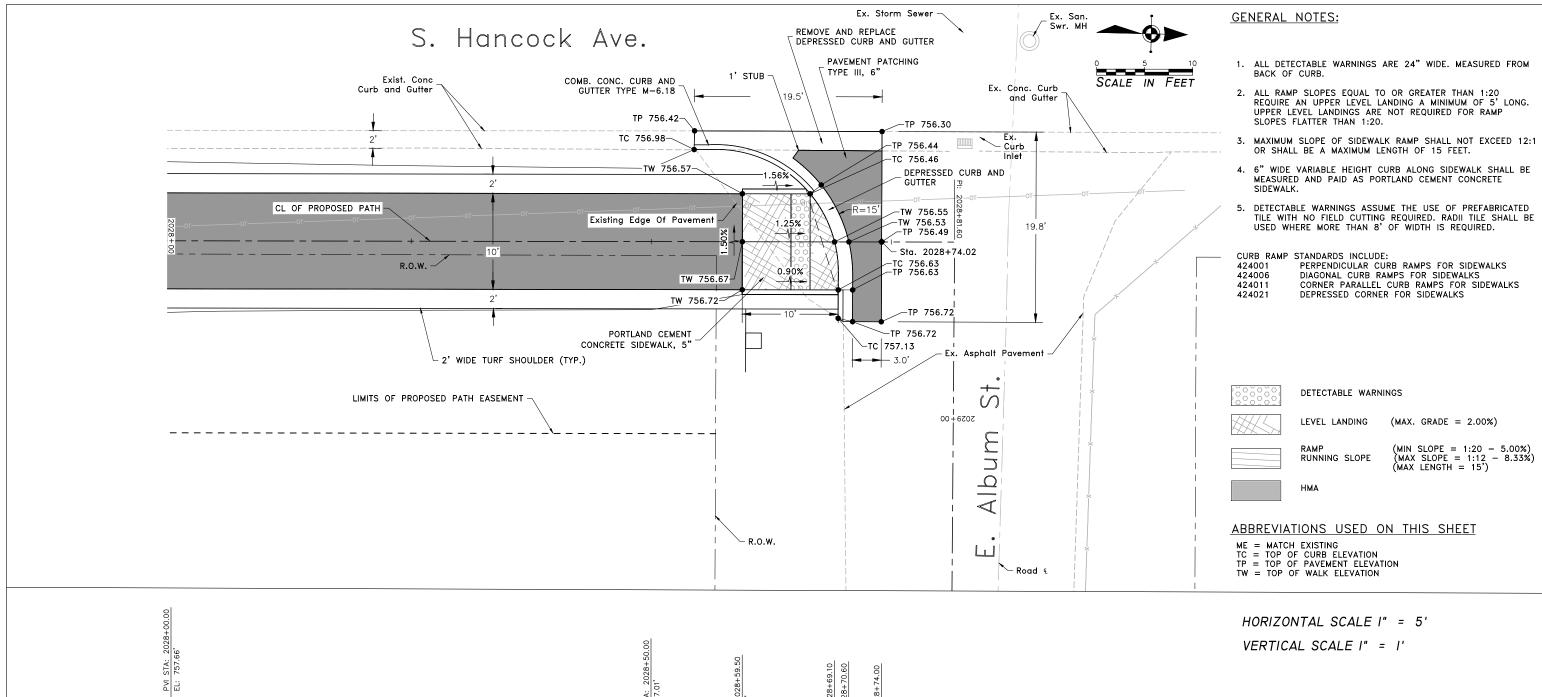


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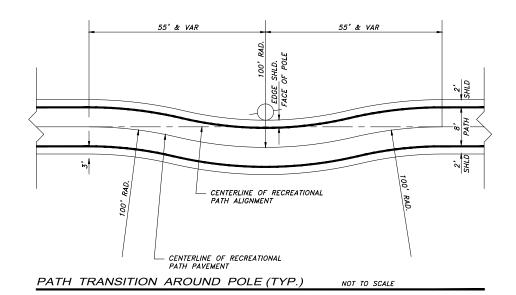
STATE OF ILLINOIS CITY OF FREEPORT




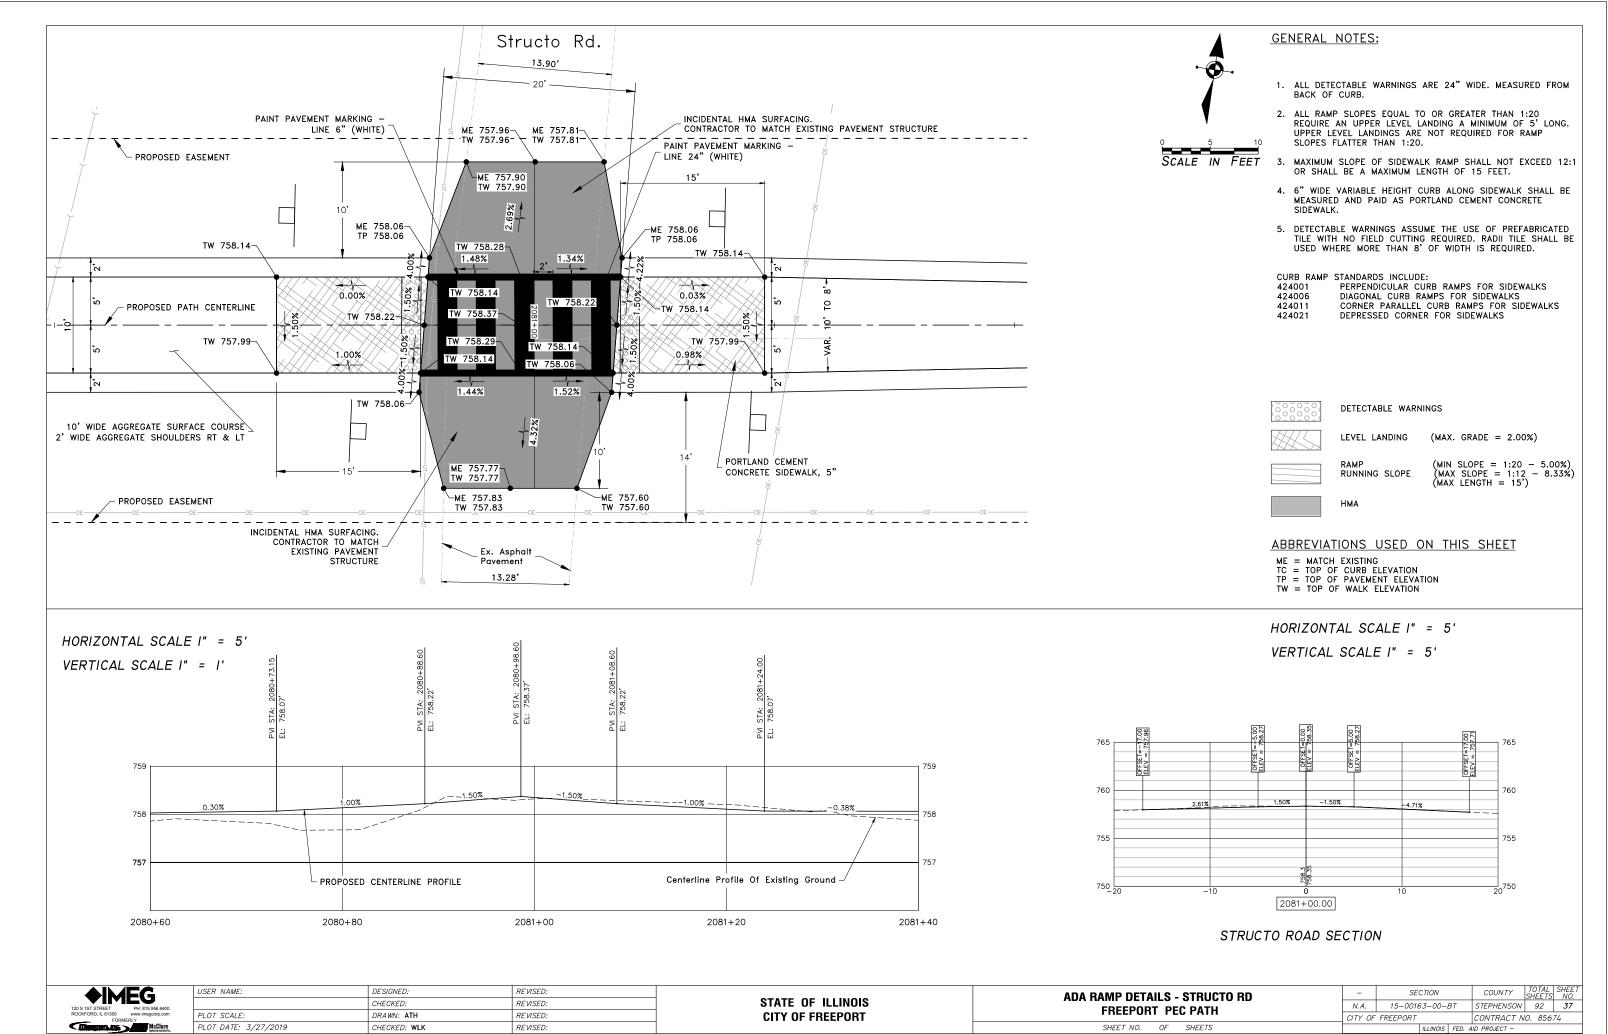


(See BRIDGE 103 GENERAL NOTES AND PLAN SHEETS for Additional Information)

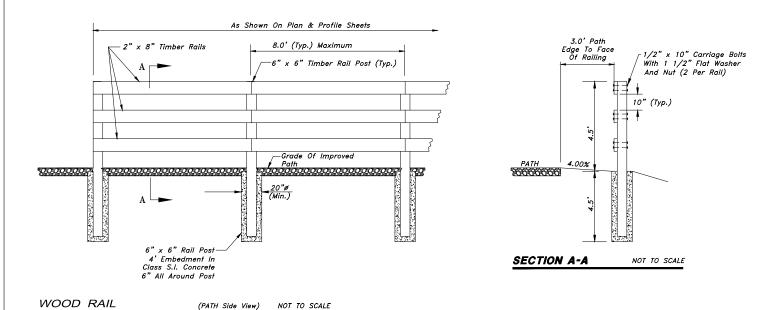(PATH Side View) NOT TO SCALE



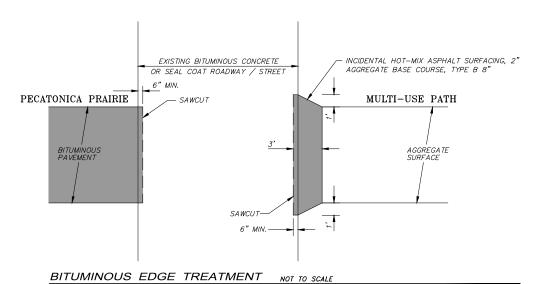

HMA OR AGG

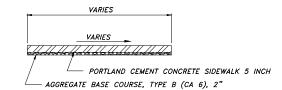

NOTE:
AGGREGATE BASE COURSE TYPE B, 2" WILL NOT BE PAID FOR SEPARATELY, BUT SHALL BE CONSIDERED INCLUDED IN THE CONTRACT UNIT PRICE FOR PORTLAND CEMENT CONCRETE SIDEWALK — 5 INCH.


SEE ADA DETAILS FOR ADDITIONAL INFORMATION.


FOR THE SIDEWALK UNDER THE HANCOCK BRIDGE, SEE $\underline{CONCRETE\ PAVED\ SECTION\ UNDER\ HANCOCK\ AVE.\ BRIDGE\ TYPICAL\ SECTION$

PORTLAND CEMENT CONCRETE SIDEWALK - 5 INCH

NOT TO SCALE

AIMEG	USER NAME:	DESIGNED:	REVISED:		MISCELLANEOUS DETAILS	- SECTION	COUNTY	TOTAL SHEET
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120 S 1ST STREET PH: 815.956.6400 ROCKFORD, IL 61350 www.imegcorp.com FORMERLY	PLOT SCALE:	DRAWN: ATH	REVISED:	CITY OF FREEPORT	FREEPORT PEC PATH	CITY OF FREEPORT	CONTRACT	NO. 85674
McClure	PLOT DATE: 3/27/2019	CHECKED: WLK	REVISED:		SHEET NO. OF SHEETS	ILLINOIS	FED. AID PROJECT -	

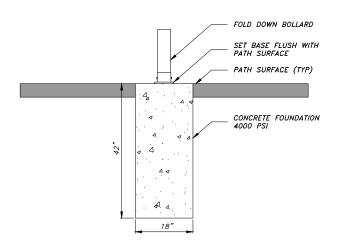

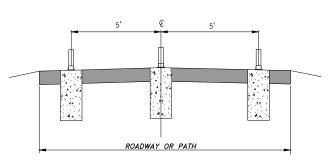

NOTE: BOLLARDS SHALL BE SINGLE POST WITH LOCK.

BOLLARDS SHALL BE INSTALLED PER MANUFACTURER'S SPECIFICATIONS.

COST OF INSTALLATION IS INCLUDED IN PAY ITEM.

FOLD DOWN BOLLARD DETAIL

(See PLAN & PROFILE SHEETS for LOCATIONS)

NOT TO SCALE

3'-0" MIN.
LINE POSTS
3'-6" MIN.
GATE OR
CORNER POSTS
4 TIMES POST DIA.


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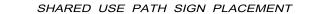
- 1. COLOR OF SLAT INSERTS SHALL BE "GREEN" AND SHALL BE APPROVED BY THE CITY OF FREEPORT ENGINEER PRIOR TO CONSTRUCTION.
- 2. CHAIN LINK FENCE MATERIALS AND INSTALLATION SHALL FOLLOW SECTION 664 OF IDDT STANDARD SPECIFICATIONS FOR ROAD AND BRIDGE CONSTRUCTION. SEE IDOT STANDARD DETAIL 664001.


FENCE (SPECIAL)

NOT TO SCALE

(See PLAN & PROFILE SHEETS for LOCATIONS)



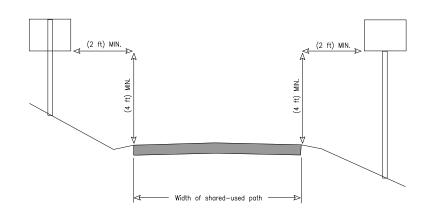


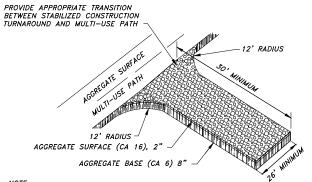

NOTE:
CONTRACTOR TO DETERMINE THE LOCATION BASED ON NEED. THE
LOCATION WILL BE APPROVED BY THE ENGINEER PRIOR TO INSTALLATION.
INCLUDED IN THE CONTRACT UNIT BID PRICE FOR GRADING AND SHAPING BIKEWAY.

CONSTRUCTION TURNAROUND

NOT TO SCALE

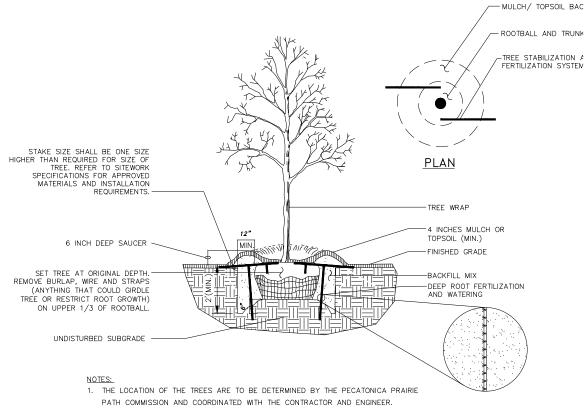

- SET TREE AT ORIGINAL DEPTH. REMOVE BURLAP, WIRE AND STRAPS (ANYTHING THAT COULD GIRDLE TREE OR RESTRICT ROOT GROWTH) ON UPPER 1/3 OF ROOT BALL.
- 3. SEE LANDSCAPE NOTES FOR THE TYPE OF MULCH MATERIAL TO USE.
- 4. PRUNE TREE AS DIRECTED BY LANDSCAPE ARCHITECT.
- 5. BRANCHING HEIGHT TO A.A.N. STANDARDS.

TREE PLANTING DETAIL

NOT TO SCALE

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USER NAME:	DESIGNED:	REVISED:
	CHECKED:	REVISED:
PLOT SCALE:	DRAWN: ATH	REVISED:
PLOT DATE: 4/5/2019	CHECKED: WLK	REVISED:


STATE OF ILLINOIS CITY OF FREEPORT MISCELLANEOUS DETAILS (2)
FREEPORT PEC PATH

SHEET NO. OF SHEETS

 SECTION
 COUNTY SHEETS NO.


 N.A.
 15-00163-00-BT
 STEPHENSON
 92
 39

 CITY OF FREEPORT
 CONTRACT NO.
 85674

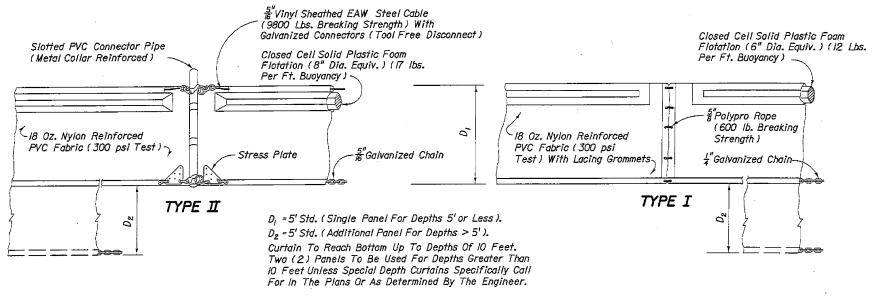

NOTICE: COMPONENTS OF TYPES I AND II MAY BE SIMILAR OR IDENTICAL
TO PROPRIETARY DESIGNS. ANY INFRINGEMENT ON THE PROPRIETARY
RIGHTS OF THE DESIGNER SHALL BE THE SOLE RESPONSIBILITY OF
THE USER. SUBSTITUTIONS FOR TYPES I AND II SHALL BE AS
APPROVED BY THE ENGINEER.

FLOATING TURBIDITY BARRIERS

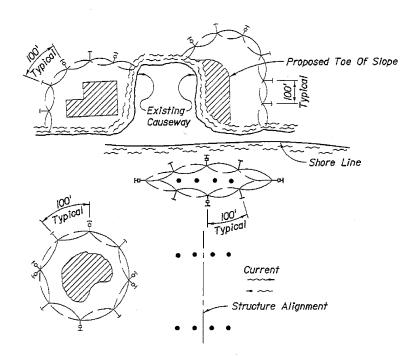


NOTES:

- I. Turbidity barriers are to be used in all permanent bodies of water regardless of water depth.
- 2. Number and spacing of anchors dependent on current velocities.
- 3. Deployment of barrier around pile locations may vary to accommodate construction operations.
- 4. Navigation may require segmenting barrier during construction operations.
- 5. Contractor to submit turbidity barrier shop drawings prior to construction.

LEGEND

- Pile Locations
- 加 Dredge Or Fill Area
- → Mooring Buoy w/Anchor
- → Anchor
- Barrier Movement Due
 To Current Action

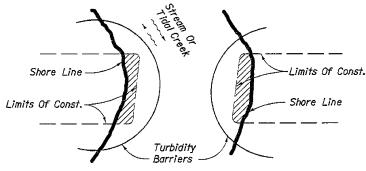

Note.

Turbidity barriers for flowing streams and tidal creeks may be either floating, or staked types or any combinations of types that will suit site conditions and meet erosion control and water quality requirements. The barrier type(s) will be at the Contractors option unless otherwise specified in the plans,

Posts in staked turbidity barriers to be installed in vertical position unless otherwise directed by the Engineer.

TURBIDITY BARRIER APPLICATIONS



DESIGNED:	REVISED:
CHECKED:	REVISED:
DRAWN: ATH	REVISED:
CHECKED: WLK	REVISED:
	CHECKED: DRAWN: ATH

STATE OF ILLINOIS CITY OF FREEPORT

MISCELLANE FREEPOR			
SHEET NO.	OF	SHEETS	

		7	- 5 -							
-	SE	CTION			COUNTY	TOTAL SHEETS	SHEET NO.			
N.A.	15-0016	53-00-l	BT		STEPHENSON	TEPHENSON 92				
TY OF	FREEPORT				CONTRACT N	0. 856.	74			
		# LINIOIC	CED	-	ID DDG (EQT					

EARTHWORK SCHEDULE

	EARTH EXCAVATION 20200100	FURNISHED EXCAVATION 20400800							
		Areas Feet)		Cummulativ	e Total (Cu.				
Station	Cut	Fill	Distance	Cut	Feet)	(Cu. Y	Fill	Cut	Fill
1999+58.00	8.3	0.1	Distance	Cut		Cut		Cut	
2000+00.00			42	21.7	0.1	16.9	0.1	16.0	0.1
ç	13.4 STATION	0.0 LOMISS	ION F. ST	FPHENS	ON STRE	FT & FX	ISTING	16.9 PARKING LO	<u>0.1</u> Г
2002+50.00			T						
2003+00.00	8.1	0.0	50	16.1	0.0	14.9	0.0	16.9	0.1
2003+50.00	8.0	0.0	50	15.8	0.1	14.6	0.1	31.8	0.1
2004+00.00	7.8	0.1	50	15.7	0.1	14.5	0.1	46.4	0.2
2004+50.00	7.9	0.0	50	16.7	0.0	15.5	0.0	61.0	0.3
2005+00.00	8.8	0.0	50	14.9	0.3	13.8	0.3	76.4	0.3
	6.1	0.3	50	13.1	0.4	12.1	0.4	90.2	0.5
2005+50.00	7.0	0.1	50	14.0	0.1	13.0	0.1	102.3	0.9
2006+00.00	7.0	0.0	50	8.9	1.9	8.2	1.8	115.3	1.0
2006+50.00	1.9	1.9	50	72.7	1.9	67.3	1.8	123.5	2.8
2007+00.00	70.8	0.0	50	239.8	0.7	222.0	0.6	190.9	4.5
2007+50.00	169.0	0.7						412.9	5.2
2008+00.00	60.2	0.4	50	229.2	1.1	212.2	1.0	625.1	6.2
2008+50.00	9.2	0.1	50	69.4	0.5	64.3	0.5	689.4	6.7
2009+00.00	5.1	0.9	50	14.3	1.0	13.2	0.9	702.6	7.6
2009+50.00	13.7	0.0	50	18.8	0.9	17.4	0.8	720.0	8.4
2010+00.00	9.9	0.0	50	23.6	0.0	21.9	0.0	741.9	8.4
2010+50.00	6.4	0.1	50	16.3	0.1	15.1	0.1	757.0	8.5
2011+00.00	5.7	0.3	50	12.1	0.4	11.2	0.4	768.2	8.9
2011+50.00	7.2	0.0	50	12.9	0.3	11.9	0.3	780.1	9.2
2012+00.00	5.6	0.2	50	12.8	0.2	11.9	0.2	792.0	9.3
2012+50.00	6.8	0.5	50	12.4	0.7	11.5	0.6	803.5	10.0
2013+00.00	8.9	0.1	50	15.7	0.6	14.5	0.6	818.0	10.5
2013+50.00	10.2	0.0	50	19.1	0.1	17.7	0.1	835.7	10.6
2014+00.00	6.6	0.1	50	16.8	0.1	15.6	0.1	851.2	10.7
2014+50.00		0.1	50	12.8	0.3	11.9	0.3	863.1	
2015+00.00	6.2		50	12.8	0.4	11.9	0.4		11.0
2015+50.00	6.6	0.2	50	12.4	0.7	11.5	0.6	874.9	11.4
2016+00.00	5.8	0.5	50	36.0	0.5	33.3	0.5	886.4	12.0
2016+50.00	30.2	0.0	50	74.5	0.0	69.0	0.0	919.7	12.5
2017+00.00	44.3	0.0	50	119.4	0.0	110.6	0.0	988.7	12.5
	75.1	0.0	50	145.4	1.5	134.6	1.4	1,099.3	12.5
2017+50.00	70.3	1.5	50	70.3	41.5	65.1	38.4	1,233.9	13.9
2018+00.00	0.0	40.0	50	0.0	81.0	0.0	75.0	1,299.0	52.3
2018+50.00	0.0	41.0	50	29.9	41.0	27.7	38.0	1,299.0	127.3
2019+00.00	29.9	0.0	50	98.4	0.4	91.1	0.4	1,326.7	165.3
2019+50.00	68.5	0.4	50	126.3	0.4	116.9	0.4	1,417.8	165.6
2020+00.00	57.8	0.0	50	81.8	4.4	75.7	4.1	1,534.7	166.0
2020+50.00	24.0	4.4	50		7.5	40.8		1,610.5	170.1
2021+00.00	20.1	3.1		44.1			6.9	1,651.3	177.0
2021+50.00	11.1	4.7	50	31.2	7.8	28.9	7.2	1,680.2	184.2
2022+00.00	10.3	0.0	50	21.4	4.7	19.8	4.4	1,700.0	188.6
2022+50.00	7.2	2.8	50	17.5	2.8	16.2	2.6	1,716.2	191.2
2023+00.00	39.3	0.0	50	46.5	2.8	43.1	2.6	1,759.3	193.8
2023+50.00	88.5	0.0	50	127.8	0.0	118.3	0.0	1,877.6	193.8
2024+00.00	98.2	0.0	50	186.7	0.0	172.9	0.0	2,050.5	193.8
2024+50.00	84.1	0.0	50	182.3	0.0	168.8	0.0	2,219.3	193.8
2025+00.00	75.5	0.0	50	159.6	0.0	147.8	0.0	2,367.1	193.8
2025+50.00	37.1	0.0	50	112.6	0.0	104.3	0.0	2,367.1	193.8

		EAR	TH WOR	K TABLE				EARTH EXCAVATION 20200100	FURNISHED EXCAVATION 20400800
		Areas Feet)			nd Areas Feet)		Totals Yards)		Le Total (Cu. ds)
Station	Cut	Fill	Distance	Cut	Fill	Cut	Fill	Cut	Fill
2026+00.00	5.0	0.2	50	42.1	0.2	39.0	0.2	2,510.3	194.0
2026+50.00	7.4	0.0	50	12.4	0.2	11.5	0.2	2,521.8	194.2
2027+00.00	7.4	0.0	50	14.8	0.0	13.7	0.0	2,535.5	194.2
2027+50.00	3.5	1.9	50	10.9	1.9	10.1	1.8	2,545.6	195.9
2028+00.00	5.5	0.4	50	9.0	2.3	8.3	2.1	2,553.9	198.0
2028+50.00	6.8	0.1	50	12.3	0.5	11.4	0.5	2,565.3	198.5
	0.0		STATION	OMISSI	ON E. AL	BUM ST	REET	2,303.3	190.5
2039+50.00	4.3	1.1						2,565.3	198.5
2040+00.00	5.1	0.4	50	9.4	1.5	8.7	1.4	2,574.0	199.9
2040+50.00	5.2	0.4	50	10.3	0.5	9.5	0.5		200.4
2041+00.00			50	22.0	19.0	20.4	17.6	2,583.5	
2041+50.00	16.8	18.9	50	68.6	18.9	63.5	17.5	2,603.9	217.9
2042+00.00	51.8	0.0	50	61.9	0.6	57.3	0.6	2,667.4	235.4
2042+50.00	10.1	0.6	50	17.2	4.6	15.9	4.3	2,724.7	236.0
2043+00.00	7.1	4.0	50	16.0	7.0	14.8	6.5	2,740.7	240.3
2043+50.00	8.9	3.0	50	19.3	4.4	17.9	4.1	2,755.5	246.7
2044+00.00	10.4	1.4	50	22.2	1.4	20.6	1.3	2,773.4	250.8
2044+50.00	11.8	0.0	50	20.2	0.1	18.7	0.1	2,793.9	252.1
2045+00.00	8.4	0.1	50	14.1	0.2	13.1	0.2	2,812.6	252.2
2045+50.00	5.7	0.1	50	13.8	0.1	12.8	0.1	2,825.7	252.4
	8.1	0.0	50	19.2	0.0	17.8	0.0	2,838.5	252.5
2046+00.00	11.1	0.0	50	19.4	1.9	18.0	1.8	2,856.2	252.5
2046+50.00	8.3	1.9	50	13.7	7.6	12.7	7.0	2,874.2	254.2
2047+00.00	5.4	5.7	50	10.1	9.9	9.4	9.2	2,886.9	261.3
2047+50.00	4.7	4.2	50	10.6	5.2	9.8	4.8	2,896.2	270.4
2048+00.00	5.9	1.0	50	9.8	2.6	9.1	2.4	2,906.0	275.3
2048+50.00	3.9	1.6	50	6.0	3.3	5.6	3.1	2,915.1	277.7
2049+00.00	2.1	1.7			2.7			2,920.7	280.7
2049+50.00	3.8	1.0	50	5.9		5.5	2.5	2,926.1	283.2
2050+00.00	5.5	1.2	50	9.3	2.2	8.6	2.0	2,934.7	285.3
2050+50.00	5.5	0.3	50	11.0	1.5	10.2	1.4	2,944.9	286.7
2051+00.00	4.2	1.3	50	9.7	1.6	9.0	1.5	2,953.9	288.1
2051+50.00	5.3	1.8	50	9.5	3.1	8.8	2.9	2,962.7	291.0
2052+00.00	6.1	1.3	50	11.4	3.1	10.6	2.9	2,973.3	293.9
2052+50.00	6.1	3.4	50	12.2	4.7	11.3	4.4	2,984.6	298.2
2053+00.00	8.3	1.1	50	14.4	4.5	13.3	4.2	2,997.9	302.4
2053+50.00	8.7	0.6	50	17.0	1.7	15.7	1.6	3,013.6	304.0
2054+00.00	9.2	0.3	50	17.9	0.9	16.6	0.8	3,030.2	304.8
2054+50.00	10.3	0.1	50	19.5	0.4	18.1	0.4	3,048.3	305.2
2055+00.00	10.3	0.0	50	20.6	0.1	19.1	0.1	3,067.3	305.3
2055+50.00	11.6	0.0	50	21.9	0.0	20.3	0.0	3,087.6	305.3
2056+00.00	11.7	3.3	50	23.3	3.3	21.6	3.1	3,109.2	308.3
2056+50.00	6.8	12.4	50	18.5	15.7	17.1	14.5	3,126.3	322.9
2057+00.00	4.8	10.5	50	11.6	22.9	10.7	21.2	3,137.1	344.1
2057+50.00	4.8	6.5	50	9.6	17.0	8.9	15.7		359.8
2058+00.00			50	9.5	7.1	8.8	6.6	3,146.0	
2058+50.00	4.7	0.6	50	4.7	66.8	4.4	61.9	3,154.7	366.4
2059+00.00	0.0	66.2	50	0.0	223.6	0.0	207.0	3,159.1	428.2
2059+50.00	0.0	157.4	50	0.0	157.4	0.0	145.7	3,159.1	635.3
2060+00.00	0.0	0.0	50	0.0	0.0	0.0	0.0	3,159.1	781.0

	EARTH EXCAVATION 20200100	FURNISHED EXCAVATIO 20400800								
	End Areas (Sq. Feet)				End Areas Feet)		Totals Yards)	Cummulativ		
Station	Cut	Fill	Distance	Cut	Fill	Cut	Fill	Cut	Fill	
2060+50.00	0.0	94.7	50	0.0	94.7	0.0	87.7	3,159.1	868.7	
2061+00.00	0.0	56.4	50	0.0	151.1	0.0	139.9	3,159.1	1,008.6	
2061+50.00	0.0	30.8	50	0.0	87.2	0.0	80.7	3,159.1	1,089.3	
2062+00.00	0.1	32.4	50	0.1	63.2	0.1	58.5	3,159.2	1,147.9	
2062+50.00	9.7	0.0	50	9.8	32.4	9.1	30.0		1,177.9	
2063+00.00	8.0	7.4	50	17.7	7.4	16.4	6.9	3,168.3		
2063+50.00	7.9	7.4	50	15.9	14.6	14.7	13.5	3,184.7	1,184.7	
2064+00.00			50	15.9	13.8	14.7	12.8	3,199.4	1,198.2	
2064+50.00	8.0	6.6	50	16.5	9.9	15.3	9.2	3,214.1	1,211.0	
2065+00.00	8.5	3.3	50	18.5	4.7	17.1	4.4	3,229.4	1,220.2	
2065+50.00	10.0	1.4	50	23.3	3.3	21.6	3.1	3,246.5	1,224.5	
2066+00.00	13.3	1.9	50	28.8	1.9	26.7	1.8	3,268.1	1,227.6	
2066+50.00	15.5	0.0	50	31.0	0.0	28.7	0.0	3,294.7	1,229.3	
2067+00.00	15.5	0.0	50	28.7	0.1	26.6	0.1	3,323.5	1,229.3	
	13.2	0.1	50	23.0	1.4	21.3	1.3	3,350.0	1,229.4	
2067+50.00	9.8	1.3	50	19.1	1.3	17.7	1.2	3,371.3	1,230.7	
2068+00.00	9.3	0.0	50	24.2	0.1	22.4	0.1	3,389.0	1,231.9	
2068+50.00	14.9	0.1	50	24.8	0.2	23.0	0.2	3,411.4	1,232.0	
2069+00.00	9.9	0.1	50	19.1	0.2	17.7	0.1	3,434.4	1,232.2	
2069+50.00	9.2	0.0					0.0	3,452.1	1,232.3	
2070+00.00	10.3	0.0	50	19.5	0.0	18.1		3,470.1	1,232.3	
2070+50.00	11.7	0.0	50	22.0	0.0	20.4	0.0	3,490.5	1,232.3	
2071+00.00	12.4	0.0	50	24.1	0.0	22.3	0.0	3,512.8	1,232.3	
2071+50.00	11.9	0.0	50	24.3	0.0	22.5	0.0	3,535.3	1,232.3	
2072+00.00	11.3	0.0	50	23.2	0.0	21.5	0.0	3,556.8	1,232.3	
2072+50.00	10.5	0.0	50	21.8	0.0	20.2	0.0	3,577.0	1,232.3	
2073+00.00	9.8	0.0	50	20.3	0.0	18.8	0.0	3,595.8	1,232.3	
2073+50.00	9.3	0.0	50	19.1	0.0	17.7	0.0	3,613.5	1,232.3	
2074+00.00	9.8	0.1	50	19.1	0.1	17.7	0.1	3,631.1	1,232.4	
2074+50.00	12.2	0.1	50	22.0	0.2	20.4	0.2	3,651.5	1,232.6	
2075+00.00	15.6	0.0	50	27.8	0.1	25.7	0.1	3,677.2	1,232.7	
2075+50.00	16.1	0.0	50	31.7	0.0	29.4	0.0	3,706.6	1,232.7	
2076+00.00	16.5	0.0	50	32.6	0.0	30.2	0.0	3,736.8	1,232.7	
2076+50.00	16.5	0.0	50	33.0	0.0	30.6	0.0	3,767.3	1,232.7	
2077+00.00	15.9	0.0	50	32.4	0.0	30.0	0.0			
2077+50.00			50	29.2	0.0	27.0	0.0	3,797.3	1,232.7	
2078+00.00	13.3	0.0	50	25.2	0.0	23.3	0.0	3,824.4	1,232.7	
2078+50.00	11.9	0.0	50	23.3	0.0	21.6	0.0	3,847.7	1,232.7	
2079+00.00	11.4	0.0	50	22.4	0.0	20.7	0.0	3,869.3	1,232.7	
2079+50.00	11.0	0.0	50	21.4	0.0	19.8	0.0	3,890.0	1,232.7	
2080+00.00	10.4	0.0	50	18.3	0.1	16.9	0.1	3,909.8	1,232.7	
2080+50.00	7.9	0.1	50	13.7	0.6	12.7	0.6	3,926.8	1,232.8	
2081+00.00	5.8	0.5	50	5.8	0.5	5.4	0.5	3,939.5	1,233.3	
	0.0	0.0	50	4.2	2.0	3.9	1.9	3,944.8	1,233.8	
2081+50.00	4.2	2.0	50	6.6	6.2	6.1	5.7	3,948.7	1,235.6	
2082+00.00	2.4	4.2	50	3.9	8.6	3.6	8.0	3,954.8	1,241.4	
2082+50.00	1.5	4.4	50	2.9	10.6	2.7	9.8	3,958.5	1,249.3	
2083+00.00	1.4	6.2	50	3.2	9.6	3.0	8.9	3,961.1	1,259.2	
2083+50.00	1.8	3.4						3,964.1	1,268.0	
2084+00.00	2.5	1.9	50	4.3	5.3	4.0	4.9	3,968.1	1,272.9	



USER NAME:	DESIGNED:	REVISED:
	CHECKED:	REVISED:
PLOT SCALE:	DRAWN: ATH	REVISED:
PLOT DATE: 3/27/2019	CHECKED: WLK	REVISED:

STATE OF ILLINOIS CITY OF FREEPORT

EARTHWORK SCHEDULE	_	SECTION	COUNTY	TOTAL SHEETS	SHEET NO.
FREEPORT PEC PATH		15-00163-00-BT	STEPHENSON	92	41
THEELONI TECTAM	CITY OF	FREEPORT	CONTRACT N	10. 856	74
SHEET NO OF SHEETS		ILLINOIS FED A	SHEETS NO. STEPHENSON 92 41		

EARTHWORK SCHEDULE


		EARTH EXCAVATION	FURNISHED EXCAVATION						
		LAN	RTH WOR	I IADLE				20200100	20400800
		Areas Feet)			nd Areas Feet)		Totals Yards)	Cummulativ Yaı	e Total (Cu. rds)
Station	Cut	Fill	Distance	Cut	Fill	Cut	Fill	Cut	Fill
2084+50.00	4.1	0.5	50	6.6	2.4	6.1	2.2	3,974.2	1,275.2
2085+00.00	5.3	1.1	50	9.4	1.6	8.7	1.5	3,982.9	1,276.7
2085+50.00	6.7	0.9	50	12.0	2.0	11.1	1.9	3,994.0	1,278.5
2086+00.00	5.3	1.5	50	12.0	2.4	11.1	2.2	4,005.1	1,280.7
2086+50.00	2.1	2.9	50	7.4	4.4	6.9	4.1	4,012.0	1,284.8
2087+00.00	1.3	16.7	50	3.4	19.6	3.1	18.1	4,015.1	1,302.9
2087+50.00	4.2	16.9	50	5.5	33.6	5.1	31.1	4,020.2	1,334.1
2088+00.00	7.3	213.1	50	11.5	230.0	10.6	213.0	4,030.9	1,547.0
2088+50.00	5.4	0.1	50	12.7	213.2	11.8	197.4	4,042.6	1,744.4
2089+00.00	3.7	0.5	50	9.1	0.6	8.4	0.6	4,051.0	1,745.0
2089+50.00	3.6	0.4	50	7.3	0.9	6.8	0.8	4,057.8	1,745.8
2090+00.00			50	7.4	0.9	6.9	0.8		
2090+50.00	3.8	0.5	50	8.6	0.8	8.0	0.7	4,064.7	1,746.7
2091+00.00	4.8	0.3	50	10.5	1.5	9.7	1.4	4,072.6	1,747.4
2091+50.00	5.7	1.2	50	10.7	3.5	9.9	3.2	4,082.3	1,748.8
2092+00.00	5.0	2.3	50	6.0	11.5	5.6	10.6	4,092.2	1,752.0
2092+50.00	1.0	9.2	50	1.8	10.5	1.7	9.7	4,097.8	1,762.7
2092+30.00	0.8	1.3	50	3.0	2.1	2.8	1.9	4,099.5	1,772.4
	2.2	0.8	50	5.4	1.1	5.0	1.0	4,102.2	1,774.3
2093+50.00	3.2	0.3	50	7.2	0.5	6.7	0.5	4,107.2	1,775.4
2094+00.00	4.0	0.2	50	8.7	0.4	8.1	0.4	4,113.9	1,775.8
2094+50.00	4.7	0.2	50	9.8	1.7	9.1	1.6	4,122.0	1,776.2
2095+00.00	5.1	1.5	50	11.8	1.5	10.9	1.4	4,131.0	1,777.8
2095+50.00	6.7	0.0						4,142.0	1,779.2
2096+00.00	8.4	0.0	50	15.1	0.0	14.0	0.0	4,156.0	1,779.2
2096+50.00	7.2	0.0	50	15.6	0.0	14.4	0.0	4,170.4	1,779.2
2097+00.00	7.0	0.0	50	14.2	0.0	13.1	0.0	4,183.5	1,779.2
2097+50.00	7.1	0.0	50	14.1	0.0	13.1	0.0	4,196.6	1,779.2
2098+00.00	7.3	0.0	50	14.4	0.0	13.3	0.0	4,209.9	1,779.2
2098+50.00	7.4	0.0	50	14.7	0.0	13.6	0.0	4,223.5	1,779.2
2099+00.00	7.6	0.0	50	15.0	0.0	13.9	0.0	4,237.4	1,779.2
2099+50.00	5.8	0.1	50	13.4	0.1	12.4	0.1	4,249.8	1,779.2
2100+00.00	5.0	0.6	50	10.8	0.7	10.0	0.6	4,259.8	1,779.9
2100+50.00	4.7	0.8	50	9.7	1.4	9.0	1.3	4,268.8	1,781.2
2101+00.00	4.7	0.8	50	9.4	1.6	8.7	1.5	4,277.5	1,782.7
2101+50.00	5.5	1.3	50	10.2	2.1	9.4	1.9		
2102+00.00			50	11.7	1.4	10.8	1.3	4,287.0 4,297.8	1,784.6
2102+50.00	6.2	0.1	50	11.9	0.3	11.0	0.3		1,785.9
2103+00.00	5.7	0.2	50	10.5	0.4	9.7	0.4	4,308.8	1,786.2
2103+50.00	4.8	0.2	50	9.5	0.5	8.8	0.5	4,318.5	1,786.6
2104+00.00	4.7	0.3	50	9.1	0.8	8.4	0.7	4,327.3	1,787.0
2104+50.00	4.4	0.5	50	7.3	1.8	6.8	1.7	4,335.8	1,787.8
2104+30.00	2.9	1.3	50	3.9	3.9	3.6	3.6	4,342.5	1,789.4
	1.0	2.6	50	1.8	5.4	1.7	5.0	4,346.1	1,793.0
2105+50.00	0.8	2.8	50	1.5	5.5	1.4	5.1	4,347.8	1,798.0
2106+00.00	0.7	2.7	50	2.0	4.8	1.9	4.4	4,349.2	1,803.1
2106+50.00	1.3	2.1	50	3.4	3.7	3.1	3.4	4,351.0	1,807.6
2107+00.00	2.1	1.6	50	7.9	2.0	7.3	1.9	4,354.2	1,811.0
2107+50.00	5.8	0.4						4,361.5	1,812.9
2108+00.00	3.3	0.7	50	9.1	1.1	8.4	1.0	4,369.9	1,813.9

		EAF	RTH WOR	K TABLE				EARTH EXCAVATION 20200100	FURNISHED EXCAVATION 20400800
		Areas Feet)		Sum of End Areas Sec. T (Sq. Feet) (Cu. Ya				Cummulative Total (Cu. Yards)	
Station	Cut	Fill	Distance	Cut	Fill	Cut	Fill	Cut	Fill
2108+50.00	0.6	4.1	50	3.9	4.8	3.6	4.4	4,373.5	1,818.3
2109+00.00	1.5	2.4	50	2.1	6.5	1.9	6.0	4,375.5	1,824.3
2109+50.00	2.7	2.3	50	4.2	4.7	3.9	4.4	4,379.4	1,828.7
2110+00.00	5.4	0.6	50	8.1	2.9	7.5	2.7	4,386.9	1,831.4
2110+50.00	6.4	0.2	50	11.8	0.8	10.9	0.7	4,397.8	1,832.1
2111+00.00	9.3	10.1	50	15.7	10.3	14.5	9.5	4,412.3	1,841.7
2111+50.00	1.5	36.0	50	10.8	46.1	10.0	42.7	4,422.3	1,884.3
2112+00.00	0.3	12.8	50	1.8	48.8	1.7	45.2	4,424.0	1,929.5
2112+50.00	12.6	0.5	50	12.9	13.3	11.9	12.3	4,436.0	1,941.8
2113+00.00	40.3	0.0	50	52.9	0.5	49.0	0.5	4,484.9	1,942.3
2113+50.00	21.0	2.4	50	61.3	2.4	56.8	2.2	4,541.7	1,944.5
2114+00.00	18.3	2.1	50	39.3	4.5	36.4	4.2	4,578.1	1,948.7
2114+50.00	20.8	0.1	50	39.1	2.2	36.2	2.0	4,614.3	1,950.7
2115+00.00	16.1	0.3	50	36.9	0.4	34.2	0.4	4,648.5	1,951.1
2115+50.00	22.2	0.7	50	38.3	1.0	35.5	0.9	4,683.9	1,952.0
2116+00.00	37.9	0.4	50	60.1	1.1	55.6	1.0	4,739.6	1,953.0
2116+50.00	4.3	0.6	50	42.2	1.0	39.1	0.9	4,778.6	1,954.0
2117+00.00	3.9	0.2	50	8.2	0.8	7.6	0.7	4,786.2	1,954.7
2117+50.00	5.7	0.1	50	9.6	0.3	8.9	0.3	4,795.1	1,955.0
2118+00.00	7.2	0.0	50	12.9	0.1	11.9	0.1	4,807.1	1,955.1
2118+50.00	3.6	3.2	50	10.8	3.2	10.0	3.0	4,817.1	1,958.0
2119+00.00	4.0	0.6	50	7.6	3.8	7.0	3.5	4,824.1	1,961.6
2119+50.00	3.8	1.8	50	7.8	2.4	7.2	2.2	4,831.3	1,963.8
2120+00.00	8.2	0.1	50	12.0	1.9	11.1	1.8	4,842.4	1,965.5
2120+50.00	6.4	0.1	50	14.6	0.2	13.5	0.2	4,856.0	1,965.7
2121+00.00	14.8	0.1	50	21.2	0.2	19.6	0.2	4,875.6	1,965.9
2121+50.00	13.7	0.0	50	28.5	0.1	26.4	0.1	4,902.0	1,966.0
2122+00.00	4.3	2.8	50	18.0	2.8	16.7	2.6	4,918.6	1,968.6
2122+50.00	6.2	0.1	50	10.5	2.9	9.7	2.7	4,928.4	1,971.3
2123+00.00	10.9	0.2	50	17.1	0.3	15.8	0.3	4,944.2	1,971.6
			20200100 -	EARTH E	XCAVATION	TOTAL (Cu. Yards)		,
			100800 FUR			•			1,971.6



USER NAME:	DESIGNED:	REVISED:
	CHECKED:	REVISED:
PLOT SCALE:	DRAWN: ATH	REVISED:
PLOT DATE: 3/27/2019	CHECKED: WLK	REVISED:

STATE OF ILLINOIS	EARTHWORK SCHEDULE (2)
CITY OF FREEPORT	FREEPORT PEC PATH
	SHEET NO OF SHEETS

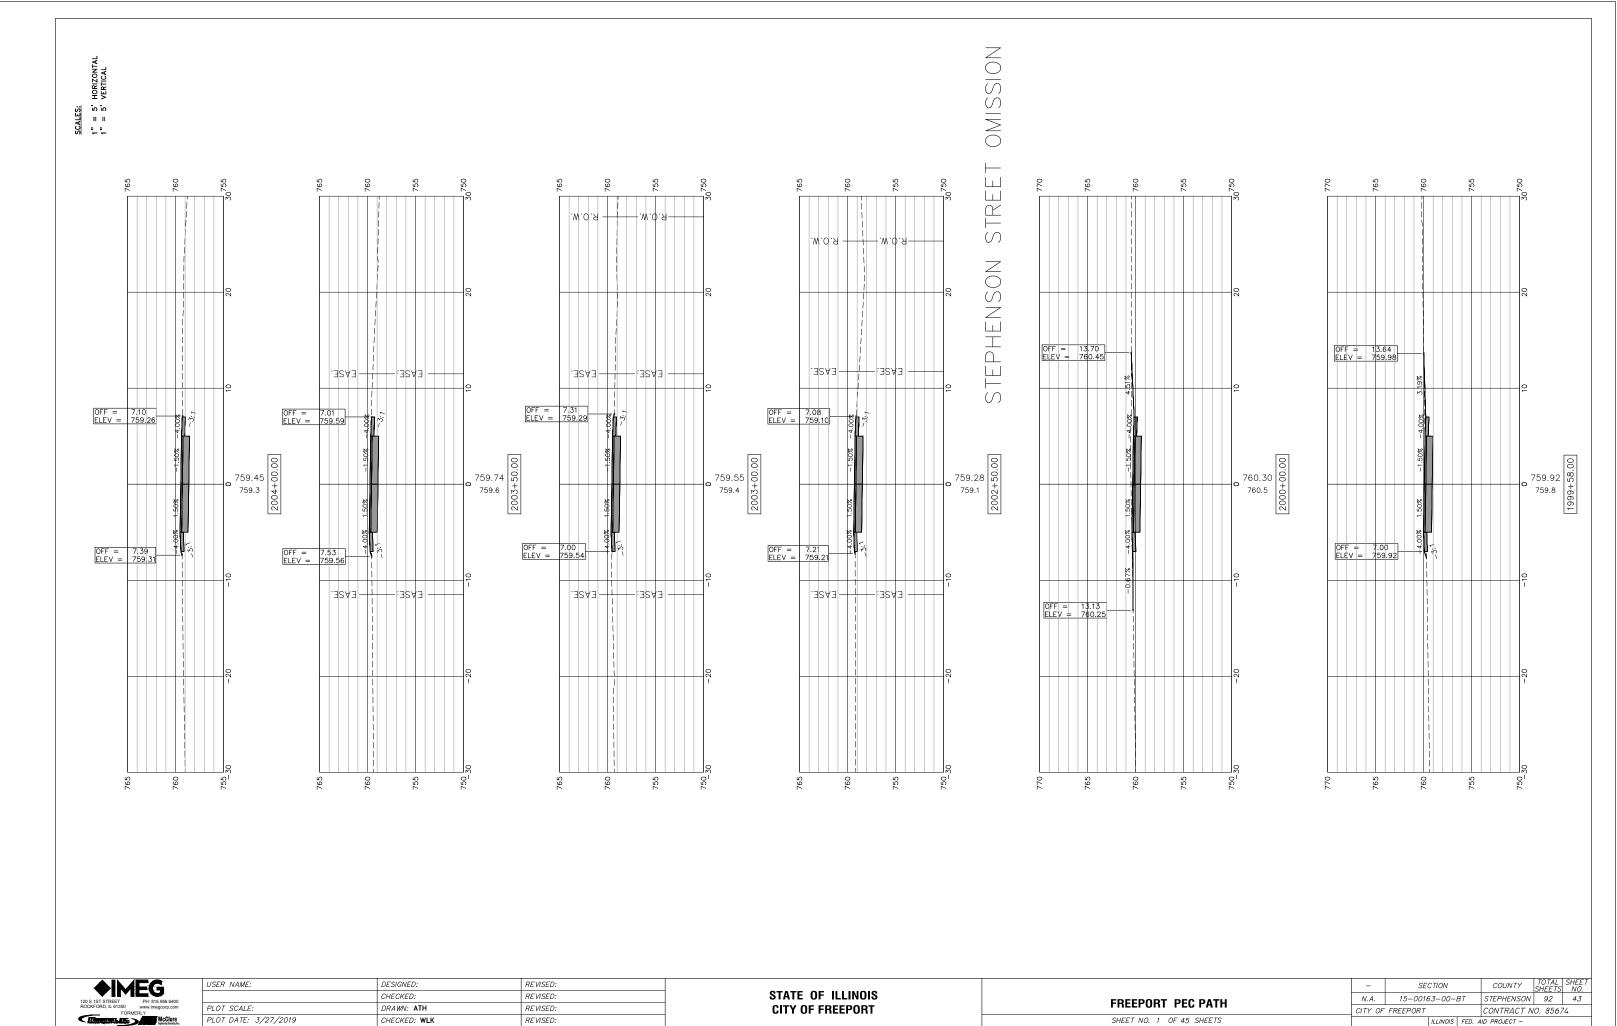


CHECKED: WLK REVISED: SCALES:
1" = 5' HORIZONTAL
1" = 5' VERTICAL 755 OFF = 8.14 ELEV = 758.81 OFF = 7.17 ELEV = 758.91 OFF = 7.24 ELEV = 759.12 OFF = 7.10 ELEV = 758.97 759.35 758.7 9007 759.35 759.3 759.3 759.20 760.9 760.9 759.50 759.3 759.3 759.12 758.9 758.9 759.16 758.9 758.9 OFF = 7.21 ELEV = 759.27 OFF = 7.25 ELEV = 759.41 OFF = 7.56 ELEV = 758.93

120 S 1ST STREET PH: 815.956.6400 ROCKFORD, IL 61350 www.imegcorp.com

USER NAME:	DESIGNED:	REVISED:
	CHECKED:	REVISED:
PLOT SCALE:	DRAWN: ATH	REVISED:
PLOT DATE: 3/27/2019	CHECKED: WLK	REVISED:

STAT	E OF	ILLINOIS
CITY	OF FI	REEPORT

CROSS SECTIONS 2004+50-2007+00	-	SECTION	COUNTY	TOTAL SHEETS	SHEET NO.
FREEPORT PEC PATH		15-00163-00-BT	STEPHENSON	92	44
		CITY OF FREEPORT CONTRACT NO.		0. 8567	4
SHEET NO. 2 OF 45 SHEETS		ILLINOIS FED. A	ID PROJECT -		

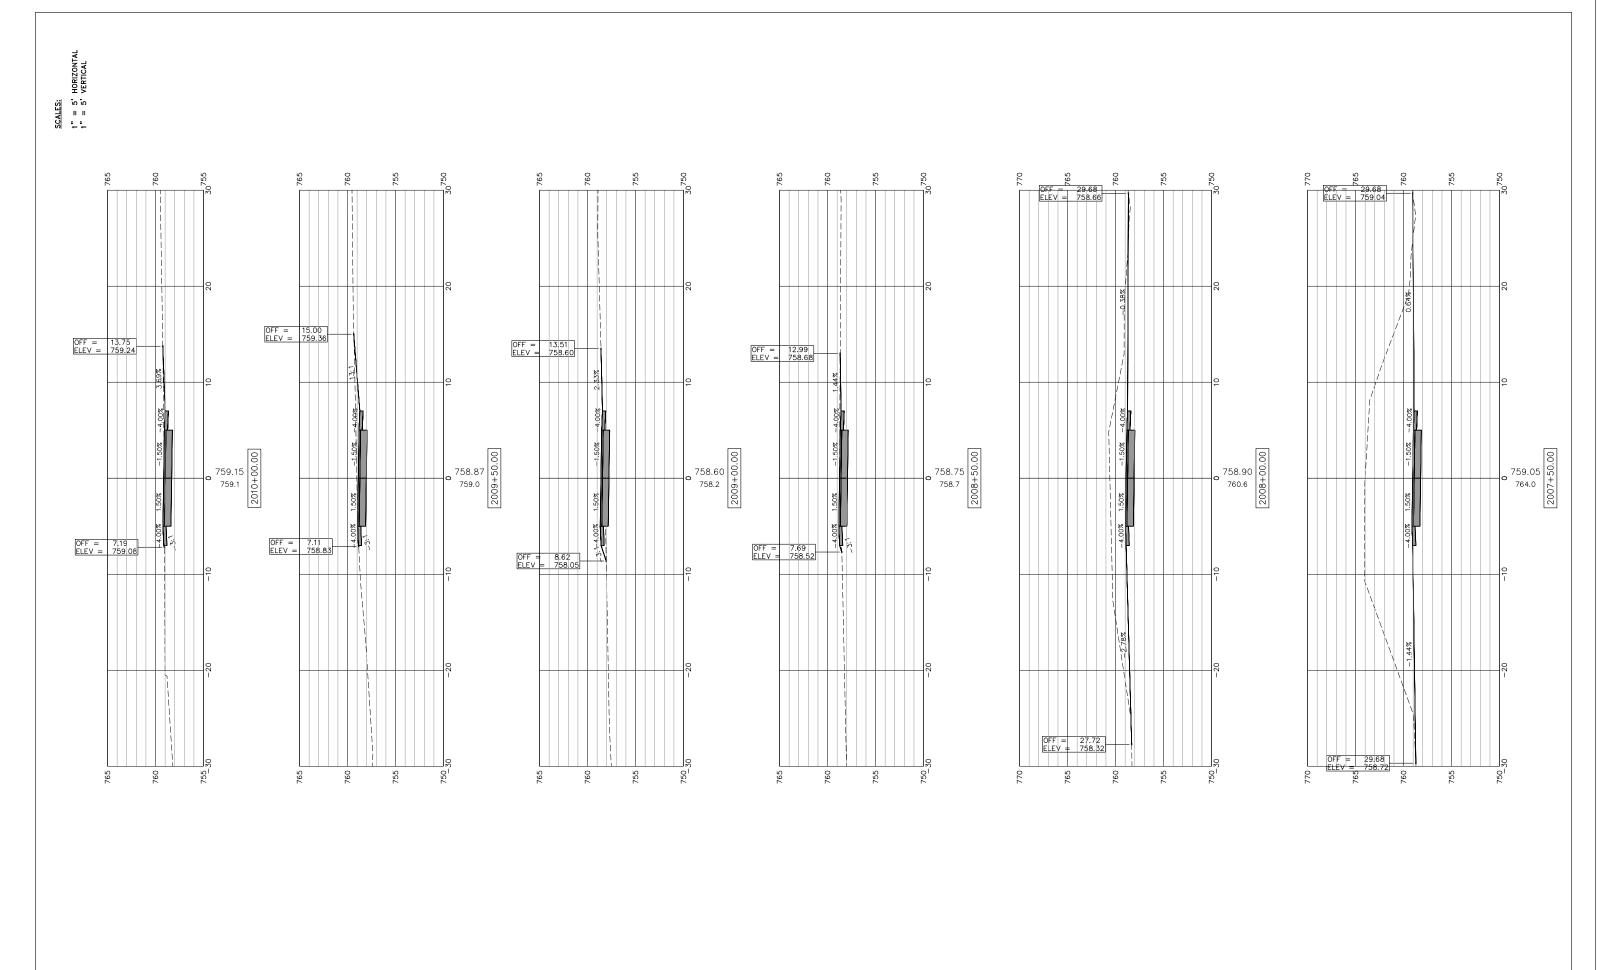

◆IM	EG
120 S 1ST STREET	PH: 815.956.6400
ROCKFORD, IL 61350	www.imegcorp.com
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Citizanan inc.	McClure

USER NAME:	DESIGNED:	REVISED:
	CHECKED:	REVISED:
PLOT SCALE:	DRAWN: ATH	REVISED:
PLOT DATE: 3/27/2019	CHECKED: WLK	REVISED:

STATE OF ILLINOIS CITY OF FREEPORT
 CROSS SECTIONS 2007+50-2010+00
 SECTIONS 2007+50-2010+00

 FREEPORT PEC PATH
 N.A. 15-0016

 SHEET NO. 3 OF 45 SHEETS
 CITY OF FREEPORT

- SECTION COUNTY TOTAL SHEETS NO.

N.A. 15-00163-00-BT STEPHENSON 92 45

CITY OF FREEPORT CONTRACT NO. 85674

FILE NAME AND PATH: \AD.K.JWW.COM\K.JWW\COM\KJWW\OFFICES\MCCLURE\ROCKFORD\PROJECTS\H-DRIVE TRANS\14-054-PECPATH-FREEPORT\DESIGN\DRAWINGS\IMEG FILE STRUCTURE\18000408.00\CAD-BIM FOLDERS\CIVIL3D\DWG\PLOT\18000408-X-SECTIONS.DWG


SCALES:
1" = 5' HORIZONTAL
1" = 5' VERTICAL OFF = 7.33 ELEV = 759.28 OFF = 7.13 ELEV = 759.43 OFF = 7.02 ELEV = 759.72 OFF = 7.01 ELEV = 759.75 OFF = 7.09 ELEV = 759.24 759.91 759.7 759.7 759.88 759.9 759.9 759.55 759.2 759.63 759.4 1100 759.70 759.4 +100 759.42 759.2 + 000 95 + 010 759.2 OFF = 7.58 ELEV = 759.68 OFF = ELEV = OFF = 7.81 ELEV = 759.15 OFF = 7.95 ELEV = 759.23 OFF = 8.40 ELEV = 759.43

	EG
120 S 1ST STREET ROCKFORD, IL 61350	PH: 815.956.6400 www.imegcorp.com
FORM	MCClure Spinity kentre, ke.

USER NAME:	DESIGNED:	REVISED:
	CHECKED:	REVISED:
PLOT SCALE:	DRAWN: ATH	REVISED:
PLOT DATE: 3/27/2019	CHECKED: WLK	REVISED:

STATE	0F	ILLINOIS
CITY C)F FI	REEPORT


CROSS SECTIONS 2010+50-2013+00	-	SECTION	COUNTY	TOTAL SHEETS	SHEET NO.
FREEPORT PEC PATH	N.A.	15-00163-00-BT	STEPHENSON	92	46
THEE ON TECTAM		CITY OF FREEPORT CONTRACT N		10. 8567	74
SHEET NO. 4 OF 45 SHEETS		ILLINOIS FED.	AID PROJECT -		

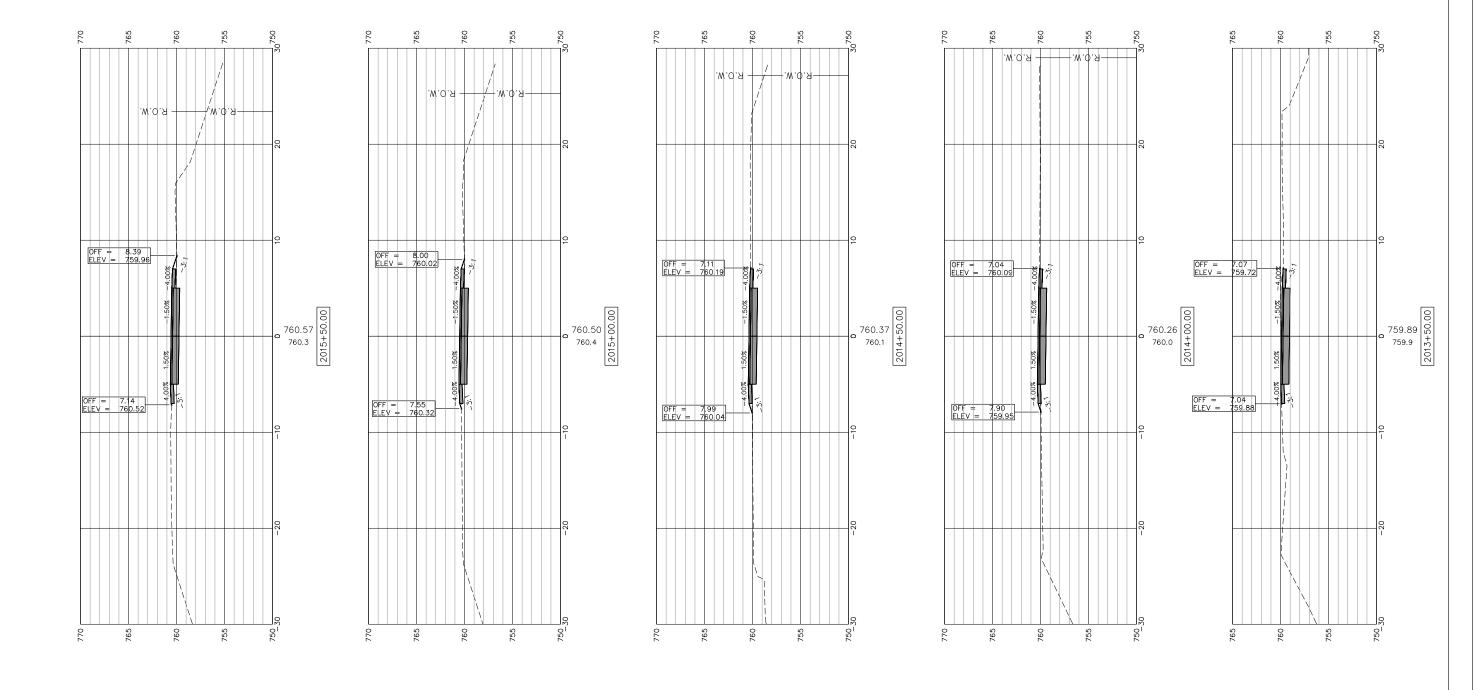

♦IM	EG
120 S 1ST STREET	PH: 815.956.6400
ROCKFORD, IL 61350	www.imegcorp.com
FORI	MERLY
C Thereton, Inc.	McClure

USER NAME:	DESIGNED:	REVISED:		CROSS SECTIONS 2013+50-2015+50	-	SECTION	COUNTY TOTA	FTS NO
	CHECKED:	REVISED:	STATE OF ILLINOIS		N.A.	15-00163-00-BT	STEPHENSON 9:	2 47
PLOT SCALE:	DRAWN: ATH	REVISED:	CITY OF FREEPORT	FREEPORT PEC PATH	CITY OF	FREEPORT	CONTRACT NO. 8	85674
PLOT DATE: 3/27/2019	CHECKED: WLK	REVISED:		SHEET NO. 5 OF 45 SHEETS		ILLINOIS FED.	AID PROJECT -	


FILE NAME AND PATH: \AD.K.JWW.COM\K.JWW\K.JWW\GFICES\MCCLURE\ROCKFORD\PROJECTS\H-DRIVE TRANS\14-054-PECPATH-FREEPORT\DESIGN\DRAWINGS\IMEG FILE STRUCTURE\18000408.00\CAD-BIM FOLDERS\CIVIL3D\DWG\PLOT\18000408-X-SECTIONS.DWG

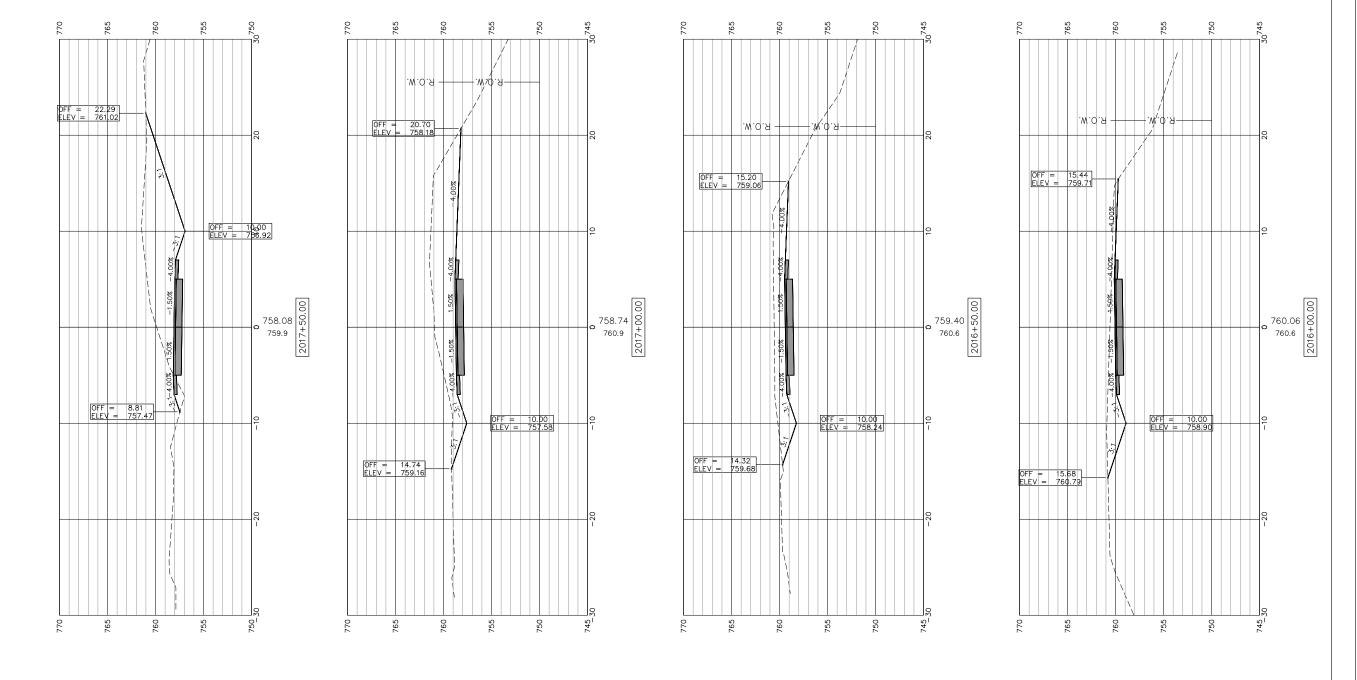


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120 S 1ST STREET ROCKFORD, IL 61350	PH: 815.956.6400 www.imegcorp.com
	MERLY
C Thereton, Inc.	McClure


USER NAME:	DESIGNED:	REVISED:		CROSS SECTIONS 2016+00-2017+50	- SECTION	COUNTY	TOTAL SHEET SHEET NO.	
	CHECKED:	REVISED:	STATE OF ILLINOIS		N.A. 15-00163-00-	-BT STEPHENSON	V 92 48	
PLOT SCALE:	DRAWN: ATH	REVISED:	CITY OF FREEPORT	FREEPORT PEC PATH	CITY OF FREEPORT	CONTRACT	NO. 85674	
PLOT DATE: 3/27/2019	CHECKED: WLK	REVISED:		SHEET NO. 6 OF 45 SHEETS	ILLINOIS	FED. AID PROJECT -		


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SEE "PLAN AND PROFILE SHERIDAN AVE." FOR ADDITIONAL INFORMATION

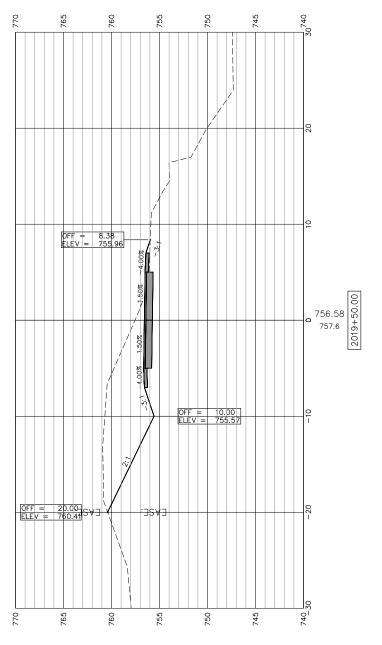

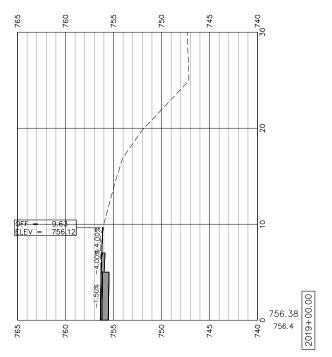


♦I M	EG
120 S 1ST STREET ROCKFORD, IL 61350	PH: 815.956.6400 www.imegcorp.com
FORM	MERLY
Chargers 15	McClure Esplecing Reachin, Inc.

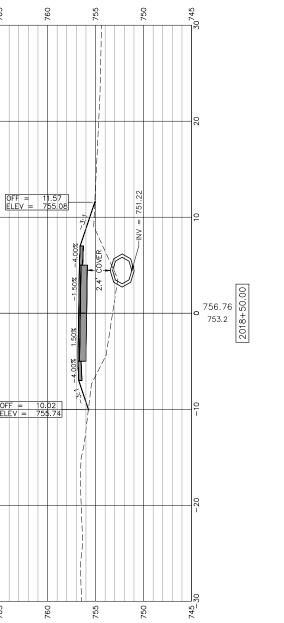USER NAME:	DESIGNED:	REVISED:	
	CHECKED:	REVISED:	
PLOT SCALE:	DRAWN: ATH	REVISED:	
PLOT DATE: 3/27/2019	CHECKED: WLK	REVISED:	

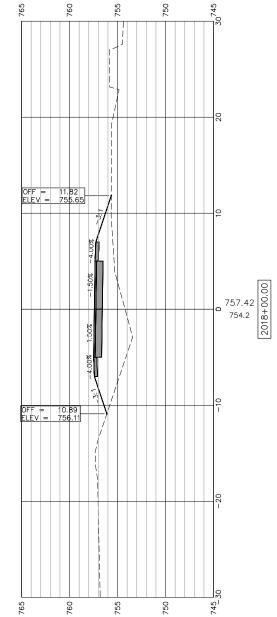STATE OF ILLINOIS	CROSS SECTIONS 2018+00-2019+50
CITY OF FREEPORT	FREEPORT PEC PATH
	SHEET NO. 7 OF 45 SHEETS

_	SE	CTION		COUNTY	TOTAL SHEETS	SHEE NO.
N.A.	15-0016	15-00163-00-BT			92	49
CITY OF	Y OF FREEPORT			CONTRACT N	0. 8567	74
		ILLINOIS	FED. A	ID PROJECT -		

FILE NAME AND PATH: \AD.KJWW.COM\KJWW\KJJWW\OFFICES\MCCLURE\ROCKFORD\PROJECTS\H-DRIVE TRANS\14-054-PECPATH-FREEPORT\DESIGN\DRAWINGS\IMEG FILE STRUCTURE\18000408.00\CAD-BIM FOLDERS\CIVIL3D\DWG\PLOT\18000408-X-SECTIONS.DWG

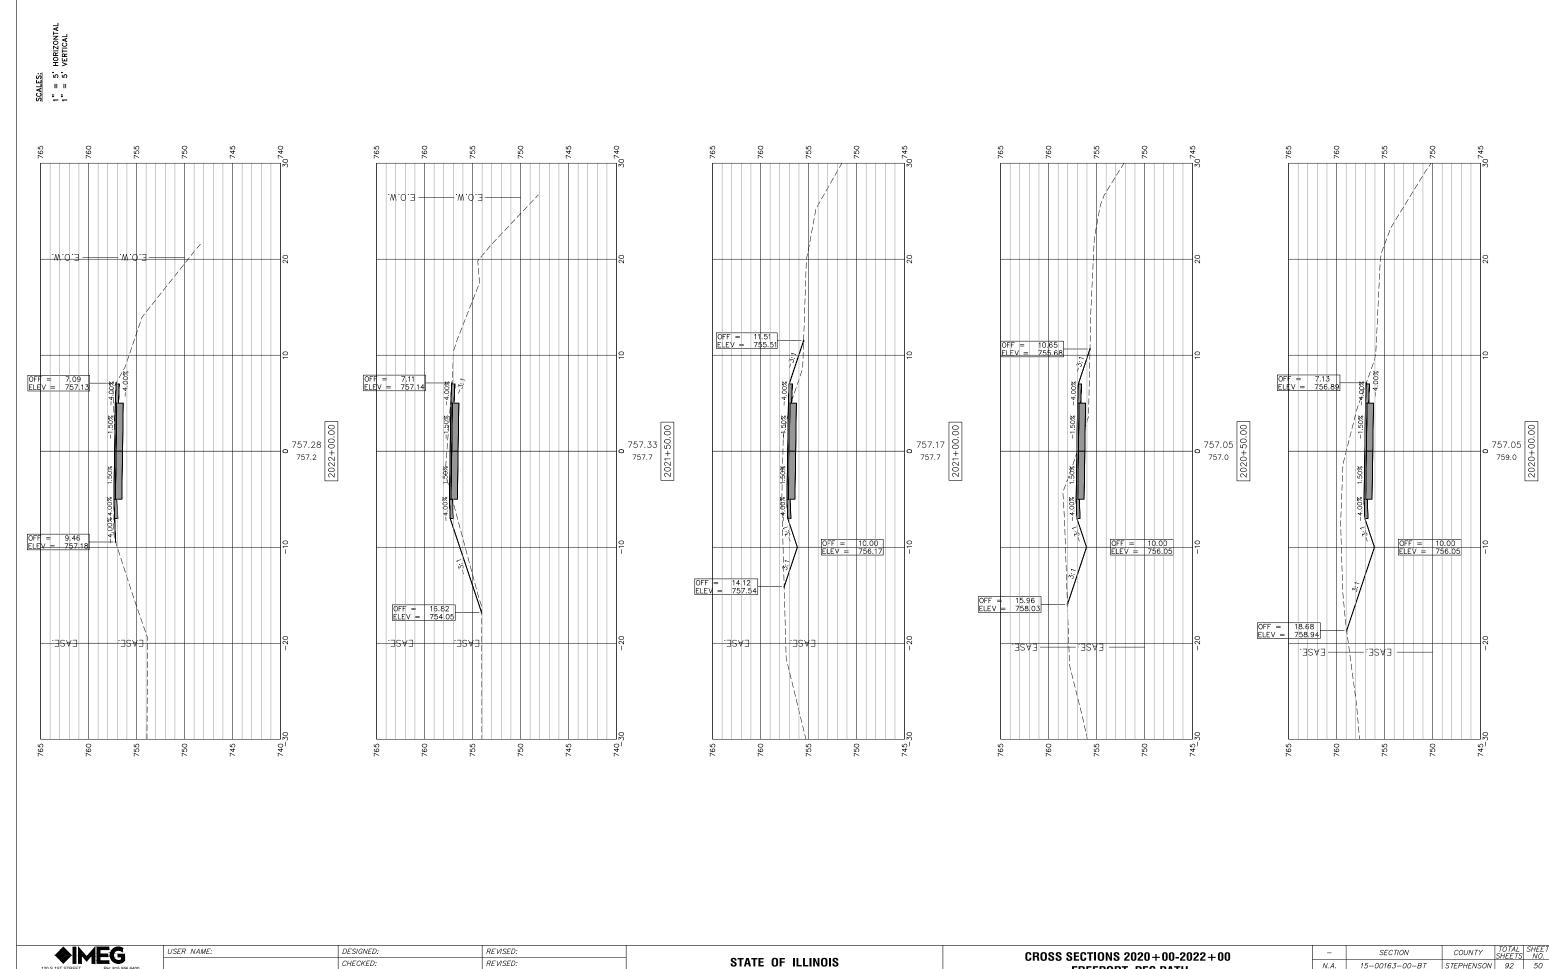

CITY OF FREEPORT PLOT DATE: 3/27/2019 CHECKED: WLK REVISED:

REVISED:

DRAWN: ATH

PLOT SCALE:


COUNTY TOTAL SHEETS NO.

STEPHENSON 92 50 CROSS SECTIONS 2020+00-2022+00 N.A. 15-00163-00-BT FREEPORT PEC PATH CITY OF FREEPORT CONTRACT NO. 85674 SHEET NO. 8 OF 45 SHEETS ILLINOIS FED. AID PROJECT -

SCALES:
1" = 5' HORIZONTAL
1" = 5' VERTICAL 750 OFF = 15.72 ELEV = 752.65 OFF = 12.01 ELEV = 755.13 751.70 00.00 754.5 754.5 753.16 756.8 756.8 755.49 757.1 757.1 OFF = 5 13.77 ELEV = 5 756.66

♦IM	EG
120 S 1ST STREET	PH: 815.956.6400
ROCKFORD, IL 61350	www.imegcorp.com
FORM	MERLY
C Thereton Line	McClure

USER NAME:	DESIGNED:	REVISED:		CROSS SECTIONS 2022+50-2024+00	_	SECTION	COUNTY TOTAL	SHEET NO.
	CHECKED:	REVISED:	STATE OF ILLINOIS		N.A.	15-00163-00-BT	STEPHENSON 92	51
PLOT SCALE:	DRAWN: ATH	REVISED:	CITY OF FREEPORT	FREEPORT PEC PATH	CITY OF	FREEPORT	CONTRACT NO. 856	74
PLOT DATE: 3/27/2019	CHECKED: WLK	REVISED:		SHEET NO. 9 OF 45 SHEETS		ILLINOIS FEL	D. AID PROJECT -	

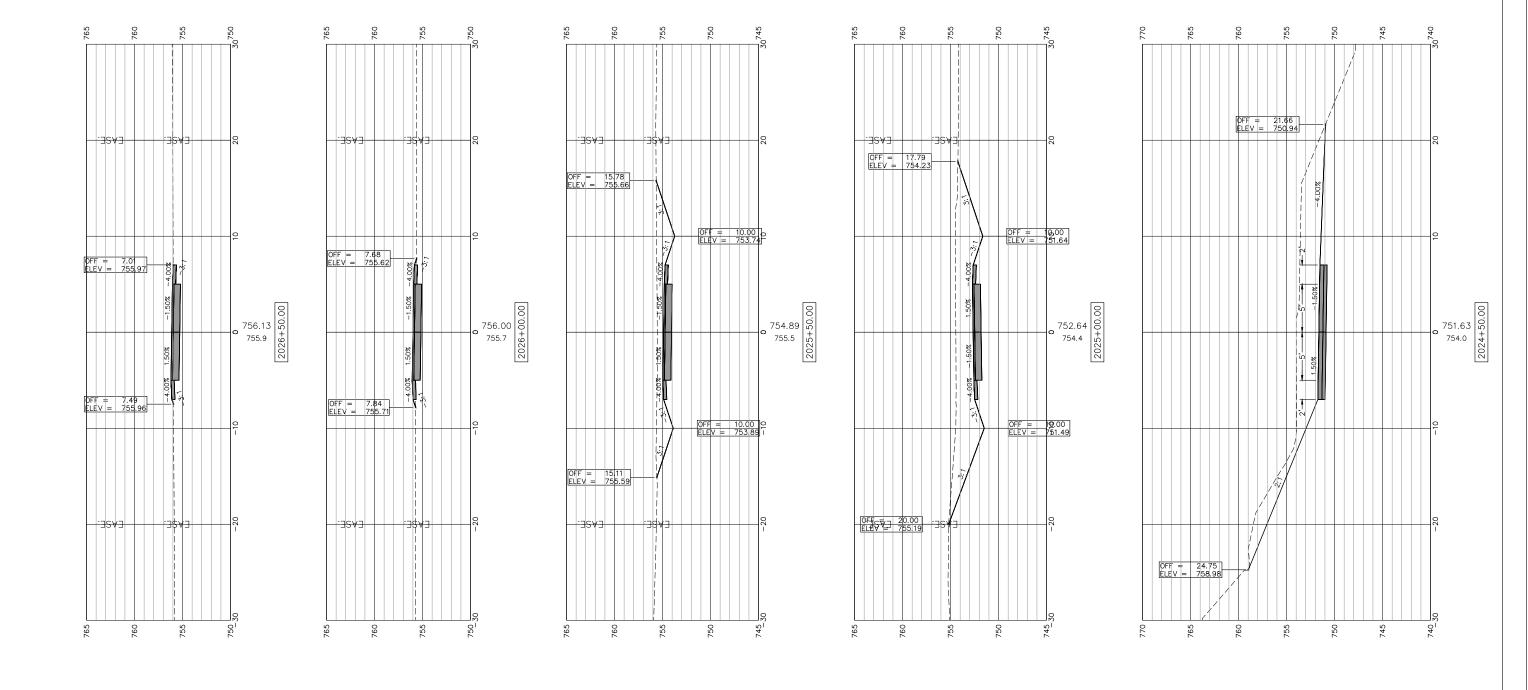

♦IM	EG
120 S 1ST STREET	PH: 815.956.6400
ROCKFORD, IL 61350	www.imegcorp.com
FORI	MERLY
C Theremen, inc.	McClure

USER NAME:	DESIGNED:	REVISED:	
	CHECKED:	REVISED:	
PLOT SCALE:	DRAWN: ATH	REVISED:	
PLOT DATE: 3/27/2019	CHECKED: WLK	REVISED:	

STATE	0F	ILLINOIS
CITY ()F FI	REEPORT

CROSS SECTIONS 2024+50-2026+50	- 2026 + 50 - SECTION COUNTY TOTAL SHEETS NO.	SHEET NO.				
FREEPORT PEC PATH	N.A.	15-00163-00-	-BT	STEPHENSON	92	52
THEEFORE TEOTATII	CITY OF FREEPORT CONTRACT NO. 8.	0. 8567	74			
SHEET NO. 10 OF 45 SHEETS		ILLINOIS	FED. A	AID PROJECT -		

SCALES:
1" = 5' HORIZONTAL
1" = 5' VERTICAL OMISSION -EASE. STREET ALBUM OFF = 7.45 ELEV = 757.35 OFF = 7.30 ELEV = 756.40 OFF = 7.09 ELEV = 756.82 OFF = 7.10 ELEV = 757.47 756.30 00 00 00 00 00 00 00 00 00 00 756.20 755.8 755.8 757.01 756.8 756.8 757.66 757.4 757.66 757.1 757.1 .w.o.я – - R.O.W. OFF = 8.23 ELEV = 757.24 OFF = 9.03 ELEV = 755.52

120 S 1ST STREET PH: 815.956.6400 ROCKFORD, IL 61350 www.imegoro.com


USER NAME:	DESIGNED:	REVISED:		CROSS SECTIONS 2027+00-2040+00
	CHECKED:	REVISED:	STATE OF ILLINOIS	
PLOT SCALE:	DRAWN: ATH	REVISED:	CITY OF FREEPORT	FREEPORT PEC PATH
PLOT DATE: 3/27/2019	CHECKED: WLK	REVISED:		SHEET NO. 11 OF 45 SHEETS

- SECTION COUNTY TOTAL SHEETS NO.

N.A. 15-00163-00-BT STEPHENSON 92 53

CITY OF FREEPORT CONTRACT NO. 85674

ILLINOIS FED. AID PROJECT -

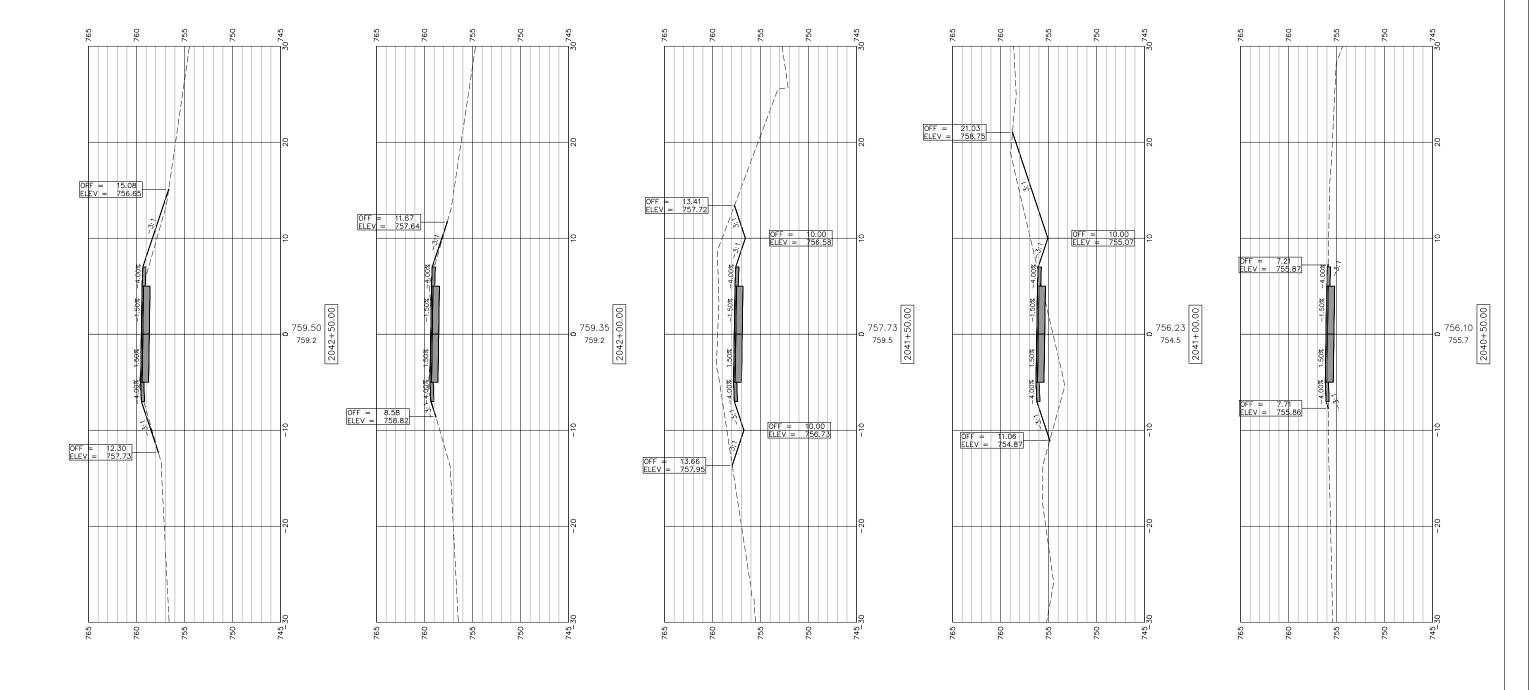


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CROSS SECTIONS 2040+50-2042+50	SS SECTIONS 2040+50-2042+50		COUNTY	TOTAL SHEETS	SHEET NO.
FREEPORT PEC PATH	N.A.	15-00163-00-BT	STEPHENSON	92	54
THEELOHI TEOTATH	CITY OF FREEPORT	FREEPORT	CONTRACT N	0. 8567	74
SHEET NO. 12 OF 45 SHEETS		ILLINOIS FED. A	ID PROJECT -		


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STATE OF ILLINOIS CITY OF FREEPORT

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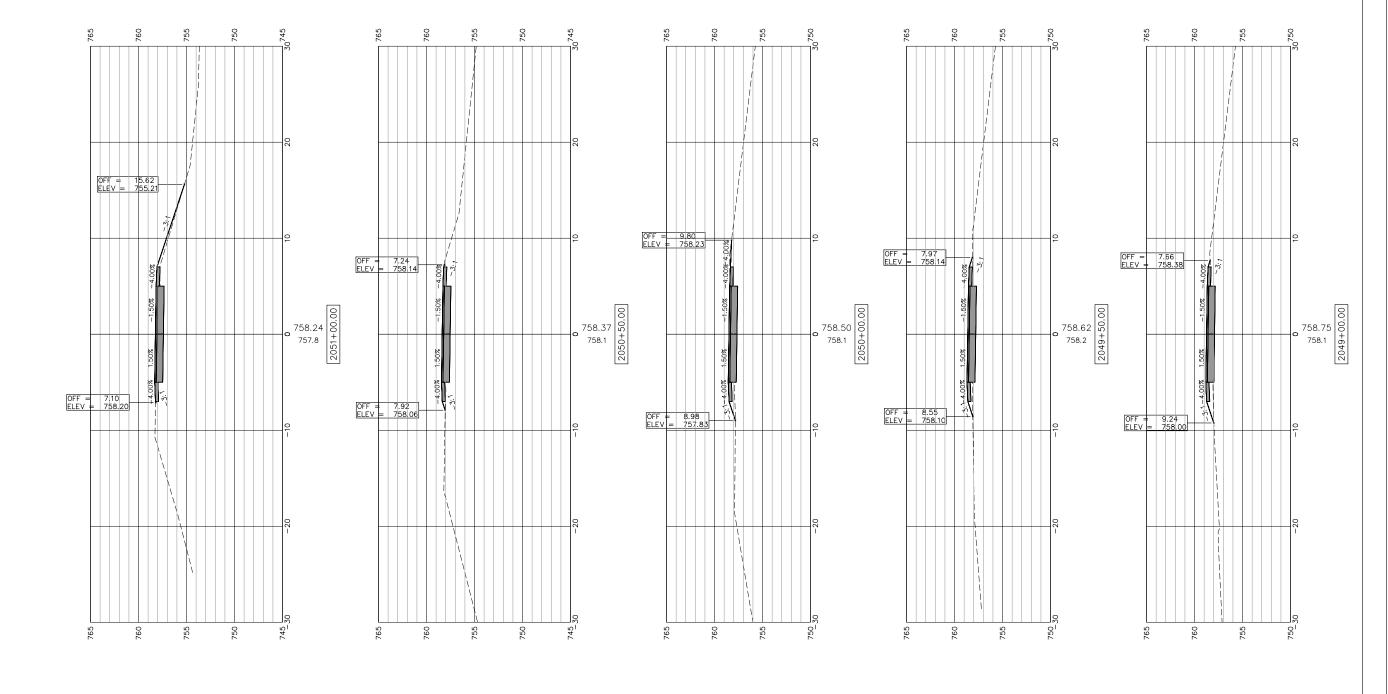
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STATE OF ILLINOIS CITY OF FREEPORT


CROSS SECTIONS 2046+00-2048+50		SECTION	COUNTY	TOTAL SHEETS	SHEET NO.
FREEPORT PEC PATH	N.A.	15-00163-00-BT	STEPHENSON	92	56
THEEL OILL LEGIAIN		CITY OF FREEPORT		CONTRACT NO. 85674	
SHFFT NO. 14 OF 45 SHFFTS		ILLINOIS FFI). AID PROJECT -		

LE NAME AND PATH: \\AD.K.JWW.COM\K.JWW\K.JWW\OFFICES\MCCLURE\ROCKFORD\PROJECTS\H-DRIVE TRANS\14-054-PECPATH-FREEPORT\DESIGN\DRAWNIGS\JMEG FILE STRUCTURE\18000408.00\CAD-BIM FOLDERS\CIVIJD\DWG\PLOT\18000408-X-SECTIONS.DWG

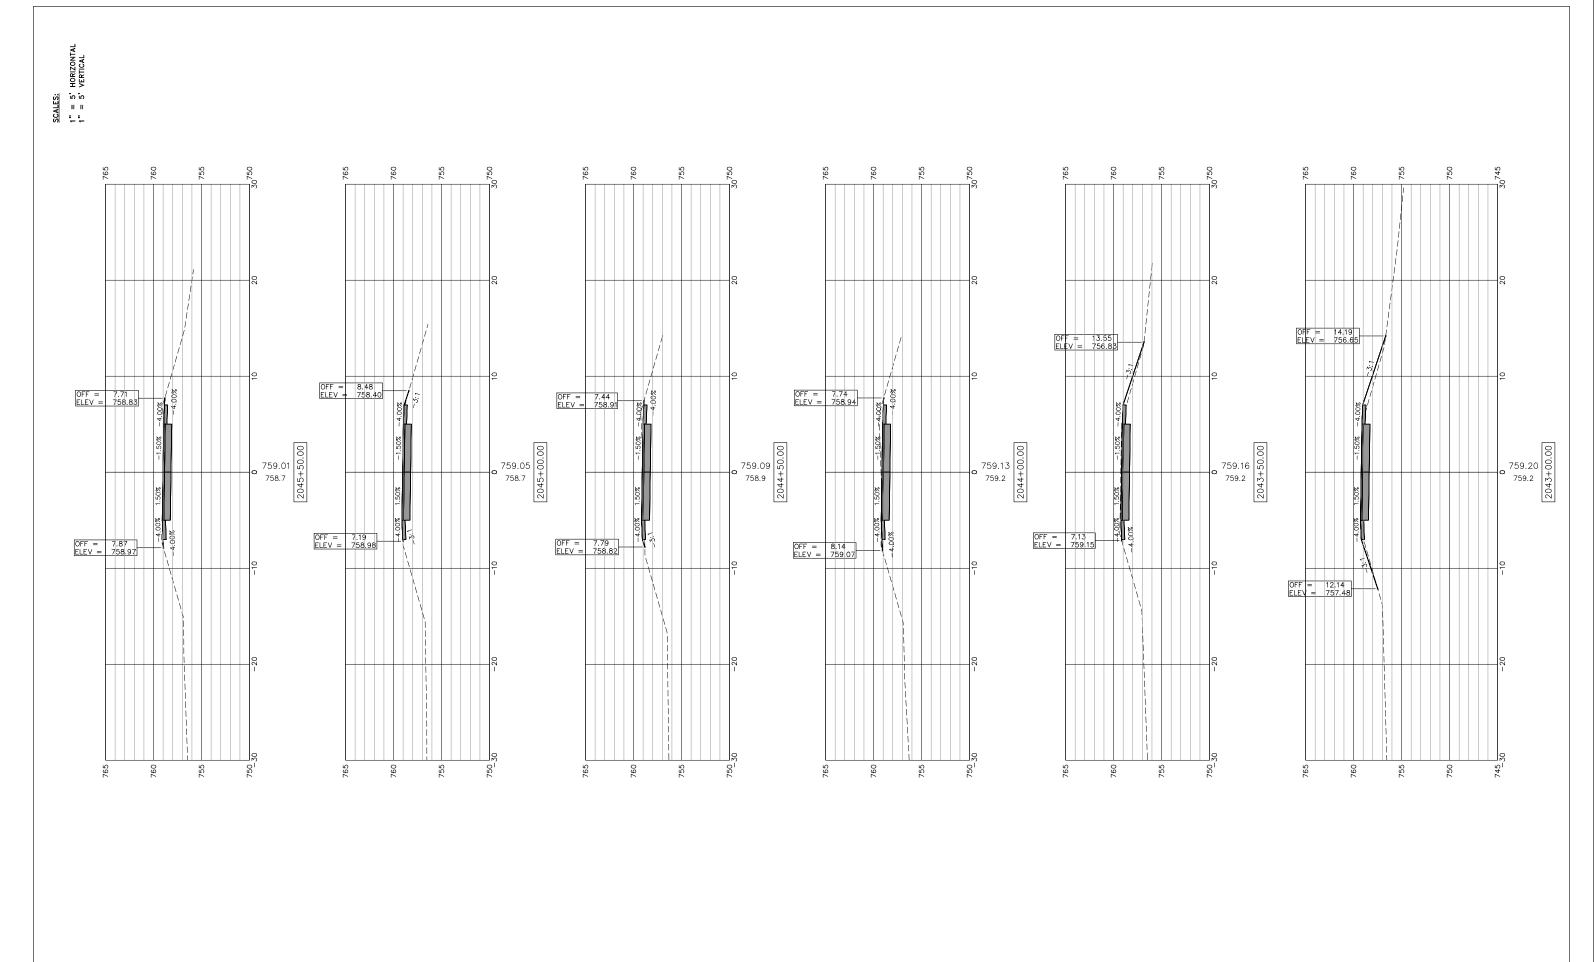
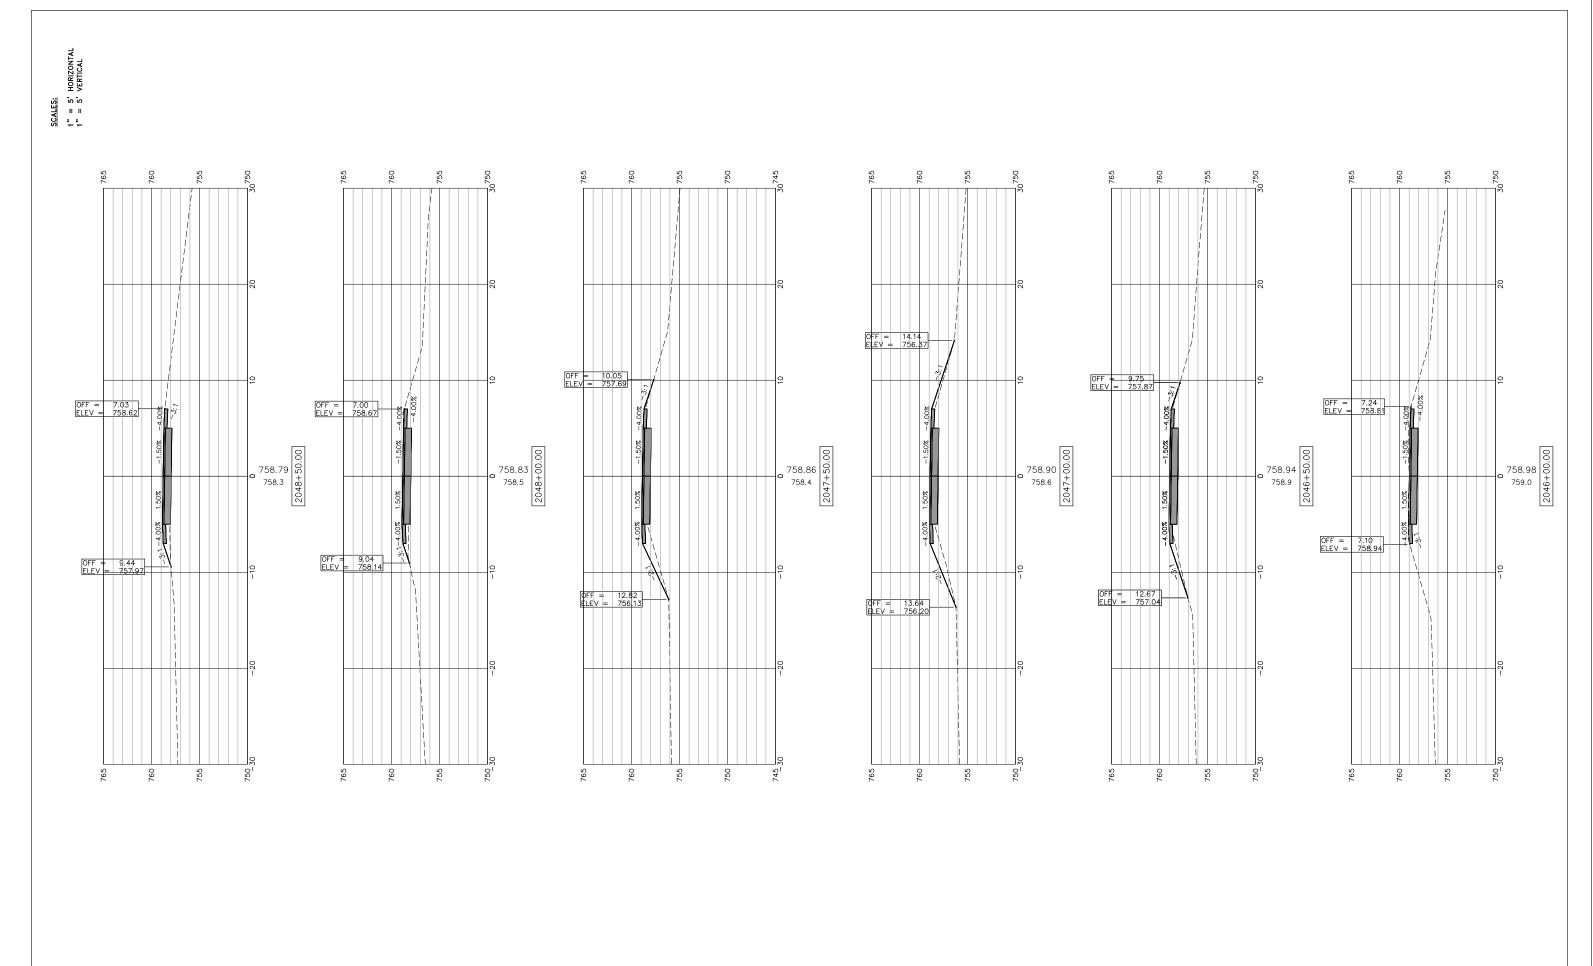
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G	USER NAME:	DESIGNED:	REVISED:		CROSS SECTIONS 2049+00-2051+00	- \$	SECTION	COUNTY
H: 815.956.6400		CHECKED:	REVISED:	STATE OF ILLINOIS		N.A. 15-00	0163-00-BT	STEPHENS
w.imegcorp.com	PLOT SCALE:	DRAWN: ATH	REVISED:	CITY OF FREEPORT	FREEPORT PEC PATH	CITY OF FREEPOR	¿T	CONTRAC
McClure	PLOT DATE: 3/27/2019	CHECKED: WLK	REVISED:		SHEET NO. 15 OF 45 SHEETS			AID PROJECT -

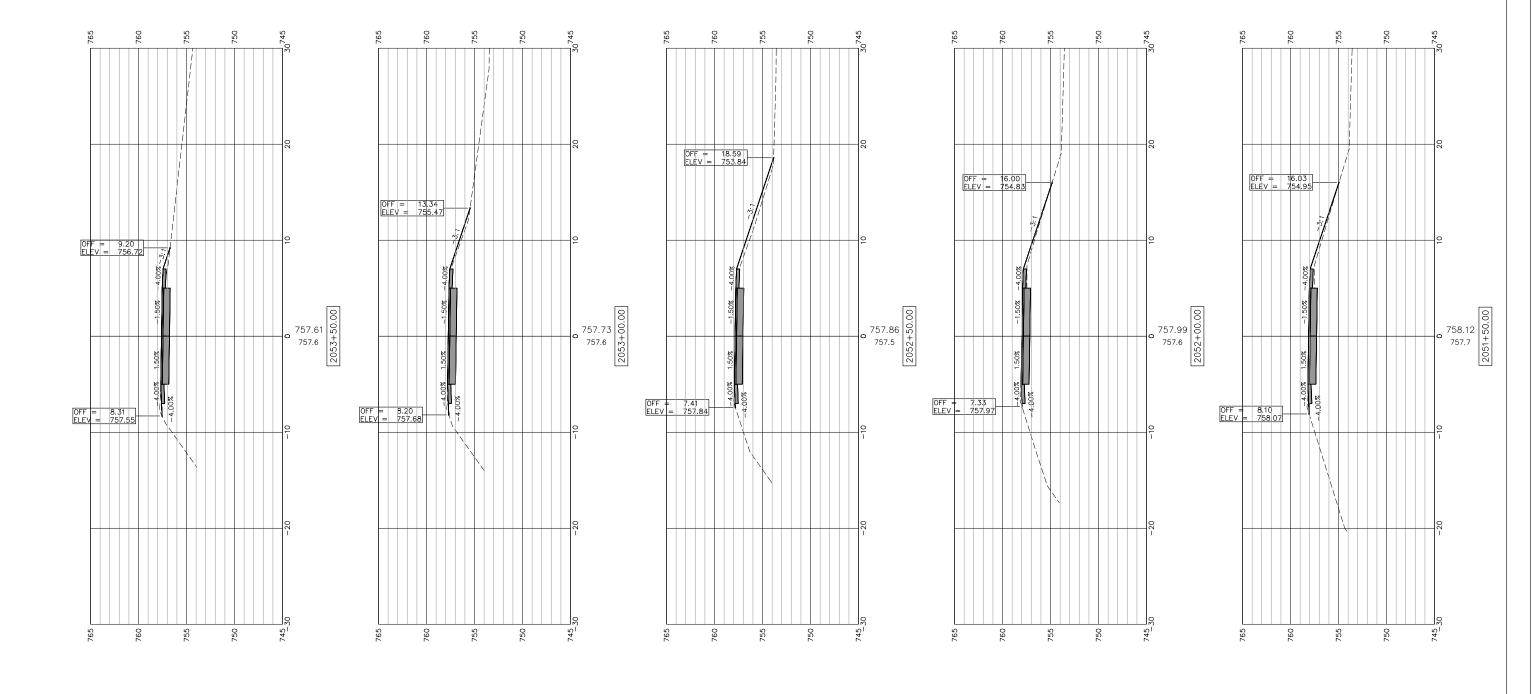


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CROSS SECTIONS 2051+50-2053+50 FREEPORT PEC PATH	_	SECTION	COUNTY	TOTAL SHEETS	SHEE NO.
	N.A.	15-00163-00-BT	STEPHENSON	92	58
	CITY OF FREEPORT		CONTRACT N	CONTRACT NO. 85674	
SHEET NO. 16 OF 45 SHEETS		ILLINOIS FE	D. AID PROJECT -		




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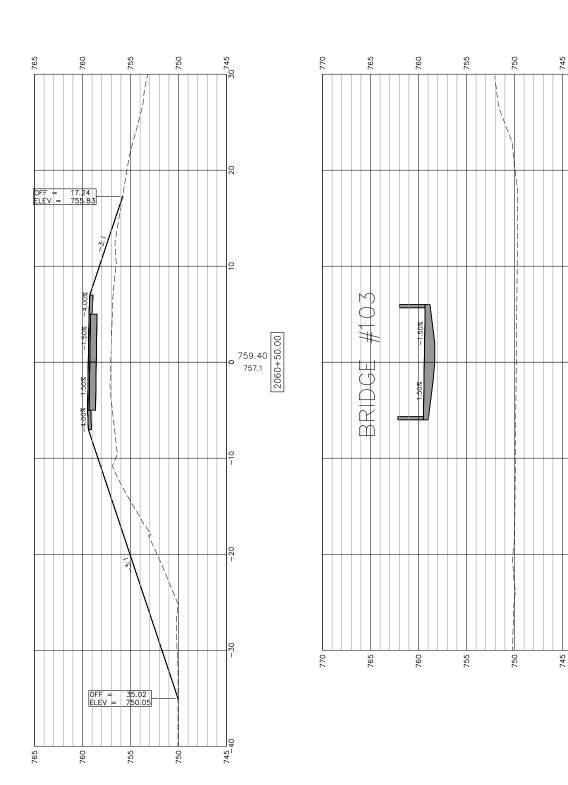
CROSS SECTIONS 2054+00-2056+00 FREEPORT PEC PATH	-	SECTION	COUNTY	TOTAL SHEETS	SHEET NO.
	N.A.	15-00163-00-BT	STEPHENSON	92	59
	CITY OF FREEPORT		CONTRACT NO. 85674		74
SHEET NO. 17 OF 45 SHEETS		ILLINOIS FED.	AID PROJECT -		


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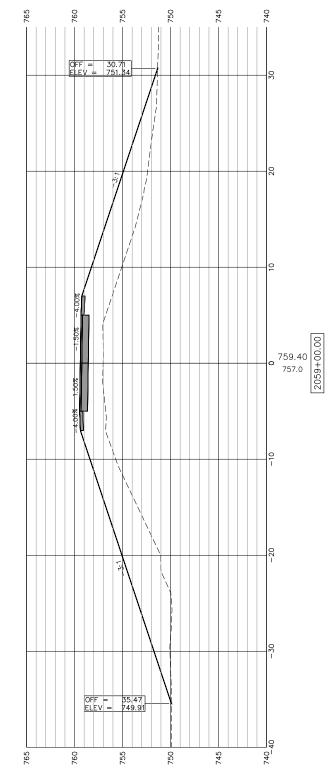

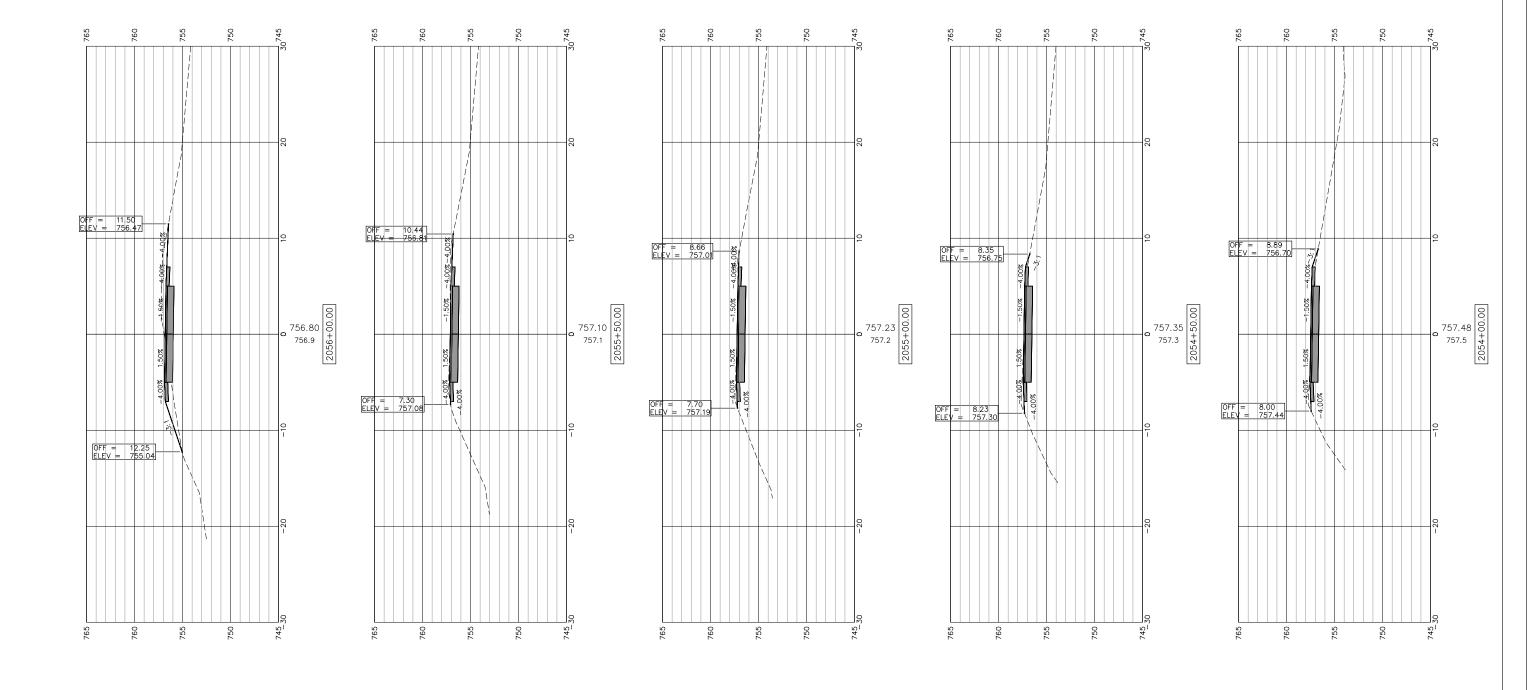
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0		CHECKED:	REVISED:	STATE OF ILLINOIS		N.A.	15-00163-00-BT	STEPHENSON	92 60
m	PLOT SCALE:	DRAWN: ATH	REVISED:	CITY OF FREEPORT	FREEPORT PEC PATH	CITY OF	FREEPORT	CONTRACT I	VO. 85674
) .in.	PLOT DATE: 3/27/2019	CHECKED: WLK	REVISED:		SHEET NO. 18 OF 45 SHEETS		ILLINOIS FEL	O. AID PROJECT -	





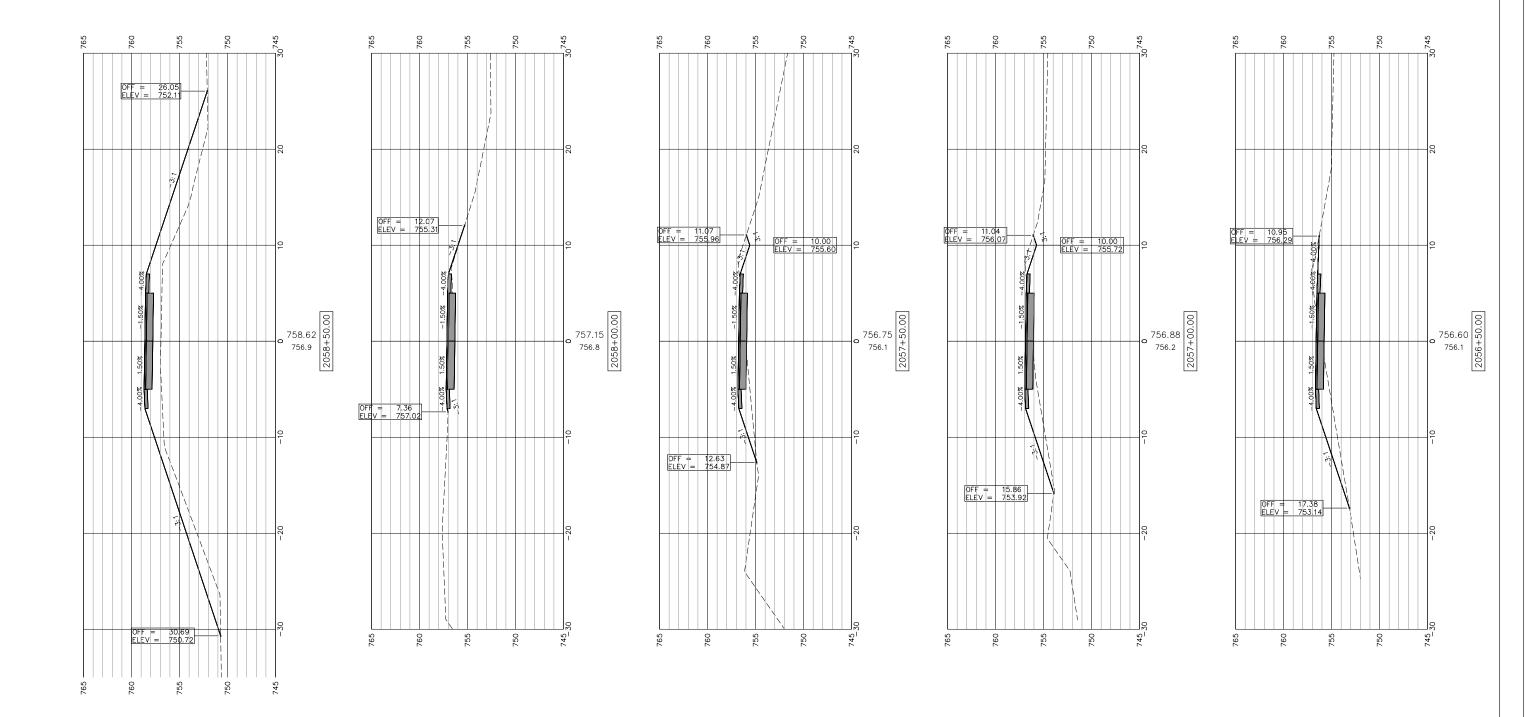

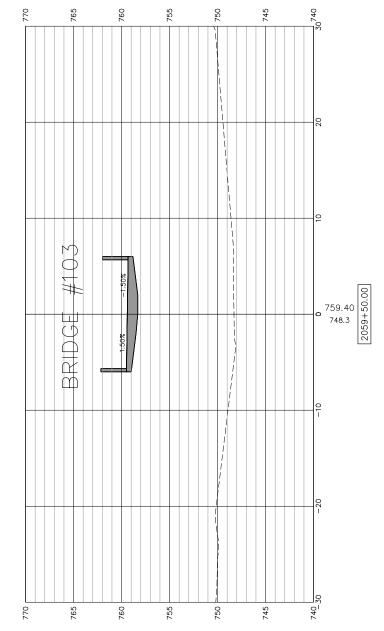
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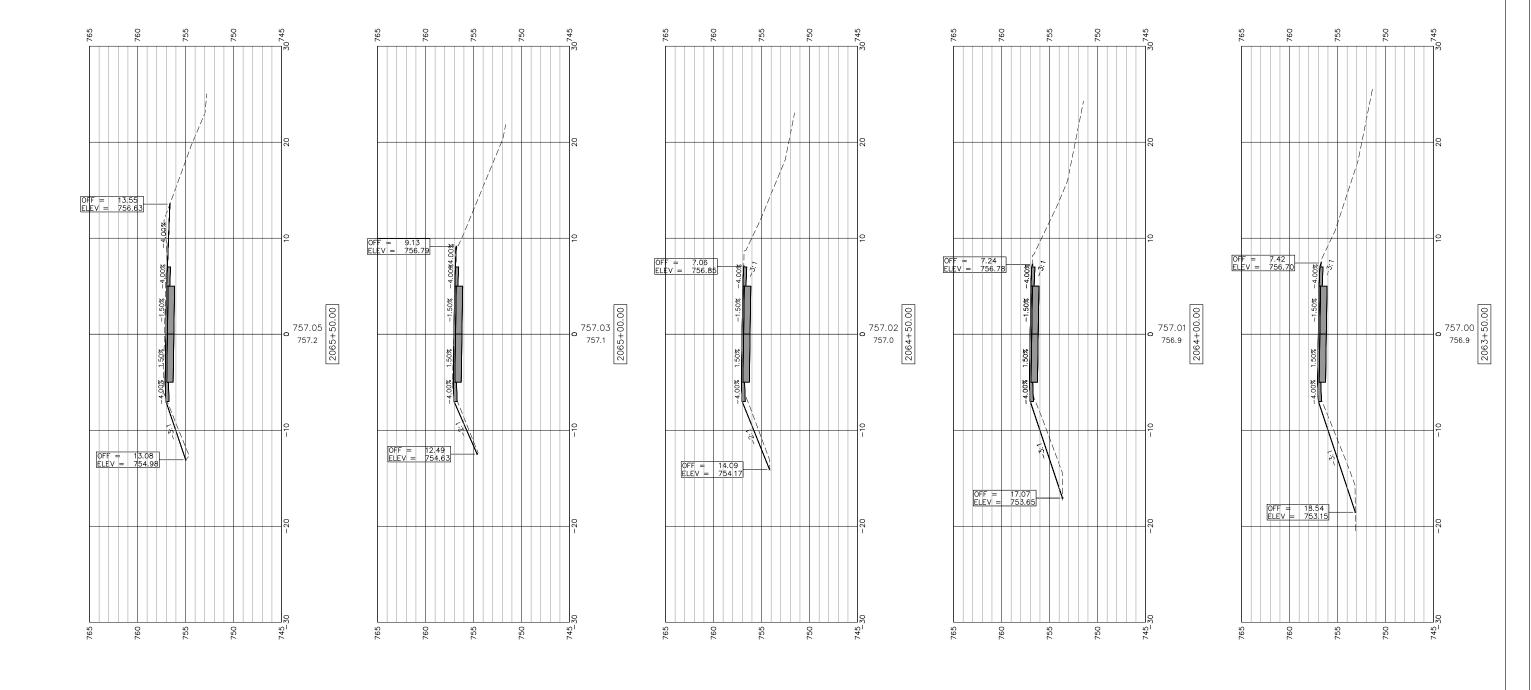
759.40 749.8 749.8

CROSS SECTIONS 2059+00-2060+50		SECTION COUNTY		COUNTY	TOTAL SHEETS	SHEE NO.
FREEPORT PEC PATH	N.A.	15-00163-00-	BT	STEPHENSON	92	61
		CITY OF FREEPORT CO			CONTRACT NO. 85674	
SHEET NO. 19 OF 45 SHEETS		ILLINOIS	FED. A	ND PROJECT -		



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10		CHECKED:	REVISED:	STATE OF ILLINOIS		N.A.	15-00163-00-BT	STEPHENSON	v 92 62	
m	PLOT SCALE:	DRAWN: ATH	REVISED:	CITY OF FREEPORT	FREEPORT PEC PATH	CITY OF	FREEPORT	CONTRACT	NO. 85674	
e Chr.	PLOT DATE: 3/27/2019	CHECKED: WLK	REVISED:		SHEET NO. 20 OF 45 SHEETS		ILLINOIS FE	D. AID PROJECT -		

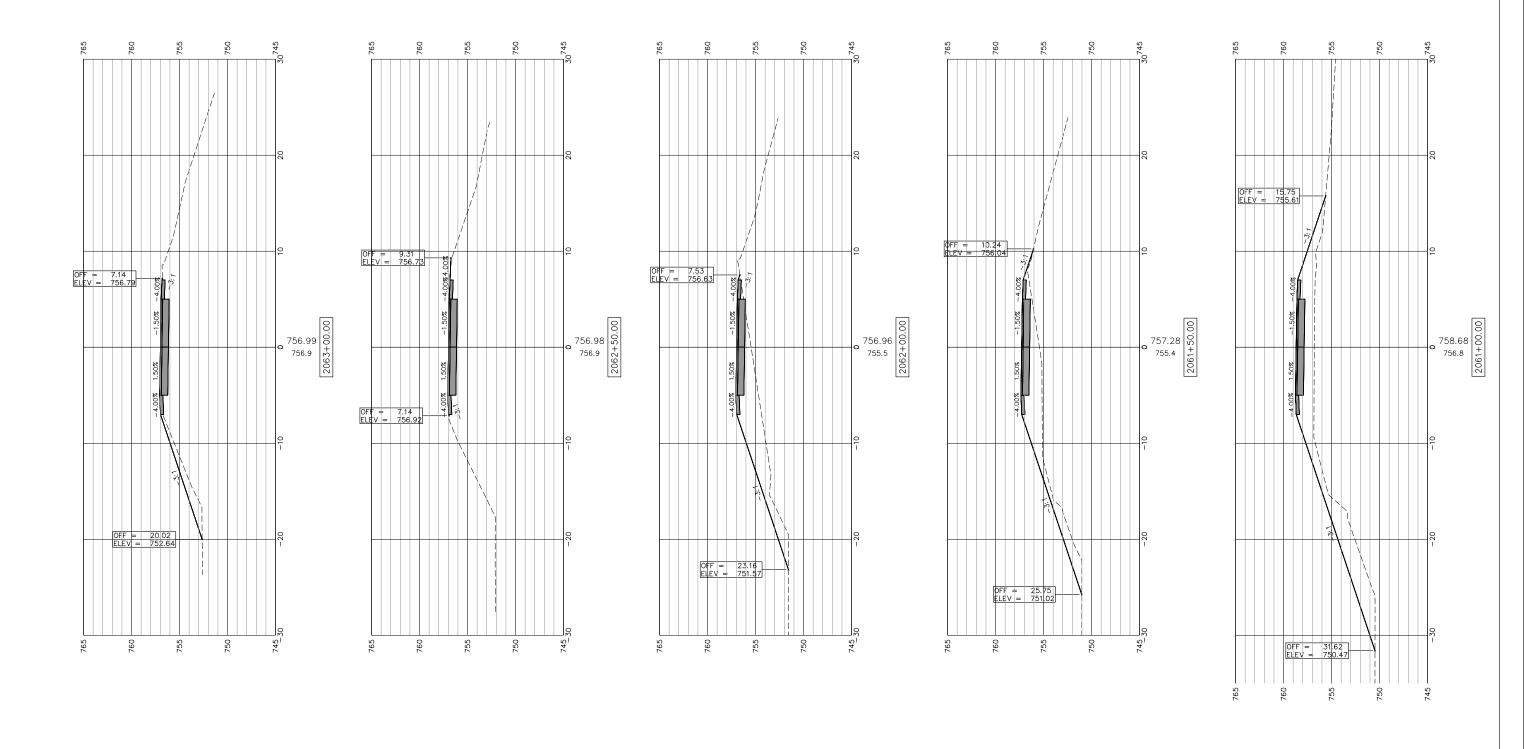


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CROSS SECTIONS 2063+50-2065+50 FREEPORT PEC PATH	_	- SECTION COU		TOTAL SHEETS	SHEET NO.
	N. A.	15-00163-00-BT	STEPHENSON	92	63
	CITY OF	FREEPORT	CONTRACT NO. 85674		74
SHEET NO. 21 OF 45 SHEETS		ILLINOIS FED. A	ID PROJECT -		

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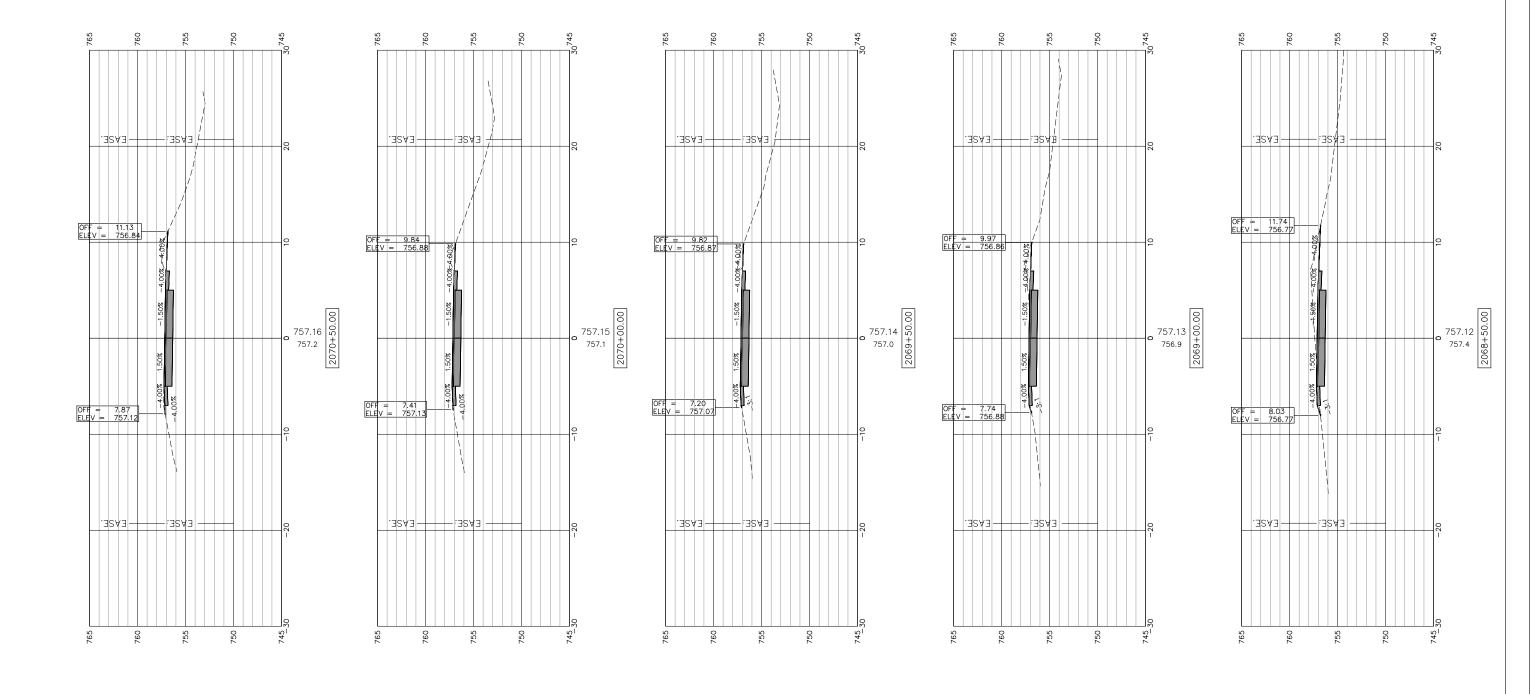


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CROSS SECTIONS 2066+00-2068+00 FREEPORT PEC PATH	-	SECTION		COUNTY	TOTAL SHEETS	SHEE NO.
	N.A.	15-00163-00-BT		STEPHENSON	92	64
	CITY OF FREEPORT			CONTRACT NO. 85674		74
SHEET NO. 22 OF 45 SHEETS		ILLINOIS	FED. A	ND PROJECT -		




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CITY O	F FI	REEPOF	RТ

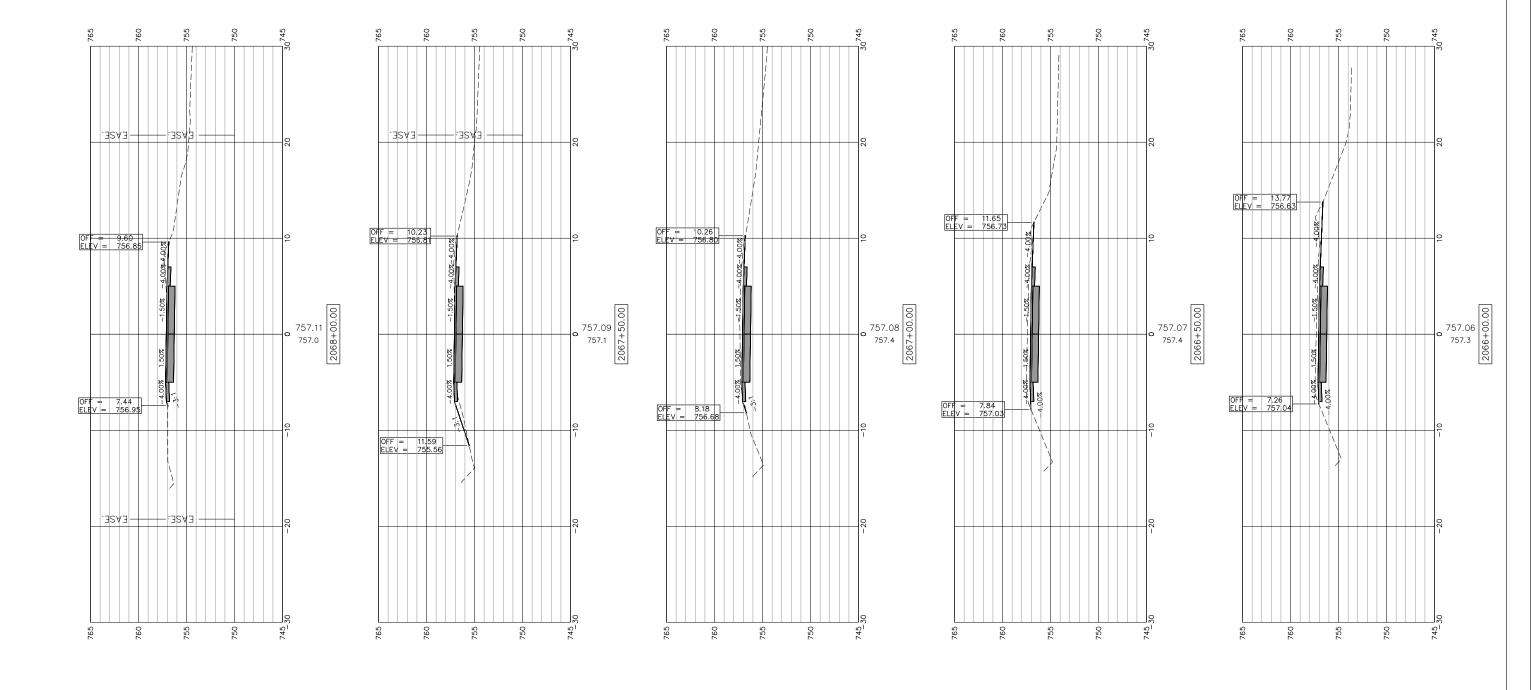CROSS SECTIONS 2068+50-2070+50 FREEPORT PEC PATH	-	SECTION		COUNTY	TOTAL SHEETS	SHEE! NO.
	N.A.	15-00163-00-BT		STEPHENSON	92	65
	CITY OF FREEPORT			CONTRACT NO. 85674		'4
SHEET NO. 23 OF 45 SHEETS		ILLINOIS	FED. A	ID PROJECT -		




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CROSS SECTIONS 2071+00-2073+00 FREEPORT PEC PATH	_	SECTION		COUNTY	TOTAL SHEETS	SHEE NO.	
	N.A.	15-00163-00-BT		STEPHENSON	92	66	
	CITY OF FREEPORT				CONTRACT NO. 85674		74
SHEET NO. 24 OF 45 SHEETS			ILLINOIS	FED.	AID PROJECT -		

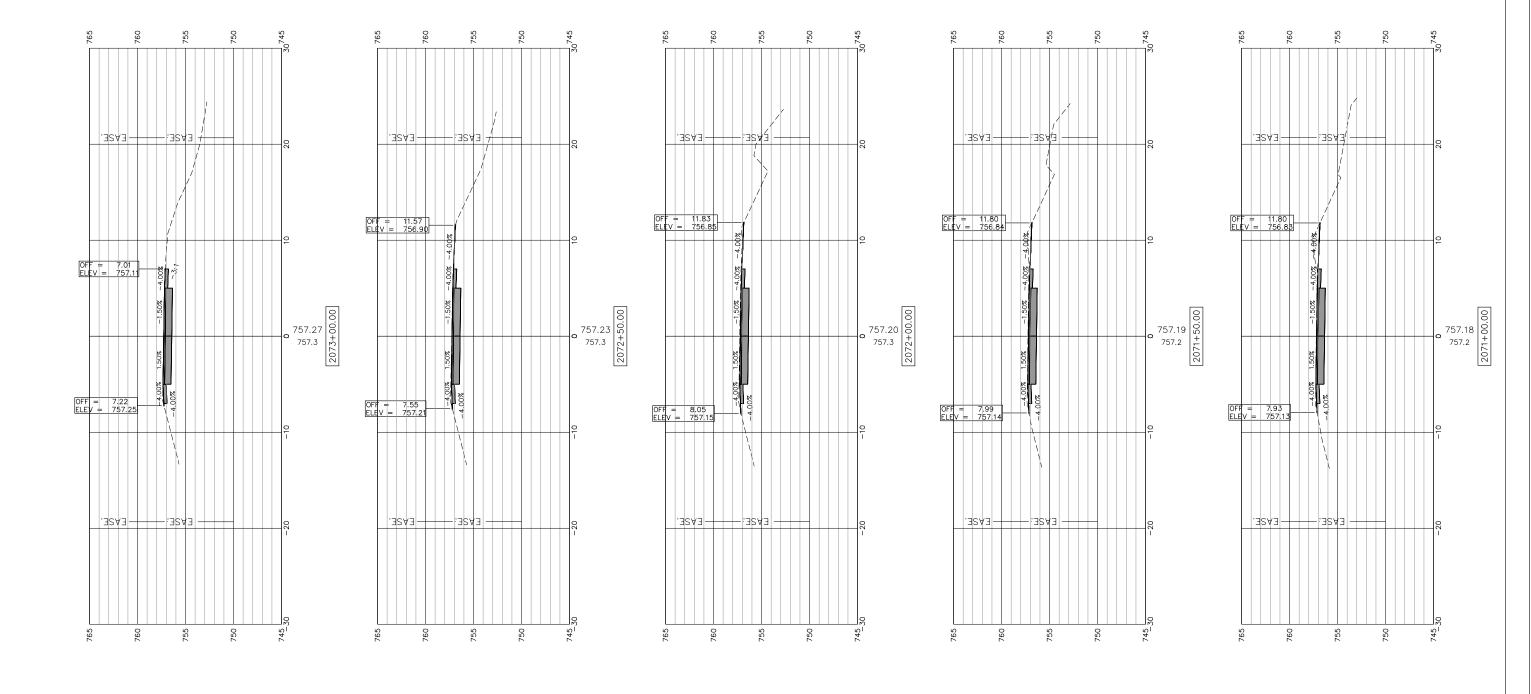
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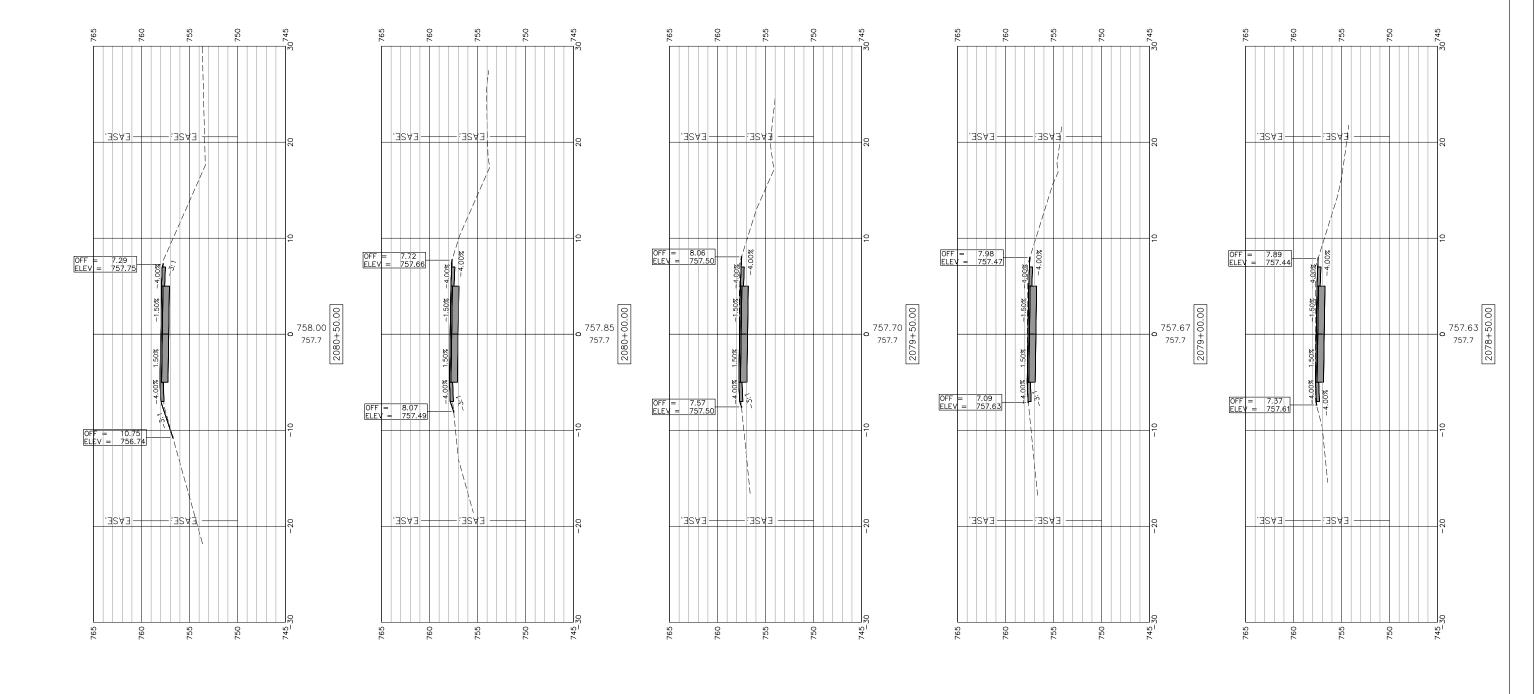
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	CHECKED:	REVISED:	STATE OF ILLINOIS	FREEPORT PEC PATH	N.A.	15-00163-00-BT	STEPHENSON 92 67	٦
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PLOT DATE: 3/27/2019	CHECKED: WLK	REVISED:		SHEET NO. 25 OF 45 SHEETS		ILLINOIS FE	ED. AID PROJECT -	٦

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	CHECKED:	REVISED:	STATE OF ILLINOIS		N.A.	15-00163-00-BT	STEPHENSON 92 68	1
PLOT SCALE:	DRAWN: ATH	REVISED:	CITY OF FREEPORT	FREEPORT PEC PATH	CITY OF I	REEPORT	CONTRACT NO. 85674	1
PLOT DATE: 3/27/2019	CHECKED: WLK	REVISED:		SHEET NO. 26 OF 45 SHEETS		ILLINOIS FED.	AID PROJECT -	




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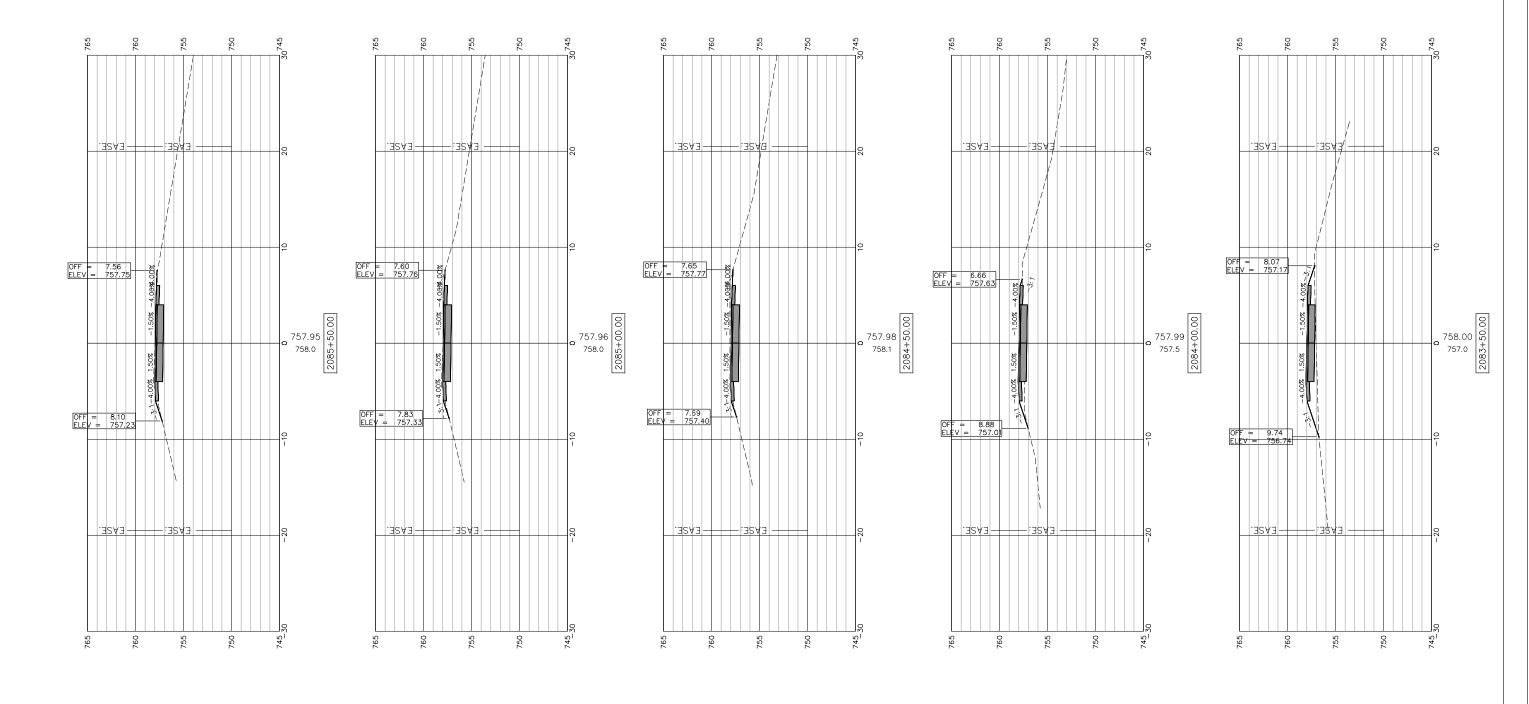
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CITY	0F	FR	EEP	ORT	

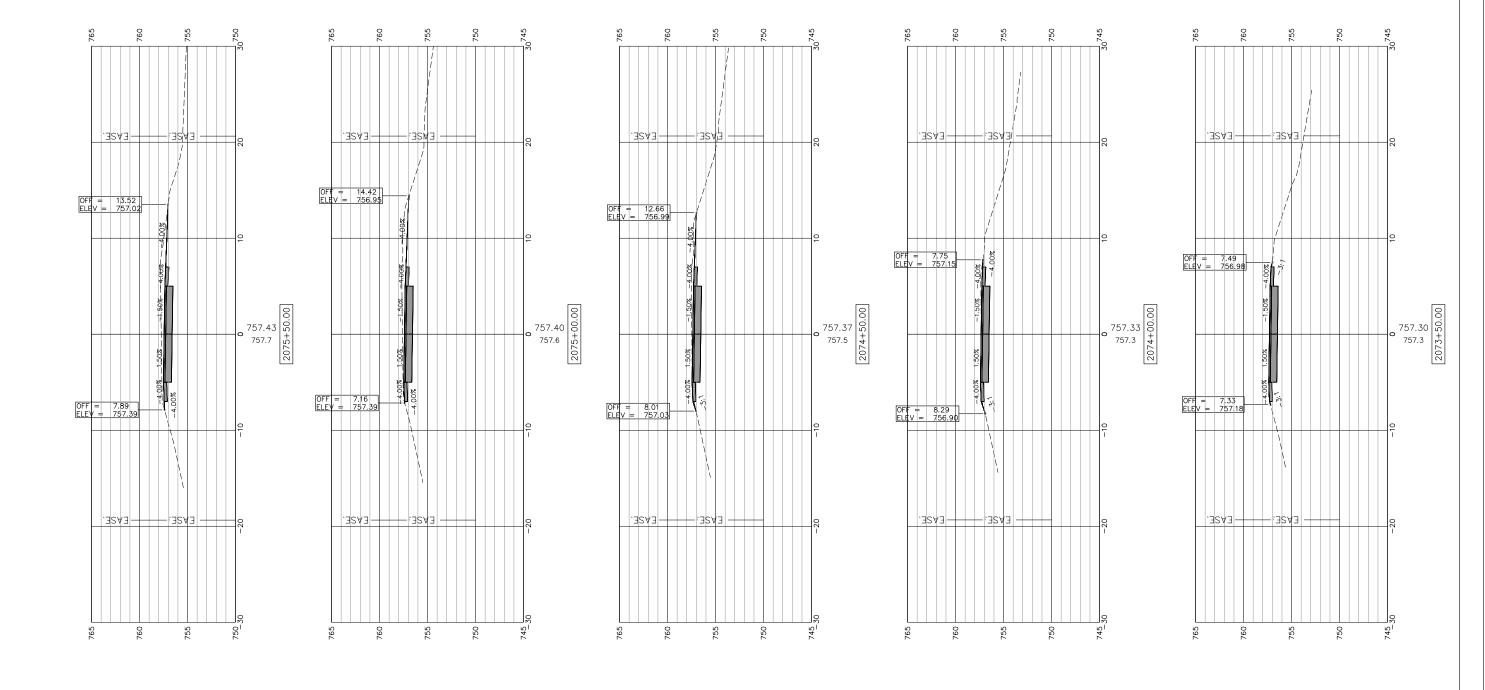CROSS SECTIONS 2078+50-2080+50	-	SECTION		COUNTY	TOTAL SHEETS	SHEE NO.	
FREEPORT PEC PATH	N.A.	15-00163-00-BT		BT	STEPHENSON	92	69
INCLIONI ILGIAIII	CITY OF FREEPORT			CONTRACT NO. 85		74	
SHEET NO. 27 OF 45 SHEETS			ILLINOIS	FED.	AID PROJECT -		

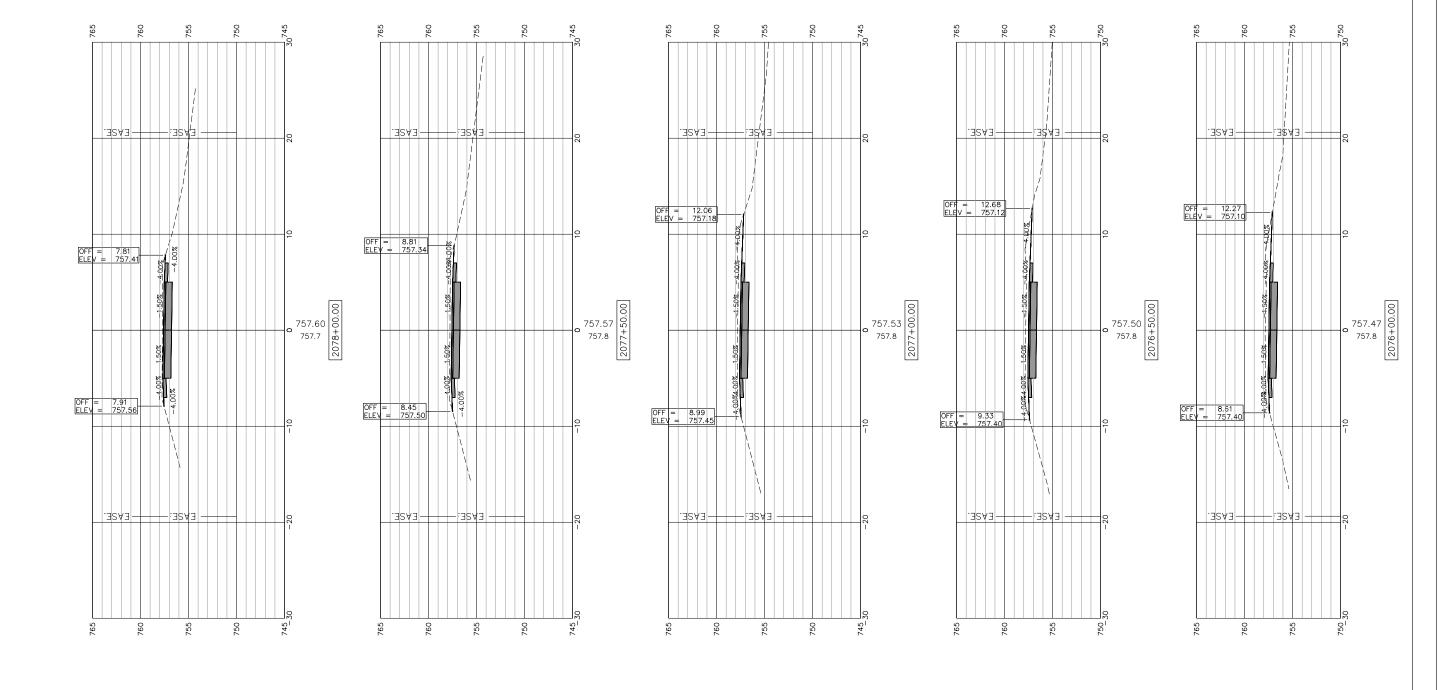

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	CHECKED:	REVISED:	STATE OF ILLINOIS	FREEPORT PEC PATH	N.A.	15-00163-00-BT	STEPHENSON	92	70
PLOT SCALE:	DRAWN: ATH	REVISED:	CITY OF FREEPORT	FREEPURI PEU PAIN	CITY OF	FREEPORT	CONTRACT N	VO. 85674	
PLOT DATE: 3/27/2019	CHECKED: WLK	REVISED:		SHEET NO. 28 OF 45 SHEETS		ILLINOIS FED. A	ID PROJECT -		

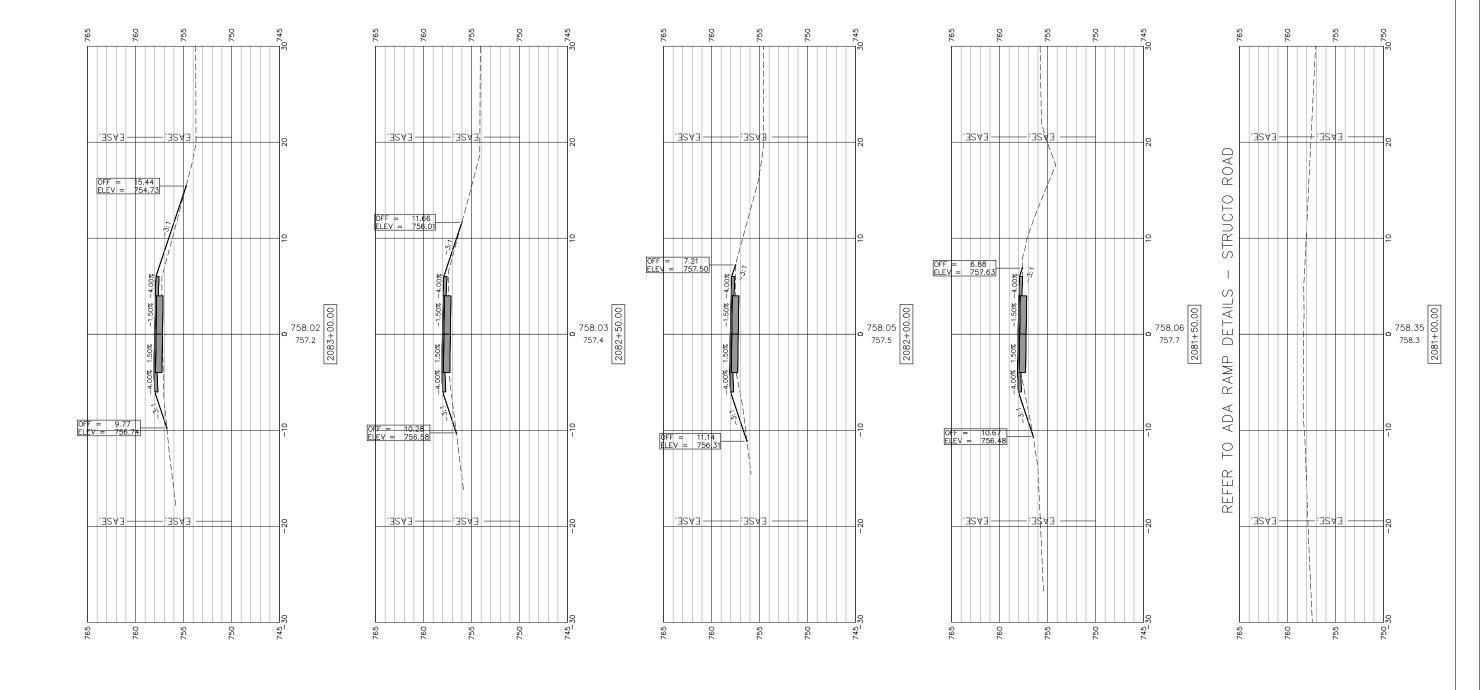

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PLOT DATE: 3/27/2019	CHECKED: WLK	REVISED:

STATE OF	ILLINOIS
CITY OF F	REEPORT

CROSS SECTIONS 2083+50-2085+50	-	SECTION	COUNTY	TOTAL SHEETS	SHEET NO.
FREEPORT PEC PATH	N.A.	15-00163-00-BT	STEPHENSON	92	71
	CITY OF FREEPORT		CONTRACT NO. 85674		
SHFFT NO. 29 OF 45 SHFFTS		ILLINOIS FED AID PROJECT -			

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SCALES:
1" = 5' HORIZONTAL
1" = 5' VERTICAL OFF = 7.59 ELEV = 758.33 #10 758.38 758.3 00 4 758.3 758.53 758.5 758.5 BRID OFF = 16.98 ELEV = 754.06

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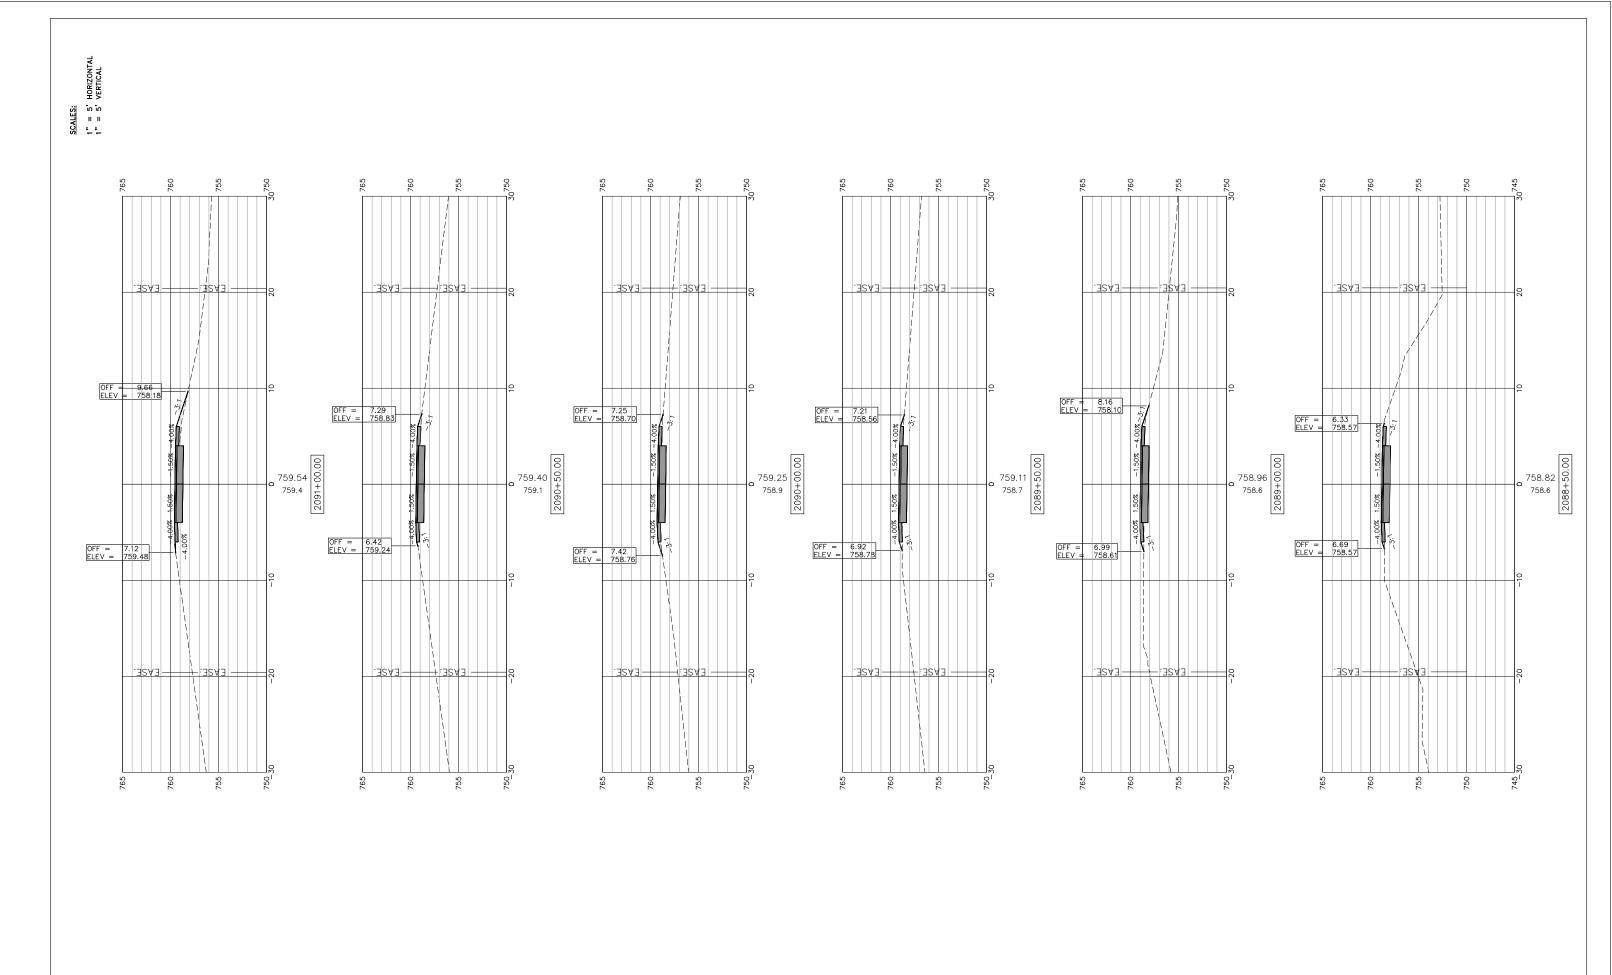
STATE OF ILLINOIS **CITY OF FREEPORT**

CROSS SECTIONS 2086+00-2088+00 FREEPORT PEC PATH CITY OF FREEPORT SHEET NO. 30 OF 45 SHEETS

 SECTION
 COUNTY
 TOTAL SHEETS NO.

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 STEPHENSON
 92
 72
 CONTRACT NO. 85674 ILLINOIS FED. AID PROJECT -

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STATE OF ILLINOIS CITY OF FREEPORT CROSS SECTIONS 2088+50-2091+00
FREEPORT PEC PATH

SHEET NO. 31 OF 45 SHEETS


- SECTION COUNTY TOTAL SHEETS NO.

N.A. 15-00163-00-BT STEPHENSON 92 73

CITY OF FREEPORT CONTRACT NO. 85674

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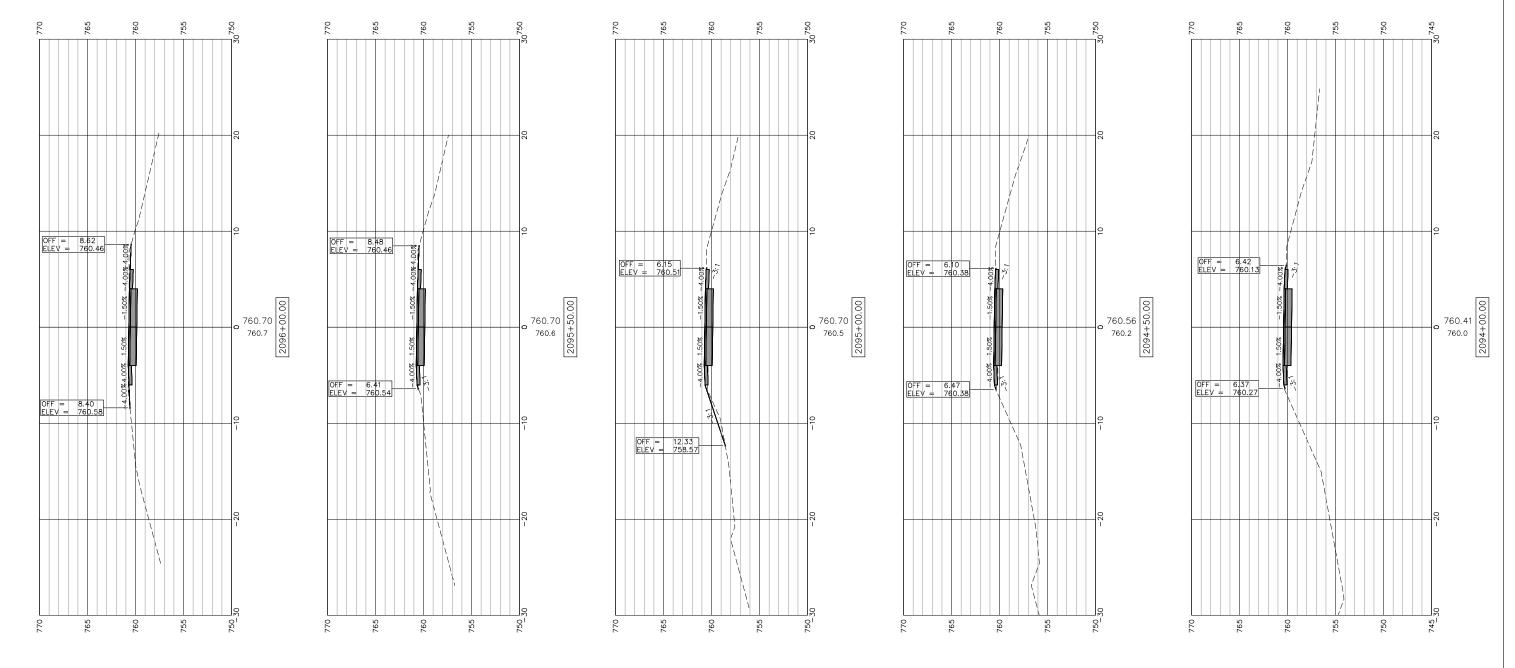


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PLOT DATE: 3/27/2019	CHECKED: WLK	REVISED:
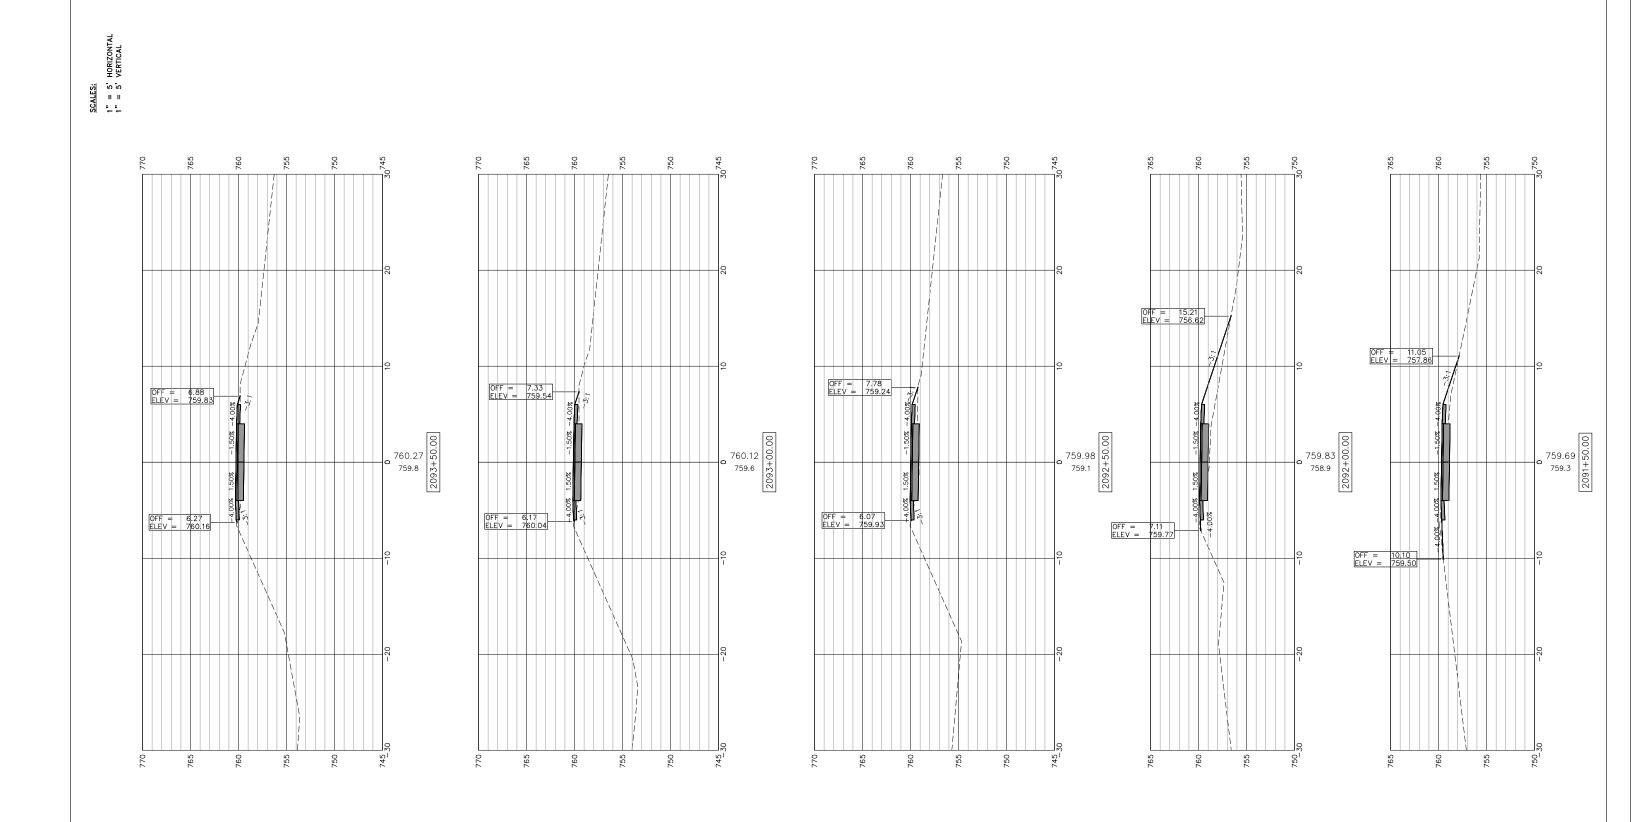
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CITY O	F FF	REEPORT	

CROSS SECTIONS 2091+50-2093+50	-	SECTION		COUNTY	TOTAL SHEETS	SHEE! NO.
FREEPORT PEC PATH	N.A.	15-00163-00-	BT	STEPHENSON	92	74
THEEL OILL LEGIAIN	CITY OF	FREEPORT		CONTRACT N	10. 8567	74
SHEET NO. 32 OF 45 SHEETS		ILLINOIS	FED. A	AID PROJECT -		




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	CHECKED:	REVISED:
PLOT SCALE:	DRAWN: ATH	REVISED:
PLOT DATE: 3/27/2019	CHECKED: WLK	REVISED:

STAT	E 0	FI	LLIN	10IS
CITY	0F	FRI	EEP(ORT

CROSS SECTIONS 2094+00-2096+00	-	SECTION	COUNTY	TOTAL SHEETS	SHEE NO.
FREEPORT PEC PATH	N.A.	15-00163-00-BT	STEPHENSON	92	75
THEEFORE TEOTATII	CITY OF	FREEPORT	CONTRACT N	10. 8567	74
SHEET NO. 33 OF 45 SHEETS		ILLINOIS FED.	AID PROJECT -		

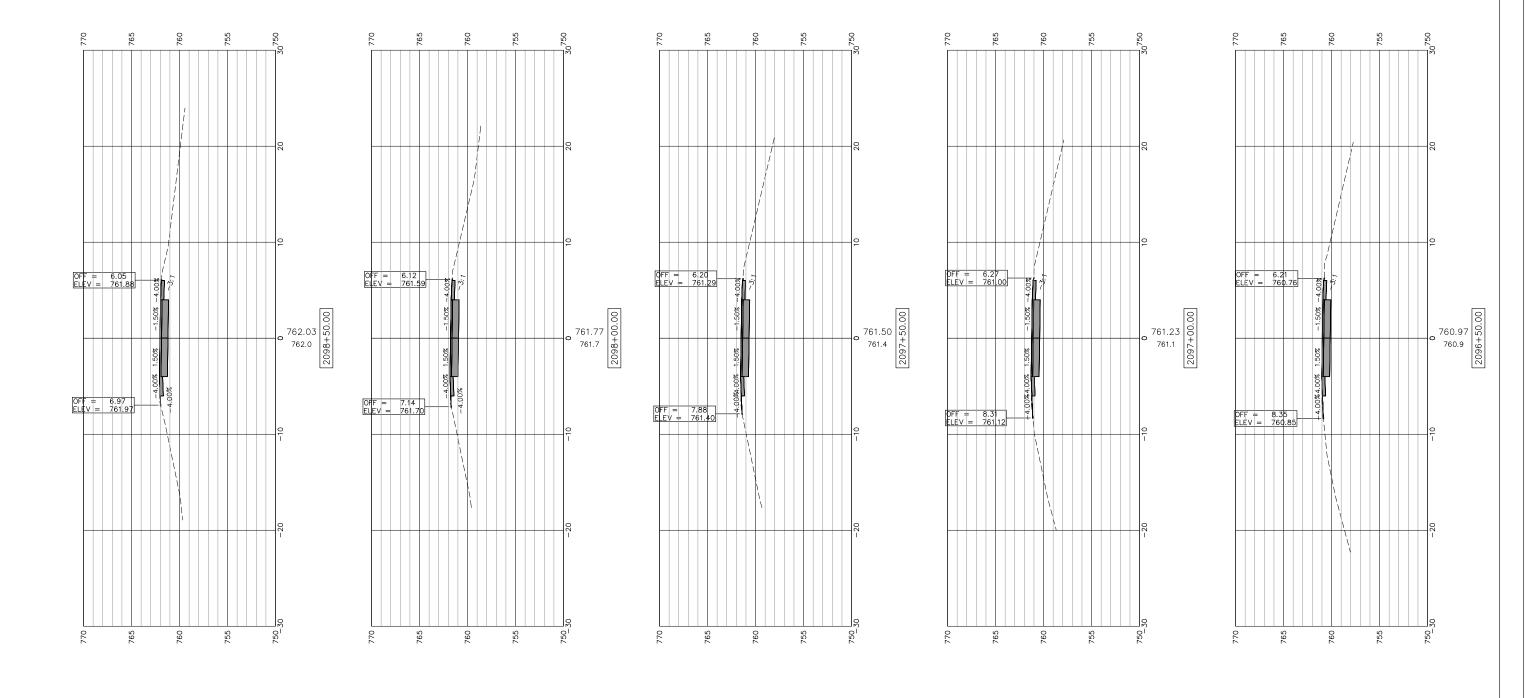


	ÆG
120 S 1ST STREET	PH: 815.956.6400
ROCKFORD, IL 61350	www.imegcorp.com
FOR	MERLY
Cilliannan inc.	McClure

USER NAME:	DESIGNED:	REVISED:
	CHECKED:	REVISED:
PLOT SCALE:	DRAWN: ATH	REVISED:
PLOT DATE: 3/27/2019	CHECKED: WLK	REVISED:

STATE	0F	ILLINOIS	
CITY O	F FI	REEPORT	

CROSS SECTIONS 2096 + 50-2098 + 50		SECTION COU		TOTAL SHEETS	SHEE NO.
FREEPORT PEC PATH	N.A.	15-00163-00-BT	STEPHENSON	92	76
THELIONI ILCIAIII	CITY OF FREEPORT		CONTRACT N	CONTRACT NO. 8567	
SHEET NO. 34 OF 45 SHEETS		ILLINOIS FI	ED. AID PROJECT -		

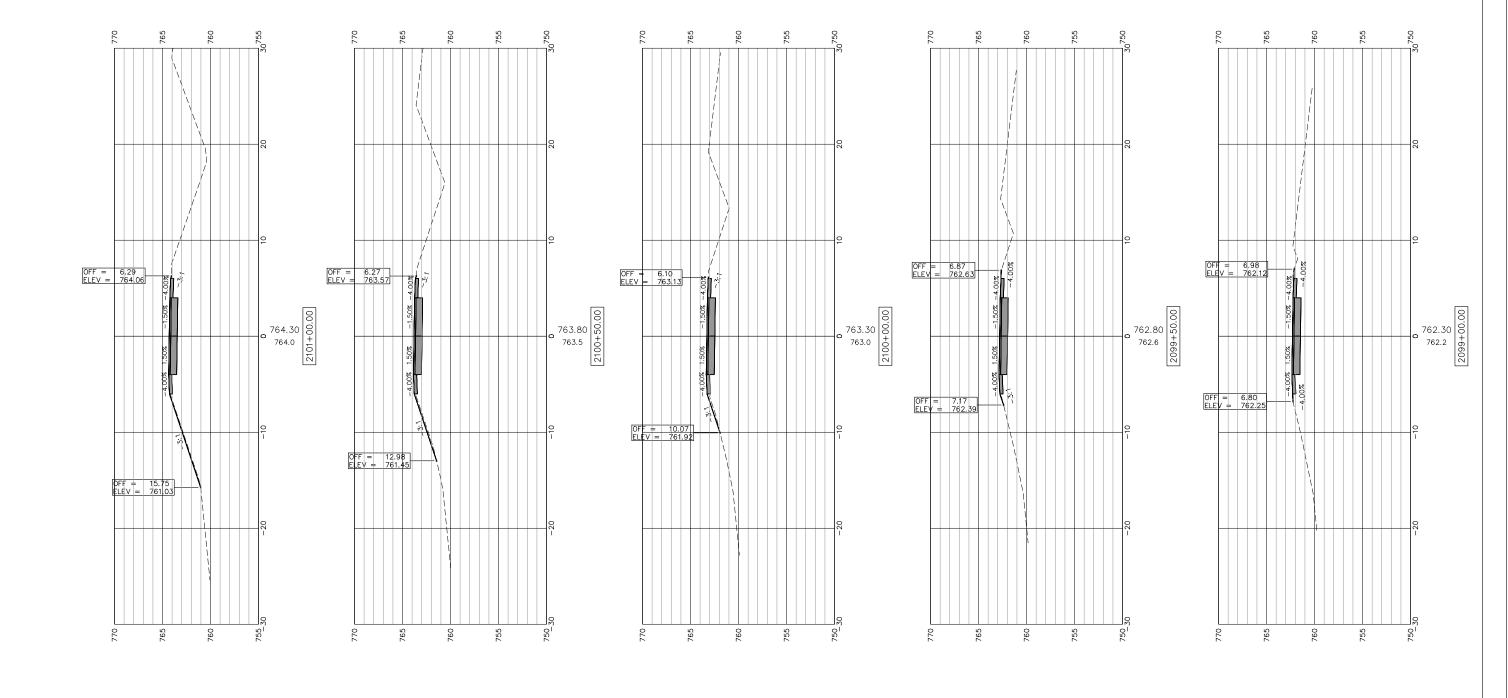


	ÆG
120 S 1ST STREET	PH: 815.956.6400
ROCKFORD, IL 61350	www.imegcorp.com
FOR	MERLY
Mannen inc	McClure

USER NAME:	DESIGNED:	REVISED:
	CHECKED:	REVISED:
PLOT SCALE:	DRAWN: ATH	REVISED:
PLOT DATE: 3/27/2019	CHECKED: WLK	REVISED:

STATE	0F	ILLINOIS
CITY 0	F FI	REEPORT


CROSS SECTIONS 2099+00-2101+00		SECTION	COUNTY	TOTAL SHEETS	SHEET NO.
FREEPORT PEC PATH	N.A.	15-00163-00-BT	STEPHENSON	92	77
THELFORT TECTATII		FREEPORT	CONTRACT N	0. 8567	74
SHEET NO. 35 OF 45 SHEETS		ILLINOIS FED. A	ID PROJECT -		

TILE NAME AND PATH: \\AD.KJWW.COM\KJWW\KJWW\OFFICES\MCCLURE\ROCKFORD\PROJECTS\H-DRIVE TRANS\14-054-PECPATH-FREEPORT\DESIGN\DRAWINGS\IMEG FILE STRUCTURE\18000408.00\CAD-BIM FOLDERS\CIVIJD\DWG\PLOT\18000408-X-SECTIONS.DWG

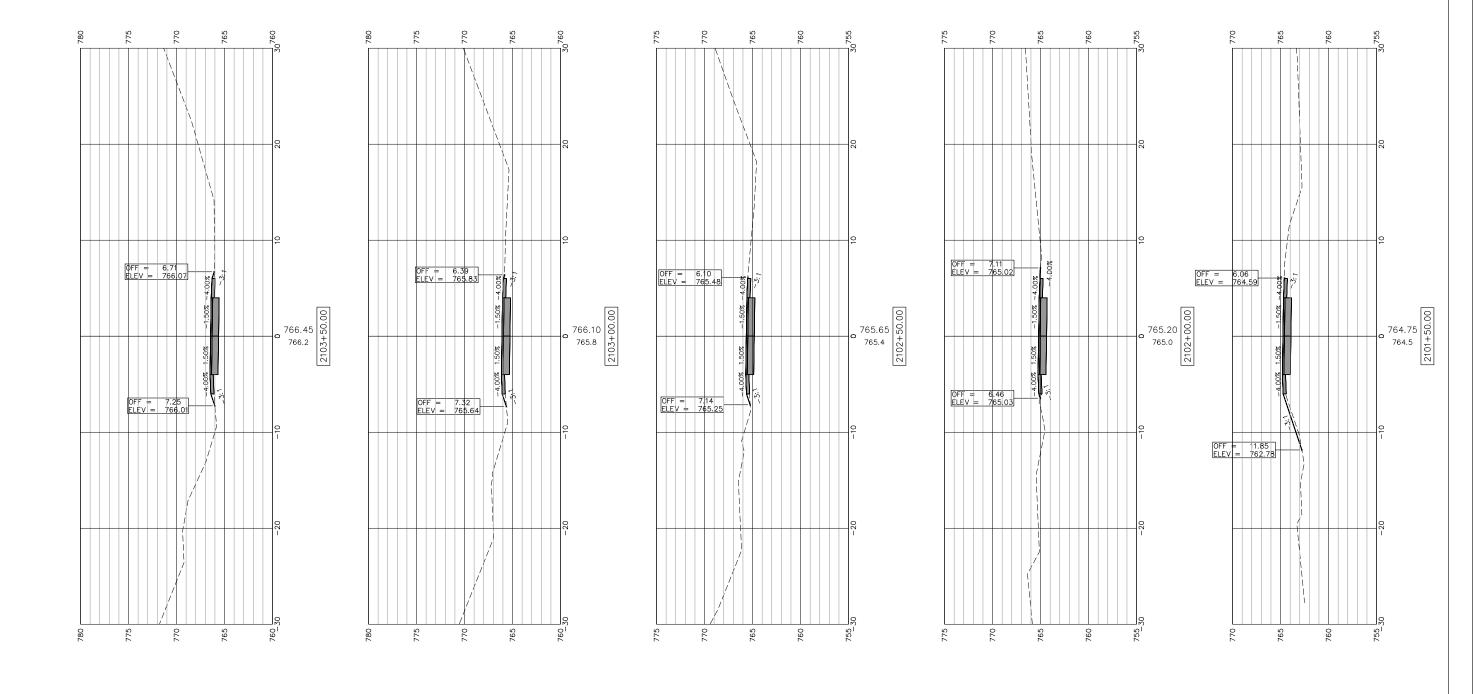


	ÆG
120 S 1ST STREET	PH: 815.956.6400
ROCKFORD, IL 61350	www.imegcorp.com
FOR	MERLY
C Thomas and and	McClure

	USER NAME:	DESIGNED:	REVISED:		CROSS SECTIONS 2101+50-2103+50	-	SECTION	COUNTY	TOTAL SHEET
0		CHECKED:	REVISED:	STATE OF ILLINOIS		N.A.	15-00163-00-BT	STEPHENSO	N 92 78
m	PLOT SCALE:	DRAWN: ATH	REVISED:	CITY OF FREEPORT	FREEPORT PEC PATH	CITY OF	FREEPORT	CONTRACT	NO. 85674
lu.	PLOT DATE: 3/27/2019	CHECKED: WLK	REVISED:		SHEET NO. 36 OF 45 SHEETS		ILLINOIS FE	D. AID PROJECT -	

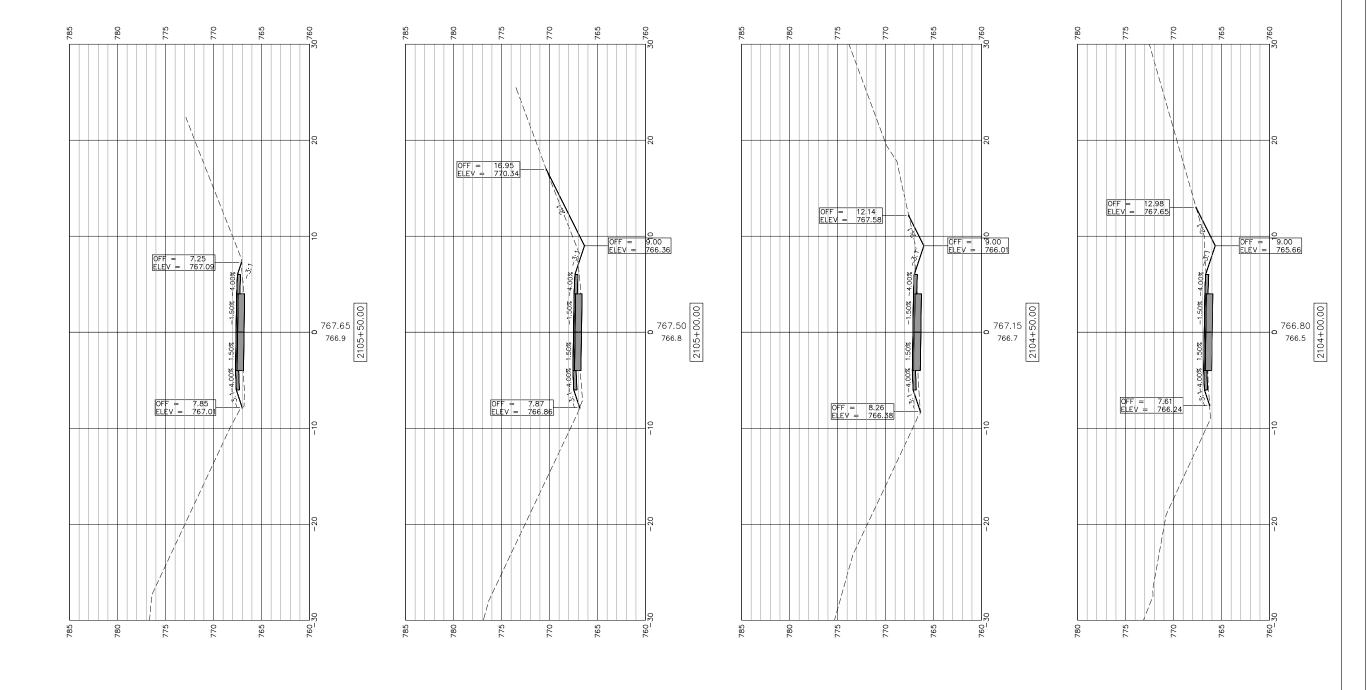

♦IM	EG
120 S 1ST STREET	PH: 815.956.6400
ROCKFORD, IL 61350	www.imegcorp.com
FORM	MERLY
C Thomas and	McClure


USER NAME:	DESIGNED:	REVISED:		CROSS SECTIONS 2104+00-2105+50	-	SECTION	COUNTY	TOTAL S SHEETS	SHEET NO.
	CHECKED:	REVISED:	STATE OF ILLINOIS	FREEPORT PEC PATH	N.A.	15-00163-00-BT	STEPHENSON	92	79
PLOT SCALE:	DRAWN: ATH	REVISED:	CITY OF FREEPORT	FREEFURI FEG FAIR	CITY OF F	FREEPORT	CONTRACT I	VO. 85674	4
PLOT DATE: 3/27/2019	CHECKED: WLK	REVISED:		SHEET NO. 37 OF 45 SHEETS		ILLINOIS FED. A	AID PROJECT -	-	

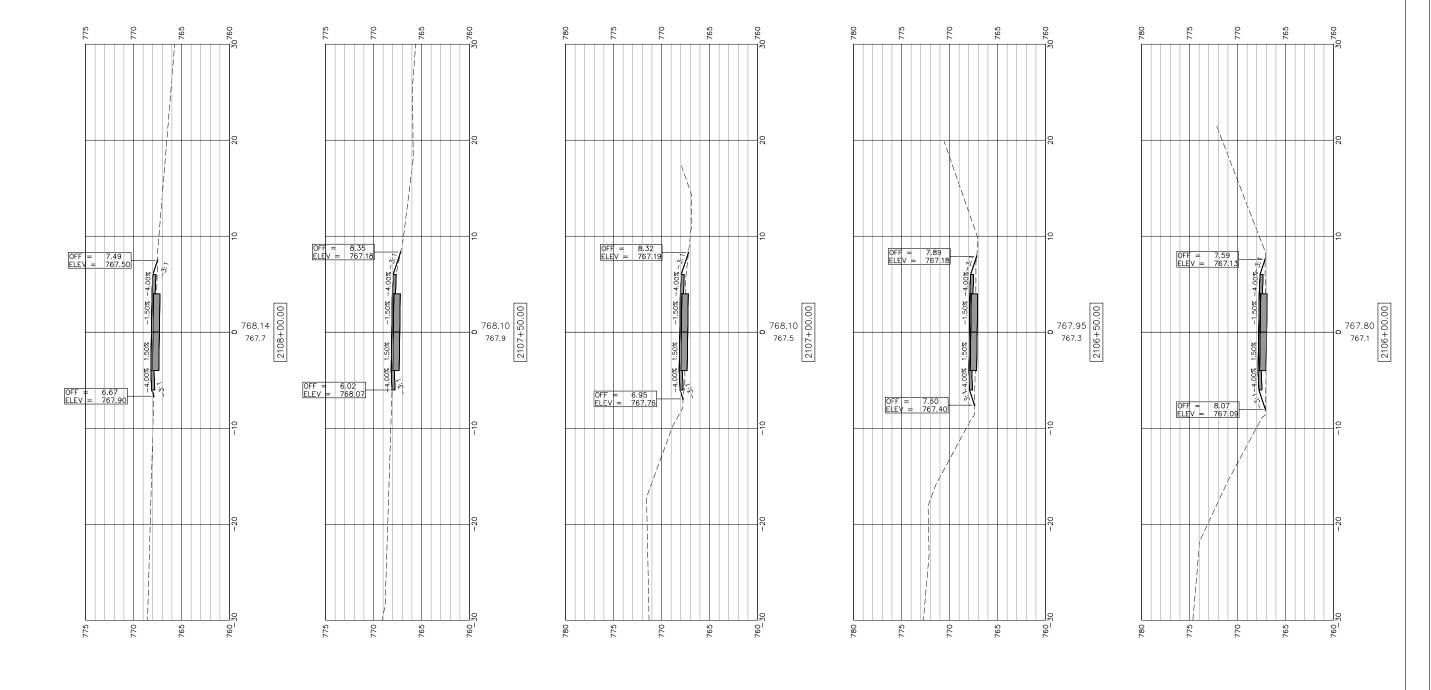



USER NAME:	DESIGNED:	REVISED:		CROSS SECTIONS 2106+00-2108+00	- SECT	ION	COUNTY TOTAL SHEET
	CHECKED:	REVISED:	STATE OF ILLINOIS	FREEPORT PEC PATH	N.A. 15-00163	-00-BT	STEPHENSON 92 80
PLOT SCALE:	DRAWN: ATH	REVISED:	CITY OF FREEPORT	FREEPURI PEU PAIR	CITY OF FREEPORT		CONTRACT NO. 85674
PLOT DATE: 3/27/2019	CHECKED: WLK	REVISED:		SHEET NO. 38 OF 45 SHEETS	IL	LINOIS FED. A	AID PROJECT -

(TYP) SEE "PATH TRANSITION AROUND POLE DETAIL FOR ADDITIONAL INFORMATION

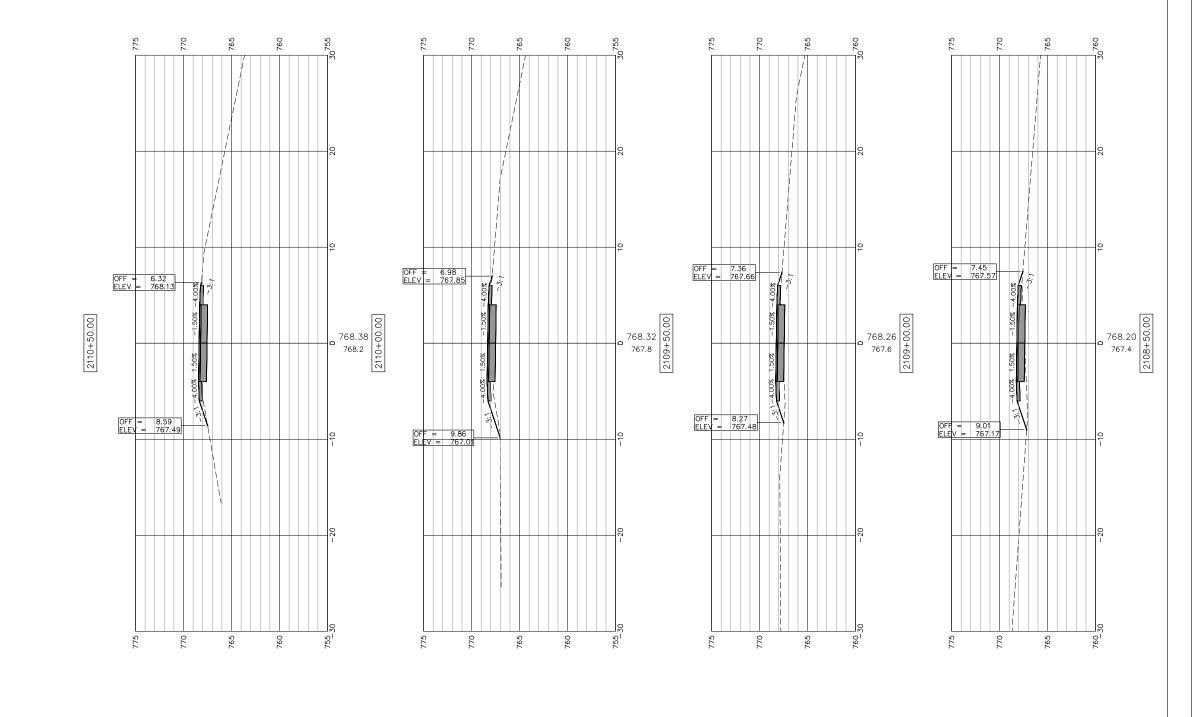

	ÆG
120 S 1ST STREET	PH: 815.956.6400
ROCKFORD, IL 61350	www.imegcorp.com
FORI	MERLY
	McClure


♦IMEG	USER NAME:	DESIGNED:	REVISED:		CROSS SECTIONS 2108+50-2110+50	_	SECTION	COUNTY TOTAL SHEET SHEETS NO.	
120 S 1ST STREET PH: 815.956.6400 ROCKFORD, IL 61350 www.imencom.com		CHECKED:	REVISED:	STATE OF ILLINOIS	FREEPORT PEC PATH	N.A.	15-00163-00-BT	STEPHENSON 92 81	
ROCKFORD, IL 61350 www.imegcorp.com FORMERLY	PLOT SCALE:	DRAWN: ATH	REVISED:	CITY OF FREEPORT	CITY OF FREEPORT	CITY OF	FREEPORT	CONTRACT NO. 85674	
McClure Spinning anniata, Inc.	PLOT DATE: 3/27/2019	CHECKED: WLK	REVISED:		SHEET NO. 39 OF 45 SHEETS	ILLINOIS FED.		AID PROJECT -	
FILE NAME AND PATH: \\AD.KJWW.COM\KJWW\K	FILE NAME AND PATH: \\AD.KJWW.COM\KJWW\KJWW\OFFICES\MCCLURE\ROCKFORD\PROJECTS\H-DRIVE TRANS\14-054-PECPATH-FREEPORT\DESIGN\DRAWINGS\IMEG FILE STRUCTURE\18000408.00\CAD-BIM FOLDERS\CIVILIZD\DWG\PLOT\18000408-X-SECTIONS.DWG								

2111+00.00

SCALES:

1" = 5' HORIZONTAL


1" = 5' VERTICAL

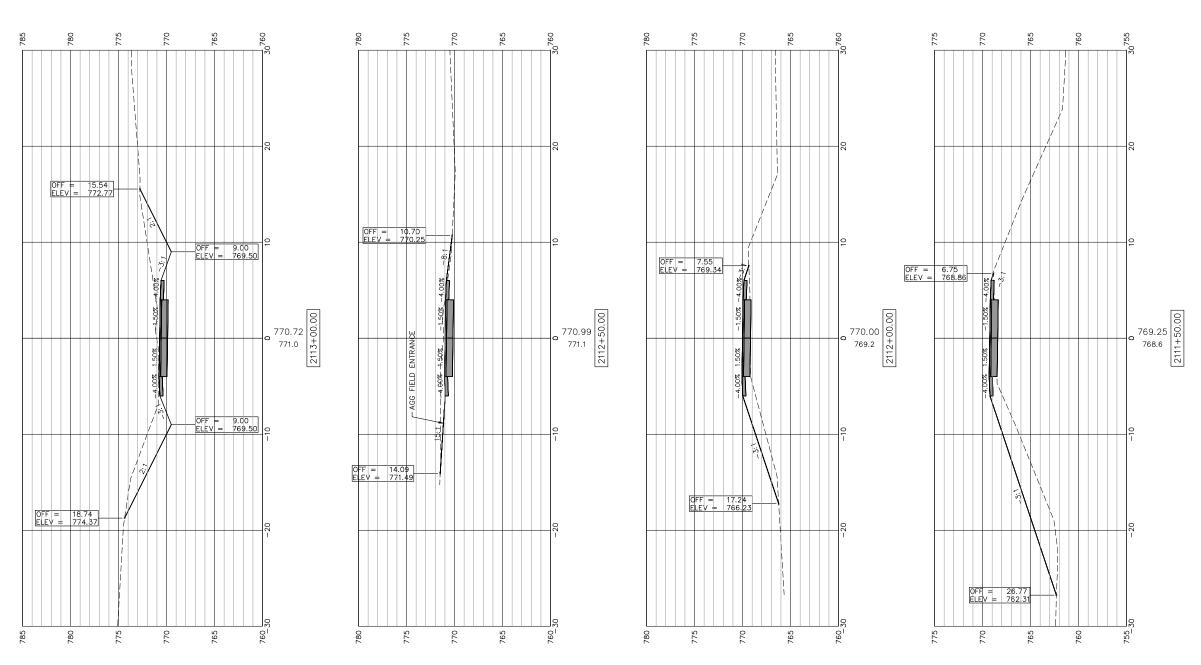

SEE "PATH TRANSITION AROUND POLE DETAIL FOR ADDITIONAL INFORMATION

	ÆG
120 S 1ST STREET	PH: 815.956.6400
ROCKFORD, IL 61350	www.imegcorp.com
FORI	MERLY
Chamberly Inc.	McClure

USER NAME:	DESIGNED:	REVISED:		CROSS SECTIONS 2111+00-2113+00	_	SECTION	COUNTY TOTAL SHEET
	CHECKED:	REVISED:	STATE OF ILLINOIS		N.A.	15-00163-00-BT	STEPHENSON 92 82
PLOT SCALE:	DRAWN: ATH	REVISED:	CITY OF FREEPORT	FREEPORT PEC PATH	CITY OF	FREEPORT	CONTRACT NO. 85674
PLOT DATE: 3/27/2019	CHECKED: WLK	REVISED:		SHEET NO. 40 OF 45 SHEETS		ILLINOIS FED. A	AID PROJECT -

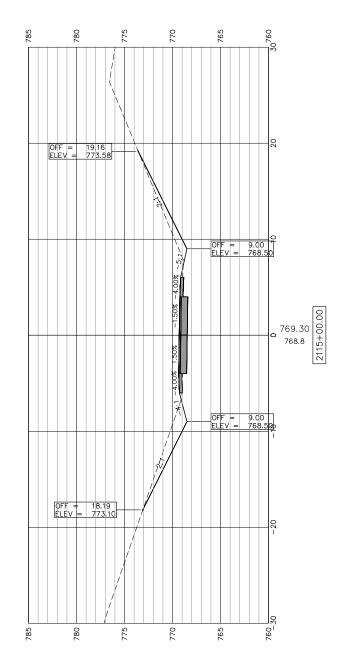


SEE "PATH TRANSITION AROUND POLE (TYP) DETAIL FOR ADDITIONAL INFORMATION

2114+50.00

AROUND POLE INFORMATION TRANSITION ADDITIONAL "PATH AIL FOR SEE "P DETAIL

2114+00.00

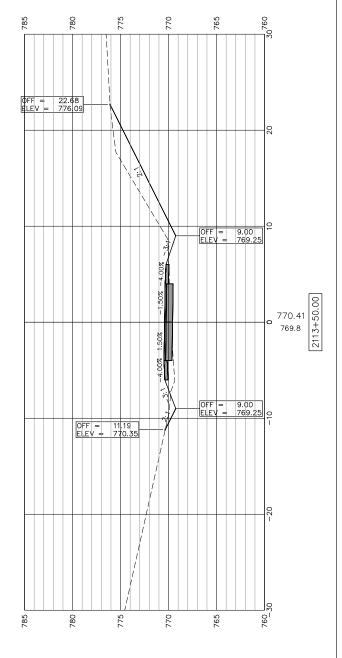




USER NAME:	DESIGNED:	REVISED:		CROSS SECTIONS 2113+50-2115+00	_	SECTION	COUNTY TOTAL SHEET SHEFTS NO.
	CHECKED:	REVISED:	STATE OF ILLINOIS		N.A.	15-00163-00-BT	STEPHENSON 92 83
PLOT SCALE:	DRAWN: ATH	REVISED:	CITY OF FREEPORT	FREEPORT PEC PATH	CITY OF	FREEPORT	CONTRACT NO. 85674
PLOT DATE: 3/27/2019	CHECKED: WLK	REVISED:		SHEET NO. 41 OF 45 SHEETS		ILLINOIS FED. A	AID PROJECT -

(TYP) SEE "PATH TRANSITION AROUND POLE DETAIL FOR ADDITIONAL INFORMATION


(TYP)" SEE "PATH TRANSITION AROUND POLE DETAIL FOR ADDITIONAL INFORMATION



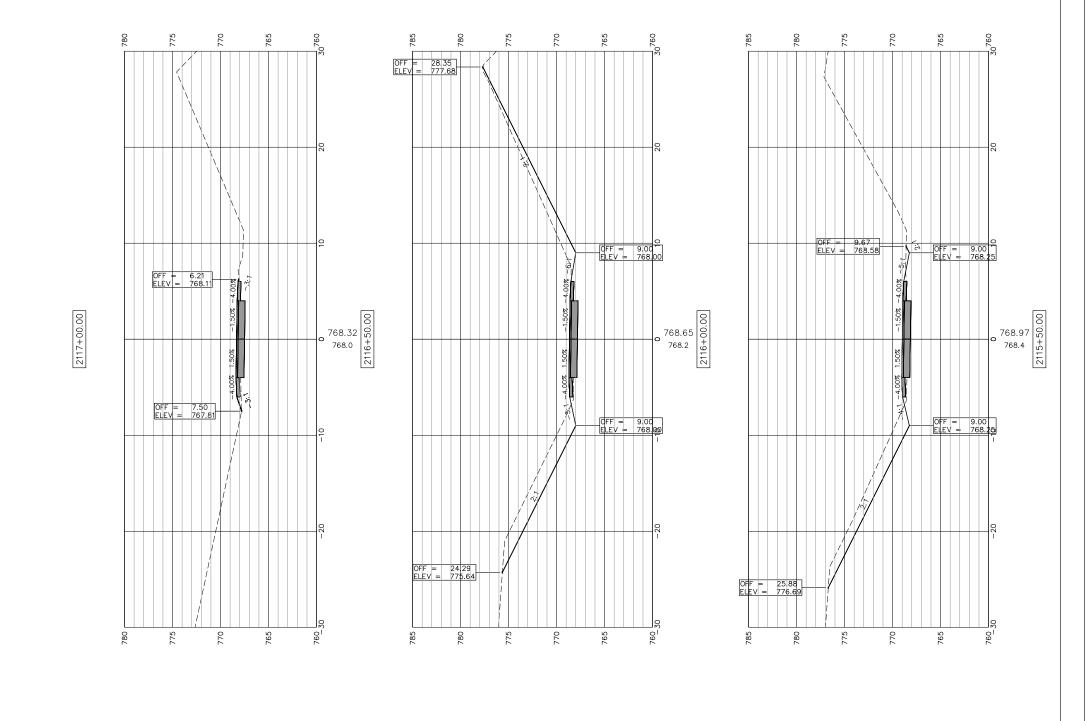



CHECKED: REVISED: STATE OF ILLINOIS	S SECTIONS 2115+50-2117+50		
	FREEPORT PEC PATH	N.A. 15-00163-00-BT	STEPHENSON 92 84
PLOT SCALE: DRAWN: ATH REVISED: CITY OF FREEPORT	C	CITY OF FREEPORT	CONTRACT NO. 85674
PLOT DATE: 3/27/2019 CHECKED: WLK REVISED:	SHEET NO. 42 OF 45 SHEETS	ILLINOIS FED.	AID PROJECT -

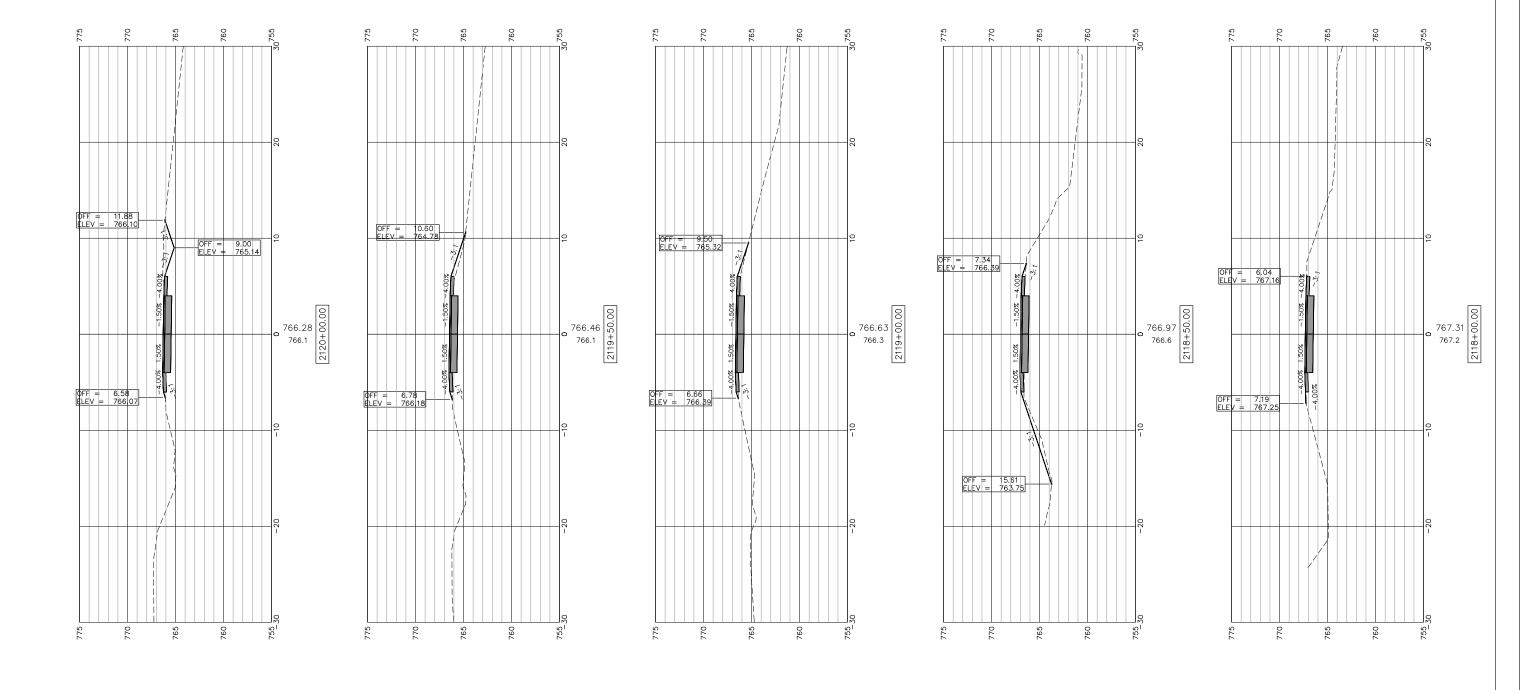


	ÆG
120 S 1ST STREET	PH: 815.956.6400
ROCKFORD, IL 61350	www.imegcorp.com
FOR	MERLY
C Manuson, Inc.	McClure


USER NAME:	DESIGNED:	REVISED:	_
	CHECKED:	REVISED:	
PLOT SCALE:	DRAWN: ATH	REVISED:	
PLOT DATE: 3/27/2019	CHECKED: WLK	REVISED:	

STATE OF	ILLINOIS
CITY OF FI	REEPORT

CROSS SECTIONS 2118+00-2120+00		SECTION	COUNTY	TOTAL SHEETS	SHEET NO.
FREEPORT PEC PATH	N.A.	15-00163-00-BT	STEPHENSON	92	85
THELI OILI TEOTATII	CITY OF	FREEPORT	CONTRACT NO. 85674		
SHEET NO. 43 OF 45 SHEETS		ILLINOIS FED. A	ID PROJECT -		

FILE NAME AND PATH: \\AD.K.IWW.COM\KJWW\KJWW\OFFICES\MCCLURE\ROCKFORD\PROJECTS\H-DRIVE TRANS\14-054-PECPATH-FREEPORT\DESIGN\DRAWINGS\MEG FILE STRUCTURE\18000408.00\CAD-BIM FOLDERS\CIVIL3D\DWG\PLOT\18000408-X-SECTIONS.DWG

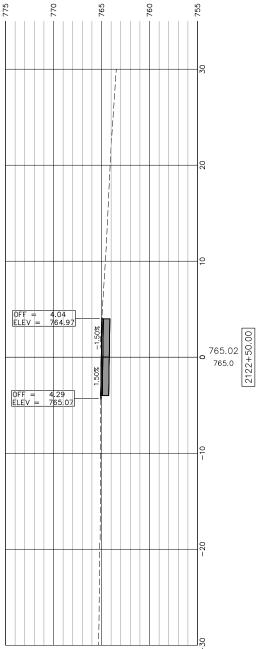


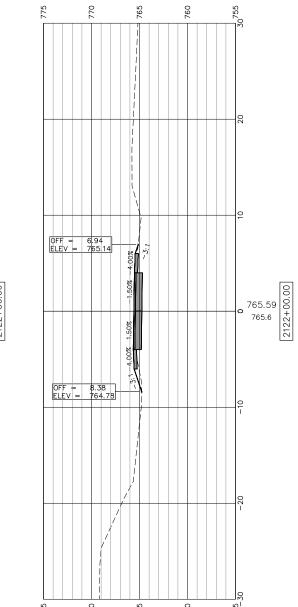

(TYP) TRANSITION AROUND POLE ADDITIONAL INFORMATION SEE "PATH T DETAIL FOR A


2121+50.00

(TYP) SEE "PATH TRANSITION AROUND POLE DETAIL FOR ADDITIONAL INFORMATION

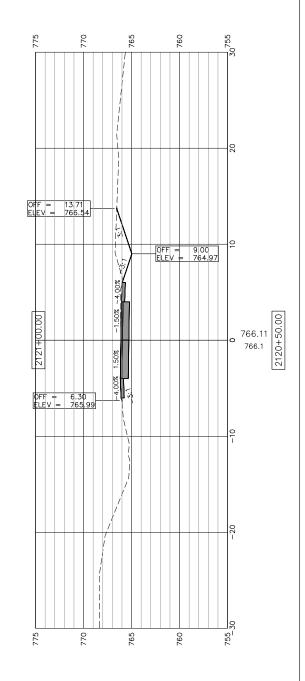

	EG
120 S 1ST STREET	PH: 815.956.6400
ROCKFORD, IL 61350	www.imegcorp.com
FORM	IERLY
Charge and the	McClure

AIMEG	USER NAME:	DESIGNED:	REVISED:		CROSS SECTIONS 2120+50-2122+50	_	SECTION	COUNTY	SHEETS NO
S 1ST STREET PH: 815.956.6400		CHECKED:	REVISED:	STATE OF ILLINOIS		N.A.	15-00163-00-BT	STEPHENSON	1 92 86
KFORD, IL 61350 www.imegcorp.com	PLOT SCALE:	DRAWN: ATH	REVISED:	CITY OF FREEPORT	CITY OF FREEPORT FREEPORT PEC PATH	CITY OF	FREEPORT	CONTRACT	NO. 85674
McClure Injuries Inc.	PLOT DATE: 3/27/2019	CHECKED: WLK	REVISED:		SHEET NO. 44 OF 45 SHEETS	ILLINOIS FEE		FED. AID PROJECT -	

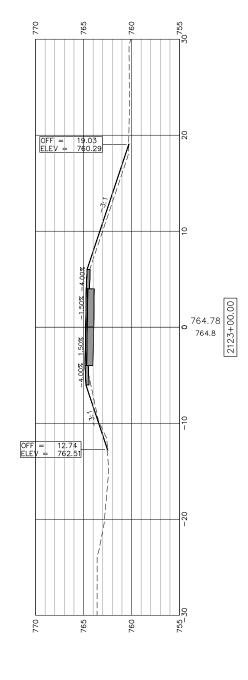


◆I M	EG
120 S 1ST STREET ROCKFORD, IL 61350	PH: 815.956.6400 www.imegcorp.com
FORM	MERLY
Charles 15	McClure September January

USER NAME:	DESIGNED:	REVISED:	
	CHECKED:	REVISED:	
PLOT SCALE:	DRAWN: ATH	REVISED:	
PLOT DATE: 3/27/2019	CHECKED: WLK	REVISED:	

STATE OF ILLINOIS	CROSS SECTIONS 2123+00-2125+00
CITY OF FREEPORT	FREEPORT PEC PATH
	SHEET NO. 45 OF 45 SHEETS

_	SE	CTION		COUNTY	TOTAL SHEETS	SHEE 1 NO.	
N.A.	15-0016	53-00-i	BT	STEPHENSON	92	87	
CITY OF	FREEPORT			CONTRACT NO. 85674			
		ILLINOIS	FED. A	ID PROJECT -			

FILE NAME AND PATH: \\ADK.WWW.OM\KJWW\\AJWW\\OFFICES\MCCLURE\ROCKFORD\PROJECTS\H-DRIVE TRANS\14-054-PECPATH-FREEPORT\DESIGN\DRAWINGS\IMEG FILE STRUCTURE\18000408.00\CAD-BIM FOLDERS\CIVIL3D\DWG\PLOT\18000408-X-SECTIONS.DWG

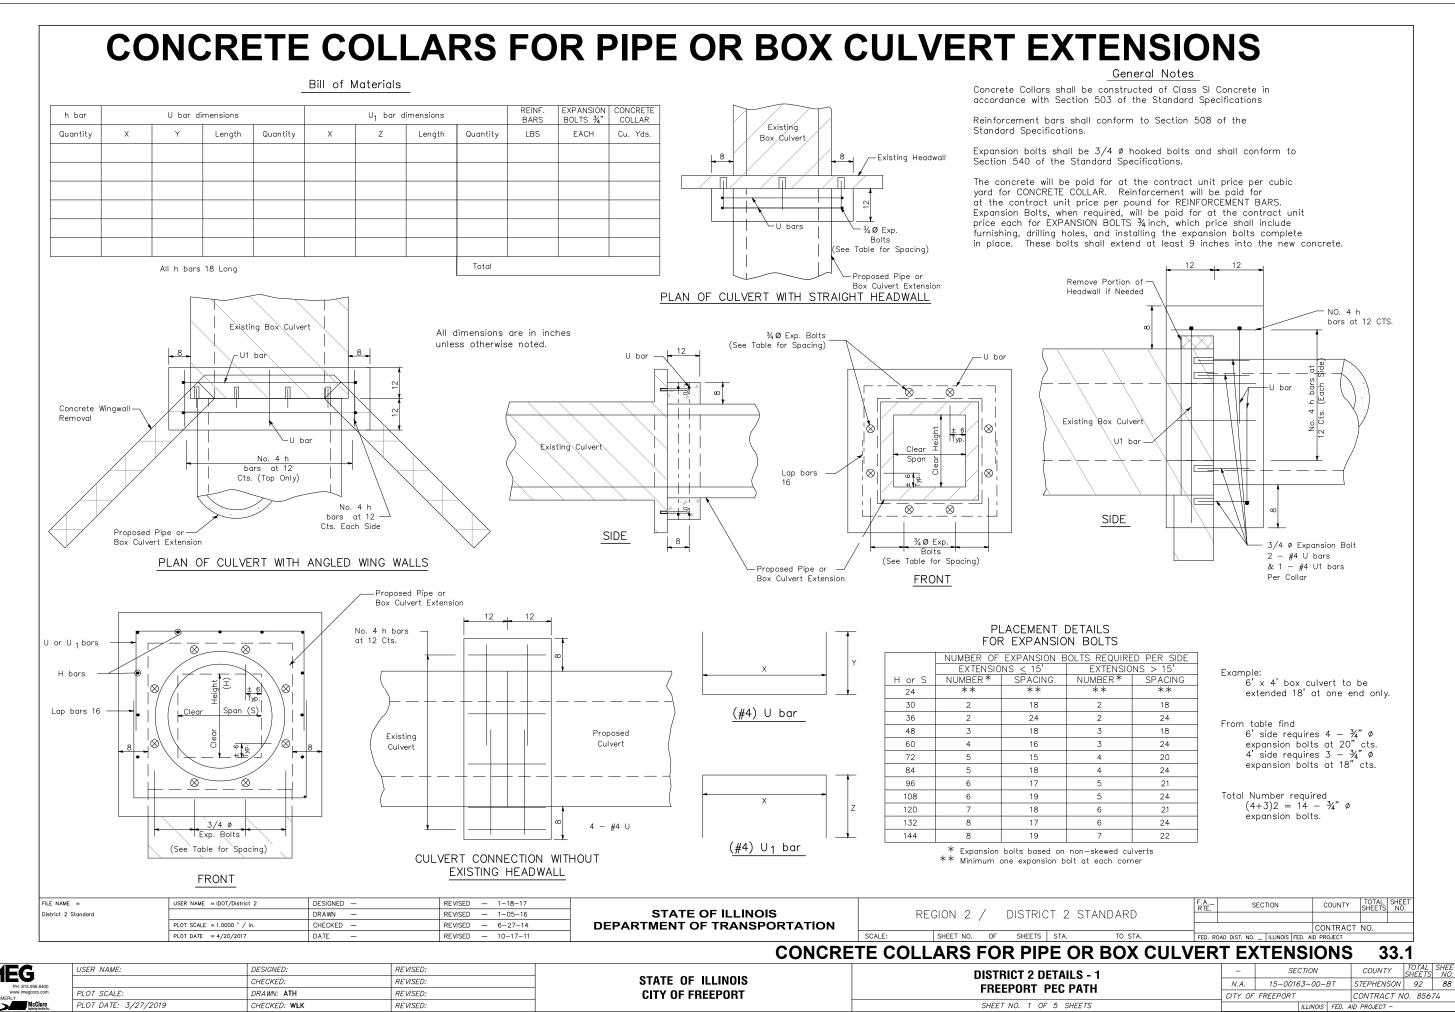



TYPICAL PAVEMENT MARKINGS

MEDIAN PAVEMENT MARKING

TYPICAL PAVEMENT MARKING FOR FLUSH MEDIAN

AT LEFT TURN LANE

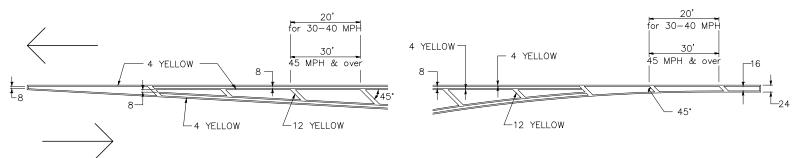

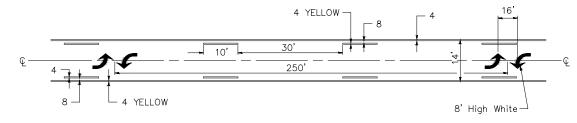


TYPICAL ISLAND OFFSET SHOULDER WIDTH


TYPICAL MARKING FOR PAINTED ISLANDS


STANDARD CROSSWALK MARKING

** ALL DIMENSIONS ARE IN INCHES UNLESS OTHERWISE NOTED.

See Schedules for Locations

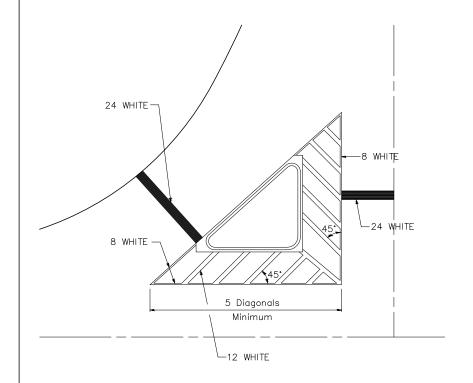

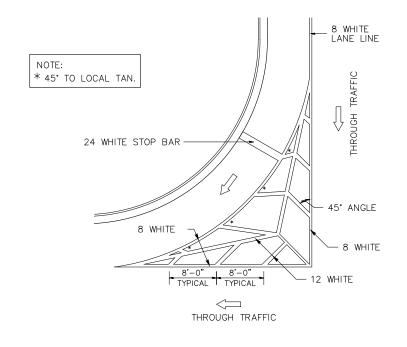

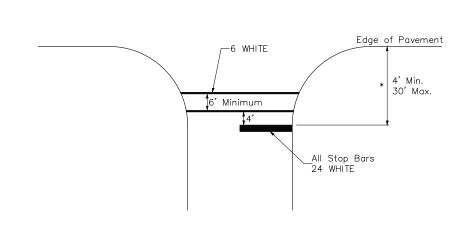

* Distance to the nearest edge of the intersecting roadway in the absence of a marked crosswalk.

FILE NAME =	USER NAME = IDOT/District 2	DESIGNED -	REVISED — 6-27-14
District 2 Standard		DRAWN —	REVISED — 3-05-12
	PLOT SCALE = 1.0000 ' / in.	CHECKED —	REVISED —
	PLOT DATE = 4/20/2017	DATE —	REVISED —

STATE OF ILLINOIS **DEPARTMENT OF TRANSPORTATION**


RE	GION	2 ,	/	DISTRIC	T 2	STANDARD
ALE:	SHEET	NO.	OF	SHEETS	STA.	TO STA.

FGION 2 / DISTRICT 2 STANDARD	F.A. SECTION COUNTY TOTAL SHEETS NO.							
REGION 2 / DISTRICT 2 STANDARD	CONTRACT NO.							
SHEET NO. OF SHEETS STA. TO STA.	FED. ROAD DIST. NO ILLINOIS FED. AID PROJECT							
TYPICAL PAVEMENT MARKINGS SHEET 1 OF 3 41.1								

USER NAME:	DESIGNED:	REVISED:
	CHECKED:	REVISED:
PLOT SCALE:	DRAWN: ATH	REVISED:
PLOT DATE: 3/27/2019	CHECKED: WLK	REVISED:

STATE	0F	ILLINOIS
CITY O	F FF	REEPORT

DISTRICT 2 DETAILS - 2	_	S
FREEPORT PEC PATH	N.A.	15-00
THEEL OHT TECTAIN	CITY OF	FREEPOR
SHEET NO. 2 OF 5 SHEETS		

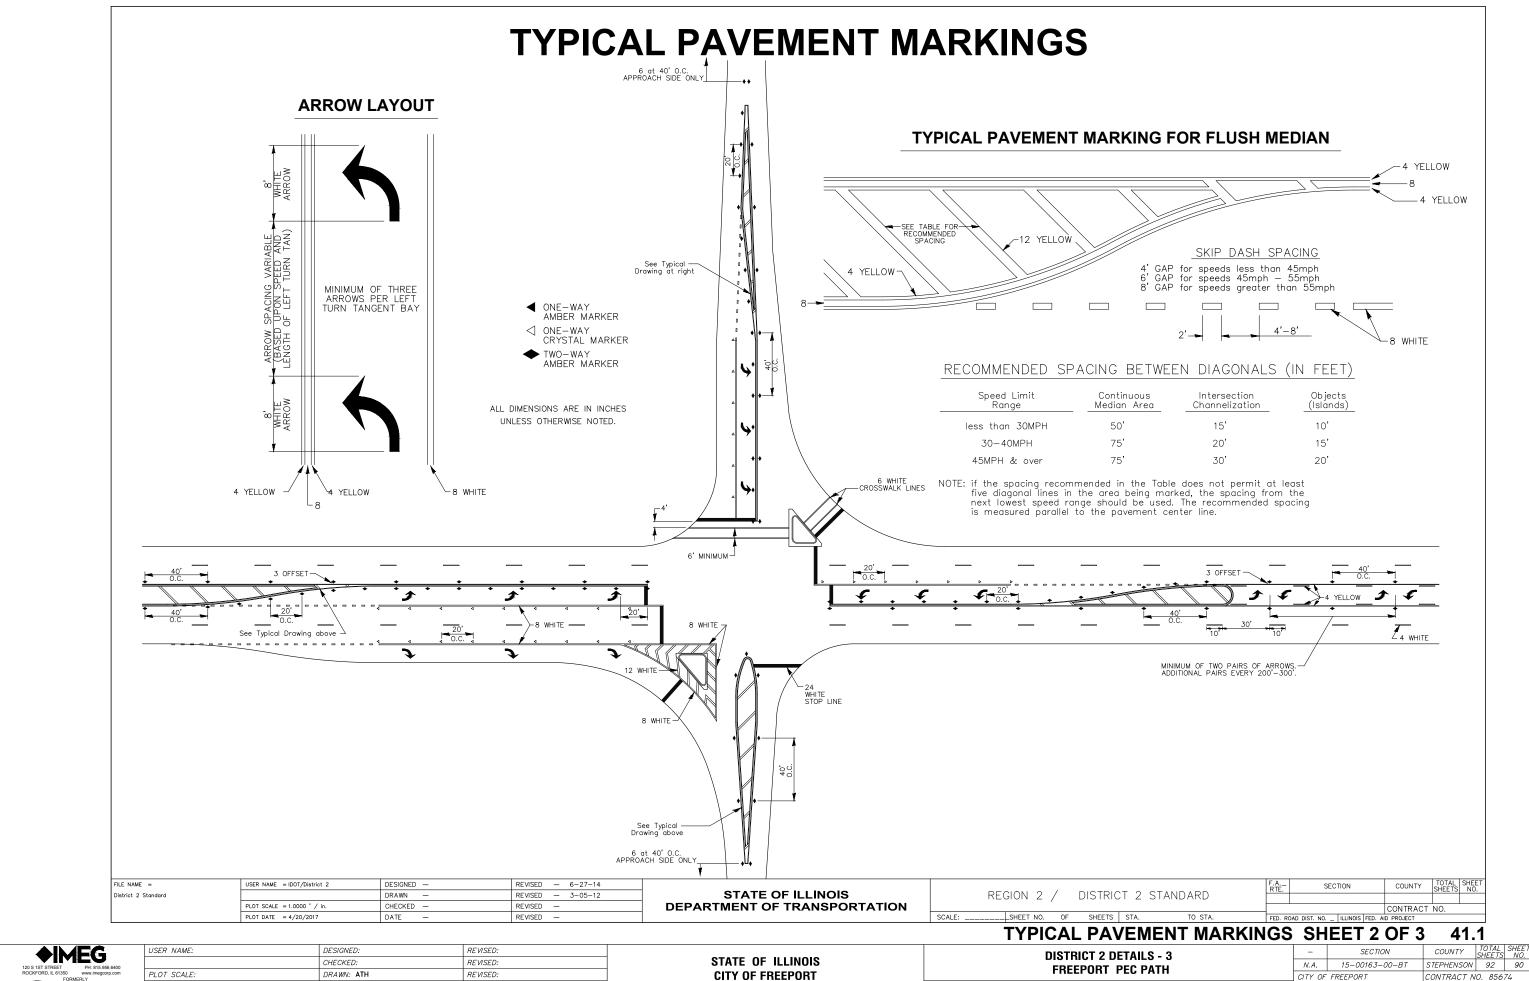

CHECKED: WLK \\AD.KJWW.COM\KJWW\KJWW\OFFICES\MCCLURE\ROCKFORD\PROJECTS\H-DRIVE TRANS\14-054-PECPATH-FREEPORT\DESIGN\DRAWNIOS\IMEG FILE STRUCTURE\18000408.00\CAD-BIM FOLDERS\CIVIL3D\DWG\PLOT\18000408-DETAILS.DWG

REVISED:

PLOT DATE: 3/27/2019

FREEPORT PEC PATH SHEET NO. 3 OF 5 SHEETS

15-00163-00-BT CITY OF FREEPORT CONTRACT NO. 85674

TYPICAL PAVEMENT MARKINGS

TYPICAL PARKING SPACING

Face of Curb

-EDGE OF PAVEMENT

WHITE

WHITE

No Parking Zone

No Parking Zone

No Parking Zone

TYPICAL PAVEMENT MARKING FOR TWO LANE SECTION - NO PASSING ZONES

22'-25'


22'-25'

20' Min. -

30' Min. —


20' Min. —

Approach to Signal

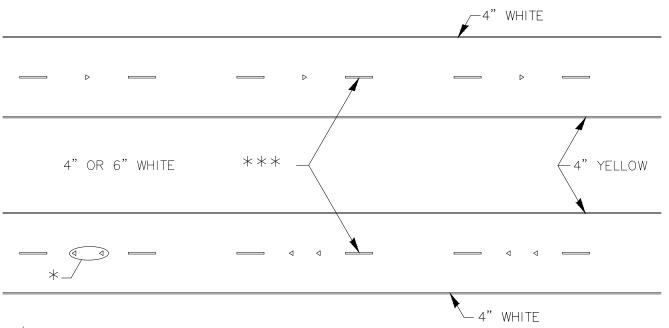

* SEE HIGHWAY STANDARD 781001 FOR SPACING DETAILS. USE DOUBLE MARKERS_WHEN ADT > 20,000.

MULTI-LANE / DIVIDED

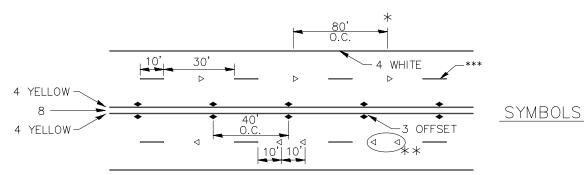

- * REDUCE TO 40' O.C. ON CURVES WHERE ADVISORY SPEEDS ARE 10 MPH LOWER THAN POSTED SPEEDS.
- ** USE DOUBLE MARKERS WHEN ADT > 20,000

*** CENTERLINE SKIP DASH PAVEMENT MARKING SPEED LIMIT LESS THAN 40 MPH USE 4" LINE. SPEED LIMIT 40 MPH AND OVER USE 6" LINE.

MULTI-LANE / UNDIVIDED & ONE WAY

(FOR MULTI-LANE UNDIVIDED HIGHWAYS USE THIS DETAIL NOT HIGHWAY STANDARD 781001)

FILE NAME =	USER NAME = IDOT/District 2	DESIGNED -	REVISED — 6-27-14
District 2 Standard		DRAWN —	REVISED — 8-27-13
	PLOT SCALE = 1.0000 ' / in.	CHECKED —	REVISED — 11-28-12
	PLOT DATE = 4/20/2017	DATE —	REVISED —

STATE OF ILLINOIS **DEPARTMENT OF TRANSPORTATION**

STATE OF ILLINOIS

CITY OF FREEPORT

		TYF	PIC:	ΔΙ	ΡΔ\	/FN	IFNT MARKIN	C
LE:		SHEET	NO.	OF	SHEETS	STA.	TO STA.	FE
	KF(GION	2 /		DISTRIC	1 2	STANDARD	
		0.01	_ /		DIOTOLO	·	OTANIBA DD	R

ı	G	2	S	Н	F	FT	. J		OF 3		4	1	1
	FED.	ROAD	DIST.	NO.	-	ILLINOIS	FED.	Αl	D PROJECT				
									CONTRACT	NO.			

SECTION

30'

YELLOW

DISTRICT 2 DETAILS - 4	
DISTRICT Z DETAILS - 4	
EDEEDODE DEC DATE	
FREEPORT PEC PATH	

SHEET NO. 4 OF 5 SHEETS


			-	1		
_	SECTION			COUNTY	TOTAL SHEETS	SH.
N.A.	15-00163-00-BT			STEPHENSON	92	- 9
CITY OF FREEPORT			CONTRACT N	0. 856	74	
		ILLINOIS	FED. A	ID PROJECT -		

COUNTY TOTAL SHEET NO.

PLOT DATE: 3/27/2019 CHECKED: WLK REVISED:


REVISED: USER NAME: DESIGNED: CHECKED: REVISED: PLOT SCALE: DRAWN: ATH REVISED:



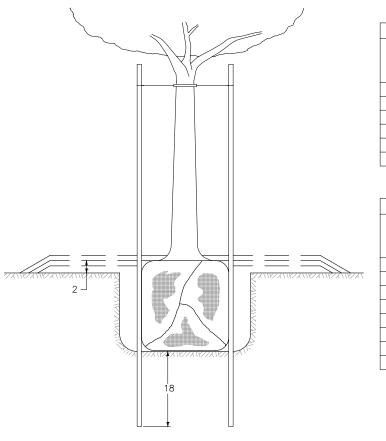



SMALL	Α	В	С	D	E	F
TREE SIZE	DIAMETER OF BALL OR ROOT SYS.	DEPTH OF HOLE EXCAVATION	WIDTH OF HOLE EXCAVATION	THICKNESS OF MULCH COVER	DEPTH OF BALL OR ROOT SYS.	VOLUME OF MULCH COVER CU. YDS.
5'-6'	16	10	30	4	12 C	.54
5'-6' BB	16	10	30	4	12	0.54
6'-7' BB	18	12	30	4	14	0.54
7'-8' BB	20	11	30	4	13	0.54
8'-10' BB	24	14	36	4	16	0.61
10'-12' BB	26	15	36	4	17	0.61


LARGE	А	В	С	D	E	F
TREE SIZE	DIAMETER OF BALL OR ROOT SYS.	DEPTH OF HOLE EXCAVATION	WIDTH OF HOLE EXCAVATION	THICKNESS OF MULCH COVER	DEPTH OF BALL OR ROOT SYS.	VOLUME OF MULCH COVER CU. YDS.
0-2	20	11	36	4	13	0.61
2-2½ BB	24	14	48	4	16	0.78
2½−3 BB	28	17	48	4	19	0.78
3-3½ BB	32	17	60	4	19	0.96
3½−4 BB	36	20	60	4	22	0.96
4-4½ BB	40	22	72	4	24	1.16
4½−5 BB	44	24	72	4	26	1.16
5-5% BB	48	27	84	4	29	1.38

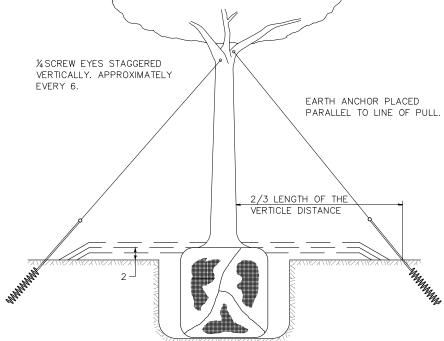

TREES OVER 4½IN DIAMETER

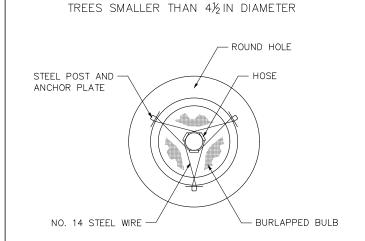

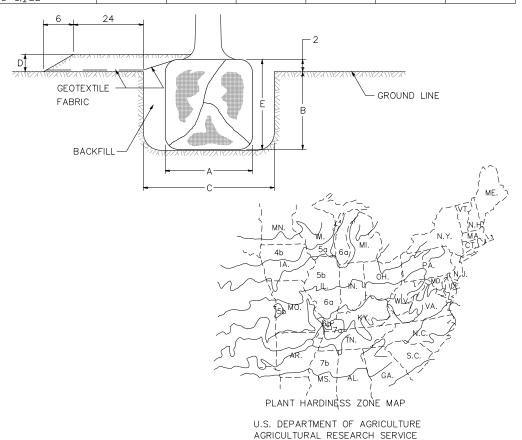

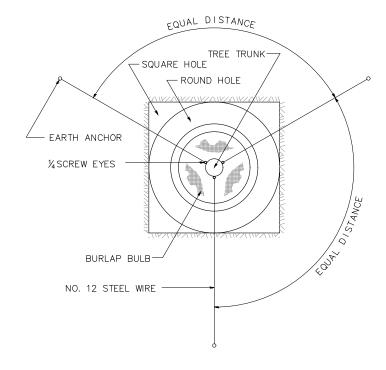

ALL DIMENSIONS ARE IN INCHES UNLESS OTHERWISE NOTED.

FILE NAME =	USER NAME = IDOT/District 2	DESIGNED -	REVISED — 10-18-11
District 2 Standard		DRAWN —	REVISED —
	PLOT SCALE = 1.0000 ' / in.	CHECKED —	REVISED —
	PLOT DATE = 4/20/2017	DATE —	REVISED —

STATE OF ILLINOIS DEPARTMENT OF TRANSPORTATION

PUBLICATION NO. 814

DECION O / DICTRIOT O CTANDARD				F.A RTE.	SECTION	COUNTY	TOTAL SHEETS	SHEET NO.		
		REGION 2 / DISTRICT 2 STANDARD								
						CONTRACT	NO.			
	SCALE:	SHEET NO. O	SHEETS	STA.	TO STA.	FED. RO	DAD DIST. NO ILLINOIS FED. A	ID PROJECT		

120 S 1ST STREET PH: 815.956.6400 ROCKFORD, IL 61550 ROMERLY

USER NAME:	DESIGNED:	REVISED:	
	CHECKED:	REVISED:	
PLOT SCALE:	DRAWN: ATH	REVISED:	
PLOT DATE: 3/27/2019	CHECKED: WLK	REVISED:	

STATE OF ILLINOIS CITY OF FREEPORT