


F.A.U. RTE.	SECTION	COUNTY	TOTAL SHEETS	SHEET NO.
3578	1327B	COOK	108	26
STA. 1503+19.73 TO STA. 1528+17.76				
FED. ROAD DIST. NO. 1 ILLINOIS FED. AID PROJECT				

STA. 1503+19.73 TO STA. 1515+00.00		
ITEM	UNIT	QUANTITY
SEEDING, CLASS 2A	ACRE	1.0
TOPSOIL FURNISH AND PLACE, 4"	SQ YD	5310
EROSION CONTROL BLANKET	SQ YD	9570
SODDING, SALT TOLERANT	SQ YD	495
SUPPLEMENTAL WATERING	UNIT	12

PROJECT BEGINS
IL ROUTE 7
STA. 1503+19.73

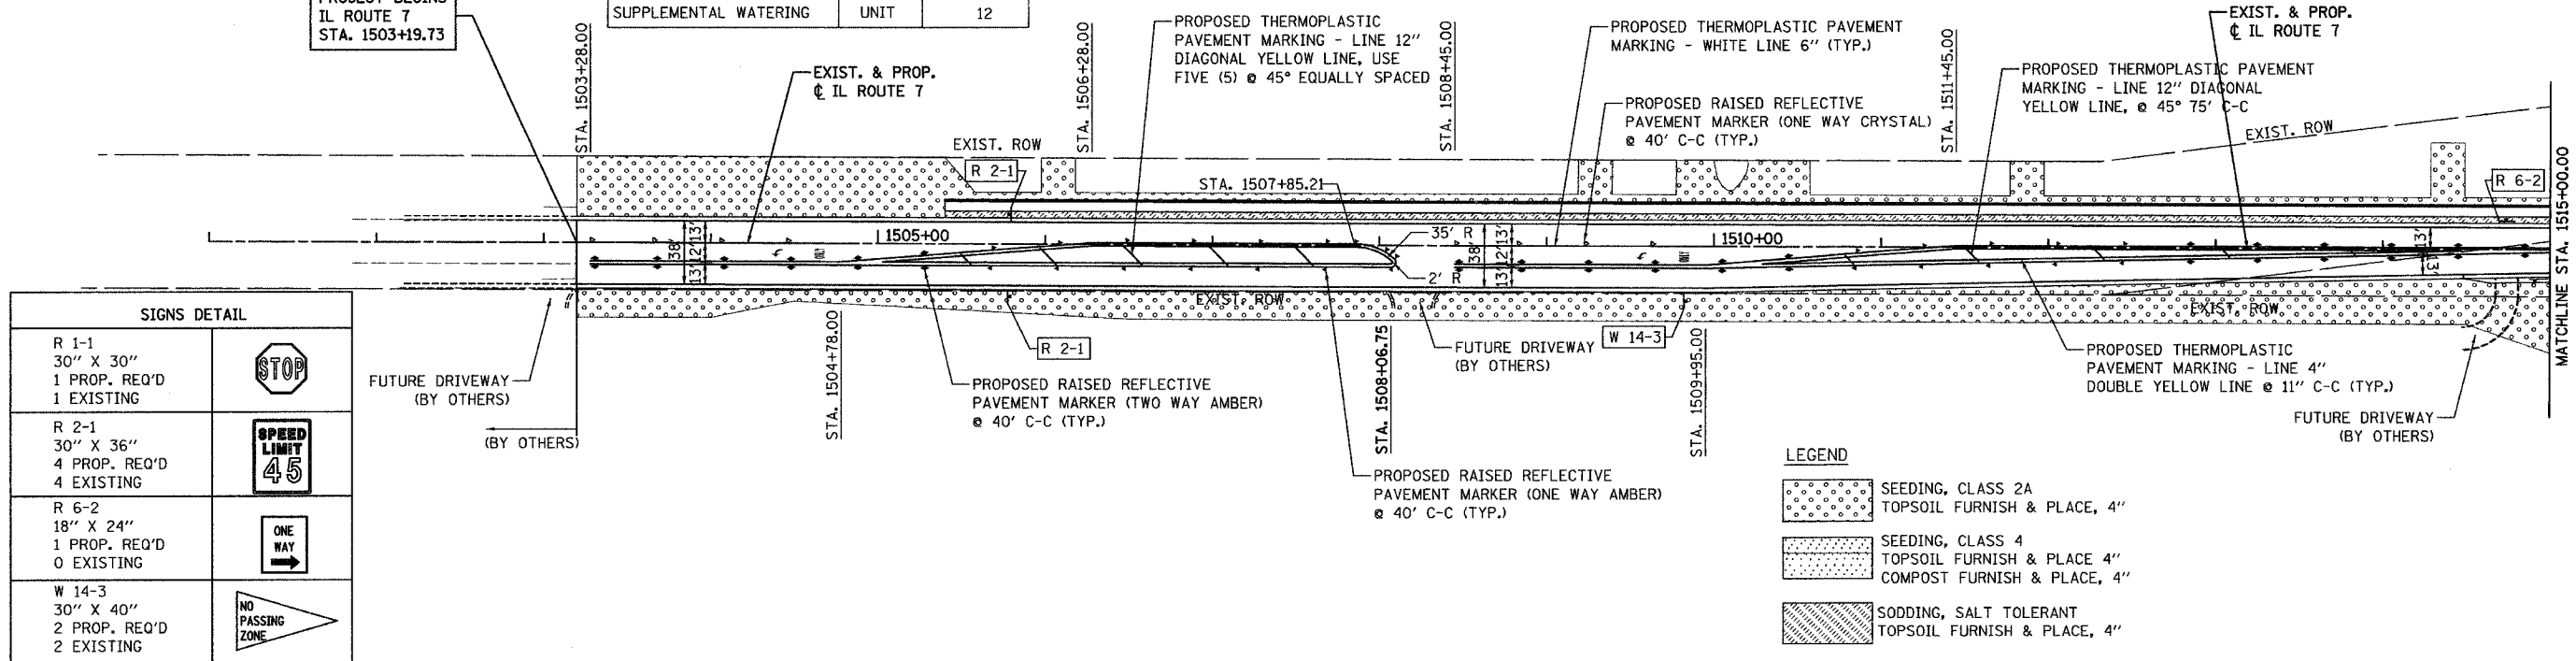


SIGNS DETAIL	
R 1-1 30" X 30" 1 PROP. REQ'D 1 EXISTING	
R 2-1 30" X 36" 4 PROP. REQ'D 4 EXISTING	
R 6-2 18" X 24" 1 PROP. REQ'D 0 EXISTING	
W 14-3 30" X 40" 2 PROP. REQ'D 2 EXISTING	

LEGEND	
	SEEDING, CLASS 2A TOPSOIL FURNISH & PLACE, 4"
	SEEDING, CLASS 4 TOPSOIL FURNISH & PLACE 4" COMPOST FURNISH & PLACE, 4"
	SODDING, SALT TOLERANT TOPSOIL FURNISH & PLACE, 4"

STA. 1515+00.00 TO STA. 1528+17.76		
ITEM	UNIT	QUANTITY
SEEDING, CLASS 2A	ACRE	0.5
SEEDING, CLASS 4	ACRE	1.7
COMPOST FURNISH AND PLACE, 4"	SQ YD	7920
TOPSOIL FURNISH AND PLACE, 4"	SQ YD	11190
EROSION CONTROL BLANKET	SQ YD	22555
SODDING, SALT TOLERANT	SQ YD	1080
SUPPLEMENTAL WATERING	UNIT	23

PROJECT ENDS
IL ROUTE 7
STA. 1528+17.76

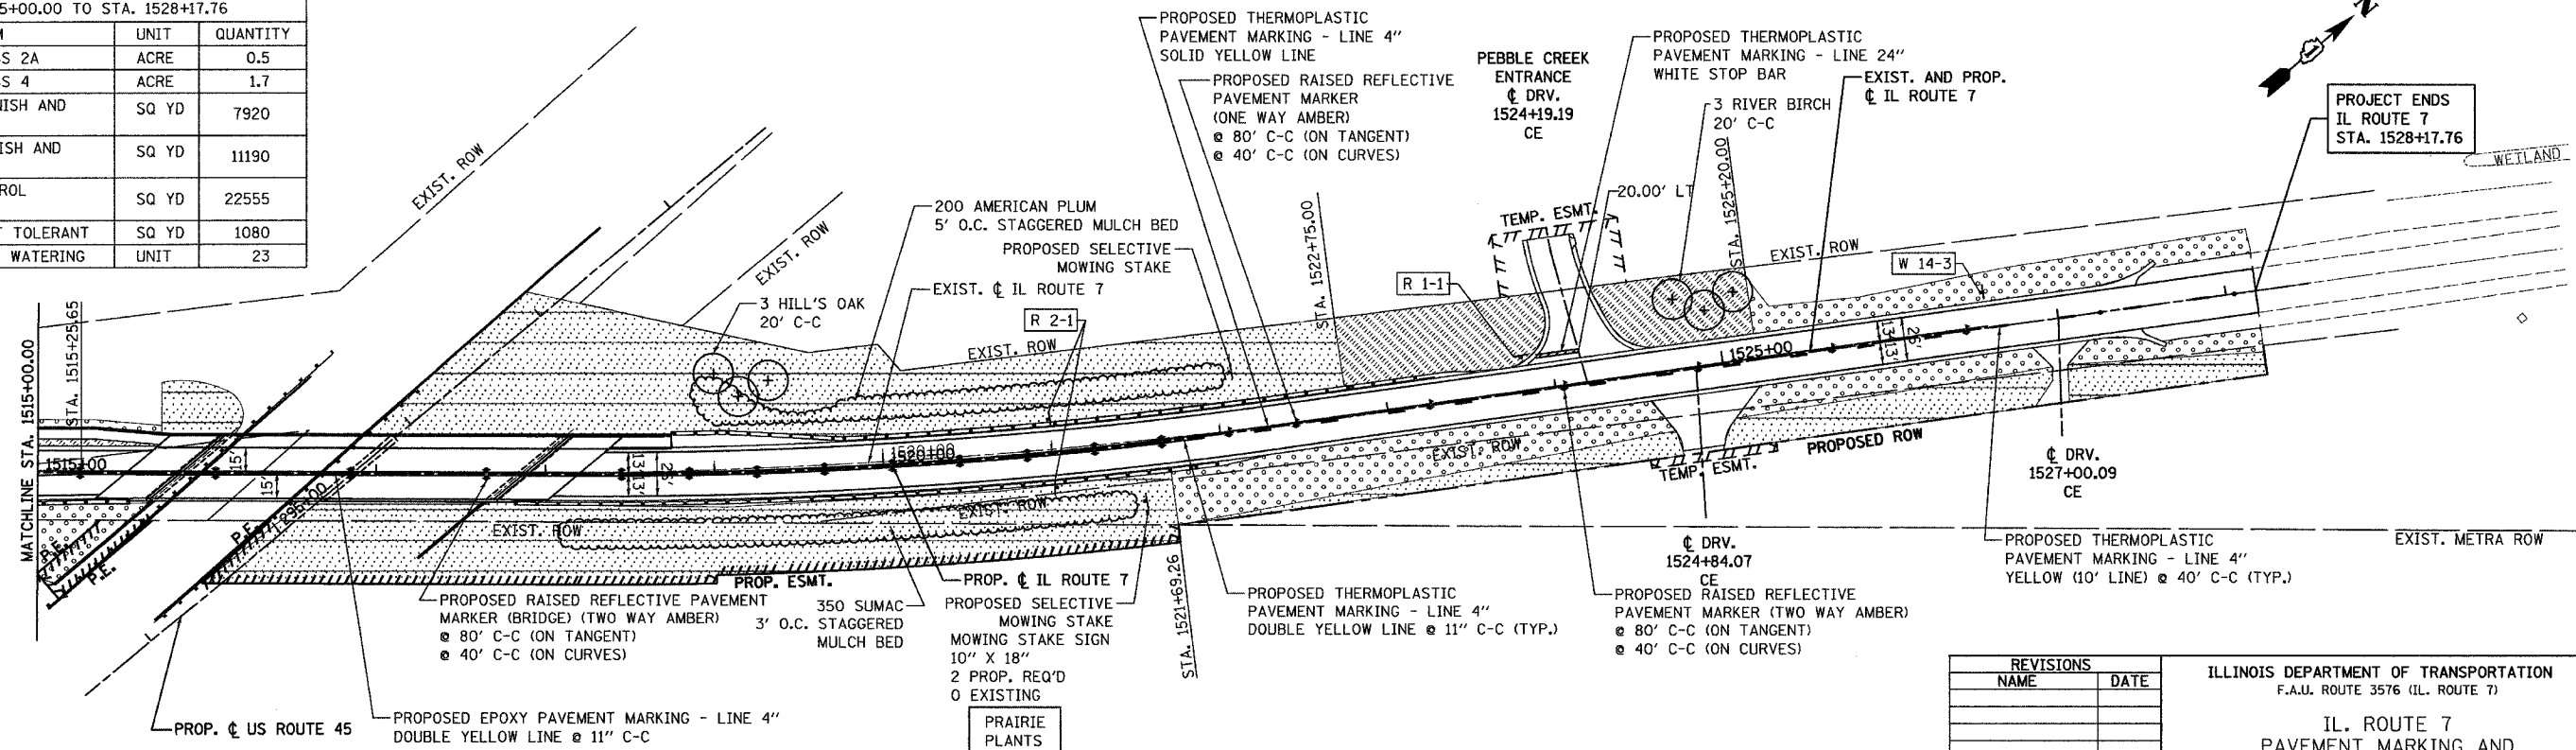

REVISIONS	
NAME	DATE

ILLINOIS DEPARTMENT OF TRANSPORTATION
F.A.U. ROUTE 3576 (IL. ROUTE 7)

IL. ROUTE 7
PAVEMENT MARKING AND
LANDSCAPING DETAILS
STA. 1503+19.73 TO STA. 1528+17.76

SCALE: VERT. 1" = 50'
HORIZ. 1" = 50'
DATE: MAR. 10, 2006

DRAWN BY BCD
CHECKED BY SLR

ITEM	SEEDING	SODDING	QUANTITY
NITROGEN FERTILIZER NUTRIENT	90 LB/ACRE X 1.50 ACRE = 135 POUND	60 LB/ACRE X 0.33 ACRE = 20 POUND	155 POUND
PHOSPHOROUS FERTILIZER NUTRIENT	90 LB/ACRE X 1.50 ACRE = 135 POUND	60 LB/ACRE X 0.33 ACRE = 20 POUND	155 POUND
POTASSIUM FERTILIZER NUTRIENT	90 LB/ACRE X 1.50 ACRE = 135 POUND	60 LB/ACRE X 0.33 ACRE = 20 POUND	155 POUND

PLOT DATE: 03/10/2006
 FILE NAME: \\sll\svr\proj\road\1\plan\p1\plan\p1.dgn
 PLOT SCALE: 1" = 50'
 REFERENCE: