SCHAUMBURG,

OFFICE

ROGRAM

TRAFFIC DATA

POSTED SPEED

LAGRANGE ROAD 38,700 (2003) 39,000 (2030)

INDEX OF SHEETS SEE SHEET 2

INDEX OF DISTRICT 1 DETAILS SEE SHEET 2

INDEX OF HIGHWAY STANDARDS SEE SHEET 2

DESIGN DESIGNATION

PRINCIPAL ARTERIAL

DESIGN SPEED

35 MPH (PROPOSED)

STATE OF ILLINOIS DEPARTMENT OF TRANSPORTATION

PLANS FOR PROPOSED FEDERAL AID HIGHWAY FAP 330/US 12-20-45 (LAGRANGE RD.)

FAU 3562 (JOLIET ROAD) TO (57TH STREET)

LANDSCAPING AND SCENIC BEAUTIFICATION

SECTION 10-00037-00-LS PROJECT TE-OOD1(864)


CITY OF COUNTRYSIDE **COOK COUNTY**

JOB NO: C-91-486-11

FAP 330 (LAGRANGE ROAD) PROJECT ENDS AT STA. 108+31

(LAGRANGE ROAD)

PROJECT BEGINS AT STA. 72+36

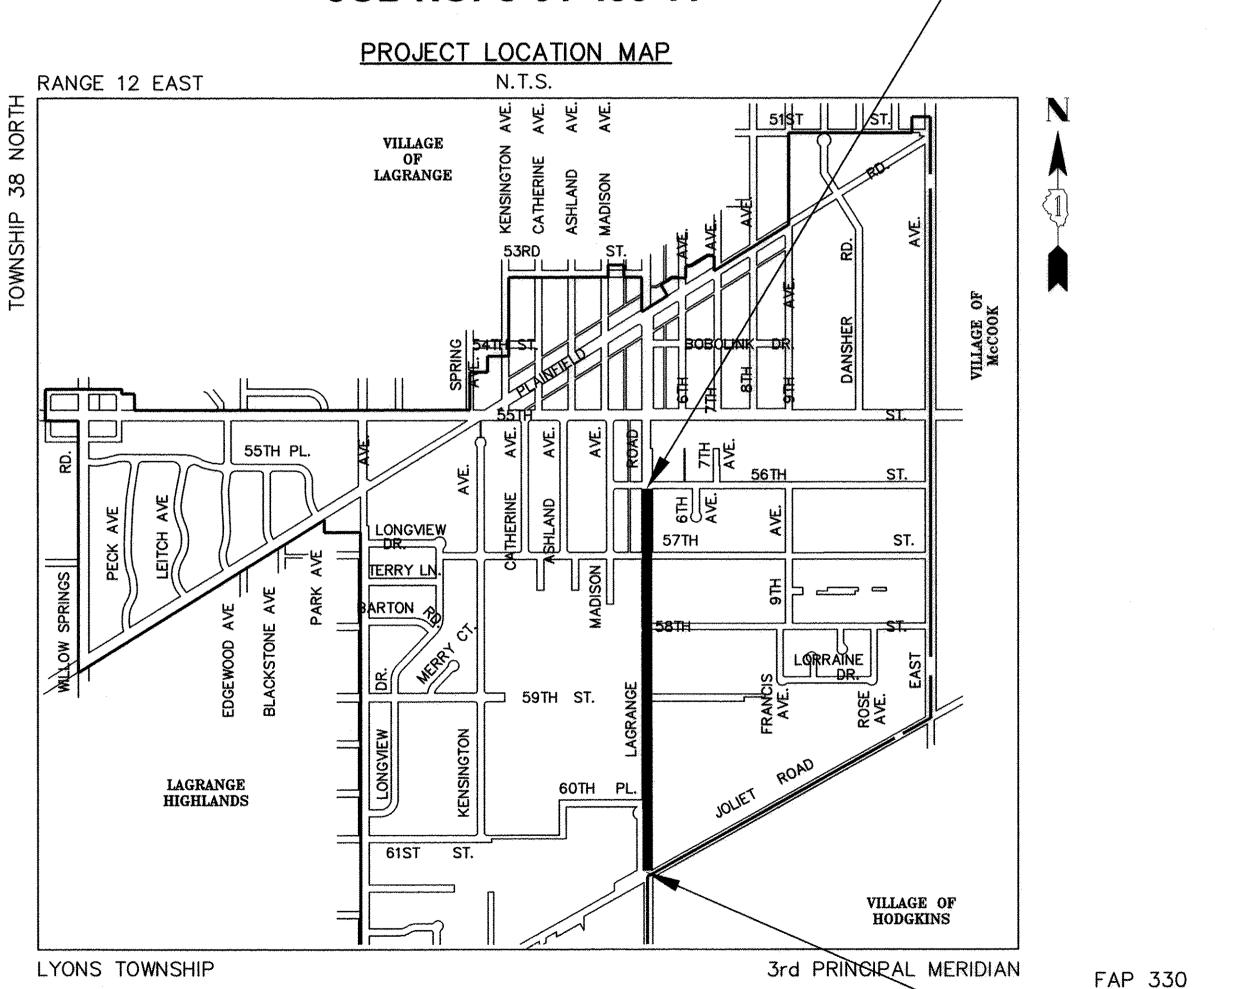

DENOTES LOCATION OF IMPROVEMENT

3,595 FEET (0.68 MILES)

3,595 FEET (0.68 MILES)

LENGTH OF PROJECT

GROSS LENGTH OF PROJECT

NET LENGTH OF PROJECT





COUNTY

ILLINOIS PROJECT

SECTION

FAP 330 10-00037-00-LS

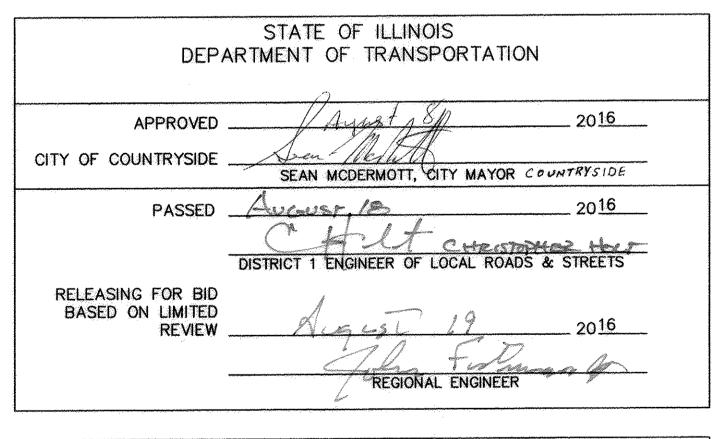

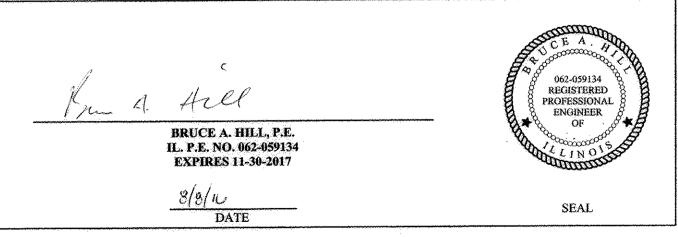

PRINTED BY THE AUTHORITY OF THE STATE OF ILLINOIS

1"=30' 1"=20' FULL SIZE PLANS HAVE BEEN PREPARED USING STANDARD ENGINEERING SCALES. REDUCED SIZED PLANS WILL NOT CONFORM TO STANDARD SCALES. IN MAKING MEASUREMENTS ON REDUCED PLANS, THE ABOVE SCALES MAY BE USED. 丁 <u>J.U.L.I.E.</u> JOINT CE UTILITY LOCATION INFORMATION CALL 811 INFORMATION FOR Know what's below. EXCAVATION Call before you dig. Frank Novotny & Associates, Inc. 545 Plainfield Rd. ♦ Willowbrook, IL ♦ 60527 ♦ Telephone: (630) 887-8640 ♦ Fax: (630) 887-0132 Civil Engineers/ STE. A ILLINOIS PROFESSIONAL DESIGN FIRM NO. 184-000928 DRAWN/DESIGNED JEP/BAH CHECKED/APPROVED JEF/JEF REVISIONS DESCRIPTION NO. BY DATE PER IDOT BAH 07/13/16 CONTRACT NO. 61C85

GENERAL CONSTRUCTION NOTES

SPECIFICATIONS

THE APRIL 1, 2016 EDITION OF THE "STANDARD SPECIFICATIONS FOR ROAD AND BRIDGE CONSTRUCTION", THE "SUPPLEMENTAL SPECIFICATIONS AND RECURRING SPECIAL PROVISIONS", PREPARED BY THE ILLINOIS DEPARTMENT OF TRANSPORTATION AND THE "MANUAL OF UNIFORM TRAFFIC CONTROL DEVICES" SHALL GOVERN ALL WORK ASSOCIATED WITH THIS PROJECT. THE "STANDARD SPECIFICATIONS FOR WATER AND SEWER MAIN CONSTRUCTION IN ILLINOIS" MAY GOVERN OTHER WORK ON THIS PROJECT AS INDICATED BY REFERENCE.

CARE IN EXCAVATION

CARE SHALL BE EXERCISED BY THE CONTRACTOR IN CARRYING OUT EARTH AND/OR TRENCHING OPERATIONS SO THAT LOCAL UTILITY SERVICES, WATER VALVES, MANHOLES, CATCH BASINS, INLETS, BUFFALO BOXES, AND OTHER STRUCTURES ARE NOT DAMAGED OR REMOVED. ANY DAMAGE DONE BY THE CONTRACTOR, WHETHER THE STRUCTURE OR SERVICE IS VISIBLE AT THE GROUND SURFACE OR NOT, SHALL BE REPAIRED OR REPLACED BY THE CONTRACTOR IN ACCORDANCE WITH ARTICLE 105.07 OF THE "STANDARD SPECIFICATIONS FOR ROAD AND BRIDGE CONSTRUCTION".

NOTIFICATION OF PUBLIC UTILITIES

PRIOR TO STARTING CONSTRUCTION. THE CONTRACTOR SHALL NOTIFY THE OFFICIALS OF THE PUBLIC WORKS DEPARTMENT OF THE LOCAL MUNICIPALITY, J.U.L.I.E. AT 1-800-892-0123 OR 811, AND OTHER PUBLIC AND PRIVATE UTILITIES SO THAT ARRANGEMENTS CAN BE MADE TO LOCATE THEIR VARIOUS FACILITIES WITHIN THE LIMITS OF CONSTRUCTION UNDER THIS CONTRACT, AS WELL AS TO PROVIDE ADEQUATE PROTECTION AND INSPECTION THERETO. IT SHALL BE THIS CONTRACTOR'S RESPONSIBILITY TO DETERMINE THE ACTUAL LOCATION OF ALL SUCH FACILITIES IN THE FIELD.

TRAFFIC CONTROL DEVICES

BARRICADES AND WARNING SIGNS SHALL BE PROVIDED IN ACCORDANCE WITH ARTICLE 107.14 OF THE "STANDARD SPECIFICATIONS FOR ROAD AND BRIDGE CONSTRUCTION".

TREES AND BRANCHES

WHERE OVERHANGING BRANCHES INTERFERE WITH OPERATIONS OF CONSTRUCTION, SAID BRANCHES SHALL BE TRIMMED AND SEALED IN ACCORDANCE WITH SECTION 253.09 OF THE "STANDARD SPECIFICATIONS FOR ROAD AND BRIDGE CONSTRUCTION", AND THE COST OF SAME SHALL BE INCLUDED IN THE COST OF THE CONTRACT. IF TREES OR SHRUBS MUST BE REMOVED, THEY WILL BE PAID FOR IN ACCORDANCE WITH THE SPECIFICATIONS.

WATER VALVE BOXES AND DOMESTIC WATER SERVICE BOXES

WATER VALVE BOXES AND DOMESTIC WATER SERVICE BOXES THAT ARE LOCATED DURING CONSTRUCTION AND ARE NOT REQUIRED TO BE MOVED SHALL BE ADJUSTED TO THE FINISH GRADE SHOWN ON THE PLANS, OR AS DIRECTED BY THE ENGINEER. THE COST OF THIS WORK SHALL BE CONSIDERED INCLUDED IN THE COST OF THE CONTRACT, AND NO ADDITIONAL COMPENSATION WILL BE ALLOWED.

EXCAVATED MATERIALS

THE CONTRACTOR WILL BE REQUIRED TO DISPOSE OF ALL SURPLUS TRENCH SPOIL MATERIALS OFF THE SITE AS WORK PROGRESSES. THE TEMPORARY STOCKPILING OF THIS MATERIAL ON THE PROJECT SITE WILL NOT BE ALLOWED.

SAWING EXISTING IMPROVEMENTS

ALL PERMANENT TYPE PAVEMENTS OR OTHER PERMANENT IMPROVEMENTS WHICH ABUT THE PROPOSED IMPROVEMENT AND MUST BE REMOVED, SHALL BE SAWED AS DIRECTED PRIOR TO REMOVAL, ALL ITEMS SO REMOVED SHALL BE REPLACED WITH SIMILAR CONSTRUCTION MATERIALS TO THEIR ORIGINAL CONDITION OR BETTER. PAYMENT FOR SAWING SHALL BE INCLUDED IN THE COST FOR THE REMOVAL OF EACH ITEM, AND REPLACEMENT WILL BE PAID FOR UNDER THE RESPECTIVE ITEMS IN THE CONTRACT UNLESS OTHERWISE INDICATED. SAW CUTTING FOR PATCHES WILL BE INCLUDED IN THE COST OF TO THE PATCHING ITEM. EXISTING DRIVEWAY PAVEMENT AND SIDEWALK TO REMAIN IN PLACE SHALL BE SAWCUT TO PROVIDE A NEAT VERTICAL FACE BETWEEN THE PROPOSED AND THE EXISTING. AND SUCH COST SHALL BE CONSIDERED INCLUDED IN THE COST OF THE CONTRACT.

CONSTRUCTION LAYOUT STAKES

FILE NAME = CITY OF COUNTRYSIDE

FAP 330/US 12-20-45 (LAGRANGE RD.)

FAU 3562 (JOLIET ROAD) TO (57TH STREET)

THE CONTRACTOR SHALL PROVIDE THE ENGINEER WITH WOODEN STAKES OR OTHER LAYOUT MATERIALS FOR LAYOUT OF THE LINES AND GRADES OF THE PROJECT. FAILURE TO PROVIDE STAKES IN A TIMELY MANNER WILL RESULT IN A DELAY IN STAKEOUT WHICH WILL BE APPLICABLE AGAINST THE TIME LIMIT FOR COMPLETION SHOWN IN THE PROJECT SPECIFICATIONS. LINE AND GRADE WILL BE ESTABLISHED BY THE ENGINEER AT REGULAR INTERVALS ON PERMANENTLY PAVED SURFACES, SIDEWALKS OR STAKES AT THE ENGINEER'S OPTION, ALL WITHIN THE PUBLIC RIGHT-OF-WAY AND SHALL BE TRANSFERRED BY THE CONTRACTOR TO THE ACTUAL LINE OF CONSTRUCTION

PROJECT SAFETY

THE CONTRACTOR SHALL COMPLY WITH AND OBSERVE THE RULES AND REGULATIONS OF O.S.H.A. AND APPROPRIATE AUTHORITIES REGARDING SAFETY PROVISIONS. THE CONTRACTOR. ENGINEER. AND OWNER SHALL EACH BE RESPONSIBLE FOR THEIR OWN RESPECTIVE AGENTS AND EMPLOYEES.

THE ENGINEER AND OWNER ARE NOT RESPONSIBLE FOR THE CONSTRUCTION MEANS, METHODS, TECHNIQUES, SEQUENCES OR PROCEDURES, TIME OF PERFORMANCE, PROGRAMS, OR FOR ANY SAFETY PRECAUTIONS USED BY THE CONTRACTOR. THE CONTRACTOR IS SOLELY RESPONSIBLE FOR EXECUTION OF HIS WORK IN ACCORDANCE WITH THE DOCUMENTS AND SPECIFICATIONS.

THE RESIDENT ENGINEER SHALL CONTACT THE TRAFFIC CONTROL SUPERVISOR AT (847) 705-4470 A MINIMUM OF 72 HOURS PRIOR TO THE PLACEMENT OF ANY TEMPORARY TRAFFIC CONTROL DEVICES.

NOTE: CONTRACTOR SHALL MILL BEFORE PATCHING.

HOT-MIX ASPHALT MIXTURE REQUIREMENTS

MIXTURE TYPE	AIR VOIDS @ NDES
HOT-MIX ASPHALT DRIVEWAY PAVEMENT, 4"	
HOT-MIX ASPHALT SURFACE COURSE, MIX "C", N50, (IL-9.5mm), 1-1/2"	4% @ 50 GYR
HOT-MIX ASPHALT BINDER COURSE, N50, (IL-19.0mm), 2-1/2"	4% @ 50 GYR

THE UNIT WEIGHT TO CALCULATE ALL HOT-MIX ASPHALT SURFACE MIXTURE QUANTITIES IS 112 LBS/SQ YD/IN.

"THE "AC TYPE" FOR POLYMERIZED HMA MIXES SHALL BE "SBS/SBR PG 76-22" AND FOR NON-POLYMERIZED HMA THE "AC TYPE" SHALL BE "PG 64-22" UNLESS MODIFIED BY DISTRICT ONE SPECIAL PROVISIONS"

FOR HMA FULL DEPTH "AC TYPE" SEE SPECIAL PROVISIONS

FOR USE OF RECYCLED MATERIALS SEE SPECIAL PROVISIONS

DESIGNED - BAH _ 07/13/16 REVISED USER NAME = REVISED - 12/22/16DRAWN - JEP CHECKED — **JEF** REVISED PLOT SCALE = **LANDSCAPING AND SCENIC BEAUTIFICATION - PHASE II** DATE - 10/15REVISED PLOT DATE =

SPECIAL PROJECT NOTES

- AFTER THE COMPLETION OF THE PROJECT, THE CITY OF COUNTRYSIDE SHALL BE RESPONSIBLE FOR ALL PAVER BRICK AND LANDSCAPING IMPROVEMENTS STREETSCAPE, CURB AND GUTTER AND OTHER APPURTENANCES AS SHOWN IN THIS PLAN SET. THE ILLINOIS DEPARTMENT OF TRANSPORTATION WILL NOT MAINTAIN OR CAUSE TO MAINTAIN OR REIMBURSE FOR MAINTENANCE OF ANY THE PROPOSED IMPROVEMENTS AS SHOWN IN THIS PLAN SET.
- 2. PROVIDE DETECTABLE WARNING STRIP AT ALL CURB RAMPS (TYPICAL)
- 3. ALL SAWCUTS SHALL BE CONSIDERED INCLUDED IN THE COST OF THE REMOVAL PAY ITEM.
- 4. PROVIDE "PROTECTIVE COAT, (SPECIAL)" ON ALL PORTLAND CEMENT CONCRETE SURFACE IN ACCORDANCE WITH ARTICLES 420.21, 420.22, AND 420.23 OF THE STANDARD SPECIFICATIONS. COST SHALL BE CONSIDERED INCIDENTAL TO THE CORRESPONDING PAY ITEM.
- THE CONTRACTOR SHALL PROVIDE A PORTABLE TOILET AT EACH WORK SITE WHERE WORKERS ARE PRESENT, WHICH COST SHALL BE INCLUDED IN THE COST OF MOBILIZATION.
- TRAFFIC CONTROL PROVISIONS OF SECTION 700, 701 AND 702 WILL BE STRICTLY ENFORCED. THE CONTRACTOR SHALL BE ALERT TO POST ALL NECESSARY SIGNAGE, HAVE FLAGGERS AT LOCATIONS OF RESTRICTED LANE OPERATIONS, AND TAKE DOWN THE SIGNAGE WHEN THE WORK IS COMPLETED.
- EXISTING DRIVEWAY PAVEMENT AND SIDEWALK TO REMAIN IN PLACE SHALL BE SAW CUT TO PROVIDE A NEAT VERTICAL FACE BETWEEN THE PROPOSED AND THE EXISTING, AND SUCH COST SHALL BE CONSIDERED INCLUDED IN THE REMOVAL PAY ITEM.
- 8. THE REMOVAL OF SHRUBS SHALL BE INCLUDED IN THE COST OF "EARTH EXCAVATION"
- 9. AFTER AWARD OF CONTRACT, CONTACT THE CITY OF COUNTRYSIDE FOR INFORMATION ON THE BEST LOCATIONS TO STORE CONSTRUCTION EQUIPMENT ON-SITE. ALL CONSTRUCTION EQUIPMENT SHALL BE REMOVED FROM THE RIGHT-OF-WAY DURING NON-WORKING HOURS, UNLESS THE CITY GRANTS SPECIAL PERMISSION. THE CONTRACTOR SHALL MAKE ALL ARRANGEMENTS, AND PAY ANY COSTS ASSOCIATED WITH COMPLYING WITH THIS PROVISION.
- 10. THE CONTRACTOR SHALL REMOVE ALL WEED GROWTH IN THE TOPSOIL AREAS AND DISTURBED PARKWAY AREAS PRIOR TO PLACEMENT OF SOD OR SEED. ANY GROWTH OVER EIGHT INCHES (8") IN HEIGHT MUST BE TEMPORARILY MOWED PRIOR TO REMOVAL
- 11. THE ENGINEER SHALL APPROVE THE TIME OF EACH OF THE SEVEN (7) OR FIFTEEN (15) FREE WATERINGS THAT ARE INCLUDED IN THE SOD PLACEMENT ITEM. WATERINGS SHALL NOT BE "BACK-TO-BACK", UNLESS SOD SHOWS SEVERE LEVELS OF STRESS.
- 12. ALL P.C. CONCRETE SIDEWALKS SHALL BE CLASS SI CONCRETE IN ACCORDANCE WITH SECTION 1020 OF THE "STANDARD SPECIFICATION FOR ROAD AND BRIDGE CONSTRUCTION" AND SHALL BE CONSTRUCTED ON A 2" MINIMUM THICKNESS CA-6 CRUSHED LIMESTONE SUBBASE.
- 13. ALL COMBINATION CONCRETE CURB & GUTTER SHALL BE CLASS SI CONCRETE IN ACCORDANCE WITH SECTION 1020 OF THE "STANDARD SPECIFICATION FOR ROAD AND BRIDGE" AND SHALL BE CONSTRUCTED ON A 4" MINIMUM THICKNESS CA-6 CRUSHED LIMESTONE SUBBASE.
- 14. A MEETING BETWEEN THE CONTRACTOR, ENGINEER, AND CITY STAFF WILL BE HELD EVERY THURSDAY MORNING AT 10:00AM TO DISCUSS THE PROGRESS OF WORK, AND ATTENDANCE BY THE PROJECT SUPERINTENDENT IS MANDATORY.
- 15. FOR PURPOSES OF WATERING SOD OR SUPPLEMENTAL WATERING, THE CITY OF COUNTRYSIDE WILL FURNISH WATER AT NO COST, BUT THE CONTRACTOR MUST USE A WATER TRUCK FOR PLACEMENT OF WATER AND FILL UP AT A DESIGNATED FIRE HYDRANT NEAR CITY HALL (5550 EAST AVE.). WATERING DIRECTLY FROM A HYDRANT AT THE PROJECT SITE WILL NOT BE ALLOWED. THE CONTRACTOR MAY NOT OPEN ANY VALVES.
- 16. THE CONTRACTOR SHALL HAVE THE RESPECTIVE UTILITY COMPANIES FIELD LOCATE ALL THEIR FACILITIES PRIOR TO BEGINNING CONSTRUCTION. ANY RELOCATION OR LOWERING OF UTILITIES SHALL BE COORDINATED BY THE CONTRACTOR WITH THE UTILITY COMPANY.
- SIDEWALKS SHALL BE INCREASED TO 8" THICKNESS AT ALL DRIVEWAYS.
- 18. ANY TREE TRIMMING NEEDED TO INSTALL ANY SIGNAGE ON THIS PROJECT WILL BE CONSIDERED INCLUDED IN THE COST OF THE SIGN PAY ITEM.

INDEX OF SHEETS

- COVER SHEET: LOCATION MAP
- INDEX OF SHEETS, GENERAL CONSTRUCTION NOTES, INDEX OF DISTRICT 1 DETAILS, INDEX OF HIGHWAY STANDARDS, HOT-MIX ASPHALT MIXTURE REQUIREMENTS. SPECIAL PROJECT NOTES, EARTH **EXCAVATION TABLE**
- SUMMARY OF QUANTITIES
- TYPICAL SECTIONS 4.-7.
- PLAN REMOVAL: LAGRANGE ROAD
- PLAN PROPOSED IMPROVEMENTS: LAGRANGE ROAD
- PLAN DETAIL FOR SIGN WALL: NW CORNER LAGRANGE ROAD
- AND JOLIET ROAD
- SIGN PANEL LOCATION MAP & DETAILS
- SIGN WALL PLAN, ELEVATION AND DETAIL
- PYLON DETAILS, PYLON LIGHTING DETAILS, 21.) RFTAINING WALL DETAIL AND SEAT WALL DETAIL

EAST PARKWAY

39 CY

68 CY

56 CY

76 CY

57 CY

296 CY

- STREETSCAPE FURNISHINGS DETAILS
- TYPICAL PLANTING DETAILS
- 24.) ELECTRICAL FIXTURE DETAILS
- 25.) ELECTRICAL DETAILS

EARTH EXCAVATION

SCHEDULE

195 CY

71 CY

52 CY

93 CY

58 CY

469 CY

223 CY

128 CY

37 CY

388 CY

TOTAL 1153 CY

FED. ROAD DIST. NO. | ILLINOIS FED. AID PROJECT TE-00D1(864)

STATION TO STATION WEST PARKWAY

78+84

84+54

88+80

95+39

102+00

PROJECT WIDE PLANTINGS

72+60

79+24

85+00

89+23

96+00

ALL TREES

ALL SHRUBS

ALL PERENNIALS

- SIGN POST DETAILS
- CONSTRUCTION HIGHWAY STANDARDS -
- CURB RAMPS FOR SIDEWALKS
- 28.-34) DISTRICT 1 DETAILS

INDEX OF DISTRICT 1 STANDARDS

- BD-01 DRIVEWAY DETAILS DISTANCE BETWEEN R.O.W. AND FACE OF CURB & EDGE OF SHOULDER > 15'
- BD-02 DRIVEWAY DETAILS DISTANCE BETWEEN R.O.W. AND FACE OF CURB & EDGE OF SHOULDER < 15'
- BD-24 CURB AND GUTTER REMOVAL AND REPLACEMENT
- TC-10 TRAFFIC CONTROL & PROTECTION FOR SIDE ROADS, INTERSECTIONS, & DRIVEWAYS TC-13 DISTRICT ONE TYPICAL PAVEMENT MARKINGS
- TC-14 TRAFFIC CONTROL AND PROTECTION AT TURN BAYS (TO REMAIN OPEN TO TRAFFIC)

TC-22 ARTERIAL ROAD INFORMATION SIGN

TC-16 SHORT TERM PAVEMENT MARKING LETTERS AND SYMBOLS

INDEX OF HIGHWAY STANDARDS

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- 000001-06 STANDARD SYMBOLS, ABBREVATIONS, AND PATTERNS
- 280001-07 TEMPORARY EROSION CONTROL SYSTEMS
- 424001-09 PERPENDICULAR CURB RAMPS FOR SIDEWALKS
- 424016-0.3 MID-BLOCK CURB RAMPS FOR SIDEWALKS
- 424021-03 DEPRESSED CORNER FOR SIDEWALKS 424026-01 ENTRANCE/ALLEY PEDESTRAIN CROSSINGS
- 424031-01 MEDIAN PEDESTRAIN CROSSINGS
- 442201-03 CLASS C AND D PATCHES
- 606001-06 CONCRETE CURB TYPE B AND COMBINATION CONCRETE CURB & GUTTER
- 701301-04 LANE CLOSURE, 2L, 2W, SHORT TIME OPERATIONS
- 701311-03 LANE CLOSURE, 2L, 2W, MOVING OPERATIONS-DAY ONLY
- 701501-06 URBAN LANE CLOSURE, 2 L, 2 W UNDIVIDED
- 701602-08 URBAN LANE CLOSURE, MULTILANE, 2 W BIDIRECTIONAL LEFT TURN LANE
- 701701-10 URBAN LANE CLOSURE, MULTILANE INTERSECTION
- 701801-06 LANE CLOSURE MULTILANE 1W OR 2W CROSSWALK
- 701901-06 TRAFFIC CONTROL DEVICES 720001-01 SIGN PANEL MOUNT DETAILS
- 720011-01 METAL POSTS FOR SIGNS, MARKERS & DELINEATOR
- 780001-05 TYPICAL PAVEMENT MARKINGS

STATE OF ILLINOIS DEPARTMENT OF TRANSPORTATION

OR SIDEWALK CLOSURE						
DRS		Civil Engineers Municipal Consult		27 • Telephone: (630) 8	187-8640 + Fax: (63	
OF SHEETS, GENERAL CONSTRUCTION NOTES,	INDEX OF DISTRICT 1	F.A.P. RTE.	SECTION	COUNTY	TOTAL SHEETS	SHEET NO.
ILS. INDEX OF HIGHWAY STANDARDS, HOT-MIX A	ASPHALT MIXTURE	330	10-00037-00-15	COOK	34	2

TO STA.

REQUIREMENTS, SPECIAL PROJECT NOTES, EARTH EXCAVATION TABLE

SCALE: NONE SHEET NO. OF SHEETS STA.

CONTRACT NO. 61C85

ty	Special				Total Quantity	Specialty	Special				Qua
	Provision	Code No.	Description	Unit	0031	ltem **	Provision	Code No.	Description	Unit	0
		20101100	TREE TRUNK PROTECTION	EACH	8.	· **			SHRUB, HYDRANGEA QUERCIFOLIA (OAKLEAF HYDRANGEA), 2' HEIGHT, CONTAINER	EACH	
		20200100	EARTH EXCAVATION	CU YD	1153	本			SHRUB, POTENTILLA FRUCTICOSA JACKMANII (JACKMANS BUSH CINQUEFOIL), 2' HEIGHT, CONTAINER	EACH	
		21101615	TOPSOIL FURNISH AND PLACE, 4"	SQ YD	5760	**			TREE, PICEA PUNGENS (COLORADO SPRUCE), 10' HEIGHT, BALLED AND BURLAPPED	EACH	
		25000210	SEEDING, CLASS 2A	ACRE	1	*			PERENNIAL PLANTS, ORNAMENTAL TYPE, GALLON POT	UNIT	
		25000400	NITROGEN FERTILIZER NUTRIENT	POUND	105	*	CD		PERENNIAL PLANTS, ORNAMENTAL TYPE, 4" POT	UNIT	
			PHOSPHORUS FERTILIZER NUTRIENT	POUND	105	不	SP	X0300635		EACH	
		25000600	POTASSIUM FERTILIZER NUTRIENT	POUND	105	不	SP		DECORATIVE SIGN POST	EACH	
		25100630	EROSION CONTROL BLANKET	SQ YD	5760	*	SP	X0327066			
		25200200	SUPPLEMENTAL WATERING	UNIT	100	*	SP		BRICK JOINT FILLER	SQ YD	
		28000510	INLET FILTERS	EACH	45		SP		TREE FRAME AND GRATE	EACH	
		31101200	SUBBASE GRANULAR MATERIAL, TYPE B 4"	SQ YD	5075		SP	X0540000	BRICK PAVERS	SQFT	
		40600275	BITUMINOUS MATERIALS (PRIME COAT)	POUND	2420		SP	X4240800	DETECTABLE WARNINGS (SPECIAL)	SQ FT	
		42300400	PORTLAND CEMENT CONCRETE DRIVEWAY PAVEMENT, 8 INCH	SQ YD	150	*	SP	X8140105	HANDHOLE (SPECIAL)	EACH	1
		44000200	DRIVEWAY PAVEMENT REMOVAL	SQ YD	260	*		X8140115	HANDHOLE TO BE ADJUSTED	EACH	
		44000600	SIDEWALK REMOVAL	SQ FT	24700	*		X8165555	UNIT DUCT, 600V, 2-1C NO. 12, 1/C NO.12 GROUND (XLP - TYPE USE),	FOOT	
		66900200	NON-SPECIAL WASTE DISPOSAL	CU YD	311				3/4" DIA., POLYETHYLENE		l
		66900450	SPECIAL WASTE PLANS AND REPORTS	LSUM	1.	*	SP	XX000959	TRASH RECEPTACLES	EACH	1
		66900530	SOIL DISPOSAL ANALYSIS	EACH	9	*	SP	XX005661	REMOVE AND RELOCATE SIGN NO. 1	EACH	
		67100100	MOBILIZATION	LSUM	1	*	SP	XX006834	ELECTRICAL CONNECTION TO EXISTING LIGHTING SYSTEM	EACH	
		70102620	TRAFFIC CONTROL AND PROTECTION, STANDARD 701501	LSUM	1	*	SP	XX006961	ORNAMENTAL STREET SIGN	EACH	1
		70102632	TRAFFIC CONTROL AND PROTECTION, STANDARD 701602	LSUM	. 1	*	SP	XX007109	LIGHT FIXTURE TYPE A	EACH	
		70102635	TRAFFIC CONTROL AND PROTECTION, STANDARD 701701	LSUM	1	*	SP	XX007112	LIGHT FIXTURE TYPE B	EACH	1
	•		TRAFFIC CONTROL AND PROTECTION, STANDARD 701801	LSUM	1 ,	*	SP	XX007113	LIGHT FIXTURE TYPE C	EACH	
		ł	THERMOPLASTIC PAVEMENT MARKING - LINE 6"	FOOT	386	*	SP	XX007415	MONUMENT, TYPE A	EACH	
		78000650	THERMOPLASTIC PAVEMENT MARKING - LINE 24"	FOOT	67	*	SP	XX008029	LIGHTING CONTROL PANEL	EACH	
			UNIT DUCT, 600V, 2-1C NO. 2, 1/C NO.6 GROUND (XLP - TYPE USE),	FOOT	485	*	SP	XX008031	M2 KNUCKLE MOUNT ACCENT FIXTURE	EACH	
			1-1/2" DIA., POLYETHYLENE	•		*	SP	XX008032	M3 FIXTURE IN PYLON	EACH	
		81603112	UNIT DUCT, 600V, 2-1C NO. 6, 1/C NO.8 GROUND (XLP - TYPE USE),	FOOT	40	*	SP	XX008033	DUPLEX WEATHERPROOF GFI RECEPTACLE AND COVER PLATE	EACH	
		01000111	1-1/4" DIA., POLYETHYLENE			*	SP	XX008104	POLE MOUNTED PLANTER BASKET	EACH	
		81702290	ELECTRIC CABLE IN CONDUIT, 600V (XLP-TYPE USE), 2/C NO. 2	FOOT	1980		SP		STAMPED COLORED PORTLAND CEMENT CONCRETE SIDEWALK, 5 INCH	SQ FT	
			MODIFY EXISTING CONTROLLER	EACH	1		SP		STAMPED COLORED PORTLAND CEMENT CONCRETE SIDEWALK, 8 INCH	SQ FT	
			REMOVE ELECTRIC CABLE FROM CONDUIT	FOOT	955	*	SP		WAYFINDING SIGN	EACH	
ĺ		Ì	TREE, ACER X FREEMANII AUTUMN BLAZE (AUTUMN BLAZE FREEMAN MAPLE), 3" CALIPER, BALLED & BURLAPPED	EACH	23	*	SP	Z0003850		EACH	
				EACH	5		SP		HOT-MIX ASPHALT DRIVEWAY PAVEMENT, 4"	SQ YD	
			TREE, ACER SACCHARUM (SUGAR MAPLE), 3" CALIPER, BALLED AND BURLAPPED		4.7				HOT-MIX ASPHALT DRIVEWAY PAVEMENT REMOVAL	SQ YD	1
			TREE, CATALPA SPECIOSA (NORTHERN CATALPA), 3" CALIPER, BALLED AND BURLAPPED	EACH	17					FOOT	
			TREE, GLEDITSIA TRIACANTHOS INERMIS SKYLINE (SKYLINE THORNLESS COMMON HONEYLOCUST), 3" CALIPER, BALLED AND BURLAPPED	EACH	25				COMBINATION CONCRETE CURB AND GUTTER REMOVAL AND REPLACEMENT	LSUM	
			TREE, GYMNOCLADUS DIOICUS (KENTUCKY COFFEETREE), 3" CALIPER, BALLED AND BURLAPPED	EACH	15				CONSTRUCTION LAYOUT	EACH	
			TREE, QUERCUS BICOLOR (SWAMP WHITE OAK), 3" CALIPER, BALLED AND BURLAPPED	EACH	2				DRAINAGE & UTILITY STRUCTURES TO BE ADJUSTED		
	•		TREE, AMELANCHIER CANADENSIS (SHADBLOW SERVICEBERRY), 8' HEIGHT, BALLED AND BURLAPPED	EACH	7				DRAINAGE & UTILITY STRUCTURES TO BE RECONSTRUCTED	EACH	1
		C2000336	SHRUB, ARONIA ARBUTIFOLIA BRILLIANT ISSIMA (BRILLIANT RED CHOKEBERRY), 3' HEIGHT, BALLED AND BURLAPPED	EACH	32				TEMPORARY INFORMATION SIGNING	SQ FT	
		C2011600	SHRUB, VIBURNUM DENTATUM BLUE MUFFIN (BLUE MUFFIN ARROWHEAD), 3' HEIGHT, BALLED AND BURLAPPED	EACH	92		SP #		TRAINEES	HOUR	1
		C2C01324	SHRUB, CLETHRA ALNIFOLIA (SUMMERSWEET CLETHRA), 2' HEIGHT, CONTAINER	EACH	103		SP #	Z0076604	TRAINEES TRAINING PROGRAM GRADUATE	HOUR	
		C2C03428	SHRUB, HYDRANGEA MACROPHYLLA ENDLESS SUMMER (ENDLESS SUMMER BIGLEAF HYDRANGEA), 2' HEIGHT, CONTAINER GROWN	EACH	64						_4_

#0042

SUMMARY OF QUANTITIES

TO STA.


SCALE: NONE SHEET NO. OF SHEETS STA.


Civil Engine Municipal Const	Frank Novoti 545 Plainfield Rd. • Willowbrook, IL • STE A ILLINOIS PROFESSIO		87-8640 • Fax: (6)	Contract of the second
F.A.P.	SECTION	COUNTY	TOTAL SHEETS	SHEET NO.
330	10-00037-00-LS	соок	34	3
		CONTRAC		C85
FED. ROA	D DIST, NO. ILLINOIS FED.	AID PROJECT TE	-00D1(86	4)


FILE NAME	CITY OF COUNTRYSIDE
FAI	330/US 12-20-45 (LAGRANGE RD.)
	AU 3562 (JOLIET ROAD) TO (57TH STREET)
LANDS	CAPING AND SCENIC BEAUTIFICATION - PHASE
#10316	


.,.,	USER NAME =	DESIGNED -	BAH	REVISED	_ 07/13/16
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	PLOT SCALE =	CHECKED -	JEF	REVISED	
	PLOT DATE =	DATE -	10/15	REVISED	


STATE OF ILLINOIS
DEPARTMENT OF TRANSPORTATION

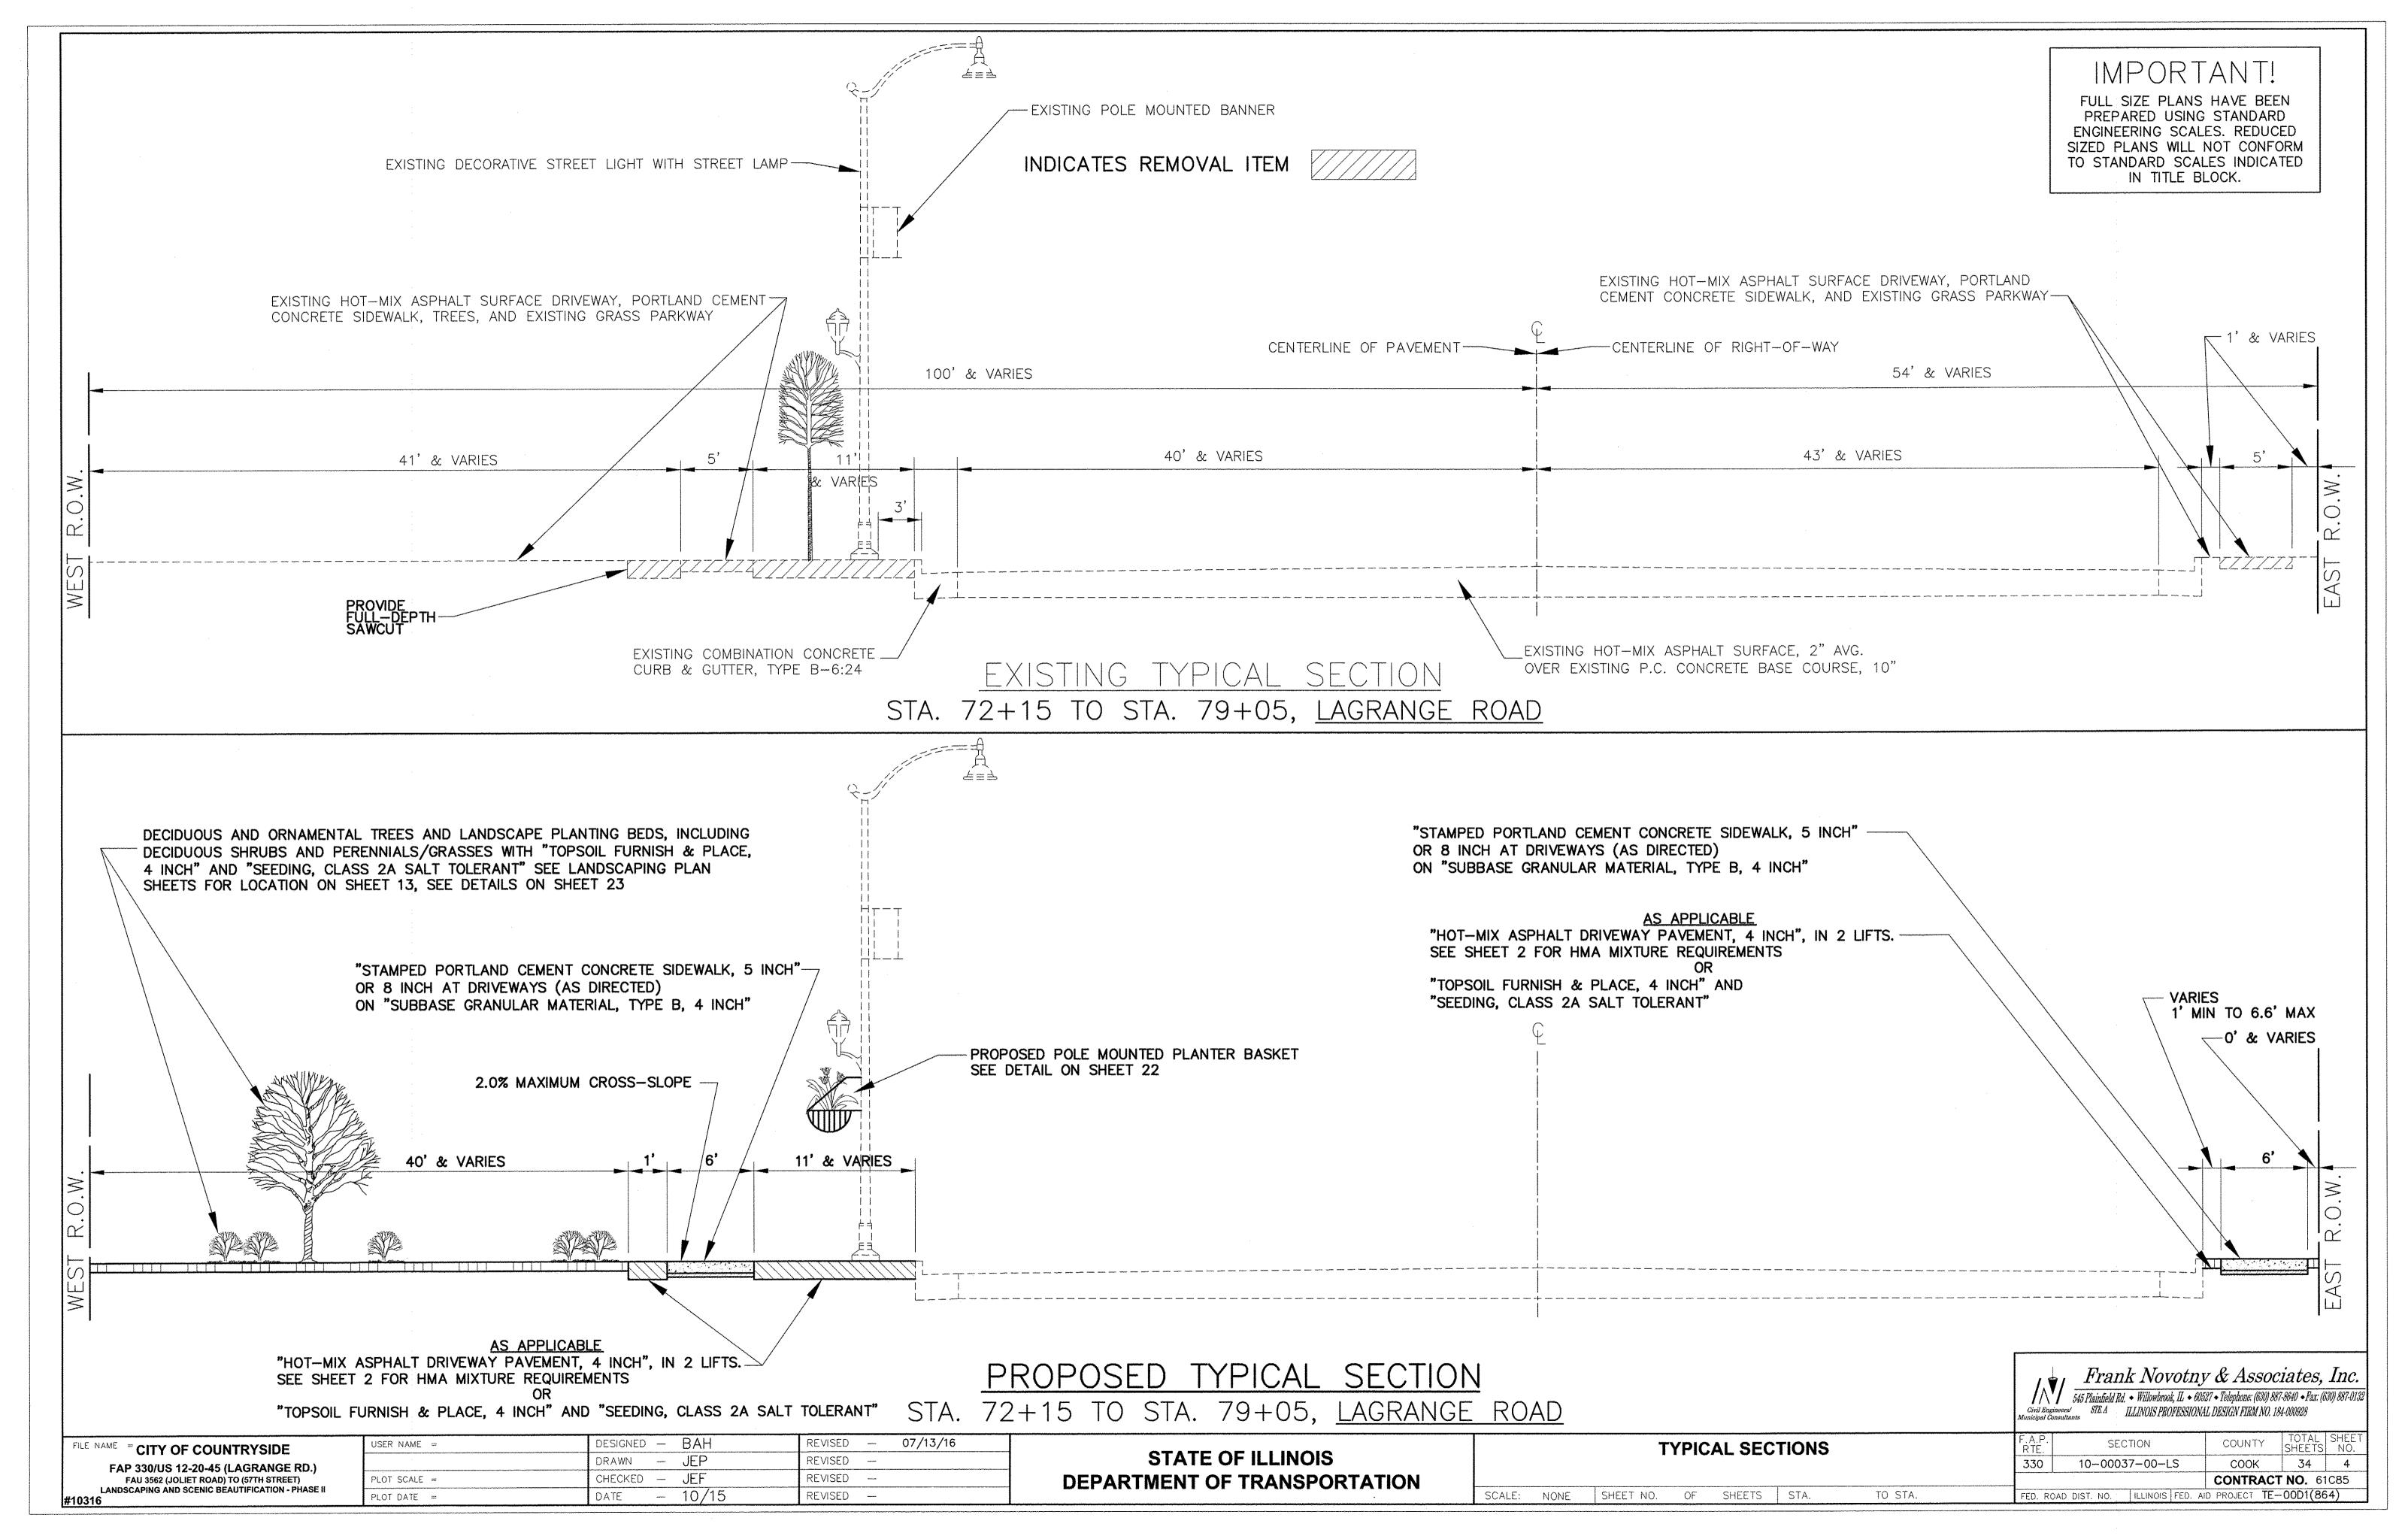


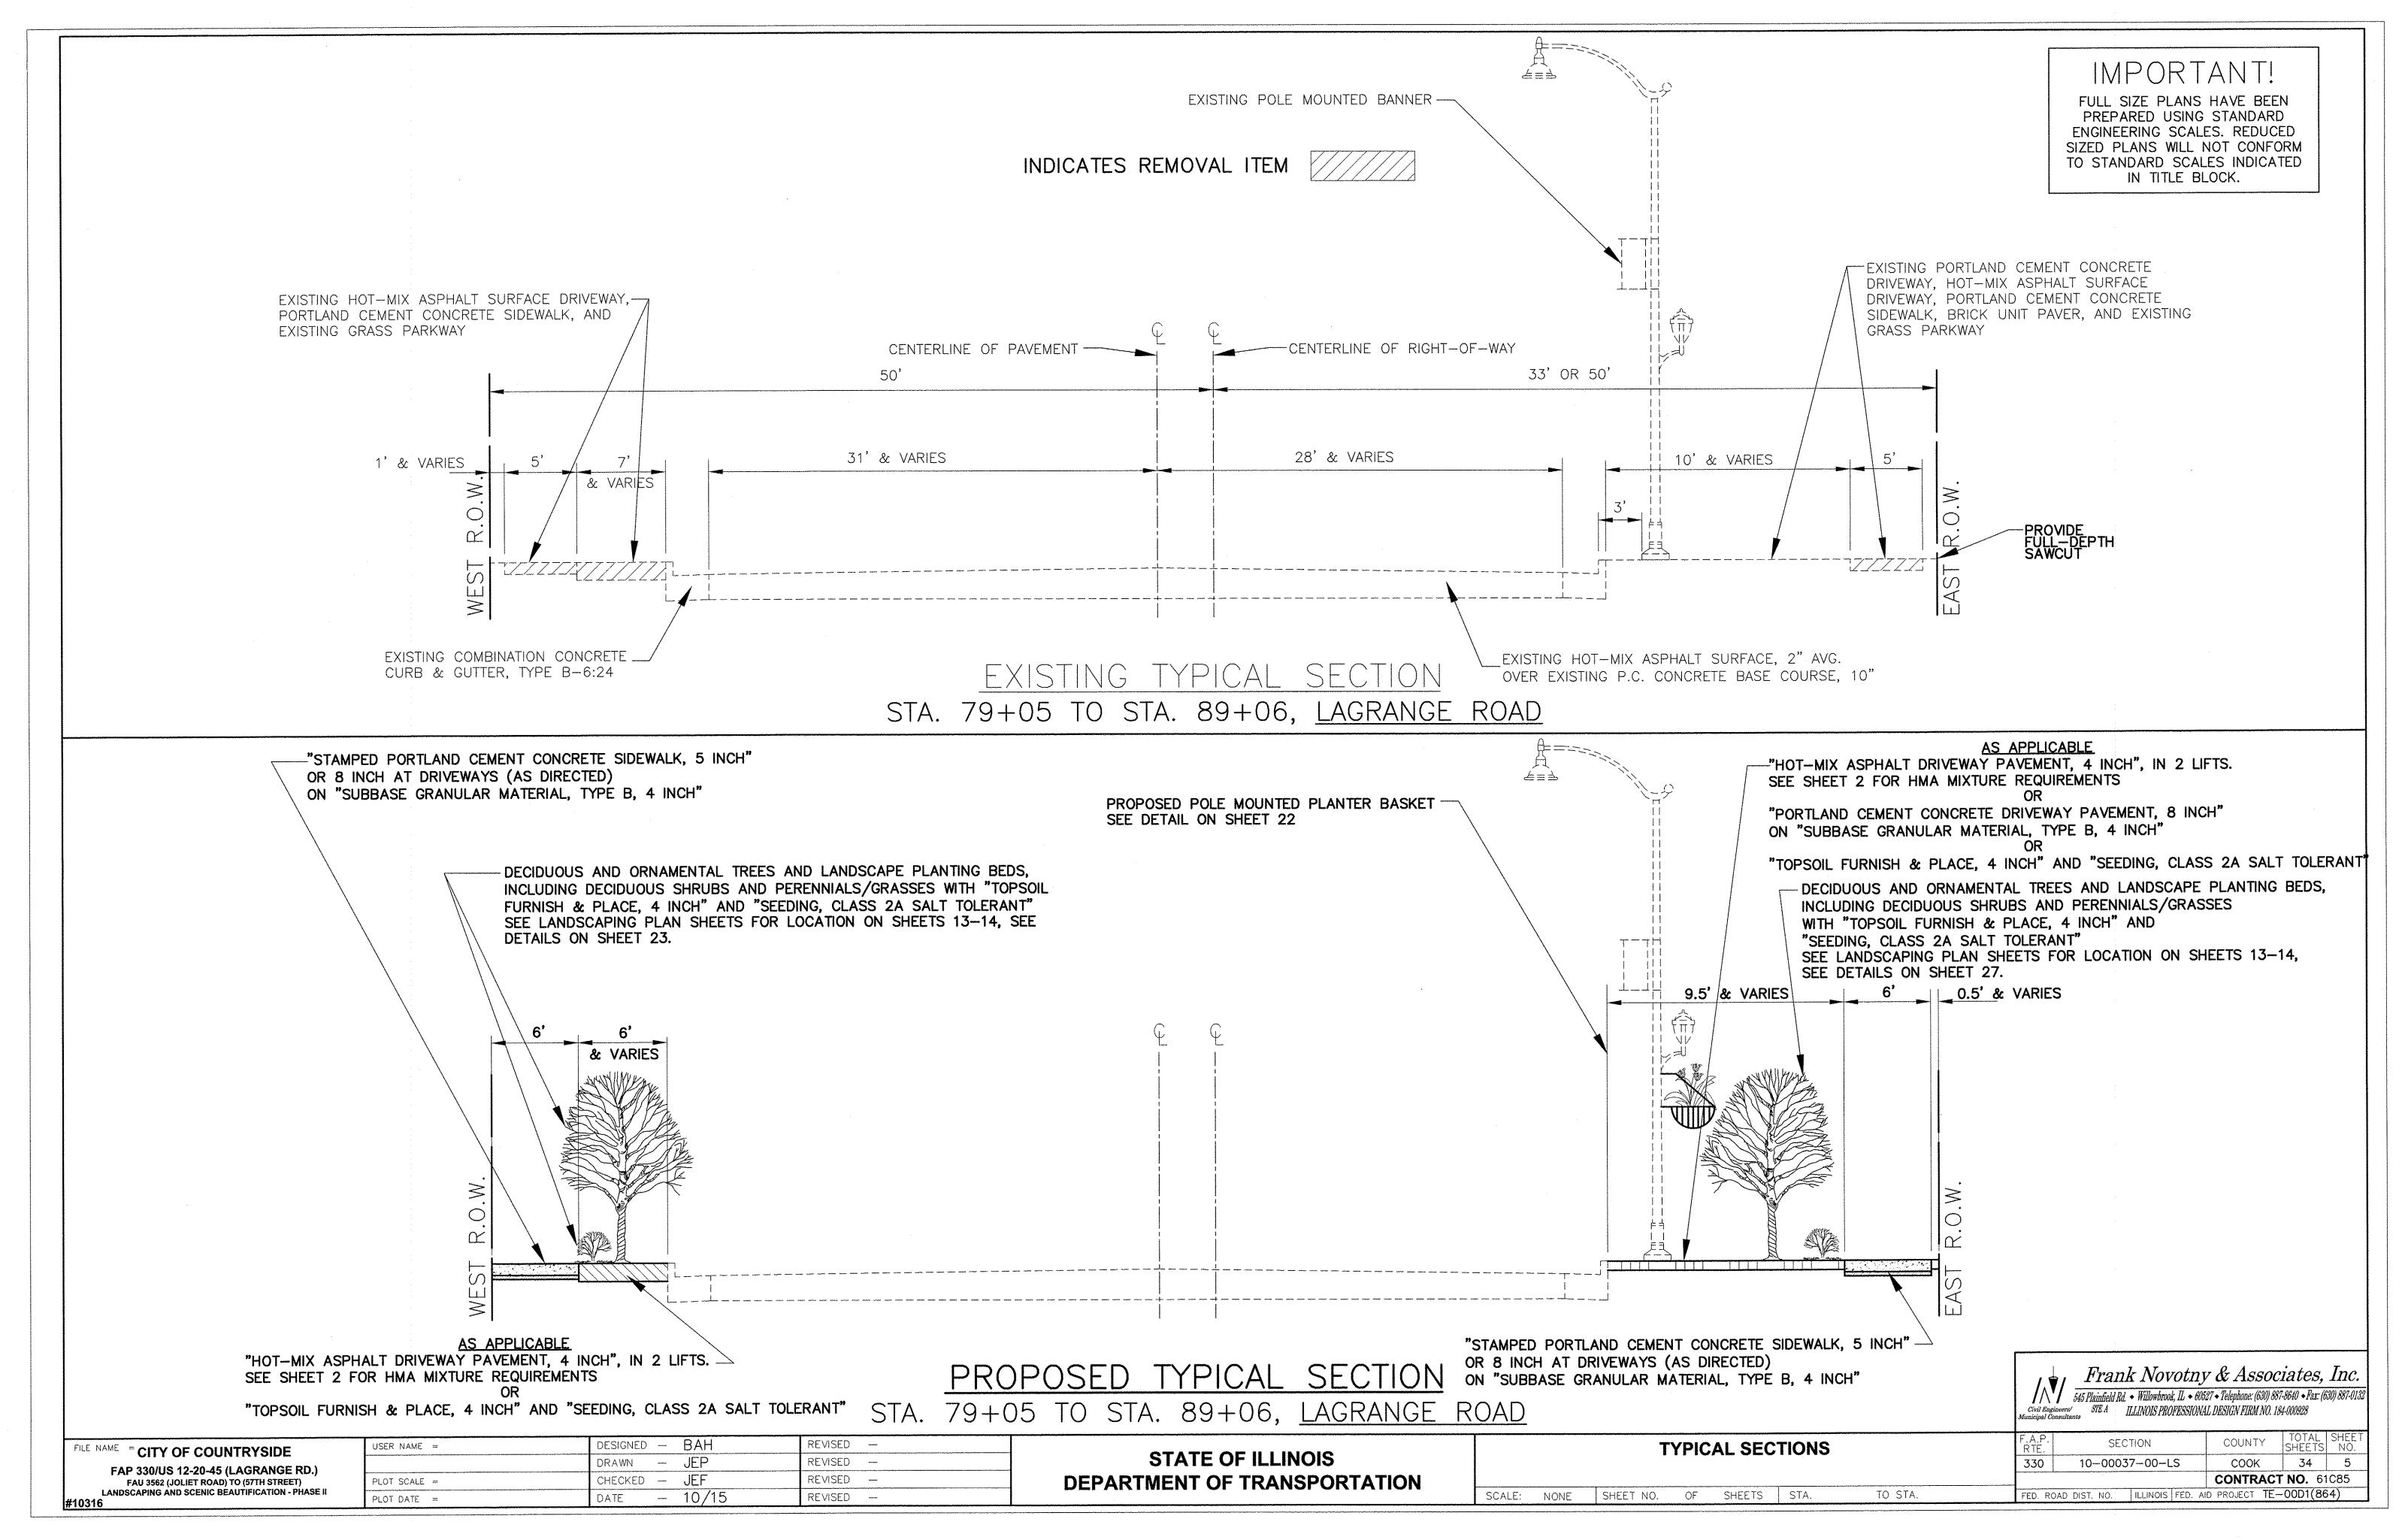


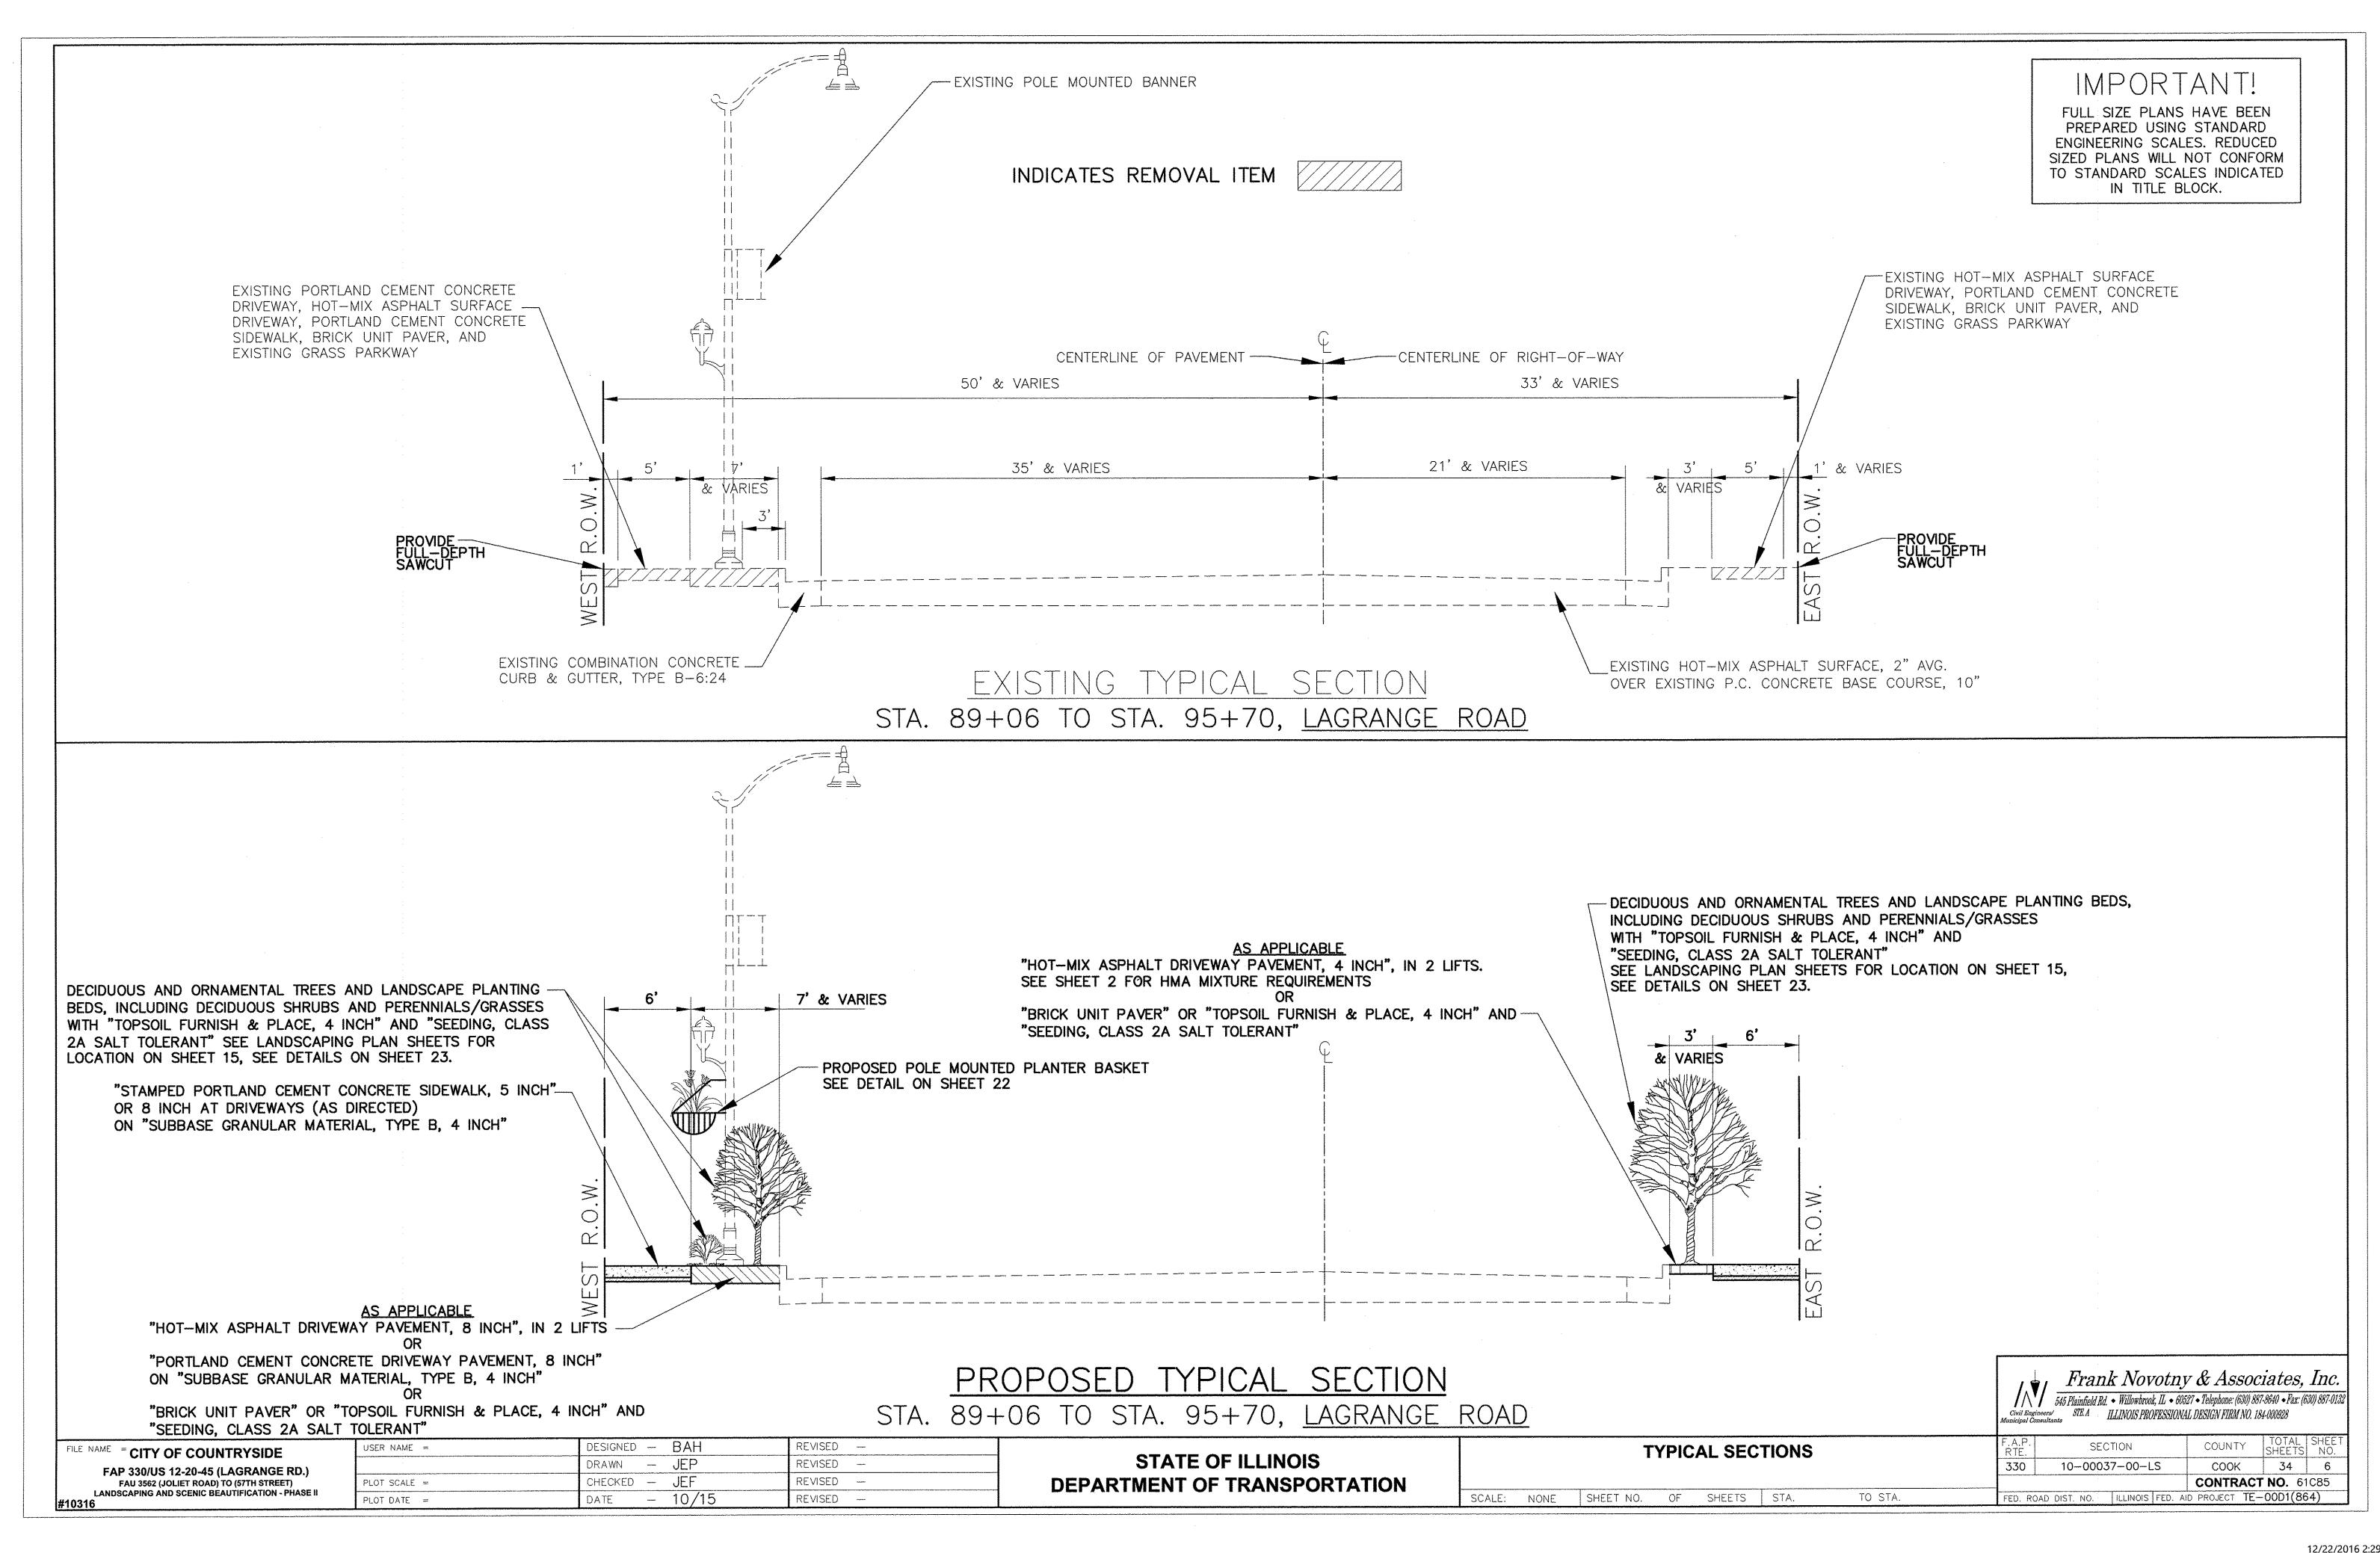

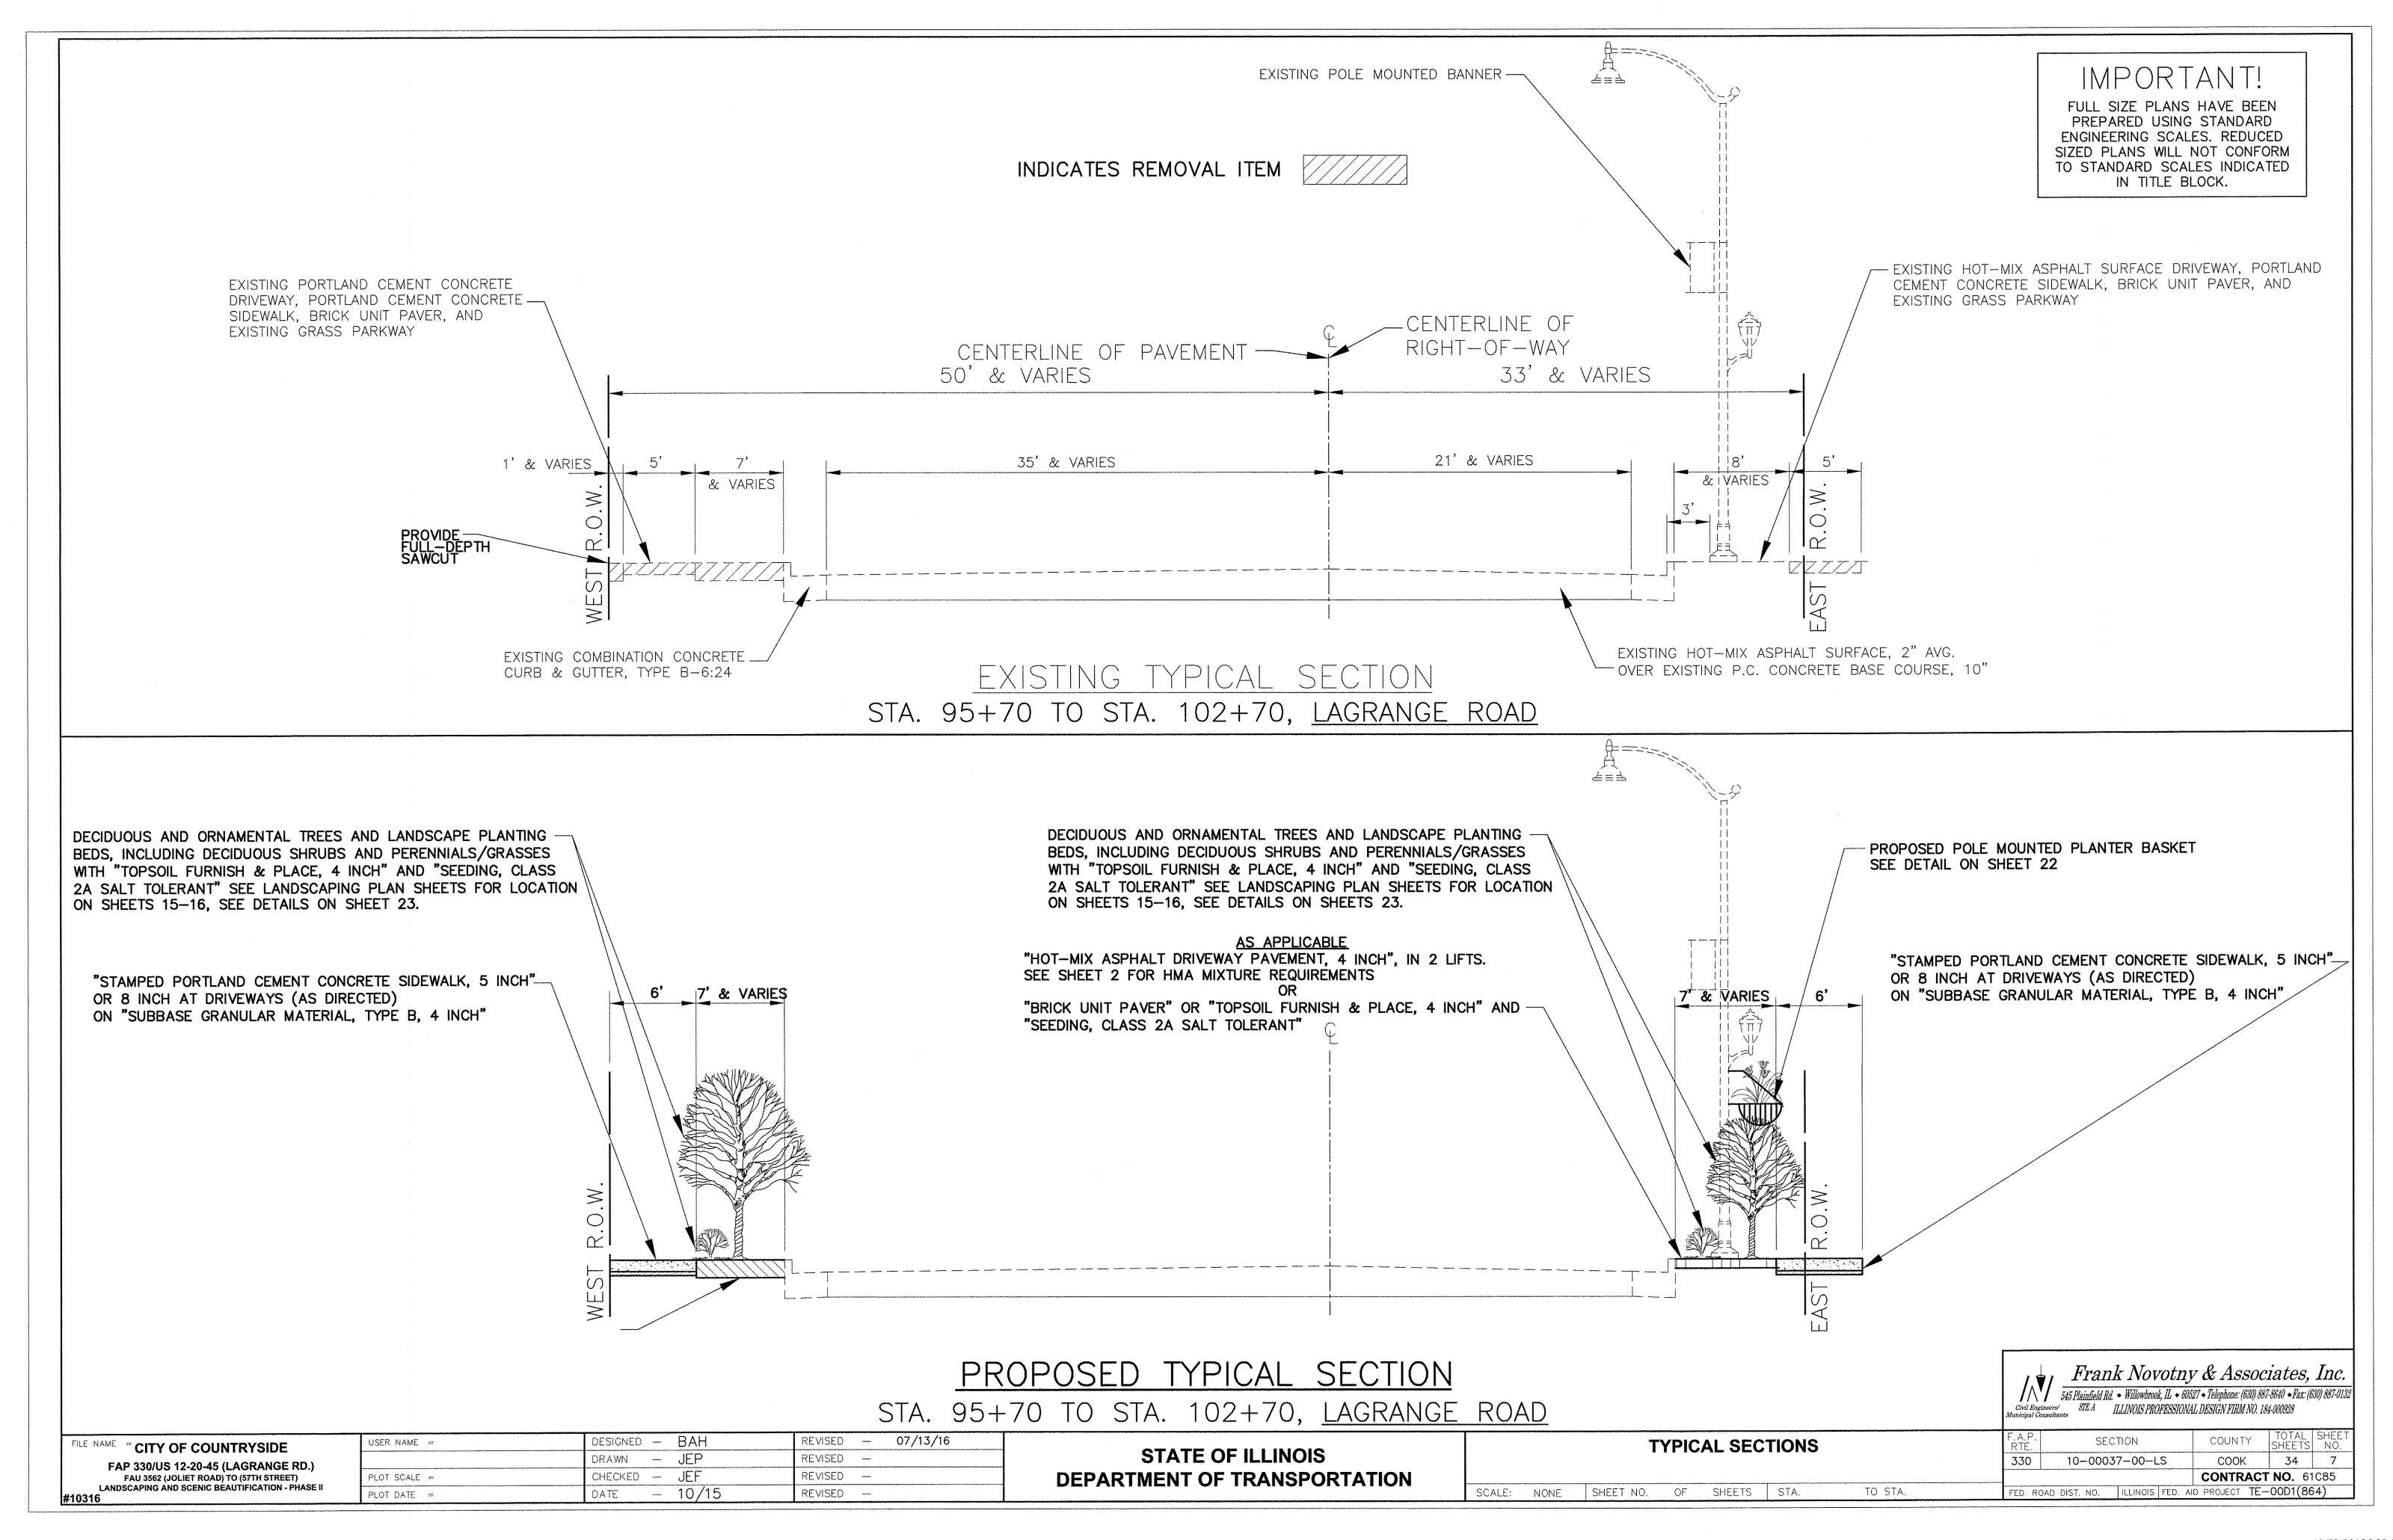

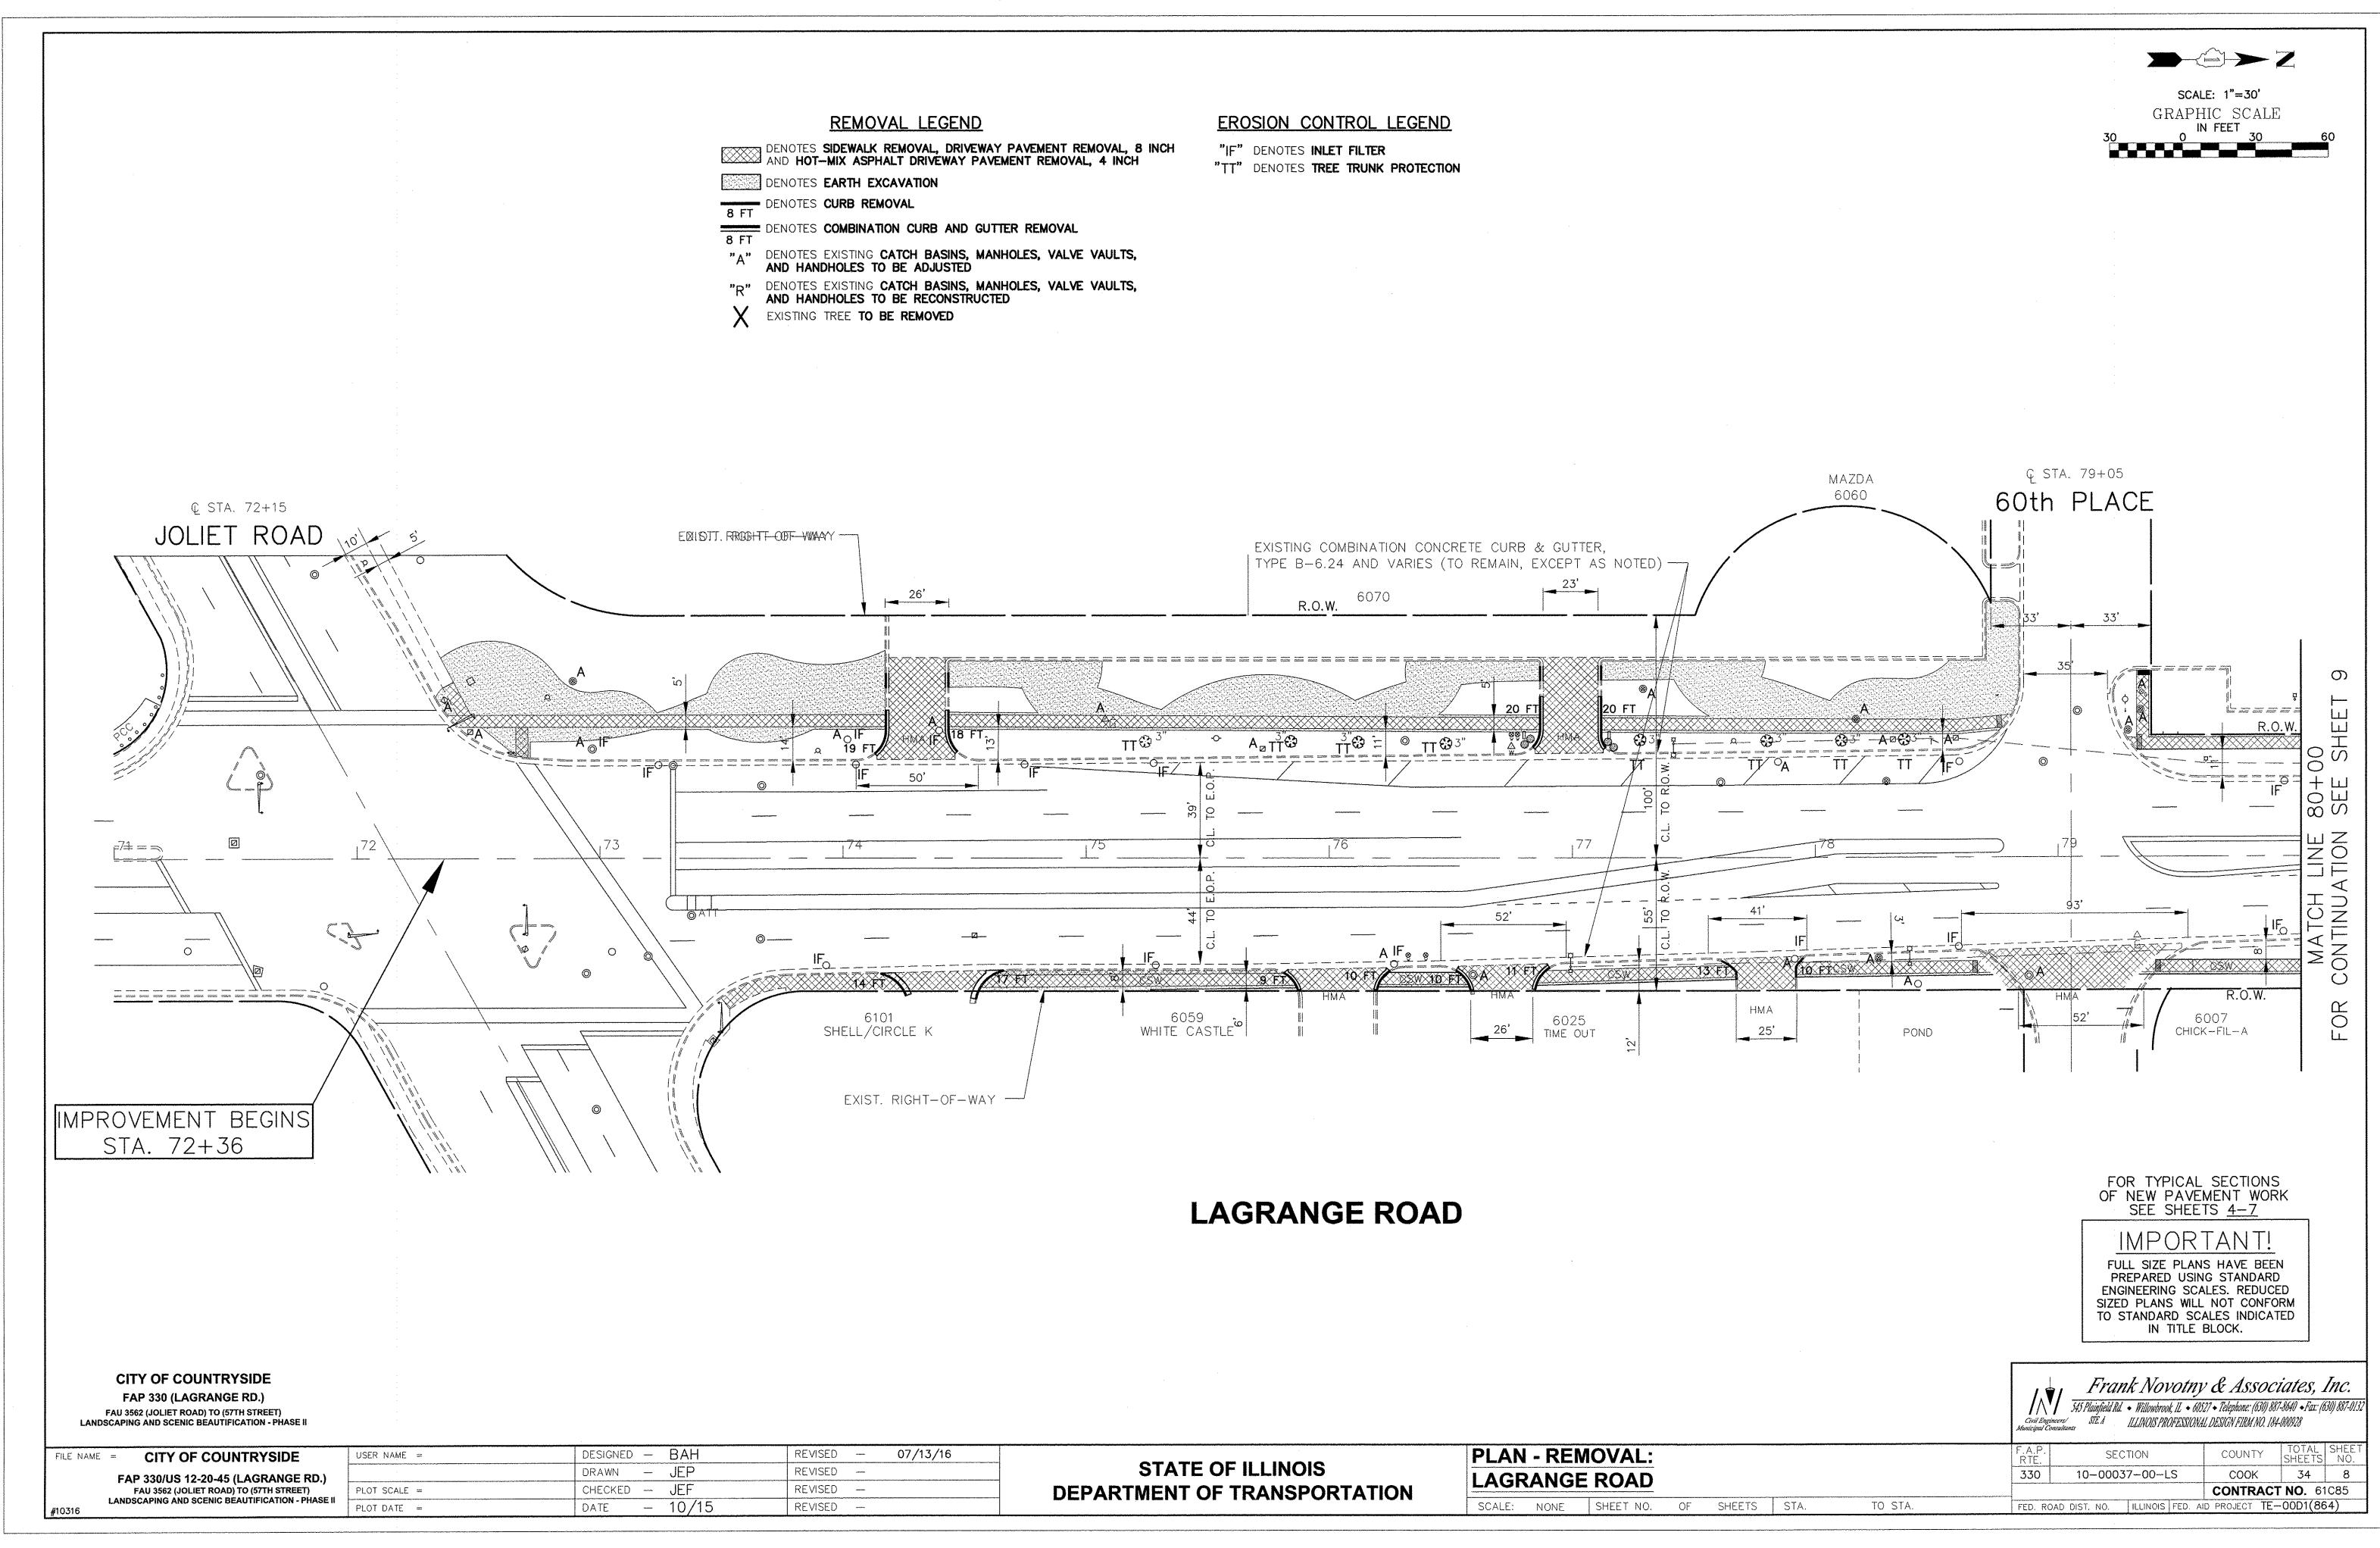

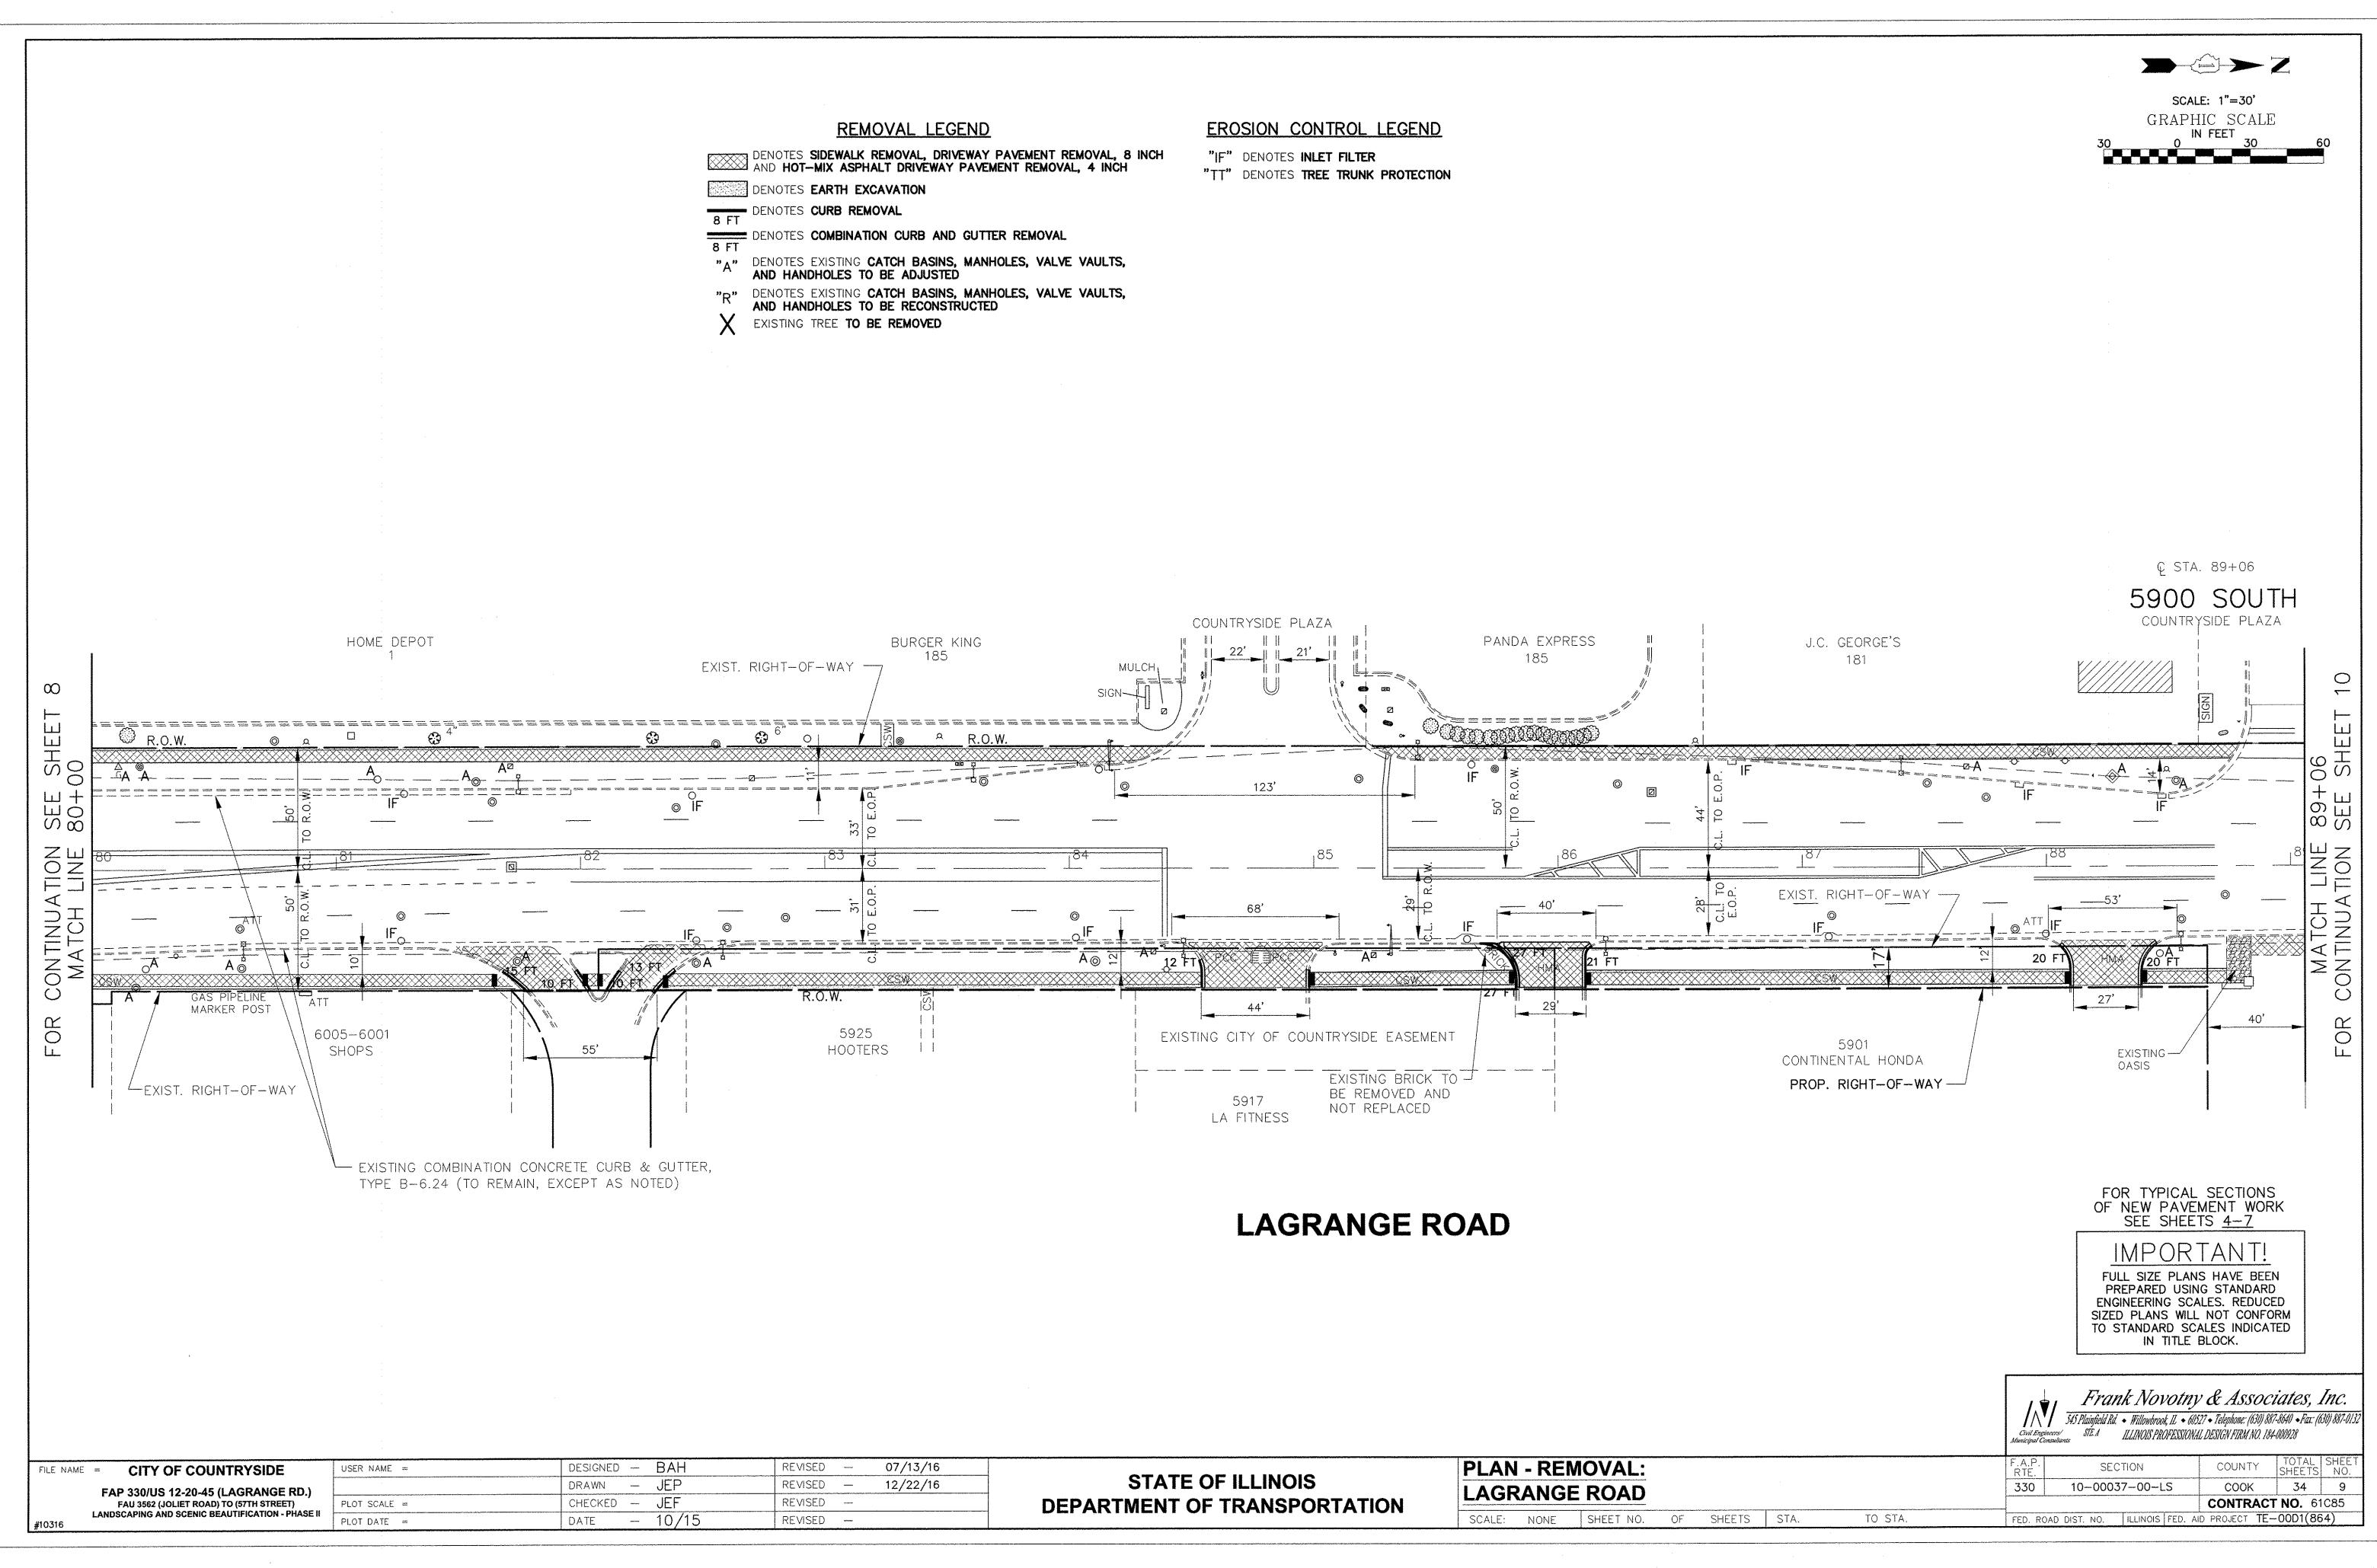

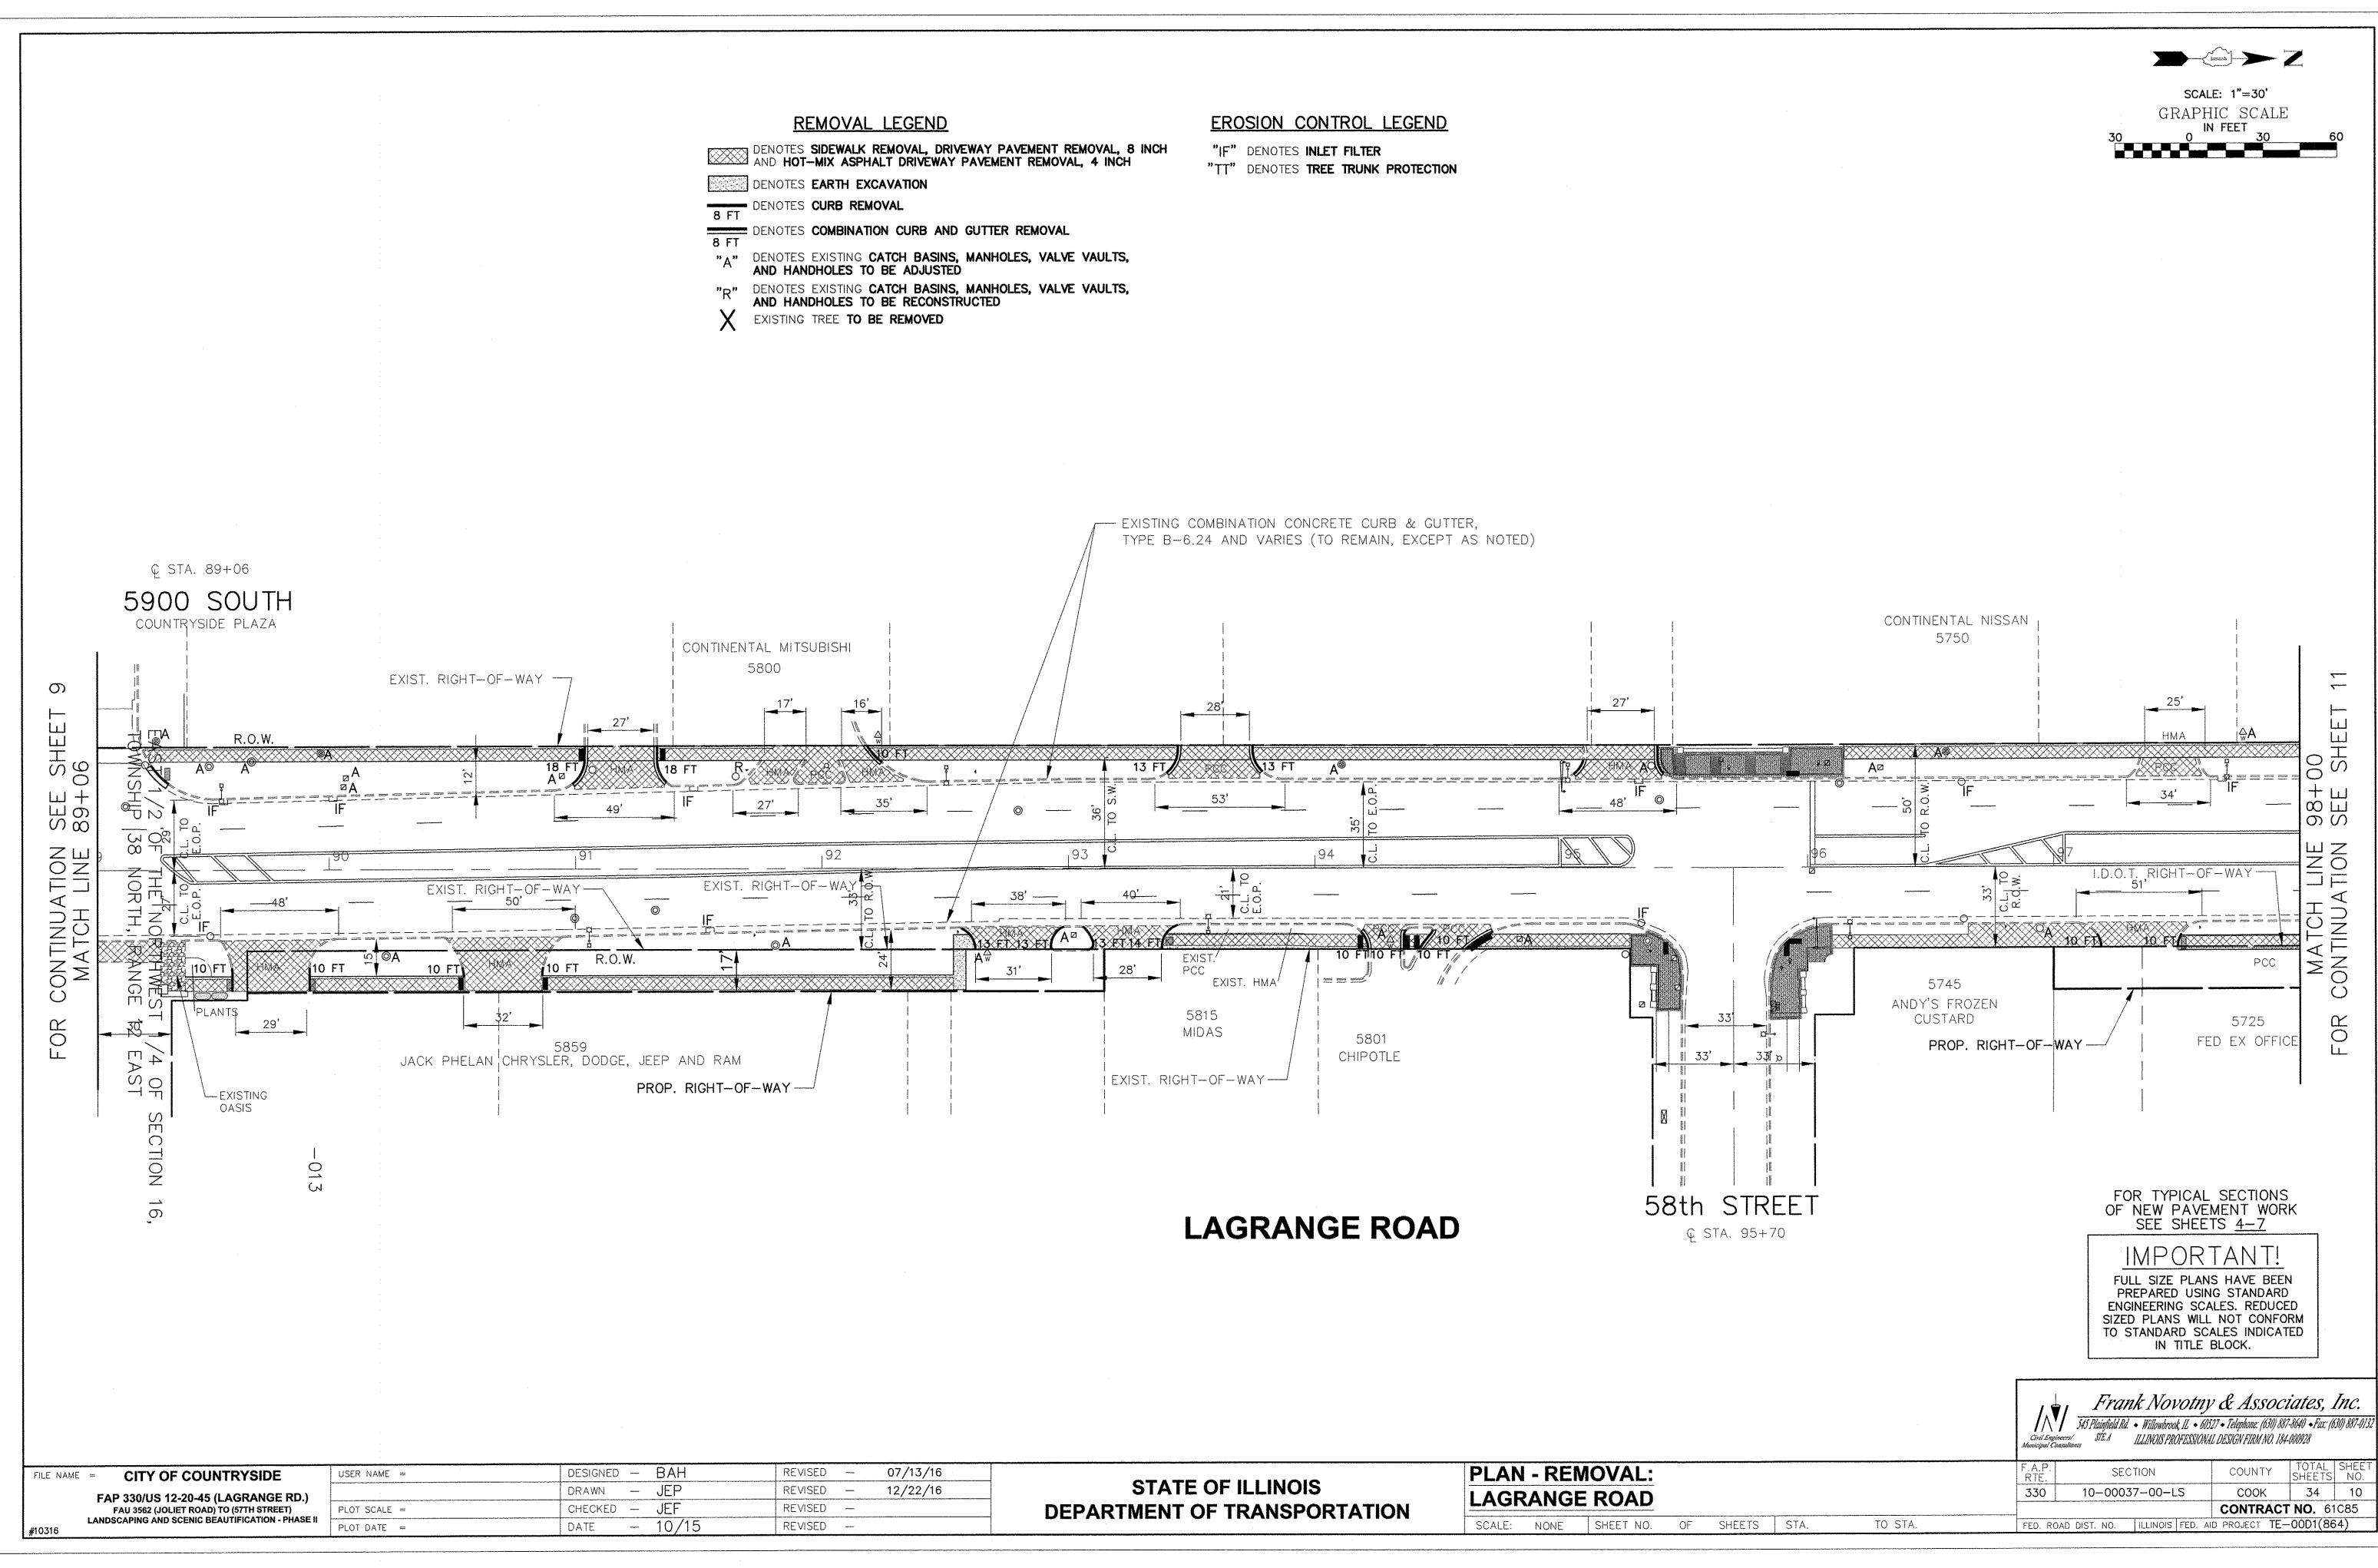

REMOVAL LEGEND

DENOTES SIDEWALK REMOVAL, DRIVEWAY PAVEMENT REMOVAL, 8 INCH AND HOT-MIX ASPHALT DRIVEWAY PAVEMENT REMOVAL, 4 INCH

DENOTES EARTH EXCAVATION

8 FT DENOTES CURB REMOVAL

- 10*/*15

REVISED

DATE

DENOTES COMBINATION CURB AND GUTTER REMOVAL

"A" DENOTES EXISTING CATCH BASINS, MANHOLES, VALVE VAULTS, AND HANDHOLES TO BE ADJUSTED


"R" DENOTES EXISTING CATCH BASINS, MANHOLES, VALVE VAULTS, AND HANDHOLES TO BE RECONSTRUCTED

EXISTING TREE TO BE REMOVED

EROSION CONTROL LEGEND

"IF" DENOTES INLET FILTER "TT" DENOTES TREE TRUNK PROTECTION

SCALE: 1"=30' GRAPHIC SCALE

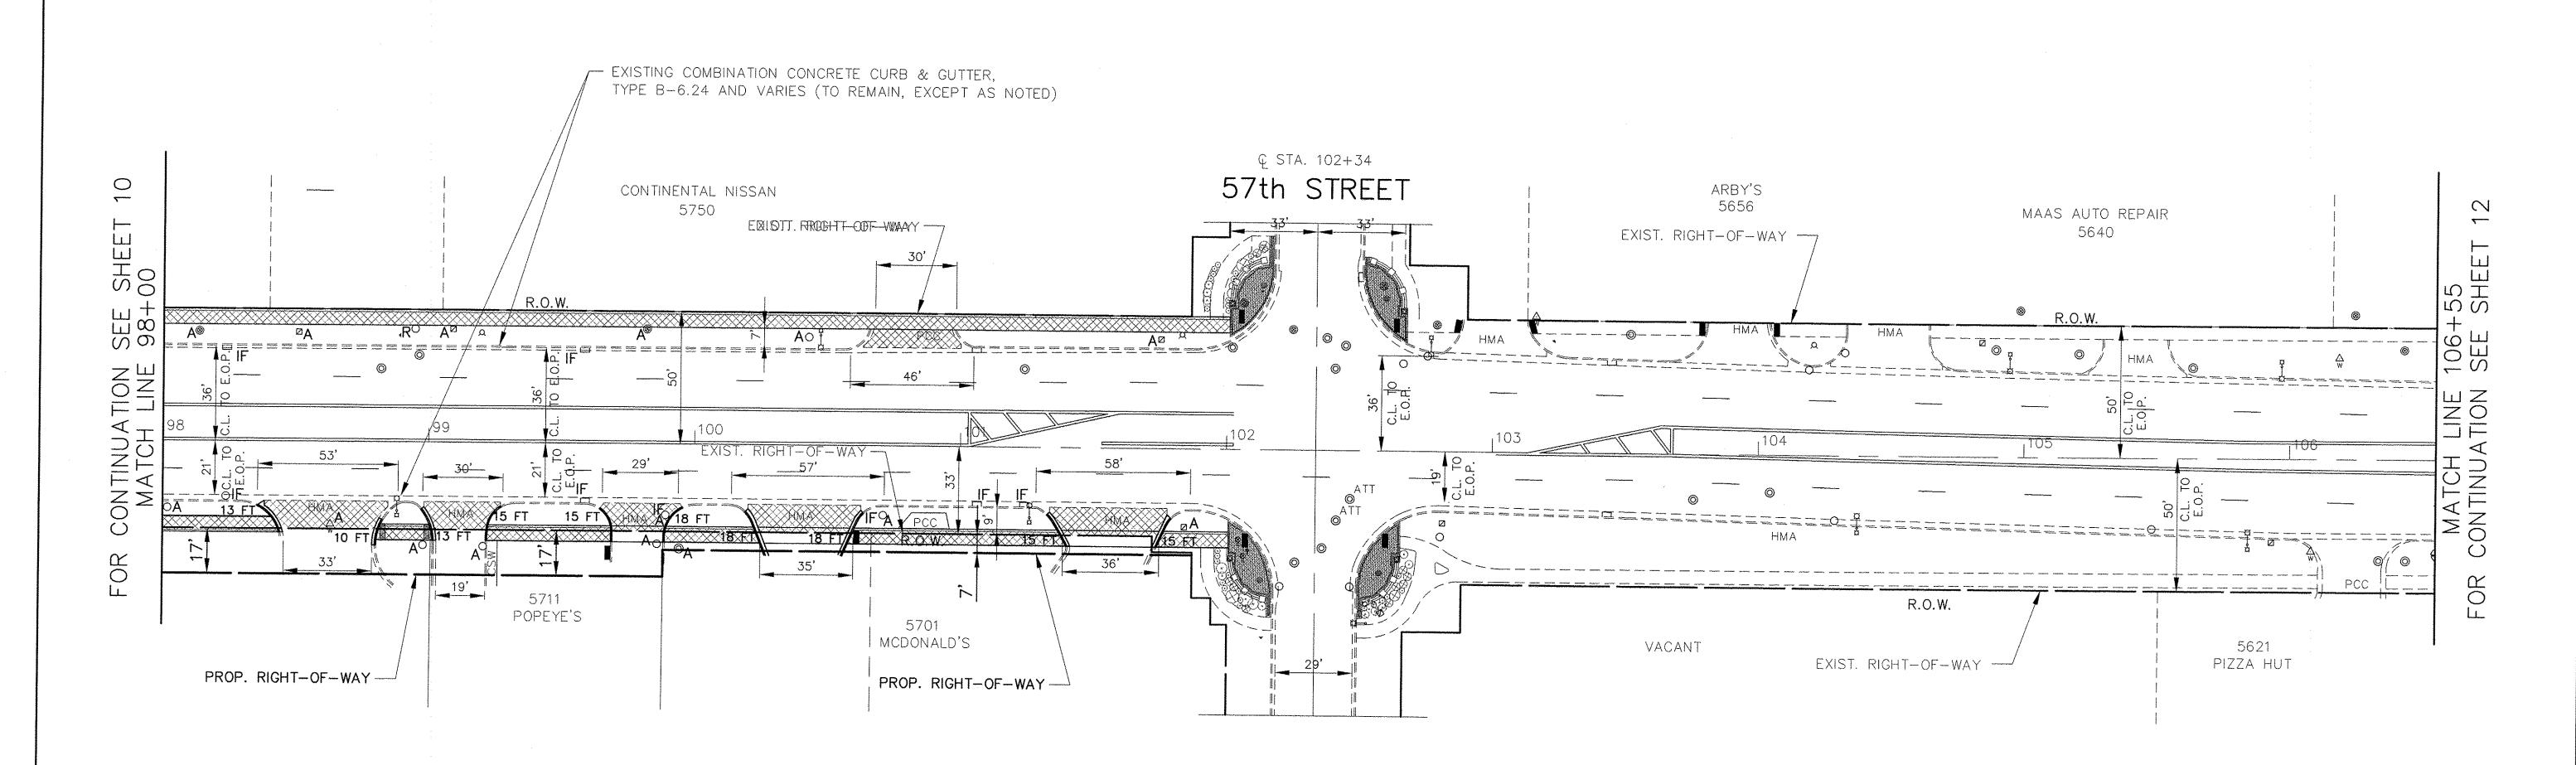

LAGRANGE ROAD

SCALE: NONE SHEET NO.

OF SHEETS STA.

TO STA.

FOR TYPICAL SECTIONS
OF NEW PAVEMENT WORK
SEE SHEETS 4-7

FULL SIZE PLANS HAVE BEEN PREPARED USING STANDARD ENGINEERING SCALES. REDUCED SIZED PLANS WILL NOT CONFORM TO STANDARD SCALES INDICATED IN TITLE BLOCK.

	: - :					Frank Novotny & Associates, Inc. 545 Plainfield Rd. • Willowbrook, IL • 60527 • Telephone: (630) 887-8640 • Fax: (630) 887-0132 Civil Engineers/ Municipal Consultants STE. A ILLINOIS PROFESSIONAL DESIGN FIRM NO. 184-000928
FILE NAME = CITY OF COUNTRYSIDE	USER NAME =	DESIGNED - BAH	REVISED — 07/13/16			
FAP 330/US 12-20-45 (LAGRANGE RD.)		DRAWN - JEP	REVISED - 12/22/16	STATE OF ILLINOIS	PLAN - REMOVAL:	F.A.P. SECTION COUNTY TOTAL SHEET
FAU 3562 (JOLIET ROAD) TO (57TH STREET) LANDSCAPING AND SCENIC BEAUTIFICATION - PHASE II	PLOT SCALE =	CHECKED — JEF	REVISED —	· · · · · · · · · · · · · · · · · · ·	LAGRANGE ROAD	330 10-00037-00-LS COOK 34 11
#10316	PLOT DATE =	DATE - 10/15	REVISED —	DEPARTMENT OF TRANSPORTATION		CONTRACT NO 61085

45 Plainfield Rd. • Willowbrook, II. • 60527 • Telephone: (630) 887-8640 • Fax: (630) 887-0132 STE. A ILLINOIS PROFESSIONAL DESIGN FIRM NO. 184-000928 SECTION 10-00037-00-LS COOK 34 11 CONTRACT NO. 61C85 FED. ROAD DIST. NO. ILLINOIS FED. AID PROJECT TE-00D1(864)

SCALE: 1"=30' GRAPHIC SCALE REMOVAL LEGEND EROSION CONTROL LEGEND DENOTES SIDEWALK REMOVAL, DRIVEWAY PAVEMENT REMOVAL, 8 INCH AND HOT-MIX ASPHALT DRIVEWAY PAVEMENT REMOVAL, 4 INCH "IF" DENOTES INLET FILTER "TT" DENOTES TREE TRUNK PROTECTION DENOTES EARTH EXCAVATION 8 FT DENOTES CURB REMOVAL DENOTES COMBINATION CURB AND GUTTER REMOVAL "A" DENOTES EXISTING CATCH BASINS, MANHOLES, VALVE VAULTS, AND HANDHOLES TO BE ADJUSTED "R" DENOTES EXISTING CATCH BASINS, MANHOLES, VALVE VAULTS, AND HANDHOLES TO BE RECONSTRUCTED EXISTING TREE TO BE REMOVED IMPROVEMENT ENDS STA. 108+31 EXISTING COMBINATION CONCRETE CURB & GUTTER, G STA. 115+63 TYPE B-6.24 (TO REMAIN, EXCEPT AS NOTED) 55th STREET Ç STA. 108+98 56th STREET FIRESTONE JIFFY LUBE STRIP MALL ENTERPRISE RENT-A-CAR DUNKIN DONUTS 5600 5550 5542 5532 5528 5502 5500 EXIST. RIGHT-OF-WAY Ш SH 55 DRAIN HMA PARKING _____CSW______ SO O ONTII MAT(\circ FOR PCC HMA | 5611 5525 5505 DISCOUNT TIRES 5501 5503 TACO BELL LEDOS MOBIL VACANT OFFICE BLDG. EXIST. RIGHT-OF-WAY -FOR TYPICAL SECTIONS
OF NEW PAVEMENT WORK
SEE SHEETS 4-7 LAGRANGE ROAD IMPORTANT! FULL SIZE PLANS HAVE BEEN
PREPARED USING STANDARD
ENGINEERING SCALES. REDUCED
SIZED PLANS WILL NOT CONFORM TO STANDARD SCALES INDICATED IN TITLE BLOCK. Frank Novotny & Associates, Inc. 545 Plainfield Rd. • Willowbrook, II. • 60527 • Telephone: (630) 887-8640 • Fax: (630) 887-0132 Civil Engineers/ STE. A ILLINOIS PROFESSIONAL DESIGN FIRM NO. 184-00028

Municipal Consultants PLAN - REMOVAL: DESIGNED - BAH REVISED 07/13/16 CITY OF COUNTRYSIDE SECTION COUNTY USER NAME =

STATE OF ILLINOIS

DEPARTMENT OF TRANSPORTATION

LAGRANGE ROAD

SCALE: NONE SHEET NO. OF SHEETS STA.

DRAWN - JEP

CHECKED - JEF

DATE - 10/15

FAP 330/US 12-20-45 (LAGRANGE RD.)

FAU 3562 (JOLIET ROAD) TO (57TH STREET)

LANDSCAPING AND SCENIC BEAUTIFICATION - PHASE II

#10316

PLOT SCALE =

PLOT DATE =

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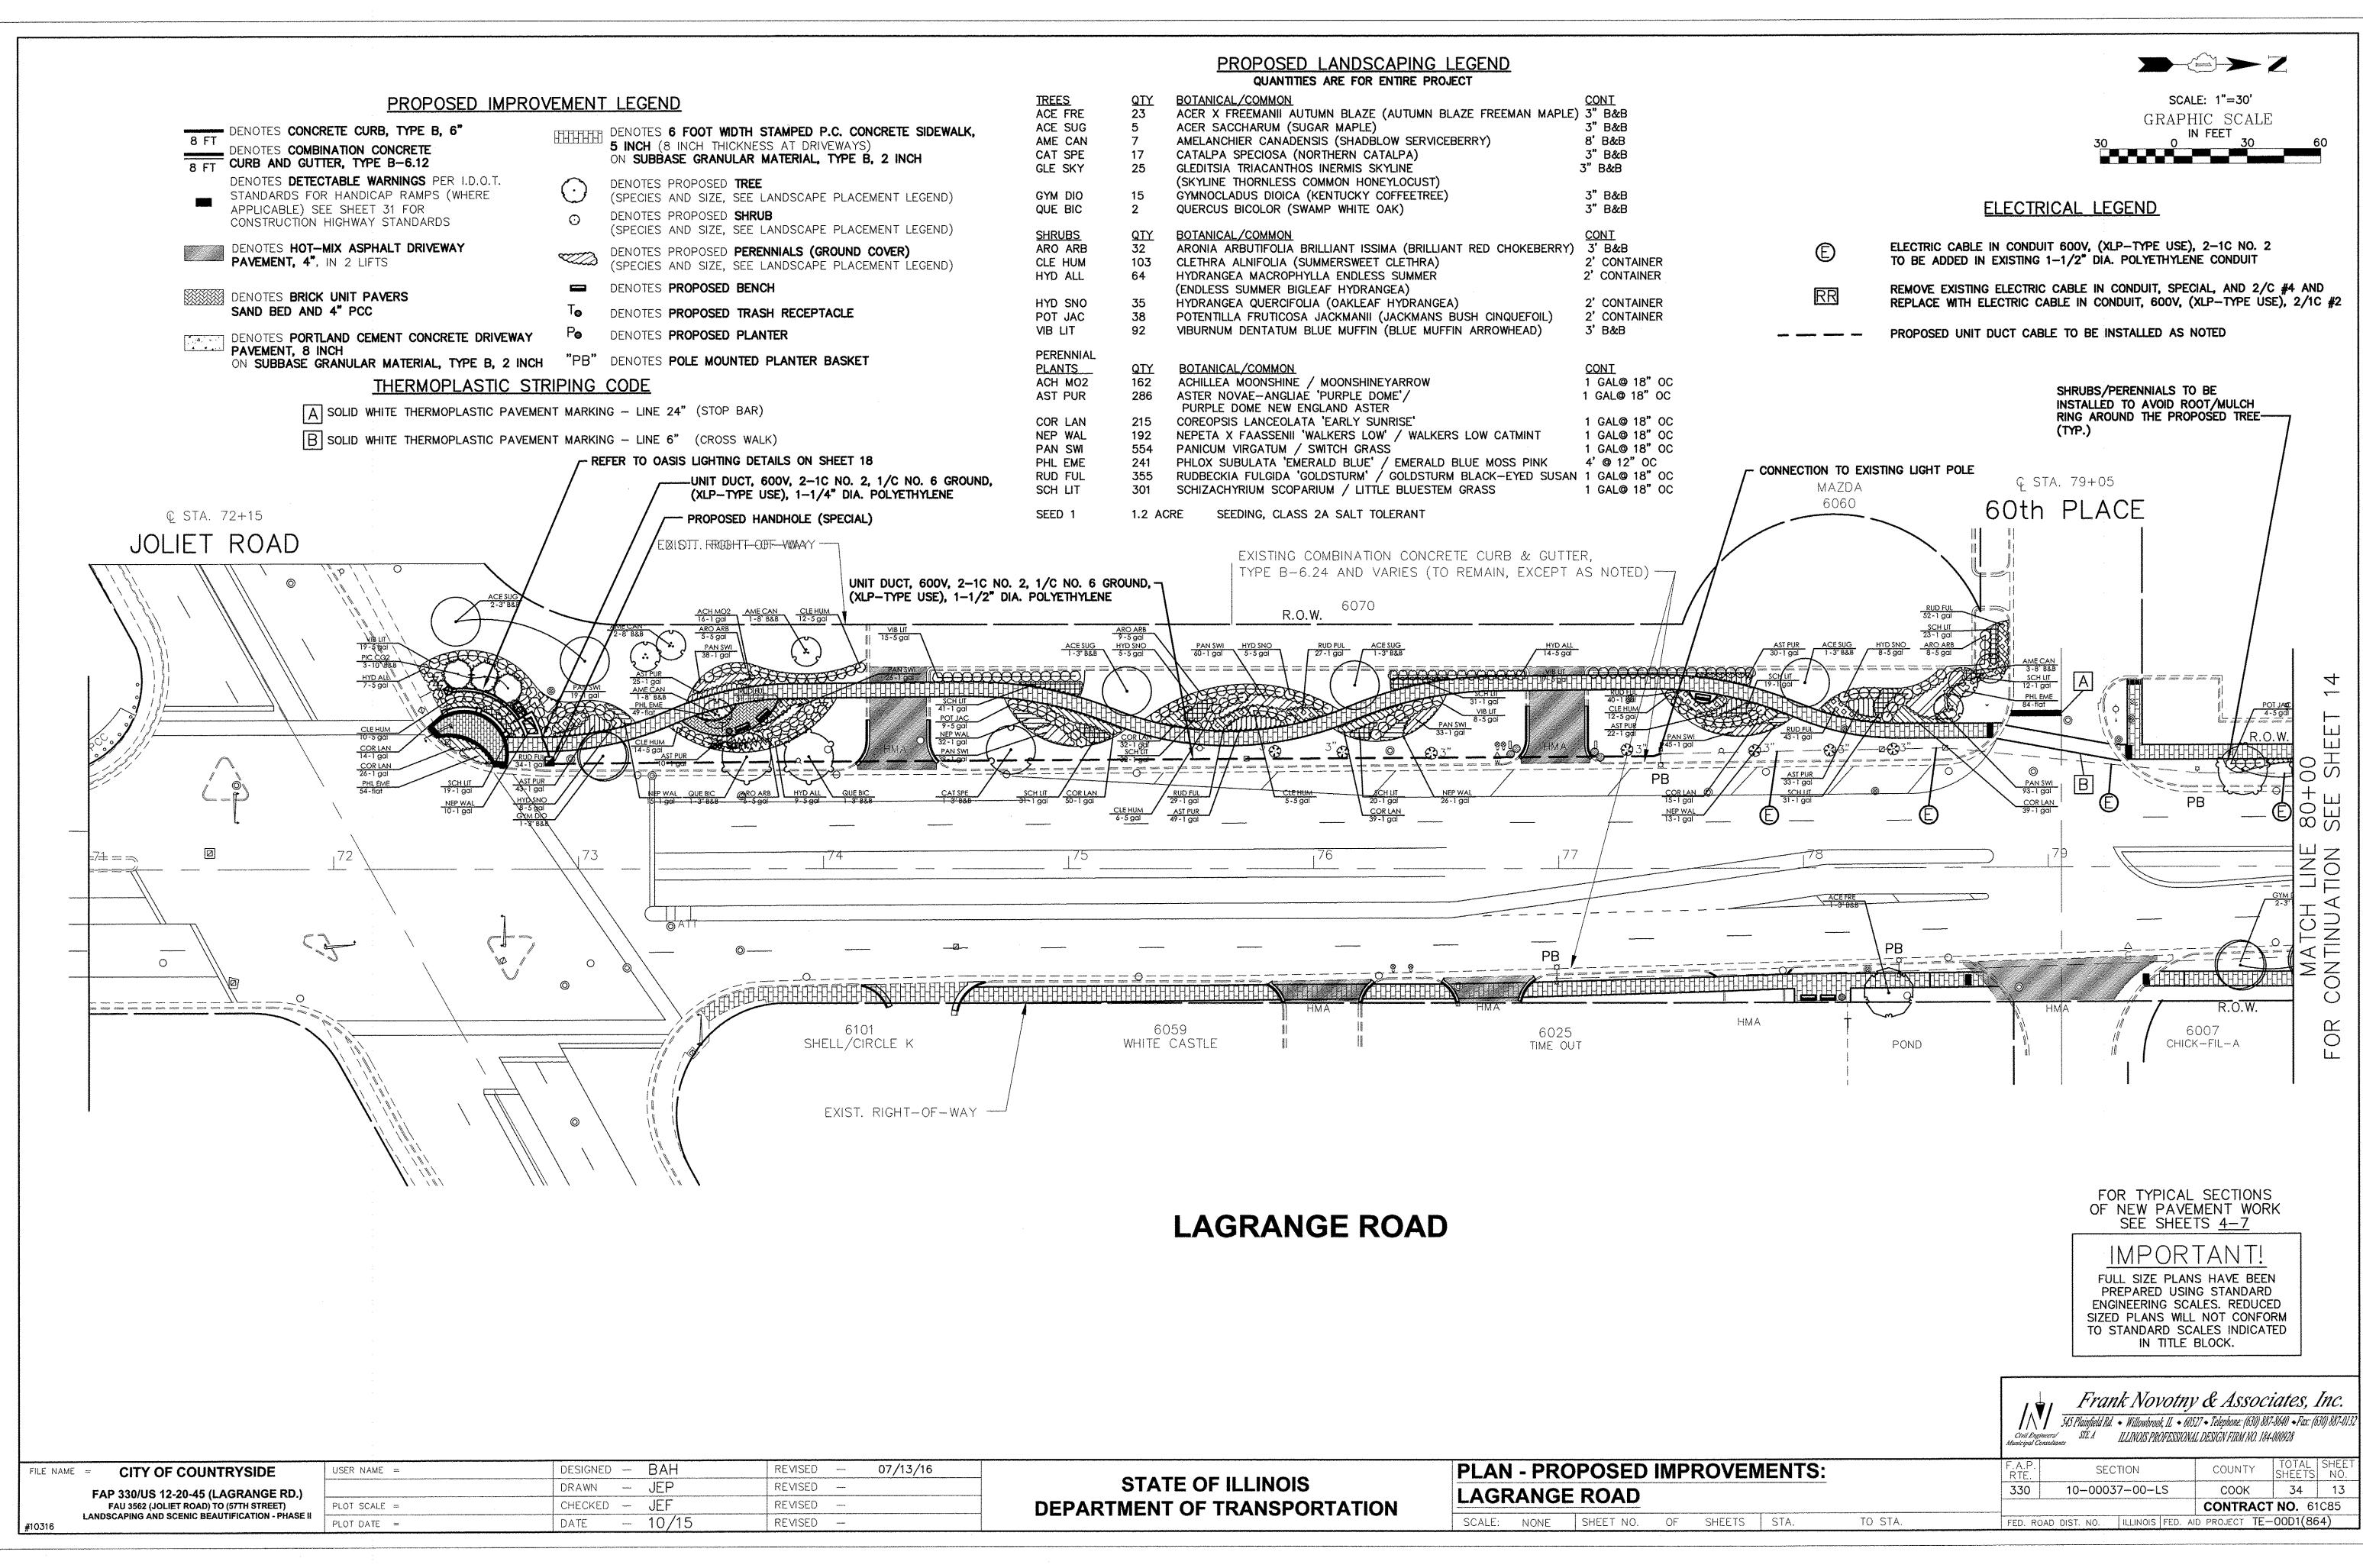
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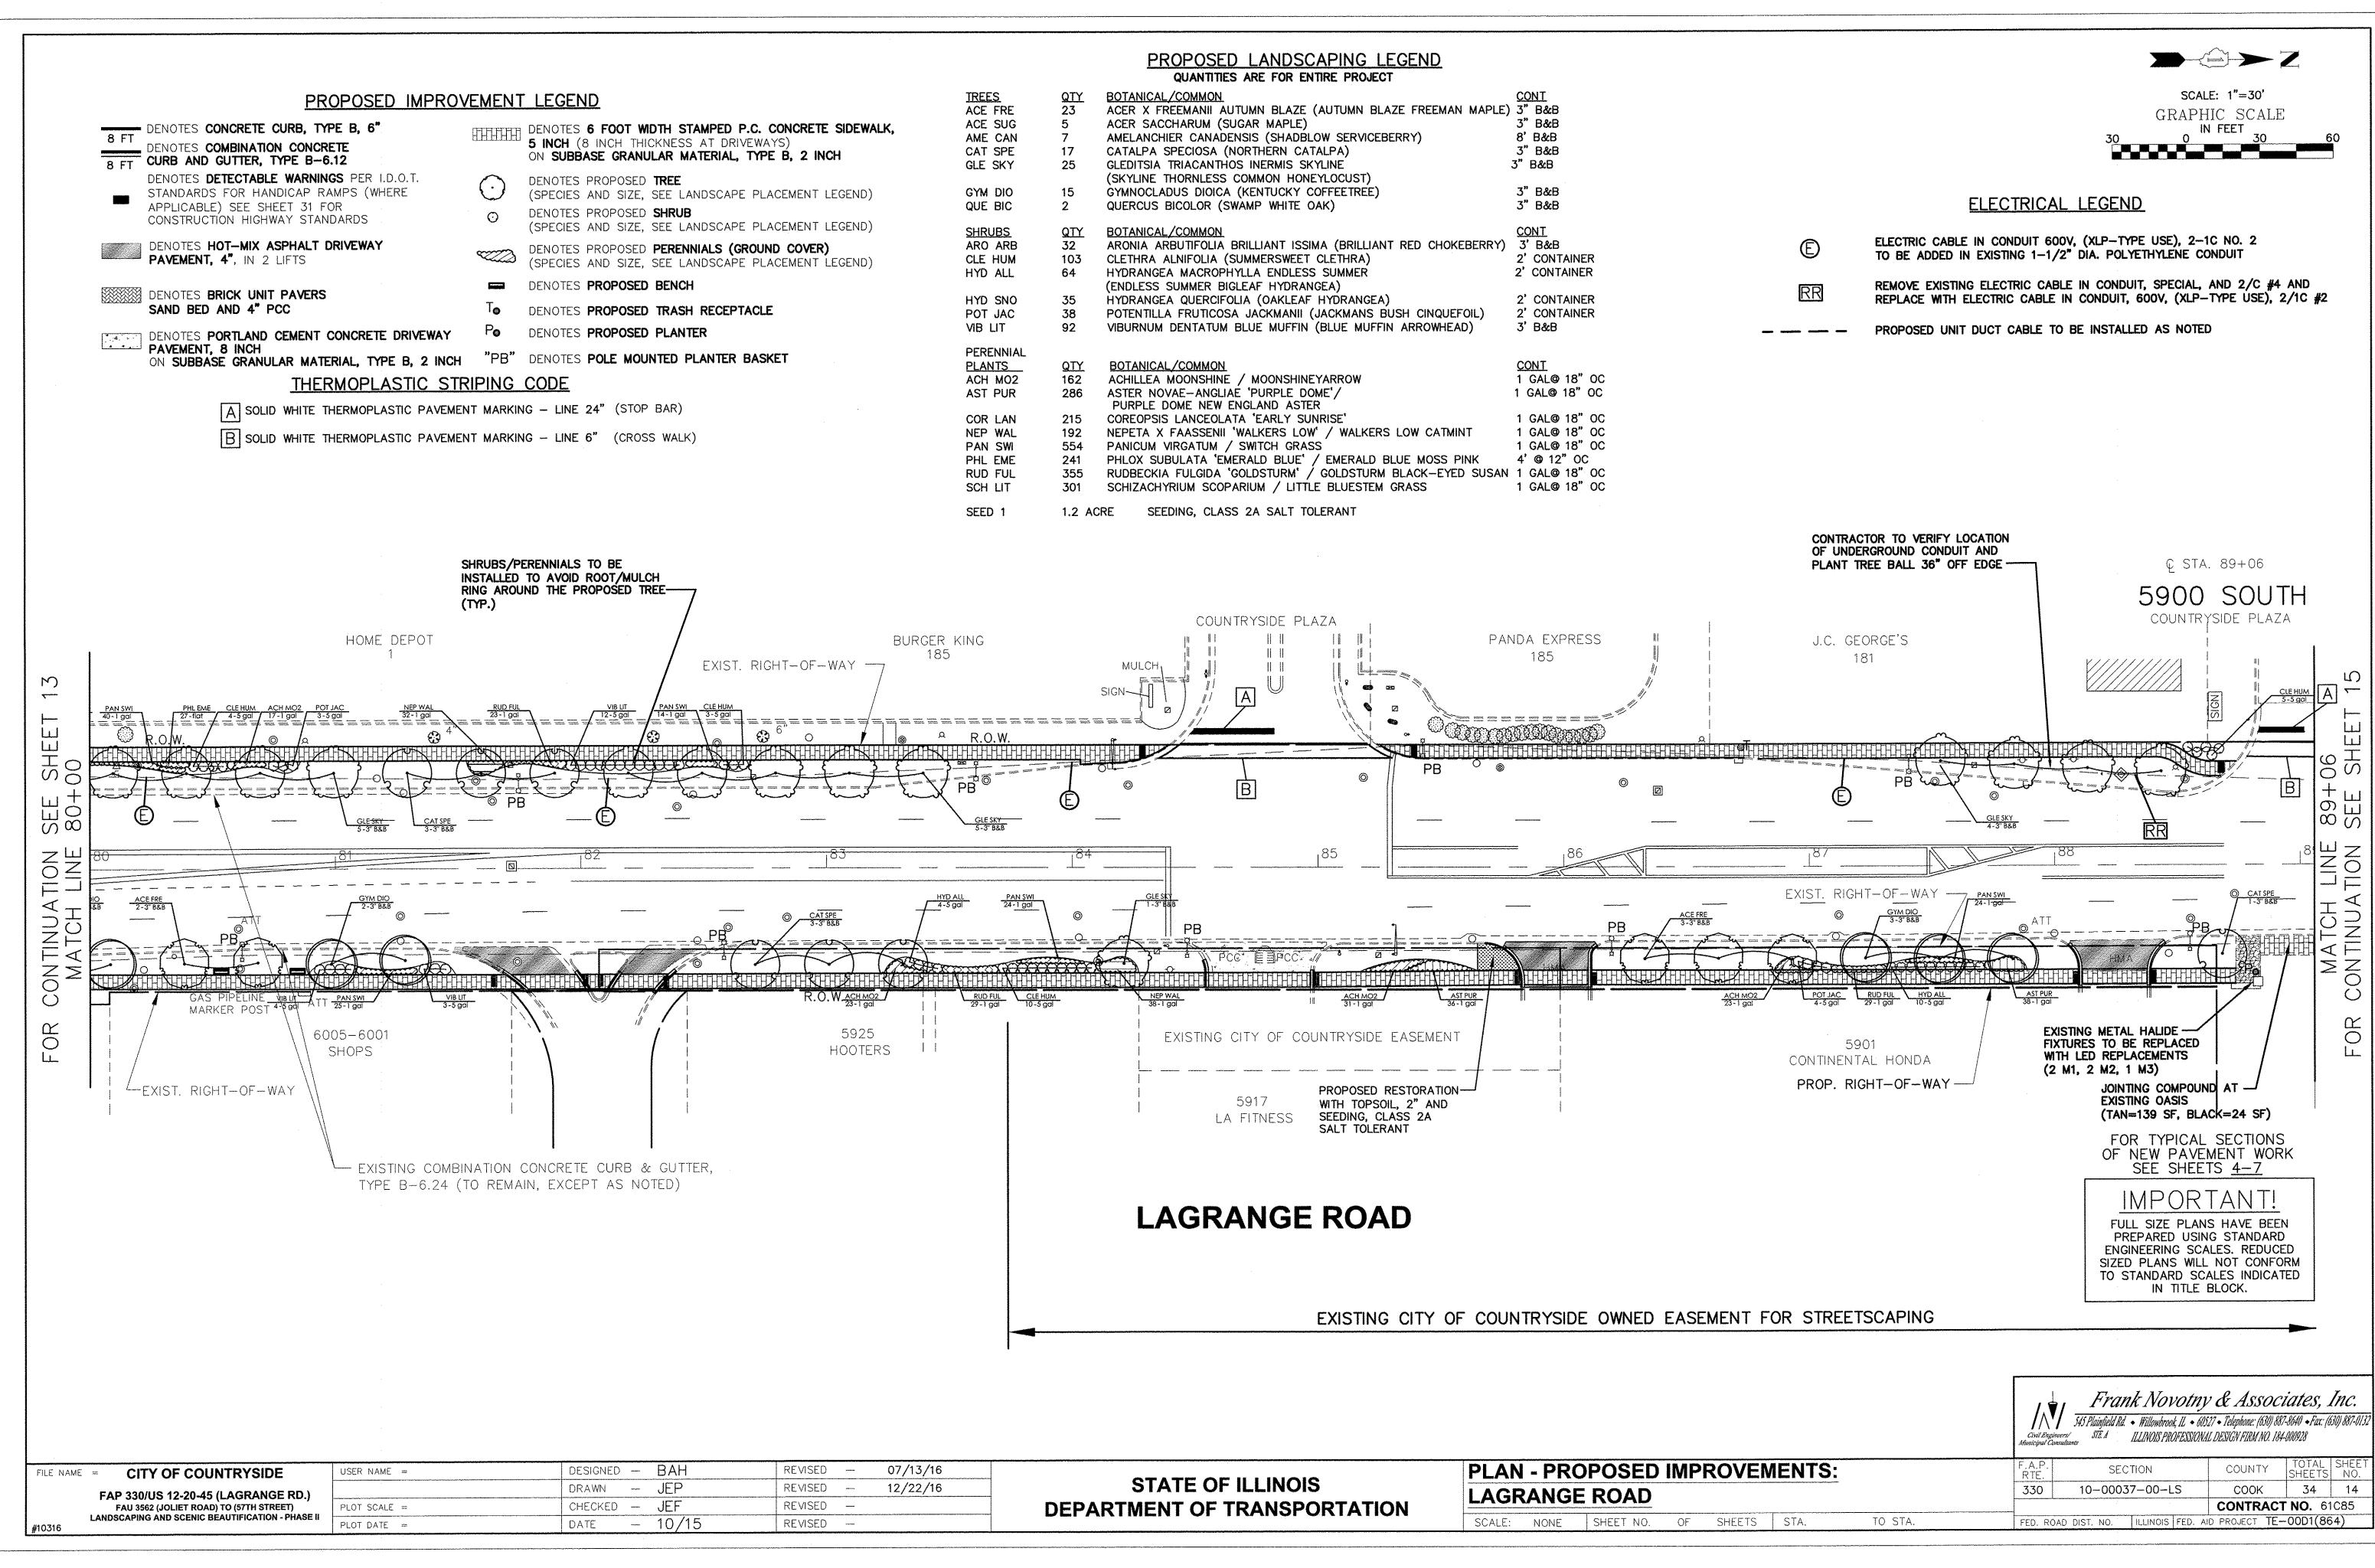
10-00037-00-LS


FED. ROAD DIST. NO. | ILLINOIS | FED. AID PROJECT | TE-00D1(864)


COOK


CONTRACT NO. 61085







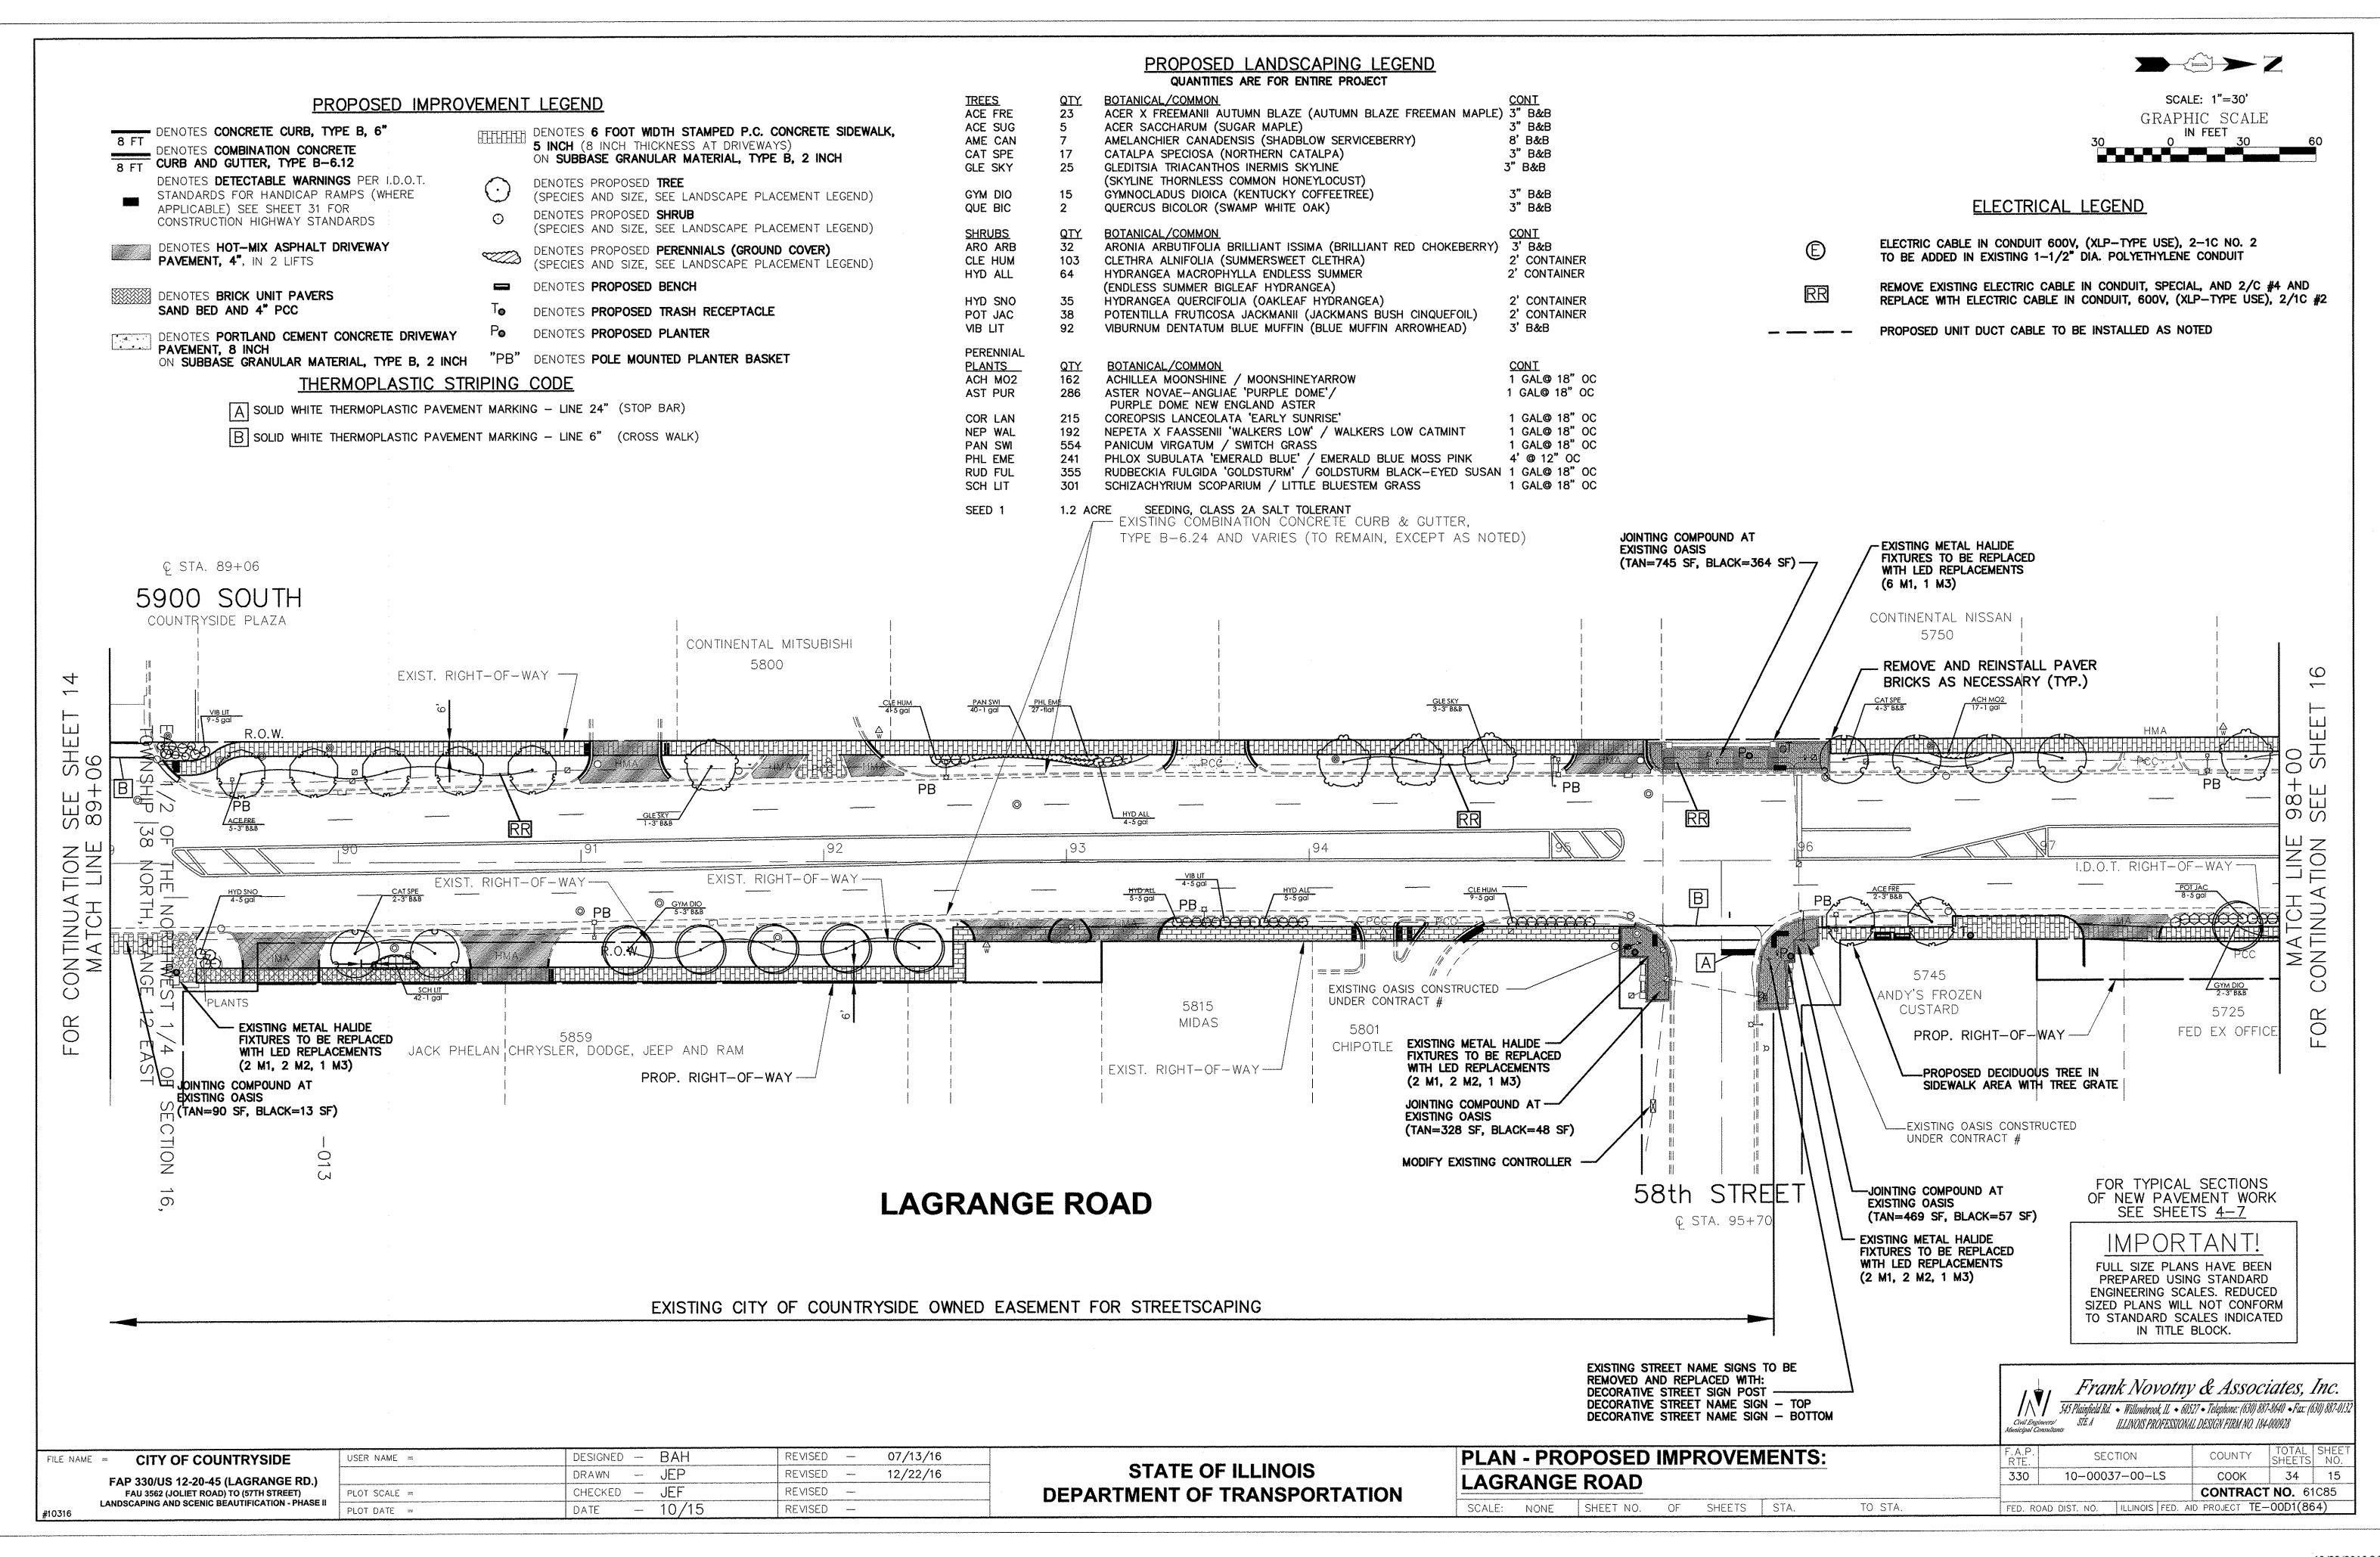


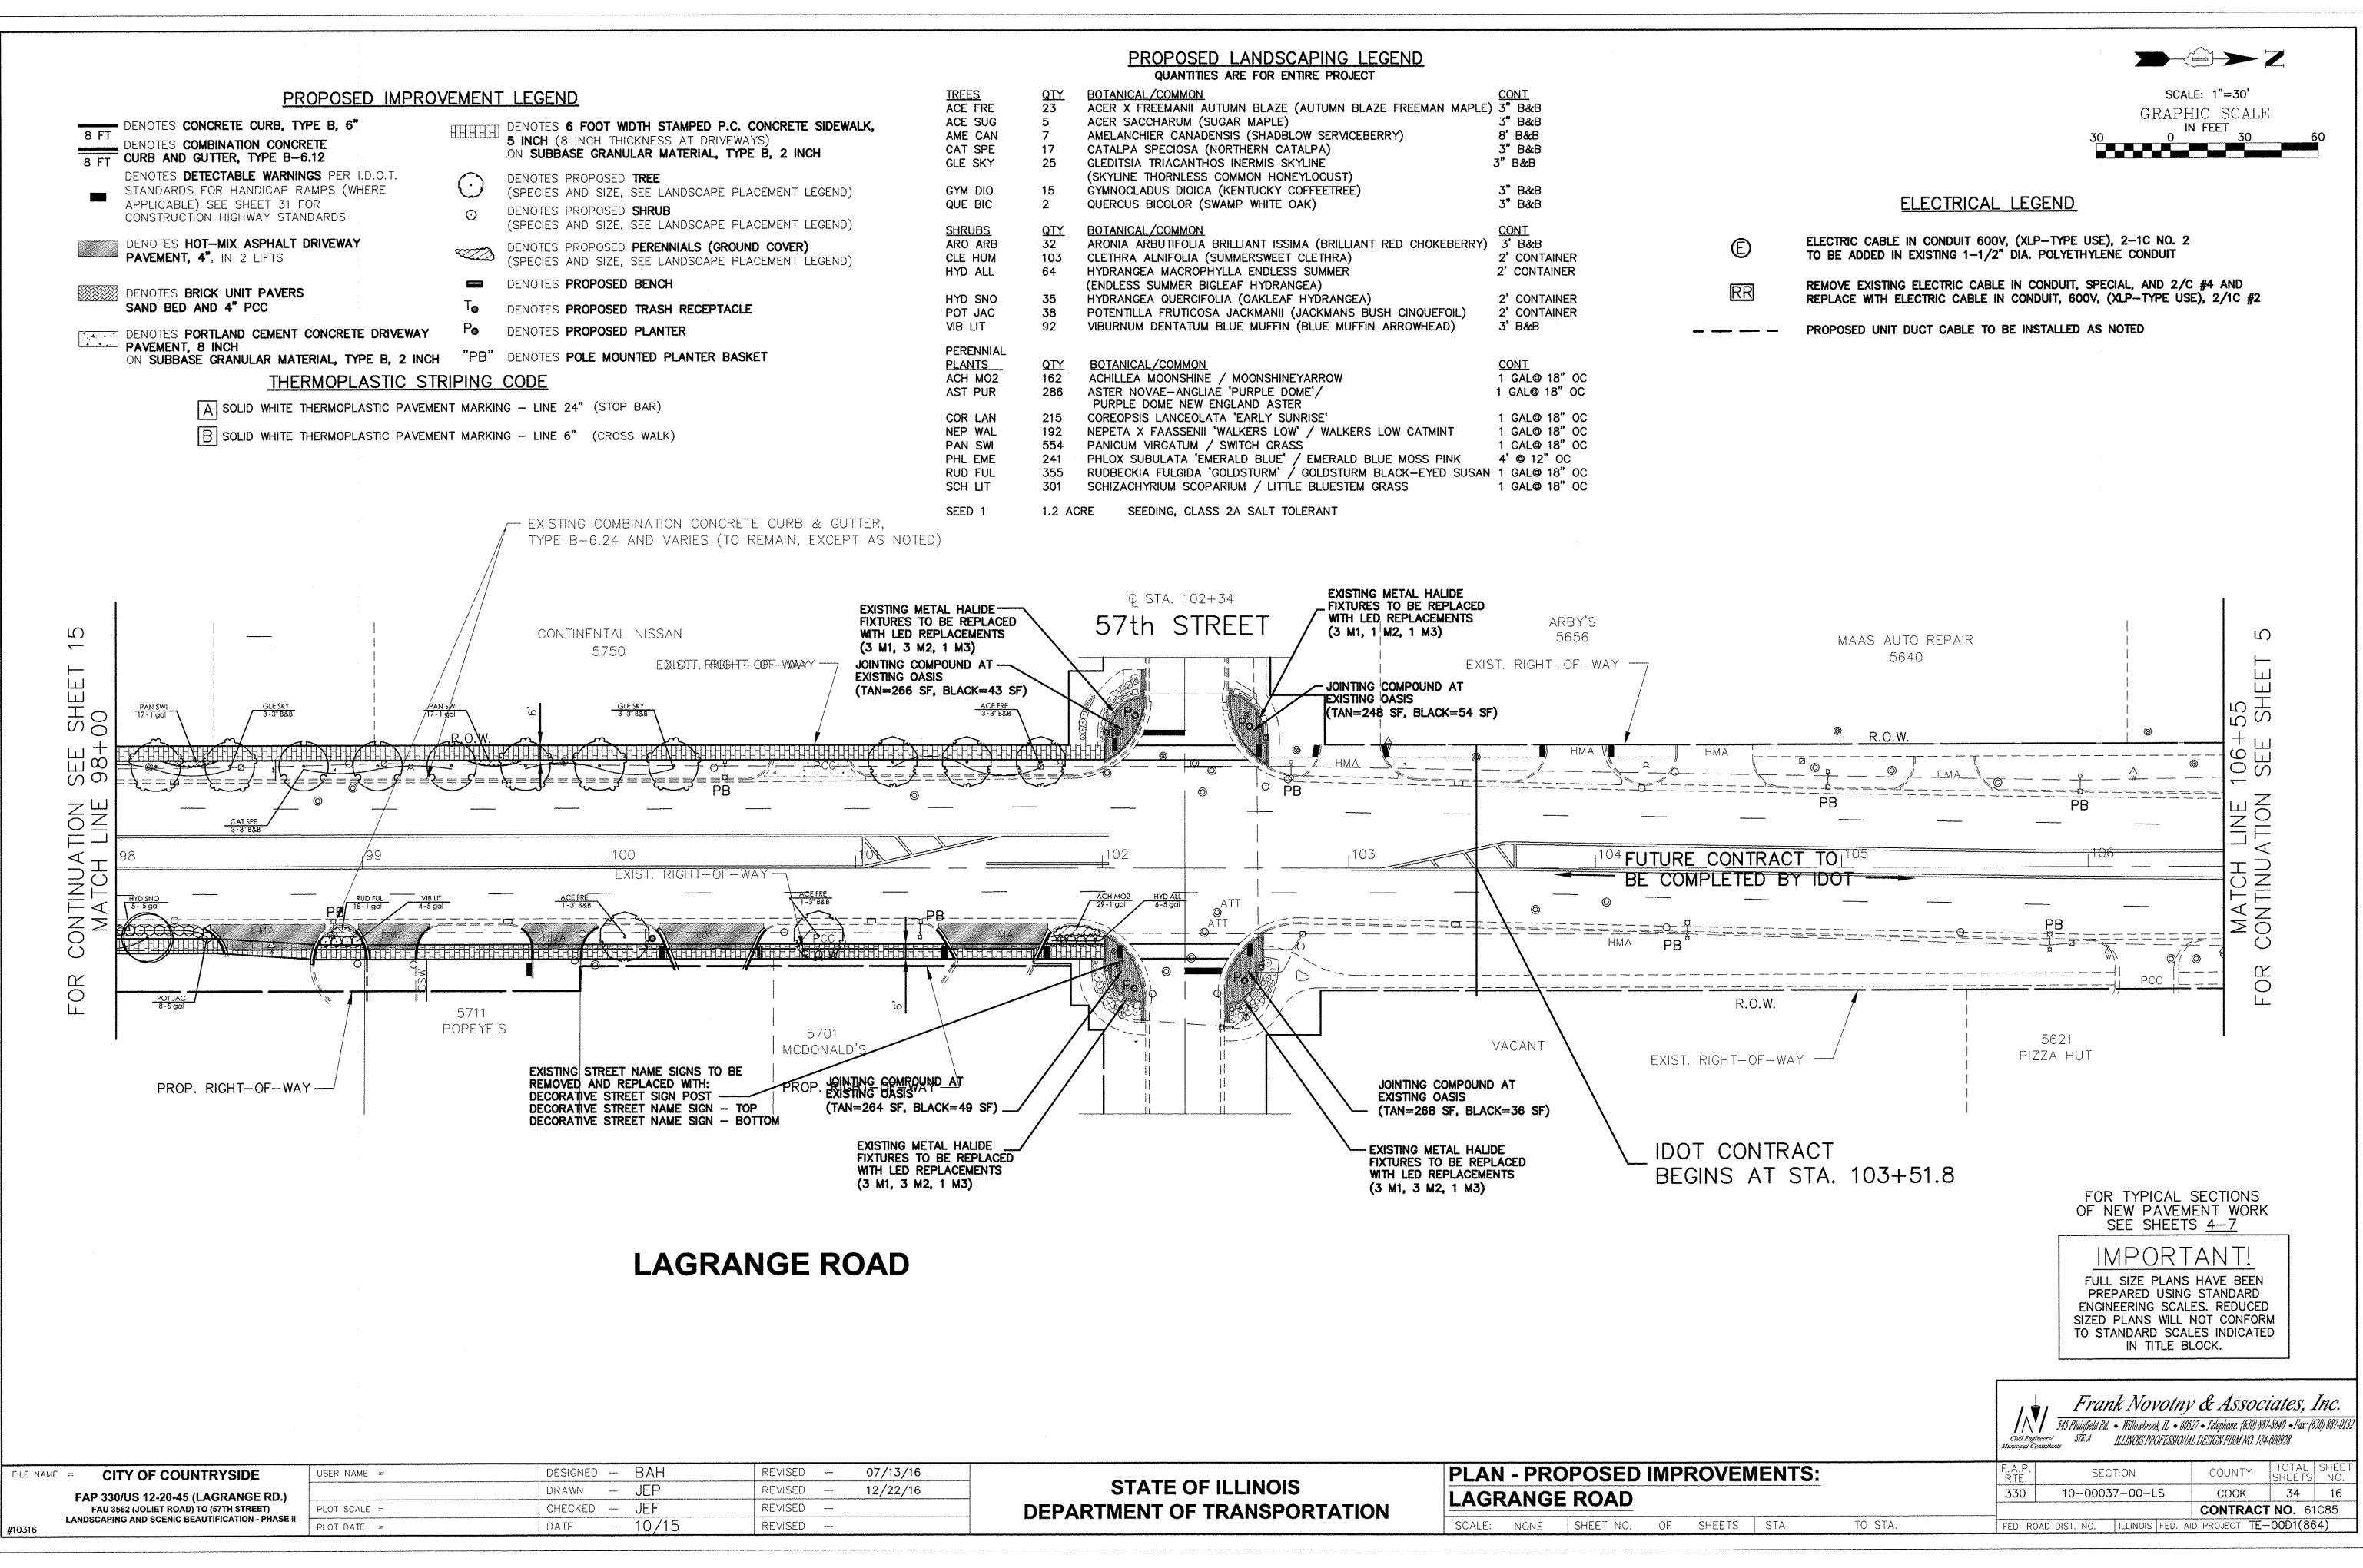


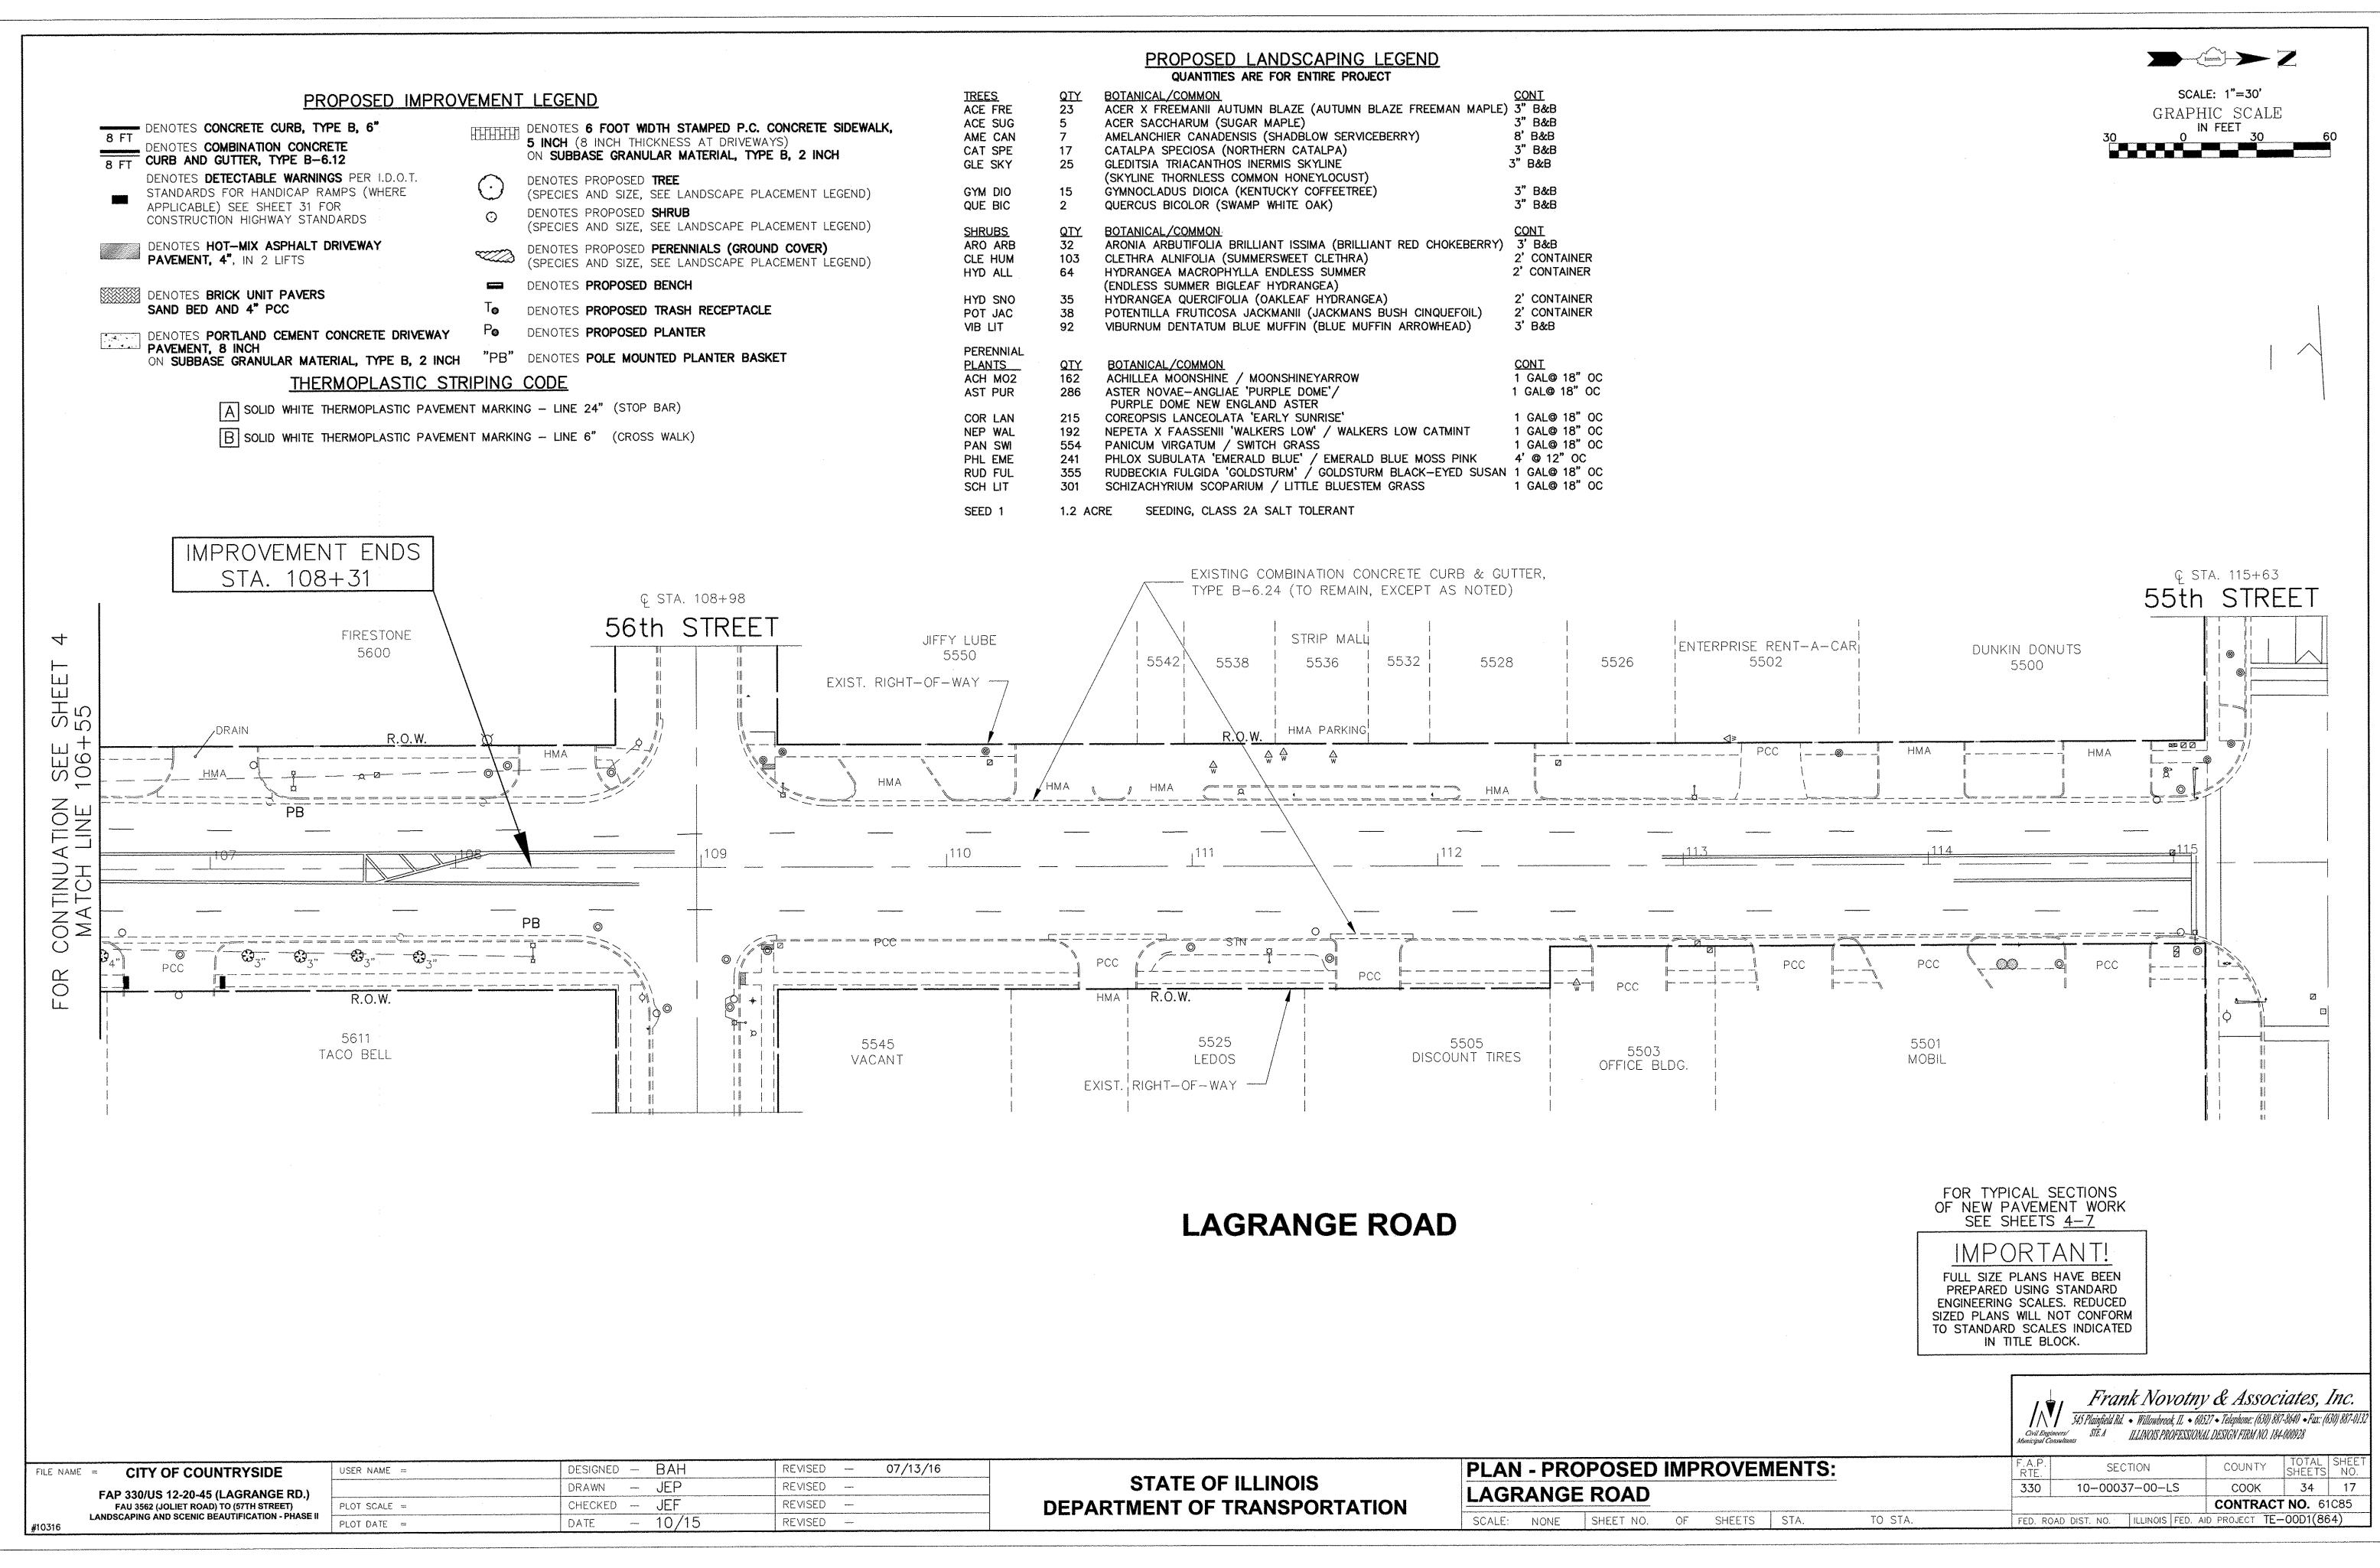


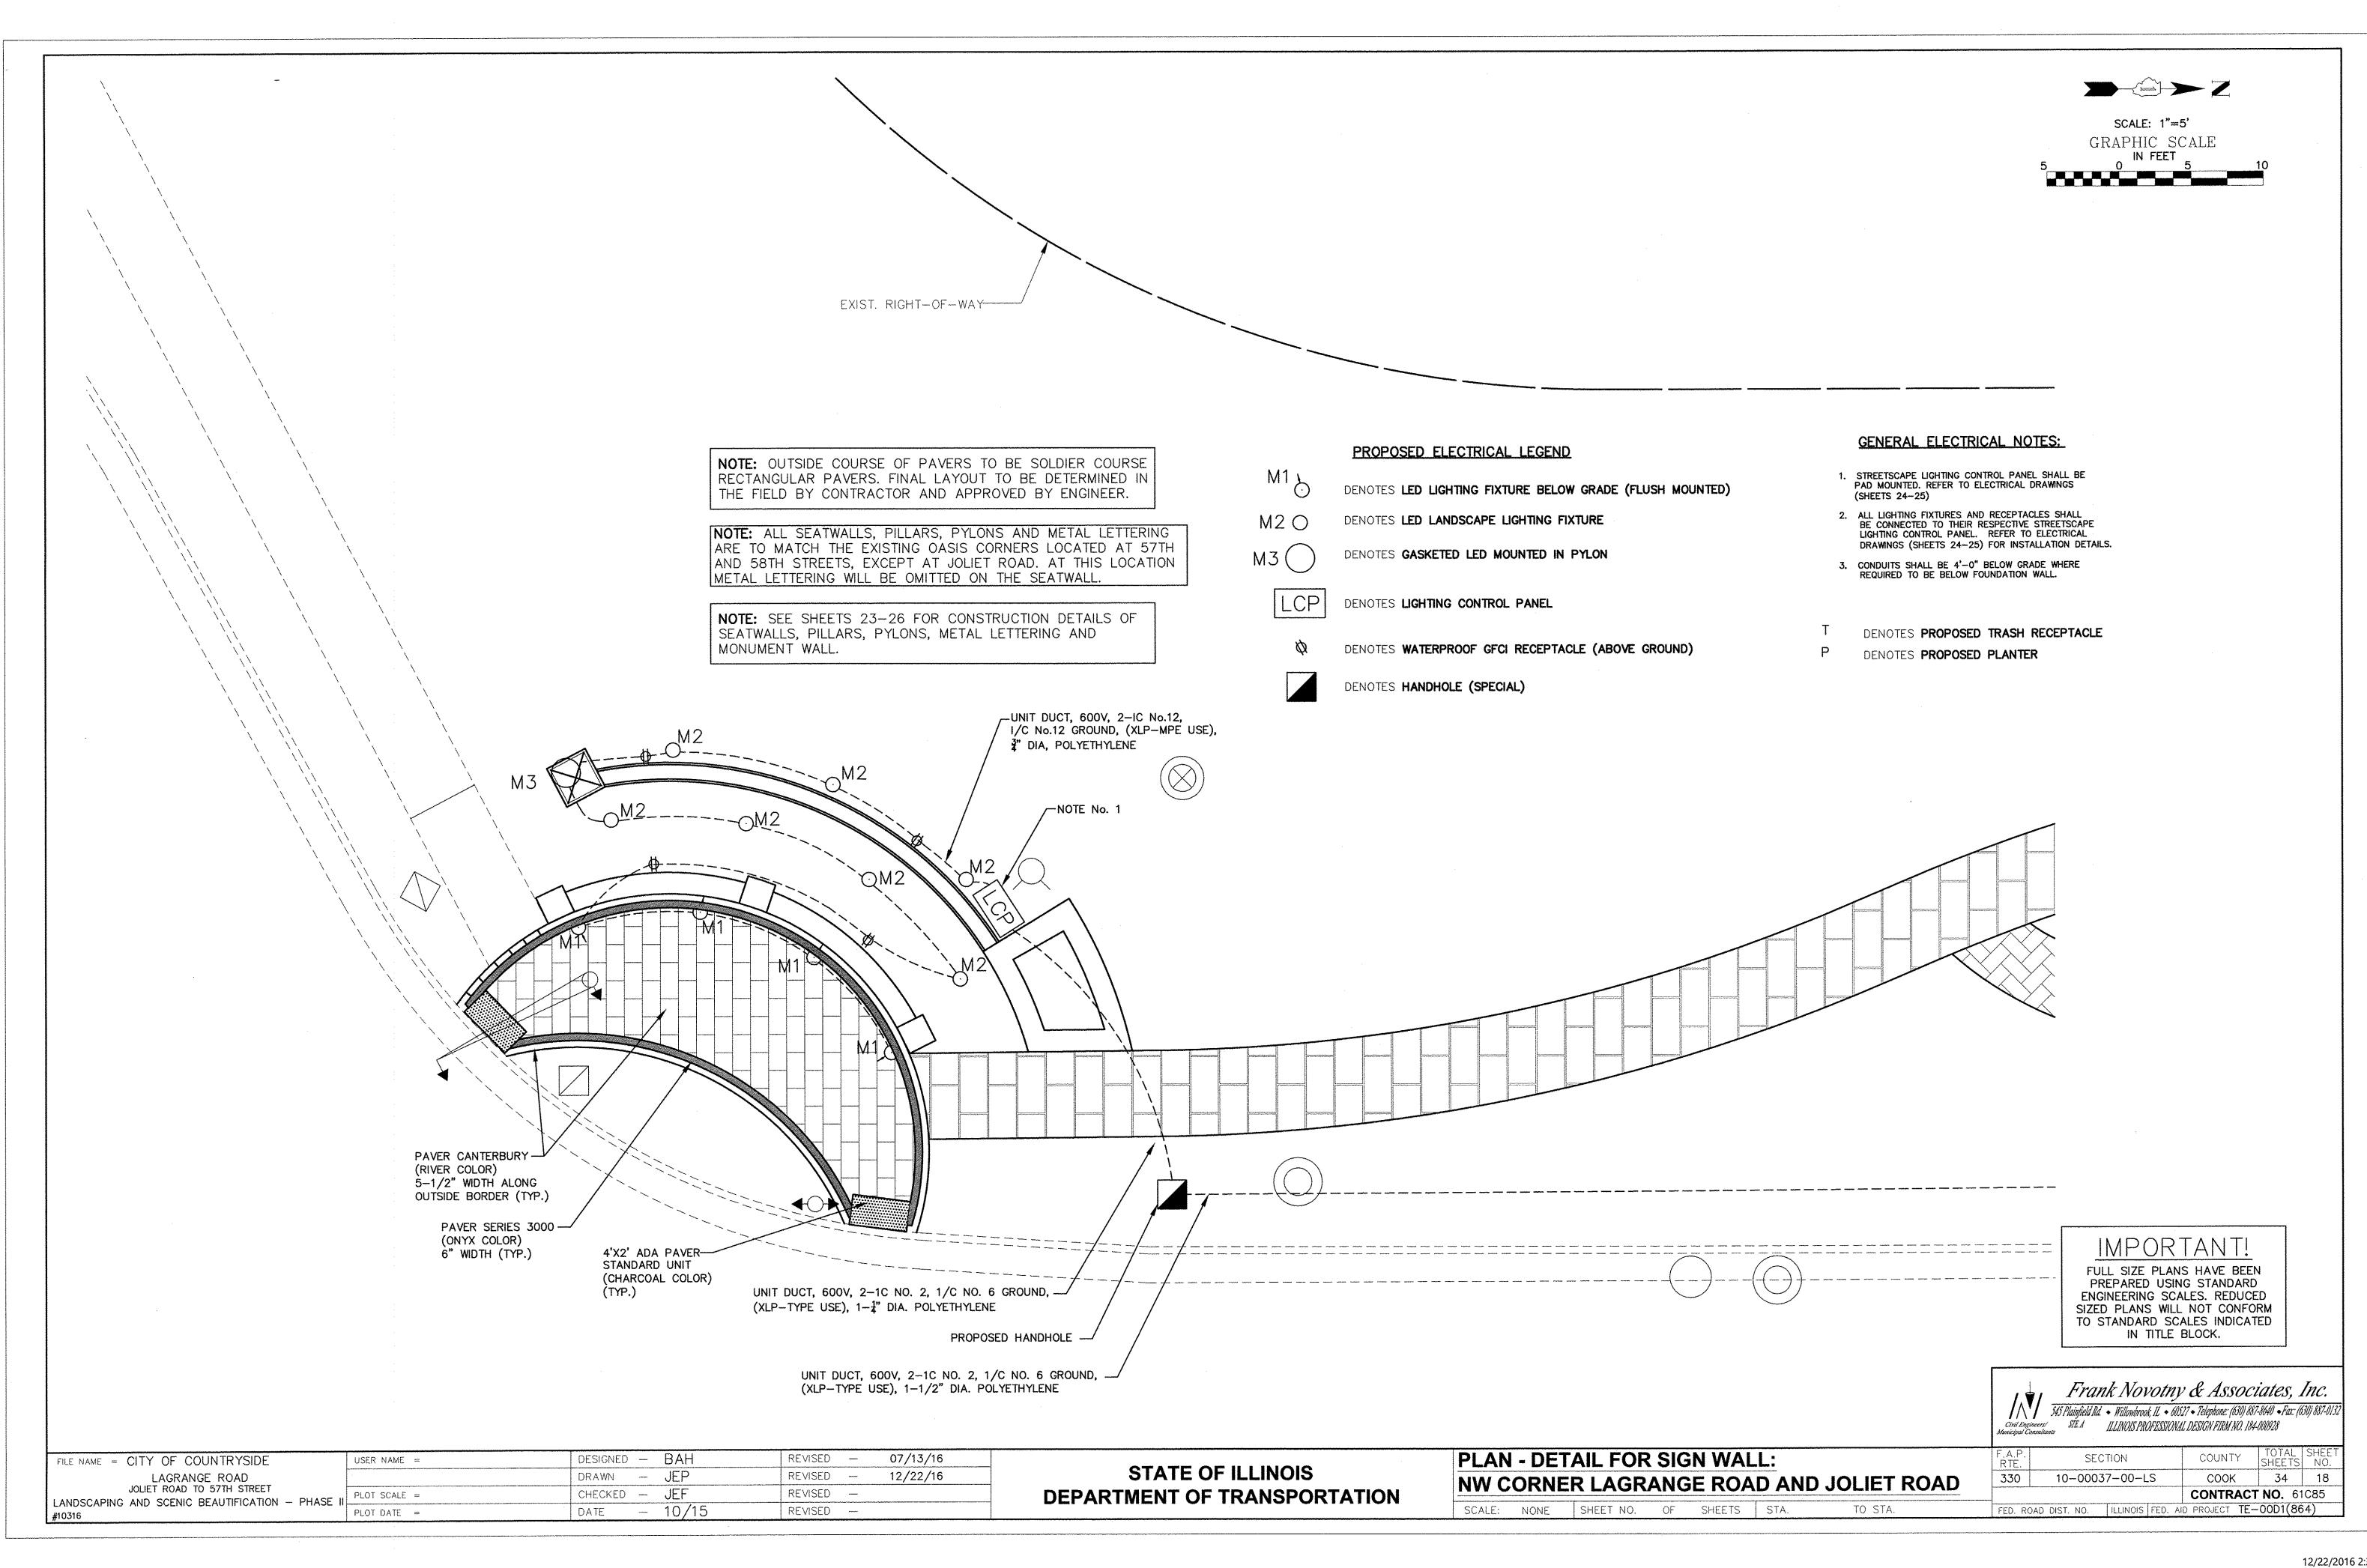

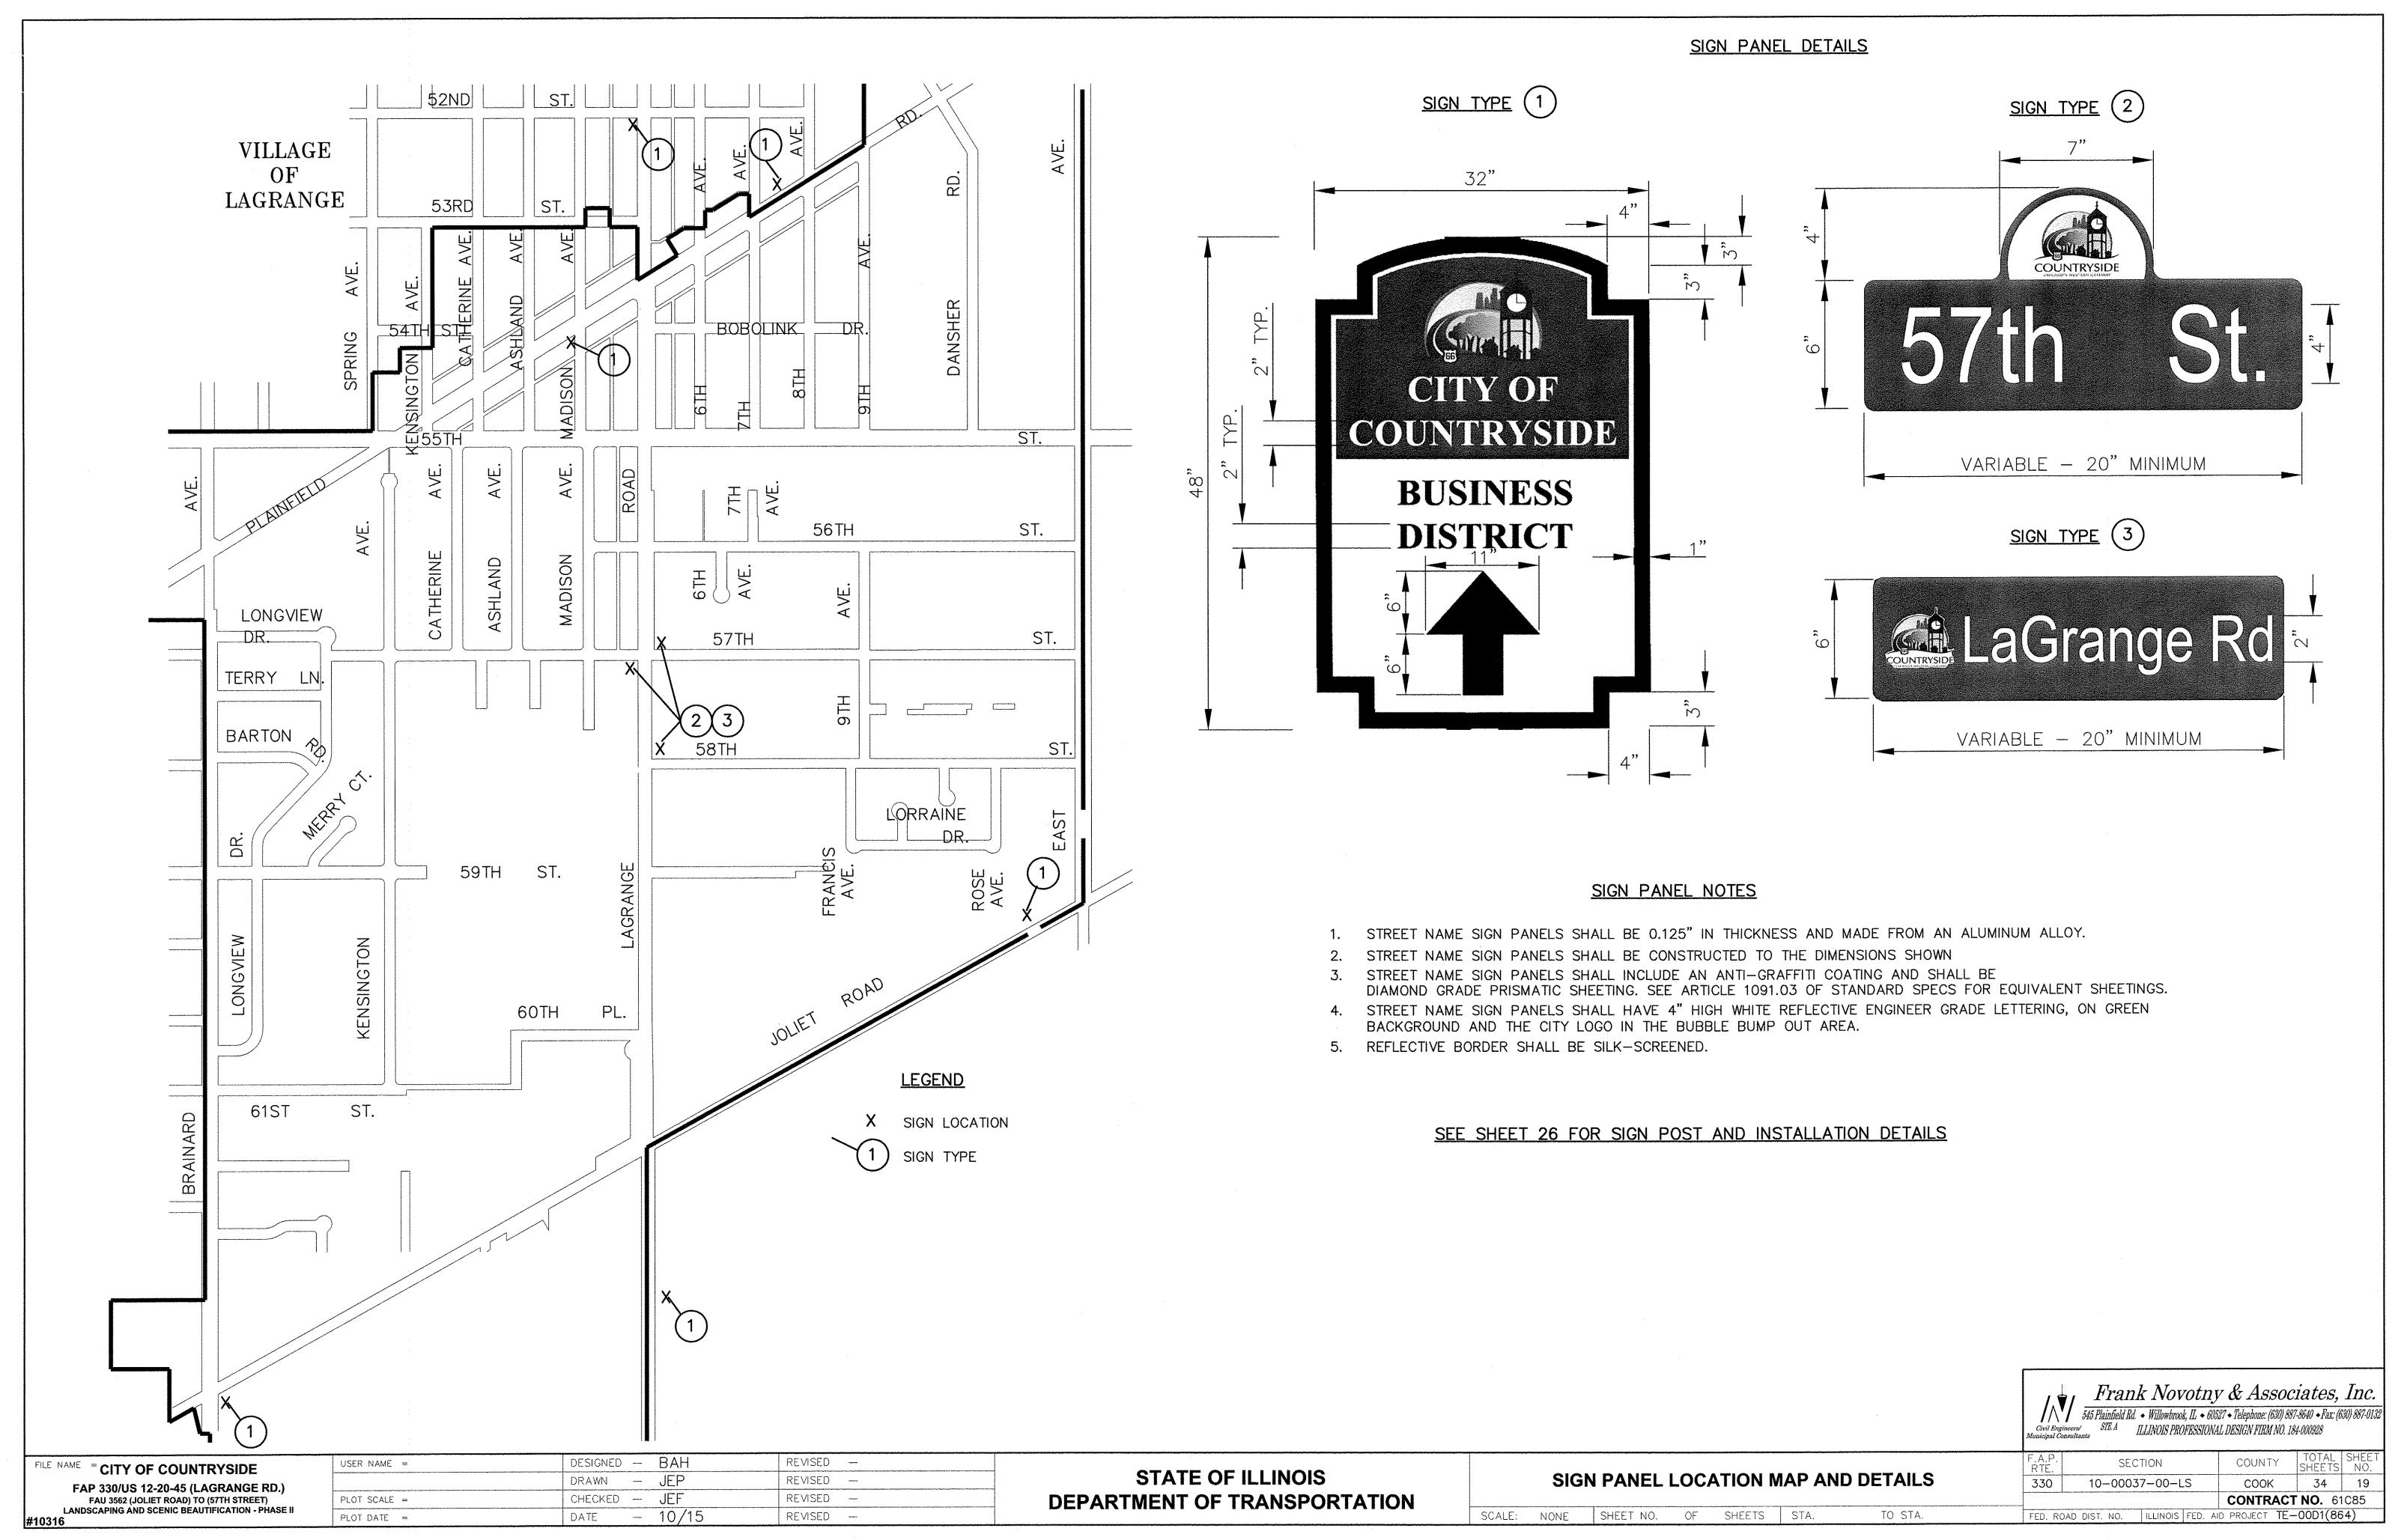

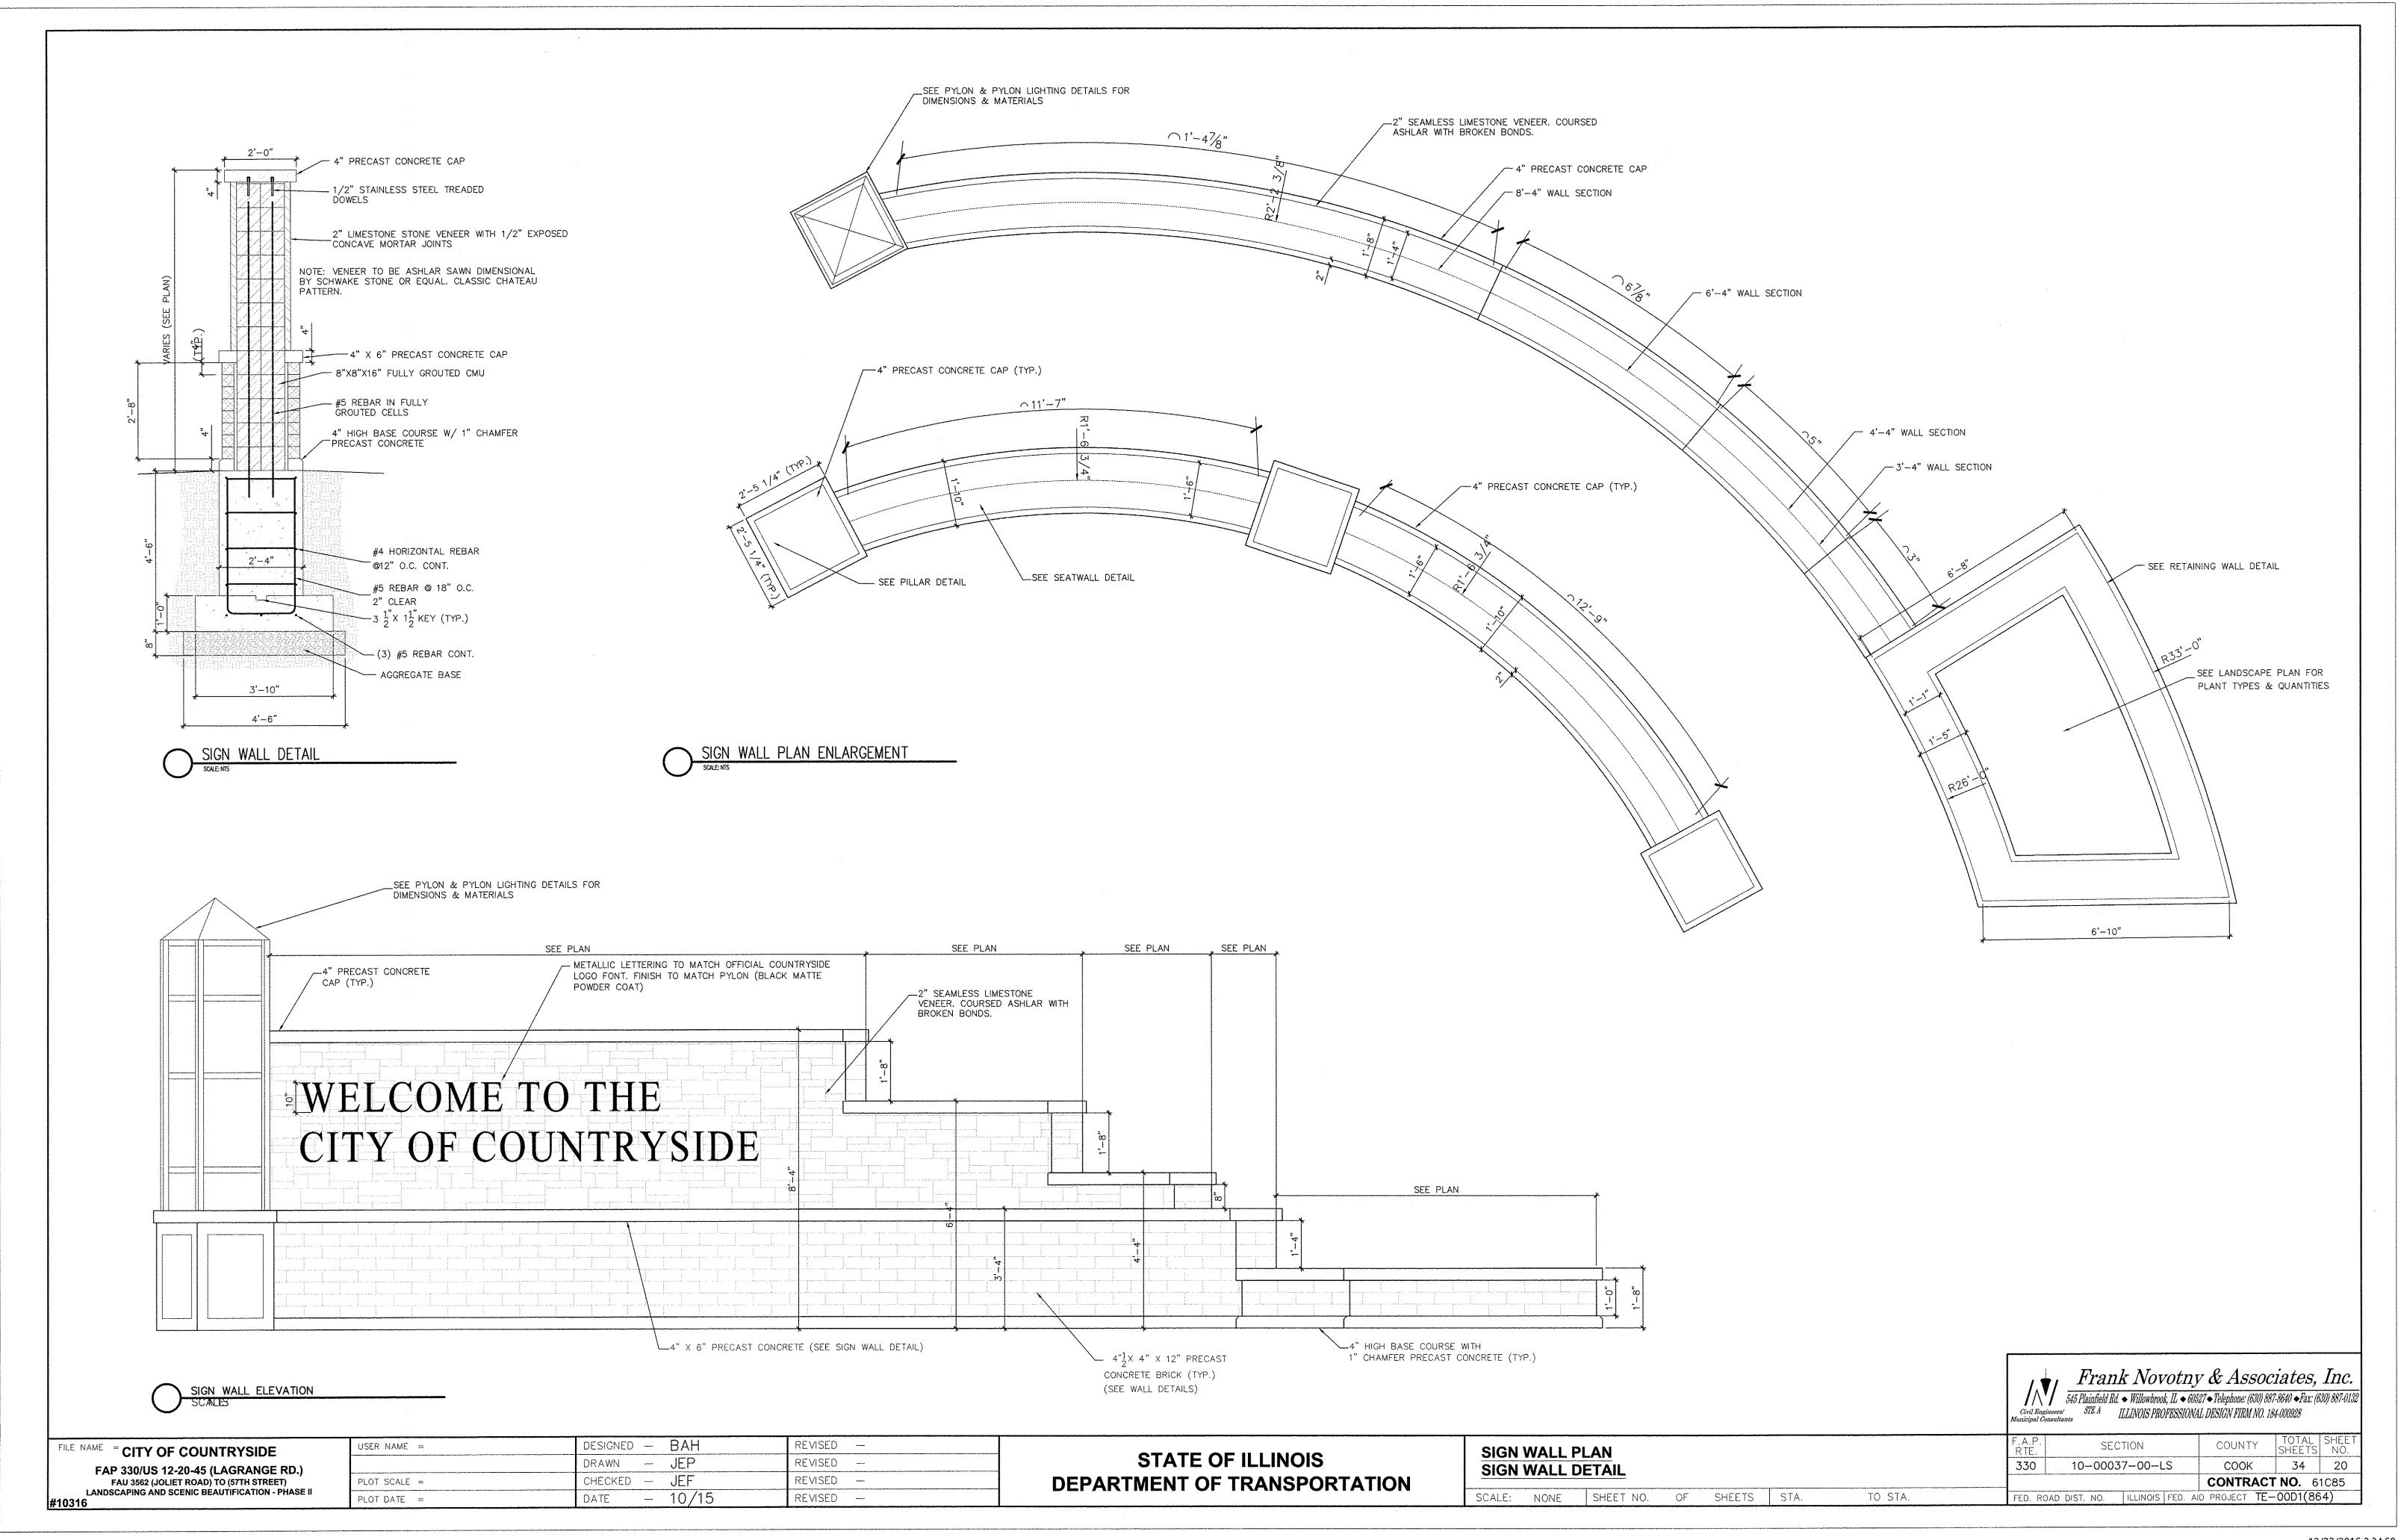

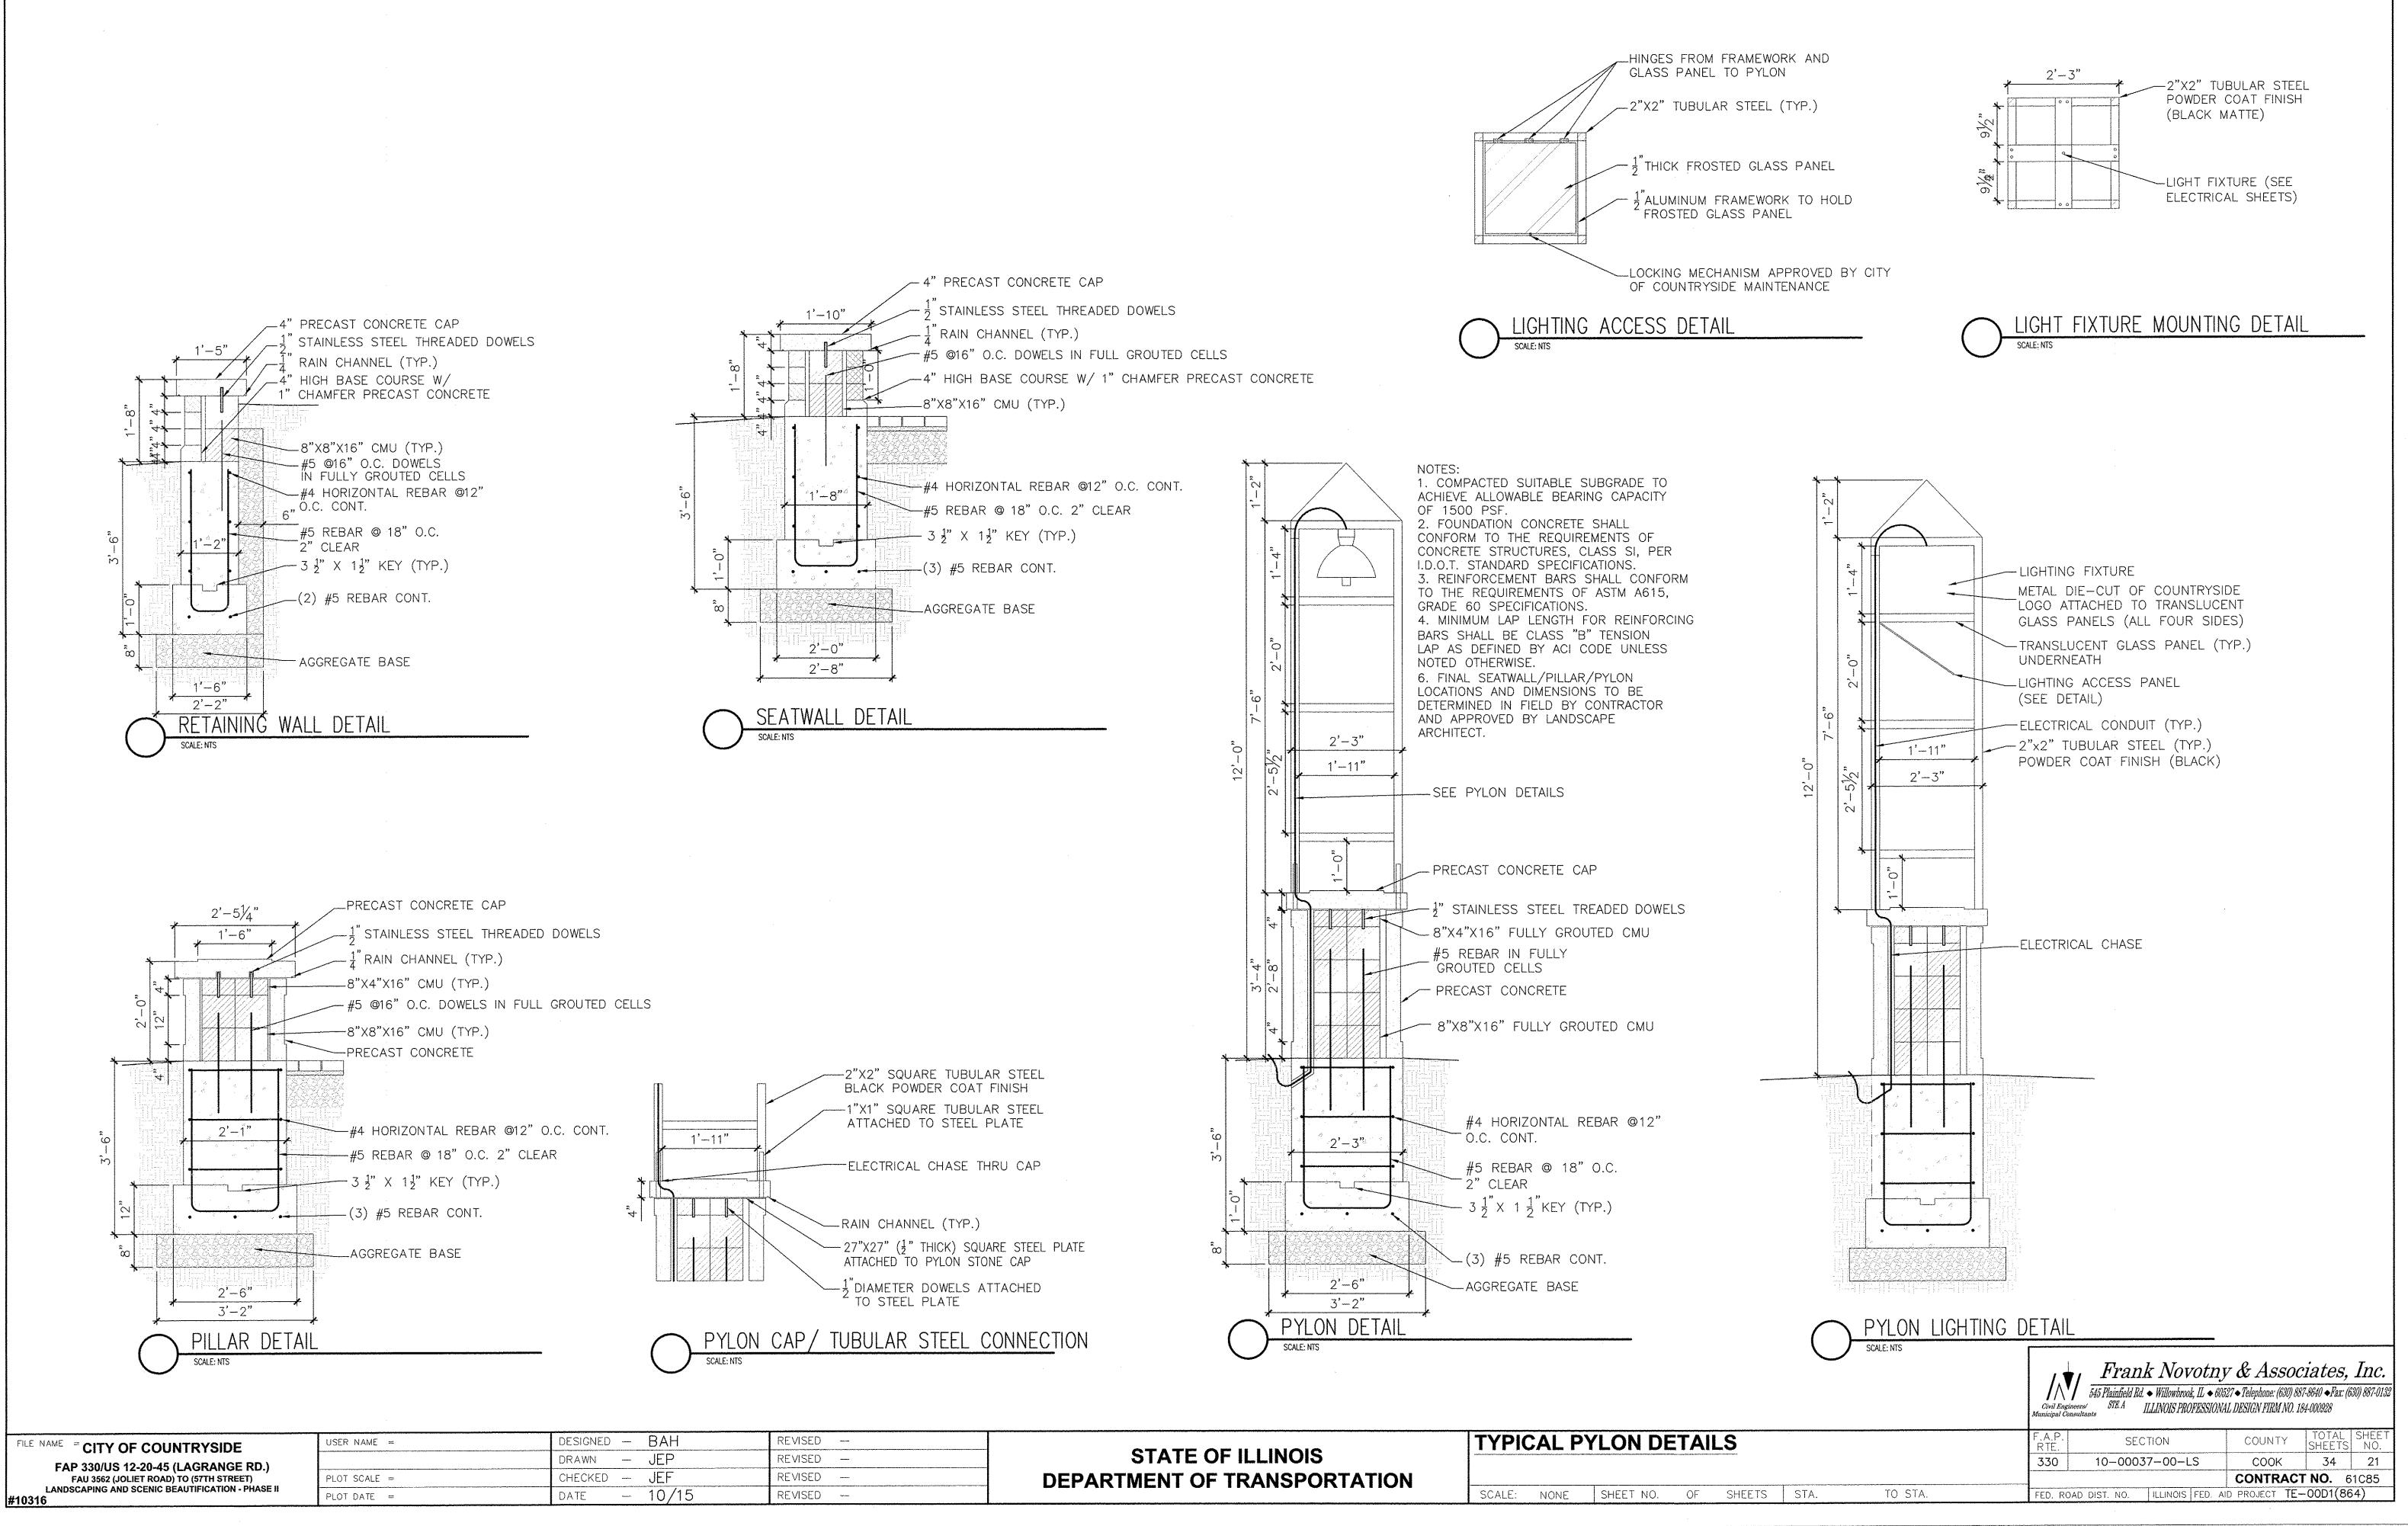

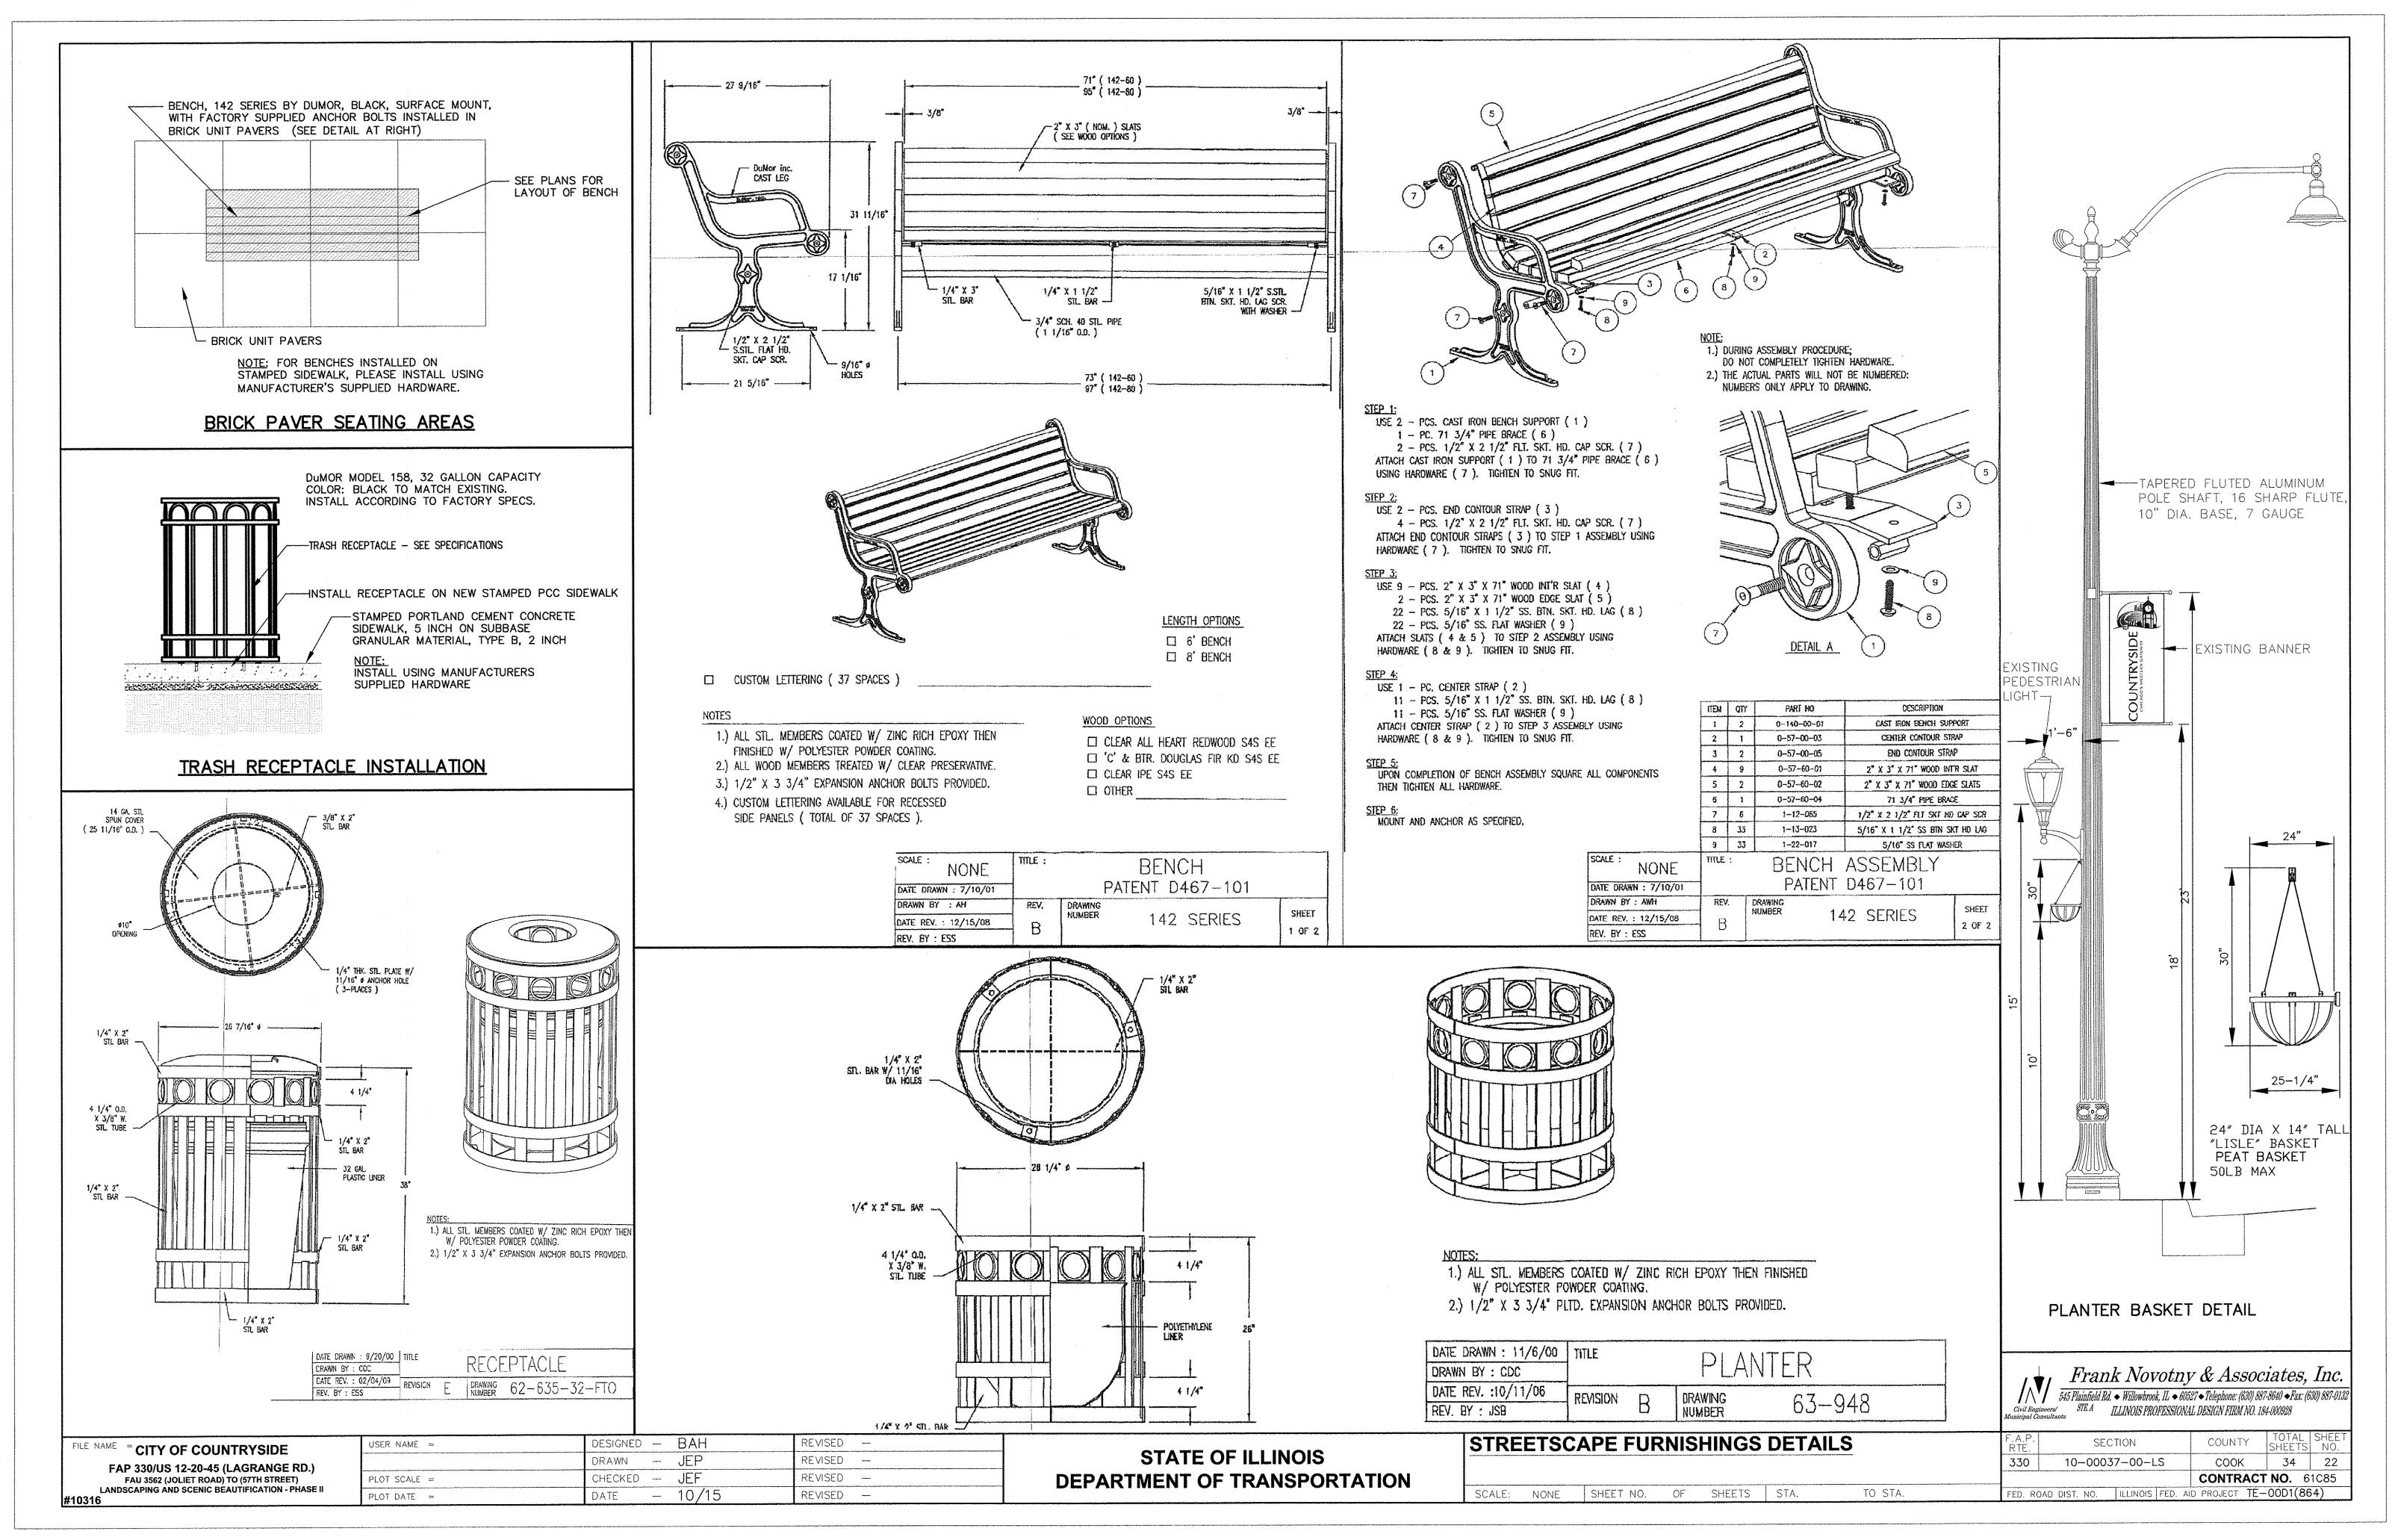

FIELD VERIFICATION

THE CONTRACTOR SHALL VERIFY ALL EXISTING CONDITIONS AND DIMENSIONS IN THE FIELD PRIOR TO BIDDING AND REPORT ANY DISCREPANCIES TO THE OWNER OR HIS REPRESENTATIVE. PROTECTION OF EXISTING SITE AND EXISTING SITE FEATURES THE CONTRACTOR SHALL PROVIDE, AT HIS OWN EXPENSE, PROTECTION AGAINST TRESPASSING AND DAMAGE TO SEEDED AREAS, PLANTED AREAS, AND OTHER CONSTRUCTION AREAS UNTIL THE PRELIMINARY ACCEPTANCE. HE SHALL PROVIDE BARRICADES, TEMPORARY FENCING, SIGNS, AND WRITTEN WARNING OR POLICING AS MAY BE REQUIRED TO PROTECT SUCH AREAS. THE CONTRACTOR SHALL NOT BE RESPONSIBLE FOR ANY DAMAGE CAUSED BY THE OWNER AFTER SUCH WARNING HAS BEEN ISSUED. IT SHALL BE THE CONTRACTOR'S RESPONSIBILITY TO LOCATE AND PROTECT ALL EXISTING ABOVE AND BELOW GROUND UTILITIES. THE CONTRACTOR SHALL BE RESPONSIBLE FOR THE PROTECTION OF CROWNS, TRUNKS AND ROOTS OF EXISTING TREES., SHRUBS, LAWNS, PAVED AREA AND OTHER EXISTING LANDSCAPED AREAS THAT ARE TO REMAIN. EXISTING TREES, WHICH MAY BE SUBJECT TO CONSTRUCTION DAMAGE. SHALL BE BOXED, FENCED, OR OTHERWISE PROTECTED BEFORE ANY WORK IS STARTED. BOXING OR OTHER PROTECTION WILL BE REMOVED AT THE END OF CONSTRUCTION. DO NOT LOCATE HEAVY EQUIPMENT OR STOCKPILES WITHIN THE DRIP-LINE OF EXISTING PLANTS OR ON LAWNS. ANY DAMAGE TO UTILITIES, STRUCTURES, PLANTINGS, OR LAWN WHICH RESULTS FROM THE CONTRACTOR'S EXPENSE IN A REASONABLE SHORT PERIOD OF TIME, WITH AS LITTLE INCONVENIENCE TO THE OWNER AS POSSIBLE. PLANTING TECHNIQUES

ALL PLANTING TECHNIQUES AND METHODS SHALL BE CONSISTENT WITH THE LATEST EDITION OF "HORTICULTURE STANDARDS OF NURSERYMEN, INC.", AND AS DETAILED ON THESE DRAWINGS. ALL DECIDUOUS PLANT MATERIAL SHALL BE THIN PRUNED TO REMOVE 1/3 INTERIOR BRANCHED, DEAD BRANCHES AND BROKEN BRANCHES. PRUNING SHALL COMPLIMENT PLANTS NATURAL FORM ABSOLUTELY NO TIP PRUNING IS ALLOWED, EXCEPT HEDGES. ANY PLANT THAT IS TIP PRUNED IS SUBJECT TO REJECTION BY THE LANDSCAPE ARCHITECT. EVERGREEN TREES AND SHRUBS SHALL BE PRUNED OF DEAD AND BROKEN BRANCHES AND AS DIRECTED BY THE LANDSCAPE ARCHITECT. ALL PRUNING WORK SHALL BE DONE WITH HAND PRUNERS ONLY. INSPECTION OF PLANT MATERIAL

ALL PLANT MATERIALS SHALL BE SUBJECT TO INSPECTION AND APPROVAL. THE LANDSCAPE ARCHITECT RESERVES THE RIGHT OT REJECT ANY PLANTS WHICH FAIL TO MEET THIS INSPECTION. ALL REJECTED MATERIAL SHALL BE REMOVED FROM THE SITE BY THE CONTRACTOR. HEIGHT OF EVERGREEN TREES ARE MEASURED FROM THE GROUND TO THE FIRST LATERAL BRANCH CLOSEST TO THE TOP. HEIGHT AND/OR WIDTH OF OTHER PLANTS SO SPECIFIED ARE MEASURED BY THE MASS OF THE PLANT NOT THE VERY TIP OF THE BRANCHES. ALL PLANT MATERIAL SHALL BE GROWN AND SUPPLIED WITHIN A 50 MILE RADIUS OF THE PROJECT. 5. PLANT SUBSTITUTION

SUBSTITUTION FROM THE SPECIFIED LIST WILL BE ACCEPTED ONLY WHEN SATISFACTORY EVIDENCE IN WRITING IS SUBMITTED TO THE LANDSCAPE ARCHITECT, SHOWING THAT THE PLANT SPECIFIED IS NOT AVAILABLE. REQUESTS FOR APPROVAL OF SUBSTITUTE PLANT MATERIAL SHALL INCLUDE COMMON AND BOTANICAL NAMES AND SIZE OF SUBSTITUTE MATERIAL. ONLY THOSE SUBSTITUTIONS OF AT LEAST EQUIVALENT SIZE AND HAVING ESSENTIAL CHARACTERISTICS SIMILAR TO THE ORIGINALLY SPECIFIED MATERIAL WILL BE APPROVED. ACCEPTANCE OR REJECTION OF SUBSTITUTE PLANT MATERIALS WILL BE ISSUED IN WRITING BY THE LANDSCAPE ARCHITECT.

. PLANTING SOIL — TREES, SHRUBS PLANTING SOIL MIXTURE AS FOLLOWS:

1/3 TOPSOIL

1/3 SAND

1/3 MUSHROOM COMPOST

ALTERNATIVE PRICE TO GUY ALL TRANSPLANT EVERGREENS.

7. PLANTING SOIL - PERENNIALS AND ORNAMENTAL GRASSES PLANTING SOIL MIXTURE AS FOLLOWS:

1/3 TOPSOIL 1/3 SAND

1/3 MUSHROOM COMPOST 7a. PLANTING SOIL - PLANTERS PLANTING SOIL MIXTURE AS FOLLOWS:

CM63 CONTAINER MIX BY MIDWEST TRADING OR SIMILAR APPROVED.

STAKING AND GUYING A. GUY AND STAKE DECIDUOUS TREES IF CONDITIONS WARRANT, OR AS REQUESTED BY THE LANDSCAPE ARCHITECT. ONE (1) STAKE TO BE USED ON TREES OF 1" CALIPER AND UNDER, OR 4' HEIGHT AND UNDER. TWO (2) STAKES TO BE USED ON TREES OF 1" TO 2 3/4" CALIPER. GUY TREES OF 3" CALIPER OR LARGER AT THREE (3) PER TREE. B. GUY ALL EVERGREEN TREES. USE THREE (3) GUYS PER TREE. PROVIDE

GENERAL PLANTING SPECIFICATIONS

9. TREE WRAP

WRAP TREE SPIRALLY WITH APPROVED TREE WRAPPING TAPE THAT IS NOT LESS THAN 4" WIDE, AND SECURELY TIE WITH SUITABLE CORD AT THE TOP, BOTTOM, AND 2" INTERVALS ALONG THE TRUNK. WRAP FROM GROUND TO THE HEIGHT OF THE FIRST BRANCH. 10. MULCH

ALL INDIVIDUAL TREES SHALL BE MULCHED WITH A MINIMUM OF 3" FINELY SHREDDED BARK MULCH. PRE-EMERGENT HERBICIDE

ALL PLANTING BEDS TO BE COVERED WITH BARK MULCH SHALL BE TREATED WITH A PRE-EMERGENT HERBICIDE PRIOR TO BARK INSTALLATION. PLANTING BED SHALL BE WEED FREE PRIOR TO HERBICIDE APPLICATION.

12. FERTILIZER TABLET SCHEDULE WOODACE 14-3-3 BRIQUETTES 17 GRAM

24 BRIQUETTES PER PLANT 4" CALIPER TREE 20 BRIQUETTES PER PLANT 3 1/2" CALIPER TREE 18 BRIQUETTES PER PLANT 3" CALIPER TREE 15 BRIQUETTES PER PLANT 2 1/2" CALIPER TREE 12 BRIQUETTES PER PLANT 2" CALIPER TREE 10 BRIQUETTES PER PLANT 1 1/2" CALIPER TREE 10 BRIQUETTES PER PLANT 7-10' HEIGHT TREE 6 BRIQUETTES PER PLANT 4-6' HEIGHT TREE 12 BRIQUETTES PER PLANT 48" SHRUB 10 BRIQUETTES PER PLANT 36" SHRUB 6 BRIQUETTES PER PLANT 18-24" SHRUB PERENNIALS OR GROUNDCOVERS

TOPSOIL

SHALL BE SPREAD OVER ALL AREAS TO BE PLANTED TO A MINIMUM DEPTH OF 12" WHEN COMPACTED TO BE PERFORMED BY OTHERS.

QUART POT SIZE

CHALL HAVE THE COLLOWING MECHANICAL ANALYSIS

TOPSOIL SHALL HAVE THE FO	LLOWING MECHANICAL ANALYSIS:	
TEXTURAL CLASS SAND (0.05-2.0 MIL. DIA. RANGE)	% OF TOTAL WEIGHT 5-25	AVERAGE % 20
SILT (0.002-0.05 MIL. DIA. RANGE)	20-50	40
CLAY (LESS THAN 0.002 MIL. DIA. RANGE)	20-50	40
1. 95% OF TOPSOIL SHALL P. 2. TOPSOIL SHALL BE FREE (ASS A 2.0 MIL. SIEVE. OF STONES 1 IN. IN LONGEST DIMENSION, EARTH	d CLODS,

PLANT PARTS AND DEBRIS.

3. ORGANIC MATTER CONTENT SHALL BE 4-12% OF TOTAL DRY WEIGHT C. TOPSOIL SHALL HAVE A pH VALUE RANGE OF 6.0 TO 7.0. IF THE SOIL DOES NOT FALL WITHIN THE pH RANGE SPECIFIED, IT MAY BE AMENDED TO BRING IT WITHIN THE SPECIFIED LIMIT.

1. OBTAIN THE FOLLOWING INFORMATION ON THE TOPSOIL AND SUBMIT IT TO THE LANDSCAPE ARCHITECT PRIOR TO BEGINNING WTH WORK. SUCH INFORMATION SHALL BE OBTAINED FROM TESTS PERFORMED BY AN INDEPENDENT TESTING LABORATORY ACCEPTABLE TO THE

LANDSCAPE ARCHITECT. THIS WILL BE AT NO ADDITIONAL EXPENSE TO THE OWNER. A. SOIL pH AND RECOMMENDATIONS ON THE TYPE AND QUANTITY OF SOIL ADDITIVES REQUIRED, IF ANY, TO BRING THE EXISTING PH WITHIN THE DESIRED

B. PERCENTAGE OF ORGANIC MATTER AND RECOMMENDATIONS ON THE TYPE AND QUANTITY OF SOIL ADDITIVES REQUIRED, IF ANY, TO BRING THE ORGANIC MATTER TO A SATISFACTORY LEVEL FOR PLANTINGS.

C. N-P-K ANALYSIS AND RECOMMENDATIONS ON THE TYPE AND QUNATITY OF ADDITIVES REQUIRED. IF ANY, TO ESTABLISH SATISFACTORY NUTRIENT LEVELS FOR PLANTINGS.

AREAS WHERE VEHICULAR TRAFFIC HAS COMPACTED THE TOP SOIL SHALL BE LOOSENED/SCARIFIED TO A MINIMUM DEPTH OF 12" BEFORE FERTILIZING AND PLANTING. FINE GRADING OF ALL PLANTING AREAS IS REQUIRED. MAXIMUM SIZE OF STONE OR TOPSOIL LUMP IS 1".

A. PLANTING AREAS AND TURF SHALL BE WATERED TO INSURE PROPER ESTABLISHMENT. ONCE PLANTS AND TURF ARE ESTABLISHED, WATERING MAY BE DECREASED BUT THE PLANTS AND TURF MUST NEVER BE ALLOWED TO DRY OUT COMPLETELY. FREQUENT WATERING SHOULD BE CONTINUED FOR APPROXIMATELY FOUR (4) WEEKS OR UNTIL PLANTS AND TURF HAVE BECOME SUFFICIENTLY ESTABLISHED TO WARRANT WATERING ON AN "AS NEEDED" BASIS.

PLANTS AND TURF ARE BEING ESTABLISHED IN A VARIETY OF CONDITIONS. IT SHALL BE THE CONTRACTOR'S RESPONSIBILITY TO DETERMINE AND IMPLEMENT WHATEVER PROCEDURES HE DEEMS NECESSARY TO ESTABLISH THE PLANTS AND TURF AS PART OF HIS WORK. PLANTED AREAS AND TURF WILL BE ACCEPTED WHEN ALL AREAS ARE IN HEALTHY CONDITION AND AT LEAST 90 DAYS HAVE ELAPSED SINCE THE COMPLETION OF THIS WORK. THE CONTRACTOR SHALL SUBMIT WITH HIS BID A DESCRIPTION OF THE METHODS AND PROCEDURES HE INTENDS TO USE.

15. PRELIMINARY ACCEPTANCE

ALL PLANTINGS SHALL BE MAINTAINED BY THE CONTRACTOR FOR A PERIOD OF 90 DAYS AFTER PRELIMINARY ACCEPTANCE BY THE OWNER OR HIS REPRESENTATIVE. MAINTENANCE SHALL INCLUDE, BUT IS NOT LIMITED TO, PRUNING PLANT MATERIAL PULLING WEEDS, WATERING PLANT MATERIAL, AND PERENNIAL FLOWER MAINTENANCE.


16. FINAL ACCEPTANCE

ALL PLANT MATERIAL (EXCLUDING ANNUAL COLOR), SHALL BE GUARANTEED FOR ONE YEAR AFTER THE END OF THE 90 DAY MAINTENANCE PERIOD. THE END OF THE MAINTENANCE PERIOD IS MARKED BY THE FINAL ACCEPTANCE OF THE CONTRACTOR'S WORK BY THE OWNER OR HIS REPRESENTATIVE.


17. SITE CLEAN-UP

THE CONTRACTOR SHALL PROTECT THE PROPERTY OF THE OWNER AND THE WORK OF OTHER CONTRACTORS. THE CONTRACTOR SHALL ALSO BE DIRECTLY RESPONSIBLE FOR ALL DAMAGE CAUSED BY THE ACTIVITIES AND FOR THE DAILY REMOVAL OF ALL TRASH AND DEBRIS FROM HIS WORK AREA TO THE SATISFACTION OF THE LANDSCAPE ARCHITECT.

18. CONFLICT WITH IDOT SPECIFICATION SECTION 253 WHERE CONFLICTS ARISE BETWEEN DETAILS SHOWN AS PART OF THESE PLANS AND IDOT SPECIFICATION SECTION 253, THE STRICTER SPECIFICATION SHALL APPLY

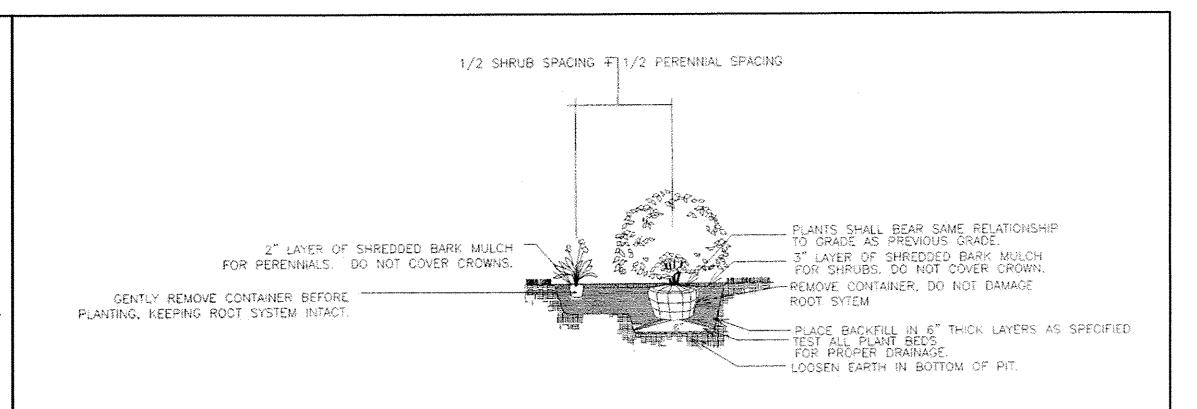

3 SHRUB/PERENNIAL/GROUNDCOVER PLANTING DETAIL

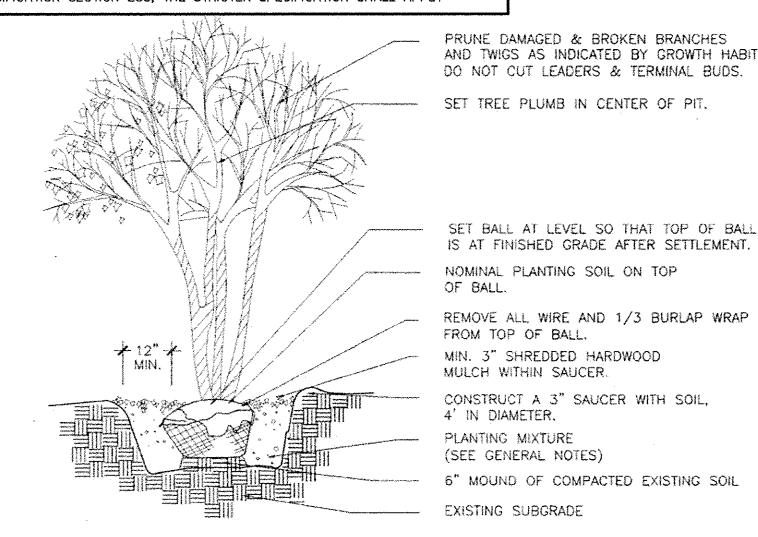

PRUNE DAMAGED & BROKEN BRANCHES AND TWIGS AS INDICATED BY GROWTH HABIT DO NOT CUT LEADERS & TERMINAL BUDS. - SET TREE PLUMB IN CENTER OF PIT. REMOVE ALL WIRE AND 1/3 BURLAP WRAP FROM TOP OF BALL. - SET BALL AT LEVEL SO THAT TOP OF BALL IS AT FINISHED GRADE AFTER SETTLEMENT. NOMINAL PLANTING SOIL ON TOP OF BALL. 3" SHREDED HARDWOOD MULCH WITHIN SAUCER CONSTRUCT A 3" SAUCER WITH SOIL. 4' IN DIAMETER PLANTING MIXTURE (SEE GENERAL NOTES)


6" MOUND OF COMPACTED EXISTING SOIL

- EXISTING SUBGRADE


ORNAMENTAL TREE/LARGE SHRUB PLANTING DETAIL NOT TO SCALE


خمية معاولة بعضوية بدائه والمعاون

1-2 BRIQUETTES PER PLANT

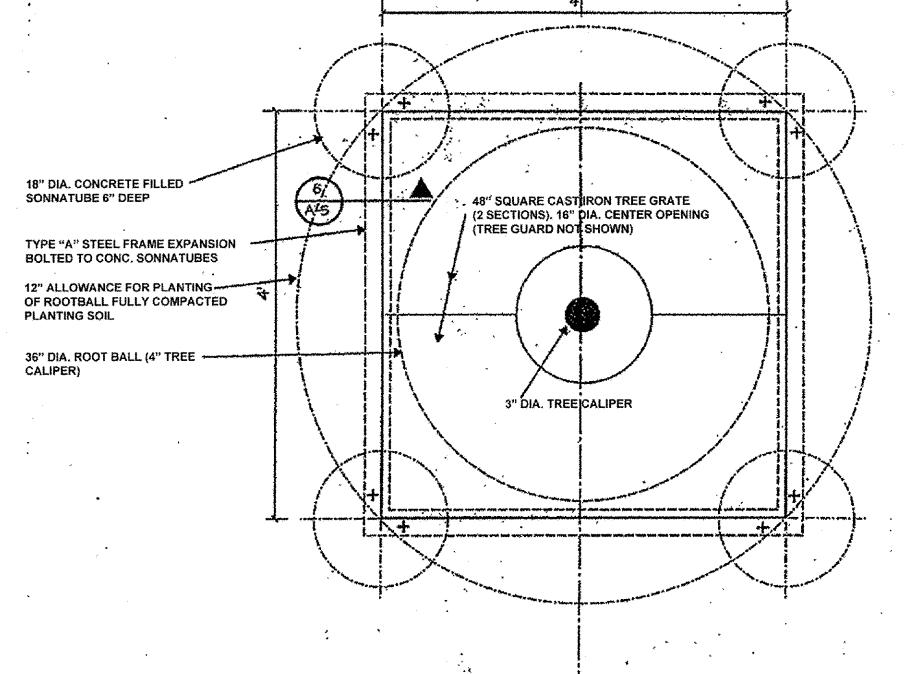

PLAN OF TREE GRATING

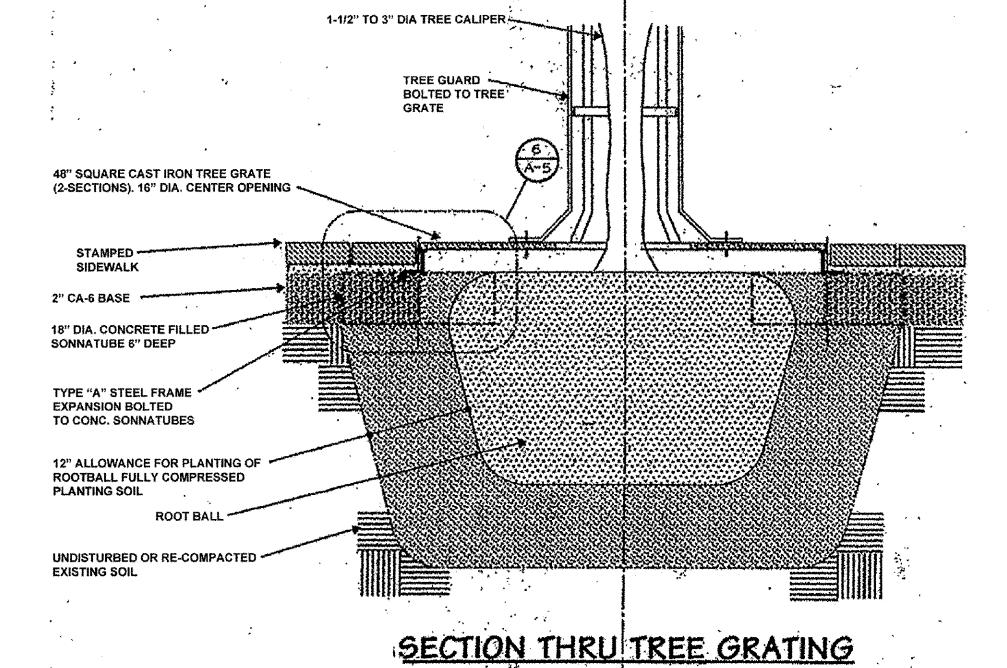

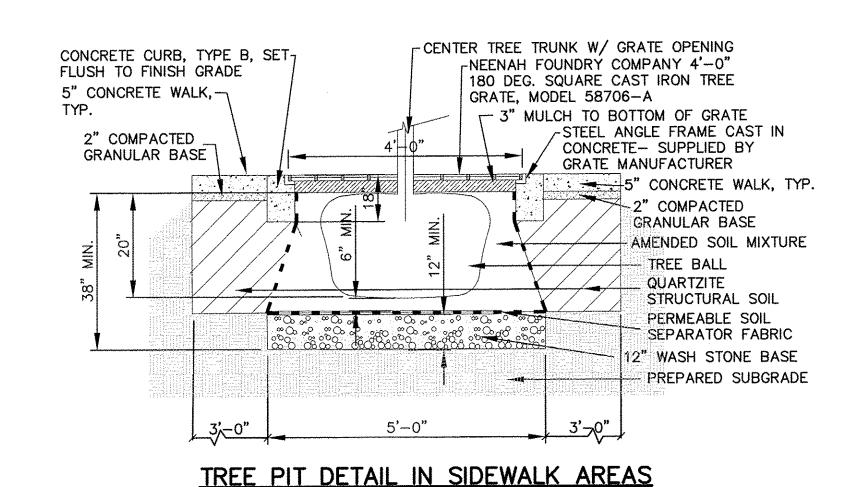

TO STA.

Frank Novotny & Associates, Inc.

545 Plainfield Rd. ◆ Willowbrook, IL ◆ 60527 ◆ Telephone: (630) 887-8640 ◆ Fax: (630) 887-01. STE A ILLINOIS PROFESSIONAL DESIGN FIRM NO. 184-000928 SECTION 34 23 330 10-00037-00-LS COOK CONTRACT NO. 61085

ED. ROAD DIST. NO. | ILLINOIS FED. AID PROJECT TE-00D1(864)

FILE NAME = CITY OF COUNTRYSIDE FAP 330/US 12-20-45 (LAGRANGE RD.) FAU 3562 (JOLIET ROAD) TO (57TH STREET)

ANDSCAPING AND SCENIC BEAUTIFICATION - PHASE II

BAH USER NAME = REVISED DESIGNED -JEP DRAWN REVISED CHECKED — **JEF** REVISED PLOT SCALE = DATE - 10/15 REVISED PLOT DATE =


STATE OF ILLINOIS **DEPARTMENT OF TRANSPORTATION** TYPICAL PLANTING DETAILS

SHEET NO.

OF SHEETS STA.


SCALE: NONE

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- 1. ALL COMPONENTS ON A 1/2" THICK BENELEX
- 2. QUANTITY AND SIZE OF CIRCUIT BREAKERS AND TRANSFORMERS SHALL BE PER LCP SCHEDULE.
- 3. PROVIDE SUITABLE QUANTITY OF LOAD TERMINAL CONNECTIONS FOR ALL DEVICES.
- 4. ALL CONDUITS TO ENTER AT BOTTOM OF PANEL. 5. CONTROL PANEL TO BE 25"X25"X8"D.
- 6. POWDER COATED GREEN TO MATCH LCP'S AT 57TH AND 58TH STREETS

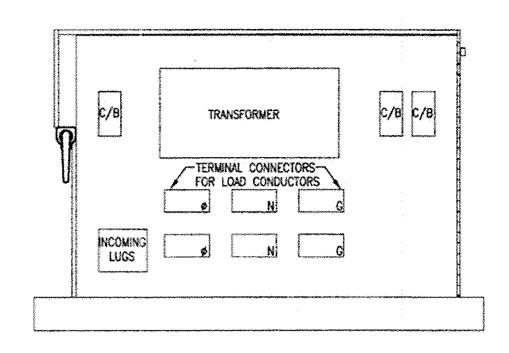1 LIGHTING CONTROL PANEL DETAIL




FILE NAME = CITY OF COUNTRYSIDE

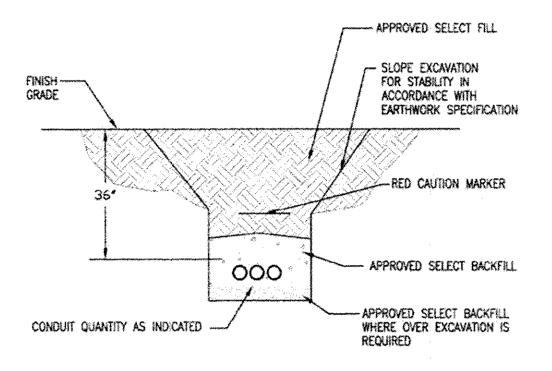FAP 330/US 12-20-45 (LAGRANGE RD.)

FAU 3562 (JOLIET ROAD) TO (57TH STREET) LANDSCAPING AND SCENIC BEAUTIFICATION - PHASE II

1. TRENCH WIDTH SHALL BE DETERMINED BY NUMBER OF CABLES AND SIDE WALL COMPACTION.


2 TYPICAL TRENCH SECTION

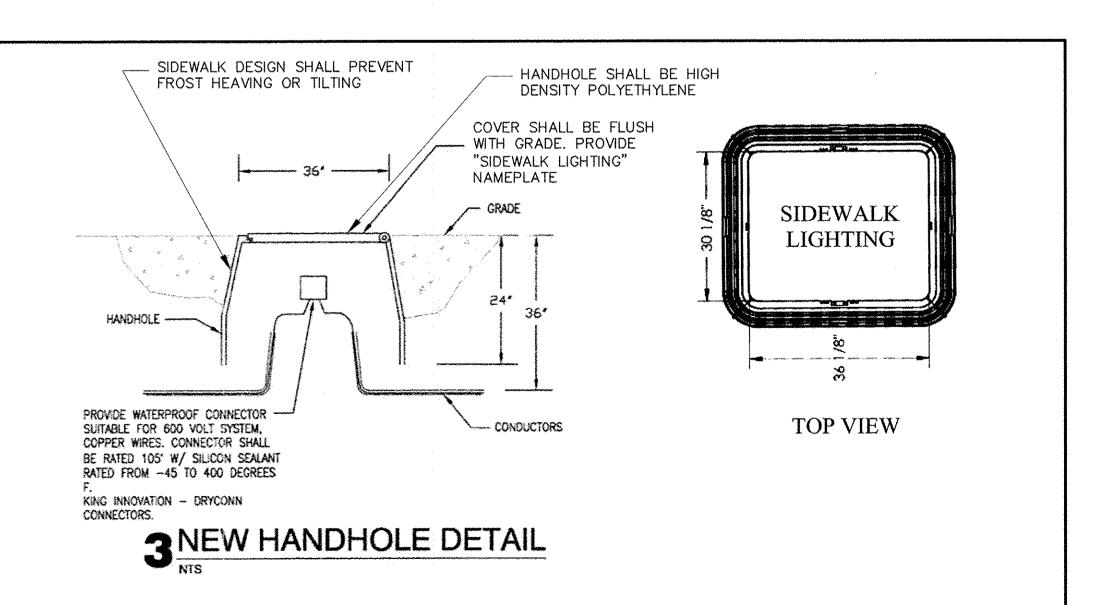

USER NAME =

PLOT SCALE =

PLOT DATE =

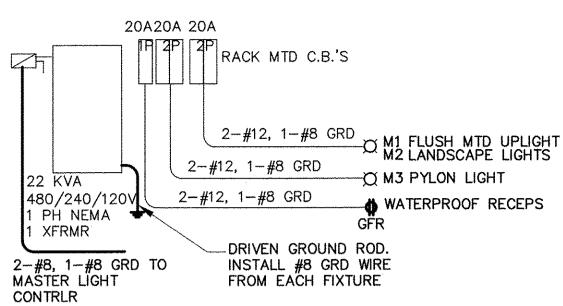

ELECTRIC RISER DIAGRAM

ВАН

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- 10/15

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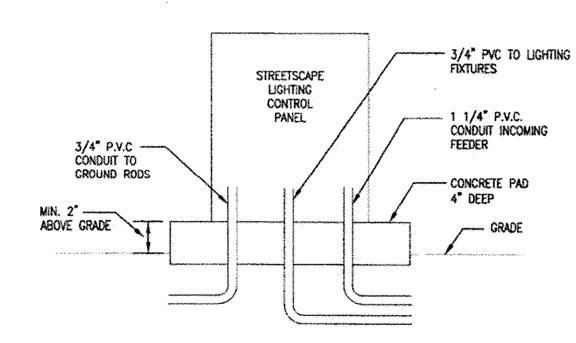
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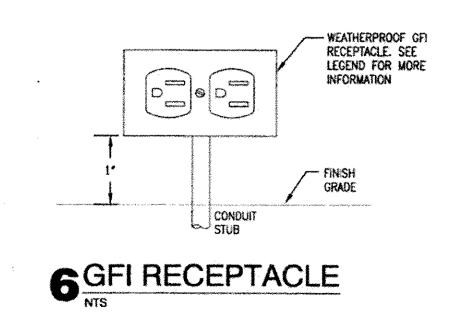
primes, militario, camania, meninter tentano esperimo citatione materiore melitario establica camania dell'archive appresso appre 6' OF EACH CABLE TO BE LOOPED IN HANDHOLE AND SUSPENDED FROM — 58 1/5. WIN -SEAL - EXIST. CABLE HOOKS 24' MIN -- 51 1/5, WIN --NOTE 1 AND 2 LOWER HALF OF WALLS TO INCREASE FROM 5" TO 9" IN THICKNESS, AS NEW CONDUIT - EXIST. FRENCH DRAIN EXIST. DRAINHOLE NOTES: 1. PROVIDE 18" OF SLACK CABLE AT HANDHOLE. 2. PROVIDE NEW CORES IN EXISTING MANHOLE FOR


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4 CONNECTION TO EXISTING HANDHOLE




5 ELECTRICAL CABINET (EXTERIOR) PAD MOUNTED



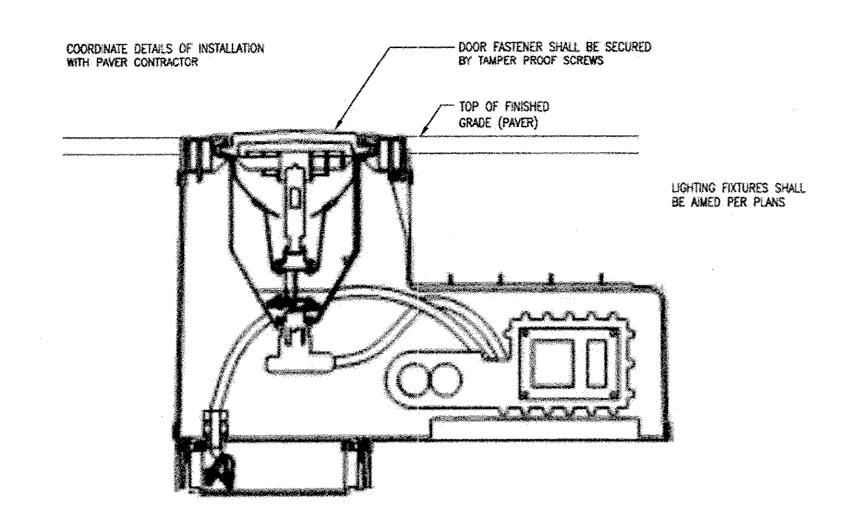


7LIGHTING FIXTURE BELOW GRADE (M1) (FLUSH MOUNTED)

– 240V, LED

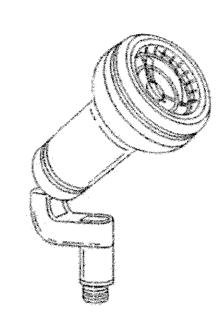

8 M2 LIGHTING FIXTURE - 240V, LED

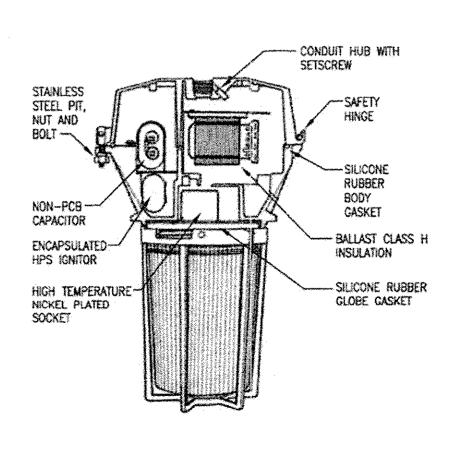

TO STA.


9 FIXTURE M3 DETAIL - 240V, LED


	Civil Eng Municipal Co	545 Plainfield Rd. ineers/STE.A	◆ Willowbroo	k, IL ◆ 605.	7 & Ass 27◆Telephone: (t L DESIGN FIRM	330) 887	-8640 ◆Fax: (6	
	F.A.P. RTE.	SEC	TION		COUNT	Υ	TOTAL SHEETS	SHEET NO.
:	330	10-0003	7-00-L	.S	COOK		34	24
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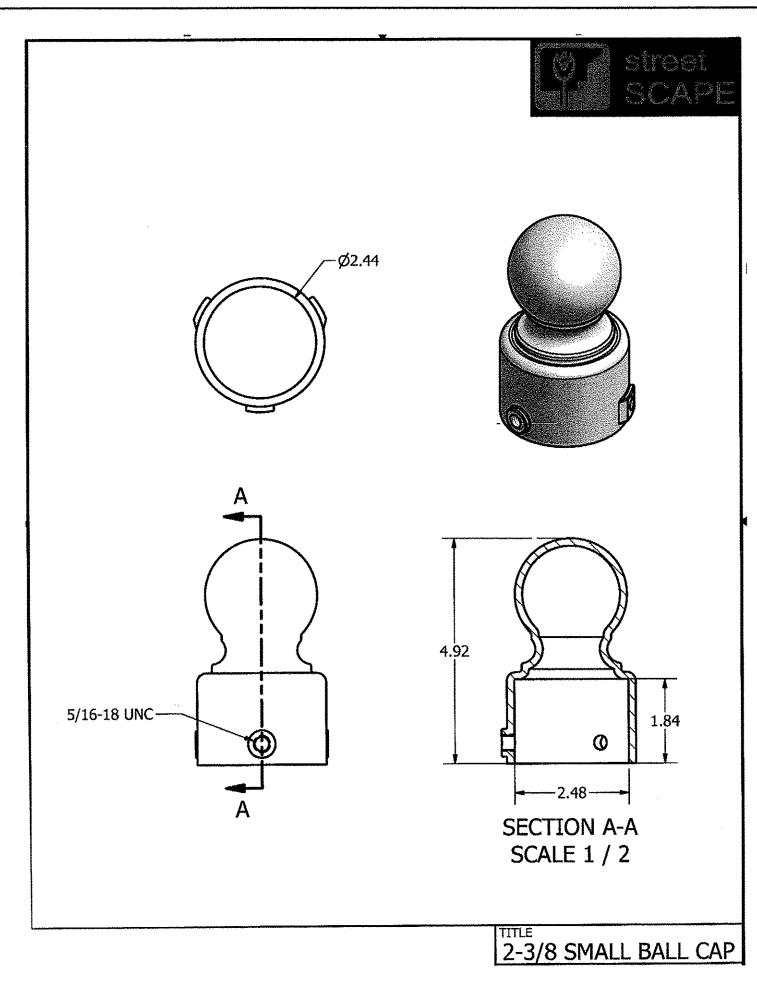
STATE OF ILLINOIS **DEPARTMENT OF TRANSPORTATION** **ELECTRICAL FIXTURE DETAILS**


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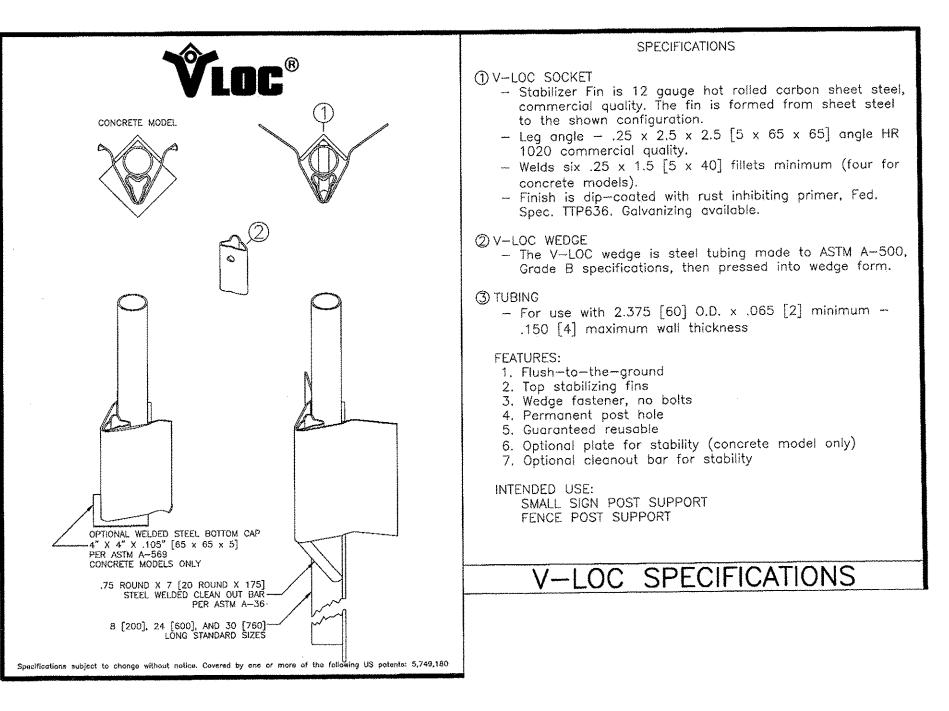
12/22/2016 2:36:54 PM






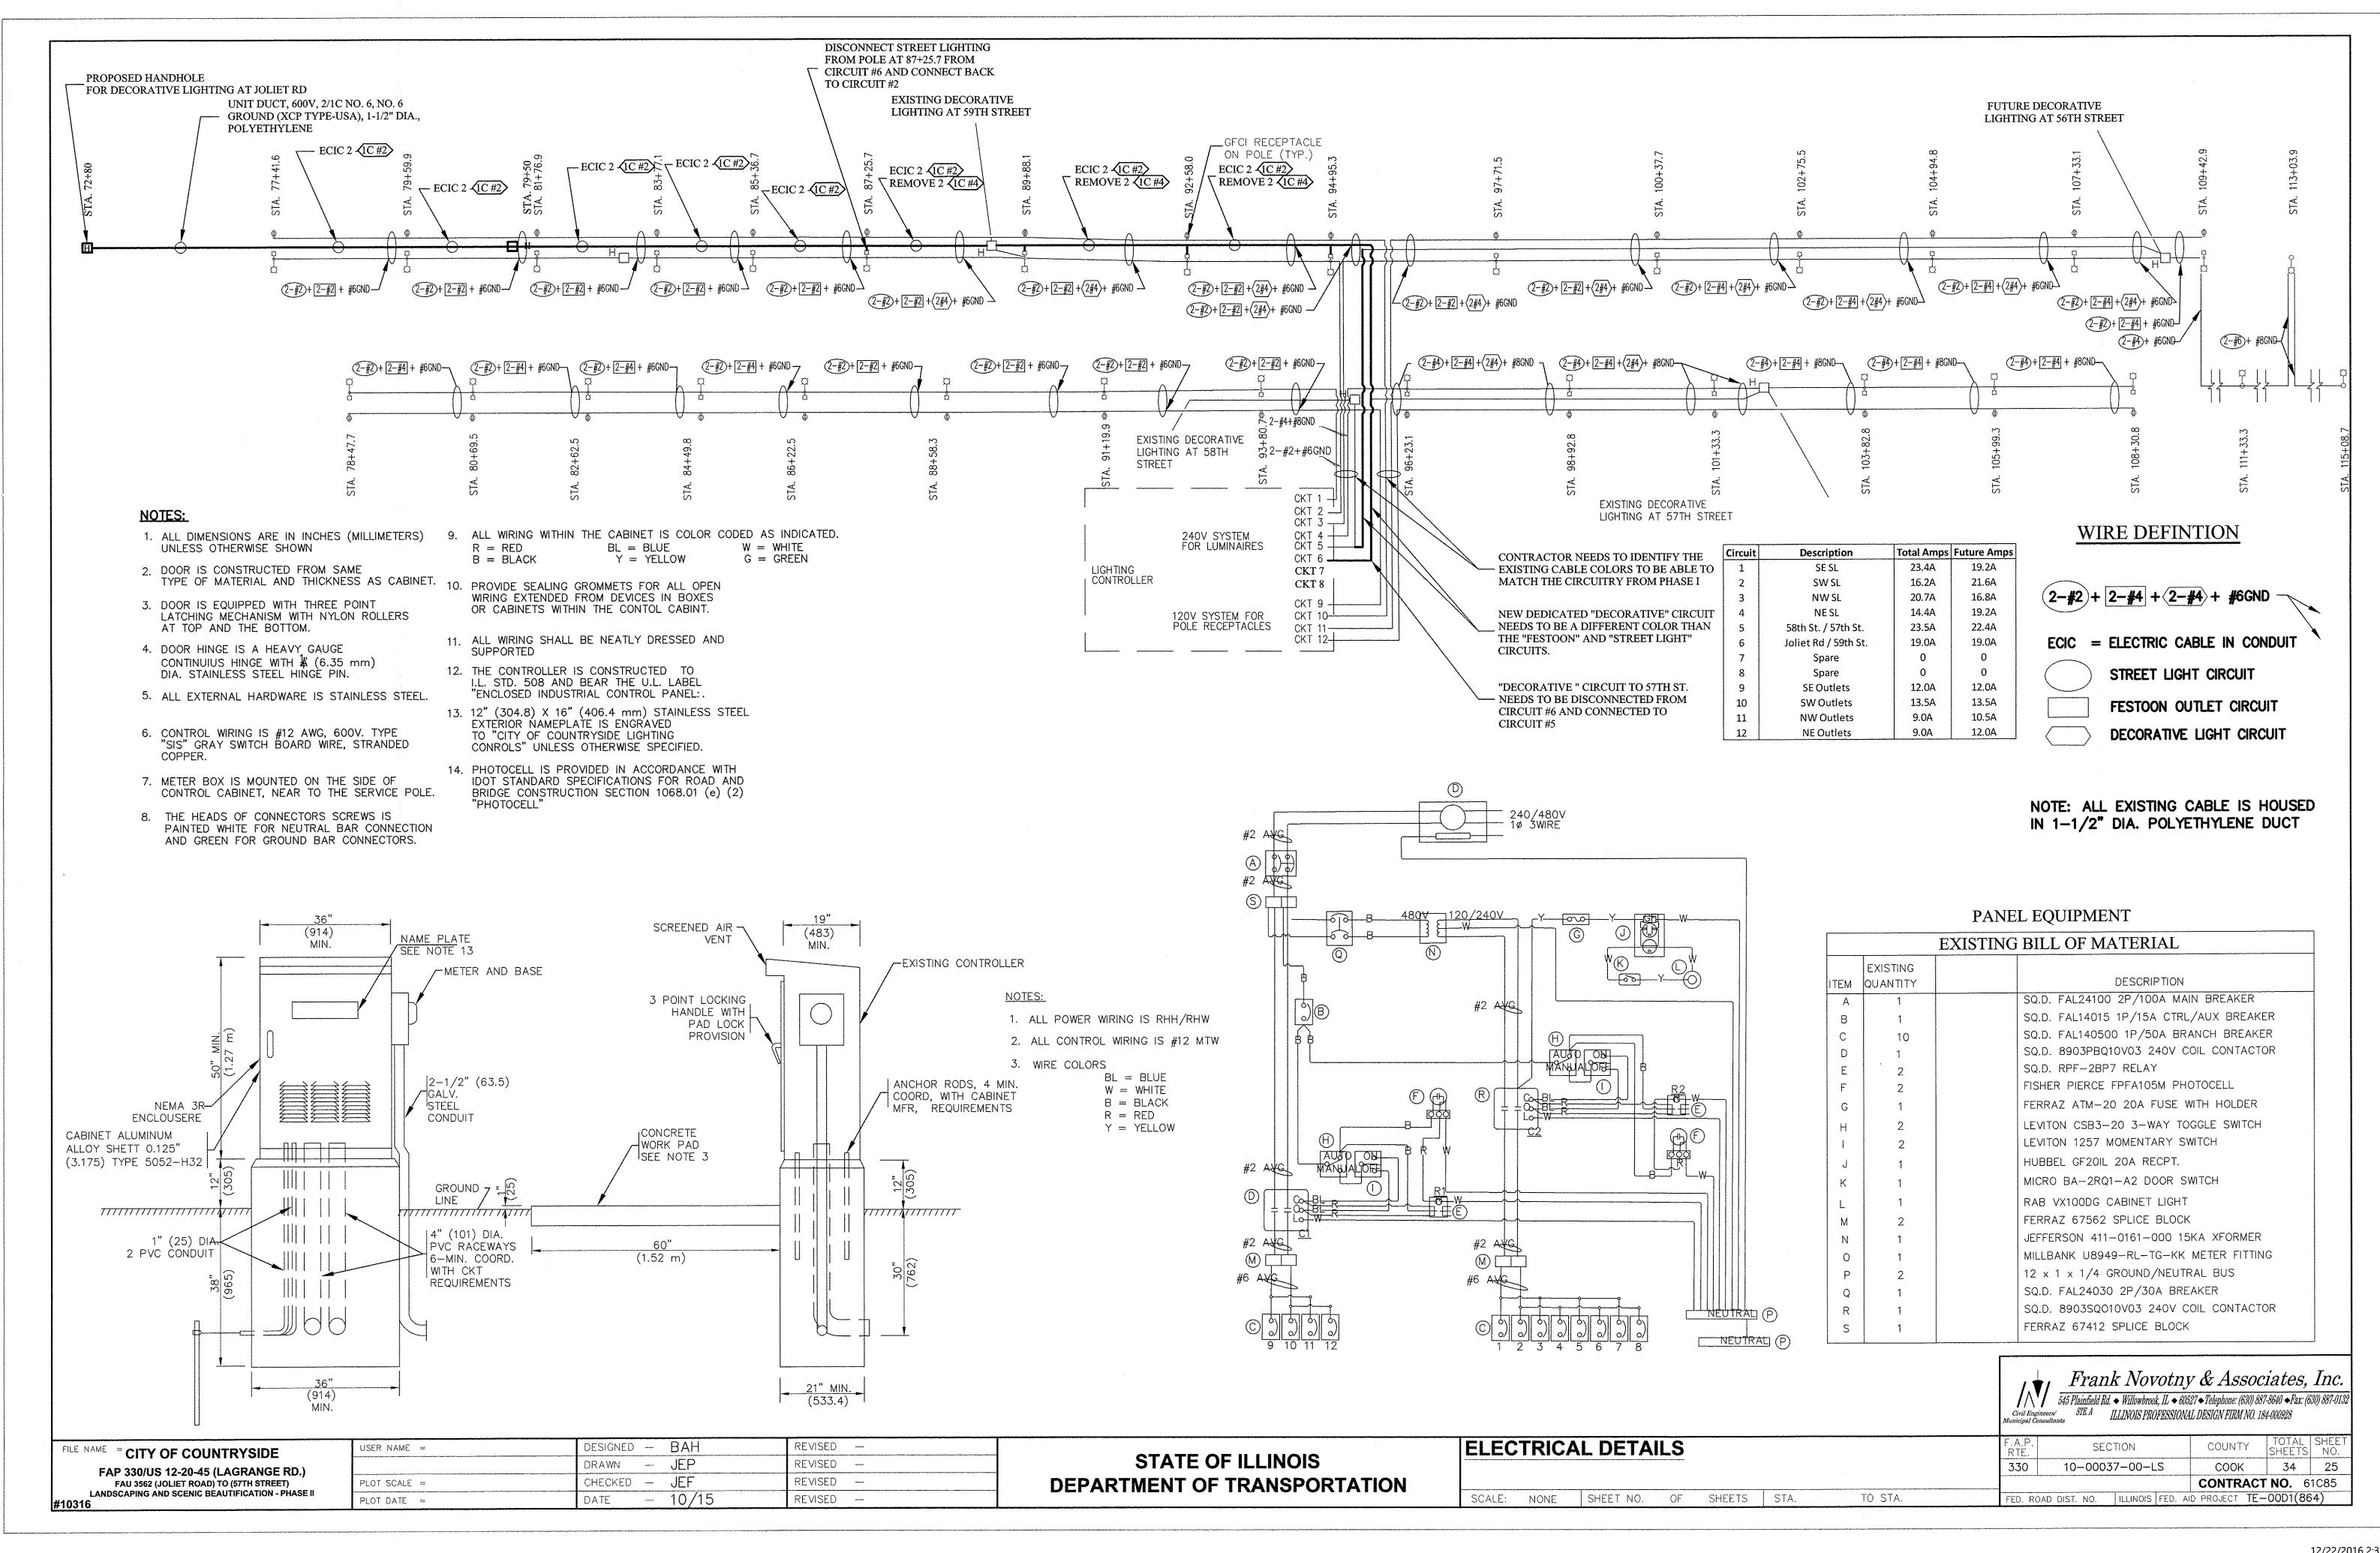

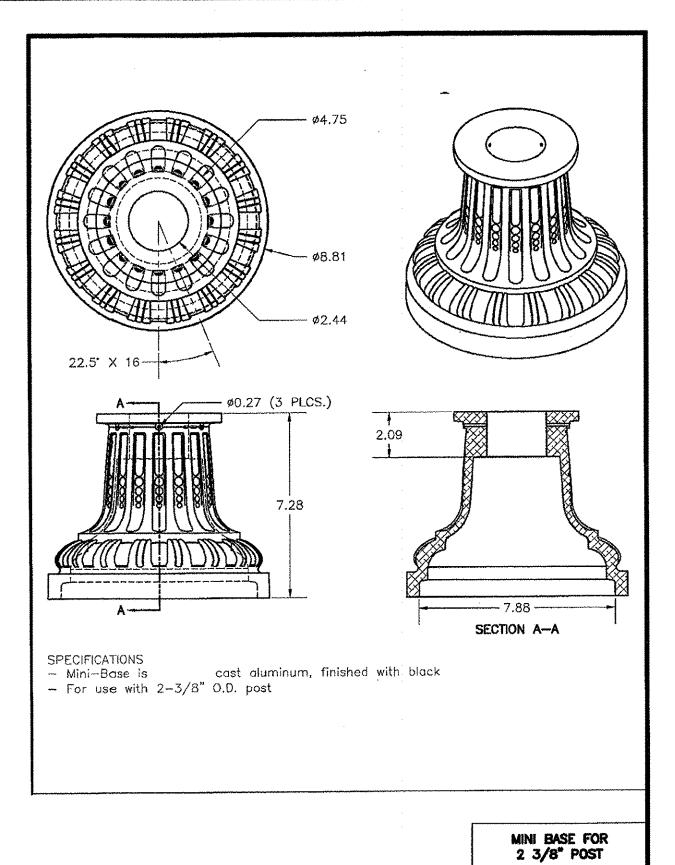

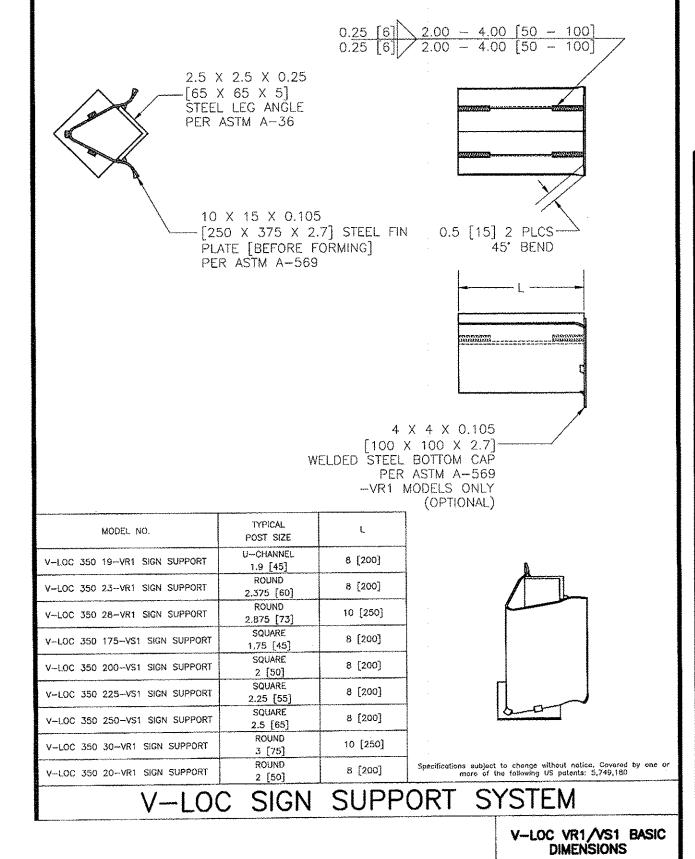

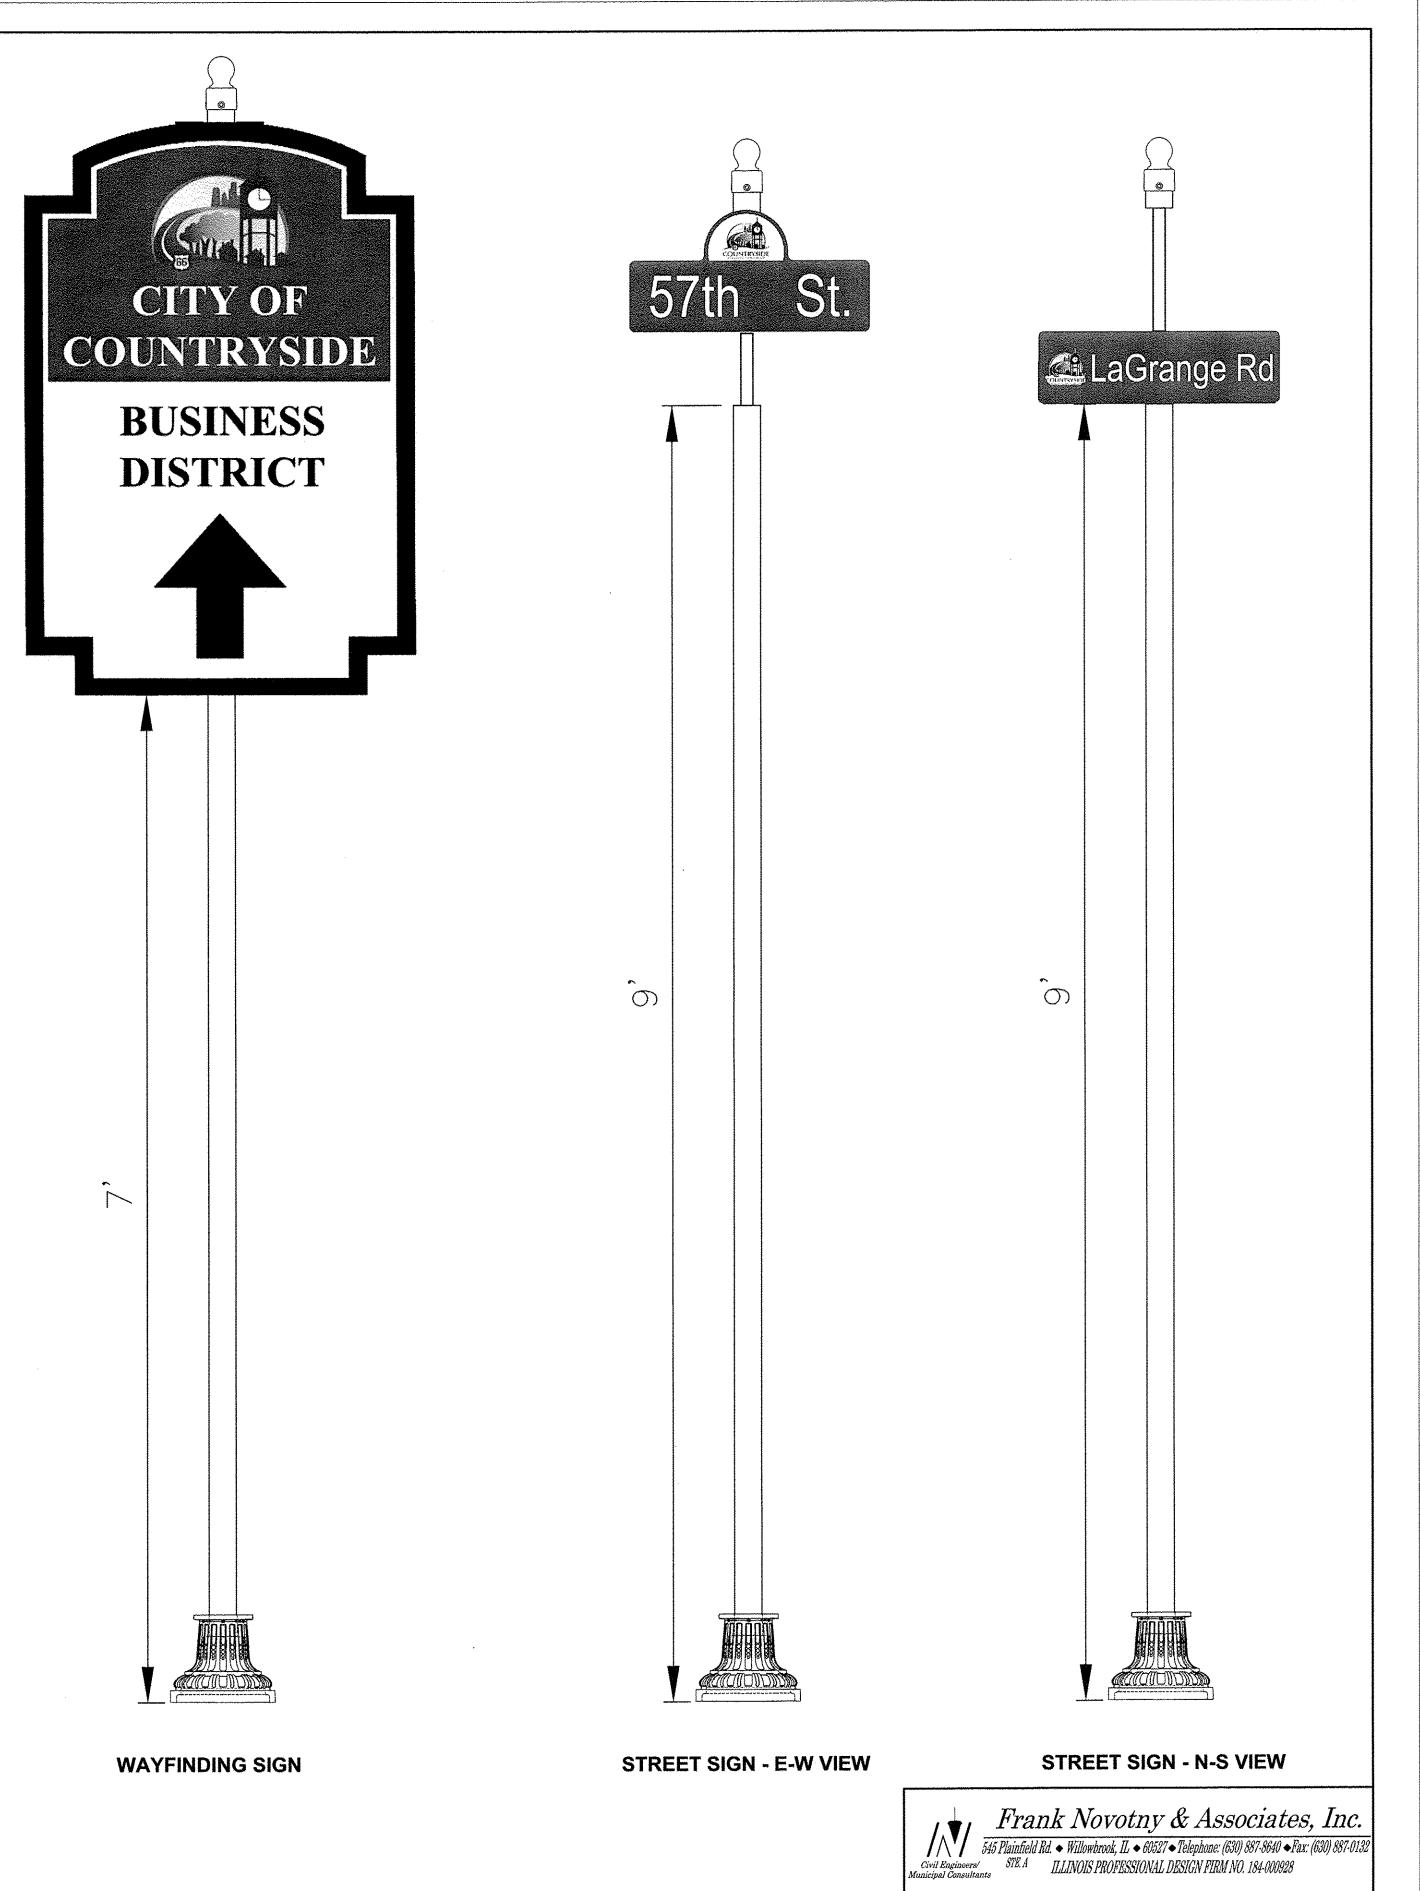



FILE NAME = CITY OF COUNTRYSIDE
FAP 330/US 12-20-45 (LAGRANGE RD.)
FAU 3562 (JOLIET ROAD) TO (57TH STREET)
LANDSCAPING AND SCENIC BEAUTIFICATION - PHASE II
#10316


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PLOT SCALE =	CHECKED		JEF	REVISED	W-M-
PLOT DATE =	DATE		10/15	REVISED	- Marie - Mari

STATE OF ILLINOIS
DEPARTMENT OF TRANSPORTATION

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IGN	POST	DETAIL	S					F.A.P. RTE.	SECTION	COUNTY	TOTAL SHEETS	SHEET NO.
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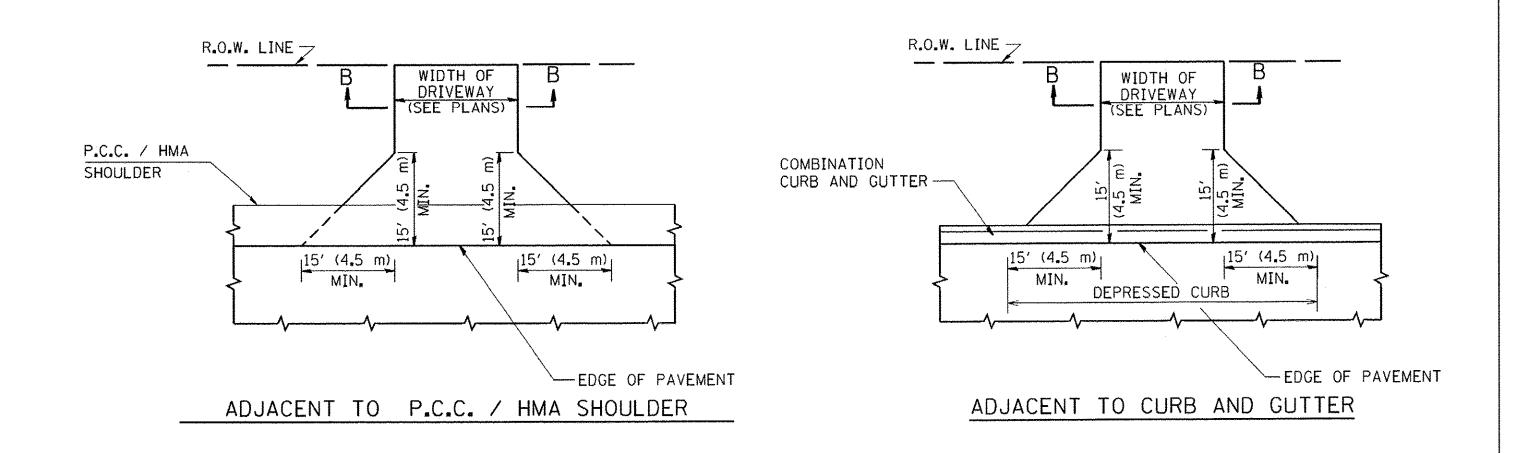


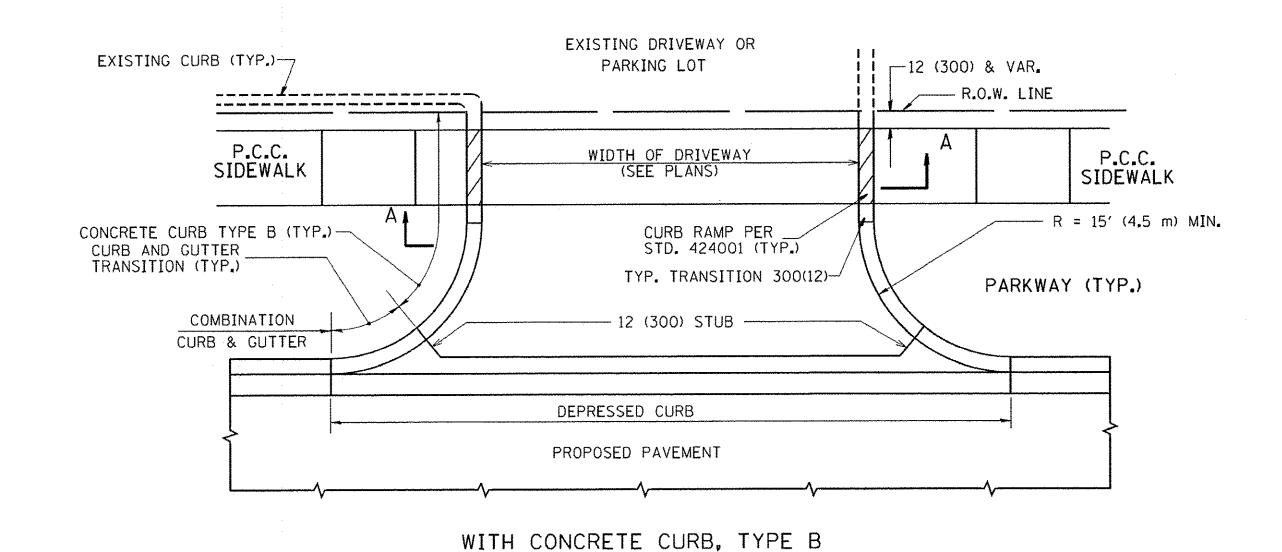


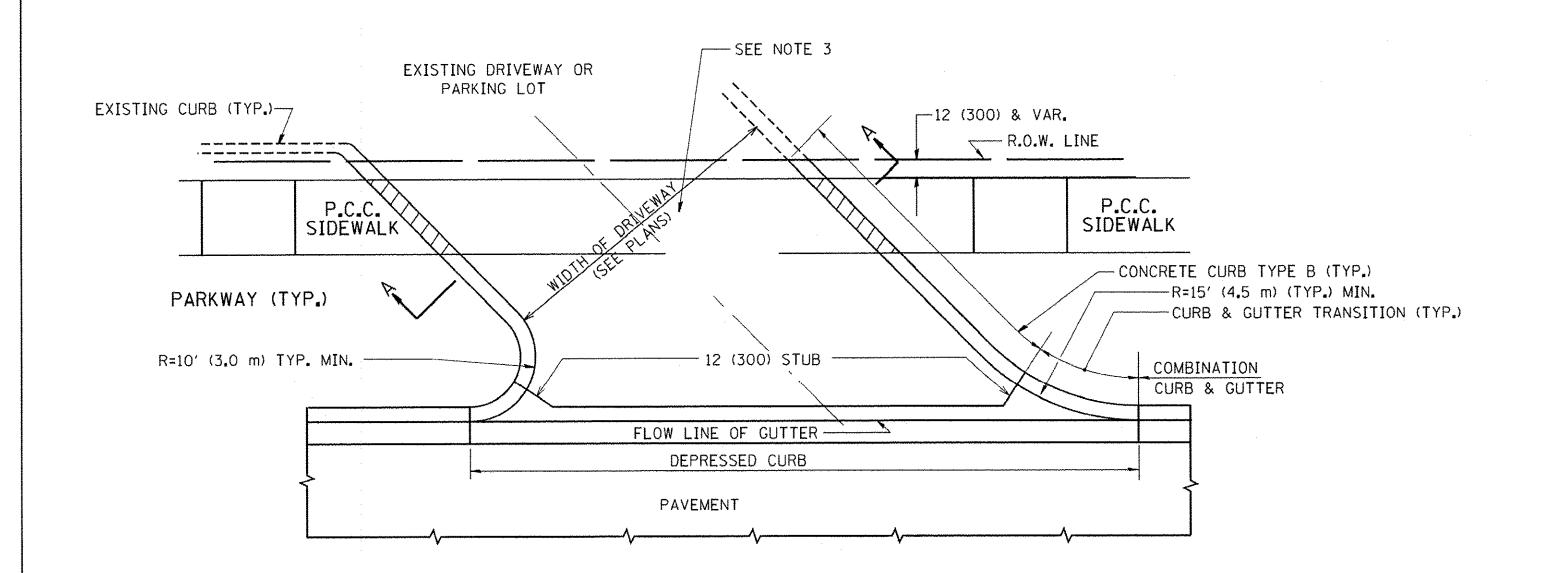
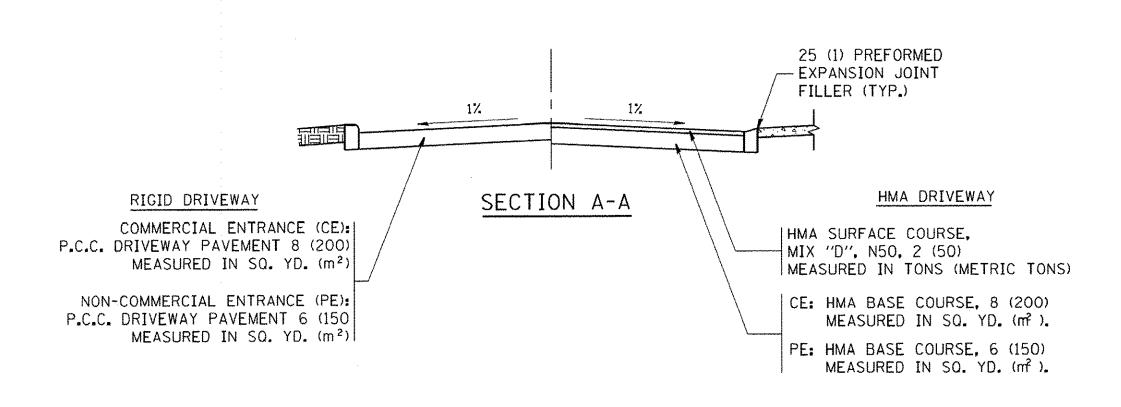
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WITH CONCRETE CURB, TYPE B



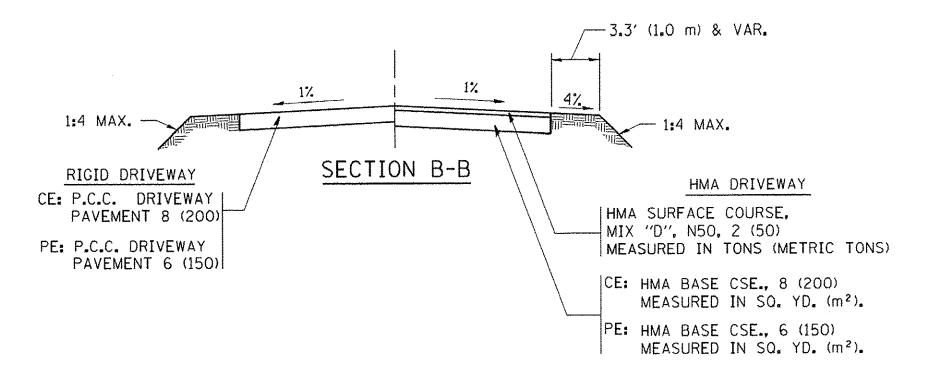

RURAL FIELD ENTRANCE (FE)

HMA SURFACE COURSE, MIX "D", N50, 2 (50) MEASURED IN TONS (METRIC TONS)

AGGREGATE BASE CSE., TYPE B, 8 (200) MEASURED IN SQ. YD. (m²).

GENERAL NOTES:

DRIVEWAY SLOPES, LOCATIONS, & GEOMETRIC LAYOUT SHALL BE IN ACCORDANCE WITH THE LATEST EDITION OF THE "HANDBOOK FOR POLICY ON PERMITS FOR ACCESS DRIVEWAYS TO STATE HIGHWAYS". FOR FURTHER LAYOUT REQUIREMENTS, REFER TO ILLUSTRATIONS IN THE PERMIT HANDBOOK. DRIVEWAYS SHALL BE REPLACED IN KIND, UNLESS OTHERWISE NOTED ON THE PLANS.

COMMERCIAL DRIVEWAYS SHALL BE CONSTRUCTED WITH CONCRETE CURB, TYPE B RETURNS EXCEPT WHEN THE SIDEWALK EDGE IS 4 FEET (1.2 METERS) OR LESS FROM THE BACK OF CURB, CONSTRUCT A FLARE DRIVEWAY WITHOUT CURB.


THE RESIDENT ENGINEER SHALL CONTACT THE TRAFFIC PERMIT OFFICE AT 847/ 705-4131 FOR ANY QUESTIONS ON DRIVEWAYS SHOWN IN THE PLANS; SPECIFICALLY IN REFERENCE TO ADDITIONAL AND/OR RELOCATION/REMOVAL OF A DRIVEWAY.


COMBINATION CONCRETE CURB & GUTTER SHALL BE MEASURED STRAIGHT ACROSS THE DRIVEWAY. NO ADDITIONAL COMPENSATION WILL BE ALLOWED FOR THE CURB & GUTTER TRANSITION.

1 (25) PREFORMED EXPANSION JOINT FILLER WILL NOT BE PAID SEPARATELY, BUT SHALL BE CONSIDERED INCLUDED IN THE COST OF THE P.C.C. DRIVEWAY PAVEMENT OR P.C.C. SIDEWALK.

WHEN THE P.C.C. SIDEWALK EXTENDS THROUGH THE DRIVEWAY, THE THICKNESS OF THE SIDEWALK IN THE DRIVEWAY AREA SHALL BE THE SAME AS THE DRIVEWAY THICKNESS. SIDEWALK WILL BE PAID FOR AS P.C.C. SIDEWALK OF THE THICKNESS SPECIFIED. SIDEWALK CROSS SLOPE THRU DRIVEWAY AREA TO BE A MAXIMUM OF 1:50.

FILE NAME =	USER NAME = leysa	DESIGNED - R. SHAH	REVISED - P. LaFLUER 04-15-03		DRIVEWAY DETAILS - DISTANCE BETWEEN R.O.W.	F.A.P. SECTION COUNTY SHEETS NO
c:\pw_work\pwidot\leysa\d0108315\bd01.d	gr	DRAWN -	REVISED - R. BORO 01-01-07	STATE OF ILLINOIS		330 10-00037-00-LS COOK 34 27
	PLOT SCALE = 50.0000 '/ in.	CHECKED -	REVISED - R. BORO 06-11-08	DEPARTMENT OF TRANSPORTATION	AND FACE OF CURB & EDGE OF SHOULDER > = 15' (4.5 m)	BD0156-07 (BD-01) CONTRACT NO. 61C85
	PLOT DATE = 9/6/2011	DATE - 11-04-95	REVISED - R. BORO 09-06-11		SCALE: NONE SHEET NO. 1 OF 1 SHEETS STA. TO STA.	FED. ROAD DIST. NO. 1 ILLINOIS FED. AID PROJECT TE-00D1(864)

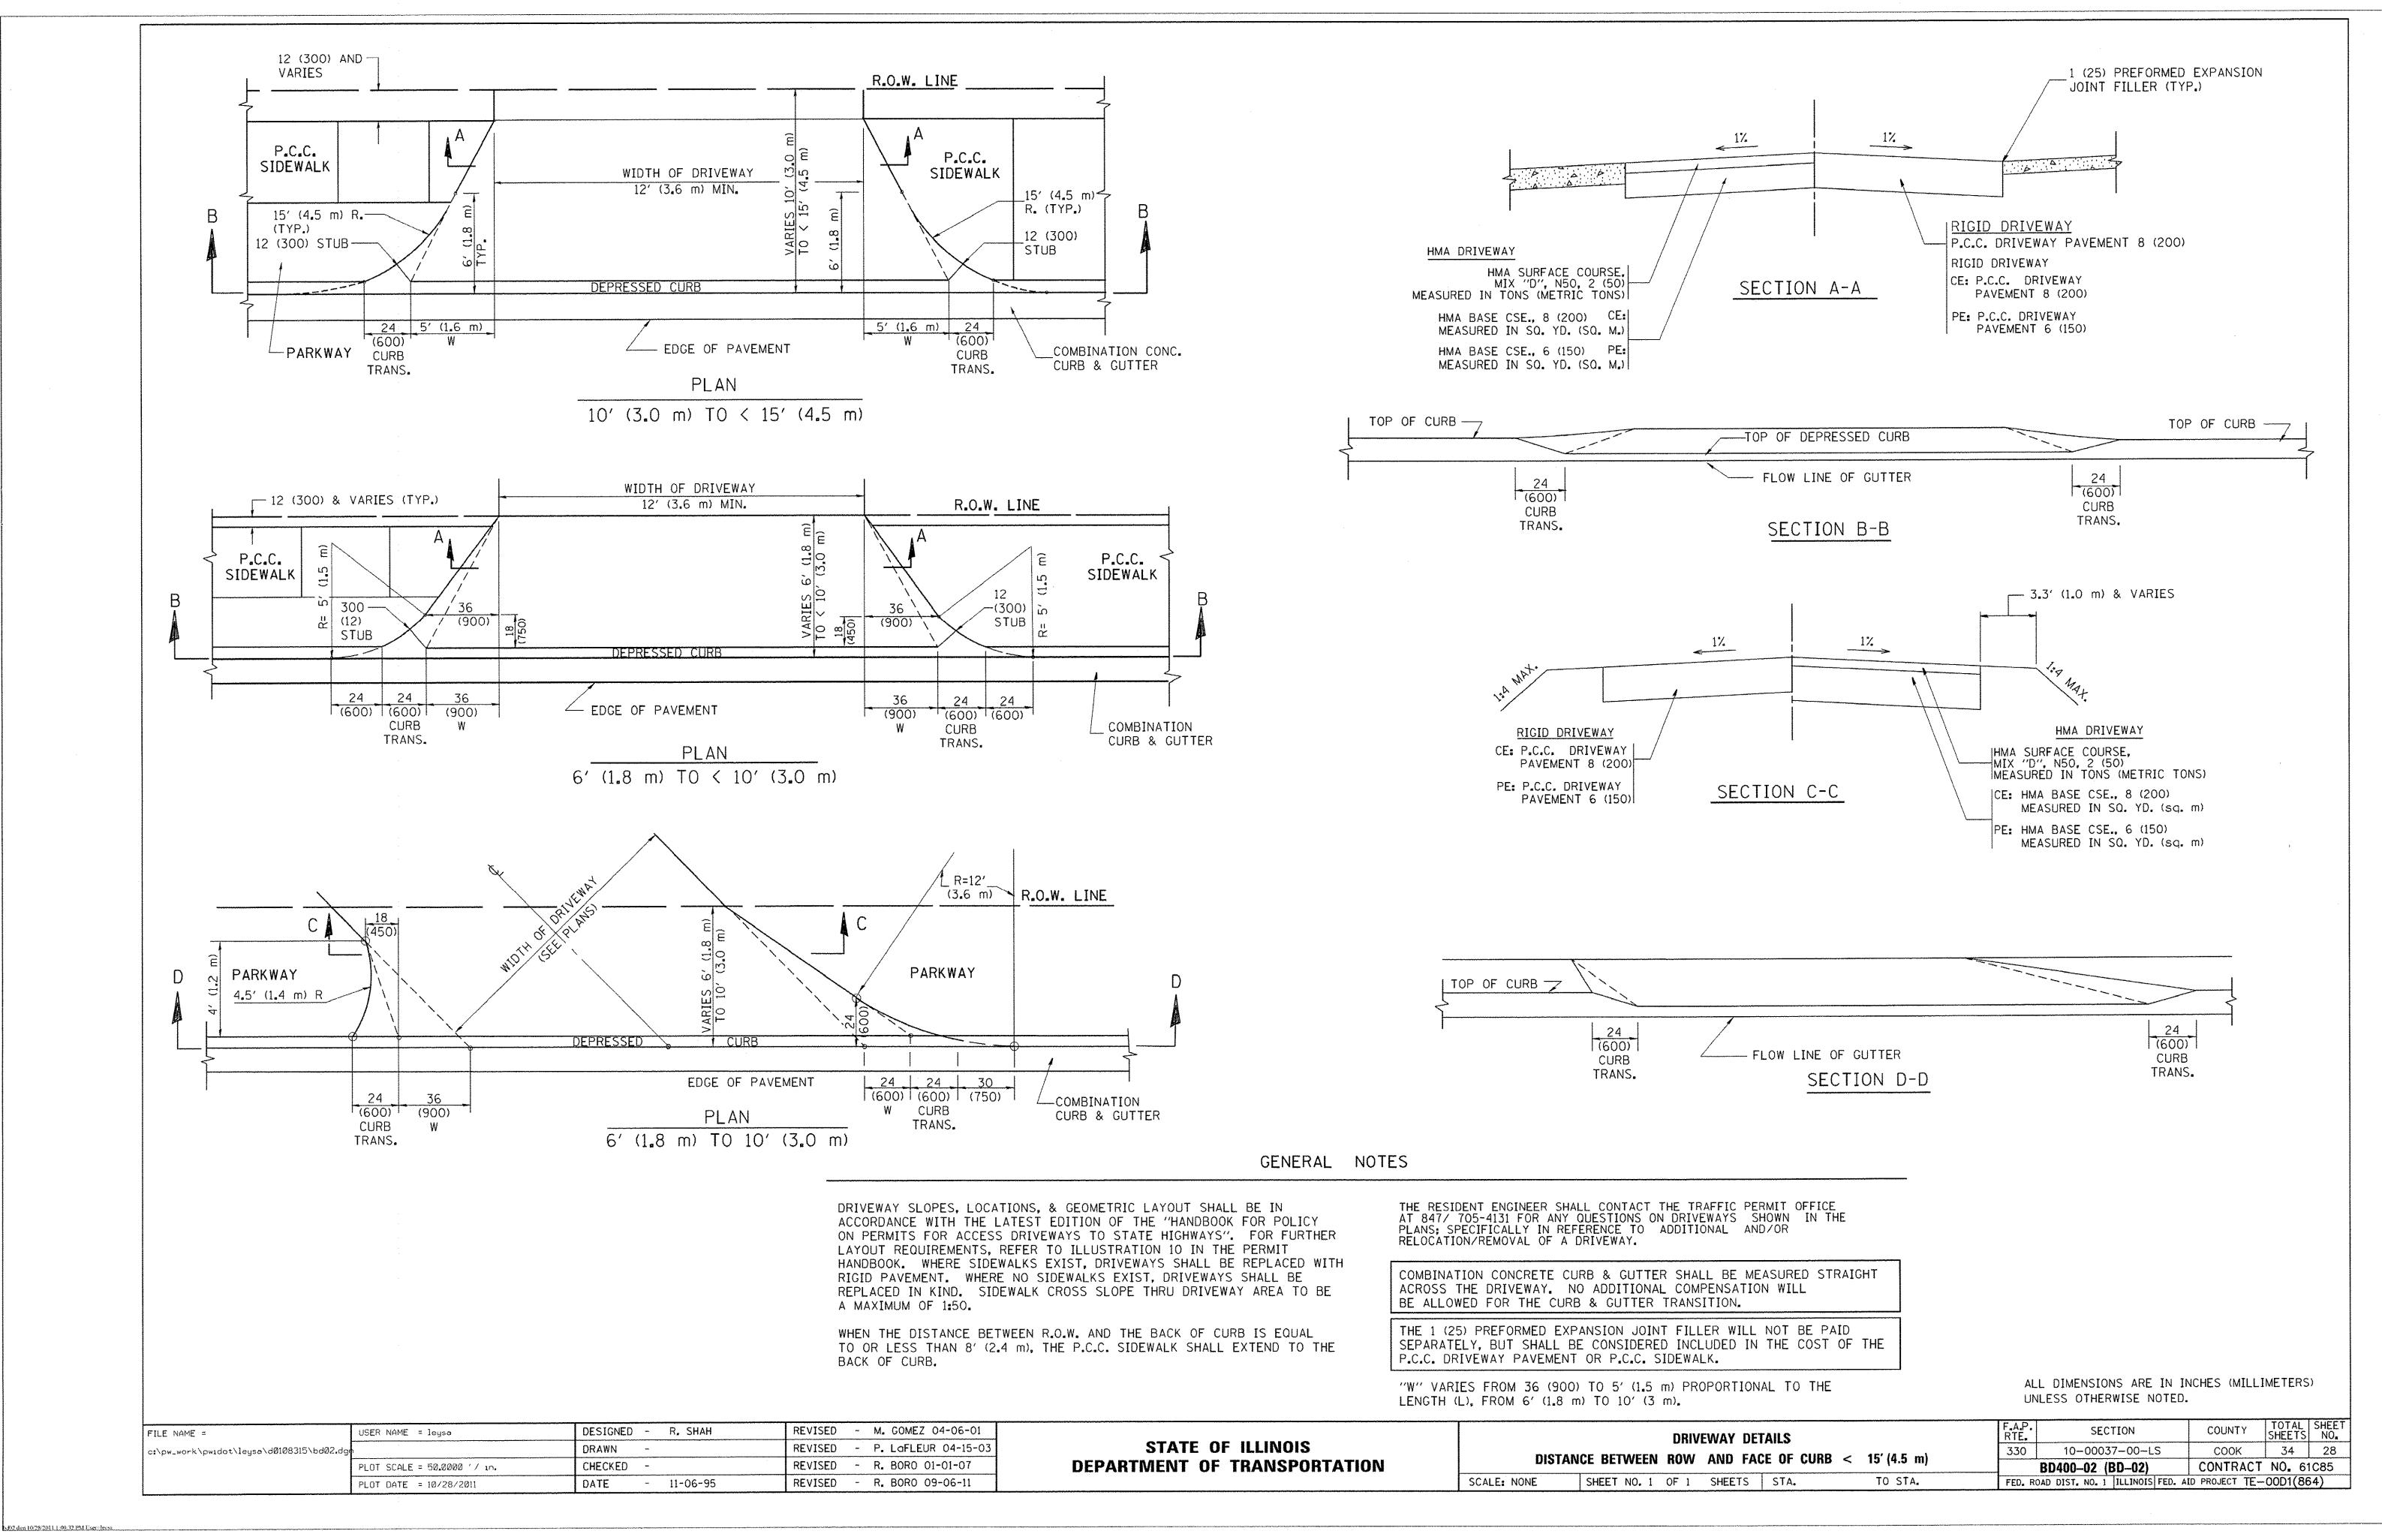


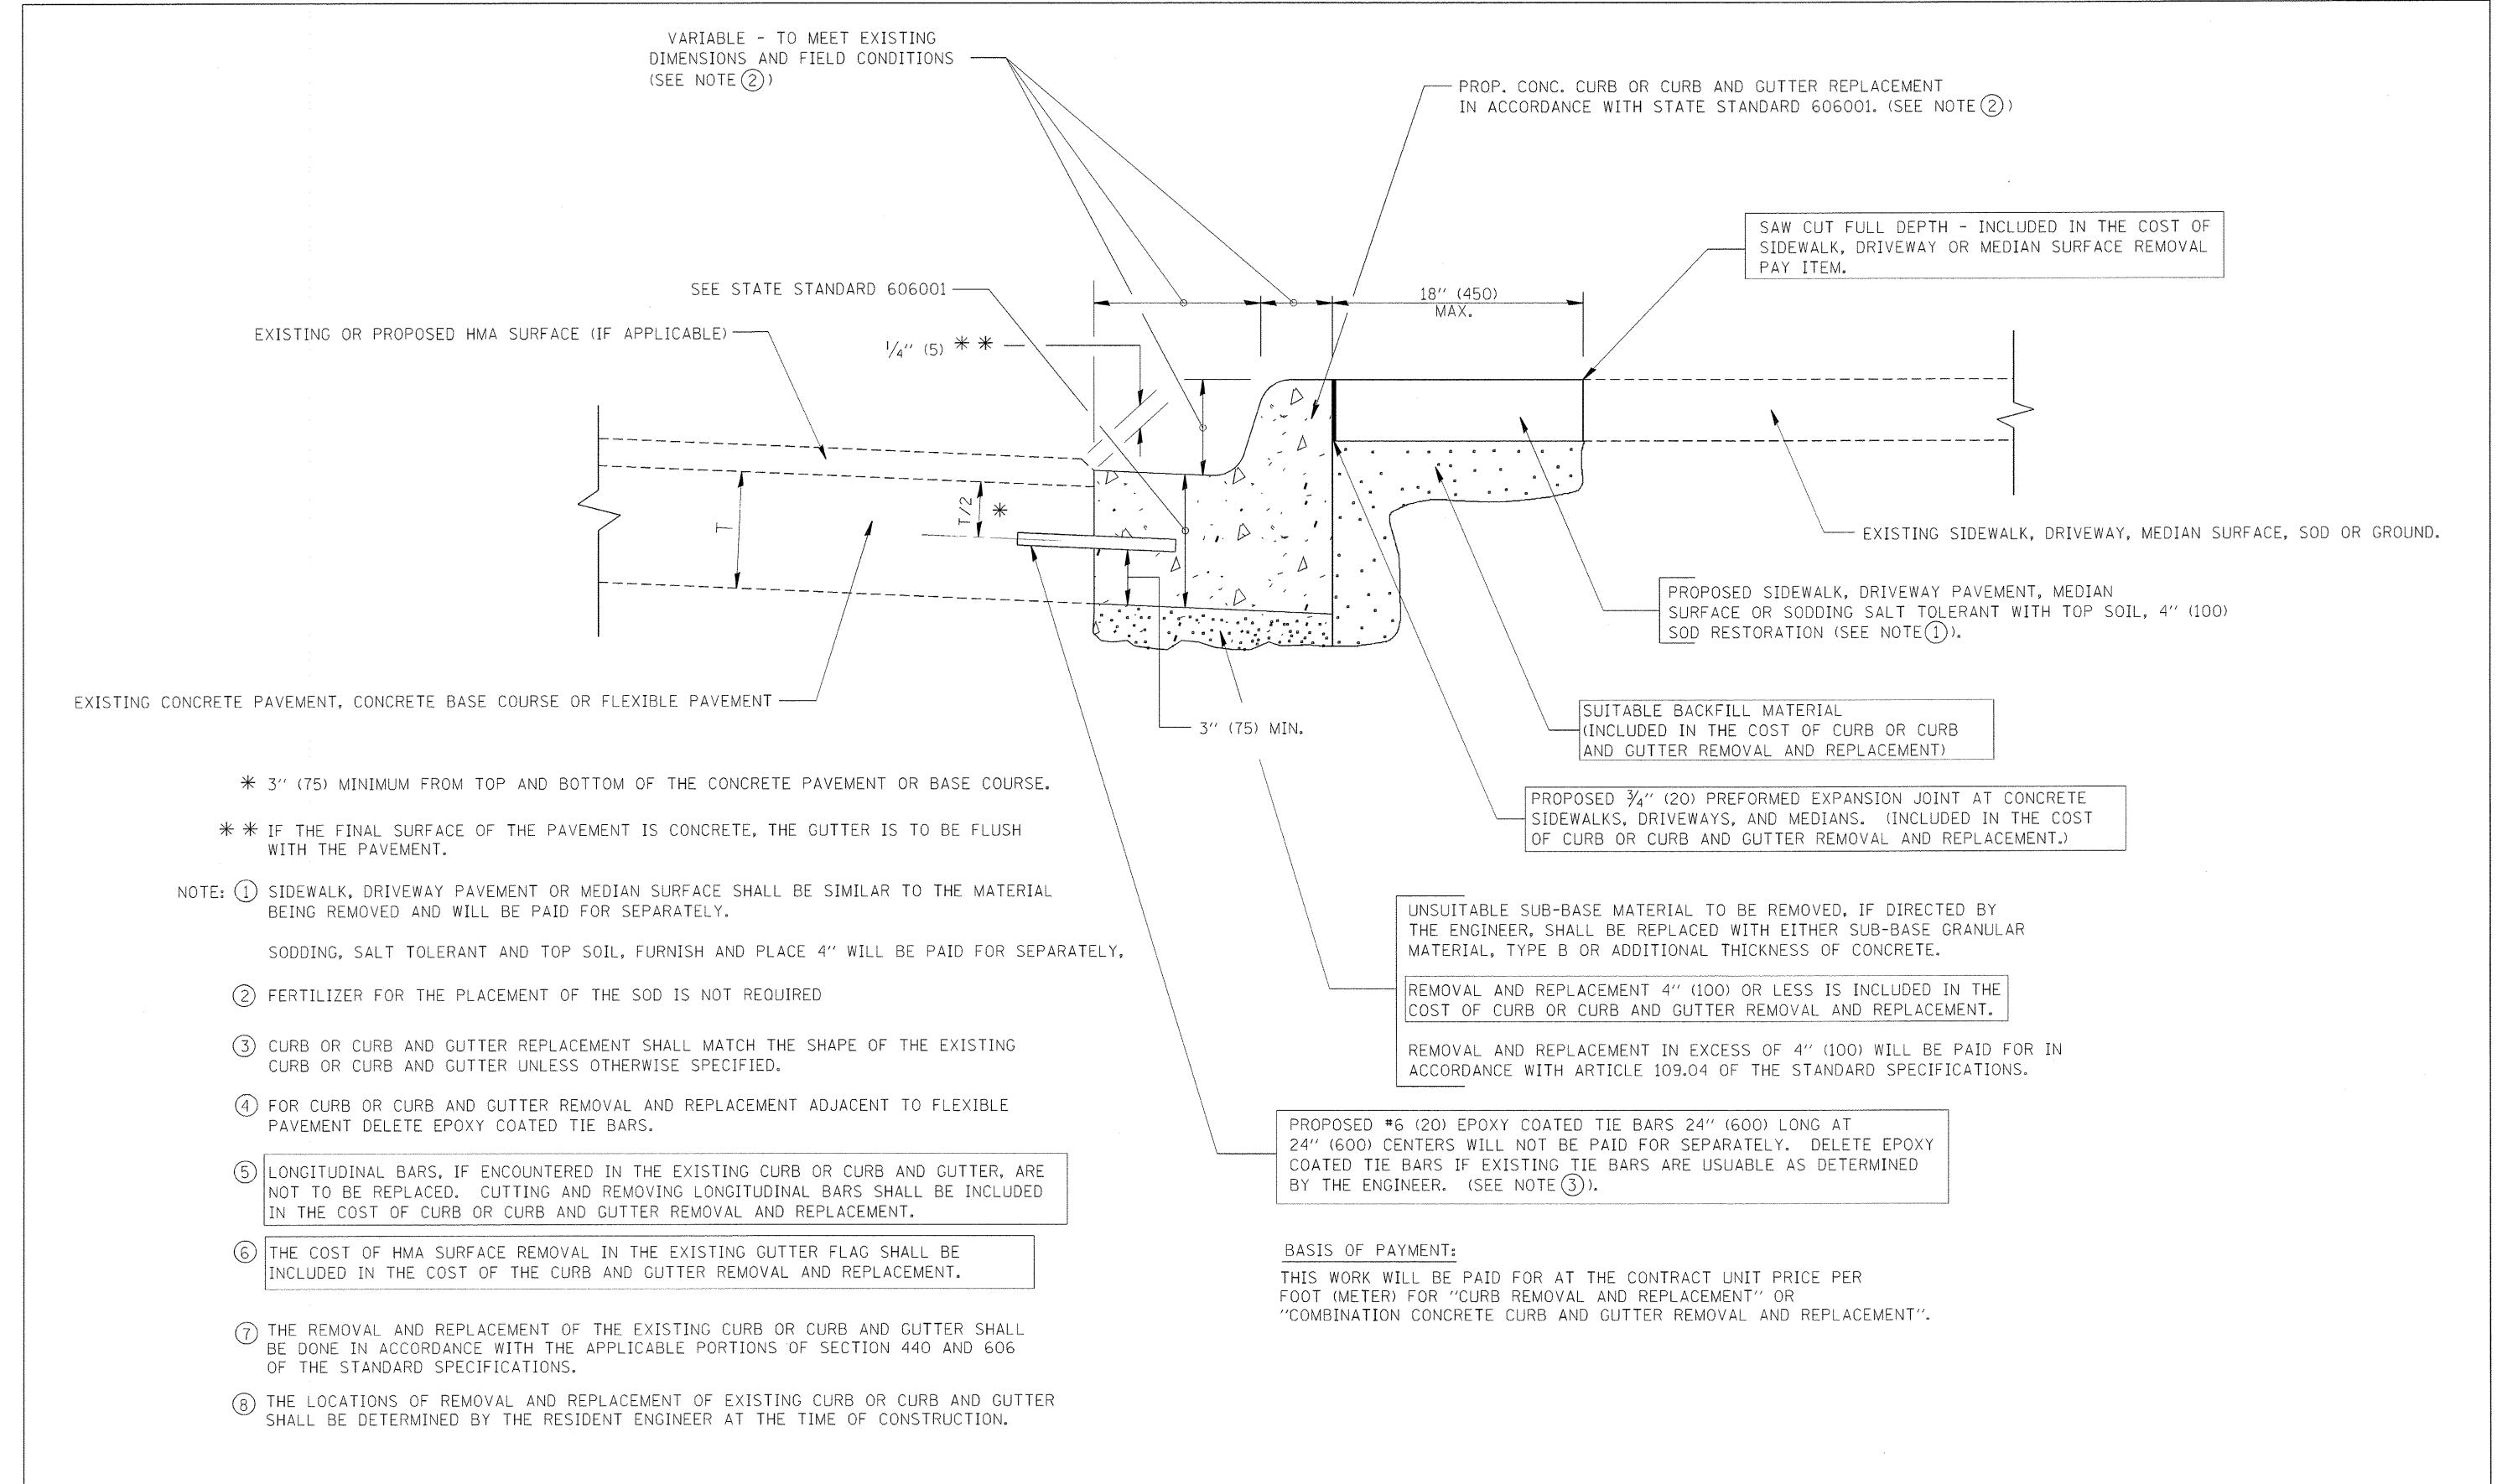

CURB OR CURB AND GUTTER REMOVAL AND REPLACEMENT

ALL DIMENSIONS ARE IN INCHES (MILLIMETERS)
UNLESS OTHERWISE SHOWN.

FILF NAME =	JSER NAME = drivakosgn	DESIGNED - A. HOUSEH	REVISED - R. SHAH 10-03-96		CURB OR CURB AND GUTTER	F.A.P. SECTION COUNTY SHEET SHEET NO.
c:\pw_work\pwidot\drivakosgn\d0108315\bd24	l.dgn	DRAWN -	REVISED - A. ABBAS 03-21-97	STATE OF ILLINOIS		330 10-00037-00-LS COOK 34 29
F	PLOT SCALE = 50.000 '/ IN.	CHECKED -	REVISED - M. GOMEZ 01-22-01	DEPARTMENT OF TRANSPORTATION	REMOVAL AND REPLACEMENT	BD600-06 (BD-24) CONTRACT NO. 61C85
F	PLOT DATE = 12/15/2009	DATE - 03-11-94	REVISED - R. BORO 12-15-09		SCALE: NONE SHEET NO. 1 OF 1 SHEETS STA. TO STA.	FED. ROAD DIST. NO. 1 ILLINOIS FED. AID PROJECT TE-00D1(864)

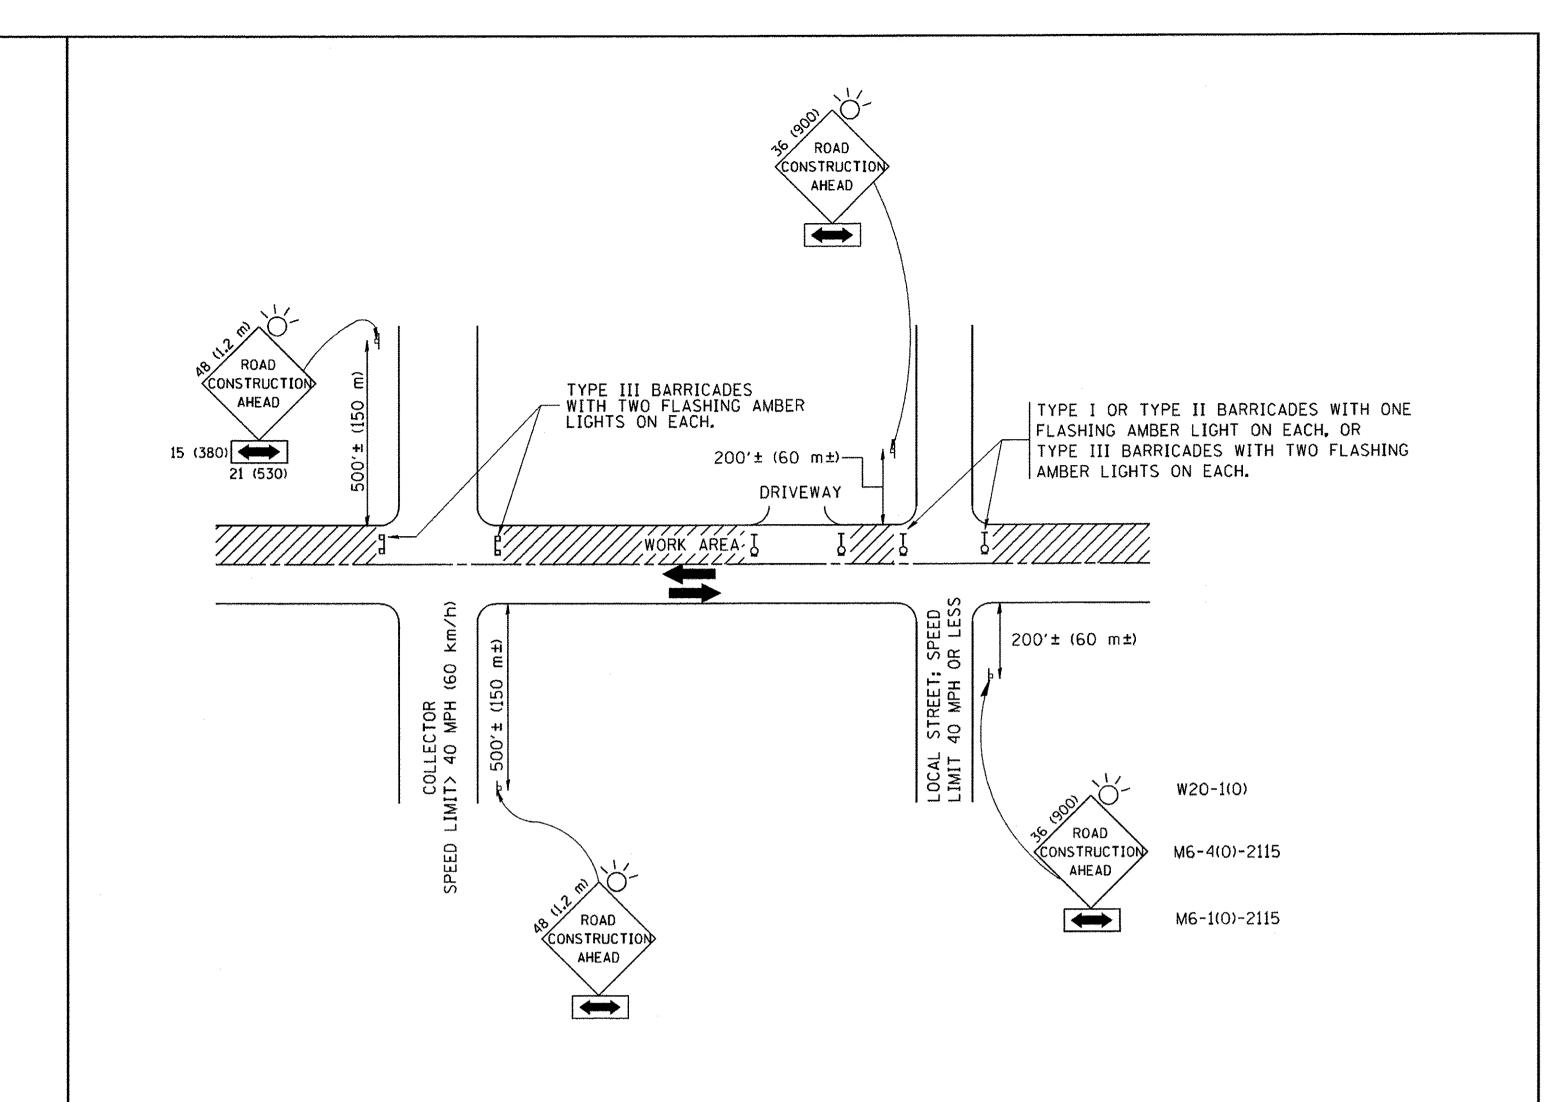

TRAFFIC CONTROL AND PROTECTION FOR SIDE ROADS, INTERSECTIONS, AND DRIVEWAYS

NOTES:

- A. FOR NO LANE RESTRICTION ON THE SIDE ROAD OR DRIVEWAYS
- 1. SIDE ROAD WITH A SPEED LIMIT OF 40 MPH (60 km/h) OR LESS AS SHOWN ON THE DRAWING AND AS DIRECTED BY THE ENGINEER:
- ONE ROAD CONSTRUCTION AHEAD SIGN 36 × 36 (900×900) WITH A FLASHER AND FLAG MOUNTED ON IT APPROXIMATELY 200' (60 m) IN ADVANCE OF THE MAIN ROUTE.
- b) THE CLOSED PORTION OF THE MAIN ROUTE SHALL BE PROTECTED BY BLOCKING WITH TYPE I, TYPE II OR TYPE III BARRICADES, 1/3 OF THE CROSS SECTION OF THE CLOSED PORTION.
- 2. SIDE ROAD WITH A SPEED LIMIT GREATER THAN 40 MPH (60 km/h) AS SHOWN ON THE DRAWING AND AS DIRECTED BY THE ENGINEER:
- a) ONE ROAD CONSTRUCTION AHEAD SIGN 48 × 48 (1.2 m × 1.2 m) WITH A FLASHER MOUNTED ON IT APPROXIMATELY 500' (150 m) IN ADVANCE OF THE MAIN ROUTE.
- b) THE CLOSED PORTION OF THE MAIN ROUTE SHALL BE PROTECTED BY BLOCKING WITH TYPE III BARRICADES, 1/2 OF THE CROSS SECTION OF THE CLOSED PORTION.
- 3. WHEN THE SIDE ROAD LIES BETWEEN THE BEGINNING OF THE MAINLINE SIGNING AND THE WORK ZONE, A SINGLE HEADED ARROW (M6-1) SHALL BE USED IN LIEU OF THE DOUBLE HEADED ARROW (M6-4).

- B. FOR A LANE CLOSURE ON A SIDE ROAD OR DRIVEWAY:
- USE APPLICABLE PORTIONS OF THE TYPICAL APPLICATION OF TRAFFIC CONTROL DEVICES (STD. 701501, STD. 701606 OR THE APPROPRIATE STANDARD). THE SPACING OF SIGNS AND BARRICADES SHALL BE ADJUSTED FOR FIELD CONDITIONS AS DIRECTED BY THE ENGINEER. THE DIRECTIONAL ARROW SHALL BE COVERED OR REMOVED WHEN NO LONGER CONSISTENT WITH THE SIDE ROAD LANE CLOSURE.
- C. ADVANCE WARNING SIGNS ARE TO BE OMITTED ON DRIVEWAY UNLESS OTHERWISE NOTED.
- D. THE TRAFFIC CONTROL AND PROTECTION FOR SIDE ROADS, INTERSECTIONS, AND DRIVEWAYS SHALL BE INCIDENTAL TO THE COST OF SPECIFIED TRAFFIC CONTROL STANDARDS OR ITEMS.

All dimensions are in millimeters (inches) unless otherwise shown.

STATE OF ILLINOIS
DEPARTMENT OF TRANSPORTATION

TRAFFIC CONTROL AND PROTECTION FOR SIDE ROADS, INTERSECTIONS, AND DRIVEWAYS


SCALE: NONE SHEET NO. 1 OF 1 SHEETS STA. TO STA.


F.A.P. SECTION COUNTY TOTAL SHEETS NO.

330 10-00037-00-LS COOK 34 30

TC-10 CONTRACT NO. 61C85

FED. ROAD DIST. NO. 1 ILLINOIS FED. AID PROJECT TE-00D1(864)

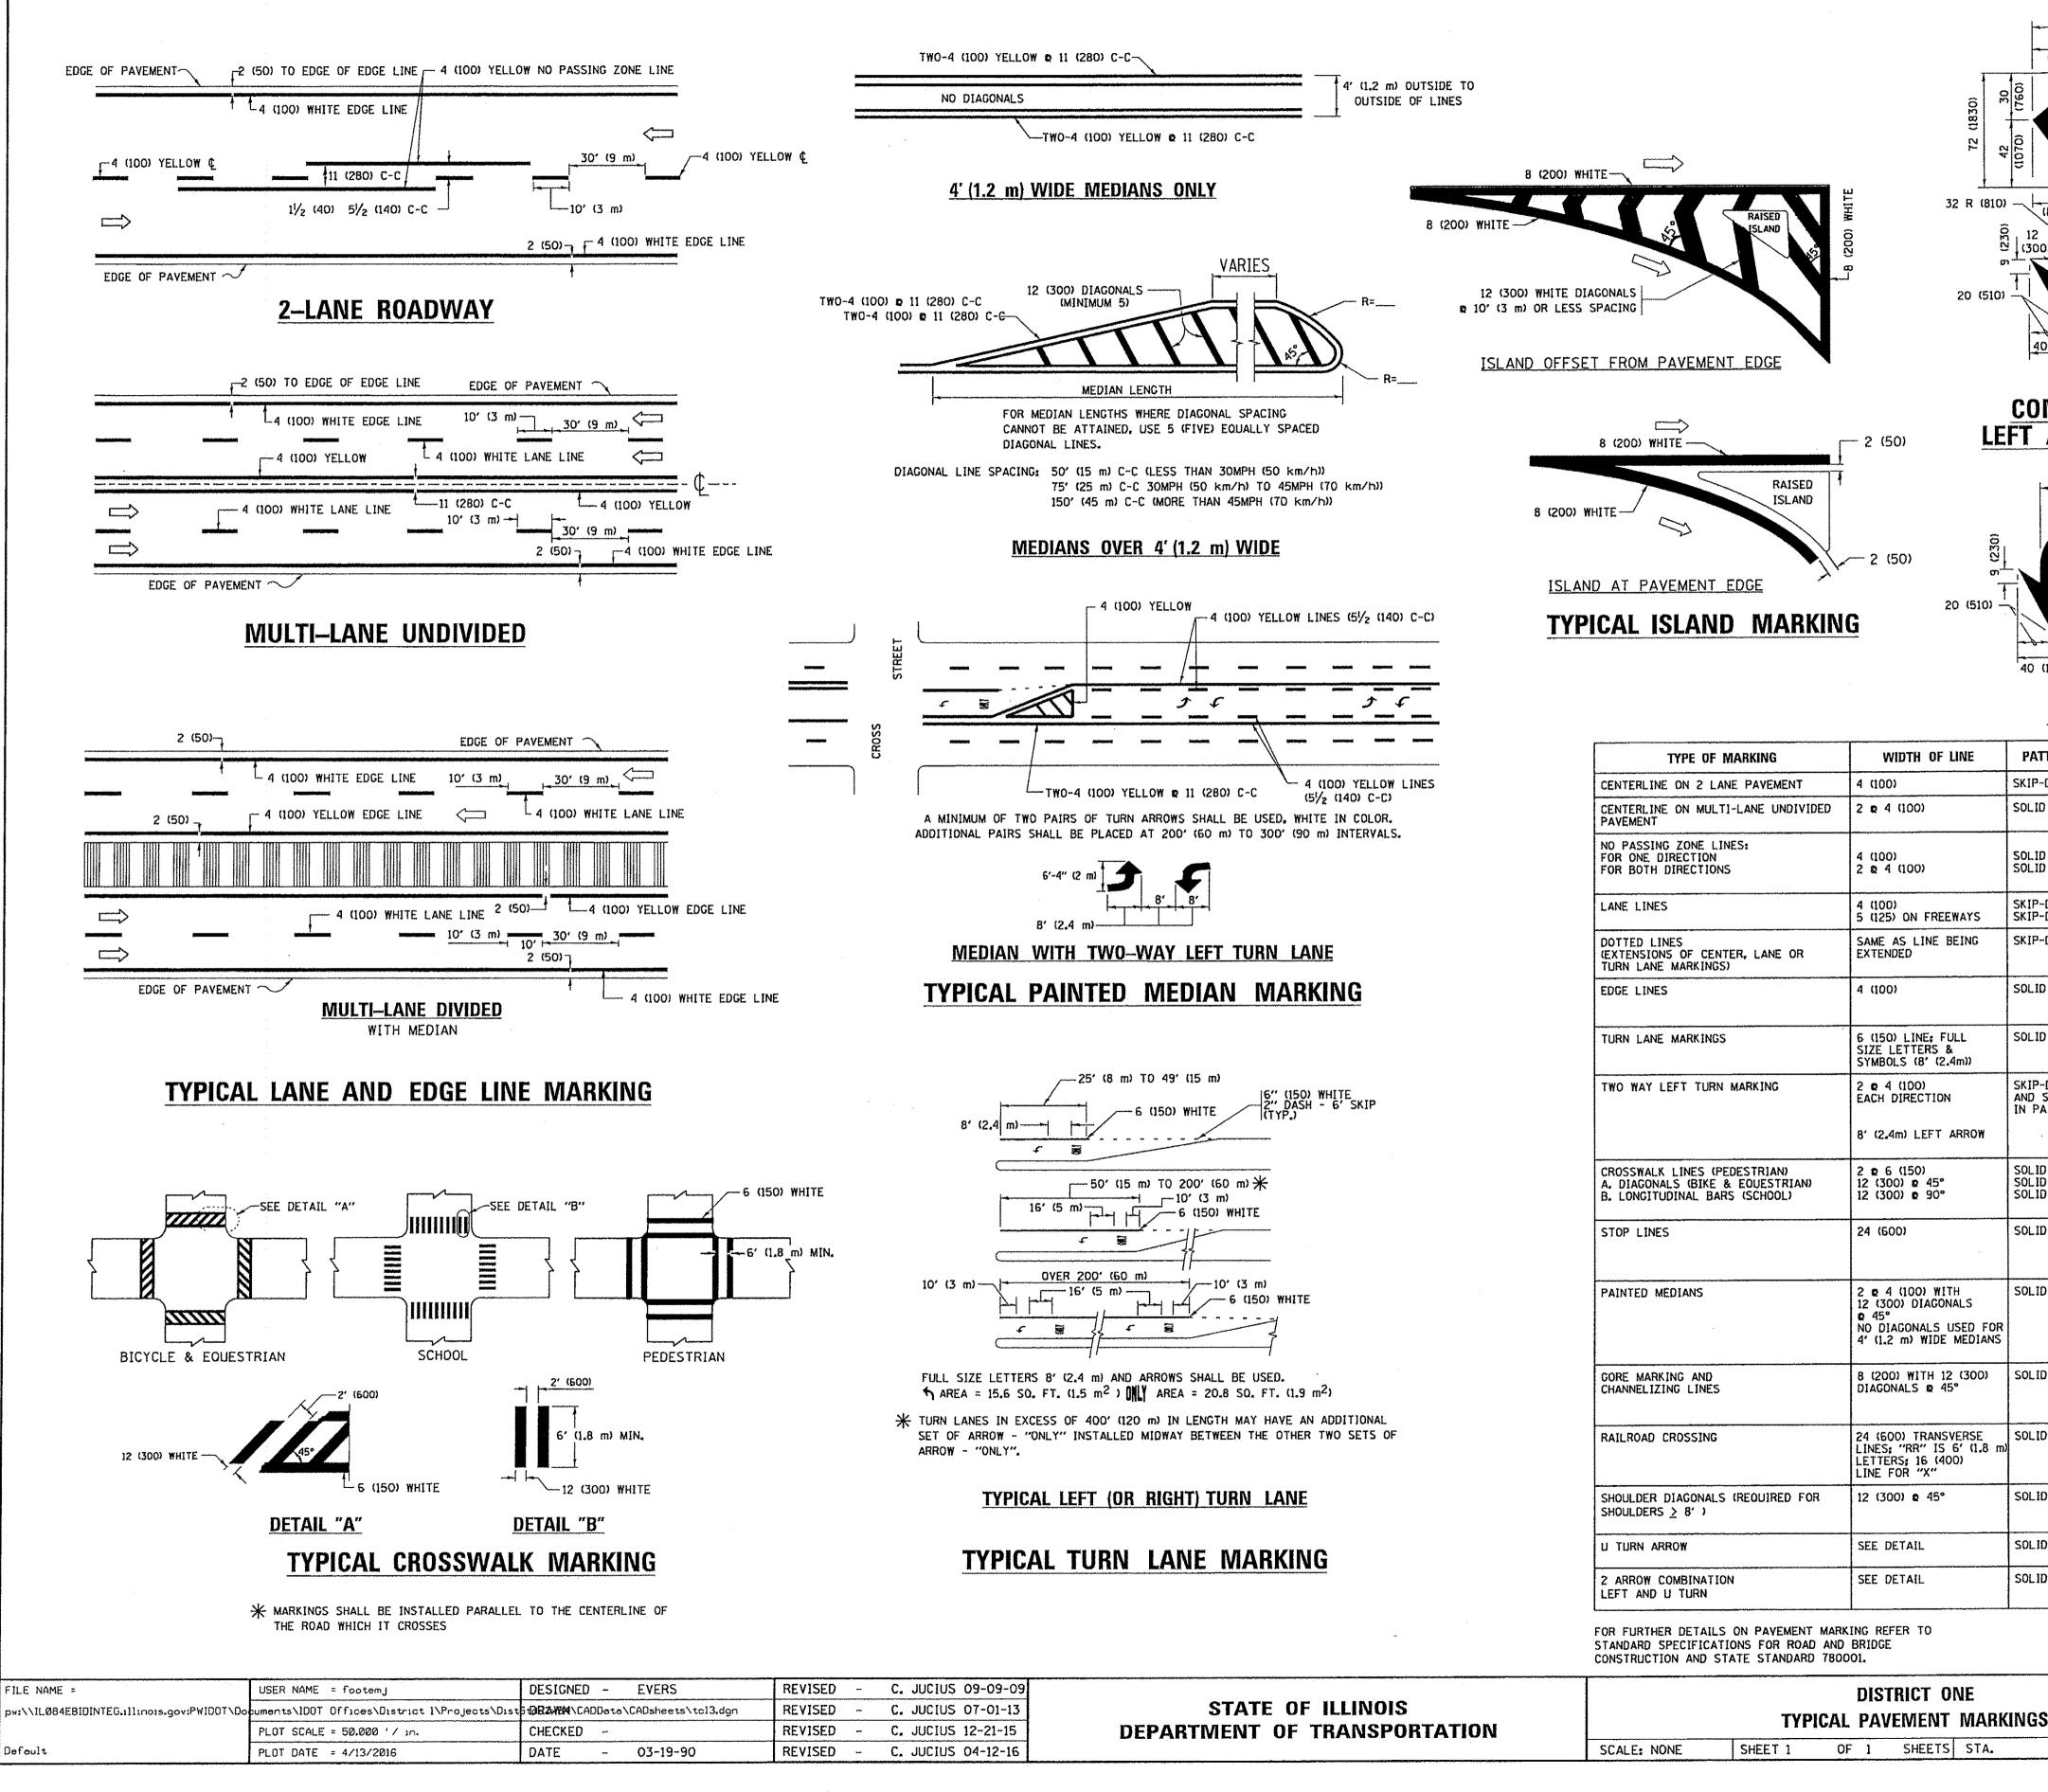

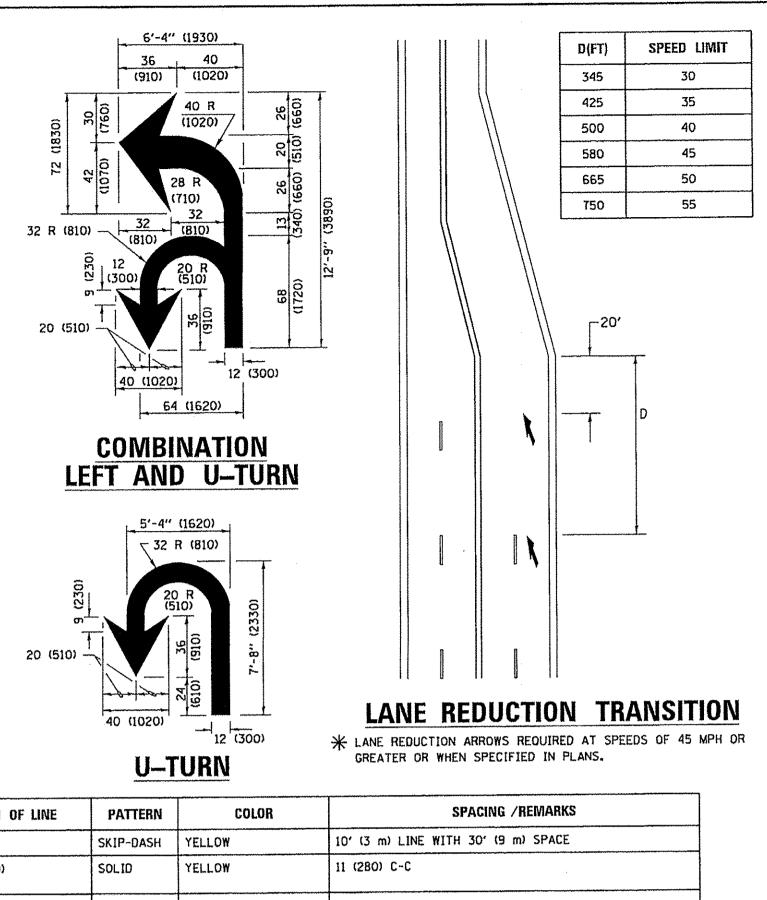

TYPE OF MARKING	WIDTH OF LINE	PATTERN	COLOR	SPACING / REMARKS
CENTERLINE ON 2 LANE PAVEMENT	4 (100)	SKIP-DASH	YELLOW	10' (3 m) LINE WITH 30' (9 m) SPACE
CENTERLINE ON MULTI-LANE UNDIVIDED PAVEMENT	2 2 4 (100)	SOLID	YELLOW	11 (280) C-C
NO PASSING ZONE LINES: FOR ONE DIRECTION FOR BOTH DIRECTIONS	4 (100) 2 & 4 (100)	SOLID SOLID	YELLOW	5½ (140) C-C FROM SKIP-DASH CENTERLINE 11 (280) C-C OMIT SKIP-DASH CENTERLINE BETWEEN
LANE LINES	4 (100) 5 (125) ON FREEWAYS	SKIP-DASH SKIP-DASH	WHITE WHITE	10' (3 m) LINE WITH 30' (9 m) SPACE
DOTTED LINES (EXTENSIONS OF CENTER, LANE OR TURN LANE MARKINGS)	SAME AS LINE BEING EXTENDED	SKIP-DASH	SAME AS LINE BEING EXTENDED	2' (600) LINE WITH 6' (1.8 m) SPACE
EDGE LINES	4 (100)	SOLID	YELLOW-LEFT WHITE-RIGHT	OUTLINE MEDIANS IN YELLOW
TURN LANE MARKINGS	6 (150) LINE; FULL SIZE LETTERS & SYMBOLS (8' (2.4m))	SOLID	WHITE	SEE TYPICAL TURN LANE MARKING DETAIL
TWO WAY LEFT TURN MARKING	2 to 4 (100) EACH DIRECTION 8' (2.4m) LEFT ARROW	SKIP-DASH AND SOLID IN PAIRS	YELLOW	10' (3 m) LINE WITH 30' (9 m) SPACE FOR SKIP-DASH; 51/2 (140) C-C BETWEEN SOLID LINE AND SKIP-DASH LINE SEE TYPICAL TWO-WAY LEFT TURN MARKING DETAIL
CROSSWALK LINES (PEDESTRIAN) A. DIAGONALS (BIKE & EQUESTRIAN) B. LONGITUDINAL BARS (SCHOOL)	2 c 6 (150) 12 (300) c 45° 12 (300) c 90°	SOLID SOLID SOLID	WHITE WHITE WHITE	NOT LESS THAN 6' (1.8 m) APART 2' (600) APART 2' (600) APART SEE TYPICAL CROSSWALK MARKING DETAILS.
STOP LINES	24 (600)	SOLID	WHITE	PLACE 4' (L2 m) IN ADVANCE OF AND PARALLEL TO CROSSWALK, IF PRESENT. OTHERWISE, PLACE AT DESIRED STOPPING POINT. PARALLEL TO CROSSROAD CENTERLINE, WHERE POSSIBLE
PAINTED MEDIANS	2 & 4 (100) WITH 12 (300) DIAGONALS 0 45° NO DIAGONALS USED FOR 4' (1.2 m) WIDE MEDIANS	SOLID	YELLOW: TWO WAY TRAFFIC WHITE: ONE WAY TRAFFIC	11 (280) C-C FOR THE DOUBLE LINE SEE TYPICAL PAINTED MEDIAN MARKING.
GORE MARKING AND CHANNELIZING LINES	8 (200) WITH 12 (300) DIAGONALS & 45°	SOLID	WHITE	DIAGONALS: 15' (4.5 m) C-C (LESS THAN 30MPH (50 km/h)) 20' (6 m) C-C 30MPH (50 km/h) TO 45MPH (70 km/h)) 30' (9 m) C-C (OVER 45MPH (70 km/h))
RAILROAD CROSSING	24 (600) TRANSVERSE LINES: "RR" IS 6' (1.8 m) LETTERS: 16 (400) LINE FOR "X"	SOLID	WHITE	SEE STATE STANDARD 780001 AREA OF: "R"=3.6 SO. FT. (0.33 m ²) EACH "X"=54.0 SO. FT. (5.0 m ²)
SHOULDER DIAGONALS (REQUIRED FOR SHOULDERS > 8')	12 (300) c 45°	SOLID	WHITE - RIGHT YELLOW - LEFT	50' (15 m) C-C (LESS THAN 30MPH (50 km/h)) 75' (25 m) C-C (30 MPH (50 km/h) TO 45MPH (70 km/h)) 150' (45 m) C-C (OVER 45MPH (70 km/h))
U TURN ARROW	SEE DETAIL	SOLID	WHITE	16.3 SF
2 ARROW COMBINATION LEFT AND U TURN	SEE DETAIL	SOLID	WHITE	30.4 SF

LS ON PAYEMENT MARKING REFER TO

ATIONS FOR ROAD AND BRIDGE

All dimensions are in inches (millimeters)
unless otherwise shown.

			רצומ	rrict or	VF		F.A.P RTE.	SECTION	COUNTY	TOTAL SHEETS	SHEET NO.
	TYPICAL PAVEMENT MARKINGS							10-00037-00-LS	COOK	34	31
	IYP	ICAL	PAV	EIVIEIVI	MARKING			TC-13	CONTRACT NO.		51C85
SCALE: NONE	SHEET 1	OF	1	SHEETS	STA.	TO STA.		ILLINOIS FED.	AID PROJECT TE	-00D1(364)

TURN BAY ENTRANCE AT START OF LANE CLOSURE TAPER

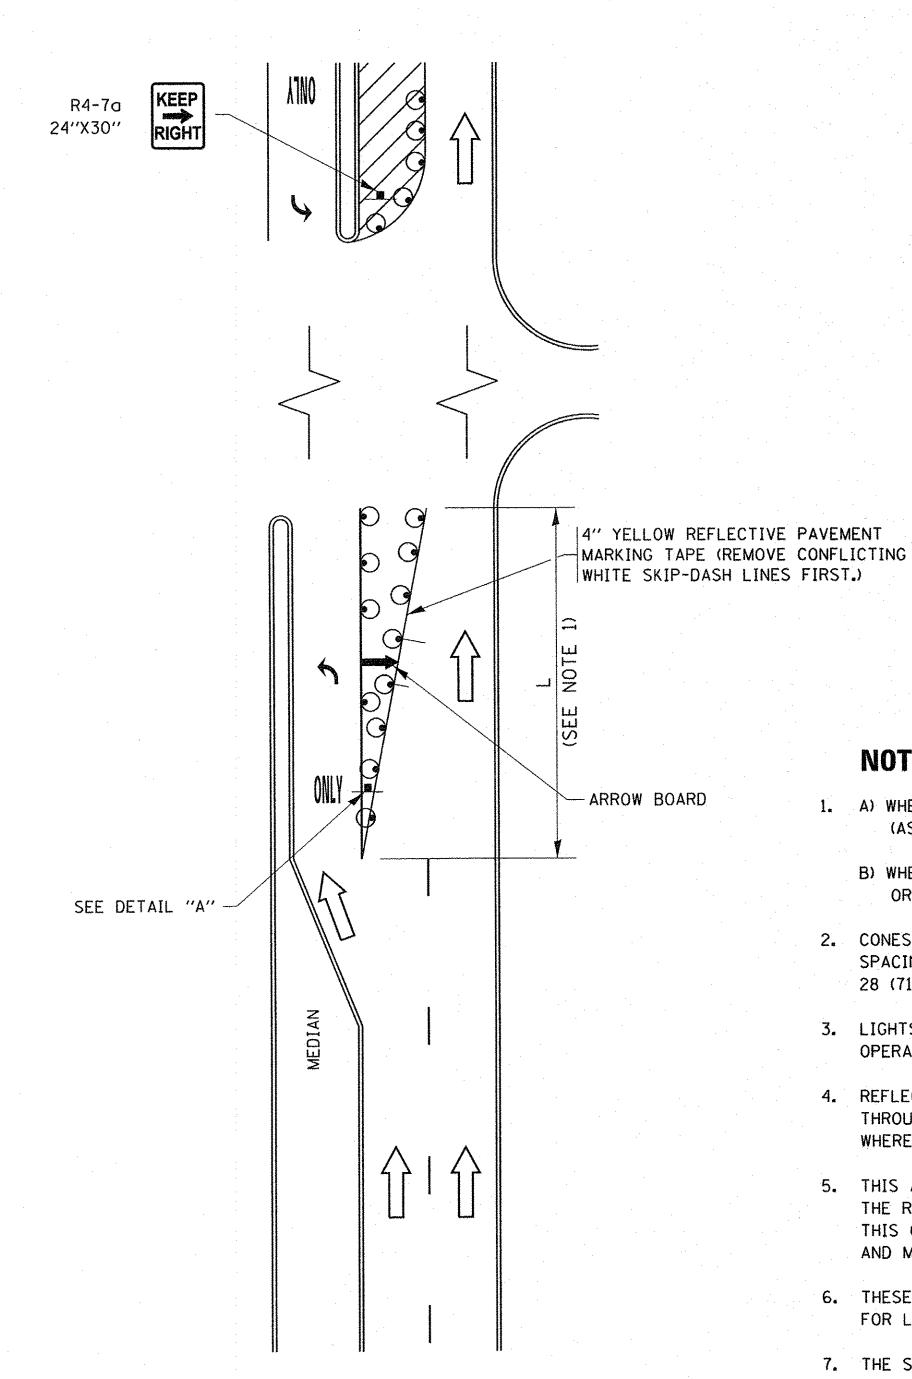


FIGURE 1

LEGEND LANE OPEN TO TRAFFIC

TYPE I OR II BARRICADE OR DRUM WITH STEADY BURN LIGHT

DRUM WITH STEADY BURN LIGHT


SIGN ASSEMBLY

TYPE I OR II CHECK BARRICADE WITH FLASHING LIGHT

NOTES:

- 1. A) WHEN "L" IS ≤ THE STORAGE LENGTH OF THE TURN LANE (AS SHOWN IN FIG. 1), USE FIGURE 1.
 - B) WHEN "L" IS > THE STORAGE LENGTH OF THE TURN LANE OR THE TURN LANE IS WITHIN THE LANE CLOSURE, USE FIGURE 2.
- 2. CONES MAY BE SUBSTITUTED FOR BARRICADES OR DRUMS AT HALF THE SPACING DURING DAY OPERATIONS. CONES SHALL BE A MINIMUM OF 28 (710) IN HEIGHT.
- 3. LIGHTS WILL NOT BE REQUIRED ON BARRICADES OR DRUMS FOR DAY OPERATIONS. ALL LIGHTS SHALL BE MONODIRECTIONAL.
- 4. REFLECTIVE TEMPORARY PAVEMENT MARKINGS SHALL BE PLACED THROUGHOUT THE BARRICADED AREAS OF EACH TURN BAY AS SHOWN WHERE THE CLOSURE TIME IS GREATER THAN FOURTEEN (14) DAYS.
- 5. THIS APPLICATION ALSO APPLIES WHEN WORK IS BEING PERFORMED IN THE RIGHT LANE(S) AND THE RIGHT TURN BAY IS TO REMAIN OPEN. UNDER THIS CONDITION, "RIGHT TURN LANE" R3-1100R 24 x 24 (600 x 600) AND M6-2R 21 x 15 (530 x 380) SHALL BE USED.
- 6. THESE CONTROLS SHALL SUPPLEMENT MAINLINE TRAFFIC CONTROL FOR LANE CLOSURES.
- 7. THE SIGNS SHALL BE MOUNTED ABOVE THE BARRICADES/DRUMS ON SEPARATE SIGN SUPPORTS THAT MEET NCHRP 350 OR MASH PREQUIREMENTS.
- 8. TRAFFIC CONTROL AND PROTECTION AT TURN BAYS (TO REMAIN OPEN TO TRAFFIC) SHALL BE INCLUDED IN THE COST OF SPECIFIED TRAFFIC CONTROL STANDARDS OR ITEMS.

TURN BAY ENTRANCE WITHIN A LANE CLOSURE

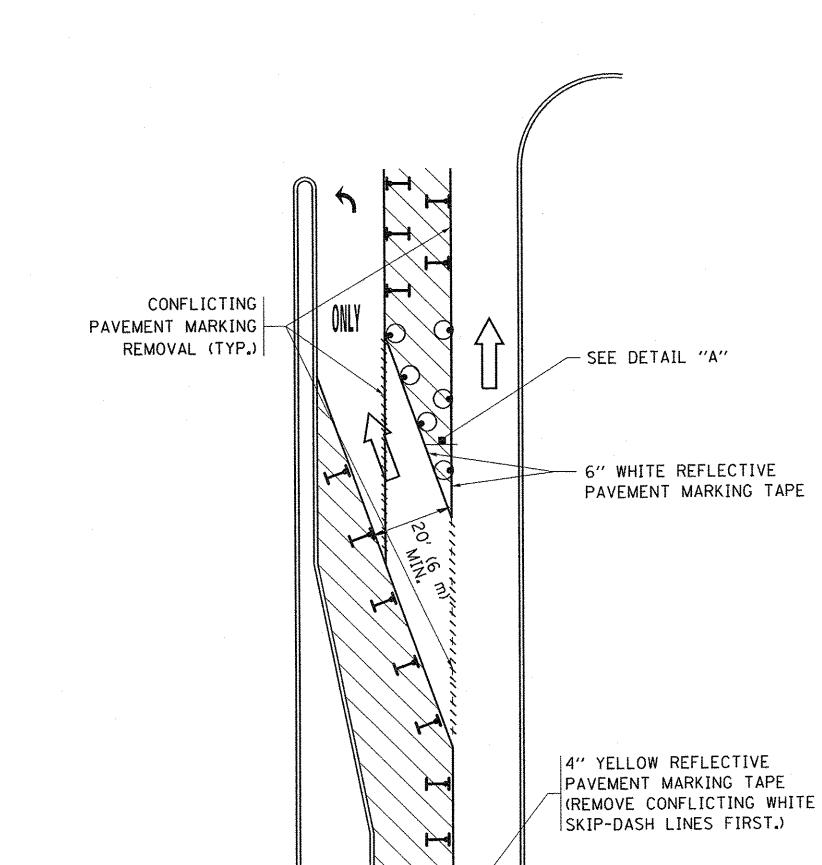

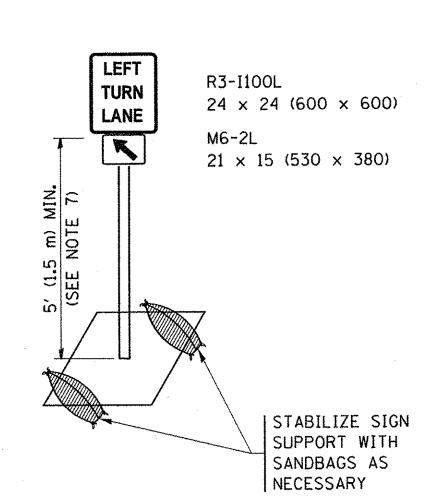


FIGURE 2

DETAIL A


All dimensions are in inches (millimeters) unless otherwise shown.


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	cuments\IDOT Offices\District 1\Projects\Dist	HREWISEDA	DData	∖CAQ∍H IOUSE HI	41 9 07-95	REVISED	- A.	SCHUETZE	07-01-13	
	PLOT SCALE = 50.0000 '/ in.	REVISED						SCHUETZE		
Nefault	PLOT DATE = 9/15/2016	REVISED	- T.	RAMMACHER	01-06-00	REVISED				1


STATE OF ILLINOIS DEPARTMENT OF TRANSPORTATION

	raffic	CONT	ROL ANI	PROTE	CTION	AT 1	rurn	BAYS
		(TO	REMAIN	OPEN	TO TR	AFFIC	;)	
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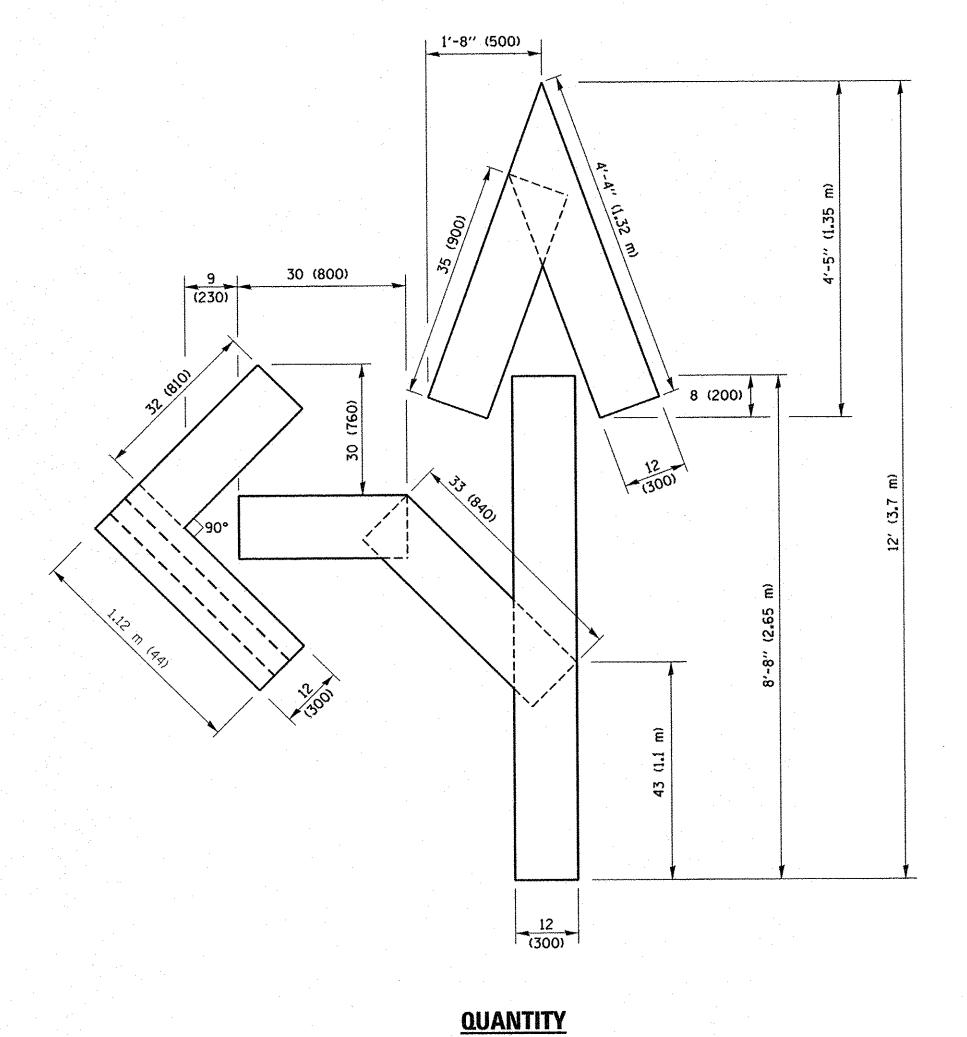
COUNTY TOTAL SHEET SHEETS NO. F.A.P RTE. SECTION 330 COOK 34 32 10-00037-00-LS CONTRACT NO. 61C85 TC-14 ILLINOIS FED. AID PROJECT TE-00D1(864)



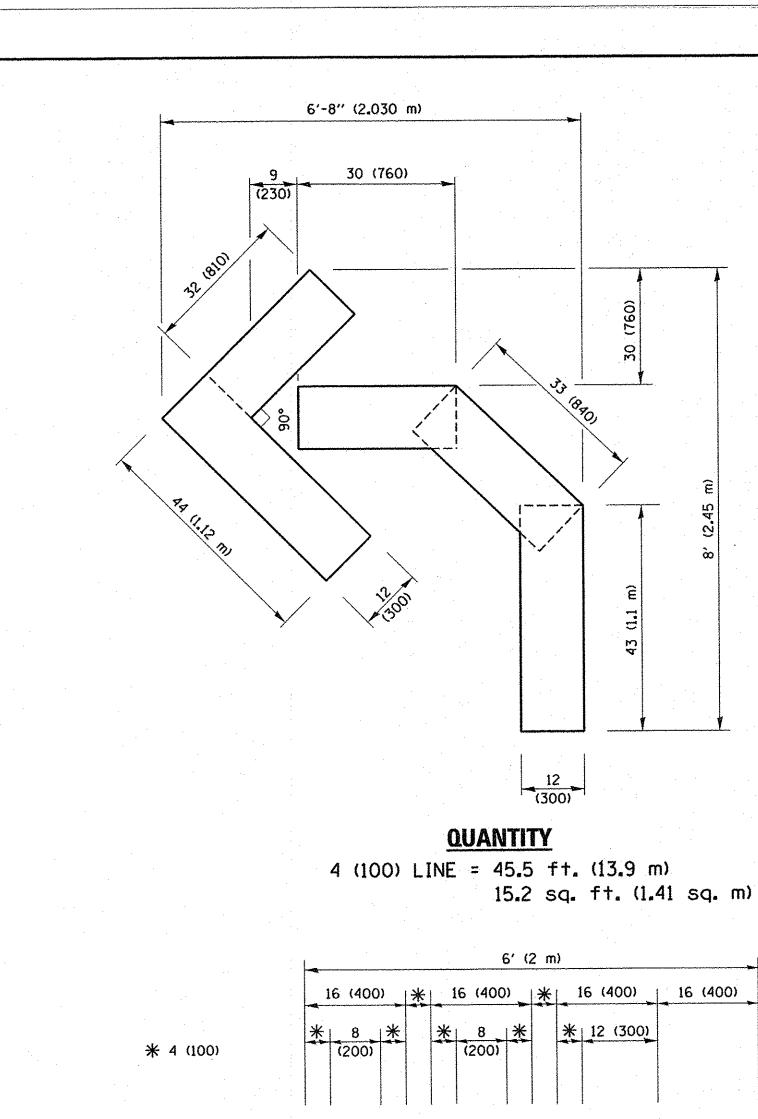

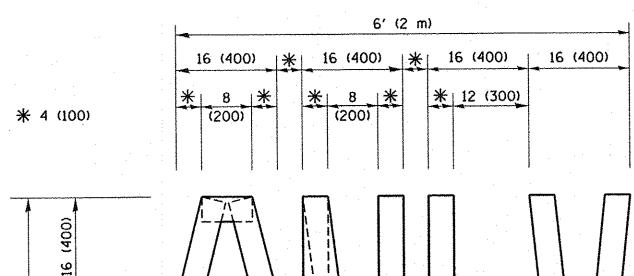

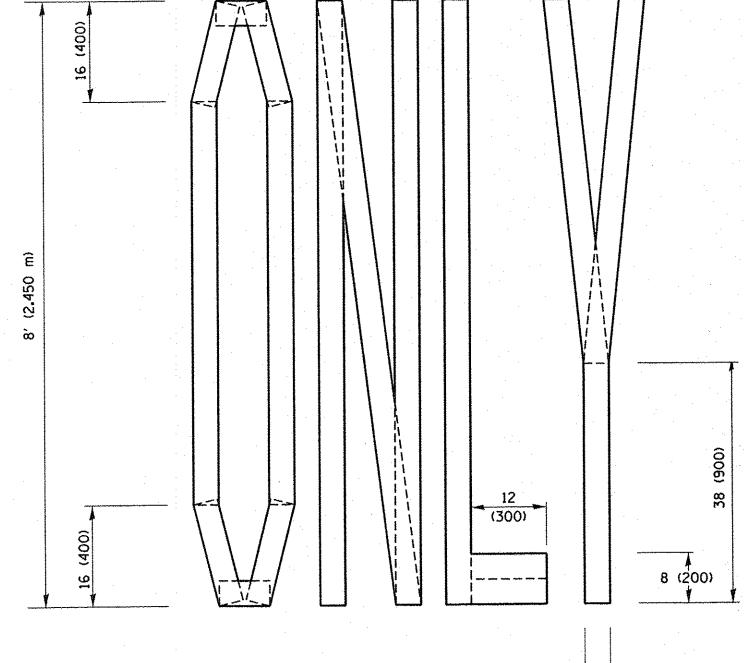
QUANTITY 4 (100) LINE = 64.1 ft. (19.5 m) 21.4 sq. ft. (1.99 sq. m)



4 (100) LINE = 82.5 ft. (25.1 m) 27.5 sq. ft. (2.53 sq. m)

NOTE:


ALL QUANTITIES OF PLACEMENT ARE REPRESENTED IN LINEAR FEET OF 4" LINES TO MATCH THE 4" TEMPORARY TAPE PAY ITEM AND REPRESENTS THE TOTAL QUANTITY OF 4" TAPE REQUIRED.

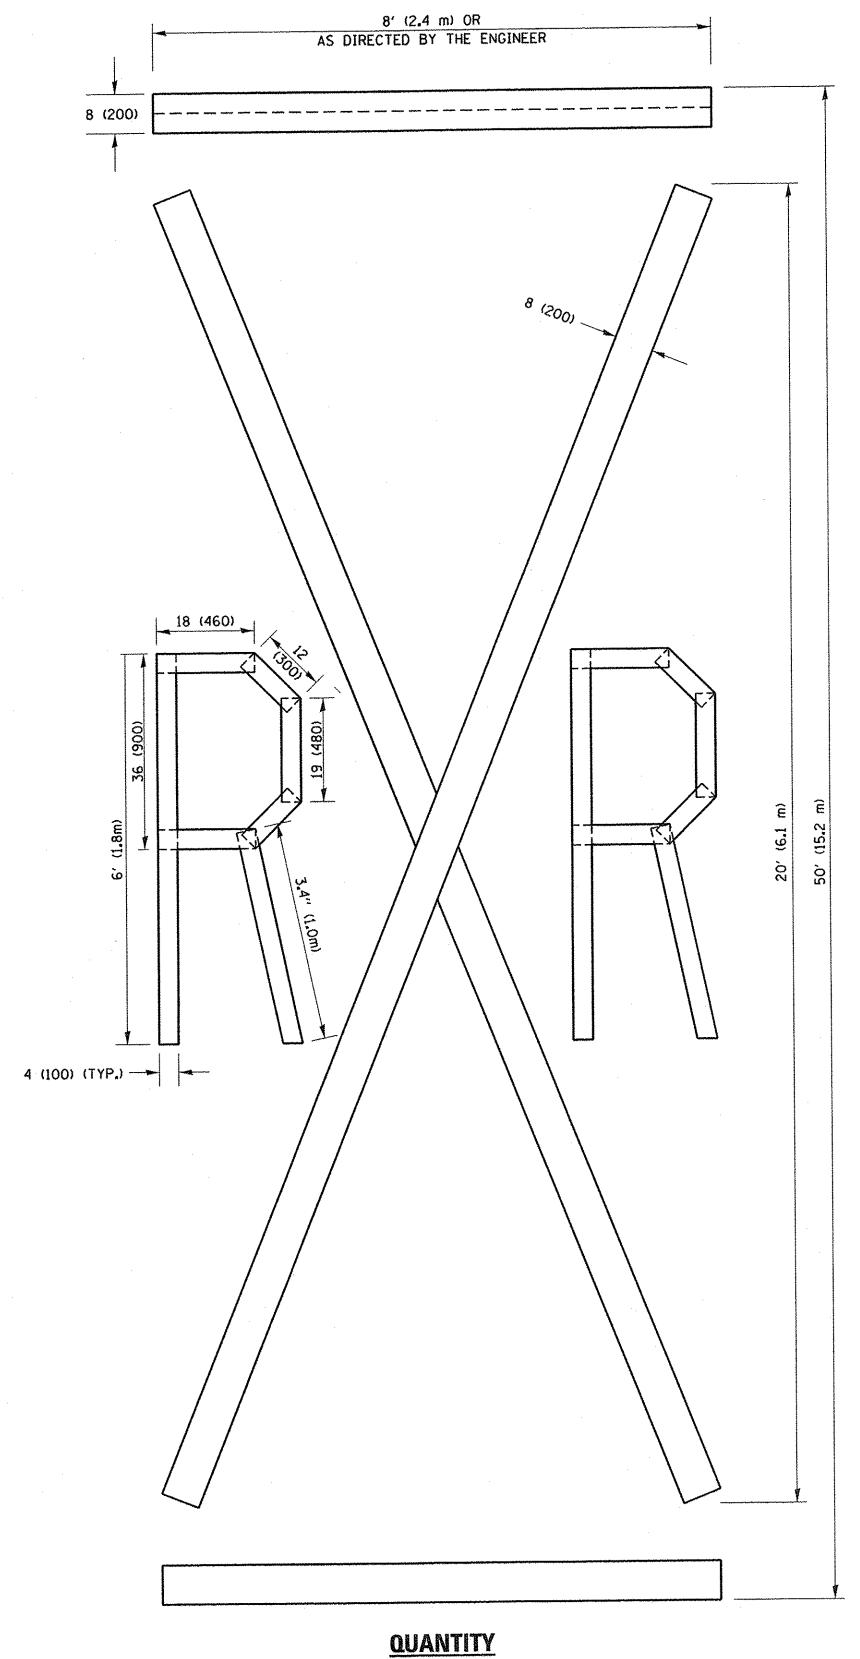

4 (100) LINE = 225.9 ft. (68.9 m) 75.3 sq. ft. (6.99 sq. m)

> All dimensions are in inches (millimeters) unless otherwise shown.

						F.A.P.	CCCTION	COUNTY		SHEET
CTL C ALABAC	USER NAME = footemj	DESIGNED -	REVISED -T. RAMMACHER 03-02-98			RTE.	SECTION	COUNTY	SHEETS	NO.
FILE NAME =	cuments\IDOT Offices\District 1\Projects\Dis	t6:10RAWN\CADData\CADsheets\tc16.dgn	REVISED -E. GOMEZ 08-28-00	STATE OF ILLINOIS	SHORT TERM PAVEMENT MARKING LETTERS AND SYMBOLS	330	10-00037-00-LS	COOK	34	33
pw. (Actorical Control of the Contro	PLOT SCALE = 50.0000 '/ in.	CHECKED -	REVISED -E. GOMEZ 08-28-00	DEPARTMENT OF TRANSPORTATION			TC-16	CONTRACT		
	PLOT DATE = 9/15/2016	DATE - 09-18-94	REVISED - A. SCHUETZE 09-15-16		SCALE: NONE SHEET NO. 1 OF 1 SHEETS STA. TO STA.	FED. ROAD	DIST. NO. 1 ILLINOIS FED.	AID PROJECT 1E-	-0001(8	04)

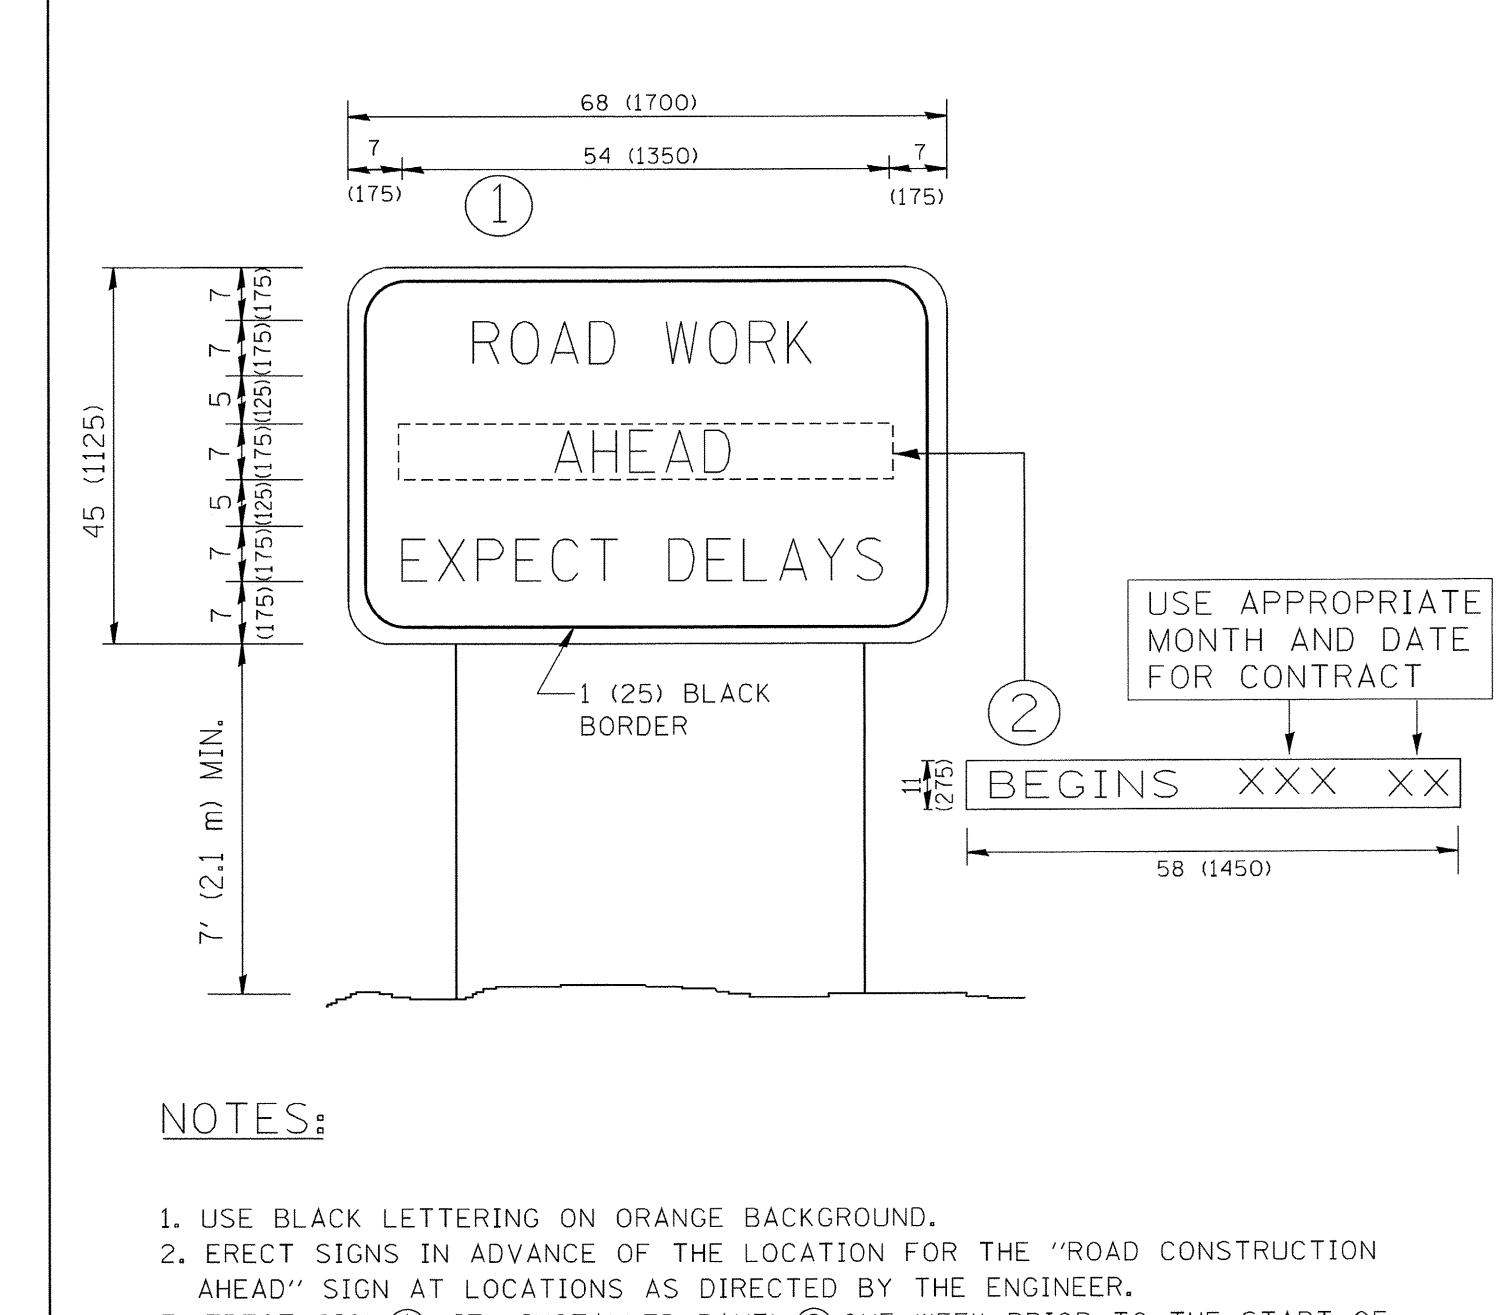

- 3. ERECT SIGN 1) WITH INSTALLED PANEL 2) ONE WEEK PRIOR TO THE START OF CONSTRUCTION.
- 4. REMOVE PANEL 2) SOON AFTER THE START OF CONSTRUCTION.
- 5. SEE SPECIAL PROVISION FOR "TEMPORARY INFORMATION SIGNING" FOR ADDITIONAL INFORMATION.
- 6. ONE SIGN ASSEMBLY EQUALS 25.70 SQ. FT. (2.3 SQ. M.)
- 7. SHALL BE PAID FOR AS TEMPORARY INFORMATION SIGNING.

ALL DIMENSIONS ARE IN INCHES (MILLIMETERS)
UNLESS OTHERWISE SHOWN.

FILE NAME =	USER NAME = gaglianobt	DESIGNED -	REVISED - R. MIRS 09-15-97		ARTERIAL ROAD	F.A.P. SECTION COUNTY SHEETS NO.
W:\diststd\22x34\tc22.dgn		DRAWN ~	REVISED - R. MIRS 12-11-97	STATE OF ILLINOIS		330 10-00037-00-LS COOK 34 34
	PLOT SCALE = 50.000 '/ IN.	CHECKED ~	REVISED -T. RAMMACHER 02-02-99	DEPARTMENT OF TRANSPORTATION	INFORMATION SIGN	TC-22 CONTRACT NO. 61C85
	PLOT DATE = 1/4/2008	DATE -	REVISED - C. JUCIUS 01-31-07		SCALE: NONE SHEET NO. 1 OF 1 SHEETS STA. TO STA.	FED. ROAD DIST. NO. 1 ILLINOIS FED. AID PROJECT TE-00D1(864)