06-16-2017 LETTING ITEM 233

FOR INDEX OF SHEETS, SEE SHEET NO. 2

FUNCTIONAL CLASSIFICATION MINOR ARTERIAL (RURAL) CLASS II TRUCK ROUTE

TRAFFIC DATA:


IL 18 2011 ADT = 1,250 2033 ADT = 1,735 SU = 3.2%, MU = 4.8% DHV = 120 POSTED SPEED LIMIT (55 MPH) DESIGN SPEED LIMIT (55 MPH) STATE OF ILLINOIS DEPARTMENT OF TRANSPORTATION


DIVISION OF HIGHWAYS

PROPOSED HIGHWAY PLANS

FAP ROUTE 653 (IL 18) SECTION (105BR-3)I IL ROUTE 18 BRIDGE DECK REPLACEMENT OVER DRAINAGE DITCH PUTNAM COUNTY

C-94-053-06 STP-0653(033)

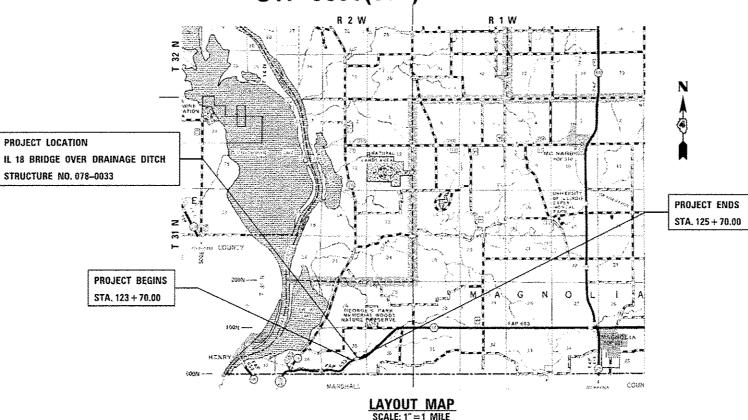

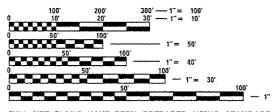

FULL SIZE PLANS HAVE BEEN PREPARED USING STANDARD ENGINEERING SCALES. REDUCED SIZED PLANS WILL NOT CONFORM TO STANDARD SCALES. IN MAKING MEASUREMENTS ON REDUCED PLANS, THE ABOVE SCALES MAY BE USED.

J.U.L.I.E. JOINT UTILITY LOCATION INFORMATION FOR EXCAVATION 1-800-892-0123 OR 811

IDOT PROJECT MANAGER: MR. KEVIN HORST (309) 671-3472 IDOT PROJECT ENGINEER: MR. RICH DOTSON (309) 671-3455


CATALOG NO. 033207-00D CONTRACT NO. 68579 GROSS LENGTH = 200.00 FT. = 0.038 MILE NET LENGTH = 200.00 FT. = 0.038 MILE



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INDEX OF SHEETS

1 COVER SHEET

- INDEX OF SHEETS. HIGHWAY STANDARDS. GENERAL NOTES, COMMITMENTS AND STATUS OF UTILITIES 2
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- 16 PAVEMENT MARKING PLANS
- 17-25 BRIDGE PLANS
- - DISTRICT 4 STANDARDS
- 26 205001-D4 SLOPE STEPS DETAIL
- 27-29 406101-04 BUTT JOINTS (3 SHTS)
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- 33 667101-D4 PERMANENT SURVEY TIE AND PERMANENT SURVEY
- 34-35 780001-04 TYPICAL PAVEMENT MARKINGS (2 SHTS)

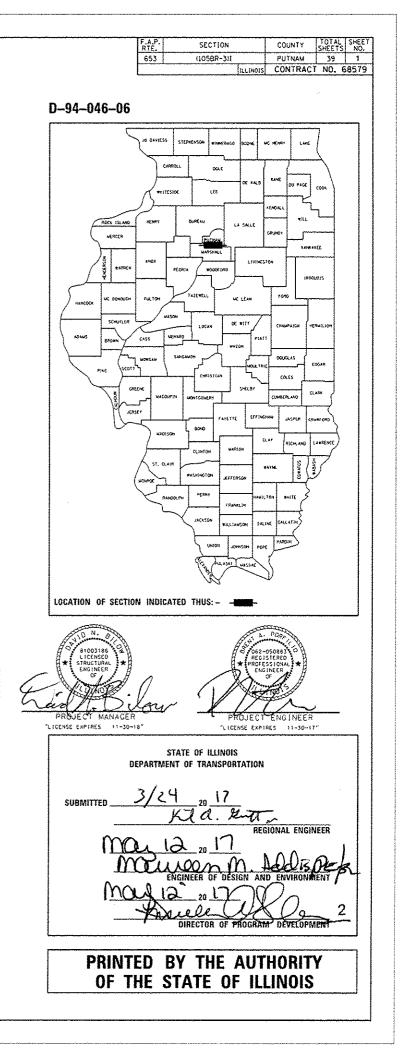36-39 CROSS SECTIONS

HIGHWAY STANDARDS

000001 00	
000001-06	STANDARD SYMBOLS. ABBREVIATIONS AND PATTERNS
001001-02	AREAS OF REINFORCEMENT BARS
001006	DECIMAL OF AN INCH AND OF A FOOT
280001-07	TEMPORARY EROSION CONTROL SYSTEMS
482001-02	HMA SHOULDER ADJACENT TO FLEXIBLE PAVEMENT
515001-03	NAME PLATE FOR BRIDGES
630001-11	STEEL PLATE BEAM GUARDRAIL
630301-07	SHOULDER WIDENING FOR TYPE 1 (SPECIAL) GUARDRAIL
631032-09	TRAFFIC BARRIER TERMINAL. TYPE GA
701001-02	OFF-ROAD OPERATIONS. 2L, 2W. MORE THAN 15' (4.5 M) AWAY
	OFF-ROAD OPERATIONS. 2L. 2W. 15' (4.5 M) TO 24" (500 MM)
701006-05	FROM PAVEMENT EDGE
701201-04	LANE CLOSURE, 2L. 2W. DAY ONLY, FOR SPEEDS ≥ 45 MPH
701301-04	LANE CLOSURE, 2L. 2W. SHORT TIME OPERATIONS
	LANE CLOSURE, 2L, 2W, MOVING OPERATIONS - DAY ONLY
701311-03	
701321-16	LANE CLOSURE, 2L, 2W, BRIDGE REPAIR WITH BARRIER
701901-06	TRAFFIC CONTROL DEVICES
704001-08	TEMPORARY CONCRETE BARRIER
725001-01	OBJECT AND TERMINAL MARKERS
780001-05	TYPICAL PAVEMENT MARKINGS
781001-04	TYPICAL APPLICATIONS RAISED REFLECTIVE PAVEMENT MARKERS
782006	CUARDRAIL AND BARRIER WALL REFLECTOR MOUNTING DETAILS
	devidente nue ensuren ange ner cevion abonitad derates

COMMITMENTS

COMMITMENTS ARE NOT TO BE ALTERED WITHOUT THE WRITTEN APPROVAL OF ALL PARTIES TO WHICH THE COMMITMENT WAS MADE

THERE ARE NO COMMITMENTS FOR THIS PROJECT.

AVAILABILITY OF ELECTRONIC FILES

MICROSTATION AND GEOPAK FILES OF THIS PROJECT WILL BE MADE AVAILABLE TO THE CONTRACTOR AFTER CONTRACT AWARD. IF THERE IS A CONFLICT BETWEEN THE ELECTRONIC FILES AND THE PRINTED CONTRACT PLANS AND DOCUMENTS. THE PRINTED CONTRACT PLANS AND DOCUMENTS SHALL TAKE PRECEDENCE OVER THE ELECTRONIC FILES. THE CONTRACTOR SHALL ACCEPT ALL RISK ASSOCIATED WITH USING THE ELECTRONIC FILES AND SHALL HOLD THE DEPARTMENT HARMLESS FOR ANY ERRORS OR OMISSIONS IN THE ELECTRONIC FILES AND THE DATA CONTAINED THEREIN. ERRORS OR DELAYS RESULTING FROM THE USE OF THE ELECTRONIC FILES BY THE CONTRACTOR SHALL NOT RESULT IN AN EXTENSION OF TIME FOR ANY INTERIM OR FINAL COMPLETION DATE OR SHALL NOT BE CONSIDERED CAUSE FOR ADDITIONAL COMPENSATION. THE CONTRACTOR SHALL NOT USE. SHARE, OR DISTRIBUTE THESE ELECTRONIC FILES EXCEPT FOR THE PURPOSE OF CONSTRUCTING THIS CONTRACT. ANY CLAIMS BY THIRD PARTIES DUE TO USE OR ERRORS SHALL BE THE SOLE RESPONSIBILITY OF THE CONTRACTOR. THE CONTRACTOR SHALL INCLUDE THIS DISCLAIMER WITH THE TRANSFER OF THESE ELECTRONIC FILES TO ANY OTHER PARTIES AND SHALL INCLUDE APPROPRIATE LANGUAGE BINDING THEM TO SIMILAR RESPONSIBILITIES.

TREE REMOVAL - UTILITY RELOCATION

TREE REMOVAL MAY BE NECESSARY PRIOR TO UTILITY COMPANIES BEING ABLE TO RELOCATE THEIR FACILITIES OUTSIDE THE CONSTRUCTION LIMITS. THE CONTRACTOR SHOULD COORDINATE ANY CONTRACT TREE REMOVAL ACTIVITIES WITH THE UTILITY COMPANIES TO ELIMINATE CONFLICTS AND POTENTIAL DELAYS CAUSED BY UTILITY TREE REMOVAL ACTIVITIES OR INCOMPLETE UTILITY RELOCATIONS.

PLAN ELEVATIONS - U.S.G.S. MEAN SEA LEVEL DATUM ALL ELEVATIONS SHOWN ON THE PLANS ARE ESTABLISHED FROM U.S.G.S. MEAN SEA LEVEL DATINA

PROPERTY OWNER ACCESS REQUIREMENT ACCESS MUST BE MAINTAINED TO ALL EXISTING PROPERTIES DURING CONSTRUCTION PER ARTICLE 107.09 UNLESS ARRANGEMENTS ARE MADE IN WRITING BY THE CONTRACTOR WITH THE PROPERTY OWNERS WITH A COPY TO THE ENGINEER FOR SHORT-TERM CLOSURES.

TREE REMOVAL

THE DISTRICT FOUR TREE COMMITTEE SHOULD BE CONTACTED AND PRIOR APPROVAL OBTAINED FOR ANY TREE REMOVAL BEYOND THE LIMITS/LOCATIONS INCLUDED IN THE PLANS

ENVIRONMENTAL REVIEWS

PRIOR TO THE USE OF ANY PROPOSED BORROW AREAS, USE AREAS (TEMPORARY ACCESS ROADS. DETOURS. RUN-AROUNDS. ETC.) AND/OR WASTE AREAS, THE CONTRACTOR SHALL FILE THE REQUIRED ENVIRONMENTAL RESOURCE REQUEST SURVEYS ACCORDING TO SECTION 107.22 OF THE STANDARD SPECIFICATIONS. THESE SURVEYS ARE REQUIRED IN ORDER FOR THE DEPARTMENT TO CONDUCT CULTURAL AND BIOLOGICAL RESOURCE SURVEYS FOR THE PROPOSED SITE.

PRIOR TO ANY WASTE MATERIALS BEING REMOVED FROM THE CONSTRUCTION SITE THE REQUIRED ENVIRONMENTAL RESOURCE SURVEYS WILL NEED TO BE OBTAINED AND FILED BY THE CONTRACTOR. EXCESS WASTE PRODUCTS REMOVED FROM THE CONSTRUCTION SITE SHALL BE DISPOSED OF AS REQUIRED IN SECTION 202.03 OF THE STANDARD SPECIFICATIONS.

ANY PROTRUDING METAL BARS SHALL BE REMOVED PRIOR TO THE DISPOSAL OF BROKEN CONCRETE AT APPROVED DISPOSAL SITES.

THE REQUIRED ENVIRONMENTAL RESOURCE DOCUMENTATION SHALL INCLUDE THE FOLLOWING:

-BDE FORM 2289 (CULTURAL AND NATURAL RESOURCES REVIEW OF BORROW AREAS)

- -BDE FORM 2290 (WASTE/USE AREA REVIEW) -A LOCATION MAP SHOWING THE SIZE LIMITS AND LOCATION OF THE USE AREA
- -COLOR PHOTOGRAPHS DEPICTING THE USE AREA
- -BORROW AREA ENTRY AGREEMENT FORM D4 PIOIOI

PLEASE NOTE THAT A MINIMUM OF FOUR WEEKS SHALL BE ALLOWED FOR THE DISTRICT TO OBTAIN THE REQUIRED WASTE SITE ENVIRONMENTAL CLEARANCES AND FIVE WEEKS FOR THE REQUIRED BORROW SITE ENVIRONMENTAL CLEARANCES.

STATUS OF UTILITIES

NAME OF UTILITY COMPANY: FRONTIER

LOCATION	TYPE OF UTILITY	TYPE OF CONFLICT	DISPOSITION
IL 18 STA. 123+70 TO STA. 124+82 LT	PHONE	GUARDRAIL, GRADING	CAUTION

GENERAL NOTES

PAVEMENT STATION NUMBERS & PLACEMENT THE CONTRACTOR SHALL PROVIDE LABOR AND MATERIALS REQUIRED TO IMPRINT PAVEMENT STATION NUMBERS IN THE FINISHED SURFACE OF THE PAVEMENT AND/OR OVERLAY. THE NUMBERS SHALL BE APPROXIMATELY 3/4 [NCH (20 MM) WIDE, 5 INCHES (125 MM) HIGH AND 5/8 INCH (15 MM) DEEP. THE PAVEMENT STATION NUMBERS SHALL BE INSTALLED AS SPECIFIED HEREIN: INTERVAL -200 FEET (ENGLISH STATIONING) OR 100 METERS (METRIC STATIONING) BOTTOM OF NUMBERS - 6 INCHES (150 MM) FROM THE INSIDE EDGE OF THE PAVEMENT MARKING LOCATION - RIGHT EDGE OF PAVEMENT IN DIRECTION OF INCREASING STATIONS POSITION - STATIONS SHALL BE PLACED SO THEY CAN BE READ FROM THE ADJACENT SHOULDER FORMAT - ENGLISH (METRIC) PAVEMENT STATIONS SHALL USE THIS FORMAT " XXX (XX+X00)", WHERE X REPRESENTS THE PAVEMENT STATION THIS WORK WILL NOT BE PAID FOR SEPARATELY, BUT WILL BE INCLUDED IN THE COST OF THE ASSOCIATED PAVEMENT AND/OR OVERLAY PAY ITEMS. BUTT JOINT CUTTING TIME RESTRICTION BUTT JOINTS SHALL NOT BE MILLED MORE THAN THREE (3) DAYS PRIOR TO PLACEMENT OF THE HMA SURFACE COURSE. PAVING SURFACE COURSE CONTINUOUS PAVING OPERATIONS ON THE MAIN ROADWAY SHALL BE MAINTAINED AT ALL TIMES DURING THE CONSTRUCTION OF THE HOT-MIX ASPHALT SURFACE. NO INTERRUPTIONS FOR SIDE ROADS, ENTRANCES, TURN LANES, ETC. WILL BE ALLOWED. CROSSING EXISTING STRUCTURES WITH EQUIPMENT THE FOLLOWING STRUCTURE SN 078-0033. MAY BE CROSSED WITH A MILLING MACHINE. (TO BE VERIFIED WITH BRIDGE OFFICE). ANY STRUCTURES NOT LISTED ABOVE SHALL BE VERIFIED BY THE RESIDENT PRIOR TO REGINNING OF WORK. TRANSITION PAYMENT METHOD - NEW/OLD CONSTRUCTION TEN FEET (10 FT.) (3 M) TRANSITIONS SHALL BE USED TO MATCH PROPOSED ITEMS OF WORK TO EXISTING ITEMS IN THE FIELD UNLESS OTHERWISE SHOWN. THE TRANSITION SHALL BE PAID FOR AT THE CONTRACT UNIT PRICE FOR THE PROPOSED ITEM OF WORK SPECIFIED.

ENGINEERS FIELD OFFICE ADD THE FOLLOWING SENTENCE TO THE END OF PARAGRAPH 670.02 (I) AND 670.04 (E): ALL OF THE TELEPHONE LINES PROVIDED SHALL HAVE UNPUBLISHED NUMBERS.

MIXTURE USE(S):	SURFACE	SHOULDERS
AC/PG:	PG 64-22	PG 64-22
DESIGN AIR VOIDS:	4.0% @ N=50	4.0% @ N=50
MIXTURE COMPOSITION:	1L 9.5	IL 9.5
FRICTION AGGREGATE:	MIX D	MIX D
OUALITY MANAGEMENT PROGRAM:	0C0A	0COA

NOTES

								_
FILE NAME :	USER NAME = AUSERA	DESIGNED - AAF	REVISED -			ILLINOIS ROUTE 18	OVER DRA	Ā
FILEL		DRAWN - AAF	REVISED -	STATE OF ILLINOIS	1	INDEX OF SHEETS,	HIGHWAY	
	PLOT SCALE = +SCALE+	CHECKED - BAP	REVISED -	DEPARTMENT OF TRANSPORTATION	GENERA	L NOTES, COMMITM	IENTS &	Ş
	PLOT DATE + SOATE+	DATE -	REVISED -		SCALE	SHEET NO. OF	SHEETS ST	ū

BITUMINOUS MIXTURE REQUIREMENTS

THE FOLLOWING MIXTURE REQUIREMENTS ARE APPLICABLE FOR THIS PROJECT:

 INDIVIDUAL LIFT THICKNESS OF EACH MIX TYPE WILL BE NO LESS THAN 3 TIMES NOMINAL MAXIMUM ACCREGATE SIZE AND NO MORE THAN 6 TIMES NOMINAL MAXIMUM ACCREGATE SIZE, UNLESS OTHERWISE APPROVED BY THE EXEMPTION ENGINEER.

2. FOR DESIGN PURPOSES, MIXTURE WEIGHT FOR ALL MIXES IS DETERMINED TO BE 112.0 LB/S.Y./IN., UNLESS OTHERWISE NOTED. SUBLOT SIZES FOR PFP AND OCP MIXES WILL BE 1000 TONS. UNLESS OTHERWISE AGREED TO BY THE ENGINEER AND THE PAVING CONTRACTOR.

DRAINAGE		F.A.P RTE.	SECTION	COUNTY	TOTAL	SHEET NO.
AY STAND. & STATUS	ARDS, OF UTILITIES	653	(10588-3)]	PUTMAN CONTRACT	39 NO. 6	2 8579
STA.	TO STA.	1	ILL INDIS FED. A			00.0

					TION CODE
				80% FED 20% STATE	80% FED 20% STATE
				ROADWAY	5N 078-003
ODE NO.	ITEM	UNIT	TOTAL QUANTITY	0004	0014
		· · · · · · · · · · · · · · · · · · ·		RURAL	RURAL
0100110	TREE REMOVAL (6 TO 15 UNITS DIAMETER)		30	30	
0101100	TREE TRUNK PROTECTION	EACH	4	4	· · · · · · · · · · · · · · · · · · ·
0400800	FURNISHED EXCAVATION	CU YD	185	185	
			107	105	
1101615	TOPSOIL FURNISH AND PLACE. 4"	SO YD	826	826	
5000210	SEEDING, CLASS 2A	ACRE	0.2	0. 2	
5000400	NITROGEN FERTILIZER NUTRIENT	POUND	16	16	
	· · · · · · · · · · · · · · · · · · ·	· · · · · · · · · · · · · · · · · · ·			
5000500	PHOSPHORUS FERTILIZER NUTRIENT	POUND	16	16	
5000600	POTASSIUM FERTILIZER NUTRIENT	POUND	16	16	
		·····			
5100630	EROSION CONTROL BLANKET	SO YD	826	826	
8000250	TEMPORARY EROSION CONTROL SEEDING	POUND	34	34	
0000230					
8000305	TEMPORARY DITCH CHECKS	FOOT	48	48	
8000400	PERIMETER EROSION BARRIER	FOOT	343	343	
8000500	INLET AND PIPE PROTECTION	EACH	2	2	
8100109	STONE RIPRAP. CLASS A5	SO YD	343		343
			<u> </u>	· · · · · · · · · · · · · · · · · · ·	

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* SPECIALTY ITEM

FILE NAME =	USER NAME = +USER+	DESIGNED -	REVISED -		·····			F.A.P	SECTION	COUNTY TOTAL SHEET
FILEL		DRAWN -	REVISED -	STATE OF ILLINOIS		SUMMARY OF QUANTITIES		8TE. 653	(10588-3)]	PUTMAN 39 3
	PLOT SCALE + +SCALE+	CHECKED -	REVISED -	DEPARTMENT OF TRANSPORTATION						CONTRACT NO. 68579
	PLOT DATE + +DATE+	DATE -	REVISED -		SCALE: NTS	SHEET NO. 1 OF 5 SHEETS STA. N/A	TO STA. N/A	<u></u>	ILLINDIS FED. AL	9 PROJECT

				80% FED 20% STATE	TION CODE 80% FED 20% STATE
CODE NO.	ITEM	UNIT	TOTAL QUANTITY	ROADWAY 0004 RURAL	SN 078-0033 0014 RURAL
				HURAL	RUKAL
28200200	FILTER FABRIC	SO YD	343		343
40600290	BITUMINOUS MATERIALS (TACK COAT)	POUND	341	341	
40600982	HOT-MIX ASPHALT SURFACE REMOVAL - BUTT JOINT	SO YD	220	220	
40600990	TEMPORARY RAMP	SO YD	54	54	
40603335	HOT-MIX ASPHALT SURFACE COURSE, MIX "D", N50	TON	54	54	
50102400	CONCRETE REMOVAL	CU YD	0.6		0.6
50104720	REMOVAL OF EXISTING CONCRETE DECK	EACH	1		1
50300225	CONCRETE STRUCTURE	Cu yd	0.6		0.6
50300255	CONCRETE SUPERSTRUCTURE	CU YD	48.3		48,3
50300260	BRIDGE DECK GROOVING	SO YD	98		98
50300300	PROTECTIVE COAT	SO YD	105		105
50800205	REINFORCEMENT BARS. EPOXY COATED	POUND	16, 920		16.920
50800515	BAR SPLICERS	EACH	90		90
50901050	STEEL RAILING. TYPE SM	FOQT	58		58
51500100	NAME PLATES	EACH			1

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FILE NAME :	USER NAME : SUSERS	DESIGNED -	REVISED -			F.A.P SECTION	COUNTY TOTAL SHEET
FILEL		DRAWN -	REVISEO -	STATE OF ILLINOIS	SUMMARY OF QUANTITIES	653 (10588-3)]	PUTMAN 39 4
	PLOT SCALE + +SCALE+	CHECKED -	REVISED -	DEPARTMENT OF TRANSPORTATION			CONTRACT NO. 68579
	PLOT DATE * #DATE#	DATE -	REVISED -		SCALE: NTS SHEET NO. 2 OF 5 SHEETS STA. N/A TO STA. N/A	ILLINDIS FED. AID	0 PROJECT

REV "

					TION CODE
				80% FED 20% STATE	80% FED 20% STATE
			TOTAL	ROADWAY	\$N 078-003
CODE NO.	ITEM	UNIT	QUANTITY	0004 RURAL	0014 RURAL
		- <u> </u>		NORAL	
59000200	EPOXY CRACK INJECTION	FOOT	158		158
63000001	STEEL PLATE BEAM GUARDRAIL, TYPE A. 6 FOOT POSTS	FOOT	50.0	50.0	
63100087	TRAFFIC BARRIER TERMINAL, TYPE 6A	EACH	4	4	
63100167	TRAFFIC BARRIER TERMINAL, TYPE 1 (SPECIAL) TANGENT	EACH	1	1	
63200310	GUARDRAIL REMOVAL	FOOT	285	285	
66700205	PERMANENT SURVEY MARKERS, TYPE I	EACH	1		1
67000500	ENGINEER'S FIELD OFFICE. TYPE B	CAL MO	4	4	
67100100	MOBILIZATION	LSUM	1	l	
70100405	TRAFFIC CONTROL AND PROTECTION, STANDARD 701321	EACH	1	1	
70100450	TRAFFIC CONTROL AND PROTECTION, STANDARD 701201	LSUM	1	1	
70106500	TEMPORARY BRIDGE TRAFFIC SIGNALS	EACH	1	Y	
70106700	TEMPORARY RUMBLE STRIPS	EACH	6	6	
70107005	PAVEMENT MARKING BLACKOUT TAPE, 5"	FOOT	1768	1768	
70300100	SHORT TERM PAVEMENT MARKING	FOOT	112	112	
10000100		F VV1	1+6		

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FILE NAME :	USER NAME : AUSER*	DESIGNED -	RÉVISED ~			F.A.P SECTION	COUNTY SHEFTS
FILEL		DRAWN -	REVISED -	STATE OF ILLINOIS	SUMMARY OF QUANTITIES	653 (1058R-3)I F	PUTMAN 39
	PLOT SCALE + +SCALE+	CHECKED -	REVISED -	DEPARTMENT OF TRANSPORTATION			CONTRACT NO. 685
	PLOT DATE	DATE -	REVISED -		SCALE: NTS SHEET NO. 3 OF 5 SHEETS STA. N/A TO STA. I	Y/A ILLINOIS FED. AND PF	ROJECT

					TION CODE
				80% FED	80% FED
			1	20% STATE	20% STATE
			TOTAL	ROADWAY	SN 078-003
CODE NO.	ITEM	UNIT	QUANTITY	0004	0014
				RURAL	RURAL
70300150	SHORT TERM PAVEMENT MARKING REMOVAL	SO FT	756	756	
70300904	PAVEMENT MARKING TAPE, TYPE IV 4"	FOOT	1595	1595	
70300924	PAVEMENT MARKING TAPE, TYPE IV 24"	FOOT	24	24	
70400100	TEMPORARY CONCRETE BARRIER	FOOT	287.5	287.5	······
70400200	RELOCATE TEMPORARY CONCRETE BARRIER	FOOT	287.5	287.5	
70600250	IMPACT ATTENUATORS. TEMPORARY (NON- REDIRECTIVE), TEST LEVEL 3	EACH	2	2	
70600350	IMPACT ATTENUATORS. RELOCATE (NON- REDIRECTIVE). TEST LEVEL 3	EACH	2	2	
72501000	TERMINAL MARKER - DIRECT APPLIED	EACH .		1	
78005110	EPOXY PAVEMENT MARKING - LINE 4"	FOOT	2460	2460	
78100100	RAISED REFLECTIVE PAVEMENT MARKER	EACH	9	9	
70200000			A		
78200005	GUARDRAIL REFLECTORS. TYPE A	EACH	4	4	
78300200	RAISED REFLECTIVE PAVEMENT MARKER REMOVAL	EACH	9	9	
20001002	GUARDRAIL AGGREGATE EROSION CONTROL	TON	70	70	
20012754	STRUCTURAL REPAIR OF CONCRETE (DEPTH EQUAL TO OR LESS THAN 5 INCHES)	SO FT	15		15

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* SPECIALTY ITEM


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FILEL		DRAWN -	REVISED -	STATE OF ILLINOIS		SUM	MARY OF	QUAN	ITI
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ITITIES	··· · · · · · · · · ·	F.A.P RTE.	SECTION	COUNTY	TOTAL SHEET SHEETS NO.
111120		653	(1058R-3)]	PUTMAN	39 6

					TION CODE
•				80% FED	80% FED
		,		20% STATE	20% STAT
			TOTAL	ROADWAY	SN 078-00
CODE NO.	ITEM	UNIT	TOTAL	0004	0014
			QUANTITY	RURAL	RURAL
Z0013798	CONSTRUCTION LAYOUT	LSUM	1	0, 5	0.5
Z0073700	TEMPORARY WALL BRACING SYSTEM	LSUM			1
X0324028	GROUT FOR USE WITH RIPRAP	CU YD	76		76
	······································				
X4401198	HOT-MIX ASPHALT SURFACE REMOVAL, VARIABLE DEPTH	SO YD	411	411	
X7015005	CHANGEABLE MESSAGE SIGN	CAL DA	14	14	
×7030005	TEMPORARY PAVEMENT MARKING REMOVAL	S0 FT	580	590	
~1030005	TEMPUKAKT PAVEMENT MARKING KEMUVAL		380	580	· · · ·
				······	
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FILE NAME :	USER NAME = #USER#	DESIGNED -	REVISED -				F.A.P	SECTION	COUNTY	TOTAL SHEET
FILEL	· · · ·	DRAWN -	REVISED -	STATE OF ILLINOIS	SUMMARY OF QUANTITIES		653	(10588-31	PUTMAN	39 7
	PLOT SCALE . +SCALE .	CHECKED -	REVISED -	DEPARTMENT OF TRANSPORTATION					CONTRACT	T NO. 68579
	PLOT DATE + +OATE+	DATE -	REVISED -		SCALE: NTS SHEET NO. 5 OF 5 SHEETS STA. N/A	TO STA. N/A		ILLINOIS FED. A	NO PROJECT	



TULINOIS FED ALD PROJECT

				78005110	78100100	78300200
PAVEMENT	MAR	KING SCHE	DULES	EPOXY PAVEMENT Mark Line 4"	RAISED REFLECTIVE PAVEMENT	RAISED REFLECTIVE PAVEMENT MARKER
	LOC	CATION			MARKERS	REMOVAL
STATION	ΤO	STATION	OFFSET	(F00T)	(EACH)	(EACH)
121 + 85	ΤO	128 + 00	C/L	1,230	9	9
121 + 85	ΤO	128 + 00	RT. EDGE	615		
121 + 85	ΤO	128 + 00	LT. EDGE	615		
123 + 70	ΤO	125 + 70	RT. EDGE			
123 + 70	ΤO	125 + 70	LT. EDGE			
			TOTAL	2,460	9	9

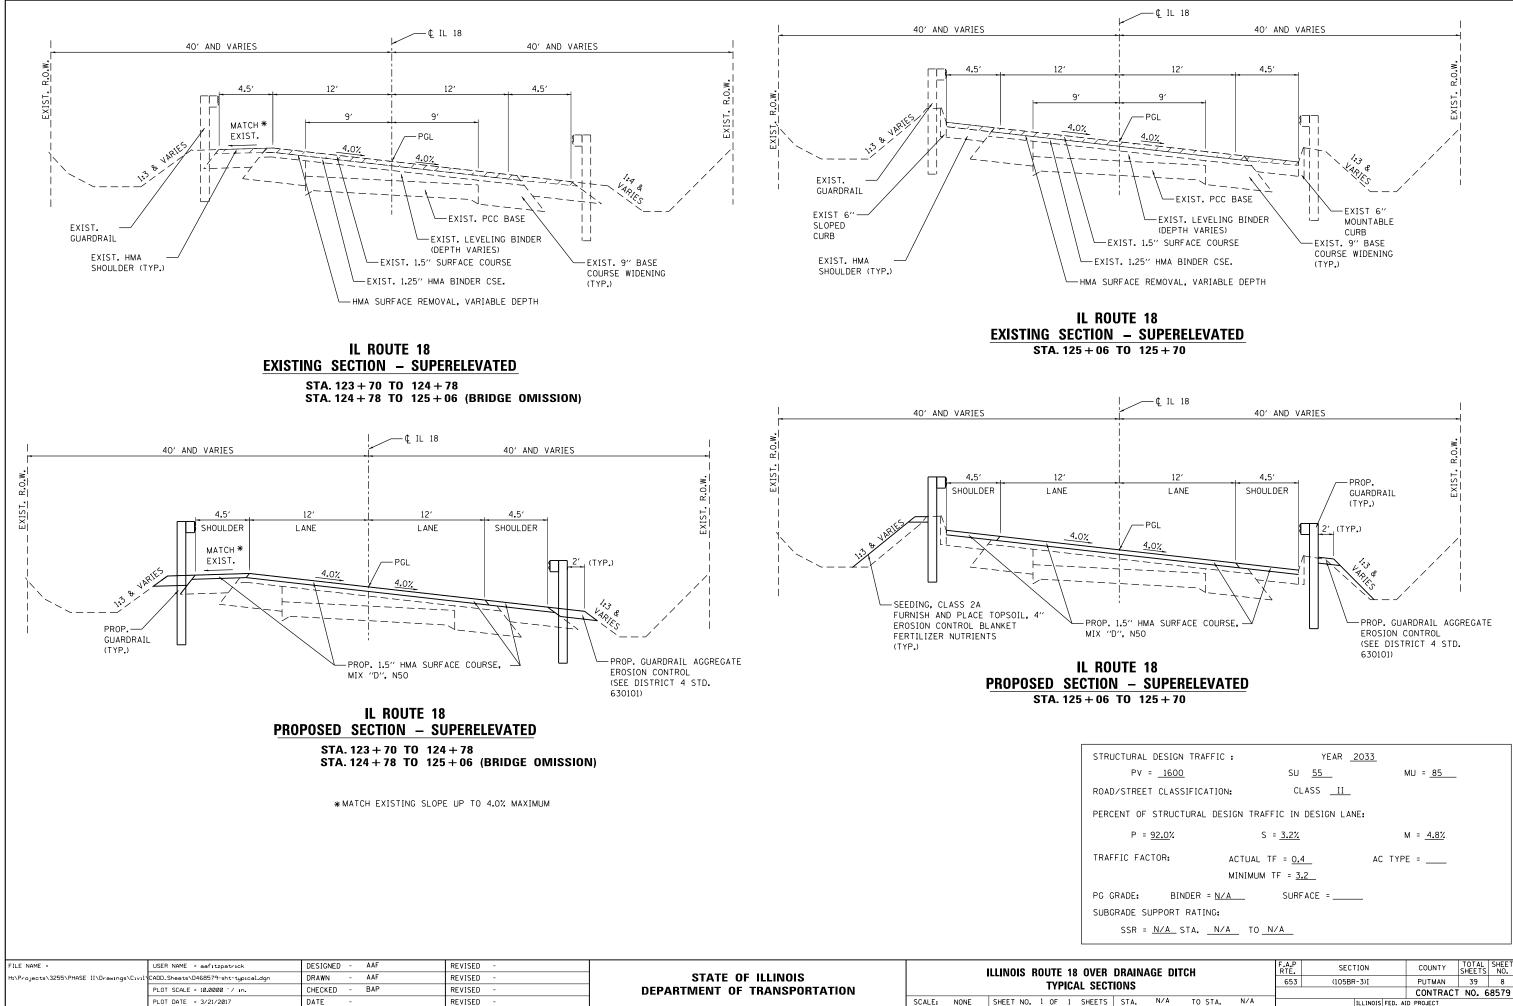				78005110	78100100	78300200
PAVEMENT	MAR	KING SCHE	EDULES	EPOXY PAVEMENT Mark., LINE 4"	RAISED REFLECTIVE PAVEMENT	RAISED REFLECTIVE PAVEMENT MARKEF
	L00	CATION			MARKERS	REMOVAL
STATION	ΤO	STATION	OFFSET	(F00T)	(EACH)	(EACH)
121 + 85	ΤO	128 + 00	C/L	1,230	9	9
121 + 85	ΤO	128 + 00	RT. EDGE	615		
121 + 85	ΤO	128 + 00	LT. EDGE	615		
123 + 70	ΤO	125 + 70	RT. EDGE			
123 + 70	ΤO	125 + 70	LT. EDGE			
			TOTAL	2,460	9	9

LOCATION	X7015005 CHANGEABLE MESSAGE SIGN
	CAL DAY
ENTIRE JOBSITE (2 SIGNS @ 7 DAYS/SIGN)	14
TOTAL	14

					70400100	70400200	70600250	70600350
MAINTEI	NANCE	NCE OF TRAFFIC SCHEDULES		TEMP. CONCRETE BARRIER	RELOCATE TEMPORARY	IMPACT ATT. TEMP. (NON-REDIRECTIVE)	IMPACT ATT. RELOCATE (NON-REDIRECTIVE)	
	L	OCATION				BARRIER		
STATION	STATION TO STATION OFFSET			STAGE	(FOOT)	(FOOT)	(EACH)	(EACH)
123 + 48	TO	126 + 35	C/L & RT.	STAGE 1	287.5			
123 + 48	TO	126 + 35	C/L & LT.	STAGE 2		287.5		
123 + 48			RT.	STAGE 1			1	
126 + 35			RT.	STAGE 1			1	
123 + 48			LT.	STAGE 2				1
126 + 35	126 + 35 LT. STAGE 2		STAGE 2				1	
				TOTAL	287.5	287.5	2	2

				63000001	63100087	63100167	63200310	72501000	78200005	Z0001002
GI	UARDF	AIL SCHEDULE	ES	SPBG, TYPE A, 6 FOOT POSTS	TRAF. BARR. TERM., TYPE 6A	TRAF. BARR. TERM., TYPE 1, (SPECIAL) TANGENT	GUARDRAIL REMOVAL	TERM. MARKER - DIRECT APPLIED	GUARDRAIL REFECTORS, TYPE A	GUARDRAIL AGG. EROSION CONTROL
STATION	TO	STATION	OFFSET	(F00T)	(EACH)	(EACH)	(F00T)	(EACH)	(EACH)	(TON)
123 + 76	TO	124 + 82	LT	(1001)	(ERGIN	(LROIT/	114	(EAGIN	(EAGIN	27
123 + 16	ТО	124 + 73	RT				57			15
125 + 01	TO	125 + 57	LT				57			13
125 + 10	ТО	125 + 76	RT				57			15
124 + 26	TO	124 + 39	LT	12.5					1	
124 + 17	ΤO	124 + 29	RT	12.5					1	
125 + 54	TO	125 + 67	LT	12.5					1	
125 + 45	TO	125 + 58	RT	12.5					1	
124 + 39	TO	124 + 83	LT		1					
124 + 29	TO	124 + 73	RT		1					
125 + 02	TO	125 + 54	LT		1					
125 + 01	TO	125 + 41	RT		1					
123 + 76	TO	124 + 26	LT			1		1		
			TOTAL	50	4	1	285	1	4	70

	CONT			20101100	28000400	20400500	28000250 TEMP.	28000305
EROSION	CON	IRUL SUF	IEDULES	TREE TRUNK PROTECTION	PERIMETER EROSION BARRIER	INLET AND PIPE PROTECTION	EROSION	TEMP. DITCH CHECK
	LOC	ATION					SEEDING	0.120.1
STATION	STATION TO STATION OFFSET		OFFSET	(EACH)	(FOOT)	(EACH)	(POUND)	(F00T)
125 + 52			35′ LT	1				
125 + 60			39′LT	1				
125 + 70			37′ LT	1				
125 + 73			40' LT	1				
123 + 64	ΤO	124 + 83	LT		126		10	12
123 + 70	ΤO	124 + 68	RT		90		9	12
125 + 11	ΤO	125 + 70	LT		82		5	12
125 + 03	ΤO	125 + 70	RT		45		10	12
125 + 21			RT			1		
125 + 38			LT			1		
			TOTAL	4	343	2	34	48

			G SCHEDUL	ГC	21101615	25000210	25000400	25000500	25000600	25100630
	LANDSCA	AF INC	, SCHEDUL		TOPSOIL FURN. &	SEEDING,	NITROGEN	PHOSP. FERT.	POTASSIUM	EROSION CONTROL
[LOCA	TION		PLACE, 4″	CLASS 2A	FERT. NUTR.	NUTR.	FERT. NUTR.	BLANKET
	STATION	TO	STATION	OFFSET	(SQ YD)	(ACRE)	(POUND)	(POUND)	(POUND)	(SQ YD)
	123 + 64	ΤO	124 + 83	LT	253	0.05	4.7	4.7	4.7	253
[123 + 70	TO	124 + 68	RT	213	0.05	4.0	4.0	4.0	213
	125 + 11	ΤO	125 + 70	LT	125	0.03	2.3	2.3	2.3	125
[125 + 03 TO 125 + 70 RT				235	0.05	4.4	4.4	4.4	235
[TOTAL	826	0.18	15.3	15.3	15.3	826

E	EARTHWORK SCHEDULES										
	LOCATION										
STATION	ΤO	STATION	OFFSET	(CU YD)							
123 + 70	ΤO	124 + 78	LT	23							
123 + 70	ΤO	124 + 78	RT	40							
125 + 06	ΤO	125 + 70	LT	97							
125 + 06	ΤO	125 + 70	LT	25							
			TOTAL	185							
			TOTAL	185							


				20400800						
E	EARTHWORK SCHEDULES									
	LOCATION									
STATION										
123 + 70	ΤO	124 + 78	LT	23						
123 + 70	ΤO	124 + 78	RT	40						
125 + 06	TO	125 + 70	LT	97						
125 + 06	TO	125 + 70	LT	25						
			TOTAL	185						

	121 + 85 TO 128 +		AVEMENT	70107005 PAVEMENT MARKING BLACKOUT TAPE, 5"	70300100 SHORT TERM PAVEMENT MARKING	70300150 SHORT TERM PAVEMENT MARKING REMOVAL	70300904 PAVEMENT MARKING TAPE, TYPE IV 4"	70300924 PAVEMENT MARKING TAPE, TYPE IV 24"	X7030005 TEMPORARY PAVEMENT MARKING REMOVAL
	L	OCATIO	N						
[STATION	ΤO	STATION	FOOT	FOOT	SQ FT	FOOT	FOOT	SQ FT
[121 + 85	ΤO	128 + 00	1768	112	756	1595	24	580
[·		TOTAL	1768	112	756	1595	24	580

			40600290	40600982	40600990	40603335	X4401198
ROADWAY F	PAVEMEN	T SCHEDULES	BITUMINOUS MATERIALS (TACK COAT)	HOT-MIX SURFACE REMOVAL (BUTT	TEMPORARY RAMP	HOT-MIX SURFACE CSE., MIX	HOT-MIX ASPHALT SURFACE REMOVAL,
	LOCATIO	N	(TACK CUAT)	JOINT)		"D", N50	VARIABLE DEPTH
STATION	TO	STATION	(POUND)	(SQ YD)	(SQ YD)	(TONS)	(SQ YD)
123 + 70	TO	124 + 78	214		27	34	
125 + 06	TO	125 + 70	127		27	20	
123 + 70	TO	124 + 00		110			286
125 + 40	TO	125 + 70		110			125
		TOTAL	341	220	54	54	411


FILE NAME =	USER NAME = \$USER\$	DESIGNED -	REVISED -			ILLINOIS ROUTE 18 OVER DRAINAGE DITCH	F.A.P RTE.	SECTION	COUNTY TOTAL SHEET SHEETS NO.
\$FILEL\$		DRAWN -	REVISED -	STATE OF ILLINOIS		SCHEDULE OF QUANTITIES	653	(105BR-3)I	PUTMAN 39 9
	PLOT SCALE = \$SCALE\$	CHECKED -	REVISED -	DEPARTMENT OF TRANSPORTATION		SCHEDULE OF QUANTILES			CONTRACT NO. 68579
	PLOT DATE = \$DATE\$	DATE -	REVISED -		SCALE: SHEET NO. 1 OF 1 SHEETS STA. TO STA.			ILLINOIS FED.	AID PROJECT

TREE REMO	VAL SCHEDULES	20100110 TREE REMOVAL (6 TO 15 UNITS DIA.)
L	DCATION	
STATION	OFFSET	(UNITS)
17 + 45	LT	10
17 + 50	LT	10
17 + 55	LT	10
		30

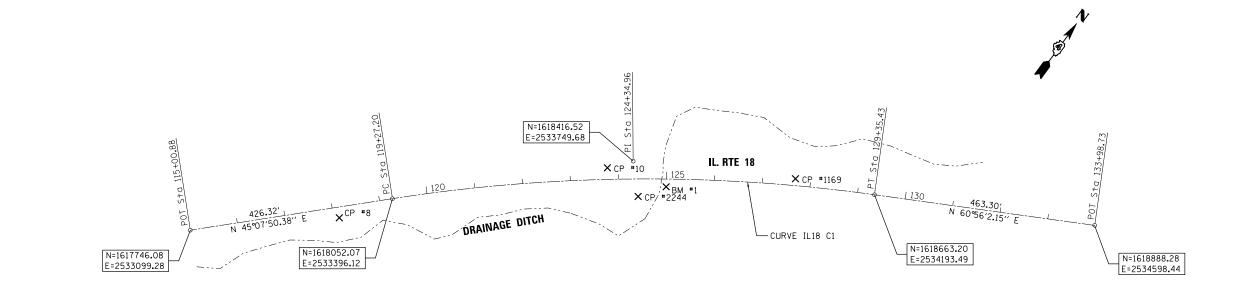



BENCHMARK DATA

BM*1 CHISELED SQUARE AT SOUTHEAST CORNER OF BRIDGE DECK AT STA. 124+98, 16.5 FT. RT. ELEV 567.33

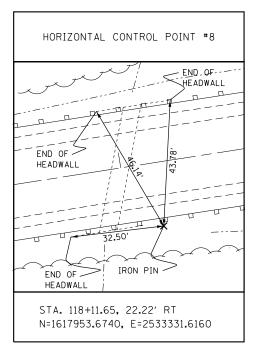

HORIZONTAL CONTROL POINTS

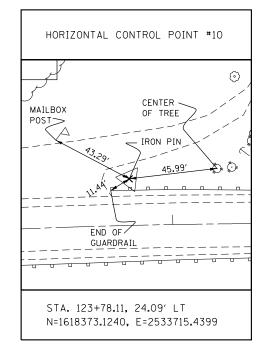


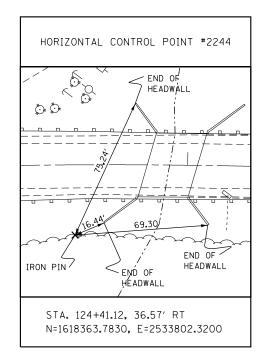



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H:\Projects\3255\PHASE II\Drawings\Civil	CADD_Sheets\D468579-sht-ATB.dgn	DRAWN - AAF	REVISED -	STATE OF ILLINOIS	ALIGNMENT, BENCHARKS & TIES			553	(105BR-3)I	PUTMAN	39 1				
	PLOT SCALE = 200.0000 ' / in.	CHECKED - BAP	REVISED -	DEPARTMENT OF TRANSPORTATION				II, DENO	IIAIIKO	d IIL3				CONTRAC	CT NO. 6857
	PLOT DATE = 3/21/2017	DATE -	REVISED -		SCALE: 1"=100' SHEET NO. OF SHEETS STA. TO STA.				ILLINOIS FED. A	ID PROJECT					

CURVE DATA

EXIST. CURVE IL18_C1 PI STA. = 124+34.96 △ = 16° 48' 12'' (RT) D = 1° 40' 00'' R = 3,437.87' T = 507.76' L = 1,008.23' E = 37.29' 4.0% (EXISTING) T.R. = 40' S.E. RUN = 140' P.C. STA. = 119+27.20 P.T. STA. = 129+35.43

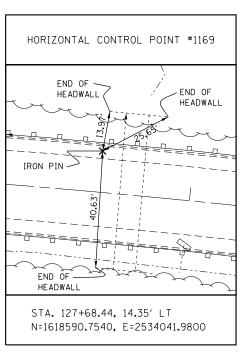

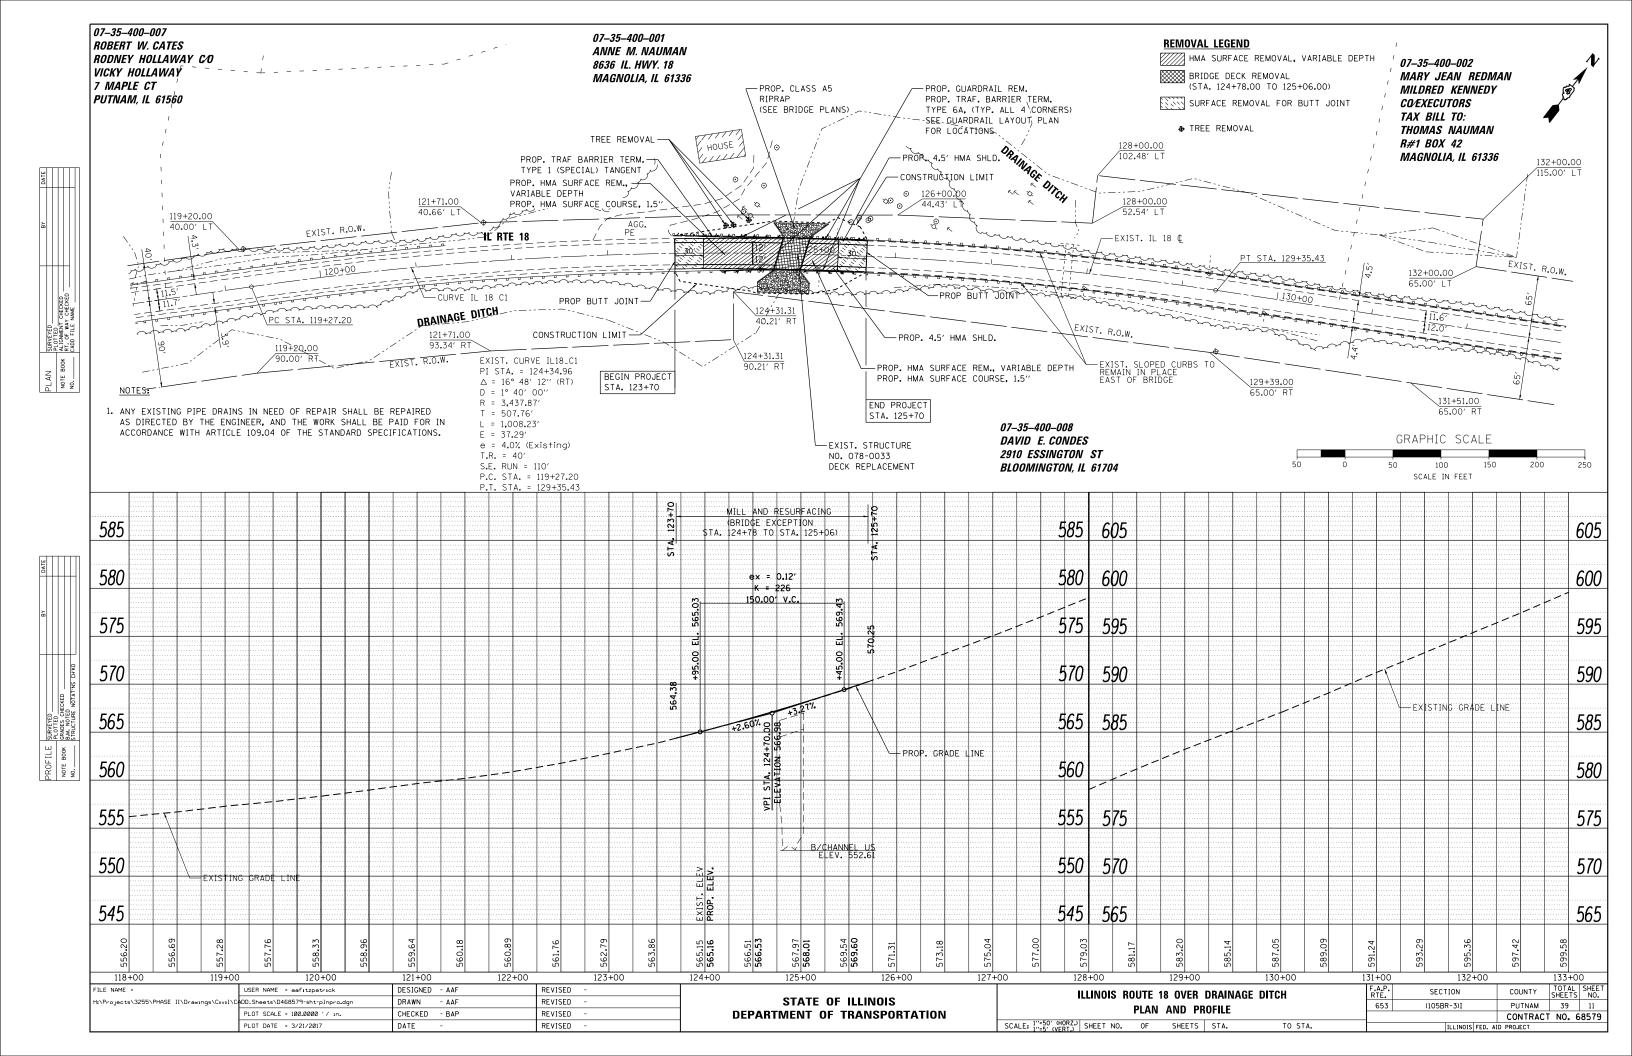

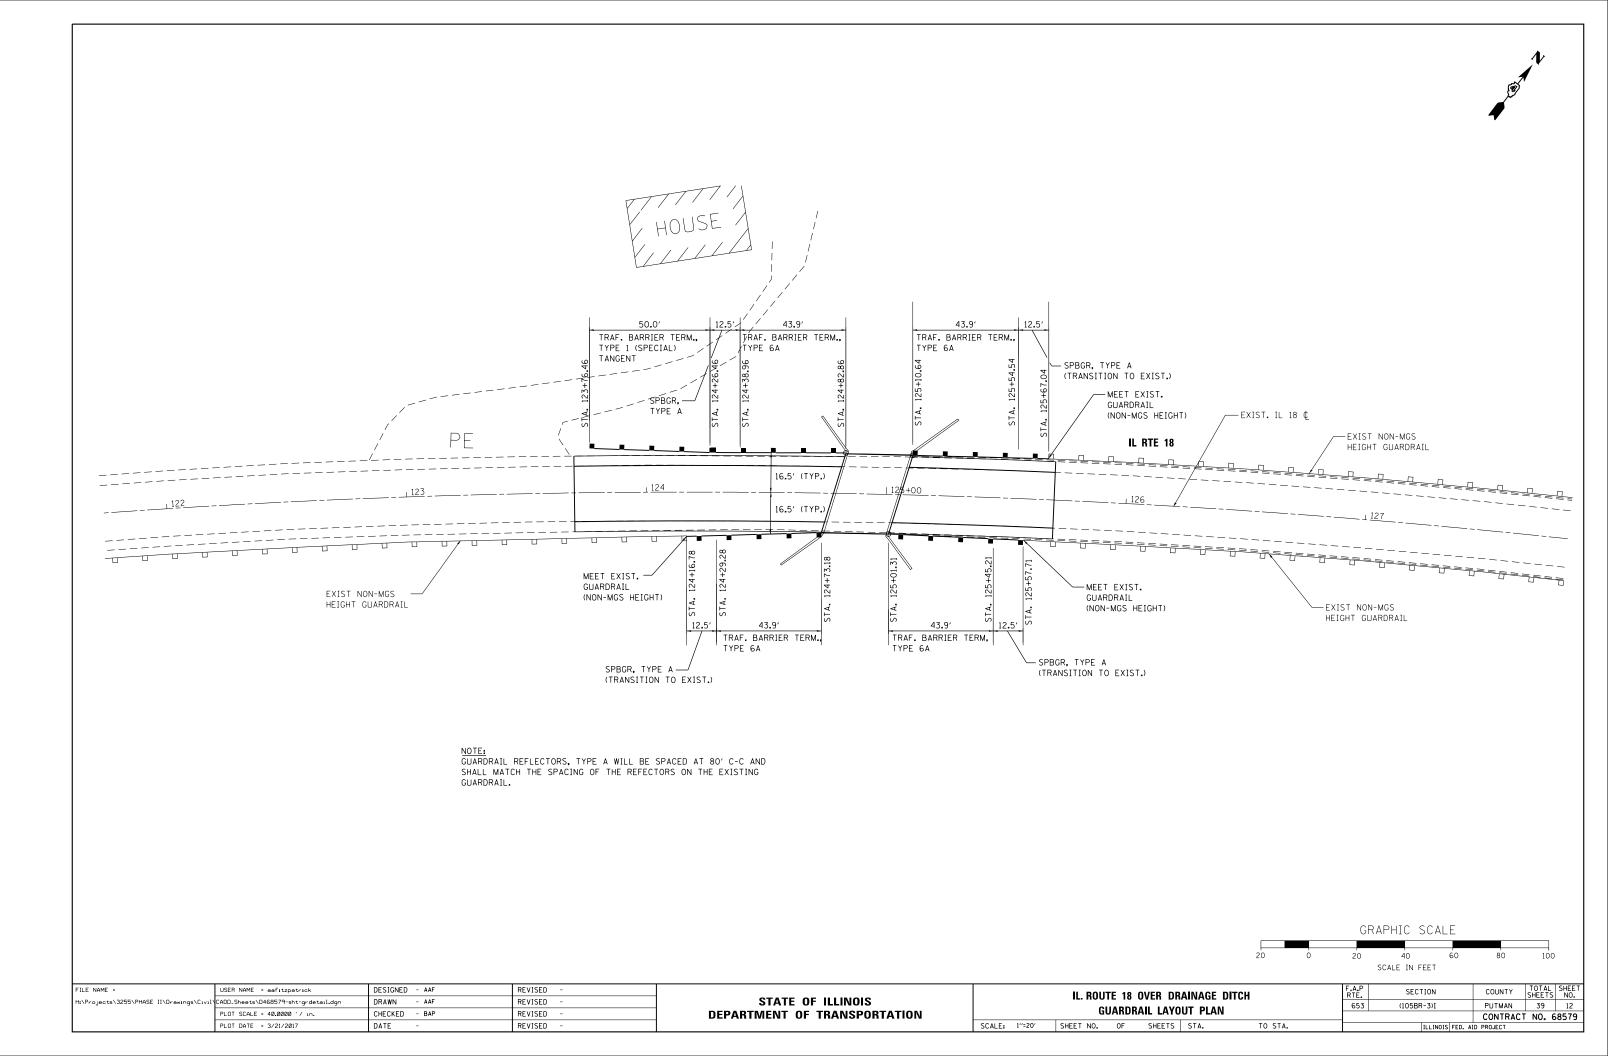

IL ROUTE 18 MAINTENANCE OF TRAFFIC NOTES

STAGE 1

EXISTING: TWO LANE, TWO WAY ROAD

PROPOSED: ONE LANE, ONE WAY TRAFFIC IN CONSTRUCTION AREA CONTROLLED BY IDOT STD. 701321.

TRAFFIC CONTROL AND PROTECTION -USE IDOT STANDARD 701201 FOR INSTALLATION.

1. INSTALL STAGE 1 TEMPORARY BARRIERS, ATTENUATORS, DEVICES, AND SIGNS ACCORDING TO IDOT STD. 701321 (SEE STAGE 1 PLAN). 2. INSTALL STAGE 1 TEMPORARY PAVEMENT MARKINGS, AND STOP LINE FOR TEMPORARY SIGNALS. REMOVE ANY PAVEMENT MARKINGS THAT CONFLICT WITH STAGE TRAFFIC. 3. INSTALL TEMPORARY TRAFFIC SIGNALS INCLUDING

SIGNALS WITH DETECTION FOR THE PRIVATE DRIVE WEST OF THE BRIDGE.

4. SHIFT IL 18 TRAFFIC TO THE NORTH SIDE OF THE EXISTING BRIDGE (SEE BRIDGE PLAN FOR DETAILS)

CONSTRUCTION

I. REMOVE SOUTH 18' OF EXISTING BRIDGE DECK, BRIDGE RAILS, AND GUARDRAIL. 2. CONSTRUCT SOUTH 16.5' OF PROPOSED BRIDGE. 3. CONSTRUCT PROPOSED GUARDRAIL ALONG SOUTH SIDE OF ROADWAY.

4. EXISTING DRIVEWAY ACCESS SHALL BE MAINTAINED BY THE CONTRACTOR WITHIN THE STAGING AREA.

STAGE 2

EXISTING: ONE LANE, ONE WAY TRAFFIC IN CONSTRUCTION AREA CONTROLLED BY TEMPORARY TRAFFIC SIGNAL AND IDOT STANDARD 701321.

PROPOSED: ONE LANE, ONE WAY TRAFFIC IN CONSTRUCTION AREA CONTROLLED BY TEMPORARY TRAFFIC SIGNAL AND IDOT STANDARD 701321.

TRAFFIC CONTROL AND PROTECTION -USE IDOT STANDARD 701201 FOR INSTALLATION.

1. RELOCATE TEMPORARY BARRIERS. ATTENUATORS, DEVICES, AND SIGNS ACCORDING TO IDOT STD. 701321 (SEE STAGE 2 PLAN) 2. INSTALL STAGE 2 TEMPORARY PAVEMENT MARKINGS. REMOVE ANY PAVEMENT MARKINGS THAT CONFLICT WITH STAGE TRAFFIC. 4. SHIFT IL 18 TRAFFIC TO THE SOUTH SIDE OF THE EXISTING BRIDGE (SEE BRIDGE PLAN FOR DETAILS)

CONSTRUCTION

1. REMOVE NORTH 15' OF EXISTING BRIDGE DECK, BRIDGE RAILS, AND GUARDRAIL. 2. CONSTRUCT NORTH 16.5' OF PROPOSED BRIDGE. 3. CONSTRUCT PROPOSED GUARDRAIL ALONG NORTH SIDE OF ROADWAY. 4. EXISTING DRIVEWAY ACCESS SHALL BE MAINTAINED BY THE CONTRACTOR WITHIN THE STAGING AREA.

REMOVE STANDARD 701321 INSTALL SHORT TERM PAVEMENT MARKING.


STAGE 3

EXISTING: TWO LANE, TWO WAY TRAFFIC


PROPOSED: ONE LANE, ONE WAY TRAFFIC

TRAFFIC CONTROL AND PROTECTION -IDOT STANDARDS 701201 AND 701311.

CONSTRUCTION 1. MILL EXISTING PAVEMENT AND PLACE OVERLAY ON LANES AND SHOULDERS. 2. INSTALL PERMANENT PAVEMENT MARKINGS ON ROADWAY AND BRIDGE. 3. PERFORM LANDSCAPING OPERATIONS.

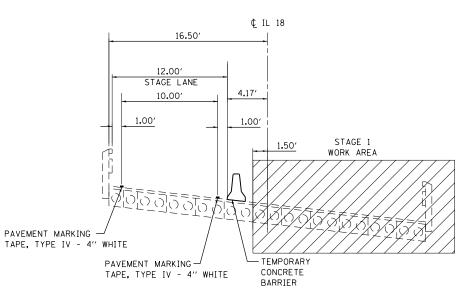




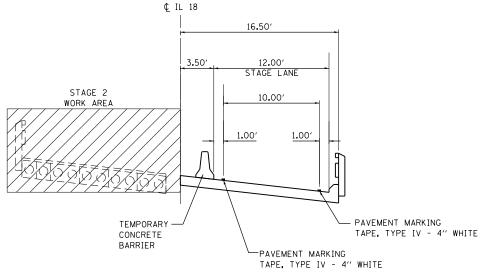


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	PLOT SCALE = 10.0000 ' / in.	CHECKED - BAP	REVISED -	DEPARTMENT OF TRANSPORTATION	MAINTENANCE OF TRAFFIC NOTES AND TYPICAL SECTIONS		CONTRACT NO. 68579
	PLOT DATE = 3/21/2017	DATE -	REVISED -		SCALE: SHEET NO. OF SHEETS STA. TO STA.	ILLINOIS FED. #	AID PROJECT




TYPICAL SECTION STAGE 2

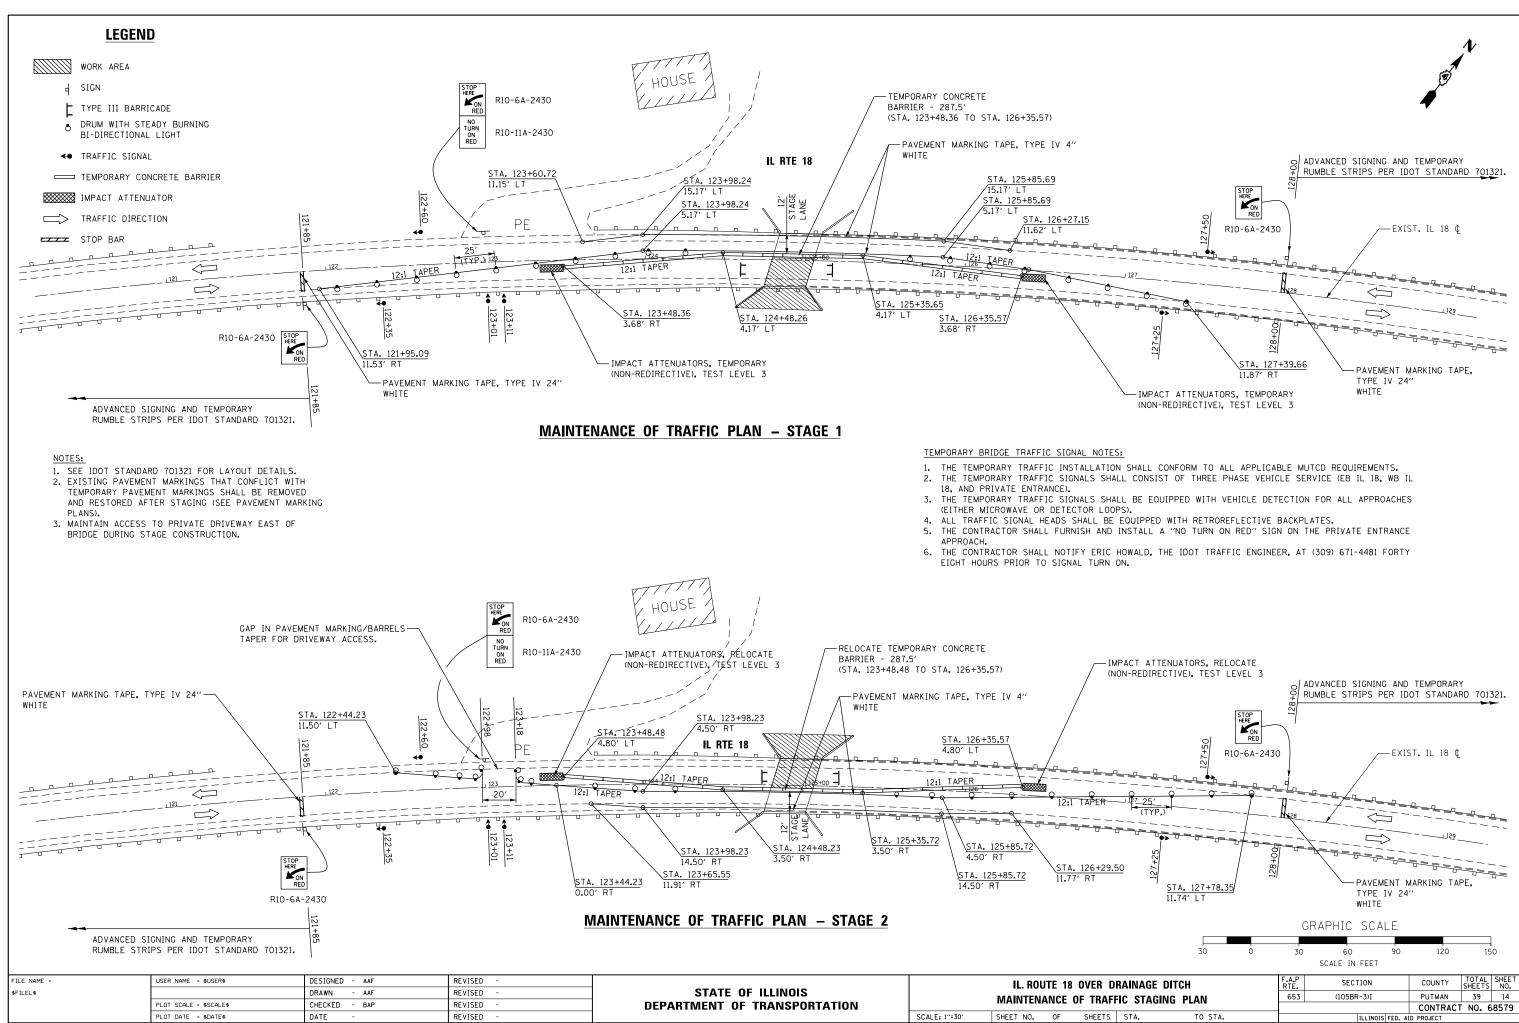

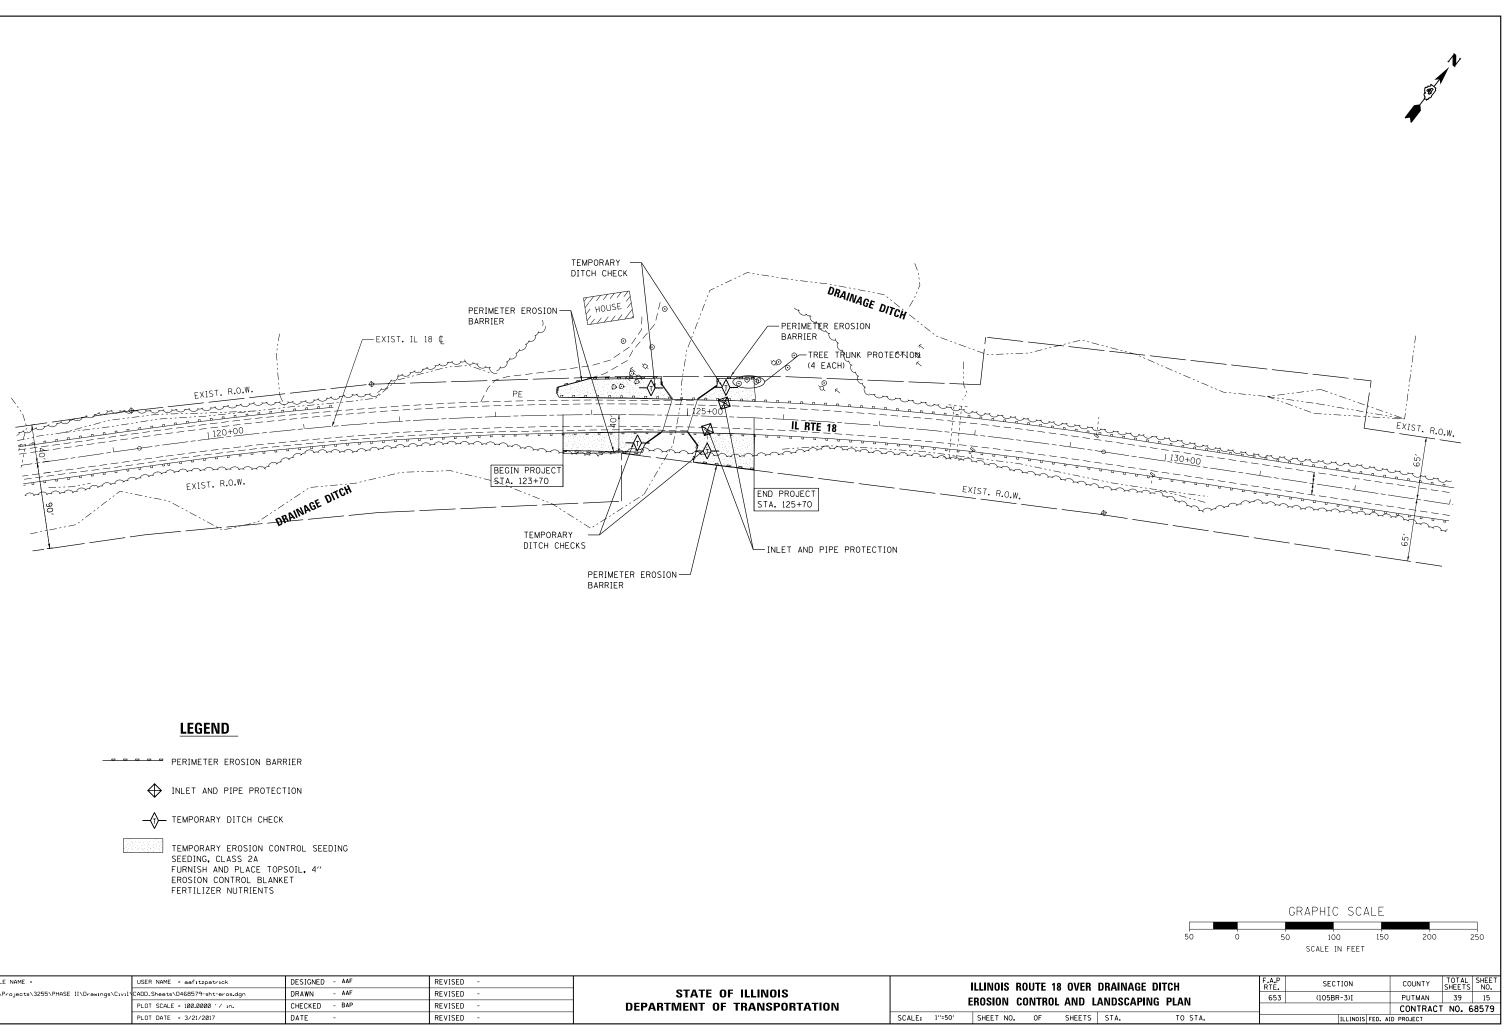


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H:\Projects\3255\PHASE_II\Drawings\Civil\	CADD_Sheets\D468579-sht-eros.dgn	DRAWN - AAF	REVISED -	STATE OF ILLINOIS			ILLINOIS R		
	PLOT SCALE = 100.0000 '/ in.	CHECKED - BAP	REVISED -	DEPARTMENT OF TRANSPORTATION			EROSION C	ONTRO	L AND L
	PLOT DATE = 3/21/2017	DATE -	REVISED -		SCALE:	1''=50'	SHEET NO.	OF	SHEETS

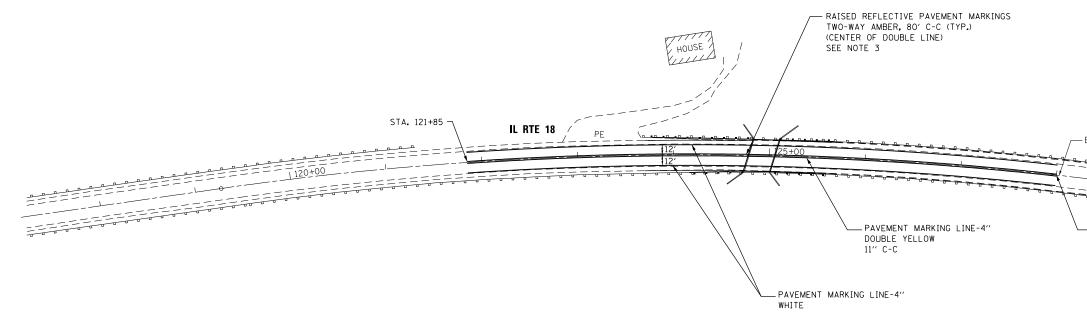


NOTES:

- 1. SEE IDOT STANDARD 781001 AND DISTRICT 4 STANDARD 781001-D4 FOR PAVEMENT MARKING LAYOUT DETAILS.
- 2. SEE IDOT STANDARD 781001 FOR TYPICAL RAISED REFLECTIVE PAVEMENT MARKING LAYOUT DETAILS.
- 3. THE SPACING AND LOCATION OF THE PROPOSED RAISED REFLECTIVE MARKERS SHALL MATCH THE EXISTING MARKER SPACING ON BOTH SIDES OF THE PROJECT LIMIT. DO NOT INSTALL RAISED REFLECTIVE PAVEMENT MARKERS ON THE NEW BRIDGE DECK.

FILE NAME =	USER NAME = aafitzpatrick	DESIGNED - AAF	REVISED -			IL. ROUT	TE 10 0	VER DR	^
H:\Projects\3255\PHASE II\Drawings\Civil	CADD_Sheets\D468579-sht-pmk.dgn	DRAWN - AAF	REVISED -	STATE OF ILLINOIS					
	PLOT SCALE = 100.0000 ' / in.	CHECKED - BAP	REVISED -	DEPARTMENT OF TRANSPORTATION		PA	VEIMEN	T MARKI	INC
	PLOT DATE = 3/21/2017	DATE -	REVISED -		SCALE: 1"=20"	SHEET NO.	OF	SHEETS	

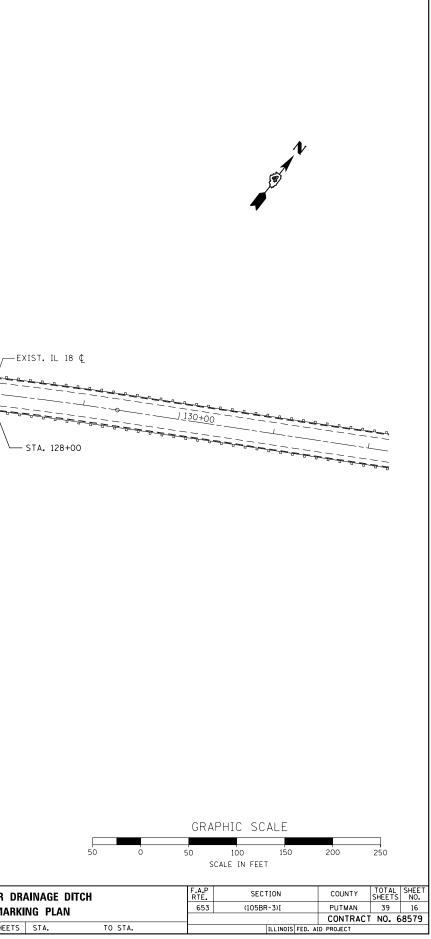

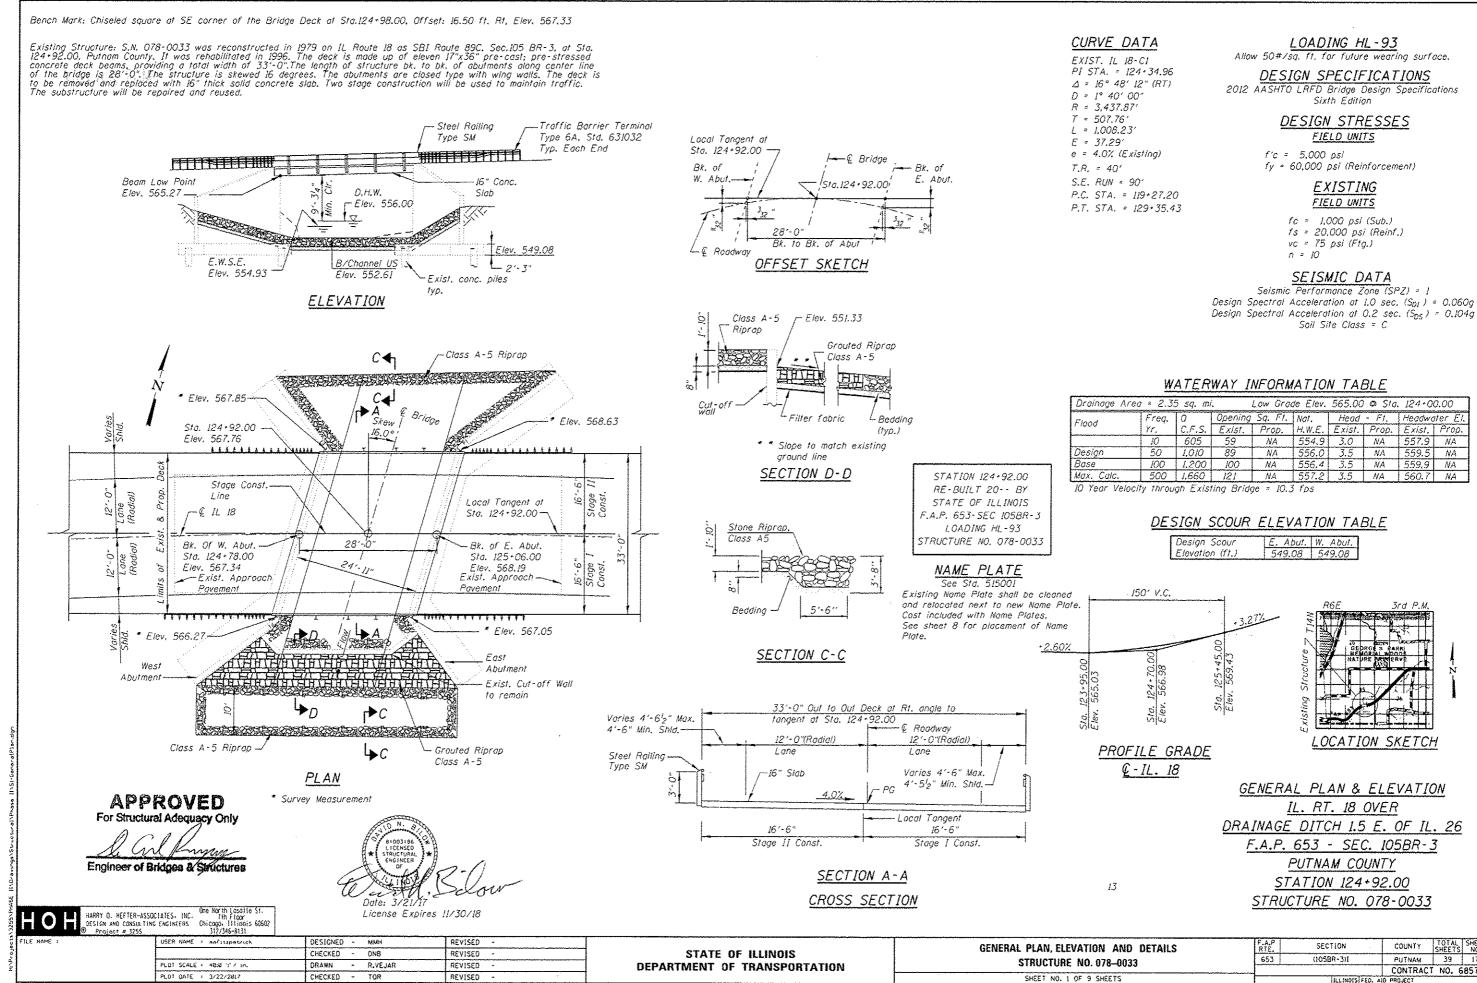




Are	ea = 2.3	5 sq. m	i.	Low Gra	de Elev.	565.00	@ \$1a	. 124+0	0.00
	Freq.	0	Opening	Sq. Ft.	Nat.	Head	- Ft.	Headwa	iter El.
	Yr.	C.F.S.	Exist.	Prop.	H.W.E.	Exist.	Prop.	Exist.	Prop.
	10	605	59	NA	554.9	3.0	NA	557.9	NA
	50	1,010	89	NA	556.0	3.5	NA	559.5	NA
	100	1.200	100	NA	556.4	3.5	NA	559,9	NA
c .	500	1,660	121	NA	557.2	3.5	NA	560.7	NA
			ting Brid			<u></u>		000.7	

Design Scour	E. Abut.	W. Abut.
Elevation (ft.)	549.08	549.08

AND DETAILS	F.A.P RTE.	SECTION	COUNTY	TOTAL	SHEET NO.
0033	653	(105BR-3)I	PUTNAM	39	17
			CONTRACT	NO. 6	8579
5		ILLINOIS FED. AL	D PROJECT		
S		ILLINOIS FED. AI	D PROJECT	······	

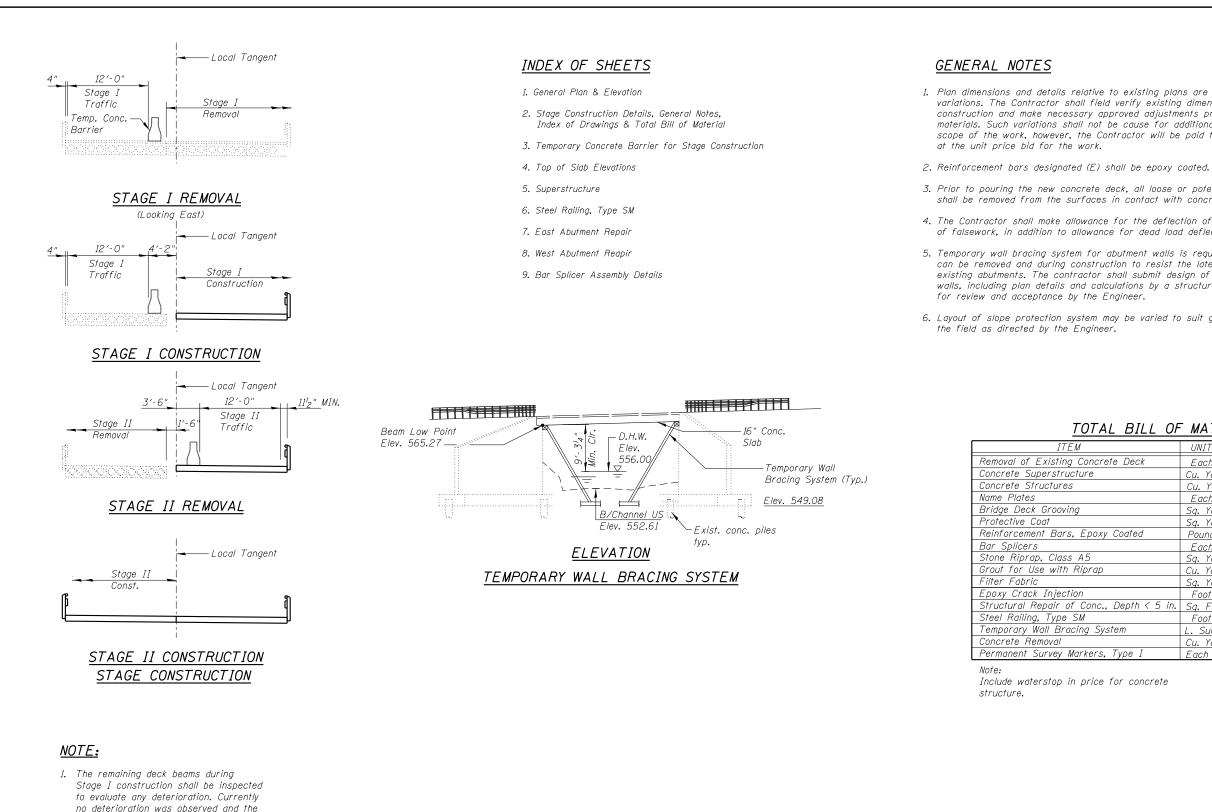

beams are adequate to carry stage traffic.

HOH	HARRY O. HEFTER-ASSOCIATES, INC.	One North Lasalle St. 7th Floor
	DESIGN AND CONSULTING ENGINEERS	Chicago, Illinois 60602
	Project # 3255	312/346-8131

	Project # 3255	512/346-8151									
FILE NAME =		USER NAME = aafitzpatrick	DESIGNED - MM	мн	REVISED -		STAGE CONSTRUCTION DETAILS, GENERAL NOTES,	F.A.P RTF	SECTION	COUNTY TOTAL SHEETS	SHEET
no r			CHECKED - DNE	NB	REVISED -	STATE OF ILLINOIS	INDEX OF DRAWINGS AND TOTAL BILL OF MATERIAL	653	(105BR-3)I	PUTNAM 39	18
		PLOT SCALE = 40:0 ':' / in.	DRAWN - R.V	VEJAR	REVISED -	DEPARTMENT OF TRANSPORTATION	STRUCTURE NO. 078–0033			CONTRACT NO. 68	8579
		PLOT DATE = 5/11/2017	CHECKED - TOP	OR	REVISED -		SHEET NO. 2 OF 9 SHEETS		ILLINOIS FED	. AID PROJECT	

1. Plan dimensions and details relative to existing plans are subject to nominal construction variations. The Contractor shall field verify existing dimensions and details affecting new construction and make necessary approved adjustments prior to construction or ordering of materials. Such variations shall not be cause for additional compensation for a change in scope of the work, however, the Contractor will be paid for the quantity actually furnished

3. Prior to pouring the new concrete deck, all loose or potentially detrimental foreign material shall be removed from the surfaces in contact with concrete.


4. The Contractor shall make allowance for the deflection of forms, shrinkage and settlement of falsework, in addition to allowance for dead load deflection.

5. Temporary wall bracing system for abutment walls is required before the superstructure can be removed and during construction to resist the lateral earth forces acting on the existing abutments. The contractor shall submit design of bracing system for abutment walls, including plan details and calculations by a structural engineer registered in Illinois

6. Layout of slope protection system may be varied to suit ground conditions in

EM	UNIT	SUPER	SUB	TOTAL
g Concrete Deck	Each	1	-	1
ucture	Cu. Yd.	48.3	-	48.3
S	Cu. Yd.	-	0.6	0.6
	Each	-	1	1
ing	Sq. Yd.	98	-	98
	Sq. Yd.	105	-	105
s, Epoxy Coated	Pound	16,920	-	16,920
	Each	90	-	90
s A5	Sq. Yd.	-	343	343
Riprap	Cu. Yd.	-	76	76
	Sq. Yd.	-	343	343
tion	Foot	-	158	158
of Conc., Depth < 5 in.	Sq. Ft.	-	15	15
SM	Foot	58	-	58
acing System	L. Sum	-	1	1
	Cu. Yd.	-	0.6	0.6
Markers, Type I	Each	1	-	1

TOTAL BILL OF MATERIAL

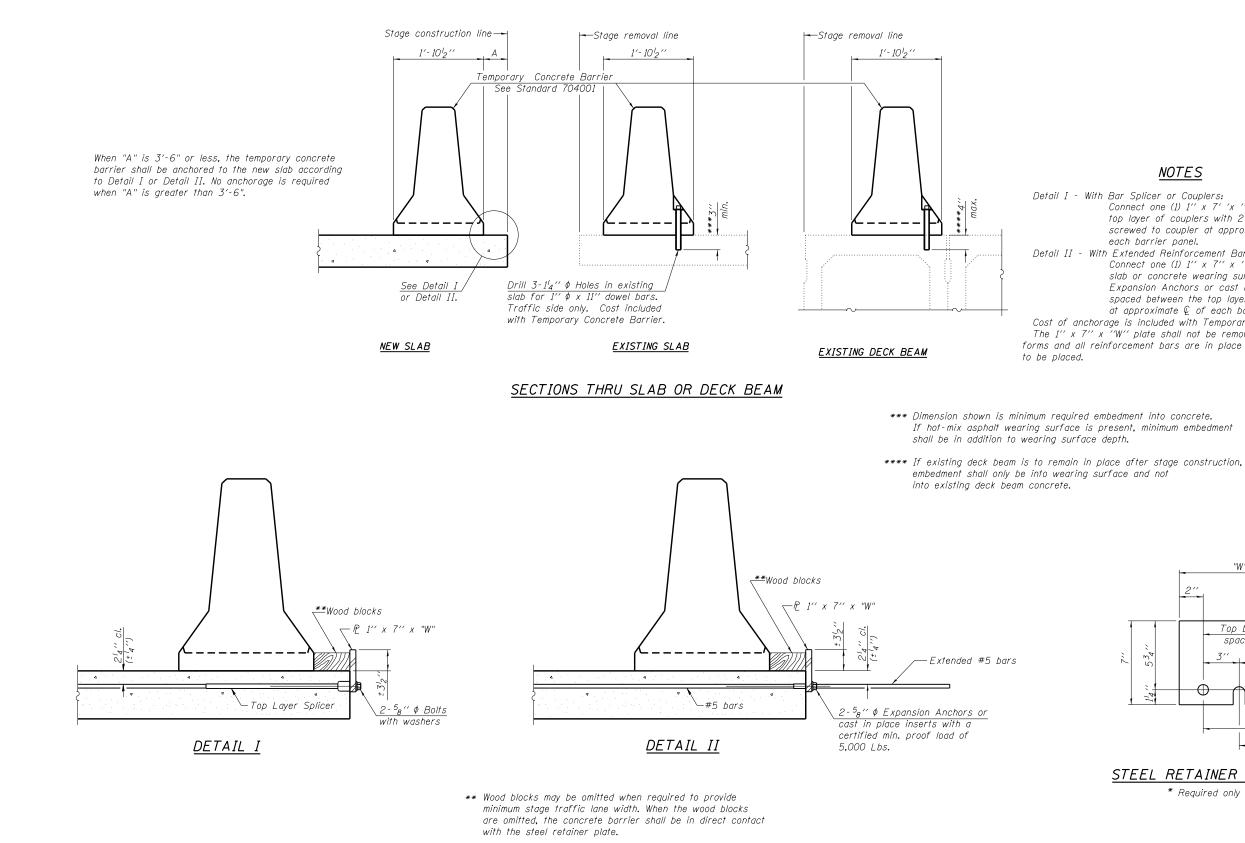

"W" = Top bars spacing + 4"


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7-1-10

FILE NAME =	USER NAME = aafitzpatrick	DESIGNED - MMH	REVISED -		TEMPORARY CONCRETE BARRIER FOR STAGE CONSTRUCTION	F.A.P RTE	SECTION	COUNTY TOTAL SHEET SHEETS NO.
0 0		CHECKED - DNB	REVISED -	STATE OF ILLINOIS	STRUCTURE NO. 078–0033	653	(105BR-3)I	PUTNAM 39 19
7 H	PLOT SCALE = 0:2 ':' / in.	DRAWN - R.VEJAR	REVISED -	DEPARTMENT OF TRANSPORTATION				CONTRACT NO. 68579
	PLOT DATE = 3/21/2017	CHECKED - TOR	REVISED -		SHEET NO. 3 OF 9 SHEETS		ILLINOIS FED.	. AID PROJECT

NOTES

Detail I - With Bar Splicer or Couplers: Connect one (1) $1'' \times 7' \times 'W''$ steel P to the top layer of couplers with $2^{-5}s'' \phi$ bolts screwed to coupler at approximate \mathcal{Q} of each barrier panel. Detail II - With Extended Reinforcement Bars: Connect one (1) I'' x 7'' x 'W'' steel ₱ to the concrete slab or concrete wearing surface with 2-5₈'' ¢ Expansion Anchors or cast in place inserts spaced between the top layer of reinforcement at approximate Q of each barrier panel. Cost of anchorage is included with Temporary Concrete Barrier. The 1" x 7" x "W" plate shall not be removed until stage II construction forms and all reinforcement bars are in place and the concrete is ready

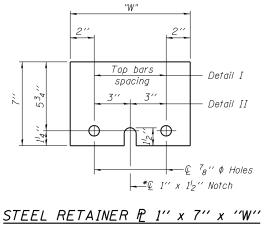

^{*} Required only with Detail II

N. EDGE OF DECK

Location	Station	Offset	Theoretical Grade Elevations	Theoretical Grade El. Adj. for D.L. Deflection
Bk. of W. Abut.	12482.73	- 16.50	568.14	568.14
A	12492.73	- 16.50	568.44	568.46
B	12502.73	- 16.50	568.75	568.76
Bk. of E. Abut.	12510.73	- 16.50	569.00	569.00

	<u>S. EDGE O</u>	F DECK		
Location	Station	Offset	Theoretical Grade Elevations	Theoretical Grade El. Adj. for D.L. Deflection
Bk. of W. Abut. A B Bk. of E. Abut.	12473.27 12483.27 12493.27 12501.27	16.50 16.50 16.50 16.50	566.54 566.84 567.14 567.39	566.54 566.86 567.15 567.39




Location

Bk. of W. Abut.

R

Note: The below deflections are not to be used in the field if the engineer is working from the grade elevations adjusted for dead load deflections as shown above.



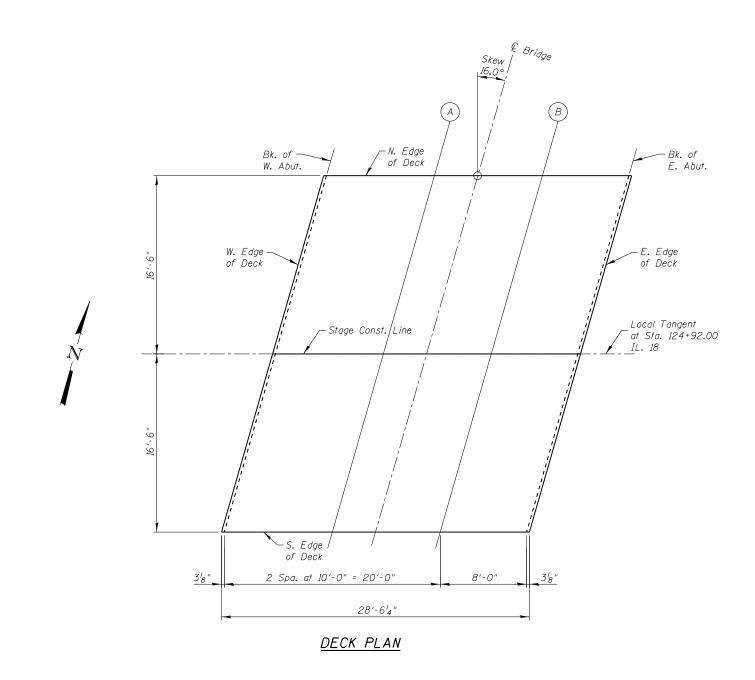

\3255\PH	HOHHARRY O. HEFTER-ASSO DESIGN AND CONSULTINU ® Project # 325	CIATES, INC. CIATES, INC. CIATES, INC. Chicago, Illinois 60602 312/346-8131							
ects	FILE NAME =	USER NAME = aafitzpatrick	DESIGNED - MMH	REVISED -		TOP OF SLAB ELEVATIONS	F.A.P	SECTION	COUNTY TOTAL SHEET
ro je			CHECKED - DNB	REVISED -	STATE OF ILLINOIS		653	(105BR-3)I	PUTNAM 39 20
μŢ		PLOT SCALE = 40:0 ':" / in.	DRAWN - R.VEJAR	REVISED -	DEPARTMENT OF TRANSPORTATION	STRUCTURE NO. 078–0033			CONTRACT NO. 68579
		PLOT DATE = 3/21/2017	CHECKED - TOR	REVISED -		SHEET NO. 4 OF 9 SHEETS		ILL INOIS F	FED. AID PROJECT


STAGE CONSTRUCTION LINE


Station	Offset	Theoretical Grade Elevations	Theoretical Grade El. Adj. for D.L. Deflection
12478.00	0.00	567.34	567.34
12488.00	0.00	567.64	567.66
12498.00	0.00	567.94	567.96
12506.00	- 0.00	568.19	568.19

DEAD LOAD DEFLECTION DIAGRAM

(Includes weight of concrete only.)


- Bk. of E. Abut - Bk. of W. Abut. _∞_ _4 _∞] 4 Spa. at 7'-0" = 28'-0"

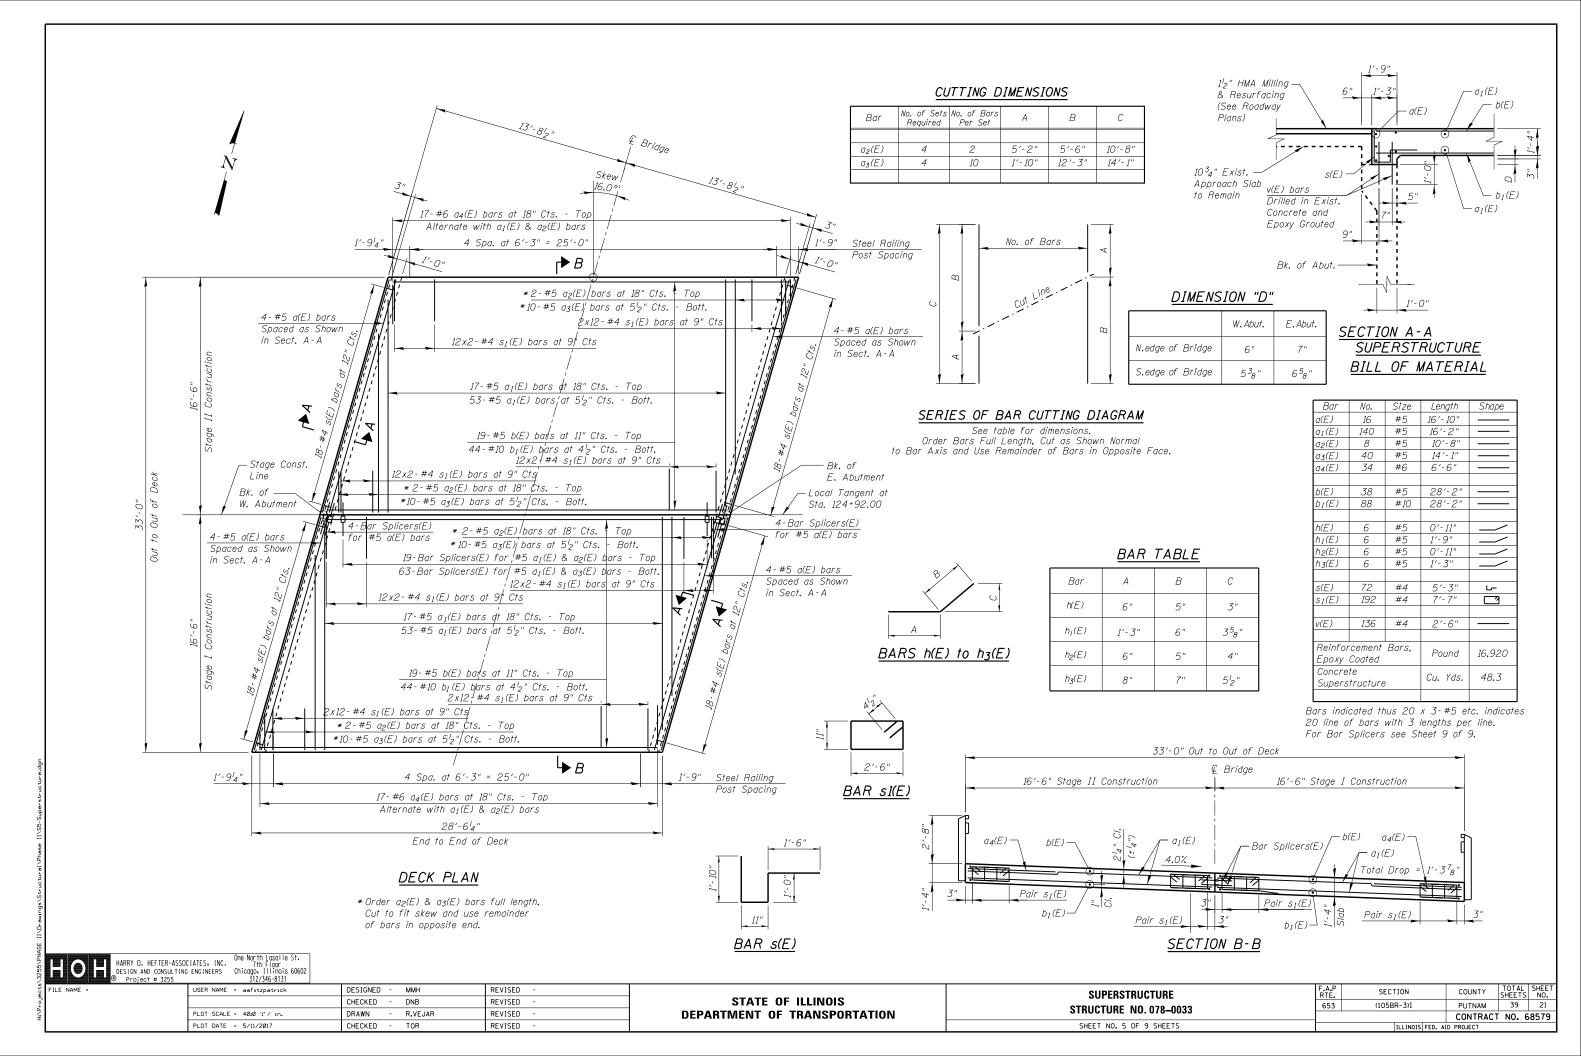


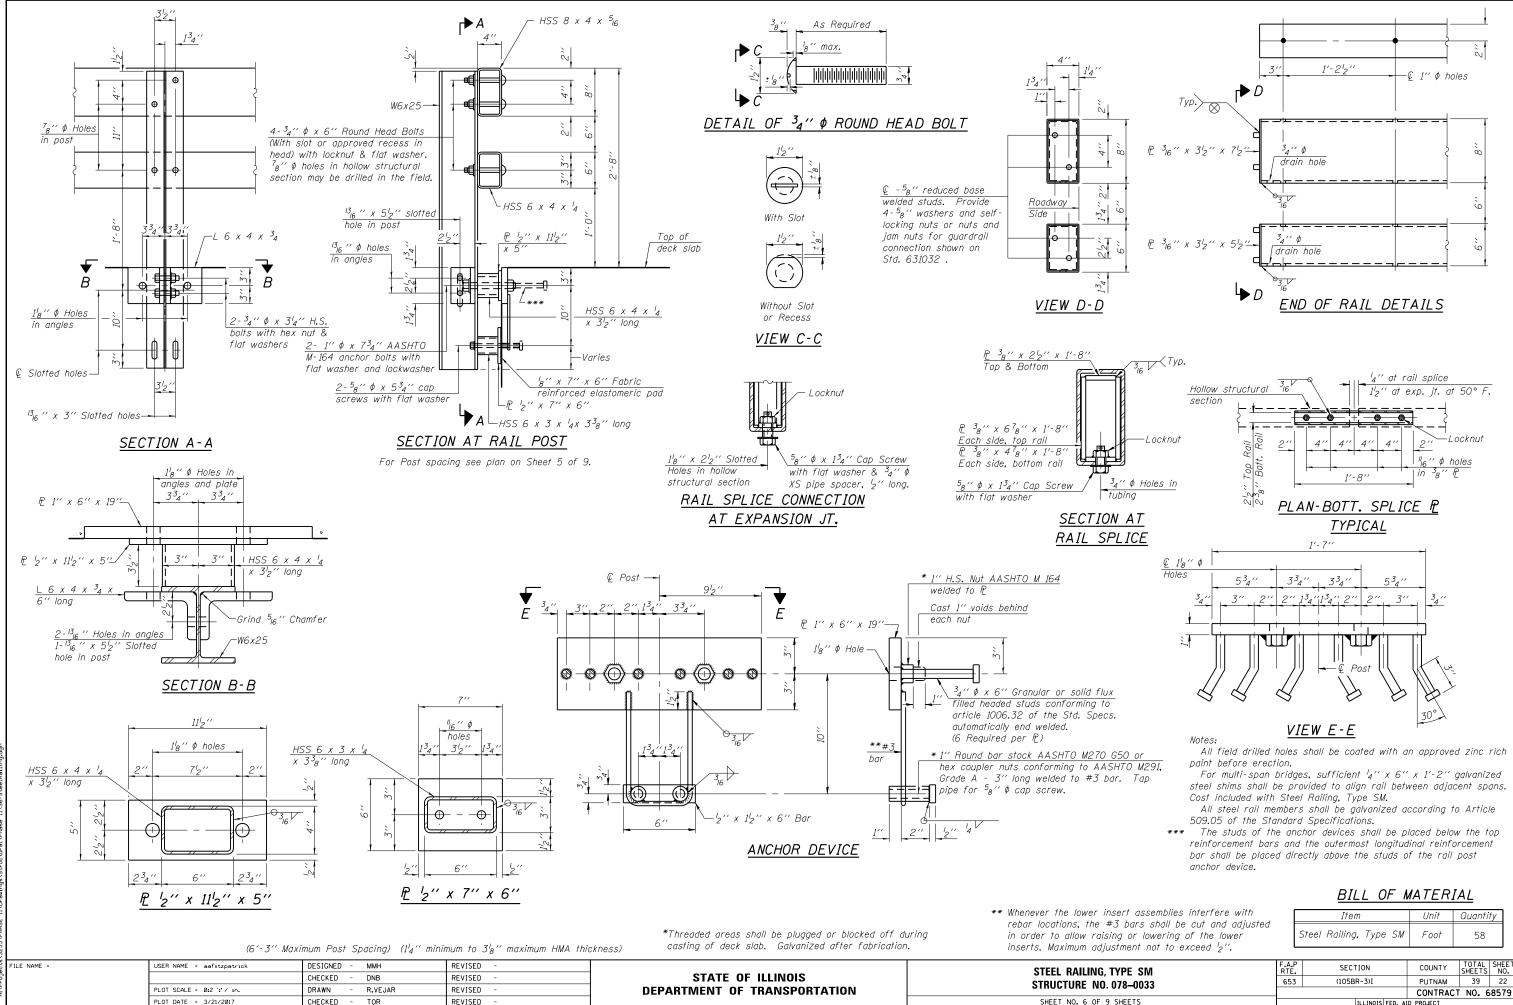


		<u>BILL OF M</u>	ATERI	<u>AL</u>	
insert assemblies interfere with #3 bars shall be cut and adjusted sing or lowering of the lower iustment not to exceed '2''.		Item	Unit	Quantity	
		Steel Railing, Type SM	Foot	58	
TYPE SM	F.A.P RTE.	SECTION	COUNTY		HEET NO.
. 078–0033	653	(105BR-3)I	PUTNAM		22

TULINOIS FED ALD PROJECT

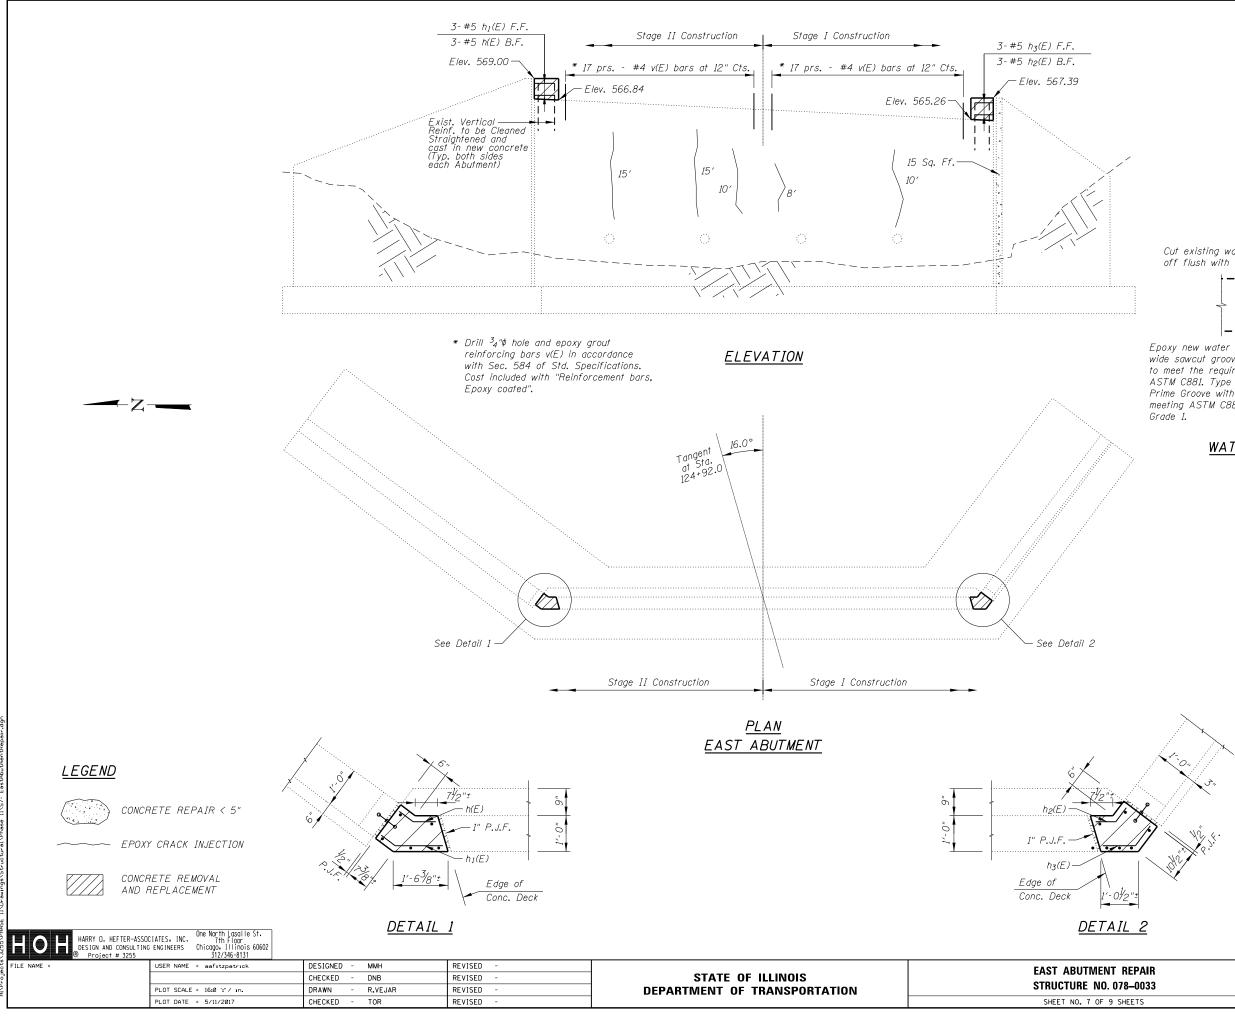

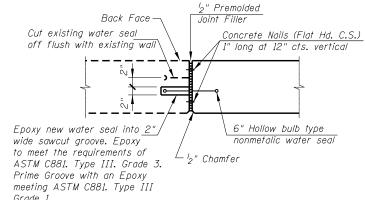


WATER SEAL REPLACEMENT DETAIL

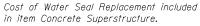


BILL OF MATERIAL-2 ABUTMENTS

Item	Unit	Quantity
Epoxy Crack Injection	Foot	158
Structural Repair of Concrete Depth < 5"	Sq. Ft.	15
Concrete Structures	Cu. Yd.	0.6
Concrete Removal	Cu. Yd.	0.6

NT REPAIR). 078–0033	F.A.P RTE	SECTION	COUNTY	TOTAL SHEETS	SHEET NO.
	653	(105BR-3)I	PUTNAM	39	23
. 070–0035			CONTRACT	NO. 6	8579
9 SHEETS		ILLINOIS FED. AI	D PROJECT		

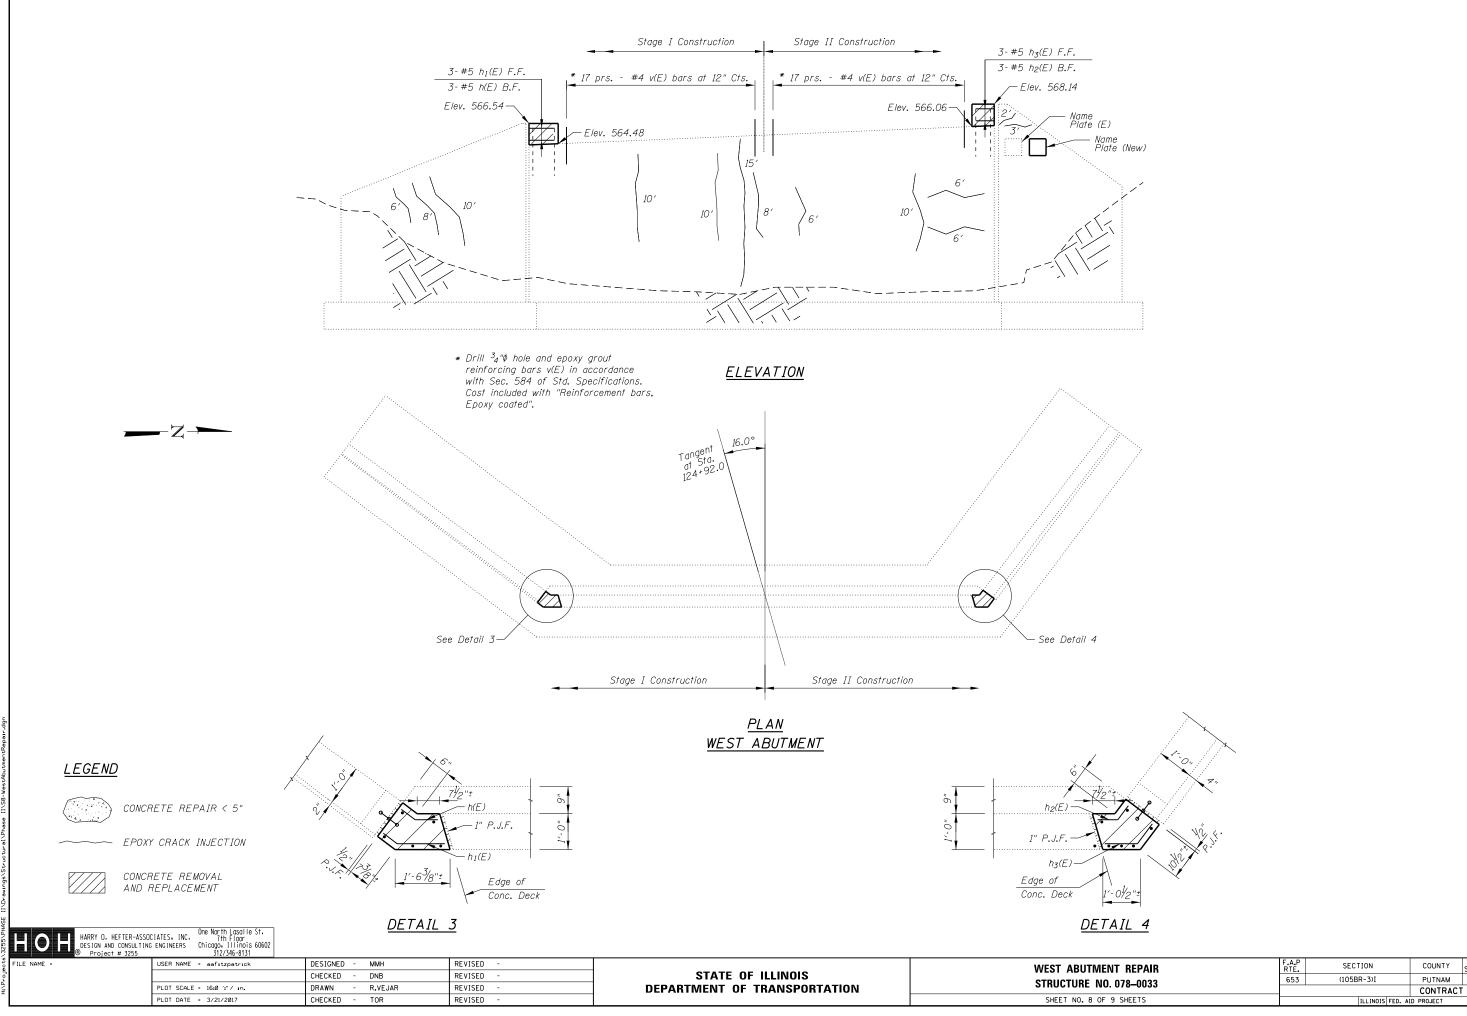

NT REPAIR		SECTION	COUNTY	TOTAL SHEETS	SHEET NO.
. 078–0033	653	(105BR-3)I	PUTNAM	39	24
. 078–0033			CONTRACT	NO. 6	8579
9 SHEETS	ILLINOIS FED. AID PROJECT				

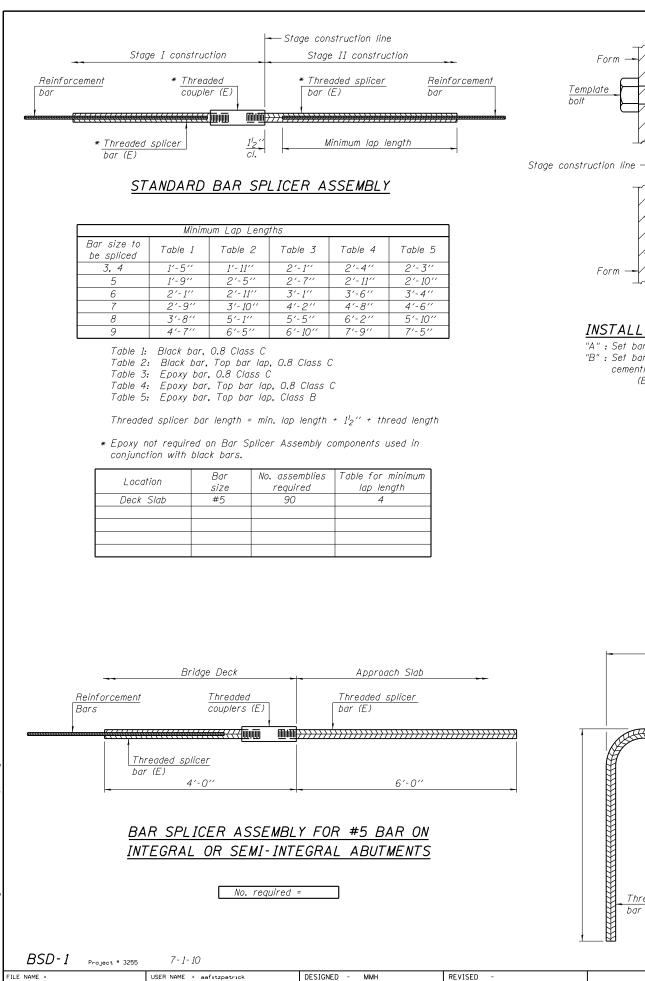

CHECKED

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CHECKED

PLOT SCALE = 0:2 ':' / in.

PLOT DATE = 3/21/2017

DNB


TOR

R.VEJAR

REVISED

REVISED

REVISED

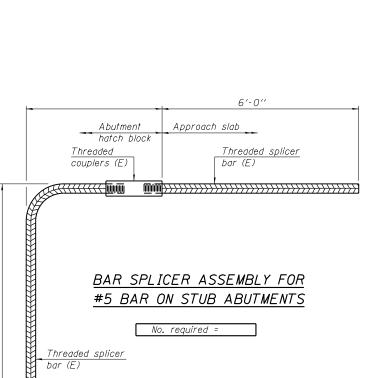

STATE OF ILLINOIS

DEPARTMENT OF TRANSPORTATION

<u>'''B''</u>

INSTALLATION AND SETTING METHODS

Threaded

coupler (E)

<u>"A"</u>

- Positive stop

Threaded coupler (E)

Threaded splicer bar (E)


Threaded splicer

bar (E)

"A" : Set bar splicer assembly by means of a template bolt. "B" : Set bar splicer assembly by nailing to wood forms or cementing to steel forms. (E) : Indicates epoxy coating.

> BAR SPLICER ASSEMBLY AND ME STRUCTURE NO.

> > SHEET NO. 9 OF 9

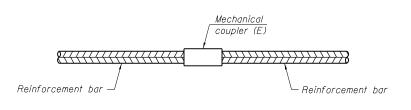

STANDARD MECHANICAL SPLICER


Location	Bar size	No. assemblies required

NOTES

Splicer bars shall be deformed with threaded ends and have a minimum 60 ksi yield strength.

All reinforcement shall be lapped and tied to the splicer bars. Bar splicer assemblies shall be epoxy coated according to the requirements for reinforcement bars. See Section 508 of the Standard Specifications. See special provision for Mechanical Splicers. See approved list of bar splicer assemblies and mechanical splicers for alternatives.

ECHANICAL SPLICER DETAILS	F.A.P RTE	SECTION	COUNTY	TOTAL SHEETS	SHEET NO.
. 078–0033	653	(105BR-3)I	PUTNAM	39	25
. 070–0035			CONTRACT	NO. 6	8579
9 SHEETS		ILLINOIS FED. AI	D PROJECT		

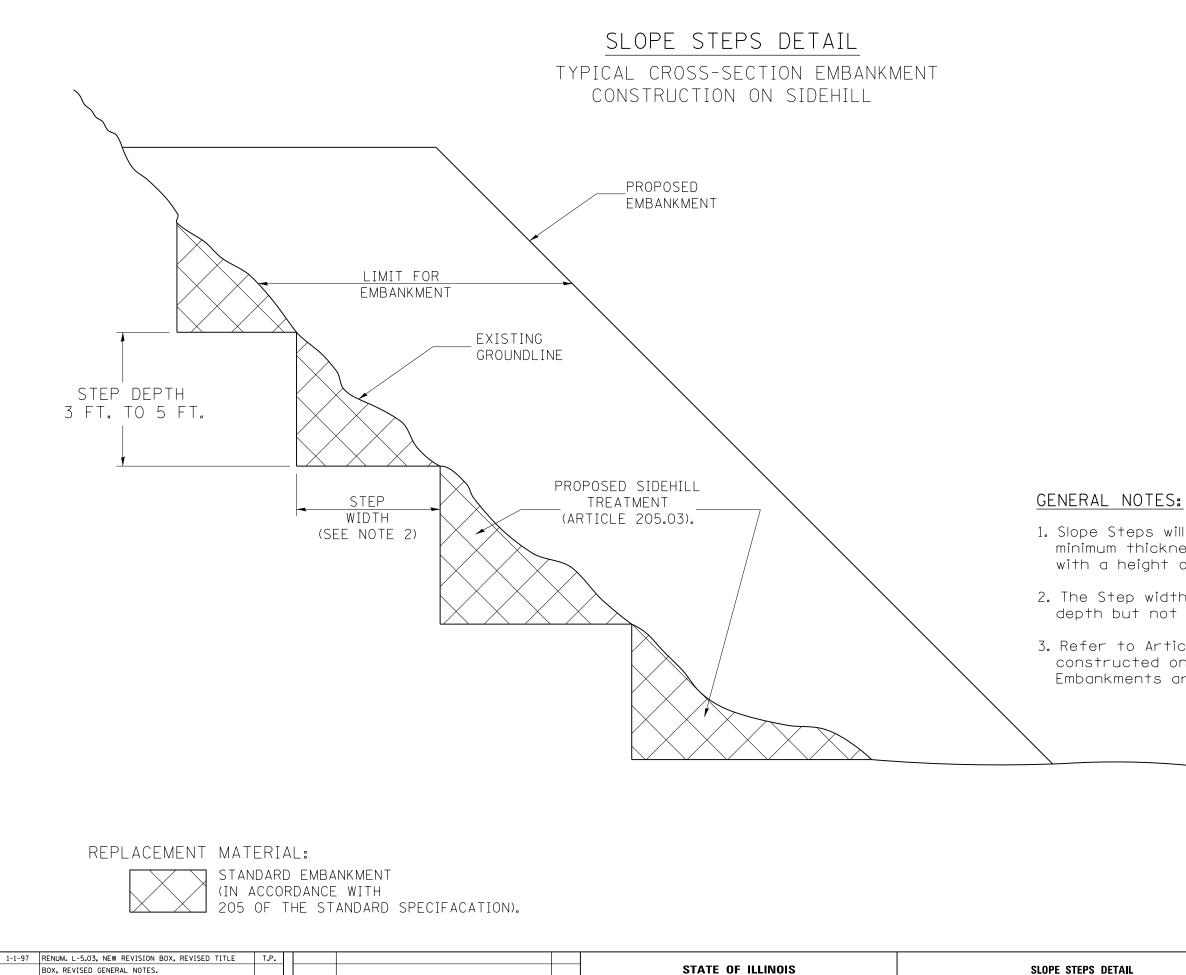

DEPARTMENT OF TRANSPORTATION

NOT TO SCALE

BOX, REVISED GENERAL NOTES.

M.A.


10-16-06 REVISED TO 2007 SPEC.

1. Slope Steps will be required for all 12(300) minimum thickness "sliver fills" and on a fills with a height of 10 feet or greater.

2. The Step width shall be twice the Step depth but not less than 6 feet.

3. Refer to Article 205.03 for Embankment to be constructed on Hillside or Slopes, or if existing Embankments are to be widened.

			F.A.P. RTE.	SECTION	COUNTY	TOTAL SHEETS	SHEET NO.
DETAIL			653	(105BR-3)I	PUTNAM	39	26
					CONTRACT	NO. 6	8579
	CADD STD.	205001-D4	FED. RC	AD DIST. NO. 4 ILLINOIS FED. AI	D PROJECT		

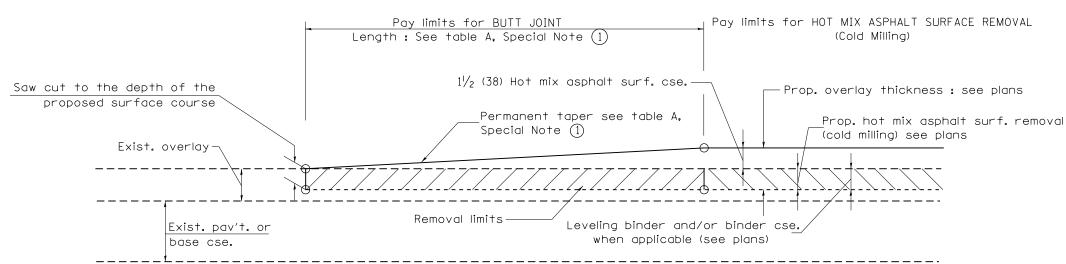


CASE 1 : WITH HOT MIX ASPHALT SURFACE REMOVAL (COLD MILLING)

	I	APER RATES		
SPECIAL NOTE	ELEMENT	MAINLINE INTERSTATES &	ALL	1.
NUMBER		4-LANE EXPRESSWAYS	OTHERS	
	BUTT JOINT	1:480	1:240	2.
	TAPER RATE			
2	TEMPORARY RAMP	1:80	1:40	
_	TAPER RATE			3.

TABLE A TAPER RATES





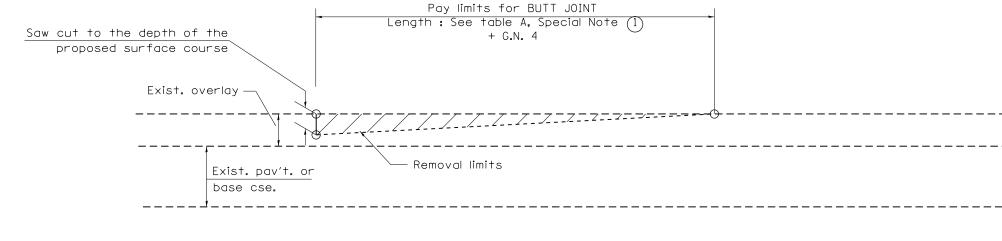

CASE 2 : NO HOT MIX ASPHALT SURFACE REMOVAL (COLD MILLING)

01-	-01-97	RENUM. C-23.01, NEW REVISION BOX	T.P.	08-21-13 MAJOR MODIFICATIONS	R.D.		
04-	-01-97	CORRECTION TO DEPTH	J.A.	02-29-16 MINOR CORRECTIONS	R.D.	STATE OF ILLINOIS	BUTT JOINTS
09-	-15-05	REVISED DESIGNER NOTE	M.M.A.	04-12-16 MINOR CORRECTIONS	R.D.	DEPARTMENT OF TRANSPORTATION	
10-	-16-06	REVISED TO 2007 SPEC.	M.A.				NOT TO SCALE

GENERAL NOTES


1. The work shall be done in accordance with Article 406.08 and the Special Provision for Butt Joints.

2. The pavement surface to be removed may be either bituminous or P.C. concrete. The work shall be performed in accordance with Article 440.04 and the Special Provisions for Butt Joints.


3. The saw cut joints shall be primed just prior to the placing of bituminous material. The work will be in accordance with the applicable portions of Article 406.05.

4. The length of butt joint is based on the taper rate times change in cold miling depth within the butt joint pay limits, unless otherwise indicated.


				F.A. RTE	P		SEC	TION		COUNT	(TOTAL SHEETS	SHEET NO.
NTS				65	3		(1058	3R-3)I		PUTNAM	A	39	27
		SHT								CONTR	ACT	NO. 6	8579
	CADD	STD. 4	106101-D4	FED.	ROAD	DIST. M	10.4	ILLINOIS	FED. AI	D PROJECT			

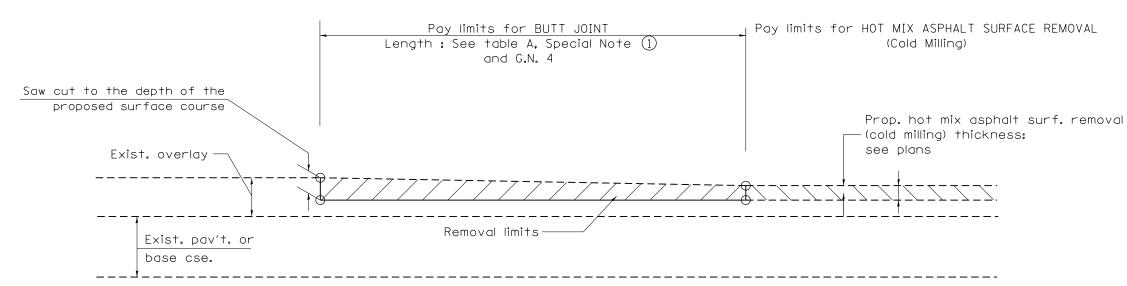

CASE 3 : HOT MIX ASPHALT SURFACE REMOVAL (COLD MILLING) TIE-IN TO EXISTING BITUMINOUS TAPER

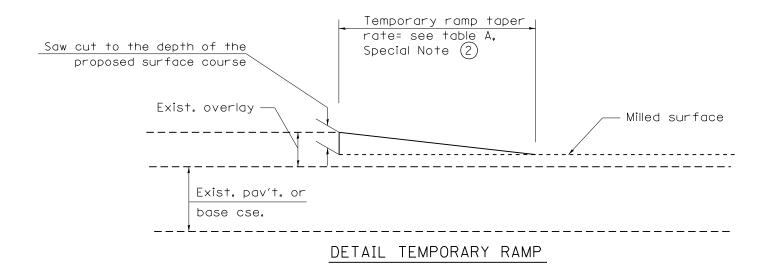


						F.A.P. RTE.	SECTION	COUNTY	TOTAL SHEET SHEETS NO.
		STATE OF ILLINOIS		BUTT JOINTS		653	(105BR-3)I	PUTNAM	39 28
		DEPARTMENT OF TRANSPORTATION			SHT. 2 OF 3			CONTRAC	T NO. 68579
			NOT TO SCALE		CADD STD. 406101-D4	FED. ROAD DIST	T. NO. 4 ILLINOIS FED. 4	AID PROJECT	

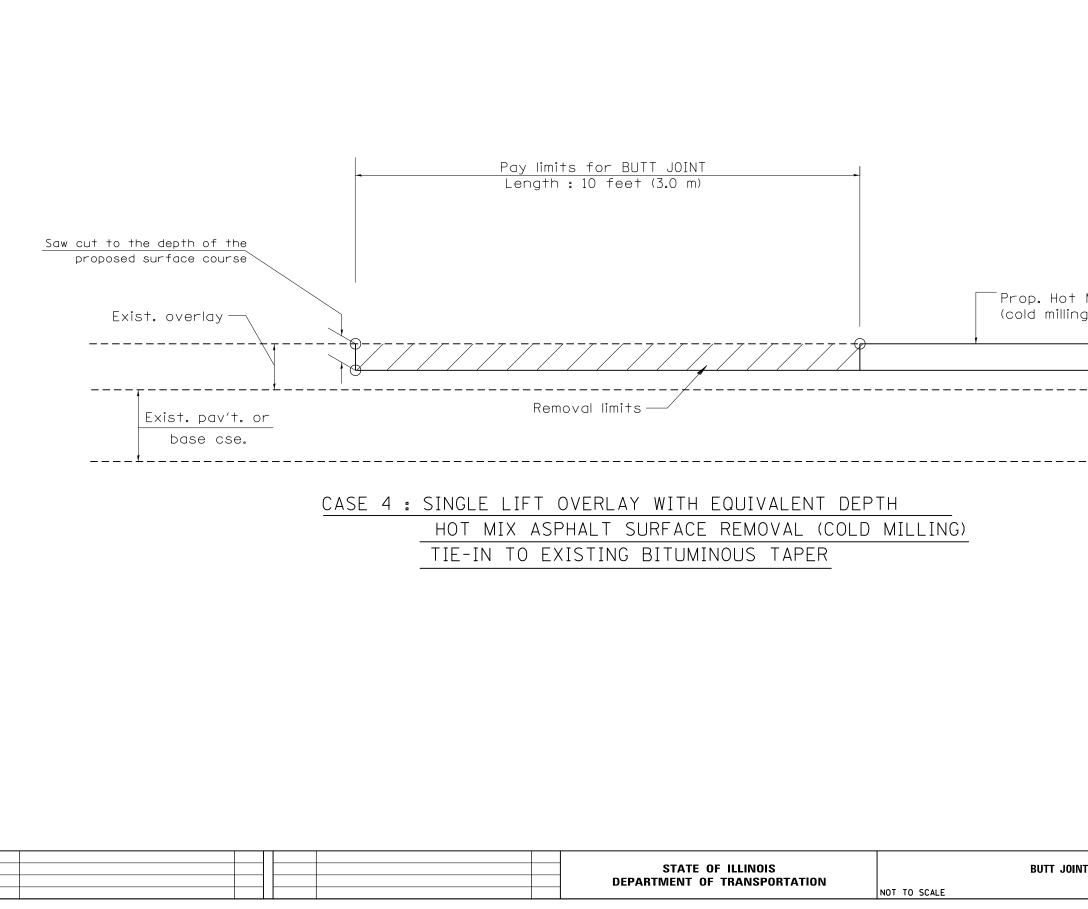


Prop. Hot Mix Asphalt surf. removal (cold milling) per plans.

		F.A.P. RTE.	SECTION	COUNTY	TOTAL SHEETS	SHEET NO.
INTS		653	(105BR-3)I	PUTNAM	39	29
	SHT. 3 OF 3			CONTRACT	NO. 6	8579
	CADD STD. 406101-D4	FED. ROA	D DIST. NO. 4 ILLINOIS FED. A	D PROJECT		

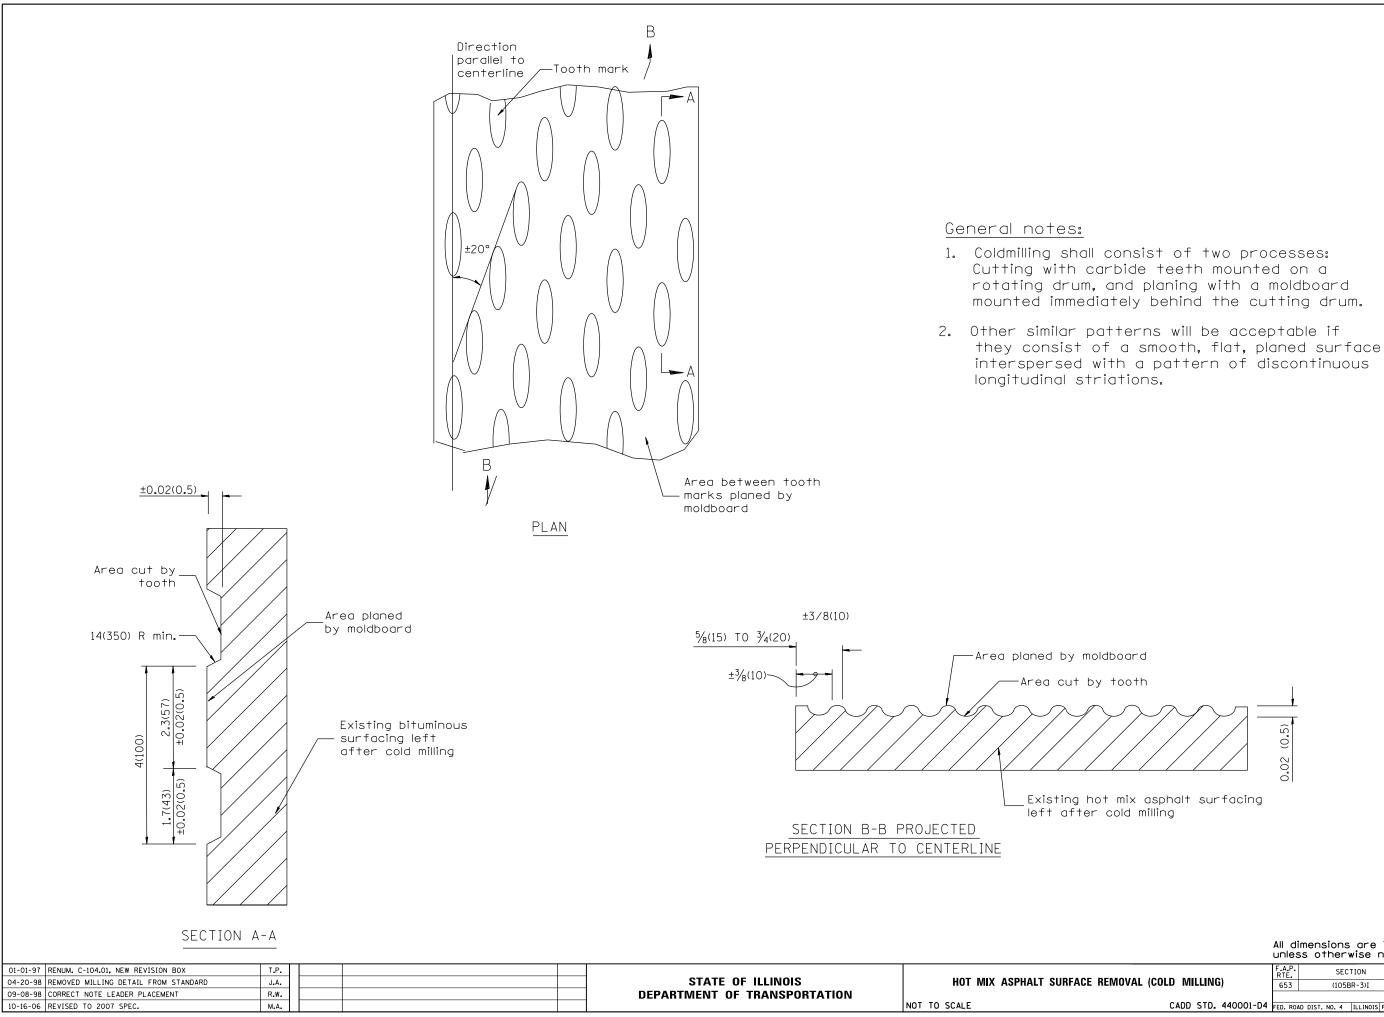


	F.A.P. RTE.	SECTION	COUNTY	TOTAL SHEETS	SHEET NO.
EMOVAL (COLD MILLING)	653	(105BR-3)I	PUTNAM	39	30
			CONTRACT	'NO. 6	8579
CADD STD. 440001-D4	FED. RO	D DIST. NO. 4 ILLINOIS FED. A	D PROJECT		

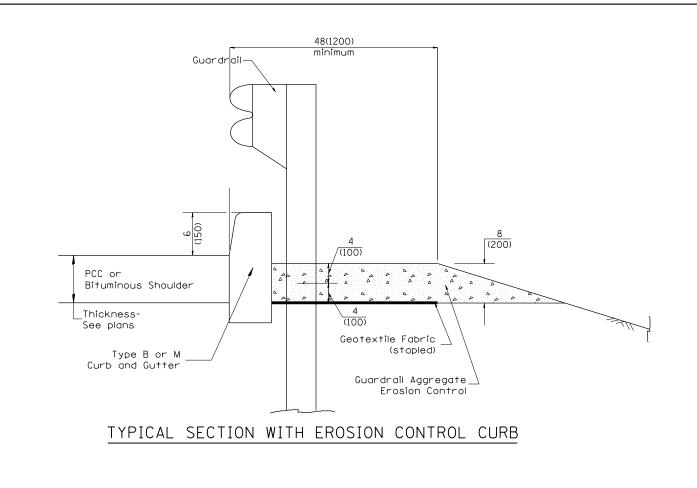

GENERAL NOTES: GUARDRAIL AGGREGATE EROSION CONTROL

- 2. Before placing the aggregate and the Geotextile Fabric, weeds and grass shall be removed from the area to be covered.
- 3. After the area has been prepared, and in a dry condition, the Geotextile fabric shall be placed with a 12(300) minimum overlap. A knife cut for guardrail post installation is necessary.
- 4. The aggregate shall be deposited, compacted and shaped by either mechanical or hand methods, in a manner reasonably true to line and grade.
- 5. The Contractor shall have the option of placing the guardrail before or filled and the aggregate returned to line and grade.
- 6. Materials shall meet the following requirements:
- A. The crushed aggregate shall be CA1 gradation in accordance with Article 1004.01(c) of the Standard Specifications.
- B. The Geotextile Fabric shall be nonwoven fabric in accordance with Article 1080.02 of the Standard Specifications.

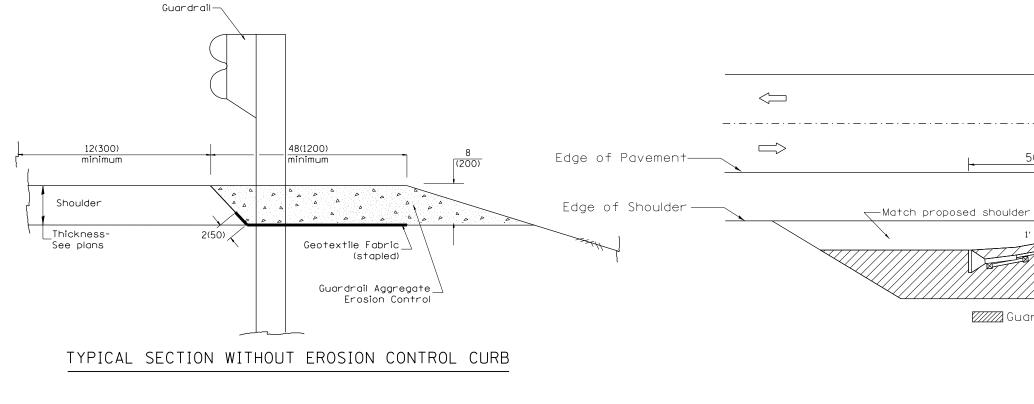

FILE NAME	=		DESIGNED	-	REVISED -								F.A.P. RTE.	SECTION	COUNTY	TOTAL	
H:\Projects	s 3255\PHASE II\Drawings\Civil\C		DRAWN	-	REVISED -	STATE OF ILLINOIS		GUARDR	AIL ERO	SION CON	TROL TREAT	MENTS	653	(105BR-3)I	PUTNAM	39	31
			CHECKED	-	REVISED -	DEPARTMENT OF TRANSPORTATION						SHT. 1 OF 2			CONTRAC	T NO.	õ8579
Default		PLOT DATE = 3/21/2017	DATE	-	REVISED -		NOT TO SCALE	SHEET	OF	SHEETS	S STA.	CADD STD. 630101-D4	FED. ROAD DIS	T. NO. 4 ILLINOIS FED.	AID PROJECT		


1. This work shall consist of grading as needed, furnishing and installing geotextile fabric and staples, and furnishing, placing and shaping crushed aggregate around and behind Steel Plate Beam Guardrail posts in accordance with Plan Details.

after the Geotextile Fabric and Aggregate are in place. If the guardrail is placed after the Geotextile Fabric and Aggregate, then any voids must be


50'-0''	(15.2m)	typ.	.1		


material (HMA or	Aggregate)
(0.3m)	

Guardrail Aggregate Erosion Control

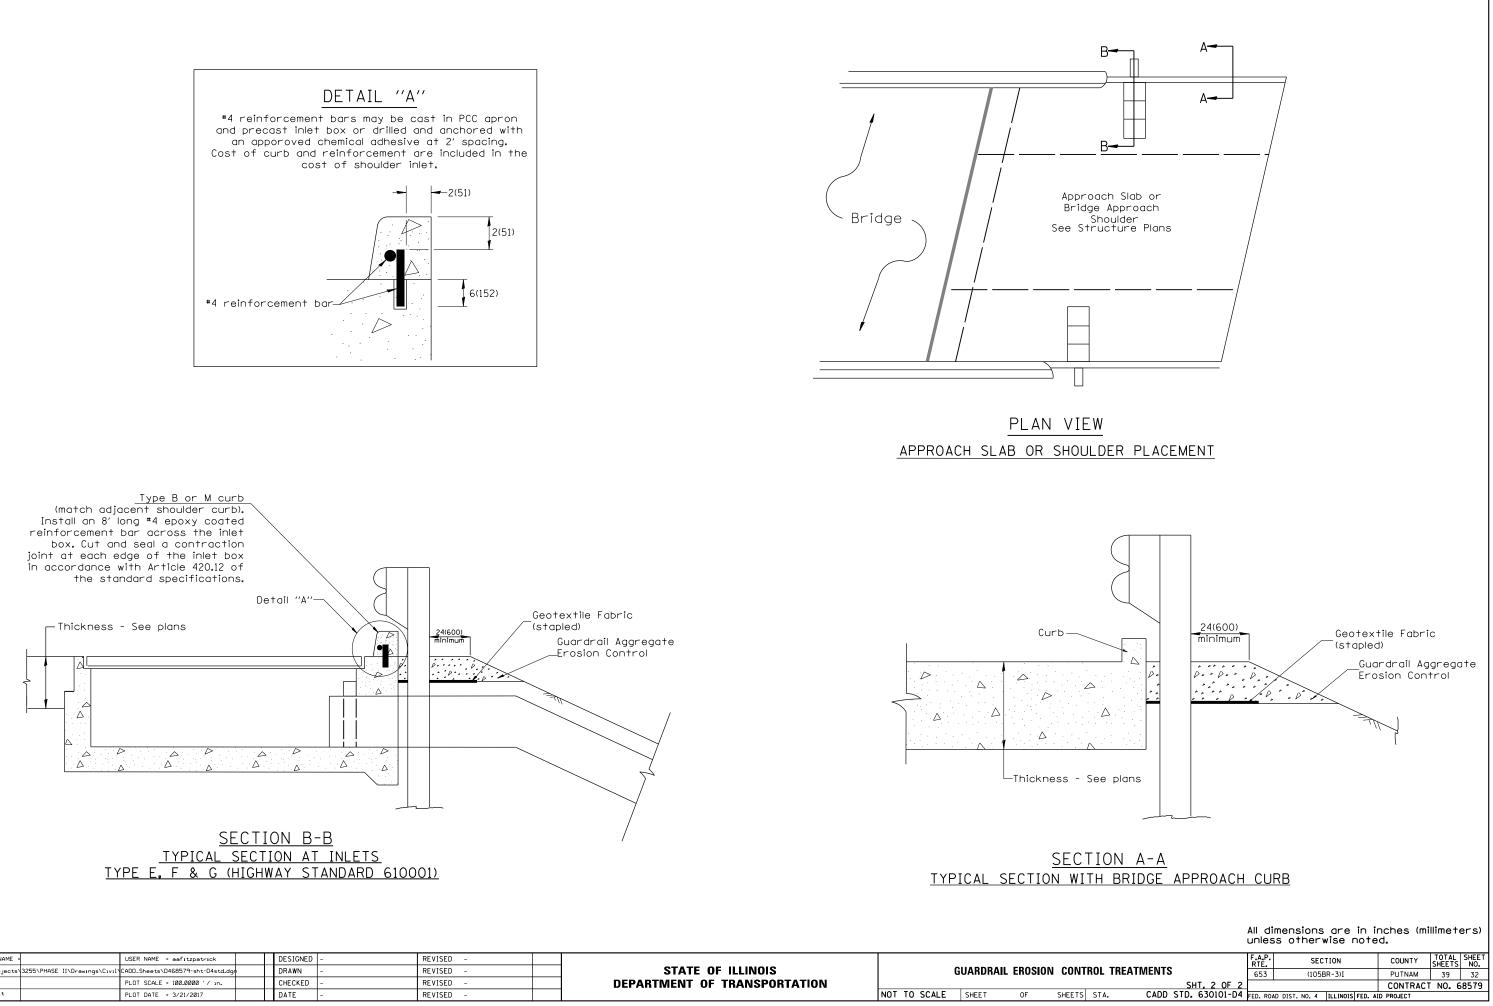

- [FILE NAME =	US	SER NAME = aafıtzpatrıck	DESIGNED	-	REVISED -					
- [H:\Projects\	3255\PHASE II\Drawings\Civil CAD	DD_Sheets\D468579-sht-D4std.dgn	DRAWN	-	REVISED -	STATE OF ILLINOIS	(UARDRAIL	EROSION	N CONTR
- [PL	LOT SCALE = 100.0000 ′ / in.	CHECKED	-	REVISED -	DEPARTMENT OF TRANSPORTATION				
[Default	PL	LOT DATE = 3/21/2017	DATE	-	REVISED -		NOT TO SCALE	SHEET	OF	SHEETS

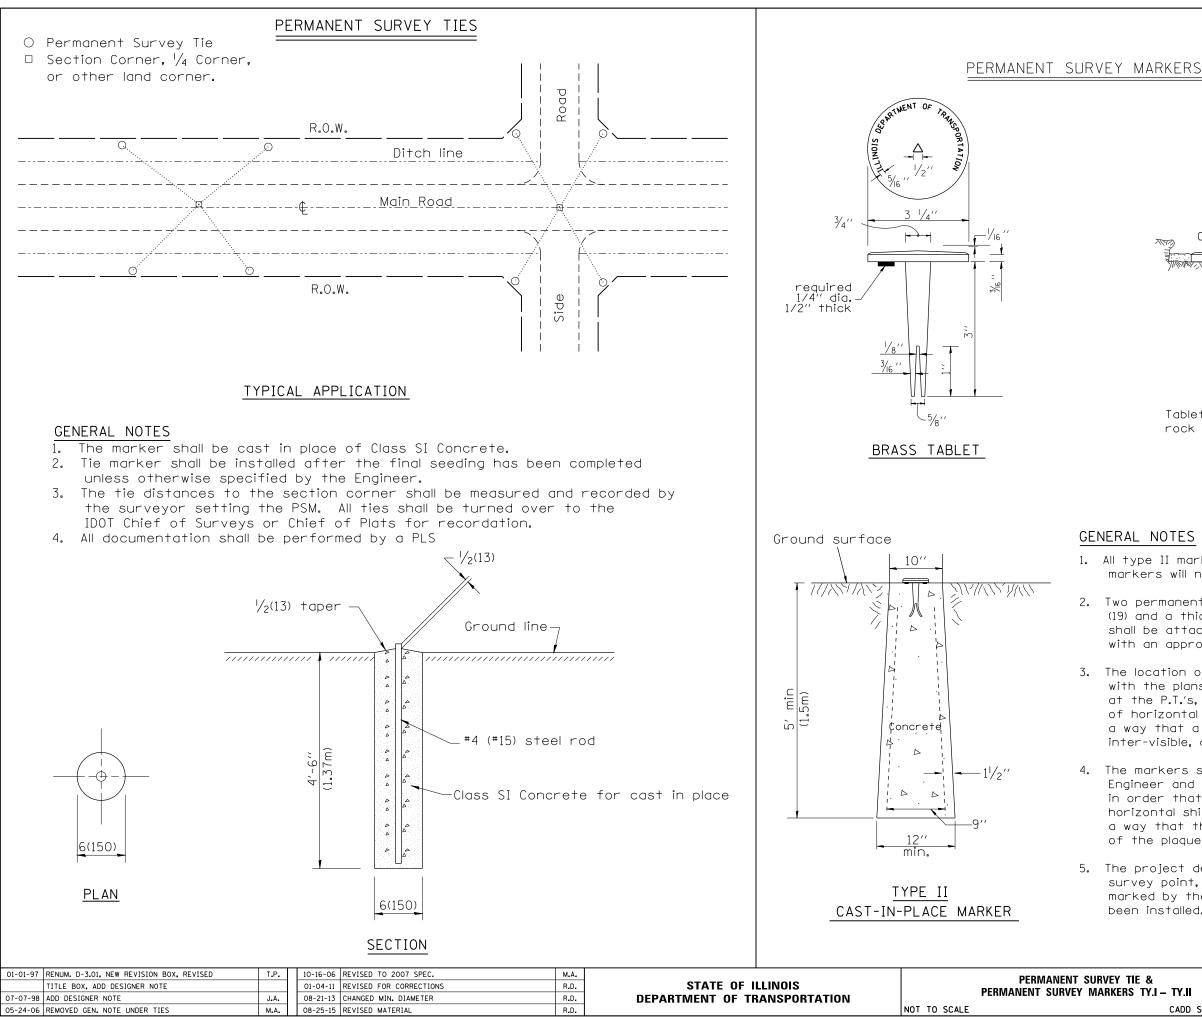

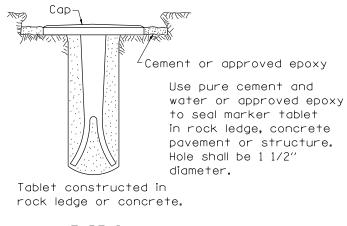

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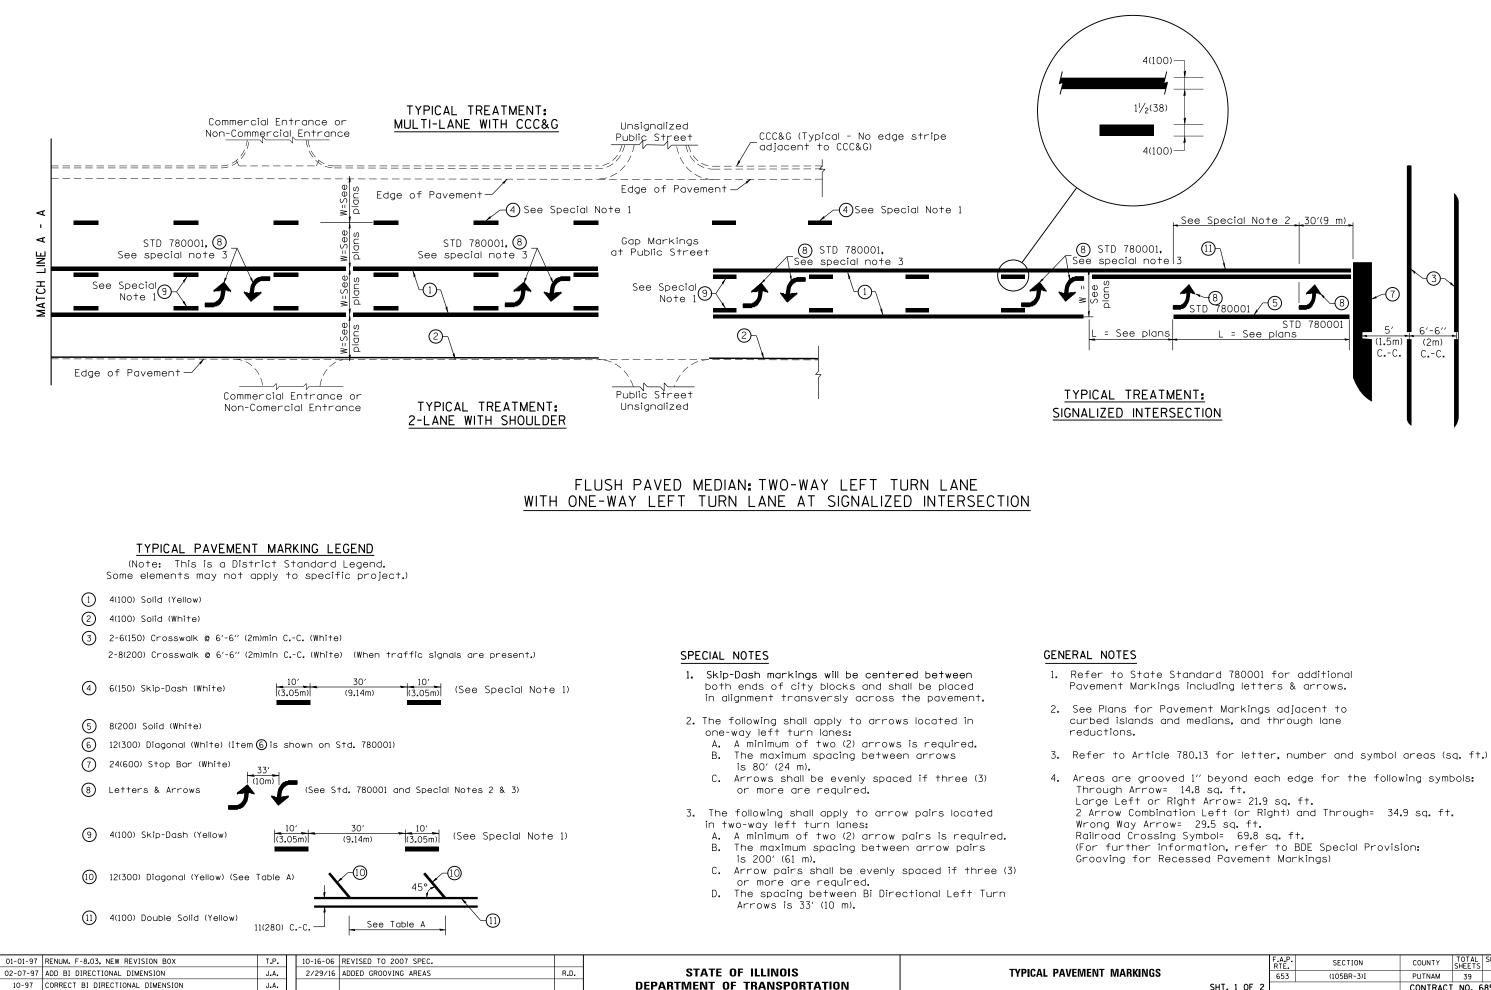
GENERAL NOTES

1. All type II markers shall be cast in place, and precast markers will not be allowed.

- 2. Two permanent magnets, each having a diameter of $\frac{3}{4}$ (19) and a thickness of $\frac{1}{4}$ (6), or equivalent, shall be attached to the underside of the tablet with an approved epoxy bonding agent.
- 3. The location of the markers shall be in accordance with the plans in general, the markers will be placed at the P.T.'s, P.C.'s, and P.I.'s llocated within the R.O.W. of horizontal curves and spaces along the tangents in a way that a minimum of two markers are always inter-visible, and not to exceed 1000' (300m).
- 4. The markers shall be placed under the direction of the Engineer and shall be installed in a workmanlike manner in order that there will be no further settlement or horizontal shifting. The monuments shall be placed in a way that the survey point will fall within the portion of the plaque provided for that purpose.
- 5. The project designation, the centerline station, the survey point, and the elevation shall be permanently marked by the use of metal dies after marker has been installed.

unless otherwise noted.									
VEY TIE &	F.A.P. RTE.	SEC	TION	COUNTY	TOTAL SHEETS	SHEET NO.			
RKERS TY.I – TY.II	653	(105B	R-3)I	PUTNAM	39	33			
				CONTRACT	NO. 6	8579			
CADD STD. 667101-D4	FED. ROA	D DIST. NO. 4	ILLINOIS FED. /	AID PROJECT					

All dimensions are in inches (millimeters)




08-02 ADD CROSSWALK DMNS. WITH T.S.

M.A.

NOT TO SCALE

-				F.A.P. RTE			S	EC	TION		COUN	NTY	TOTAL SHEETS	SHEET NO.
T MARKINGS				653		(105BR-3)I				PUTM	MAN	39	34	
		SHT. 1 OF 2 ADD STD. 780001-D4					CON	TRACT	NO.	68579				
	CADD	STD.	FED. RO	AD	DIST.	NO	4	ILLINOIS	FED. AI	D PROJEC	:T			

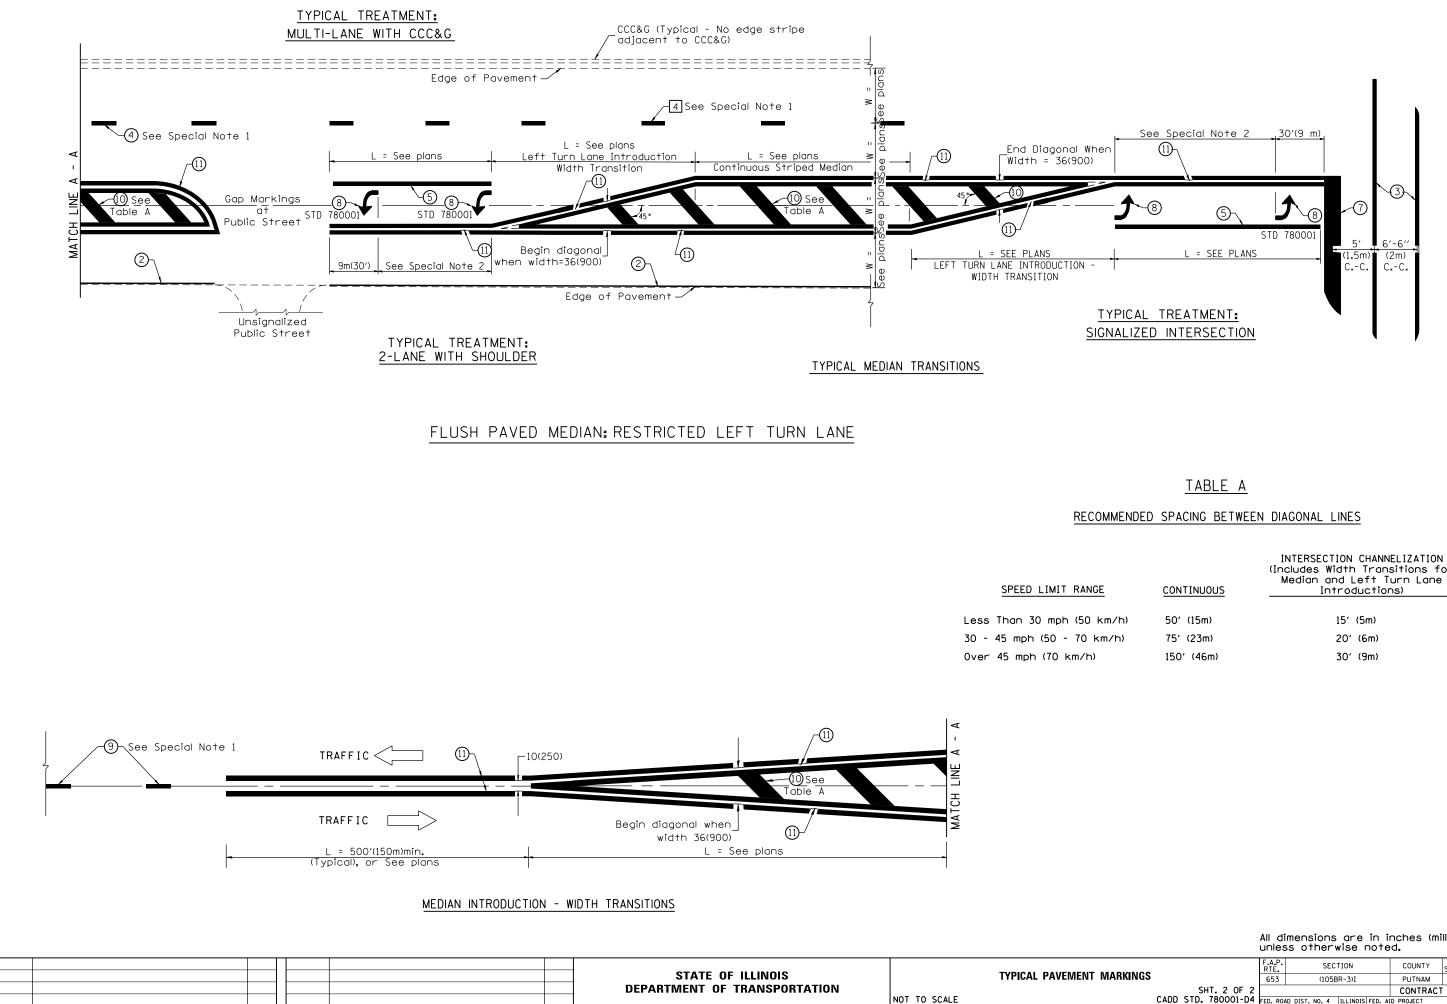

NGE	CONTINUOUS	(Includes Width Transitions for Median and Left Turn Lane Introductions)
) km/h)	50' (15m)	15' (5m)
km/h)	75' (23m)	20' (6m)
h)	150' (46m)	30' (9m)

-				F.A.P. RTE.	SEC	TION	COUNTY	TOTAL SHEETS	SHEET NO.
T MARKINGS	angs			653	(105B	R-3)I	PUTNAM	39	35
		SHT. 2 OF 2					CONTRACT	NO. 6	8579
	CADD	STD.	780001-D4	FED. ROA	D DIST. NO. 4	ILLINOIS FED. AI	D PROJECT		

