STATE OF ILLINOIS
DEPARTMENT OF TRANSPORTATION
DIVISION OF HIGHWAYS

SECTION COUNTY TOTAL SHEE SHEETS NO.

FITZGERRELL PARKING FRANKLIN 49 1


LILINOIS CONTRACT NO. 4693

INDEX OF SHEETS
(SEE SHEET 2)

STATE STANDARDS (SEE SHEET 2)

I.D.O.T./I.D.N.R. STATEWIDE WAYNE FITZGERRELL STATE RECREATION AREA SECTION: FITZGERRELL PARKING

PARK IMPROVEMENTS
FRANKLIN COUNTY
I.D.O.T. PROJECT No. P—XX—00X—XX
I.D.N.R. FILE No. 5—22—011
C—30—003—22

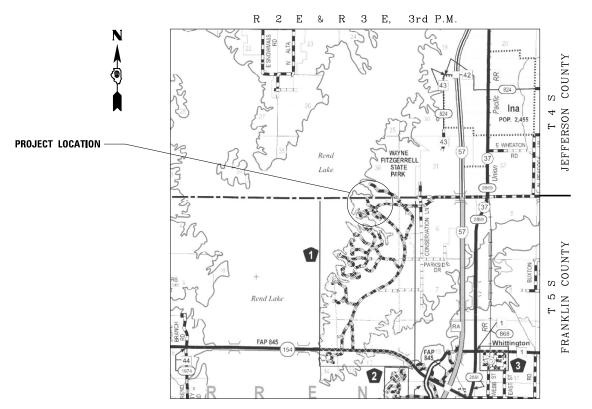

LOCATION MAP



ADAMS

ROCK ISLAND

WHITESIDE

WHITESIDE

WHITESIDE

WHANKER

WHAN

STATE OF ILLINOIS DEPARTMENT OF TRANSPORTATION DIVISION OF HIGHWAYS

 $\textbf{SUBMITTED} \, \underline{\frac{\text{MAY 12, 2023}}{\text{MAY 12, 2023}}}$


DEPUTY DIRECTOR OF HIGHWAYS, REGION ENGINEER

19 12, 2023 San E.A. E.S.

2 2023

DIRECTOR OF HIGHWAYS PROJECT IMPLEMENTATION

PRINTED BY THE AUTHORITY OF THE STATE OF ILLINOIS

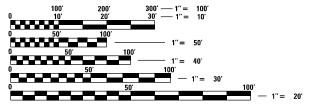

FULL SIZE PLANS HAVE BEEN PREPARED USING STANDARD ENGINEERING SCALES. REDUCED SIZED PLANS WILL NOT CONFORM TO STANDARD SCALES. IN MAKING MEASUREMENTS ON REDUCED PLANS, THE ABOVE SCALES MAY BE USED.

J.U.L.I.E.

 \circ

JOINT UTILITY LOCATING INFORMATION FOR EXCAVATORS 1-800-892-0123

CONTRACT No. 46932

INDEX OF SHEETS

- **COVER SHEET** 1
- 2 INDEX OF SHEETS, GENERAL NOTES AND HIGHWAY STANDARDS
- 3–7 SUMMARY OF QUANTITIES
- SCHEDULE OF QUANTITIES
- 10-13 TYPICAL SECTIONS
- 14 ALIGNMENTS
- 15 **NORTH AREA REMOVAL PLAN**
- 16 **SOUTH AREA REMOVAL PLAN**
- 17 NORTH AREA PAVEMENT MARKING & SIGNING PLAN
- 18 SOUTH AREA PAVEMENT MARKING & SIGNING PLAN
- 19 HORSESHOE BEND PAVEMENT MARKING & SIGNING PLAN
- 20 PLAN & PROFILE - HORSESHOE BEND AT H&CC
- 21 PLAN & PROFILE - CABIN ROAD 1
- 22 PLAN & PROFILE - CABIN ROAD 2
- 23 ADA PARKING PLAN - FLAGSHIP BOATEL
- 24 ADA TRAILER PARKING PLAN - FLAGSHIP BOATEL
- 25 ADA TRAILER PARKING PLAN - ACCESS TO BAY BRIDGE BOAT LAUNCH
- 26 ADA PARKING PLAN - SCHOONER BOATEL
- 27 ADA PARKING PLAN - HOTEL & CONVENTION CENTER
- ADA PARKING PLAN TENNIS COURT & BLUE HERON CAFE AREA 28
- 29 ADA PARKING PLAN - PENINSULA AREA
- 30 ADA PARKING PLAN - HOTEL LOT 1
- 31 ADA PARKING PLAN - CABIN ROAD 1 - SWIMMING POOL AREA
- 32 ADA PARKING PLAN - CABIN ROAD 1 - CABINS A9408 & A9424
- 33 NORTH AREA EROSION CONTROL PLAN
- 34 SOUTH AREA EROSION CONTROL PLAN
- 35 SITE DETAILS
- INDEX OF SHEETS, STANDARDS LIST, AND LIGHTING SUMMARY OF QUANTITIES 36
- 37 LIGHTING PLAN - NORTH AREA
- LIGHTING PLAN SOUTH AREA 38
- 39 LUMINAIRE PERFORMANCE TABLE
- 40 **WIRING DIAGRAMS**
- 41 FLOOD LIGHTING DETAILS
- CROSS SECTIONS HORSESHOE BEND 42-44
- 45-47 CROSS SECTIONS - CABIN ROAD 1
- CROSS SECTIONS CABIN ROAD 2 48-49

GENERAL NOTES

- SPECIFICATIONS SHALL BE THE "STANDARD SPECIFICATIONS FOR ROAD AND BRIDGE CONSTRUCTION" ADOPTED JANUARY 1, 2022,
- 2 ALL ELEVATIONS ARE REFERENCED TO ELEVATIONS ESTABLISHED BY ILLINOIS DEPARTMENT OF TRANSPORTATION.
- 3 THE CONTRACTOR SHALL ASSUME COMPLETE RESPONSIBILITY FOR JOB SITE CONDITIONS DURING THE COURSE OF CONSTRUCTION INCLUDING SAFETY OF ALL PERSONS AND PROPERTY, THAT THIS REQUIREMENT SHALL APPLY CONTINUOUSLY AND NOT BE LIMITED TO NORMAL WORKING HOURS, AND THAT THE CONTRACTOR SHALL DEFEND, IDEMNIFY, AND HOLD THE OWNER AND THE ENGINEER HARMLESS FROM ANY AND ALL LIABILITY, REAL OR ALLEDED, IN CONNECTION WITH THE PERFORMANCE OF WORK ON THIS PROJECT, EXCEPT FOR LIABILITY ARISING FROM THE SOLE NEGLIGENCE OF THE OWNER OR THE ENGINEER.
- 4 WHERE SECTION STONES OR PROPERTY MARKERS ARE ENCOUNTERED, THE ENGINEER SHALL BE NOTIFIED BEFORE SUCH STONES OR MARKERS ARE REMOVED. THE CONTRACTOR SHALL PROTECT AND PRESERVE ALL PROPERTY MARKERS UNTIL AN OWNER OR AUTHORIZED SURVEYOR HAS WITNESSED OR REFERENCED THEIR LOCATION.
- 5 ALL BORROW/WASTE/USE SITES MUST BE APPROVED BY THE DEPARTMENT PRIOR TO REMOVING ANY MATERIAL FROM THE PROJECT OR INITIATING ANY EARTHMOVING ACTIVITIES, INCLUDING TEMPORARY STOCKPILING OUTSIDE THE LIMITS OF CONSTRUCTION.
- 6 EXISTING TOP SOIL EXCAVATED FOR THIS PROJECT MAY BE USED FOR THE PLACEMENT LOCATIONS NOTED ON THE PLANS PROVIDED THAT THE EXCAVATED MATERIALS MEET THE REQUIREMENTS OF ARTICLE 1081,05(a) OF THE STANDARD SPECIFICATIONS.

LOCATIONS	HOT MIX ASPHALT BINDER COURSE
MIXTURE USE(S):	HOT MIX ASPHALT BINDER COURSE, IL-9.5, N50
PG:	PG64-22
DESIGN AIR VOIDS:	4.0%, 50 GYRATION DESIGN
MIXTURE COMPOSITION:	IL-9.5mm
(GRADATION MIXTURE)	it-9.5mm
FRICTION AGGREGATE:	NONE
MIXTURE WEIGHT:	112 LBS/SQ YD/IN
QUALITY MANAGEMENT	00/04
PROGRAM:	QC/QA
SUBLOT SIZE:	3,000 TONS
LOCATIONS	HOT MIX ASPHALT SURFACE COURSE
LOCATIONS MIXTURE USE(S):	HOT MIX ASPHALT SURFACE COURSE HOT MIX ASPHALT SURFACECOURSE, IL-9.5, N50
MIXTURE USE(S):	HOT MIX ASPHALT SURFACECOURSE, IL-9.5, N50
MIXTURE USE(S): PG:	HOT MIX ASPHALT SURFACECOURSE, IL-9.5, N50 PG64-22 4.0%, 50 GYRATION DESIGN
MIXTURE USE(S): PG: DESIGN AIR VOIDS:	HOT MIX ASPHALT SURFACECOURSE, IL-9.5, N50 PG64-22
MIXTURE USE(S): PG: DESIGN AIR VOIDS: MIXTURE COMPOSITION:	HOT MIX ASPHALT SURFACECOURSE, IL-9.5, N50 PG64-22 4.0%, 50 GYRATION DESIGN
MIXTURE USE(S): PG: DESIGN AIR VOIDS: MIXTURE COMPOSITION: (GRADATION MIXTURE)	HOT MIX ASPHALT SURFACECOURSE, IL-9.5, N50 PG64-22 4.0%, 50 GYRATION DESIGN IL-9.5mm
MIXTURE USE(S): PG: DESIGN AIR VOIDS: MIXTURE COMPOSITION: (GRADATION MIXTURE) FRICTION AGGREGATE:	HOT MIX ASPHALT SURFACECOURSE, IL-9.5, N50 PG64-22 4.0%, 50 GYRATION DESIGN IL-9.5mm MIX C 112 LBS/SQ YD/IN
MIXTURE USE(S): PG: DESIGN AIR VOIDS: MIXTURE COMPOSITION: (GRADATION MIXTURE) FRICTION AGGREGATE: MIXTURE WEIGHT:	HOT MIX ASPHALT SURFACECOURSE, IL-9.5, N50 PG64-22 4.0%, 50 GYRATION DESIGN IL-9.5mm MIX C

LEGEND

-0-	-	EXISTING	POWER POLE
\leftarrow	-	EXISTING	GUY WIRE
þ	-	EXISTING	SIGN
0	-	EXISTING	WOOD POST
	-	EXISTING	FENCE POST
	-	EXISTING	MAILBOX
©	-	EXISTING	DECIDUOUS TREE
Ф [.]	-	EXISTING	EVERGREEN TREE
0	-	EXISTING	BUSH
©	-	EXISTING	JUNCTION BOX
	-	EXISTING	ELECTRIC SPLICE BOX
B	-	EXISTING	TELEPHONE SPLICE BOX
0	-	EXISTING	WATER VALVE
0	-	EXISTING	CATCH BASIN
0	-	EXISTING	MANHOLE
⊲	-	EXISTING	END SECTION
	-	EXISTING	PARKING BLOCK
*	-	EXISTING	A.D.A. PARKING SYMBOL
	-	EXISTING	RIPRAP
- x x x x x	-	EXISTING	FENCE LINE
	-	EXISTING	DITCH LINE
	-	EXISTING	GUARD RAIL
825——	-	EXISTING	CONTOURS
······	-	EXISTING	TREE LINE
.11111111111111111111111111111111111111	-	EXISTING	BUILDING LIMITS
	-	EXISTING	CULVERT

IDOT HIGHWAY STANDARDS

000001-08	STANDARD SYMBOLS, ABBREVIATIONS AND PATTERNS	701006-05	OFF-RD OPERATIONS, 2L, 2W, 15' (4.5m) TO 24" (600mm) FROM PAVEMENT EDGE
001006	DECIMAL OF AN INCH AND A FOOT	701201-05	LANE CLOSURE, 2L, 2W, DAY ONLY, FOR SPEEDS 45MPH
280001-07	TEMPORARY EROSION CONTROL SYSTEMS	701901-08	TRAFFIC CONTROL DEVICES
424001-11	PERPENDICULAR CURB RAMPS FOR SIDEWALKS	720001-01	SIGN PANEL MOUNTING DETAILS
424006-05	DIAGONAL CURB RAMPS FOR SIDEWALKS	728001-01	TELESCOPING STEEL SIGN SUPPORT
424011-04	CORNER PARALLEL CURB RAMPS FOR SIDEWALKS	780001-05	TYPICAL PAVEMENT MARKINGS
424016-05	MID-BLOCK CURB RAMPS FOR SIDEWALKS	821101-02	LUMINAIRE WIRING IN POLE
424021-06	DEPRESSED CORNER FOR SIDEWALKS	825021-04	LIGHTING CONTROLLER BASE MOUNTED, 240V
424026-03	ENTRANCE/ALLEY PEDESTRIAN CROSSINGS	830001-03	LIGHT POLE ALUMINUM MAST ARM
542401-04	METAL FLARED END SECTION FOR PIPE CULVERTS	836001-04	LIGHT POLE FOUNDATION
602301-04	INLET, TYPE A	878001-11	CONCRETE FOUNDATION DETAILS
604001-05	FRAME AND LIDS, TYPE 1	B.L.R. 10-8	PCC PAVEMENT SPECIAL (NONREINFORCED)
604051-04	FRAME AND GRATE TYPE 11	B.L.R. 14-13	PORTLAND CEMENT CONCRETE PAVEMENT (NONREINFORCED)
606001-08	CONCRETE CURB TYPE B AND COMBINATION CONCRETE CURB AND GUTTER	720006-04	SIGN PANEL ERECTION DETAILS
420001-10	PAVEMENT JOINTS	805001-01	ELECTRICAL SERVICE INSTALLATION DETAILS

REV. - MS

FILE NAME	USER NAME	DESIGNED - JEB	REVISED -	STATE OF
I S N		DRAWN - JEB	REVISED -	DEPARTMENT OF 1
	PLOT SCALE	CHECKED - RHD	REVISED -	
D	PLOT DATE	DATE - 3/31/23	REVISED -	DEPARTMENT OF NA

OF ILLINOIS TRANSPORTATION IATURAL RESOURCES

INDEX OF	SHEETS, G	ENERAL	NOTES A	F.A. RTE.	SECTION	COUNTY	TOTAL SHEETS	SHEET NO.		
w	AYNE FIT	7CERREI	I STATE		FITZGERRELL PARKING	FRANKLIN	49	2		
VV	TINE III	LULIIILL	L SIAIL			CONTRACT	NO. 4	16932		
SCALE: SHEET OF SHEETS STA. TO STA.							TILINOIS EED AT	D PPO IECT		

				CONSTR.
				ROADWA
CODE			TOTAL	0004
NO.	ITEM	UNIT	QUANTITY	RURAL
20100110	TREE REMOVAL (6 TO 15 UNITS DIAMETER)	UNIT	18	18
21400100	GRADING AND SHAPING DITCHES	FOOT	225	225
28000400	PERIMETER EROSION BARRIER	FOOT	479	479
28000510	INLET FILTERS	EACH	11	11
28000510	INLET FILTERS	EACH	11	11
31100300	SUBBASE GRANULAR MATERIAL, TYPE A 4"	SQ YD	791	791
35100700	AGGREGATE BASE COURSE, TYPE A 8"	SQ YD	5872	5872
40600275	BITUMINOUS MATERIALS (PRIME COAT)	POUND	12531	12531
40000273	BIT OPINOUS PIAT ERIALS (PRIPE COAT)	FOUND	12331	12331
40600290	BITUMINOUS MATERIALS (TACK COAT)	POUND	11005	11005
40600982	HOT-MIX ASPHALT SURFACE REMOVAL - BUTT JOINT	SQ YD	114	114
40602978	HOT-MIX ASPHALT BINDER COURSE, IL- 9.5, N50	TON	624	624
40604050	HOT-MIX ASPHALT SURFACE COURSE, IL-9.5, MIX "C", N50	TON	2289	2289
42000300	PORTLAND CEMENT CONCRETE PAVEMENT 8"	SQ YD	287	287
42400200	PORTLAND CEMENT CONCRETE SIDEWALK 5 INCH	SQ FT	4131	4131
44000151	HOT-MIX ASPHALT SURFACE REMOVAL, 1/2"	SQ YD	2217	2217

WODEL: Detault FILE NAME: Z:\0 V and K Jobs\5371-041 Rend Lake Resor

USER NAME = skuper	DESIGNED	-	J.E.B.	REVISED -	
	DRAWN	-	S.D.K.	REVISED -	
PLOT SCALE = 40.0000 / in	CHECKED	-	R.H.D.	REVISED -	
PLOT DATE = 4/16/2023	DATE	-	4/14/23	REVISED -	

STATE OF ILLINOIS DEPARTMENT OF TRANSPORTATION DEPARTMENT OF NATURAL RESOURCES

011111111111111111111111111111111111111			F.A. RTE.	SECT	ION		COUNTY	TOTAL SHEETS	SHEET NO.
SUMMARY OF QUANT			FITZGERRELI	_ PARKI	NG	FRANKLIN	49	3	
							CONTRACT	NO. 46	5932
SHEET 1 OF 5 SHEETS STA	. TO	STA.			ILLINOIS	EED AL	D PROJECT		

CODE			TOTAL	ROADWAY
NO.	ITEM	UNIT	QUANTITY	RURAL
44000154	HOT-MIX ASPHALT SURFACE REMOVAL, 1 1/4"	SQ YD	16852	16852
44000300	CURB REMOVAL	FOOT	527	527
44000500	COMBINATION CURB AND GUTTER REMOVAL	FOOT	126	126
44000600	SIDEWALK REMOVAL	SQ FT	3677	3677
45100200	CRACK FILLING	POUND	6054	6054
50105220	PIPE CULVERT REMOVAL	FOOT	16	16
542C0217	PIPE CULVERTS, CLASS C, TYPE 1 12"	FOOT	17	17
54262712	METAL FLARED END SECTIONS 12"	EACH	4	4
55100500	STORM SEWER REMOVAL 12"	FOOT	12	12
59300100	CONTROLLED LOW-STRENGTH MATERIAL	CU YD	3	3
60236800	INLETS, TYPE A, TYPE 11 FRAME AND GRATE	EACH	2	2
60500060	REMOVING INLETS	EACH	2	2
60600605	CONCRETE CURB, TYPE B	FOOT	711	711
60603800	COMBINATION CONCRETE CURB AND GUTTER, TYPE B-6.12	FOOT	126	126

Z:\0 V and K Jobs\5371-041 Rend Lake Resort - Survey & Design\CADD

USER NAME = skuper	DESIGNED -	-	J.E.B.	REVISED -
	DRAWN -	-	S.D.K.	REVISED -
PLOT SCALE = 40.0000 / in.	CHECKED -	-	R.H.D.	REVISED -
PLOT DATE = 4/16/2023	DATE -	-	4/14/23	REVISED -

STATE OF ILLINOIS
DEPARTMENT OF TRANSPORTATION

SCALE:

CHANAADY OF CHANTITIES							F.A. RTE	RTE. SECTION COUNT		COUNTY	TOTAL SHEETS	SHEET NO.
SUMMARY OF QUANTITIES							FRANKLIN			49	4	
										CONTRACT	NO. 46	932
SHEET 2 OF 5 SHEETS STA. TO STA.						ILU	INOIS FED. A	D PROJECT				

					CONSTR. CODE
	CODE			TOTAL	ROADWAY 0004
	NO.	ITEM	UNIT	QUANTITY	RURAL
	NO.	1 1 EM	UNIT	QUANTITI	RURAL
	60626500	TRANSITIONAL COMBINATION CONCRETE CURB AND GUTTER	FOOT	23	23
	67000500	ENGINEER'S FIELD OFFICE, TYPE B	CAL MO	5	5
	67100100	MOBILIZATION	L SUM	1	1
*	72000100	SIGN PANEL - TYPE 1	SQ FT	66	66
*	72800100	TELESCOPING STEEL SIGN SUPPORT	FOOT	408	408
*	78000100	THERMOPLASTIC PAVEMENT MARKING - LETTERS AND SYMBOLS	SQ FT	115	115
_					
*	78000200	THERMOPLASTIC PAVEMENT MARKING - LINE 4"	FOOT	10802	10802
*	78000400	THERMOPLASTIC PAVEMENT MARKING - LINE 6"	FOOT	4823	4823
	7 0000 100		1001	1023	1023
	78300201	PAVEMENT MARKING REMOVAL - GRINDING	SQ FT	1358	1358
*	80400100	ELECTRIC SERVICE INSTALLATION	EACH	2	2
*	81028370	UNDERGROUND CONDUIT, PVC, 3" DIA.	FOOT	1565	1565
		UNIT DUCT, 600V, 2-1C NO.6, 1/C NO.6 GROUND, (XLP-TYPE USE), 1 1/4" DIA.			
*	81603037	POLYETHYLENE	FOOT	11305	11305
*	82110006	LUMINAIRE, LED, ROADWAY, OUTPUT DESIGNATION F	EACH	127	127
*	82500370	LIGHTING CONTROLLER, BASE MOUNTED, 240VOLT, 200AMP	EACH	2	2

* SPECIALTY ITEM

USER NAME = skuper	DESIGNED -	J.E.B.	REVISED -	07477 0F H 1 1 1 1 1 1 1 1 1 1 1 1 1 1 1 1 1 1						F.A. RTE	SECTION	COUNTY	TOTAL SH SHEETS	HEE NO
	DRAWN -	S.D.K.	REVISED -	STATE OF ILLINOIS			SUMMARY	OF QUANTITIES			FITZGERRELL PARKING	FRANKLIN	49	5
PLOT SCALE = 40.0000 / in.	CHECKED -	R.H.D.	REVISED -	DEPARTMENT OF TRANSPORTATION								CONTRAC	Γ NO. 4693	32
PLOT DATE = 4/16/2023	DATE -	4/14/23	REVISED -		SCALE:	SHEET 3	3 OF 5	SHEETS STA.	TO STA.		ILLINOIS FED. A	ID PROJECT		

					CONSTR. CODE
					ROADWAY
	CODE			TOTAL	0004
	NO.	ITEM	UNIT	QUANTITY	RURAL
*	83600200	LIGHT POLE FOUNDATION, 24" DIAMETER	FOOT	465	465
	84200600	REMOVAL OF LIGHTING UNIT, NO SALVAGE	EACH	92	92
	84200804	REMOVAL OF POLE FOUNDATION	EACH	92	92
	84500110	REMOVAL OF LIGHTING CONTROLLER	EACH	1	1
	84500120	REMOVAL OF ELECTRIC SERVICE INSTALLATION	EACH	1	1
	84500130	REMOVAL OF LIGHTING CONTROLLER FOUNDATION	EACH	1	1
	X0301430	PRECAST CONCRETE PARKING BLOCK	EACH	4	4
	X0327308	PARKING LOT SEAL COAT	GALLON	3560	3560
*	X8302393	LIGHT POLE, ALUMINUM 25 FT M.H., 4 FT. ARM (SPECIAL)	EACH	63	63
*	X8302395	LIGHT POLE, ALUMINUM 25 FT M.H., 4 FT. ARM,TWIN (SPECIAL)	EACH	32	32
	X2110104	TOPSOIL FURNISH AND PLACE, 4" (SPECIAL)	SQ YD	1000	1000
	X2140100	GRADING AND SHAPING DITCHES (SPECIAL)	FOOT	60	60
	X4404400	PAVEMENT REMOVAL (SPECIAL)	SQ YD	5283	5283
	X6026800	INLETS TO BE RECONSTRUCTED (SPECIAL)	EACH	1	1

* SPECIALTY ITEM

REV. - MS

USER NAME = skuper	DESIGNED -	J.E.B.	REVISED -	07477 07 11 11 11 11 11			F.A. RTE.	SECTION	COUNTY	TOTAL	S SHE	Ē).
	DRAWN -	S.D.K.	REVISED -	STATE OF ILLINOIS		SUMMARY OF QUANTITIES		FITZGERRELL PARKING	FRANKLIN	49	6	
PLOT SCALE = 40.0000 ' / in	CHECKED -	R.H.D.	REVISED -	DEPARTMENT OF TRANSPORTATION					CONTRAC	T NO. 4	16937	
PLOT DATE = 4/16/2023	DATE -	4/14/23	REVISED -		SCALE:	SHEET 4 OF 5 SHEETS STA. TO STA.		ILLINOIS FED. A	ID PROJECT			_

					CONSTR. CODE
					ROADWAY
	CODE			TOTAL	0004
	NO.	ITEM	UNIT	QUANTITY	RURAL
	X7010216	TRAFFIC CONTROL AND PROTECTION, (SPECIAL)	L SUM	1	1
*	X8200002	FLOOD LIGHTING UNIT	EACH	5	5
*	X8360110	LIGHT POLE FOUNDATION, SPECIAL	FOOT	16	16
	Z0004002	BOLLARDS	EACH	6	6
	Z0010605	CLEANING DRAINAGE SYSTEM	L SUM	1	1
	Z0013798	CONSTRUCTION LAYOUT	L SUM	1	1
	V1.400E10		EAGL:	10	40
	X1400519	REMOVE AND REATTACH EX RECEPTACLE OUTLET APPARATUS ONTO LIGHT POLE	EACH	13	13

★ SPECIALTY ITEM

REV. - MS

USER NAME = skuper	DESIGNED - J.E.B.	REVISED -					F.A.	SECTION	COUNTY	TOTAL SHE SHEETS NO	ĒΤ
	DRAWN - S.D.K.	REVISED -	STATE OF ILLINOIS		SUMMARY OF QU	ANT iti es	IXI'E.	FITZGERRELL PARKING	FRANKLIN	49 7	-
PLOT SCALE = 40.0000 / in	CHECKED - R.H.D.	REVISED -	DEPARTMENT OF TRANSPORTATION						CONTRACT	NO. 46937	. – 1
PLOT DATE = 4/16/2023	DATE - 4/14/23	REVISED -		SCALE:	SHEET 5 OF 5 SHEETS	STA. TO STA.		ILLINOIS FED. A	ID PROJECT		_

MAIN PARK ROAD	STA. 158+00.00		SUB GRAN	AGG BSE CSE	BIT MATLS	BIT MATLS	HMA BC	HMA SURF CSE,	PCC PAV'T	PC CONCRETE	CRACK	CONC CURB	COMB CC&G	TRANSITIONAL	PREC CONC	
145+50.00 158 158+00.00 166 166+86.42 170 167+75.50 LT 167 167+83.36 RT 167 169+76.02 LT 170 170+16.58 178 167+78.24 LT 167 167+86.05 RT 167 WINDY LANE 0+30.00 17 6+69.70 LT 9+ 10.65.76 RT 10 10+82.78 LT 10 HOTEL BOULEVARD 50+11.52 56 HORSESHOE BEND 60 60+22.52 RT 62 60+82.16 RT 62 WINDOWS WAY 70+09.50 71 71+89.20 73 73.30.20 74 73+16.62 LT 73 RESTAURANT SERVICE DR LAKESIDE DRIVE 80+30.00 83 81+25.93 RT 81 100+25.00 102 102+39.62 103 103+41.81 108 102+27.68 RT 102 103+46.81 RT 103 104+94.11 RT 104 104+96.83 LT 106 105+97.62 LT 106 107+44.41 LT 107 CABIN ROAD 2 200+25.00 206 HOTEL LOT 1 300+11.50 302 HOTEL LOT 2 400+11.70 402 400+12.02 LT 400 400+67.30 LT 400 HOTEL LOT 3 500+12.30 502		LT, STA. RT		TY A 8" (SQ YD) 35100700	(PRIME COAT) (POUND) 40600275	(TACK COAT) (POUND) 40600290	IL-9.5 N50 (TON) 40602978	IL-9.5, MIX "C", N50 (TON) 40604050	8" (SQ YD) 42000300	SIDEWALK 5" (SQ FT) 42400200	FILLING (POUND) 45100200	TYPE B (FOOT) 60600605	TB-6.12 (FOOT) 60603800	COMB CC&G (FOOT) 60626500	PARK BLOCK (EACH) X0301430	PARKING LO SEAL COAT (GALLON) X0327308
158+00.00																
166+86.42		3+00.00									1192					701
167+75.50 LT 167 167+83.36 RT 167 169+76.02 LT 170 170+16.58 178 167+78.24 LT 167 167+86.05 RT 167 WINDY LANE 0+30.00 17 6+69.70 LT 64 9+12.45 LT 9+ 10.65.76 RT 10 10+82.78 LT 10 HOTEL BOULEVARD 50+11.52 56 HORSESHOE BEND 60+11.77 62 59+93.10 LT 63 60+22.52 RT 62 60+82.16 RT 62 WINDOWS WAY 70+09.50 71 71+89.20 73 73.30.20 74 73+16.62 LT 73 RESTAURANT SERVICE DR LAKESIDE DRIVE 80+30.00 83 81+25.93 RT 81 CABIN ROAD 1 100+25.00 102 102+39.62 103 103+41.81 108 102+27.68 RT 102 103+41.81 108 102+27.68 RT 103 104+94.11 RT 104 104+96.83 LT 105 105+97.62 LT 106 107+44.41 LT 107 CABIN ROAD 2 200+25.00 206 HOTEL LOT 1 300+11.50 302 HOTEL LOT 2 400+11.70 402 400+12.02 LT 400 HOTEL LOT 3 500+12.30 502	166+86.42	5+86.42									738					434
167+83.36 RT 167 169+76.02 LT 170 170+16.58 178 167+78.24 LT 167 167+86.05 RT 167 WINDY LANE 0+30.00 17 6+69.70 LT 6+ 9+12.45 LT 9+ 10.65.76 RT 10 10+82.78 LT 10 HOTEL BOULEVARD 50+11.52 56 HORSESHOE BEND 60+11.77 62 59+93.10 LT 63 60+22.52 RT 62 60+82.16 RT 62 WINDOWS WAY 70+09.50 71 71+89.20 73 73.30.20 74 73+16.62 LT 73 RESTAURANT SERVICE DR LAKESIDE DRIVE 80+30.00 83 81+25.93 RT 81 CABIN ROAD 1 100+25.00 102 102+39.62 103 103+41.81 108 102+27.68 RT 103 104+94.11 RT 104 104+96.83 LT 105 105+97.62 LT 106 107+44.41 LT 107 CABIN ROAD 2 200+25.00 206 HOTEL LOT 1 300+11.50 302 HOTEL LOT 2 400+11.70 402 400+12.02 LT 400 HOTEL LOT 3 500+12.30 502	170+16.58)+16.58				587		110								
169+76.02 LT 170 170+16.58 178 167+78.24 LT 167 167+86.05 RT 167 WINDY LANE 0+30.00 177 6+69.70 LT 6+ 9+12.45 LT 9+ 10.65.76 RT 10 10+82.78 LT 10 HOTEL BOULEVARD 50+11.52 56 HORSESHOE BEND 60+11.77 62 59+93.10 LT 63 60+22.52 RT 62 60+82.16 RT 62 WINDOWS WAY 70+09.50 71 71+89.20 73 30.20 74 73+16.62 LT 73 RESTAURANT SERVICE DR LAKESIDE DRIVE 80+30.00 83 81+25.93 RT 81 CABIN ROAD 1 100+25.00 102 102+39.62 103 103+41.81 108 102+27.68 RT 102 103+42.371 RT 103 104+94.11 RT 104 104+96.83 LT 105 105+97.62 LT 106 107+44.41 LT 107 CABIN ROAD 2 200+25.00 206 HOTEL LOT 1 300+11.50 302 HOTEL LOT 2 400+11.70 402 400+67.30 LT 400 HOTEL LOT 3 500+12.30 502 HOTEL LOT 3 HOTEL LOT 3 500+12.30 502 HOTEL LOT 2 400+11.70 402 400+67.30 LT 400 HOTEL LOT 3 500+12.30 502	167+95.65	7+95.65 LT	•									20				
170+16.58	167+96.63	7+96.63 RT										16				
167+78.24 LT 167 167+86.05 RT 167 WINDY LANE 0+30.00 LT 6+ 9+12.45 LT 9+ 10.65.76 RT 10 HOTEL BOULEVARD 50+11.52 56 HORSESHOE BEND 60+11.77 62 59+93.10 LT 63 60+22.52 RT 62 60+82.16 RT 62 WINDOWS WAY 70+09.50 71 71+89.20 73 330.20 74 73+16.62 LT 73 RESTAURANT SERVICE DR LAKESIDE DRIVE 80+30.00 83 81+25.93 RT 81 CABIN ROAD 1 100+25.00 102 102+39.62 103 103+41.81 108 102+27.68 RT 102 103+46.81 RT 103 104+94.11 RT 104 104+96.83 LT 105 105+97.62 LT 106 107+44.41 LT 107 CABIN ROAD 2 200+25.00 206 HOTEL LOT 1 300+11.50 302 HOTEL LOT 2 400+11.70 402 400+12.02 LT 400 HOTEL LOT 3 500+12.30 502 HOTEL LOT 3 500+12.30 LT 400 HOTEL LOT 3	170+09.38)+09.38 LT	9											23		
167+86.05 RT 167 WINDY LANE 0+30.00 17 6+69.70 LT 64 9+12.45 LT 9+ 10.65.76 RT 10 10+82.78 LT 10 HOTEL BOULEVARD 50+11.52 56 HORSESHOE BEND 60+11.77 62 59+93.10 LT 63 60+22.52 RT 62 60+82.16 RT 62 WINDOWS WAY 70+09.50 71 71+89.20 73 73.40.62 LT 73 RESTAURANT SERVICE DR LAKESIDE DRIVE 80+30.00 83 81+25.93 RT 81 CABIN ROAD 1 100+25.00 102 102+39.62 103 103+41.81 108 102+27.68 RT 102 103+46.81 RT 103 104+94.11 RT 104 104+96.83 LT 105 105+97.62 LT 106 107+44.41 LT 107 CABIN ROAD 2 200+25.00 206 HOTEL LOT 1 300+11.50 302 HOTEL LOT 2 400+11.70 402 400+67.30 LT 400 HOTEL LOT 3 500+12.30 502 HOTEL LOT 2 400+11.70 402 400+67.30 LT 400 HOTEL LOT 3 500+12.30 502	178+83.82										898					528
WINDY LANE 0+30.00	167+93.57	7+93.57 LT	9							78						
0+30.00	167+96.41	7+96.41 RT	5							40						
6+69.70 LT 6+ 9+12.45 LT 9+ 10.65.76 RT 10 10+82.78 LT 10 HOTEL BOULEVARD 50+11.52 56 HORSESHOE BEND 60+11.77 62 59+93.10 LT 63 60+22.52 RT 62 60+82.16 RT 62 WINDOWS WAY 70+09.50 71 71+89.20 73 73.30.20 74 73+16.62 LT 73 RESTAURANT SERVICE DR LAKESIDE DRIVE 80+30.00 83 81+25.93 RT 81 CABIN ROAD 1 100+25.00 102 102+39.62 103 103+41.81 108 102+27.68 RT 102 103+46.81 RT 103 104+94.11 RT 104 104+96.83 LT 105 105+97.62 LT 106 107+44.41 LT 107 CABIN ROAD 2 200+25.00 206 HOTEL LOT 1 300+11.50 302 HOTEL LOT 2 400+11.70 402 400+12.02 LT 400 HOTEL LOT 3 500+12.30 502																
9+12.45 LT 9+ 10.65.76 RT 10 10+82.78 LT 10 HOTEL BOULEVARD 50+11.52 S6 HORSESHOE BEND 60+11.77	17+87.61	+87.61				2673		499								
10.65.76 RT 10 10+82.78 LT 10 10+82.78 LT 10 HOTEL BOULEVARD 50+11.52 56 HORSESHOB BEND 60+11.77 62 59+93.10 LT 63 60+22.52 RT 62 60+82.16 RT 62 WINDOWS WAY 70+09.50 71 71+89.20 73 73.30.20 74 73+16.62 LT 73 RESTAURNT SERVICE DR LAKESIDE DRIVE 80+30.00 83 81+25.93 RT 81 CABIN ROAD 1 100+25.00 102 102+39.62 103 103+41.81 108 102+27.68 RT 102 103+41.81 RT 103 104+96.83 LT 103 104+96.83 LT 105 105+97.62 LT 106 107+44.41 LT 107 CABIN ROAD 2 200+25.00 40 107+44.41 LT 107 CABIN ROAD 2 200+25.00 40 HOTEL LOT 1 300+11.50 302 HOTEL LOT 2 400+11.70 402 400+67.30 LT 400 HOTEL LOT 3 500+12.30 502	6+79.70	-79.70 LT											10			
10+82.78	9+22.45	-22.45 LT	•										10			
10+82.78	10+75.76												10			
HOTEL BOULEVARD 50+11.52 56 HORSESHOE BEND 60+11.77 62 59+93.10 LT 63 60+22.52 RT 62 60+82.16 RT 62 WINDOWS WAY 70+09.50 71 71+89.20 73 73.30.20 74 73+16.62 LT 73 RESTAURANT SENVICE DR LAKESIDE DRIVE 80+30.00 83 81+25.93 RT 81 CABIN ROAD 1 100+25.00 102 102+39.62 103 103+41.81 109 103+23.71 RT 103 103+23.71 RT 103 104+94.11 RT 104 104+96.83 LT 105 105+97.62 LT 106 107+44.41 LT 107 CABIN ROAD 2 200+25.00 206 HOTEL LOT 1 300 HOTEL LOT 2 400 400+11.70 402 400+11.70 402 400+67.30 LT 400 HOTEL LOT 3 502	10+92.78												10			
50+11.52 56 HORSESHOE BEND 60+11.77 62 59+93.10 LT 63 60+22.52 RT 62 60+82.16 RT 62 WINDOWS WAY 70+09.50 71 71+89.20 73 73.30.20 74 73+16.62 LT 73 RESTAURANT SERVICE DR LAKESIDE DRIVE 80+30.00 83 81+25.93 RT 81 CABIN ROAD 1 100+25.00 102 102+39.62 103 103+41.81 108 102+27.68 RT 102 103+46.81 RT 103 104+94.11 RT 104 104+96.83 LT 105 105+97.62 LT 106 107+44.41 LT 107 CABIN ROAD 2 20+25.00 206 HOTEL LOT 1 300+11.50 302 HOTEL LOT 2 400+12.02 LT 400 400+67.30 LT 400 HOTEL LOT 3 500+12.30 502																
60+11.77 62 59+93.10 LT 63 60+22.52 RT 62 60+82.16 RT 62 WINDOWS WAY 70+09.50 71 71+89.20 73 73.30.20 74 73+16.62 LT 73 RESTAURANT SERVICE DR LAKESIDE DRIVE 80+30.00 83 81+25.93 RT 81 CABIN ROAD 1 100+25.00 102 102+39.62 103 103+41.81 108 102+27.68 RT 102 103+27.68 RT 102 103+46.81 RT 103 104+94.11 RT 104 104+96.83 LT 105 105+97.62 LT 106 107+44.41 LT 107 CABIN ROAD 2 200+25.00 206 HOTEL LOT 1 300+11.50 302 HOTEL LOT 2 400+12.02 LT 400 400+67.30 LT 400 HOTEL LOT 3 500+12.30 502	56+74.72	+74.72				1022		191							4.0	
60+11.77 62 59+93.10 LT 63 60+22.52 RT 62 60+82.16 RT 62 WINDOWS WAY 70+09.50 71 71+89.20 73 73.30.20 74 73+16.62 LT 73 RESTAURANT SERVICE DR LAKESIDE DRIVE 80+30.00 83 81+25.93 RT 81 CABIN ROAD 1 100+25.00 102 102+39.62 103 103+41.81 108 102+27.68 RT 102 103+46.81 RT 103 104+94.11 RT 104 104+96.83 LT 105 105+97.62 LT 106 107+44.41 LT 107 CABIN ROAD 2 200+25.00 206 HOTEL LOT 1 300+11.50 302 HOTEL LOT 2 400+11.70 402 400+67.30 LT 400 HOTEL LOT 3 500+12.30 502																
59+93.10 LT 63 60+22.52 RT 62 60+82.16 RT 62 WINDOWS WAY 70+09.50 71. 71+89.20 73 73.30.20 74 73+16.62 LT 73 RESTAURANT SERVICE DR LAKESIDE DRIVE 80+30.00 83 81+25.93 RT 81. CABIN ROAD 1 100+25.00 102 102+39.62 103 103+41.81 108 102+27.68 RT 102 103+46.81 RT 103 104+94.11 RT 104 104+96.83 LT 105 105+97.62 LT 106 107+44.41 LT 107 CABIN ROAD 2 200+25.00 206 HOTEL LOT 1 300+11.50 302 HOTEL LOT 2 400+12.02 LT 400 400+67.30 LT 400 HOTEL LOT 3 500+12.30 502	62+99.16	+99.16		1408	2999	296	149	111								
60+22.52 RT 62 60+82.16 RT 62 WINDOWS WAY 70+09.50 71 71+89.20 73 73.30.20 74 73+16.62 LT 73 RESTAURANT SERVICE DR LAKESIDE DRIVE 80+30.00 83 81+25.93 RT 81 CABIN ROAD 1 100+25.00 102 102+39.62 103 103+41.81 108 102+27.68 RT 102 103+23.71 RT 103 104+94.11 RT 104 104+96.83 LT 105 105+97.62 LT 106 107+44.41 LT 107 CABIN ROAD 2 200+25.00 206 HOTEL LOT 1 300+11.50 302 HOTEL LOT 2 400+12.02 LT 400 400+67.30 LT 400 HOTEL LOT 3 500+12.30 502	63+17.89		258							2318		421				
60+82.16 RT 62 WINDOWS WAY 70+09.50 71 71+89.20 73 73.30.20 74 73+16.62 LT 73 RESTAURANT SERVICE DR LAKESIDE DRIVE 80+30.00 83 81+25.93 RT 81 CABIN ROAD 1 100+25.00 102 102+39.62 103 103+41.81 108 102+27.68 RT 102 103+23.71 RT 103 103+23.71 RT 103 104+94.11 RT 104 104+96.83 LT 105 105+97.62 LT 106 107+44.41 LT 107 CABIN ROAD 2 200+25.00 206 HOTEL LOT 1 300+11.50 302 HOTEL LOT 2 400+11.70 402 400+67.30 LT 400 HOTEL LOT 3 500+12.30 502	62+88.54											254				
WINDOWS WAY 70+09.50 71 71+89.20 73 73.30.20 74 73+16.62 LT 73 RESTAURANT SERVICE DR 84 LAKESIDE DRIVE 80+30.00 83 80+30.00 83 81+25.93 RT 81 CABIN ROAD 1 102 102 102 102 102 103 102 103 103 103 102 103 103 103 103 103 103 103 104 104 103 104 104 103 104 103 104 103 104	62+56.72									390		231				
70+09.50 71: 71+89.20 73: 73.30.20 74: 73+16.62 LT 73: RESTAURANT SERVICE DR LAKESIDE DRIVE 80+30.00 83: 81+25.93 RT 81: CABIN ROAD 1 100+25.00 102: 102+39.62 103: 103+41.81 108: 102+27.68 RT 102: 103+41.81 RT 103: 103+41.81 RT 103: 104+94.11 RT 104: 104+96.83 LT 105: 105+97.62 LT 106: 107+44.41 LT 107: CABIN ROAD 2 200+25.00 206: HOTEL LOT 1 300+11.50 302: HOTEL LOT 2 400+12.02 LT 400: 400+67.30 LT 400: HOTEL LOT 3 500+12.30 502	02130.72	130.72								330						
71+89.20 73 73.30.20 74 73+16.62 LT 73 RESTAURANT SERVICE DR LAKESIDE DRIVE 80+30.00 83 81+25.93 RT 81 CABIN ROAD 1 100+25.00 102 102+39.62 103 103+41.81 108 102+27.68 RT 102 103+41.81 RT 103 103+46.81 RT 103 104+94.11 RT 104 104+96.83 LT 105 105+97.62 LT 106 107+44.41 LT 107 CABIN ROAD 2 200+25.00 206 HOTEL LOT 1 300+11.50 302 HOTEL LOT 2 400+12.02 LT 400 400+67.30 LT 400 HOTEL LOT 3 500+12.30 502	71+83.20	102.20				368		69								
73.30.20 74 73+16.62 LT 73 RESTAURANT SERVICE DR LAKESIDE DRIVE 80+30.00 83 81+25.93 RT 81 CABIN ROAD 1 100+25.00 102 103+41.81 108 102+27.68 RT 103 103+42.81 RT 103 103+46.81 RT 103 104+94.11 RT 104 104+96.83 LT 105 105+97.62 LT 106 107+44.41 LT 107 CABIN ROAD 2 200+25.00 206 HOTEL LOT 1 300+11.50 302 HOTEL LOT 2 400+11.70 402 400+67.30 LT 400 HOTEL LOT 3 500+12.30 502	73+24.27					255		48								
73+16.62 LT 73 RESTAURANT SERVICE DR LAKESIDE DRIVE 80+30.00 83 81+25.93 RT 81 CABIN ROAD 1 102 103 100+25.00 103 103 102+39.62 103 103 103+41.81 100 102 103+23.71 RT 103 103+23.71 RT 103 104+94.11 RT 104 104+96.83 LT 105 105+97.62 LT 106 107+44.41 LT 107 CABIN ROAD 2 200+25.00 206 HOTEL LOT 1 302 302 HOTEL LOT 2 400+11.70 402 400+12.02 LT 400 400+67.30 LT 400 HOTEL LOT 3 500+12.30 502																
RESTAURANT SERVICE DR LAKESIDE DRIVE 80+30.00 83 81+25.93 RT 81 CABIN ROAD 1 100+25.00 102+39.62 103+41.81 102+27.68 RT 102+27.68 RT 103+46.81 RT 103+46.81 RT 103+46.81 RT 104+94.11 RT 104+96.83 LT 105+97.62 LT 107+44.41 LT 107 CABIN ROAD 2 20+25.00 206 HOTEL LOT 1 400+11.70 402 400+12.02 LT 400 HOTEL LOT 3 500+12.30 83 83 RT 102 102 102 103 104 104 104 104 104 104 104 104 104 104	74+69.77		. 45			343		64		424						
LAKESIDE DRIVE 80+30.00 81+25.93 RT CABIN ROAD 1 100+25.00 102+39.62 103+41.81 102+27.68 RT 103+23.71 RT 103+46.81 RT 104+94.11 RT 104+96.83 LT 105+97.62 LT 107+44.41 LT CABIN ROAD 2 200+25.00 HOTEL LOT 1 300+11.50 302 HOTEL LOT 2 400+12.02 LT 400 400 400 400 HOTEL LOT 3 500+12.30 838 RT 102 102 103 104 105 105 105 105 105 105 105	73+33.16		15			100				134						
80+30.00 83 81+25.93 RT 81 CABIN ROAD 1 100+25.00 102 102+39.62 103 103+41.81 108 102+27.68 RT 102 103+23.71 RT 103 104+94.11 RT 104 104+96.83 LT 105 105+97.62 LT 106 107+44.41 LT 107 CABIN ROAD 2 200+25.00 206 HOTEL LOT 1 300+11.50 302 HOTEL LOT 2 400+11.70 402 400+67.30 LT 400 HOTEL LOT 3 500+12.30 502	EDRIVE	IVE	-			169		32								
81+25.93 RT 81 CABIN ROAD 1 100+25.00 102 102+39.62 103 103+41.81 108 102+27.68 RT 102 103+46.81 RT 103 104+94.11 RT 104 104+96.83 LT 105 105+97.62 LT 106 107+44.41 LT 107 CABIN ROAD 2 200+25.00 206 HOTEL LOT 1 300+11.50 302 HOTEL LOT 2 400+12.02 LT 400 400+67.30 LT 400 HOTEL LOT 3 500+12.30 502																
CABIN ROAD 1 100+25.00 102+39.62 103+41.81 102+27.68 RT 103+23.71 RT 103+46.81 RT 104+94.11 RT 104+96.83 LT 105+97.62 LT 107+44.41 LT 107 CABIN ROAD 2 200+25.00 HOTEL LOT 1 300+11.50 400+11.70 400+12.02 LT 400 HOTEL LOT 3 500+12.30 502 HOTEL LOT 3 500+12.30 502	83+40.00					456		85								
100+25.00 102 102+39.62 103 103+41.81 108 102+27.68 RT 102 103+23.71 RT 103 103+46.81 RT 103 104+94.11 RT 104 104+96.83 LT 105 105+97.62 LT 106 107+44.41 LT 107 CABIN ROAD 2 200+25.00 206 HOTEL LOT 1 300+11.50 302 HOTEL LOT 2 400+11.70 402 400+12.02 LT 400 HOTEL LOT 3 500+12.30 502	81+38.13	+38.13 RT	28							248						
102+39.62 103 103+41.81 108 102+27.68 RT 102 103+23.71 RT 103 103+46.81 RT 103 104+94.11 RT 104 104+96.83 LT 105 107+44.41 LT 107 CABIN ROAD 2 200+25.00 206 HOTEL LOT 1 300+11.50 302 HOTEL LOT 2 400+11.70 402 400+67.30 LT 400 HOTEL LOT 3 500+12.30 502																
103+41.81 108 102+27.68 RT 102 103+23.71 RT 103 103+46.81 RT 103 104+94.11 RT 104 104+96.83 LT 105 105+97.62 LT 106 107+44.41 LT 107 CABIN ROAD 2 200+25.00 206 HOTEL LOT 1 300+11.50 302 HOTEL LOT 2 400+11.70 402 400+67.30 LT 400 HOTEL LOT 3 500+12.30 502	102+39.62			690	1447	143	72	53								
102+27.68 RT 102 103+23.71 RT 103 103+46.81 RT 103 104+94.11 RT 104 104+96.83 LT 105 105+97.62 LT 106 107+44.41 LT 107 CABIN ROAD 2 200+25.00 206 HOTEL LOT 1 300+11.50 302 HOTEL LOT 2 400+11.70 402 400+67.30 LT 400 HOTEL LOT 3 500+12.30 502	103+41.81		316						287							
103+23.71 RT 103 103+46.81 RT 103 104+94.11 RT 104 104+96.83 LT 105 105+97.62 LT 106 107+44.41 LT 107 CABIN ROAD 2 200+25.00 206 HOTEL LOT 1 300+11.50 302 HOTEL LOT 2 400+11.70 402 400+67.30 LT 400 HOTEL LOT 3 500+12.30 502	108+48.63			1722	3693	365	184	137								
103+46.81 RT 103 104+94.11 RT 104 104+96.83 LT 105 105+97.62 LT 106 107+44.41 LT 107 CABIN ROAD 2 200+25.00 206 HOTEL LOT 1 300+11.50 302 HOTEL LOT 2 400+11.70 402 400+67.30 LT 400 HOTEL LOT 3 500+12.30 502	102+35.69		19							168						
104+94.11 RT 104 104+96.83 LT 105 105+97.62 LT 106 107+44.41 LT 107 CABIN ROAD 2 200+25.00 206 HOTEL LOT 1 300+11.50 302 HOTEL LOT 2 400+11.70 402 400+12.02 LT 400 400+67.30 LT 400 HOTEL LOT 3 500+12.30 502	103.32.86	3.32.86 RT	3							24						
104+96.83 LT 105 105+97.62 LT 106 107+44.41 LT 107 CABIN ROAD 2 200+25.00 206 HOTEL LOT 1 300+11.50 302 HOTEL LOT 2 400+11.70 402 400+12.02 LT 400 HOTEL LOT 3 500+12.30 502	103+67.09	3+67.09 RT	12							108						
105+97.62 LT 106 107+44.41 LT 107 CABIN ROAD 2 200+25.00 206 HOTEL LOT 1 300+11.50 302 HOTEL LOT 2 400+11.70 402 400+12.02 LT 400 400+67.30 LT 400 HOTEL LOT 3 500+12.30 502	104+99.56	I+99.56 RT	3							24						
107+44.41 LT 107 CABIN ROAD 2 200+25.00 206 HOTEL LOT 1 300+11.50 302 HOTEL LOT 2 400+11.70 402 400+12.02 LT 400 400+67.30 LT 400 HOTEL LOT 3 500+12.30 502	105+05.45	5+05.45 LT	4							28						
107+44.41 LT 107 CABIN ROAD 2 200+25.00 206 HOTEL LOT 1 300+11.50 302 HOTEL LOT 2 400+11.70 402 400+12.02 LT 400 400+67.30 LT 400 HOTEL LOT 3 500+12.30 502	106+09.64	5+09.64 LT	11							92						
200+25.00 206 HOTEL LOT 1 300+11.50 302 HOTEL LOT 2 400+11.70 402 400+12.02 LT 400 400+67.30 LT 400 HOTEL LOT 3 500+12.30 502	107+63.32		30							262						
HOTEL LOT 1 300+11.50 302 HOTEL LOT 2 400+11.70 400+12.02 LT 400+67.30 LT 400TEL LOT 3 500+12.30 502																
300+11.50 302 HOTEL LOT 2 400+11.70 402 400+12.02 LT 400 400+67.30 LT 400 HOTEL LOT 3 500+12.30 502	206+68.88	5+68.88		2052	4392	434	219	162								
300+11.50 302 HOTEL LOT 2 400+11.70 402 400+12.02 LT 400 400+67.30 LT 400 HOTEL LOT 3 500+12.30 502																
HOTEL LOT 2 400+11.70 400+12.02 LT 400+67.30 LT 400TEL LOT 3 500+12.30 502	302+35.75	2+35.75				1360		254								
400+11.70 402 400+12.02 LT 400 400+67.30 LT 400 HOTEL LOT 3 500+12.30 502																
400+12.02 LT 400 400+67.30 LT 400 HOTEL LOT 3 500+12.30 502	402+36.20	2+36.20				1360		254								
400+67.30 LT 400 HOTEL LOT 3 500+12.30 502	400+76.27		•										86			
HOTEL LOT 3 500+12.30 502	400+73.96									217.0						
500+12.30 502																
	502+36.45	2+36.45				1174		220								
TRAILER PARKING LOT 1						11/7		220								
	302130.43	2+70.76									1680					988
TRAILER PARKING LOT 2		. , 0. / 0	-								1000					366
	602+70.76	240 74	+								1546					909
700+11.23 702	602+70.76	T49.74	-								1546					909
TOTAL	602+70.76															

USER NAME = skuper	DESIGNED -	J.E.B.	REVISED -
	DRAWN -	S.D.K.	REVISED -
PLOT SCALE = 40.0000 / in	CHECKED -	R.H.D.	REVISED -
PLOT DATE = 4/16/2023	DATE -	4/14/23	REVISED -

SCALE:

		SC	HED	ULE	OF QU	ANTITIES		F.A. RTE.	SEC ⁻	TION		COUNTY	TOTAL SHEETS	SHEET NO.
w	AVNF F	IT70	FRR	FII	STATE	RECRE∆T	ION AREA		FITZGERREI	L PARKI	NG	FRANKLIN	49	8
***	AIIVE I	1120	aliviv		JIAIL	ILCILAI	ION ANLA					CONTRACT	NO. 46	5932
	SHEET	1	OF	2	SHEETS	STA.	TO STA.			ILLINOIS	FED. A	D PROJECT		

: Z:\0 V and K Jobs\5371-041 Rend Lake Resort - Survey & Design\CADD S

	DRAINAGE SCHEDULE													
				METAL FL	P CUL CL	CONTR LOW-	INLETS TA	INLETS RECONST	CLEAN DRAIN					
				SEC 12"	C 1 12	STRENG MATL	T11 F&G	SPL	SYSTEM					
	LT/		LT/	(EACH)	(FOOT)	(CU YD)	(EACH)	(EACH)	(LSUM)					
STA.	RT	STA.	RT	54262712	542C0217	59300100	60236800	X6026800	Z0010605					
SITE WIDE									1					
MAIN PARK ROAD														
169+93.00, 13.7'	LT					3		1						
HORSESHOE BEND														
60+76.00, 11.30'	LT						1							
62+68.00, 18.00'	LT						1							
CABIN ROAD 1														
102+22.00, 24'	RT	102+40.33, 23.2'	RT		17									
102+22.00, 24'	RT			1										
102+40.33, 23.2'	RT			1										
CABIN ROAD 2														
200+28.00, 17.5'	LT			1										
200+42.00, 16.0'	RT			1										
TOTAL =				4	17	3	2	1	1					

		PAV	EMENT MAR	PAVEMENT MARKING & SIGNING SCHEDULE													
				TELE STL SIGN	THPL PVT MK	THPL PVT MK	THPL PVT MK	BOLLARDS									
			SIGN PANEL T1	SUPPORT	LTR & SYM	LINE 4	LINE 6										
			SQ. FT.	FOOT	SQ. FT.	FOOT	FOOT	(EACH)									
LOCATION	STATION	TO STATION	72000100	72800100	78000100	78000200	78000400	Z0004002									
SOUTH AREA			30	168	71.1	6340	2140	2									
NORTH AREA			16	72	31	3977	1922	4									
HORSESHOE BEND			20	168	12.4	485	761										
		TOTAL	66	408	115	10802	4823	6									

		EROSIO	<u> </u>	CONTRO	L SCHE	DULE		
				GRAD &	PERIMETER	INLET	GRAD &	TOPSOIL
				SHAP DTCH	EROS BAR	FILTERS	SHAP DTCH SPL	F & P SPL
	LT/		LT/	(FOOT)	(FOOT)	(EACH)	(FOOT)	(SQ YD)
STA.	RT	STA.	RT	21400100	28000400	28000510	X2140100	X2110104
ENTIRE PROJECT LIMITS								1000
SOUTH AREA								
5+75.00, 26.00'	LT					1		
100+23.00, 49.00'	RT					1		
100+24.00, 36.00'	LT					1		
101+71.00, 23.40'	RT	102+22.00, 24.00'	RT	50				
101+71.00, 23.40'	RT					1		
102+42.00, 23.00'	RT	103+21.00, 24.00'	RT	70				
102+90.00, 37.00'	LT	103+73.00, 32.00'	LT	105				
103+71.00, 32.00'	LT					1		
105+20.00, 27.00'	LT					1		
106+33.00, 18.00'	LT					1		
107+11.00, 17.00'	LT					1		
200+39.00, 20.00'	LT					1		
200+76.00, 12.00'	LT	204+90.00, 29.00'	LT		479			
206+30.00, 17.00' LT						1		
NORTH AREA								
169+85.00, 70.00'	RT	169+93.00, 24.00'	RT				60	
170+07.00, 16.00'	LT					1		
TOTAL =			-	225	479	11	60	1,000


							R	EMOV	AL SCI	HEDULE						
					TREE REM	HMA SURF REM	HMA SURF	HMA SURF	CURB	COMB CURB	SIDEWALK	PIPE CULVERT	STORM SEWER	REMOV	PAVMT MRKG	PAVT
					6-15	BUTT JT	REM 1/2	REM 1 1/4	REM	GUTTER REM	REM	REMOV	REM 12	INLETS	REM GRIND	REMOVAL SPI
	LT/		LT/		(UNIT)	(SQ YD)	(SQ YD)	(SQ YD)	(FOOT)	(FOOT)	(SQ FT)	(FOOT)	(FOOT)	(EACH)	(SQ FT)	(SQ YD)
STA.	RT	STA.	RT	OFF	20100110	40600982	44000151	44000154	44000300	44000500	44000600	50105220	55100500	60500060	78300201	X4404400
SOUTH AREA								16852	431		3308	16				5283
6+69.70, 10.22'	LT									10						
9+12.45, 10.10'	LT	9+22.45, 10.10'	LT							10						
9+62.77, 12.55'	RT	400+76.27, 63.55'	LT							86						
10+65.76, 38.40'	RT	10+75.76, 38.40'	RT							10						
10+82.78, 9.70'	LT	10+92.78, 9.56'	LT							10						
60+78.62, 6.50'	LT												6	1		
61+20.00, 40.50'	RT				18											
62+66.10, 12.50'	RT												6	1		
NORTH AREA						114	2217								1358	
81+26.00, 37.00'	RT	81+38.00, 9.80'	RT								250					
81+26.33, 30.70'	RT	81+38.00, 9.20'	RT						33							
167+75.50, 11.60'	LT	167+95.65, 13.42'	LT						20							
167+83.40, 11.30'	RT	167+97.00, 16.30'	RT						16							
167+86.00, 12.00'	RT	167+96.40, 16.70'	RT								40					
167+92.00, 12.00'	LT	167+93.60, 12.10'	LT								79					
169+76.00, 11.75'	LT	170+09.40, 11.90'	LT						27							
					18	114	2,217	16,852	527	126	3,677	16	12	2	1,358	5,283


SCALE:


USER NAME = skuper	DESIGNED -	-	J.E.B.	REVISED -	
	DRAWN -	-	S.D.K.	REVISED -	
PLOT SCALE = 40.0000 / in	CHECKED -	-	R.H.D.	REVISED -	
PLOT DATE = 4/16/2023	DATE -	-	4/14/23	REVISED -	


	F.A. RTE	SECTION		COUNTY	TOTAL SHEETS	SHEET NO.		
WAYNE FITZGERRELL STATE RECREATION AREA		FITZGERRELL PARKIN	G	FRANKLIN 49		9		
WATTE THE DESIRED THE RESIDENT AREA				CONTRACT NO. 46932				
SHEET 2 OF 2 SHEETS STA. TO STA.		ILLINOIS F	FED. AID	PROJECT				

rult 2:\0 V and K Jobs\5371-041 Rend Lake Resort - Survey & Design\CADD Sheets\522011d - Schedules.dgr

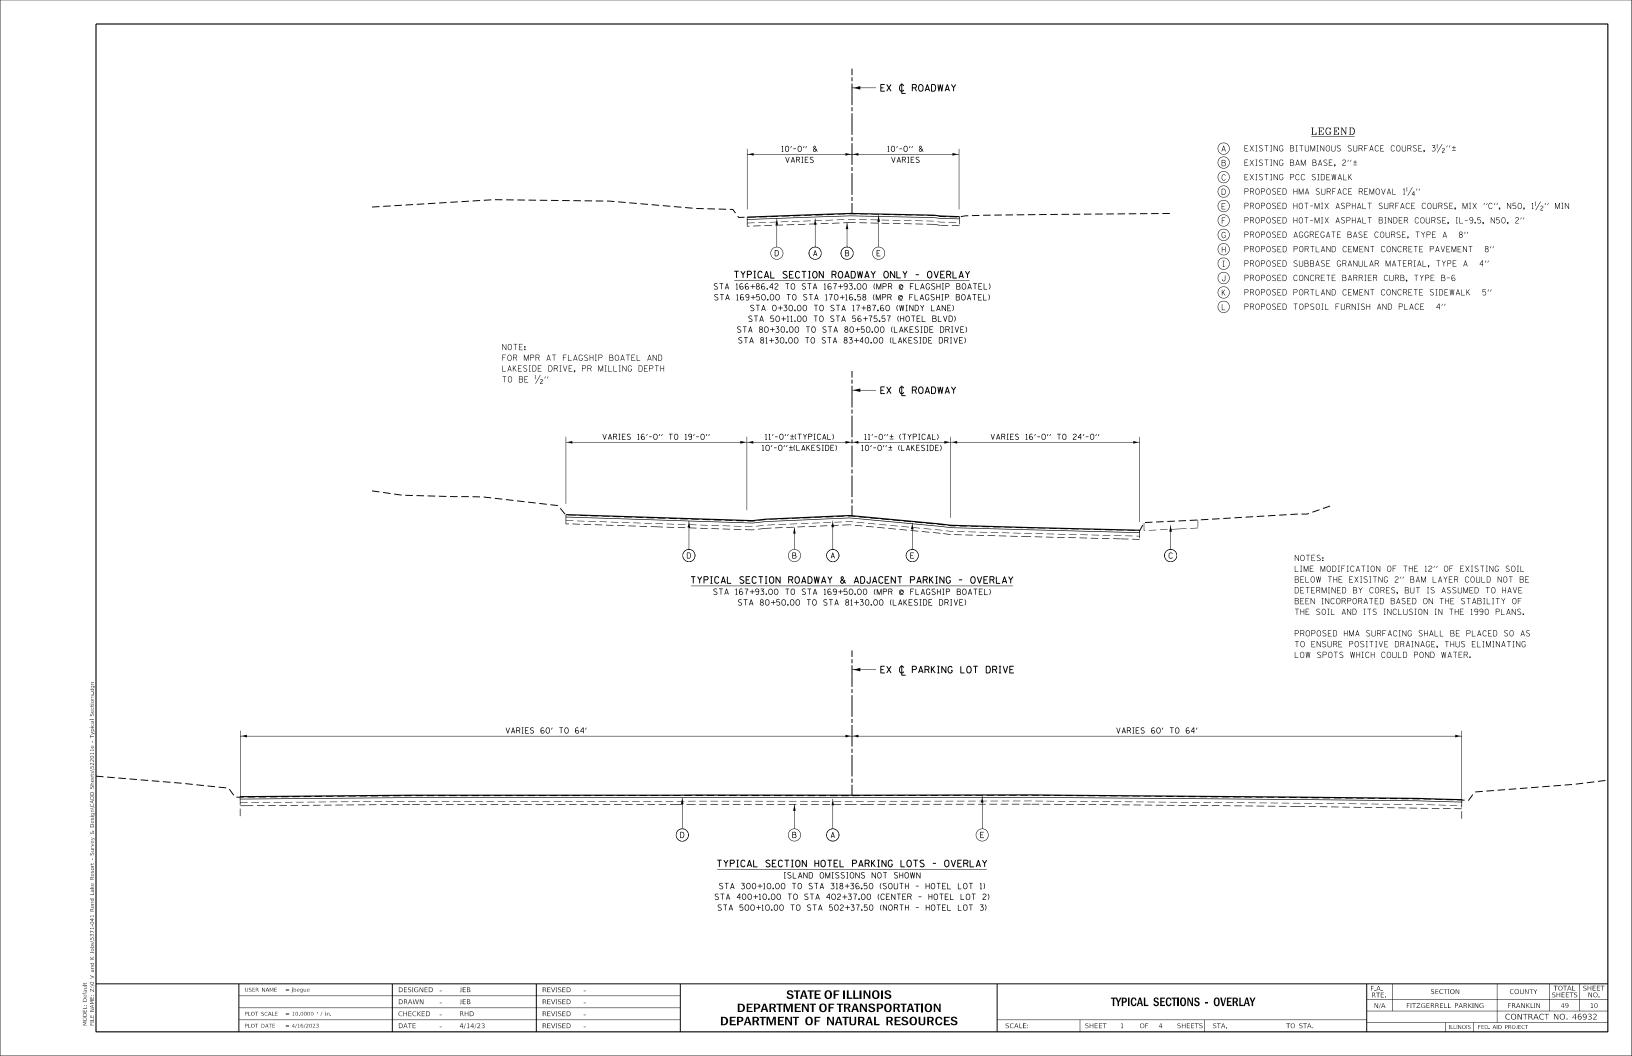

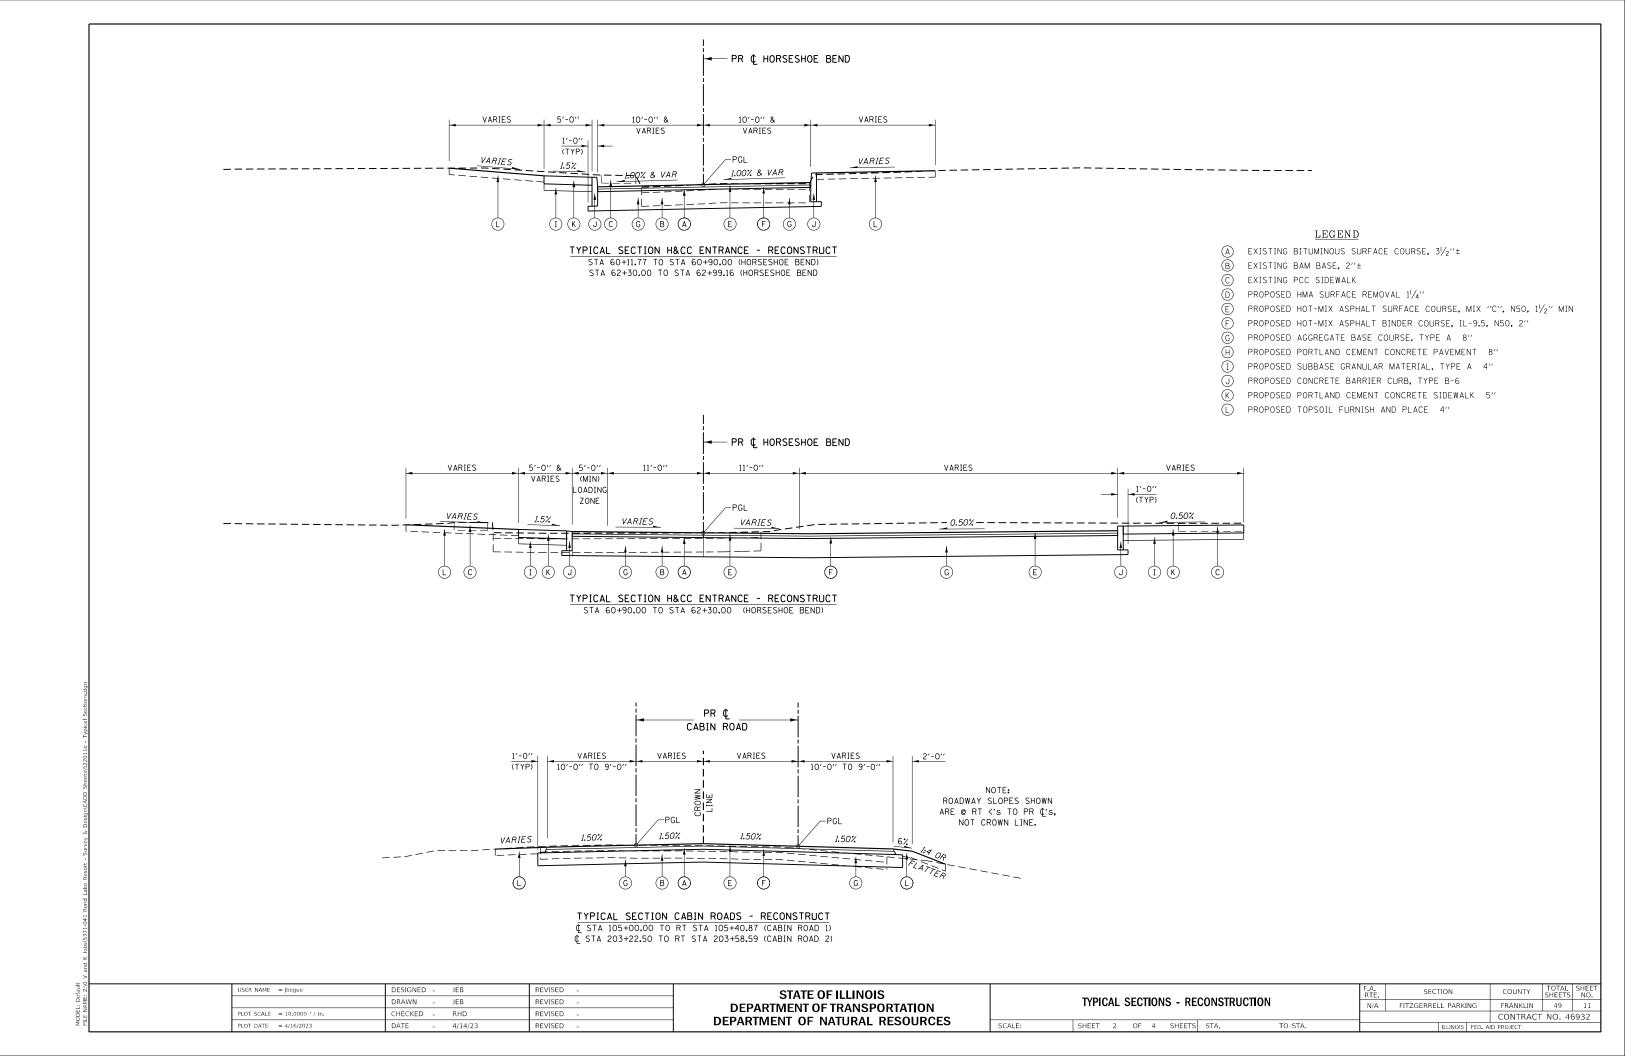

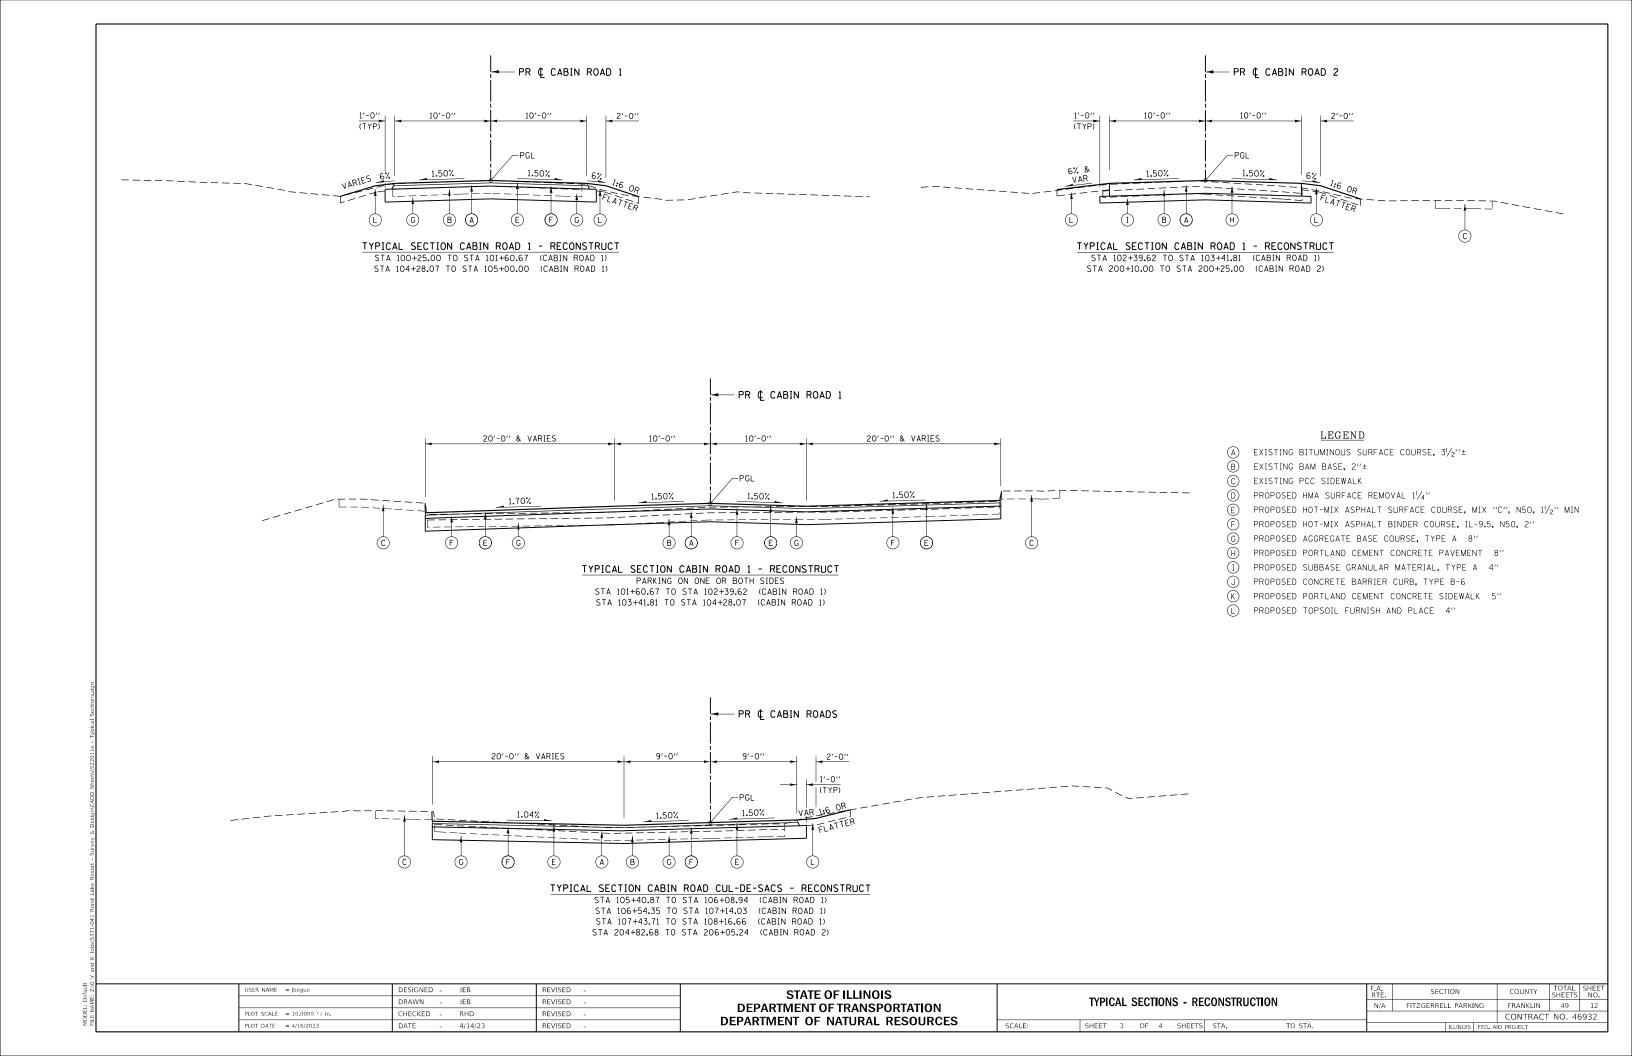

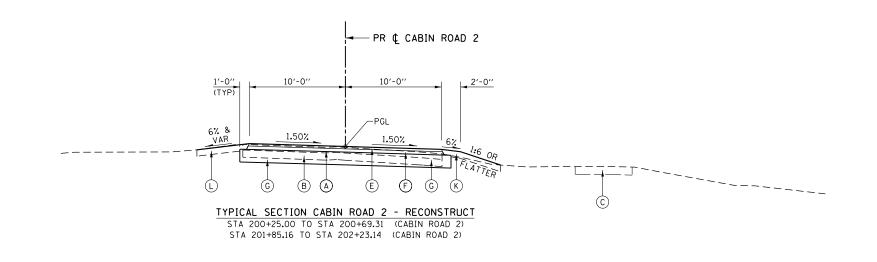


− PR ¢ CABIN ROAD 2 1'-0" (TYP) 20'-0" & VARIES 10'-0" 10'-0" -PGL 1.50% 1.50% 1:6 OR FLATTER

TYPICAL SECTION CABIN ROAD 2 - RECONSTRUCT STA 200+69.31 TO STA 201+85.16 (CABIN ROAD 2) AS SHOWN STA 202+23.14 TO STA 203+22.50 (CABIN ROAD 2) PARKING RIGHT SIDE

<u>LEGEND</u>

- (A) EXISTING BITUMINOUS SURFACE COURSE, 31/2"±
- EXISTING BAM BASE, 2"±
- EXISTING PCC SIDEWALK
- D PROPOSED HMA SURFACE REMOVAL 11/4"
- $\stackrel{\textstyle (E)}{\textstyle (E)}$ PROPOSED HOT-MIX ASPHALT SURFACE COURSE, MIX "C", N50, 1 $^1\!/_2$ " MIN
- F PROPOSED HOT-MIX ASPHALT BINDER COURSE, IL-9.5, N50, 2"
- © PROPOSED AGGREGATE BASE COURSE, TYPE A 8"
- (H) PROPOSED PORTLAND CEMENT CONCRETE PAVEMENT 8"
- PROPOSED SUBBASE GRANULAR MATERIAL, TYPE A 4"
- PROPOSED CONCRETE BARRIER CURB, TYPE B-6
- PROPOSED PORTLAND CEMENT CONCRETE SIDEWALK 5"
- PROPOSED TOPSOIL FURNISH AND PLACE 4"

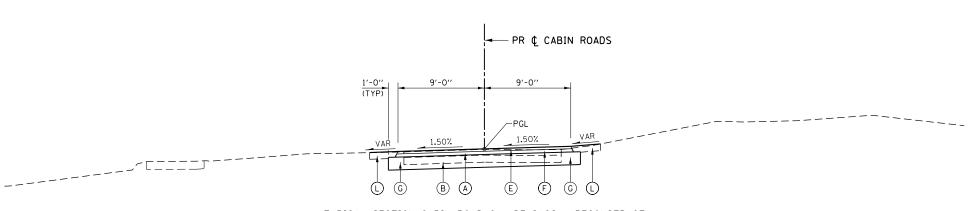


TYPICAL SECTION CABIN ROAD CUL-DE-SACS - RECONSTRUCT


- STA 106+08.94 TO STA 106+54.35 (CABIN ROAD 1)
- STA 107+14.03 TO STA 107+43.71 (CABIN ROAD 1)
- STA 108+16.66 TO STA 108+24.00 (CABIN ROAD 1)
- STA 203+58.59 TO STA 204+82.68 (CABIN ROAD 2)
- STA 206+05.24 TO STA 206+43.84 (CABIN ROAD 2)


USER NAME = jbegue	DESIGNED -	JEB	REVISED -	
	DRAWN -	JEB	REVISED -	
PLOT SCALE = 10.0000 / in.	CHECKED -	RHD	REVISED -	
PLOT DATE = 4/16/2023	DATE -	4/14/23	REVISED -	


STATE OF ILLINOIS DEPARTMENT OF TRANSPORTATION **DEPARTMENT OF NATURAL RESOURCES**


	T/DIO		0501		10 DE	ONOTO	потом			F.A. RTE.	SECT	ΠΟN		COUNTY	TOTAL SHEETS	SHEET NO.	
	IYPIC	AL	SECI	IUN	S - REC	JONSIR	UCTION			N/A	FITZGERRELL PARKING		FRANKLIN	49	13		
													CONTRACT NO. 46932				
SCALE:	SHEET	4	OF	4	SHEETS	STA.		TO STA.	l			ILLINOIS	FED. AI	D PROJECT			

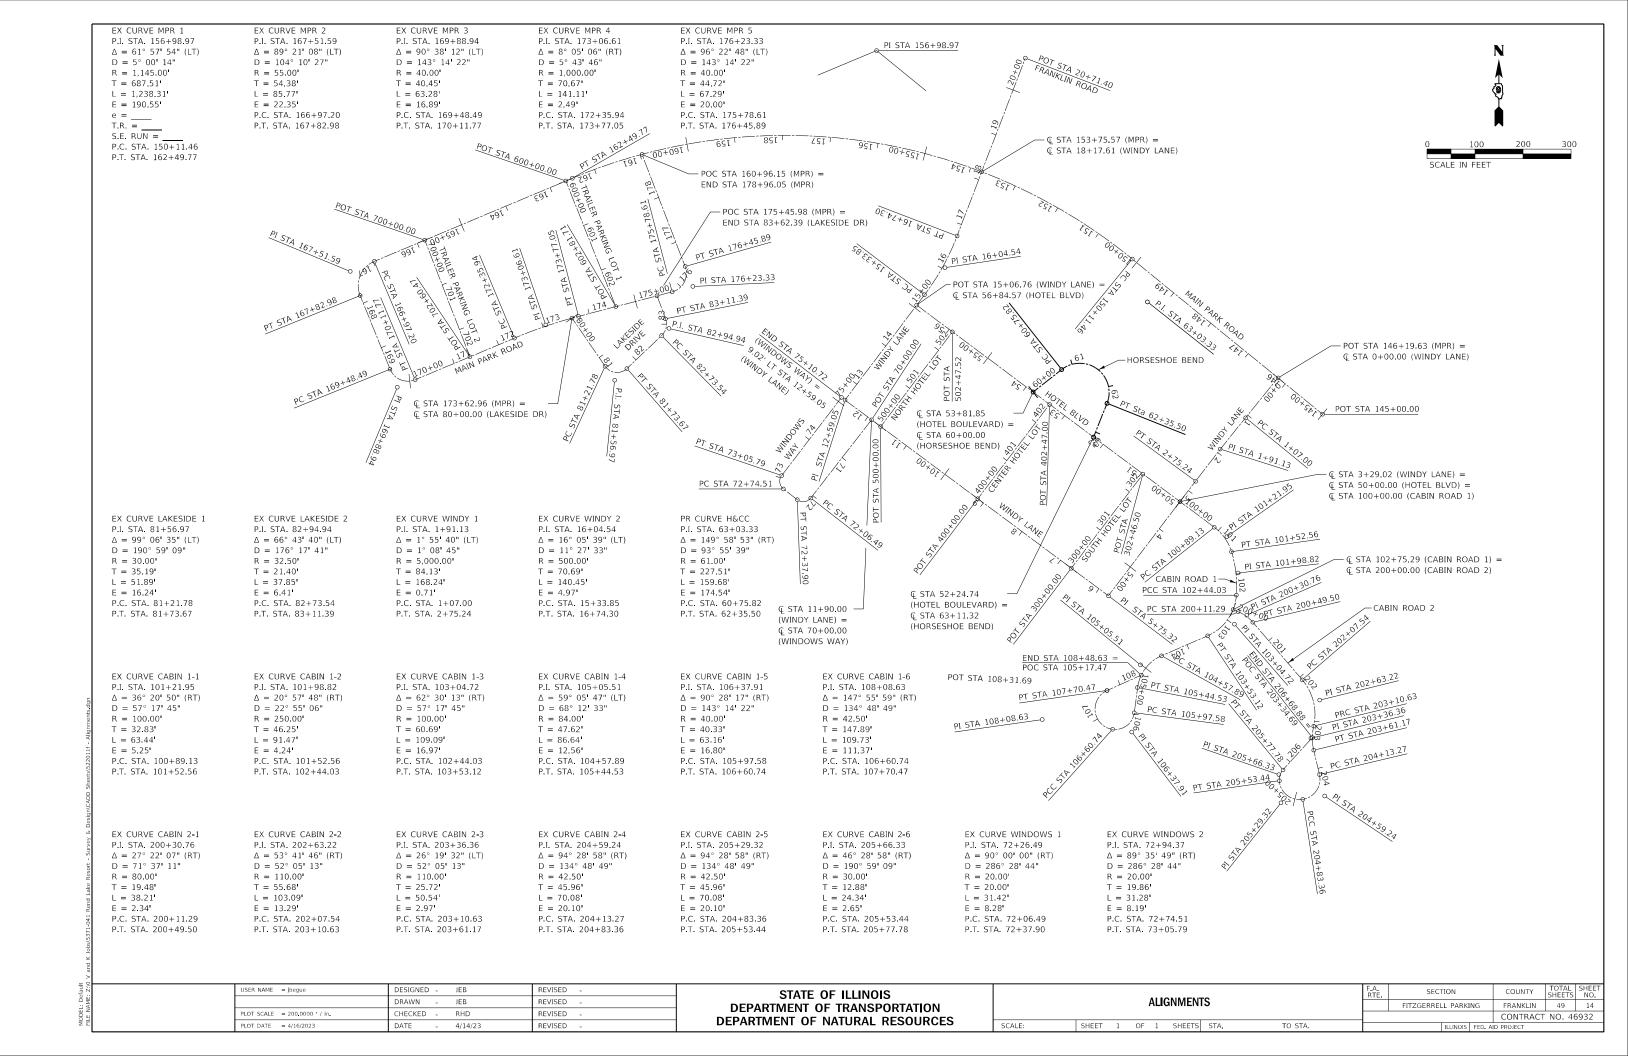


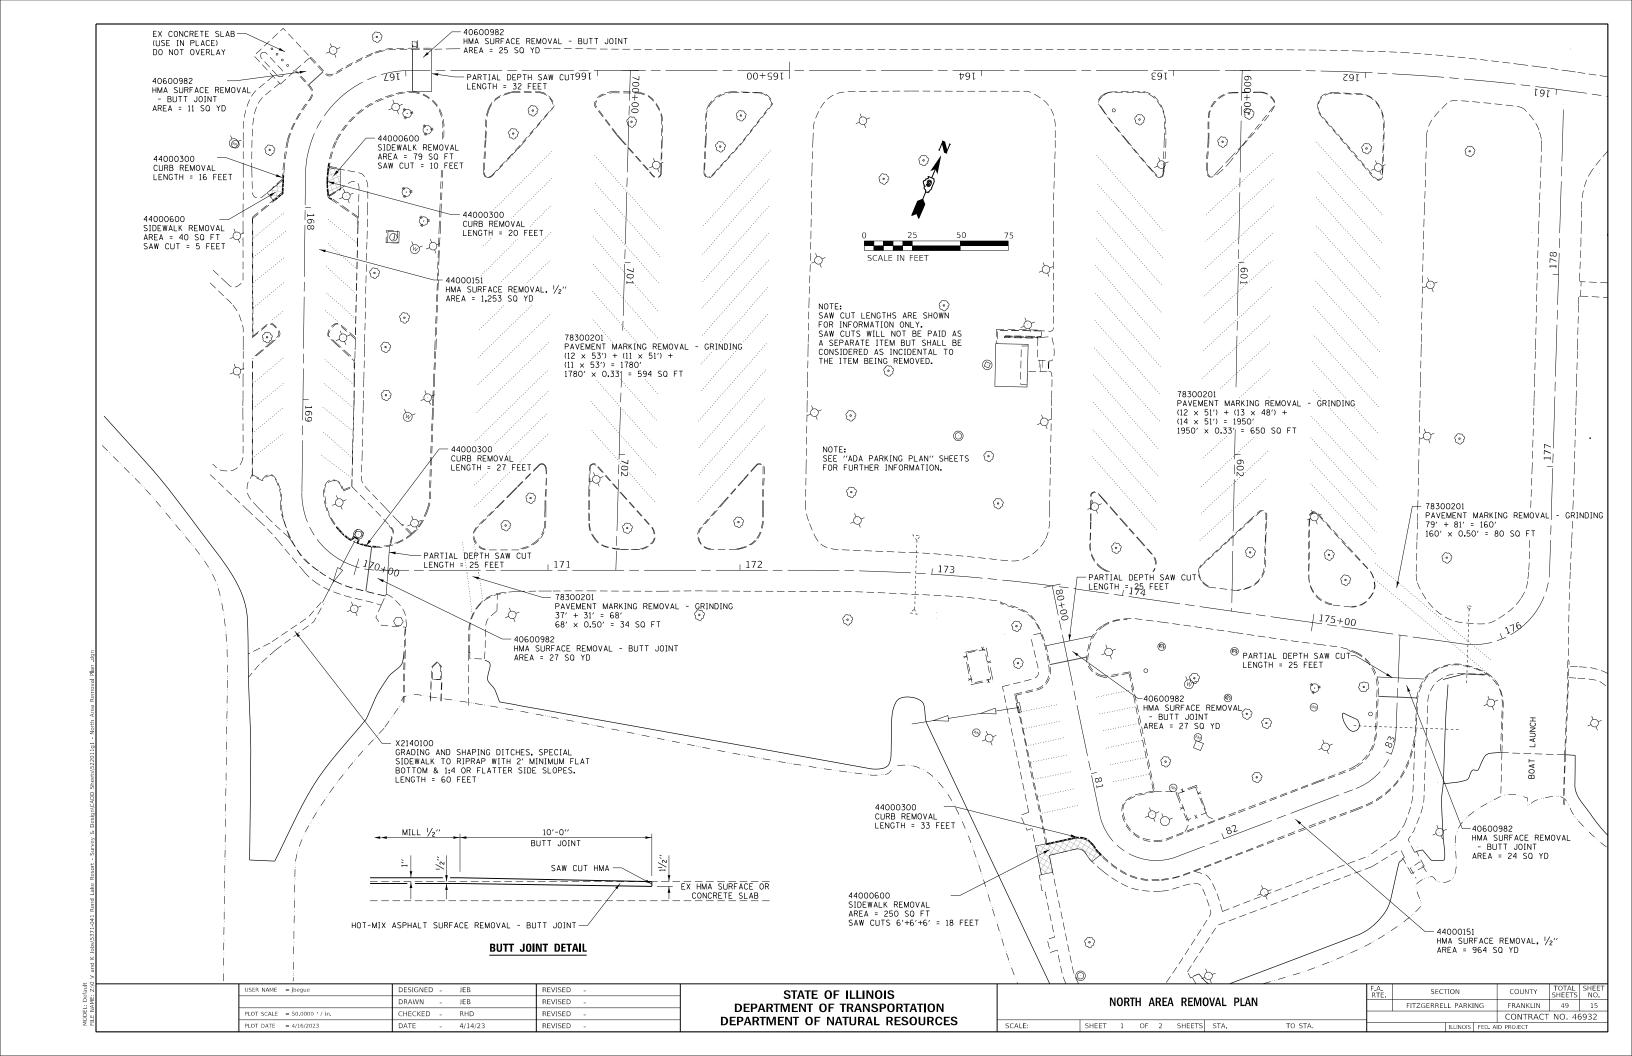


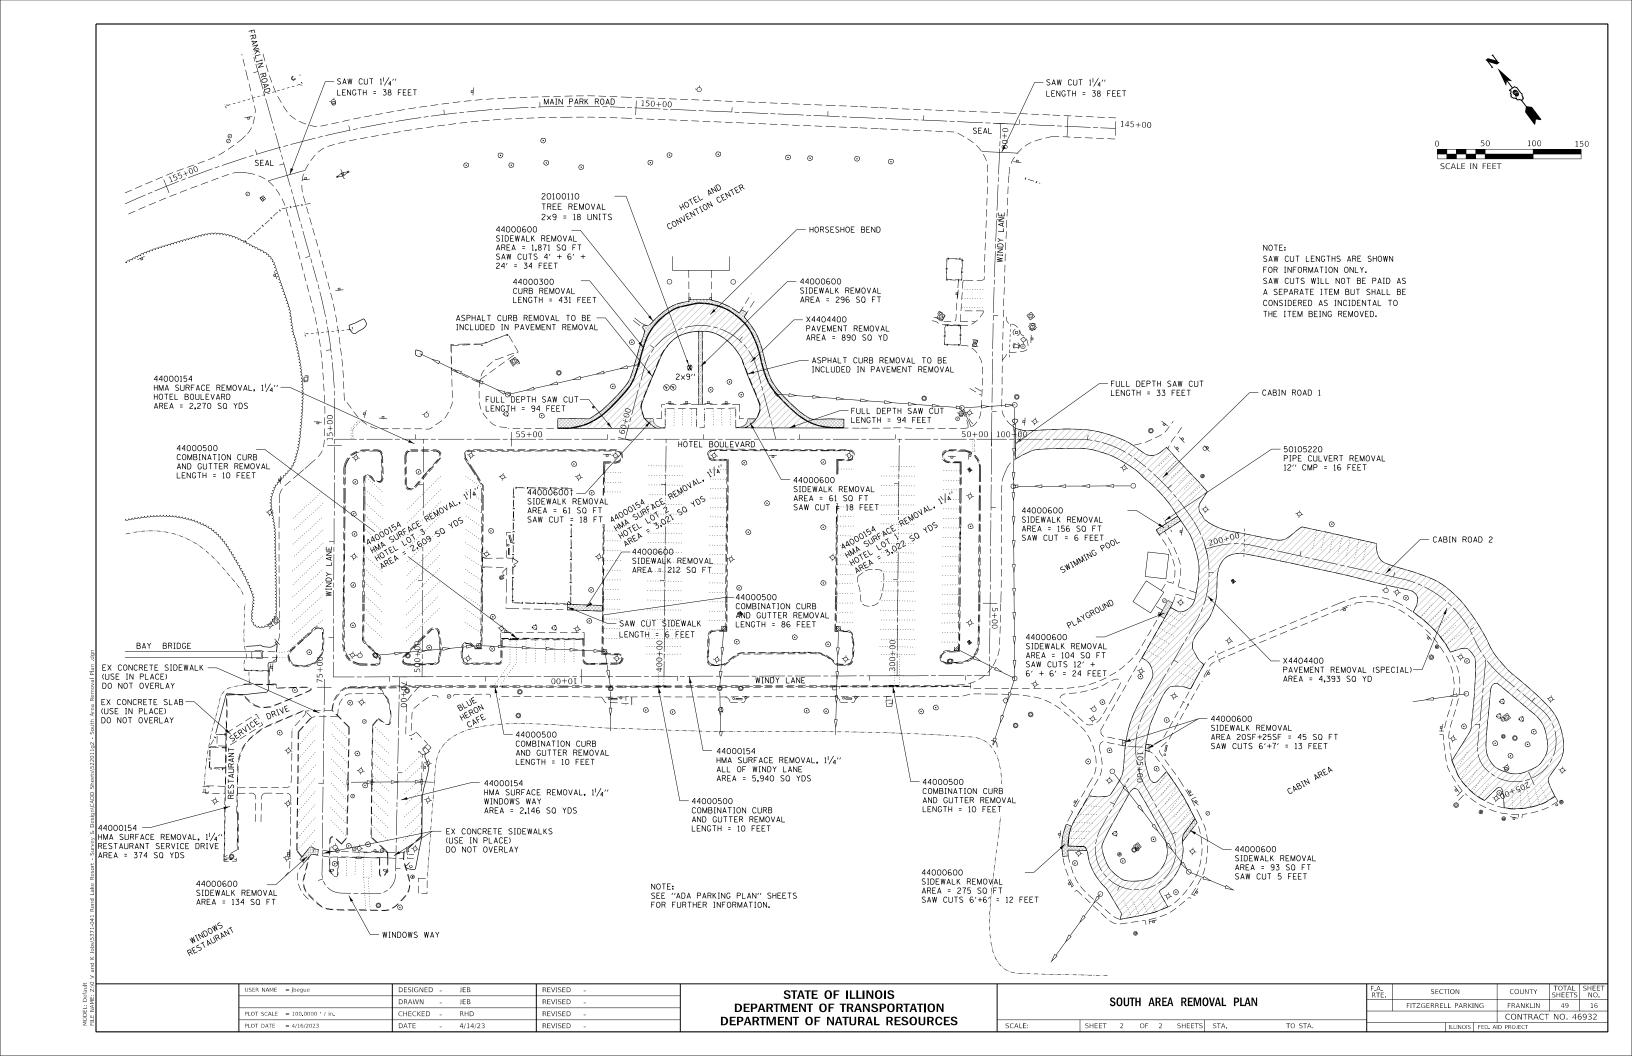


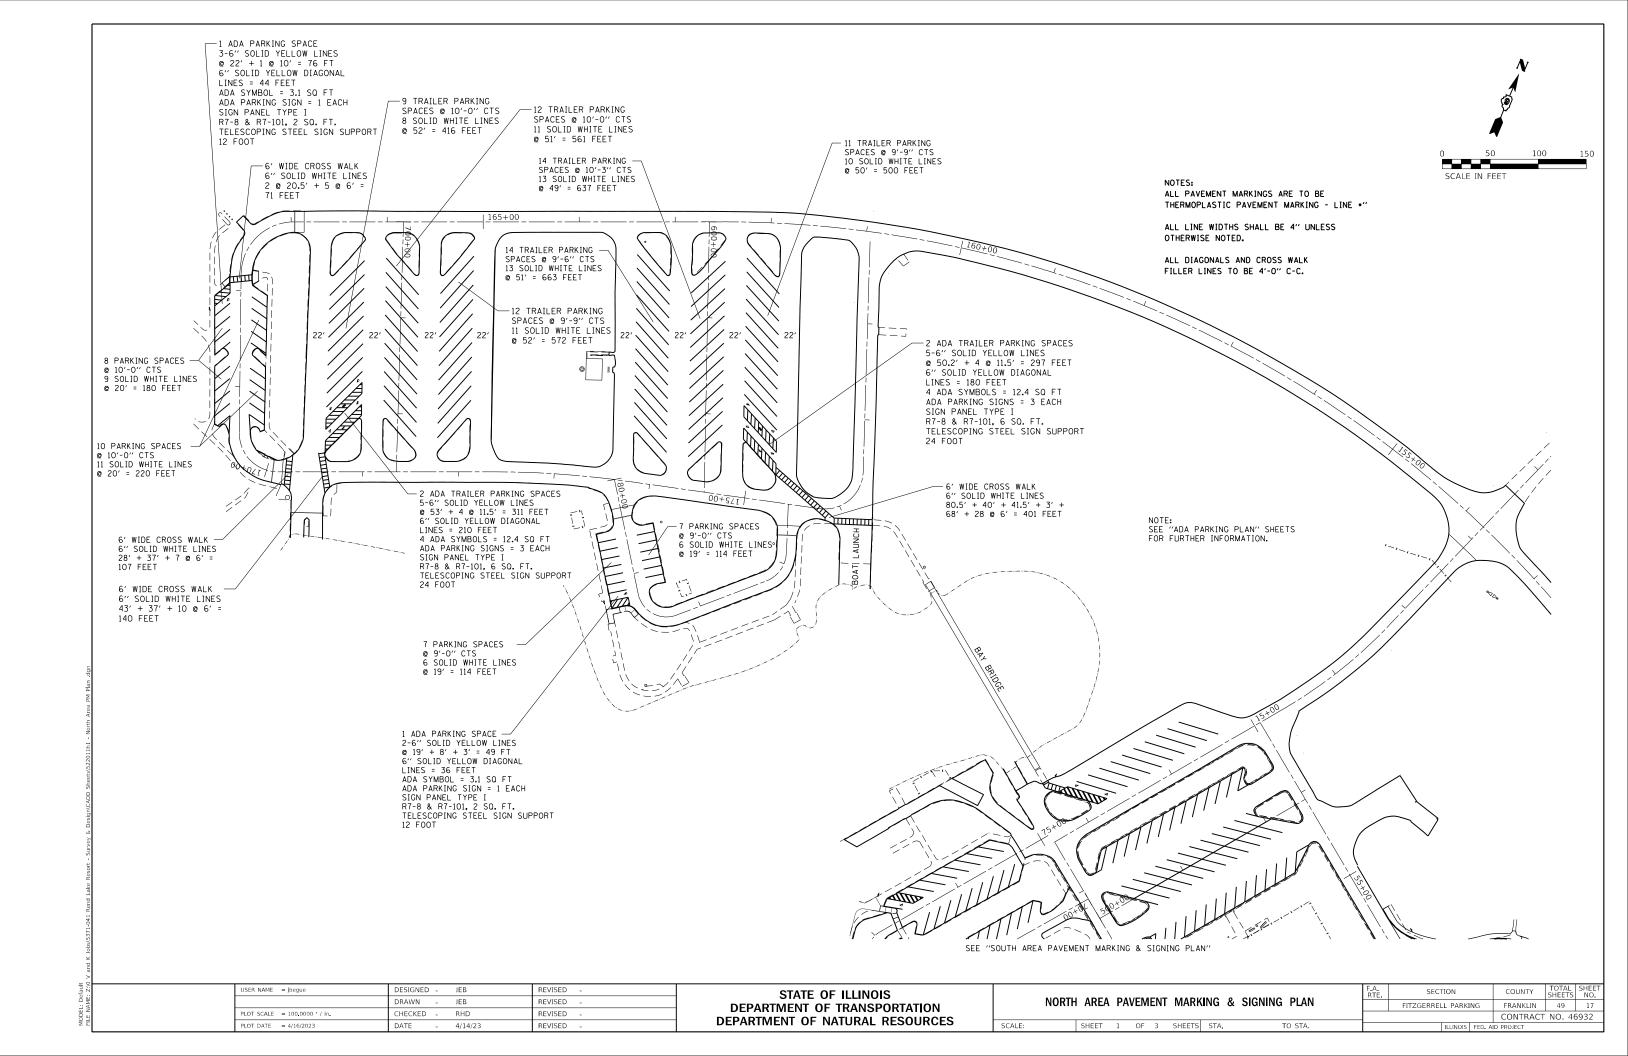


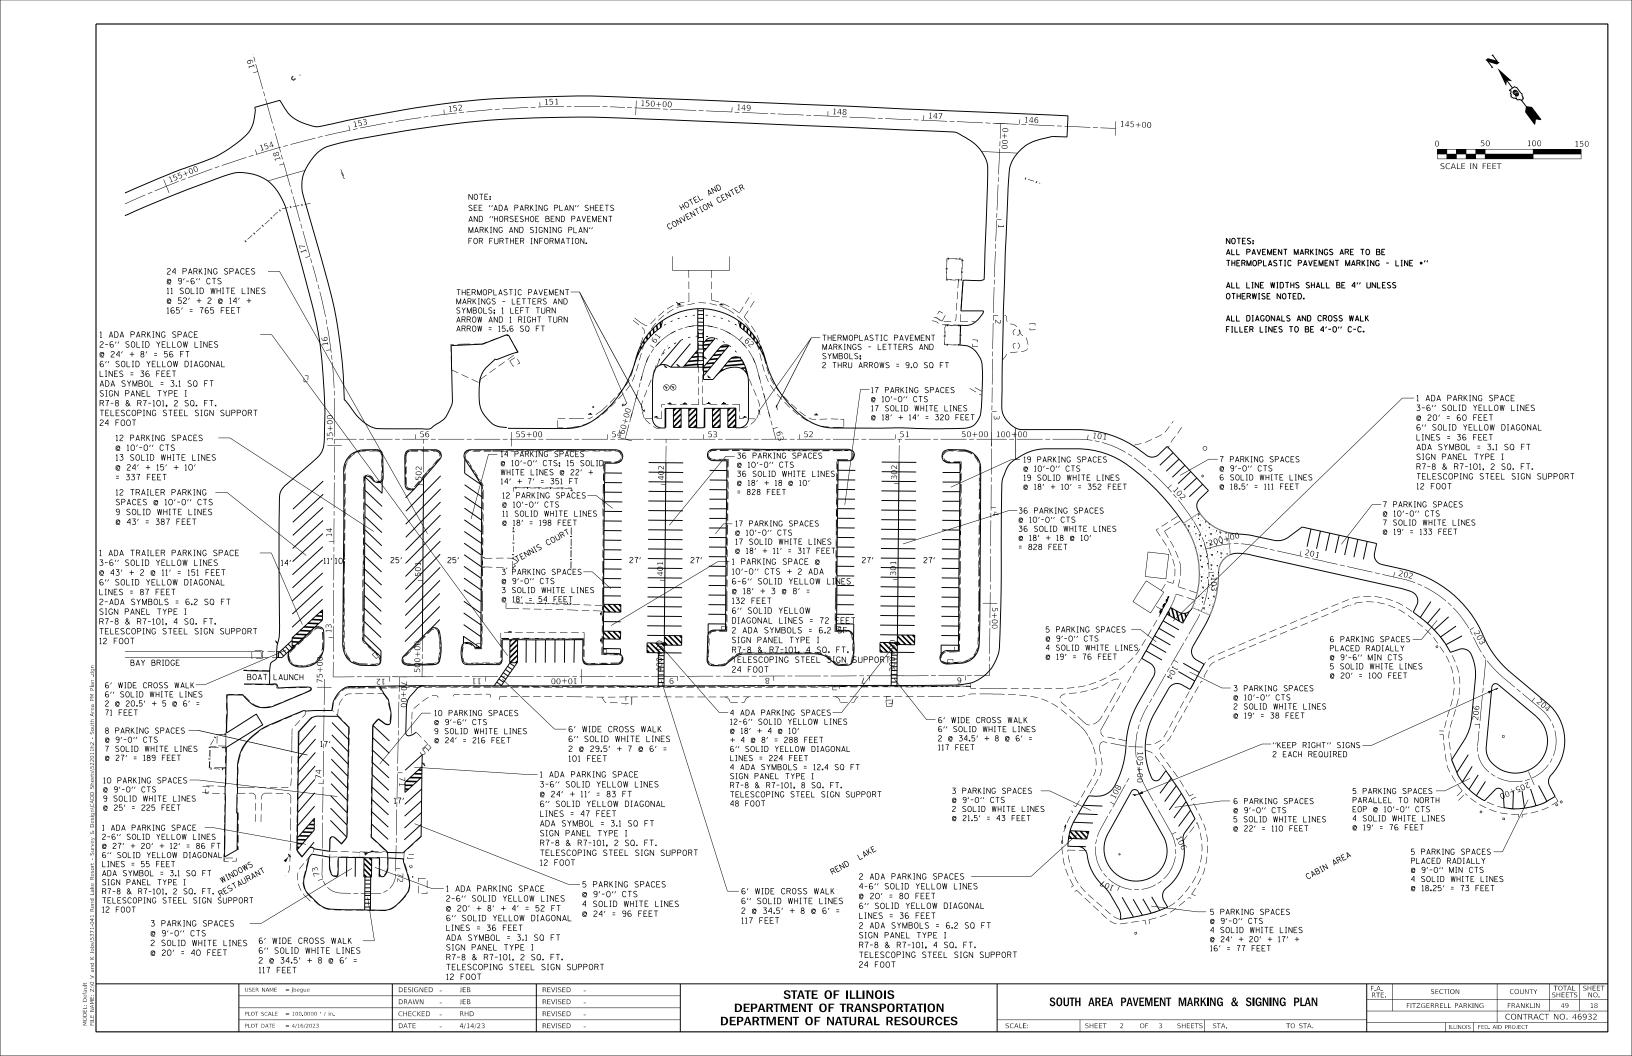


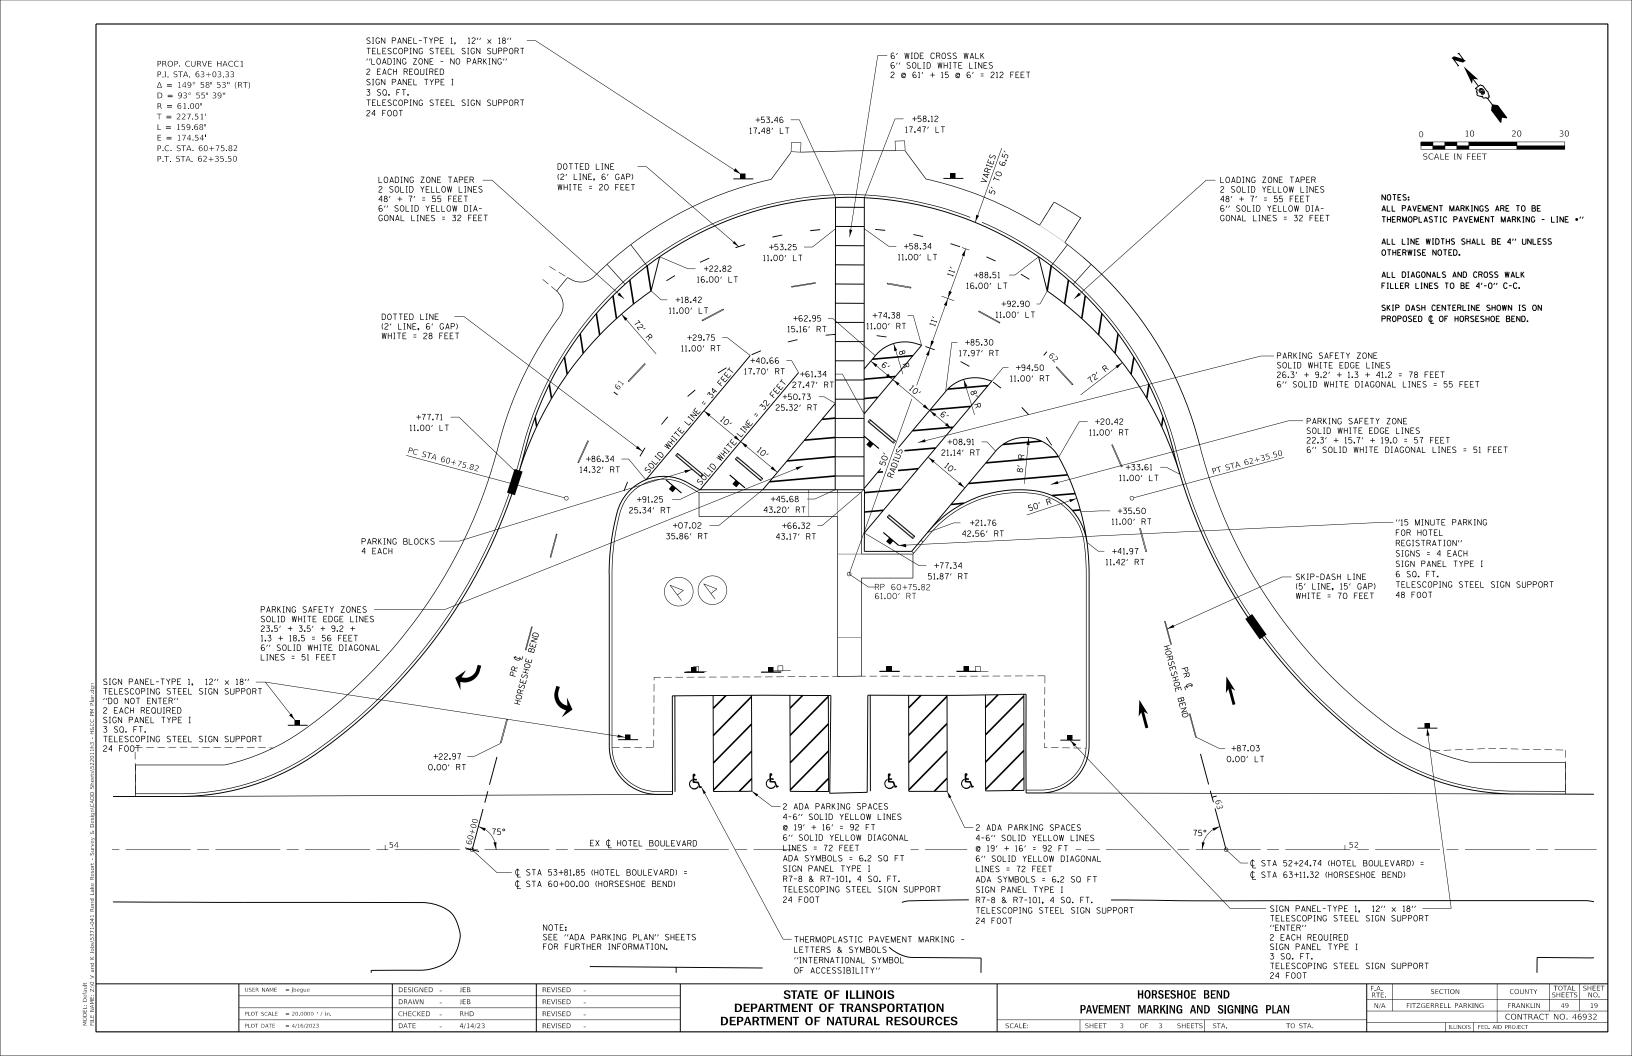


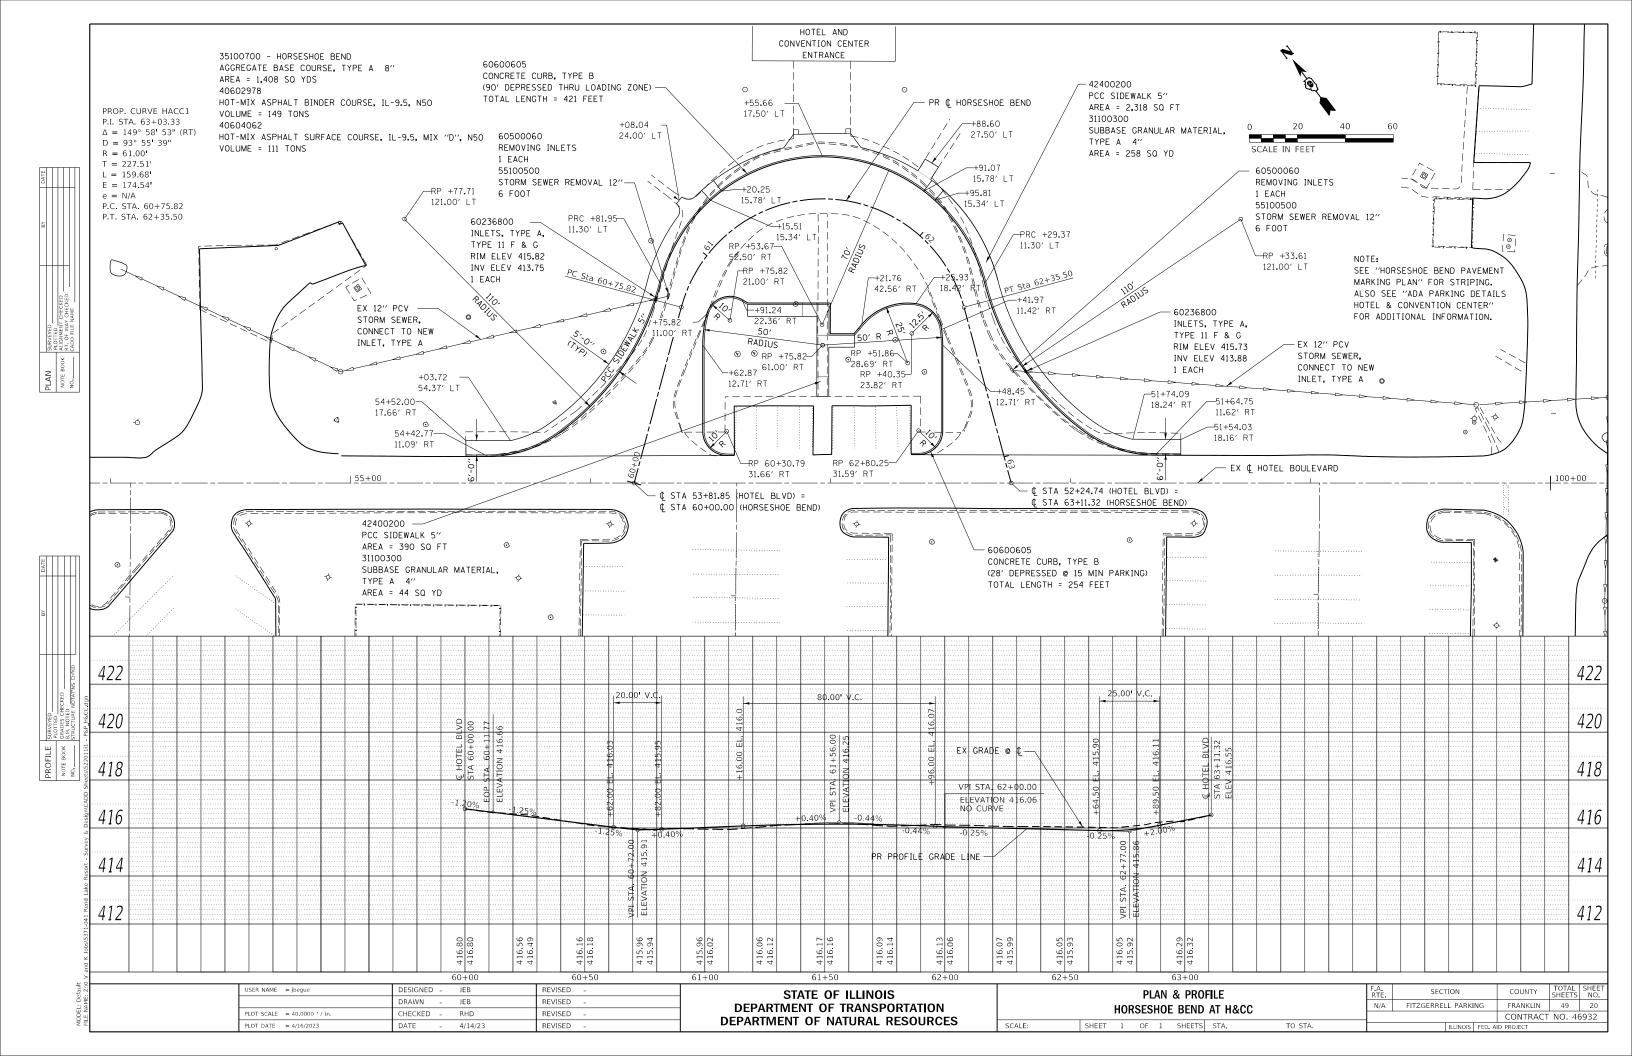


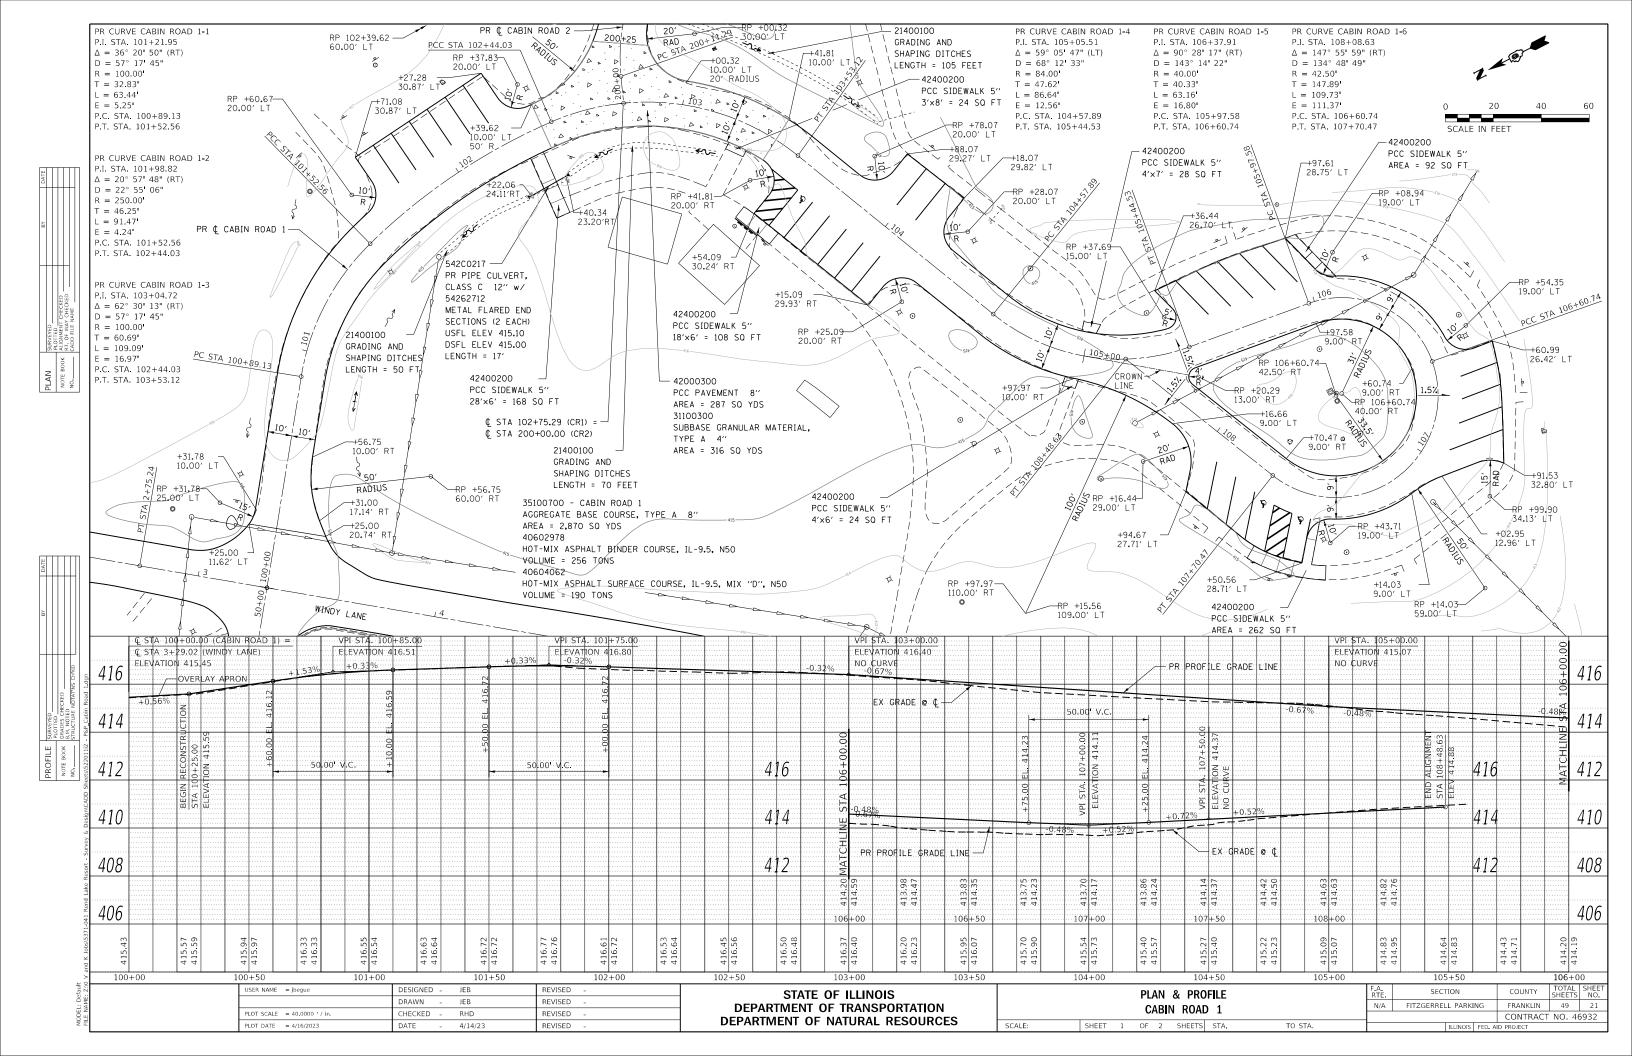


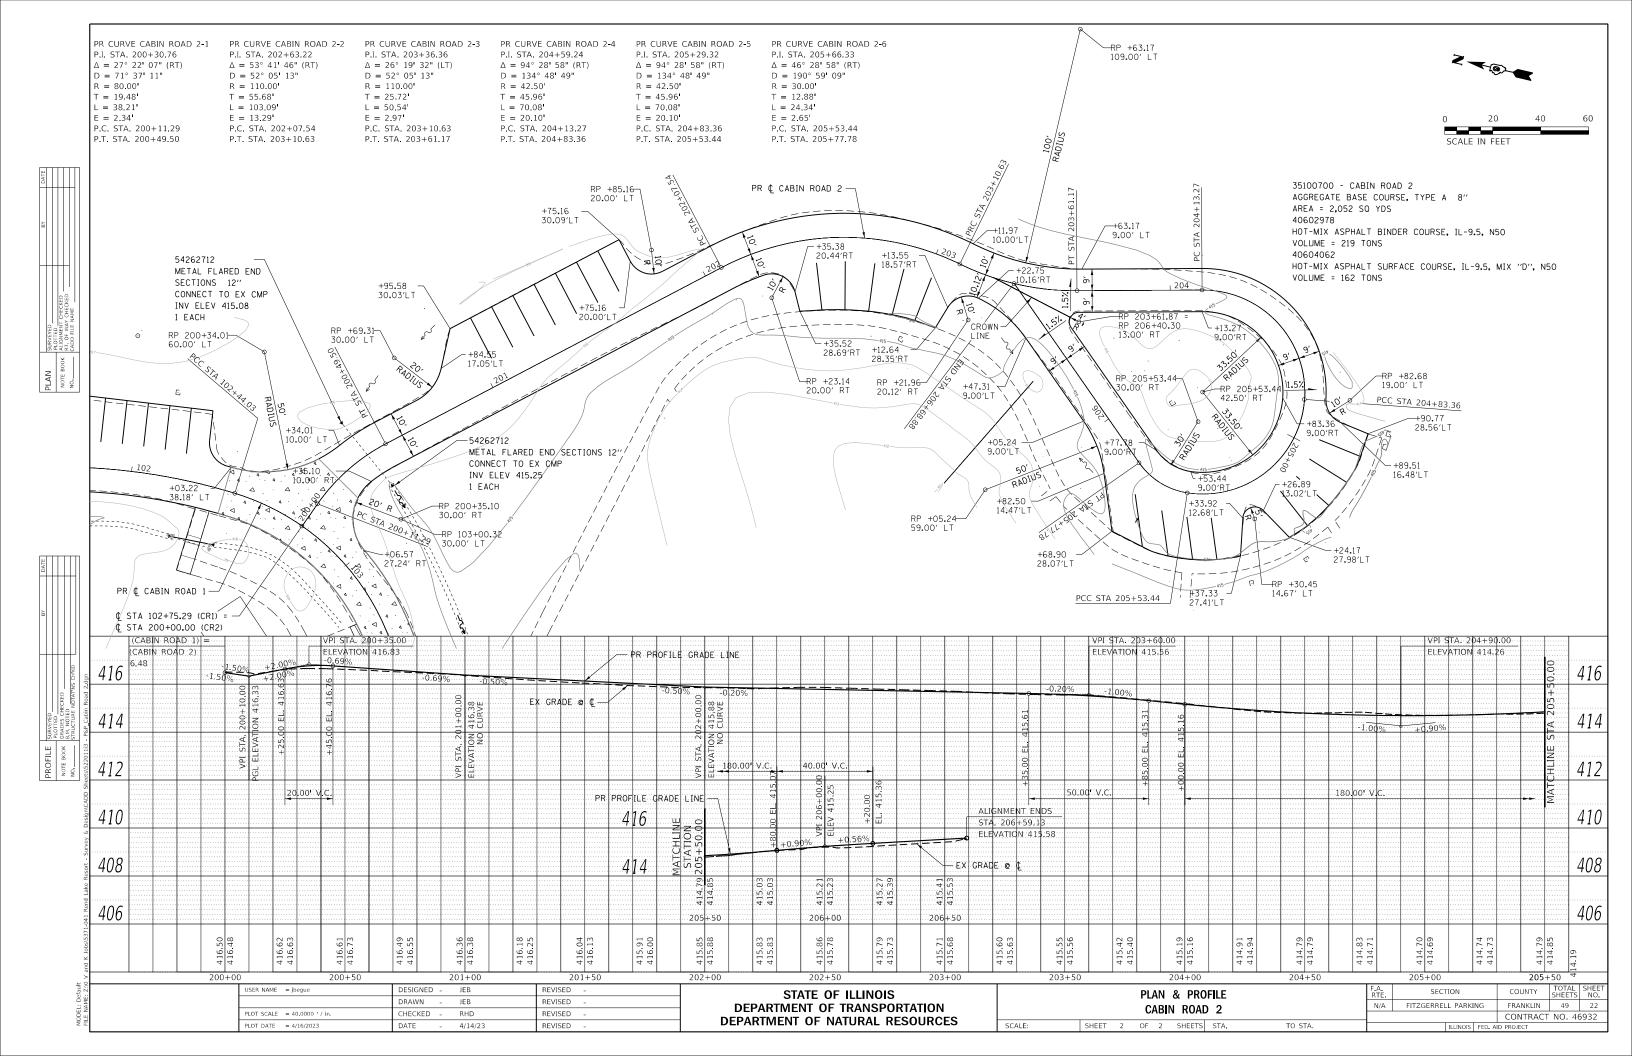


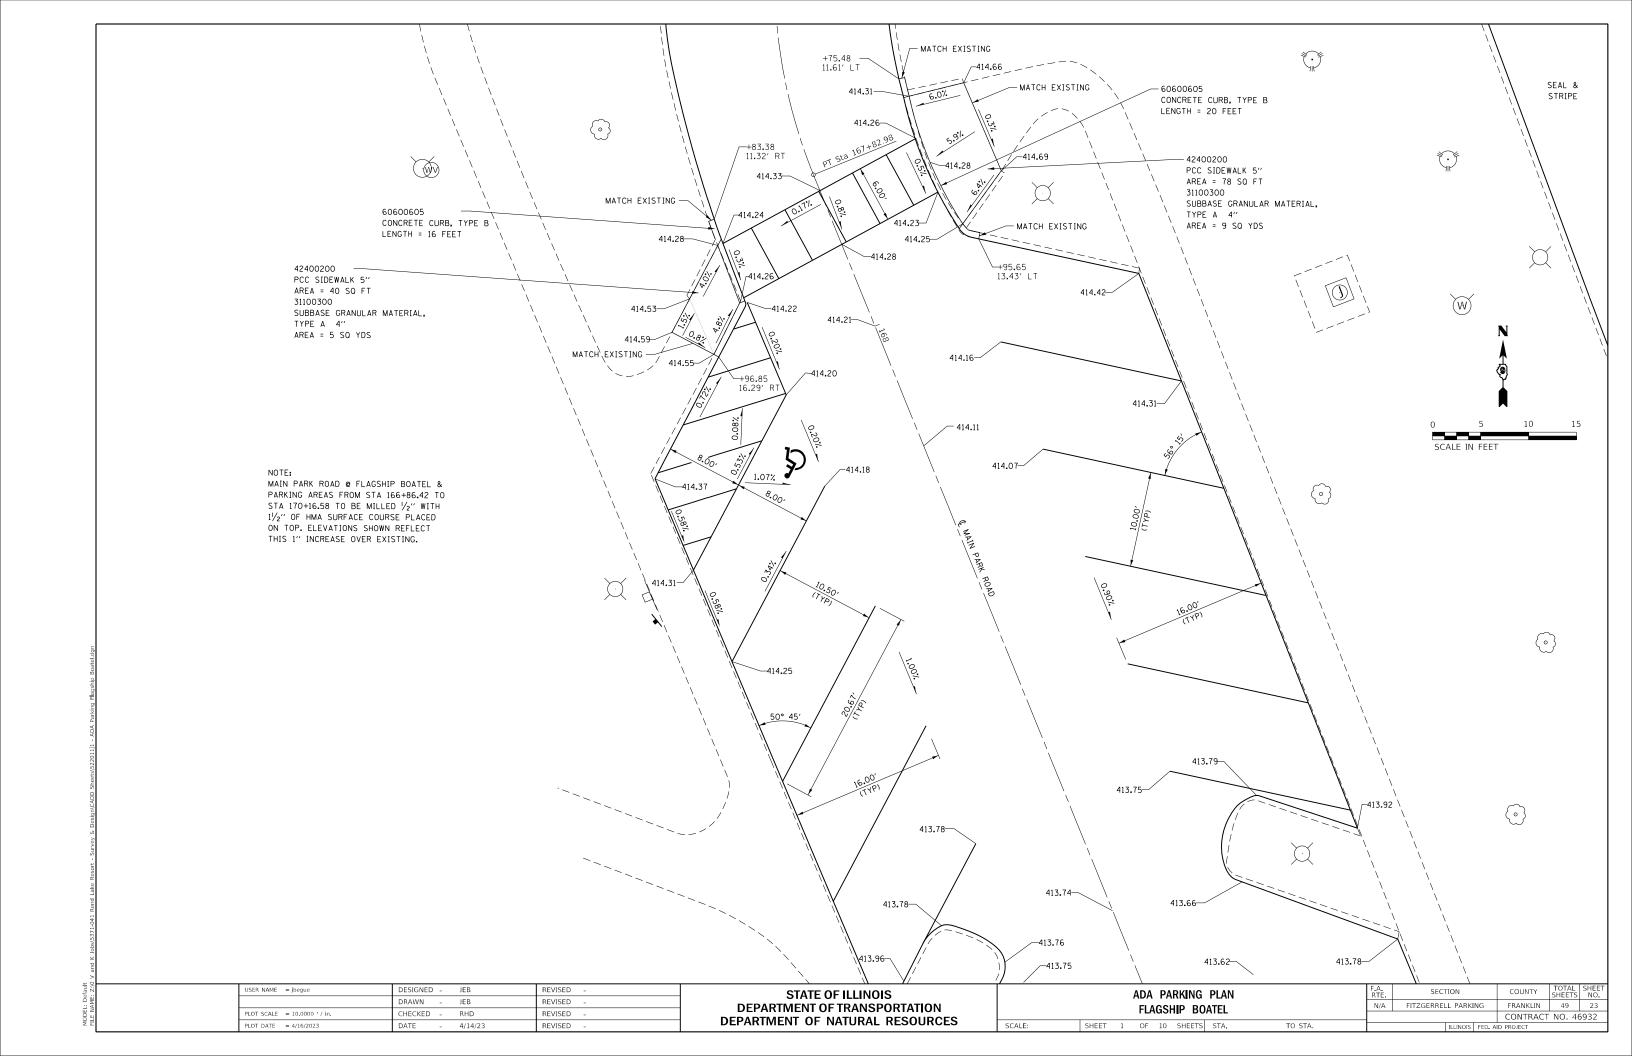


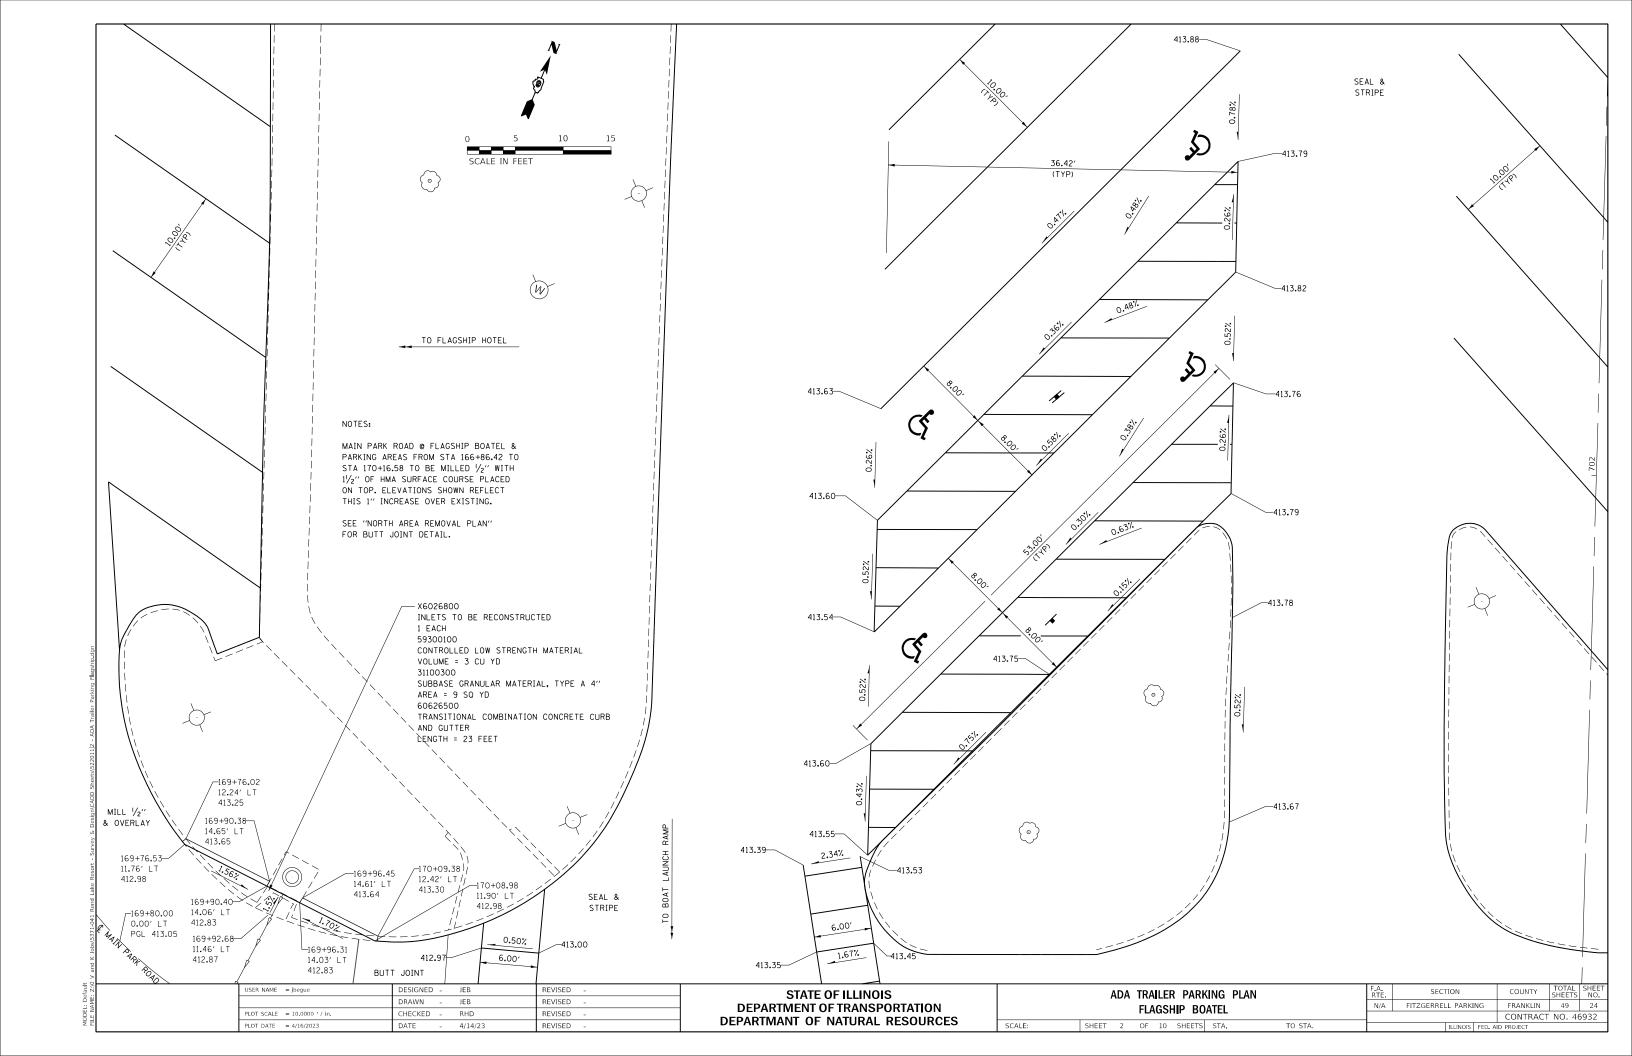


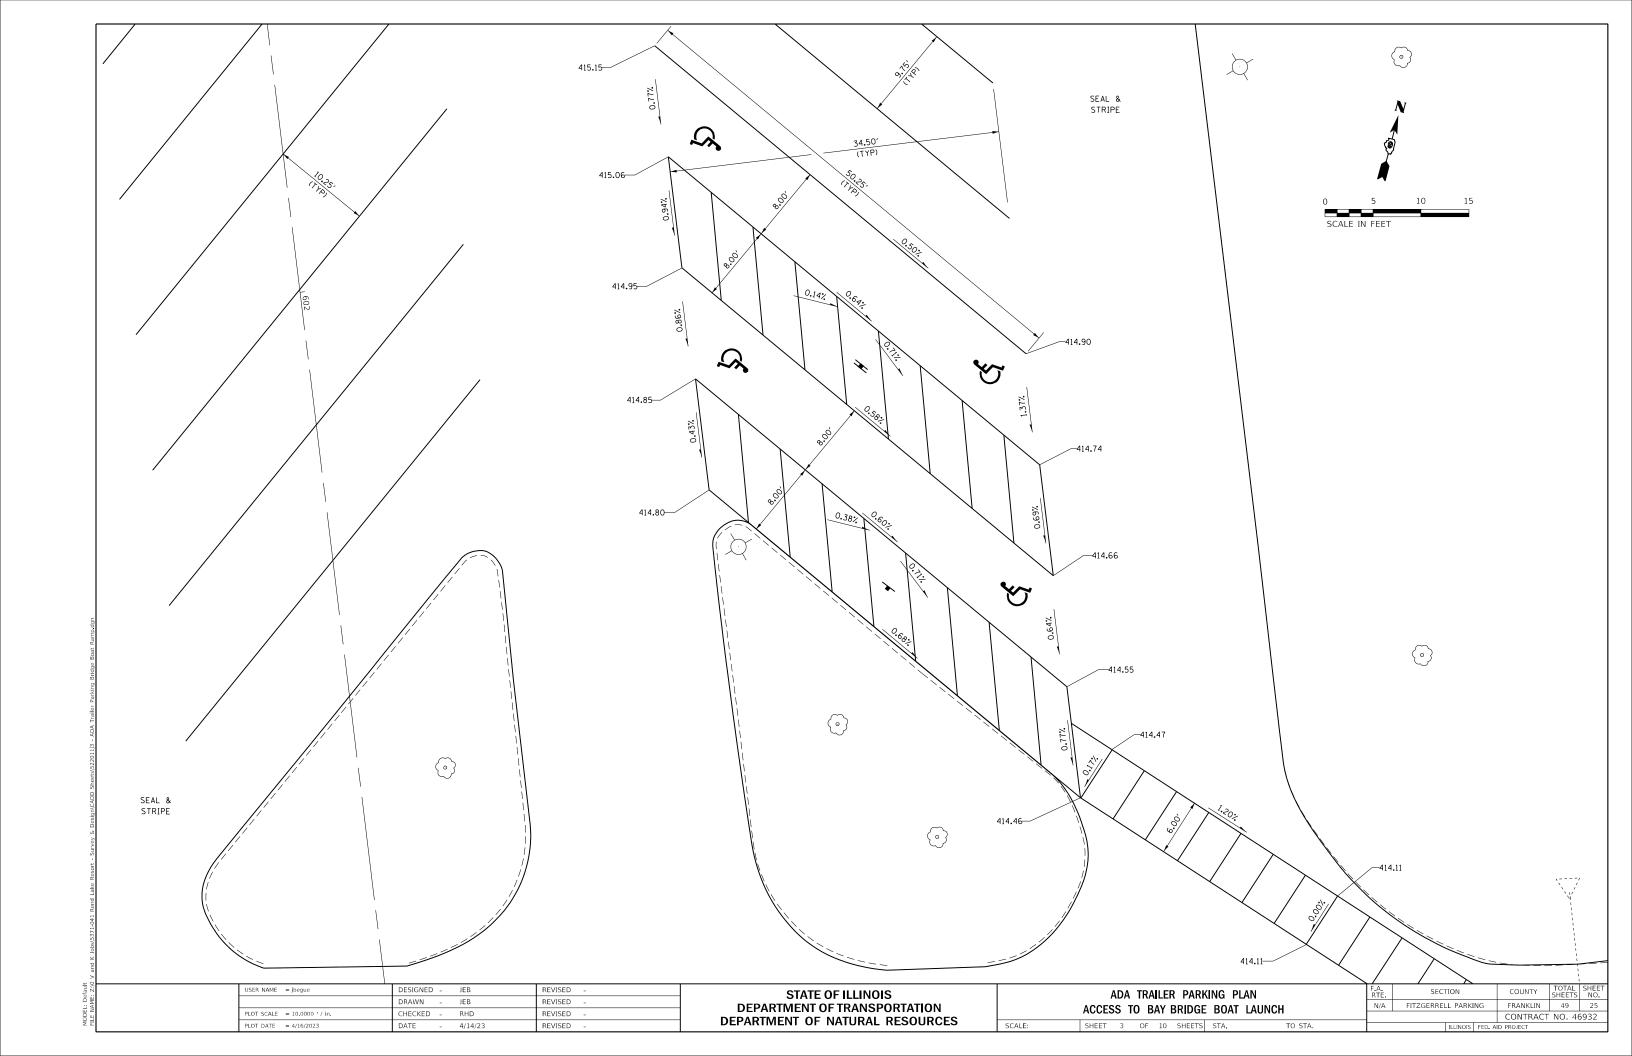


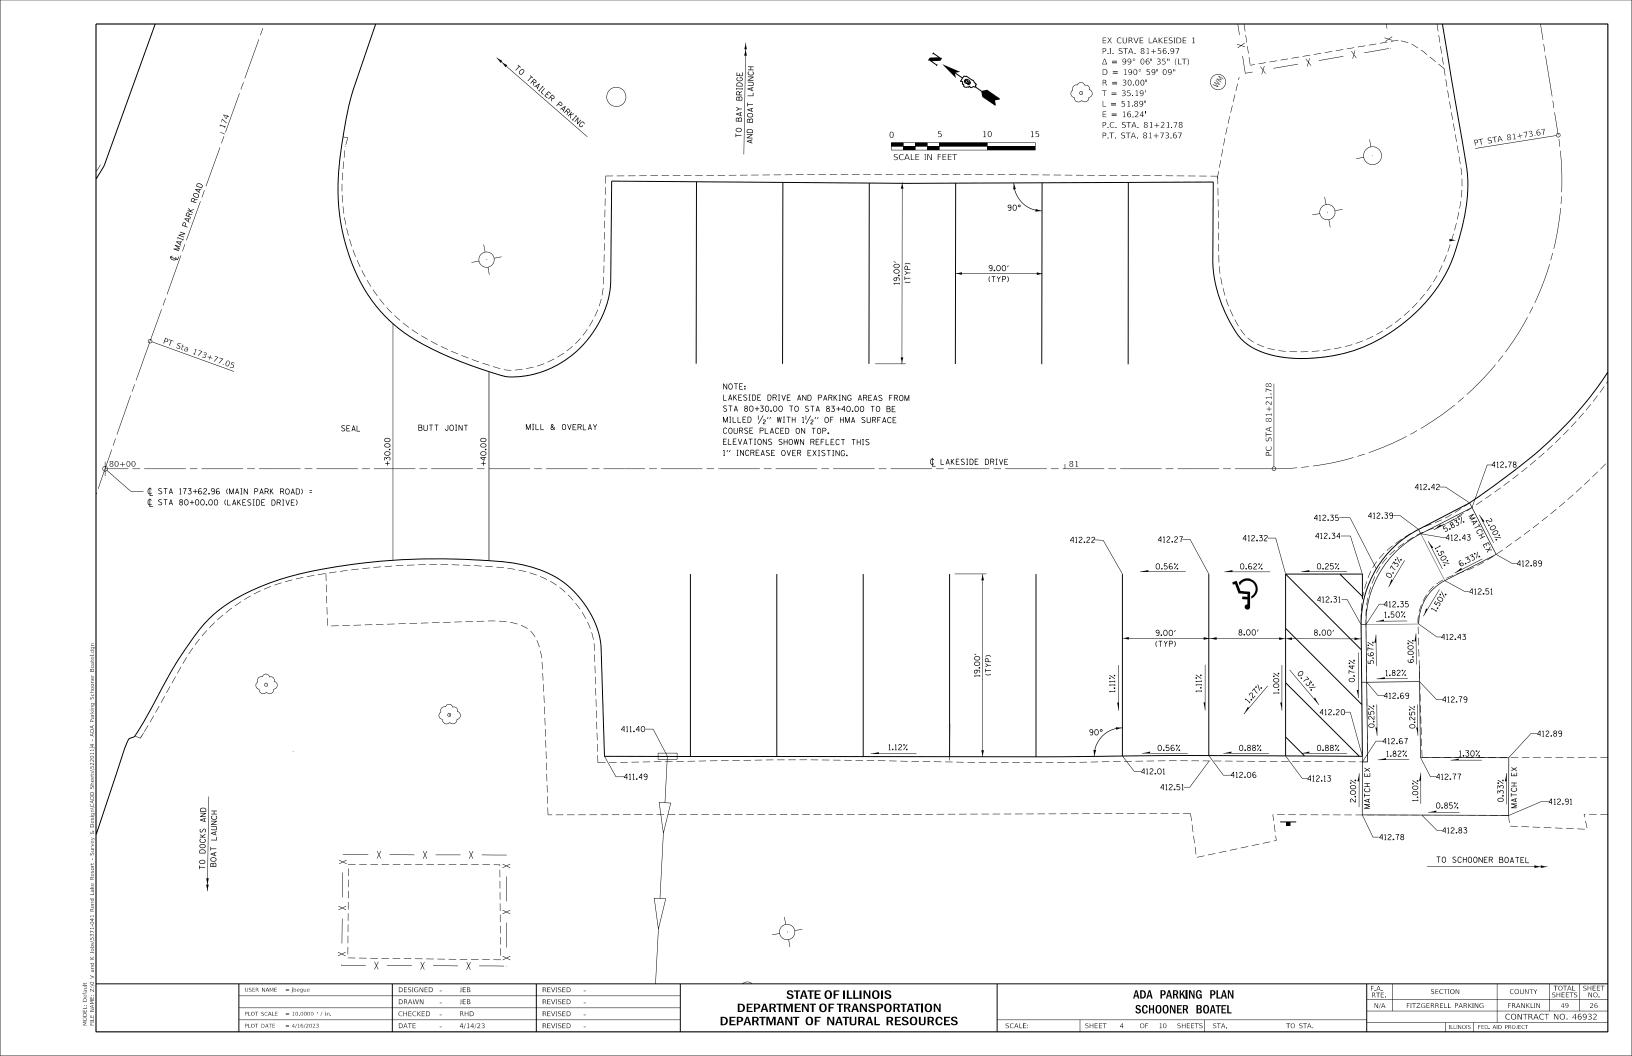


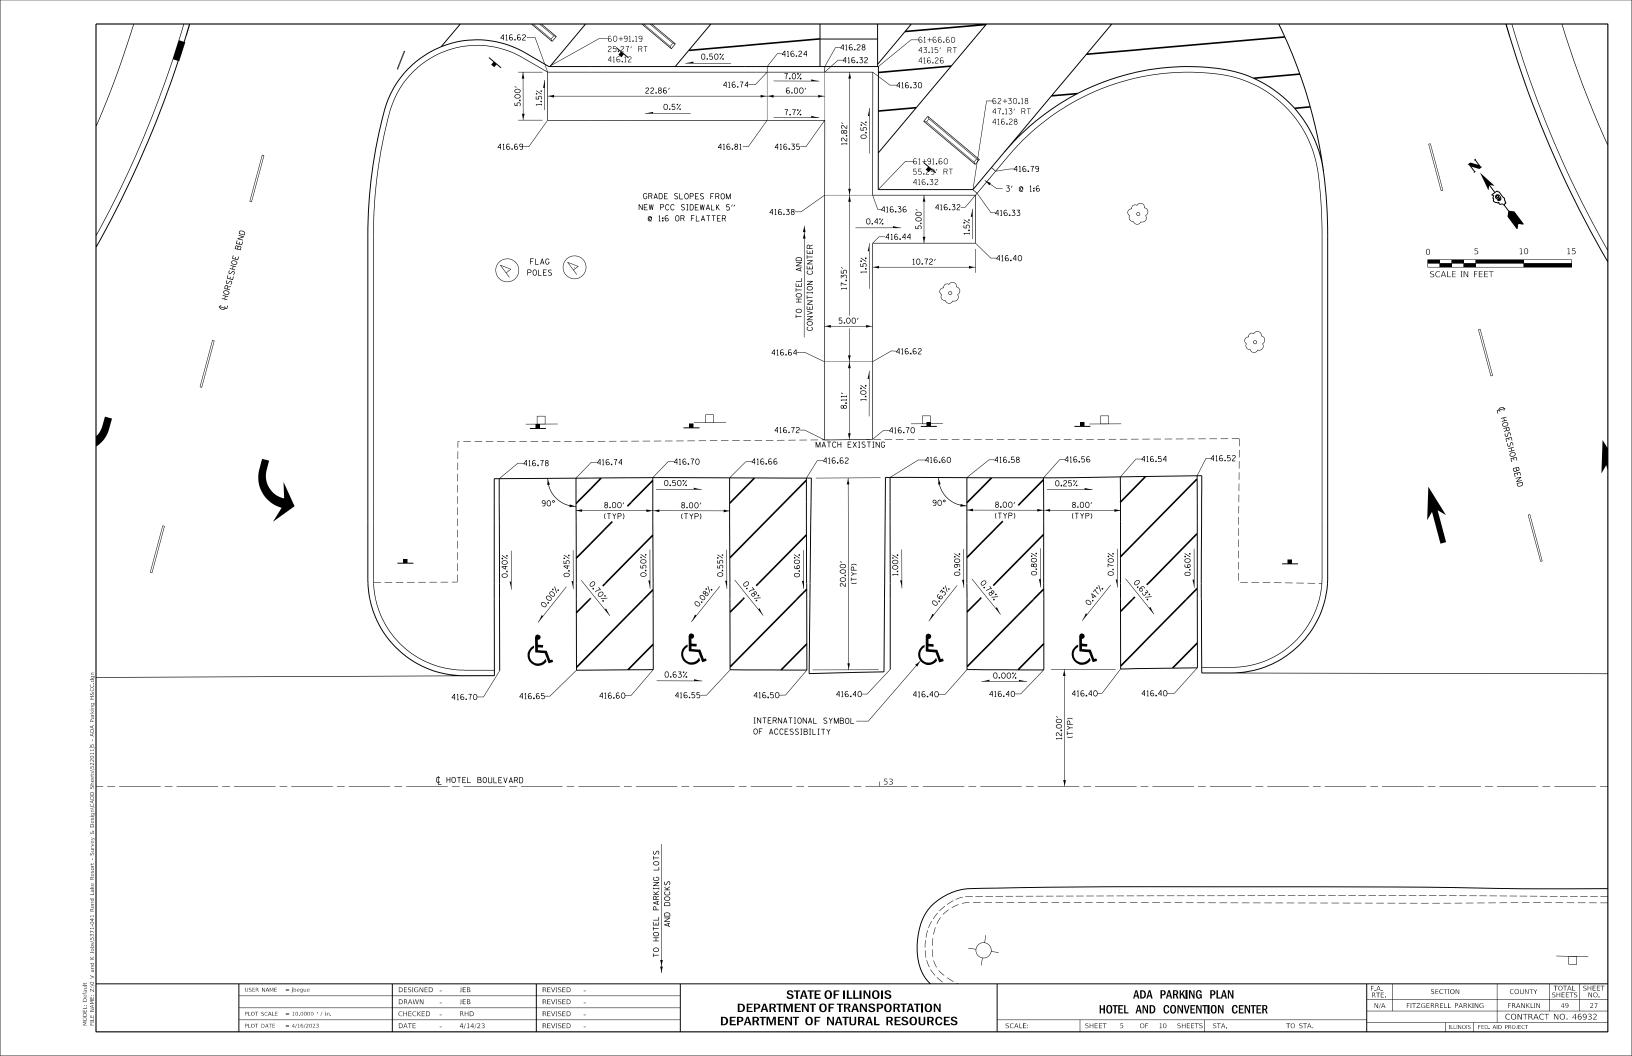


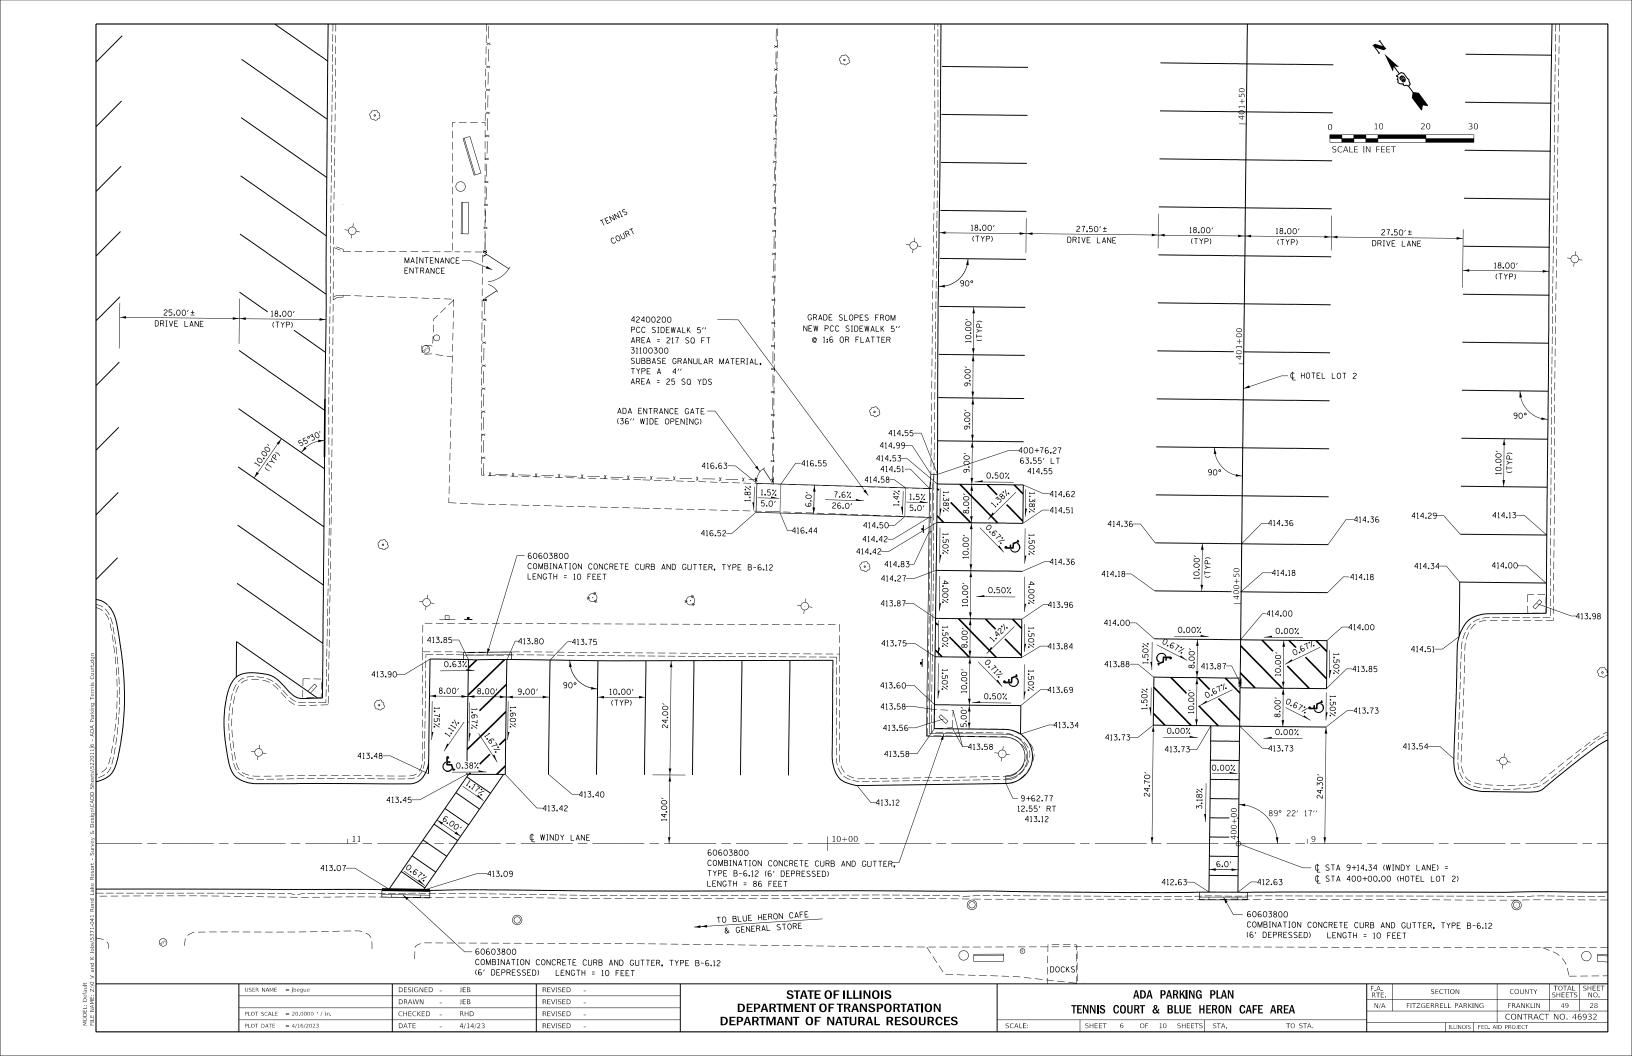


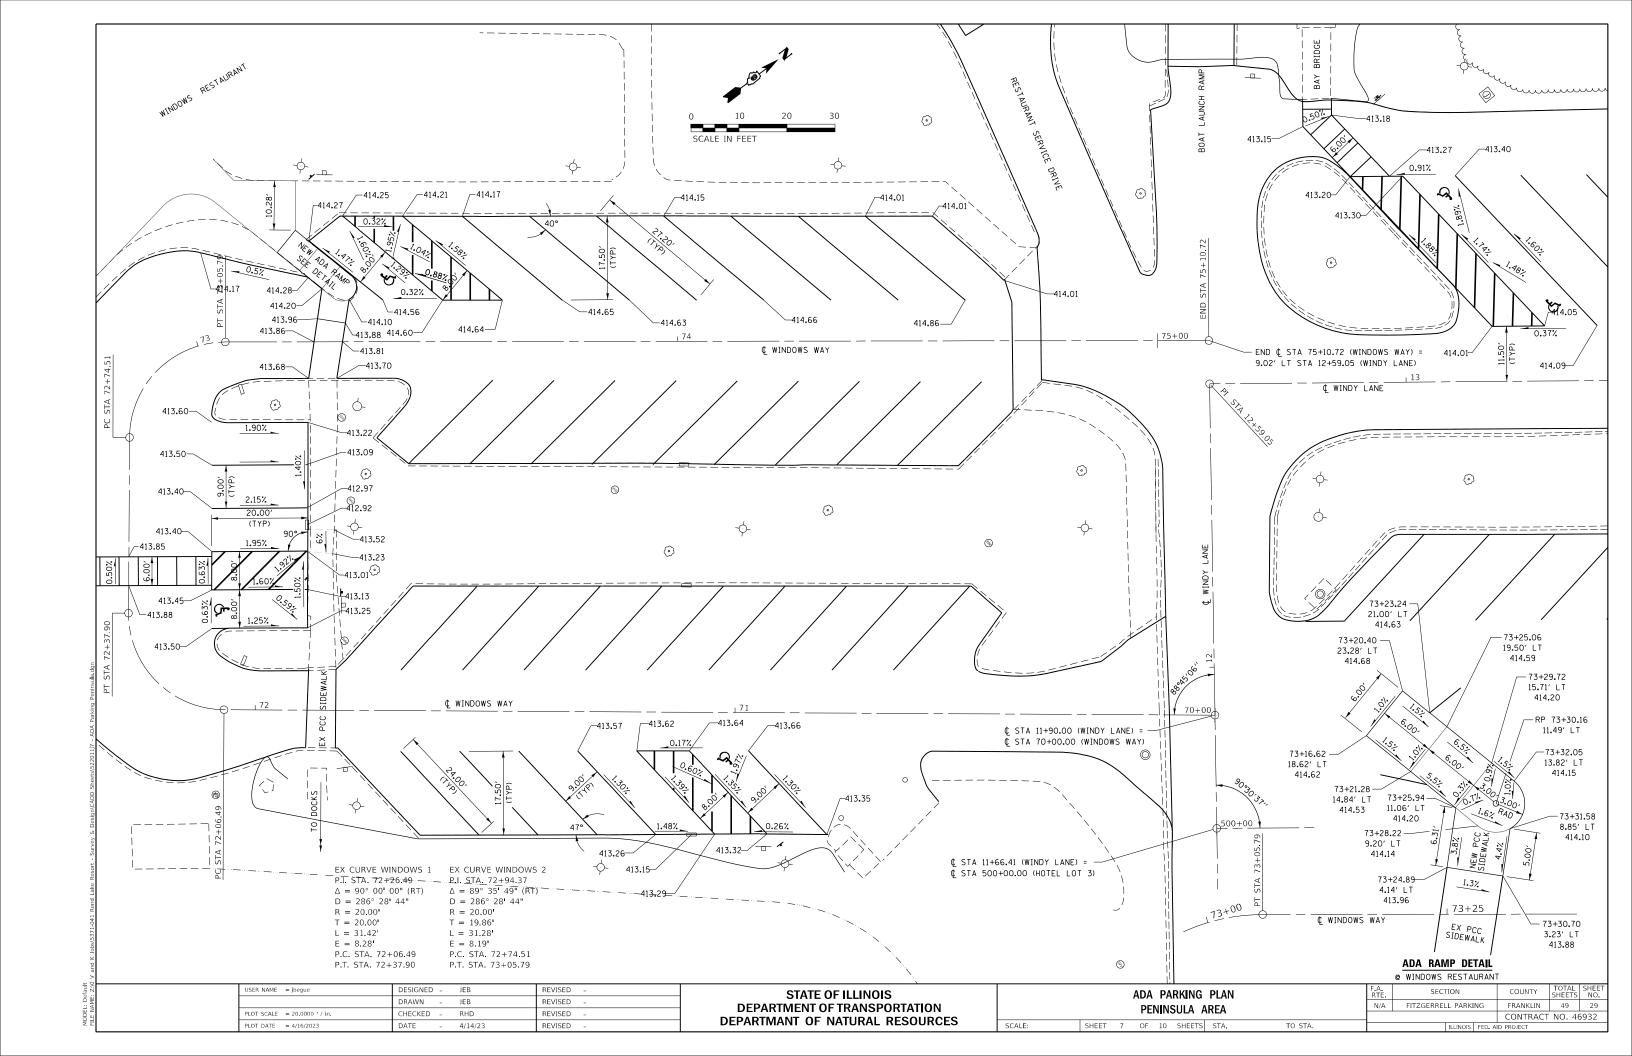


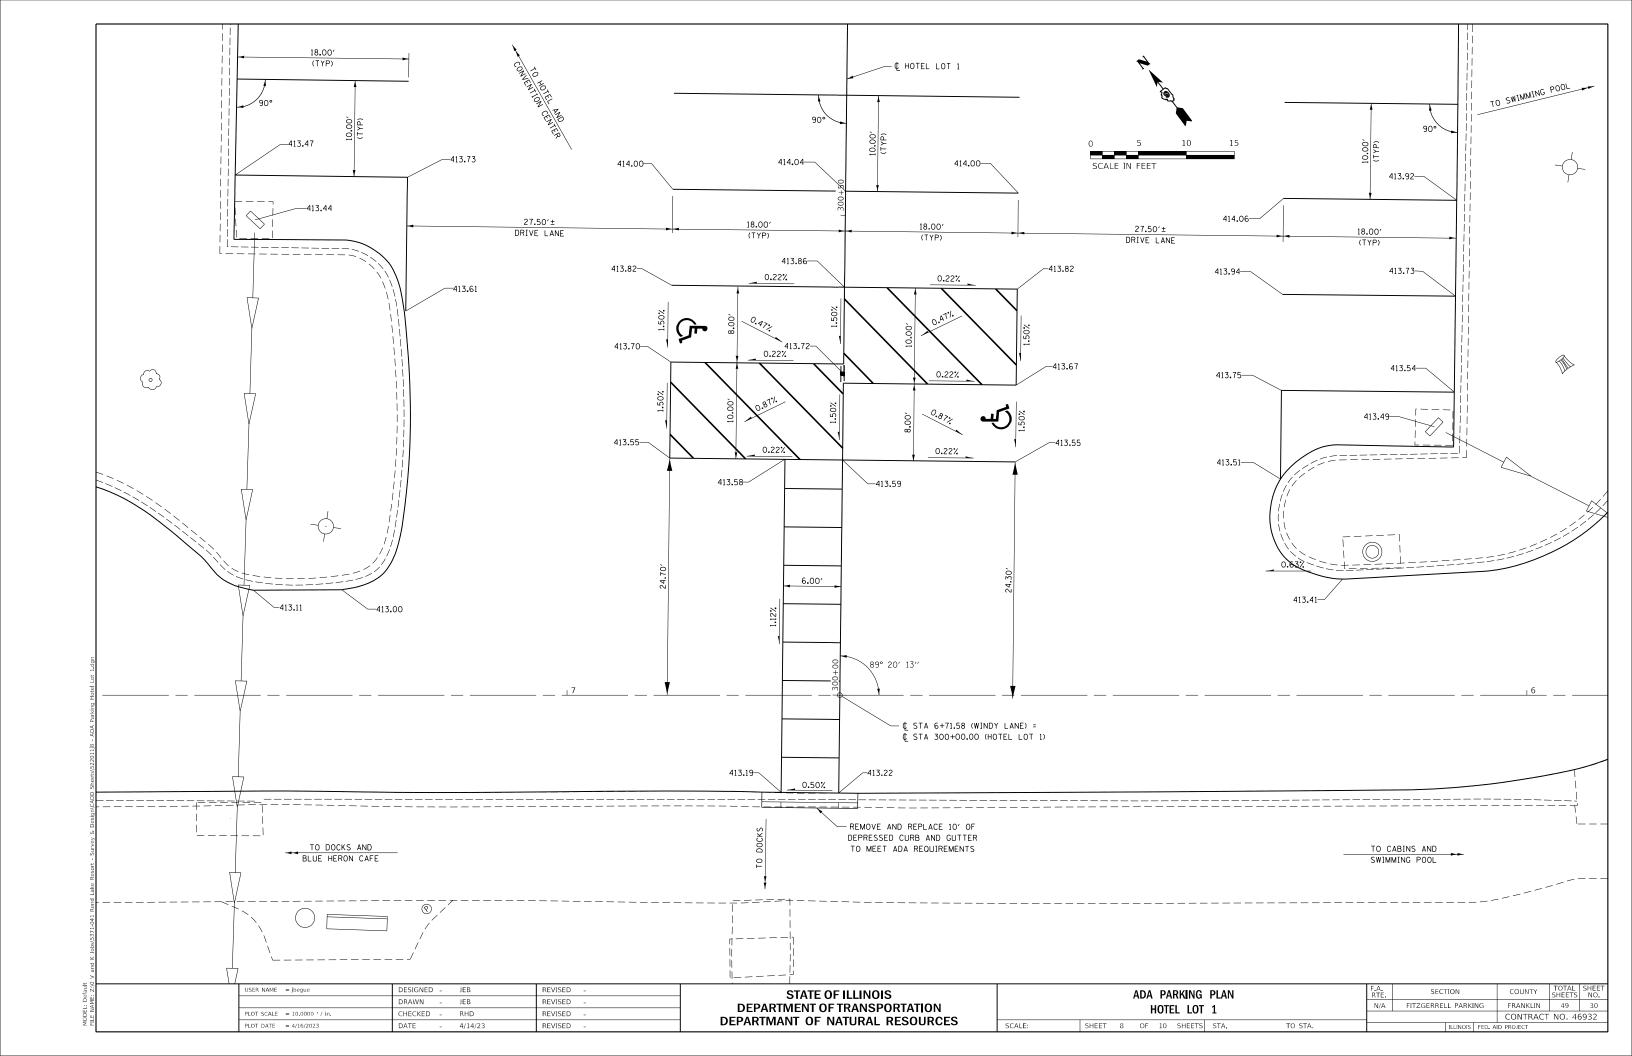


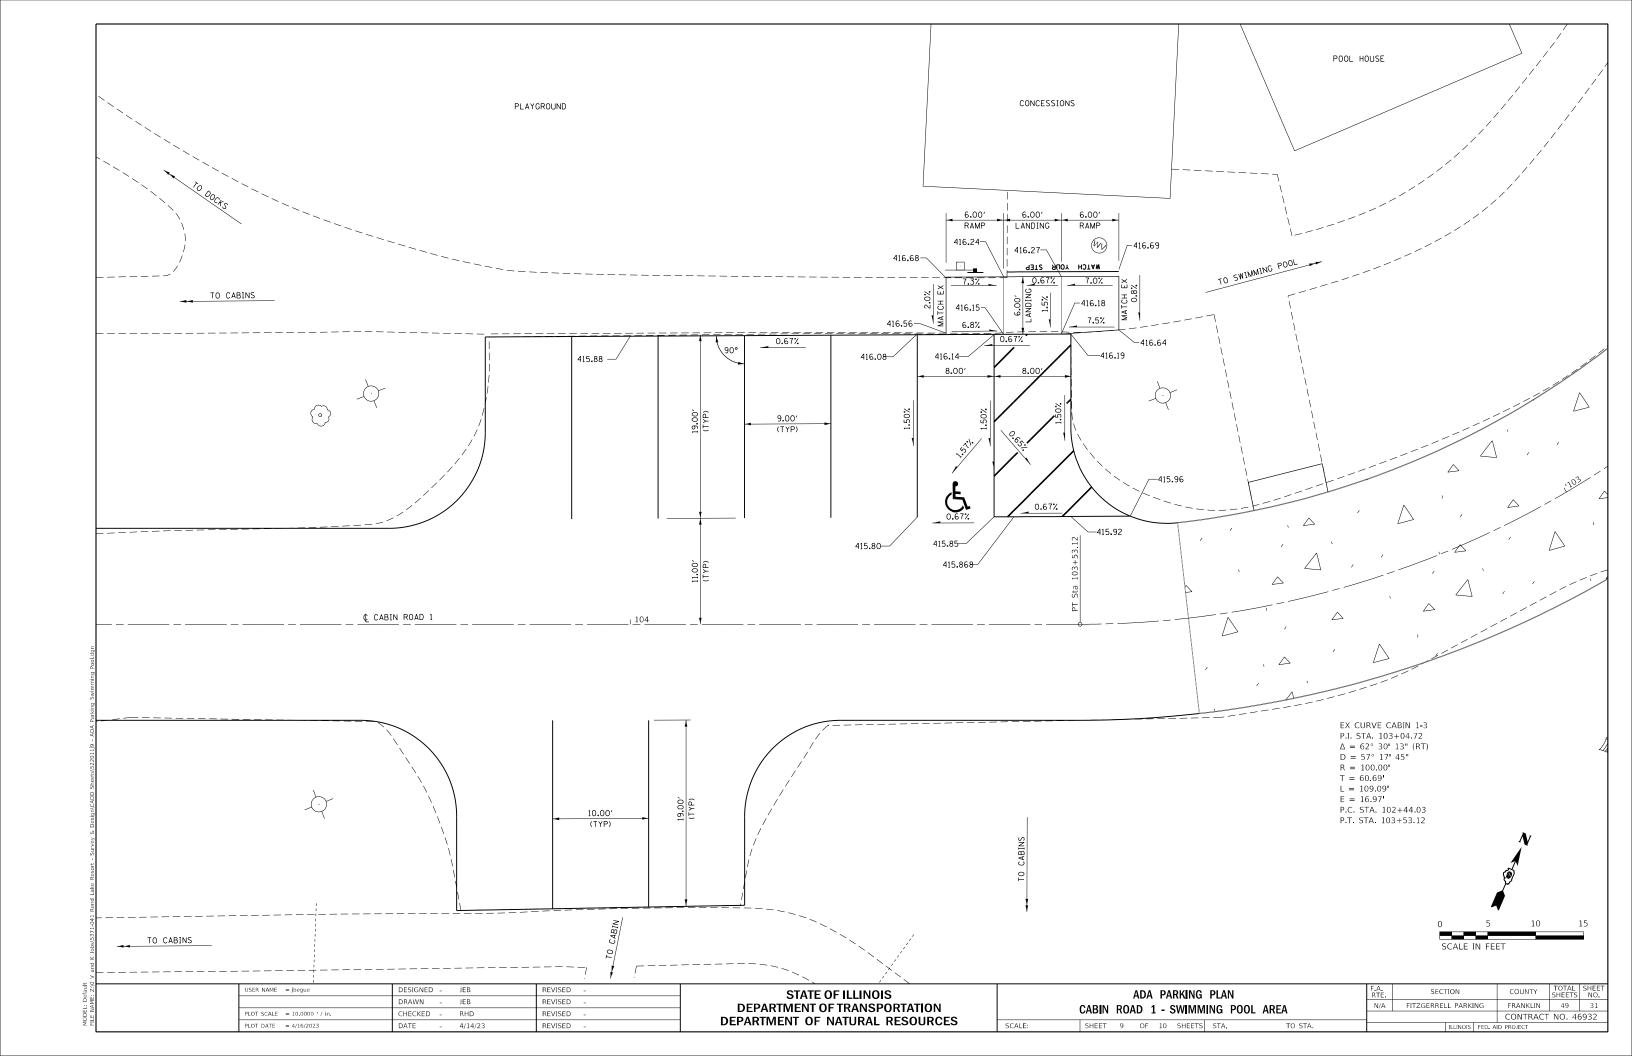


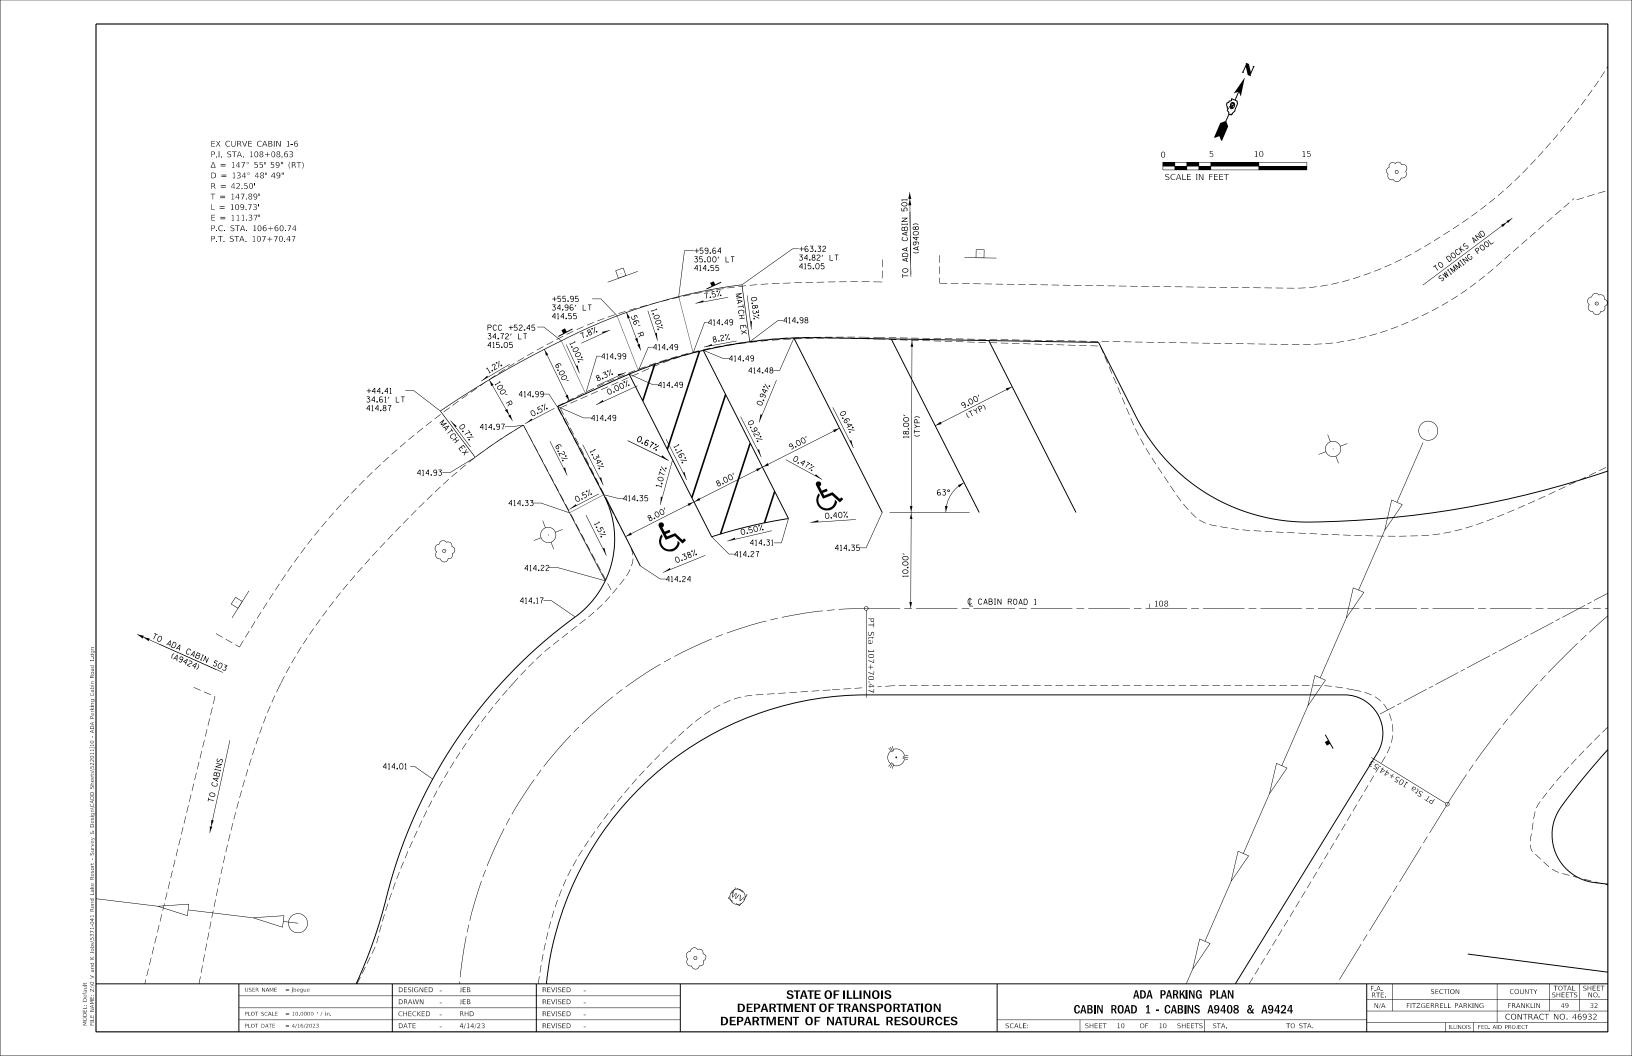


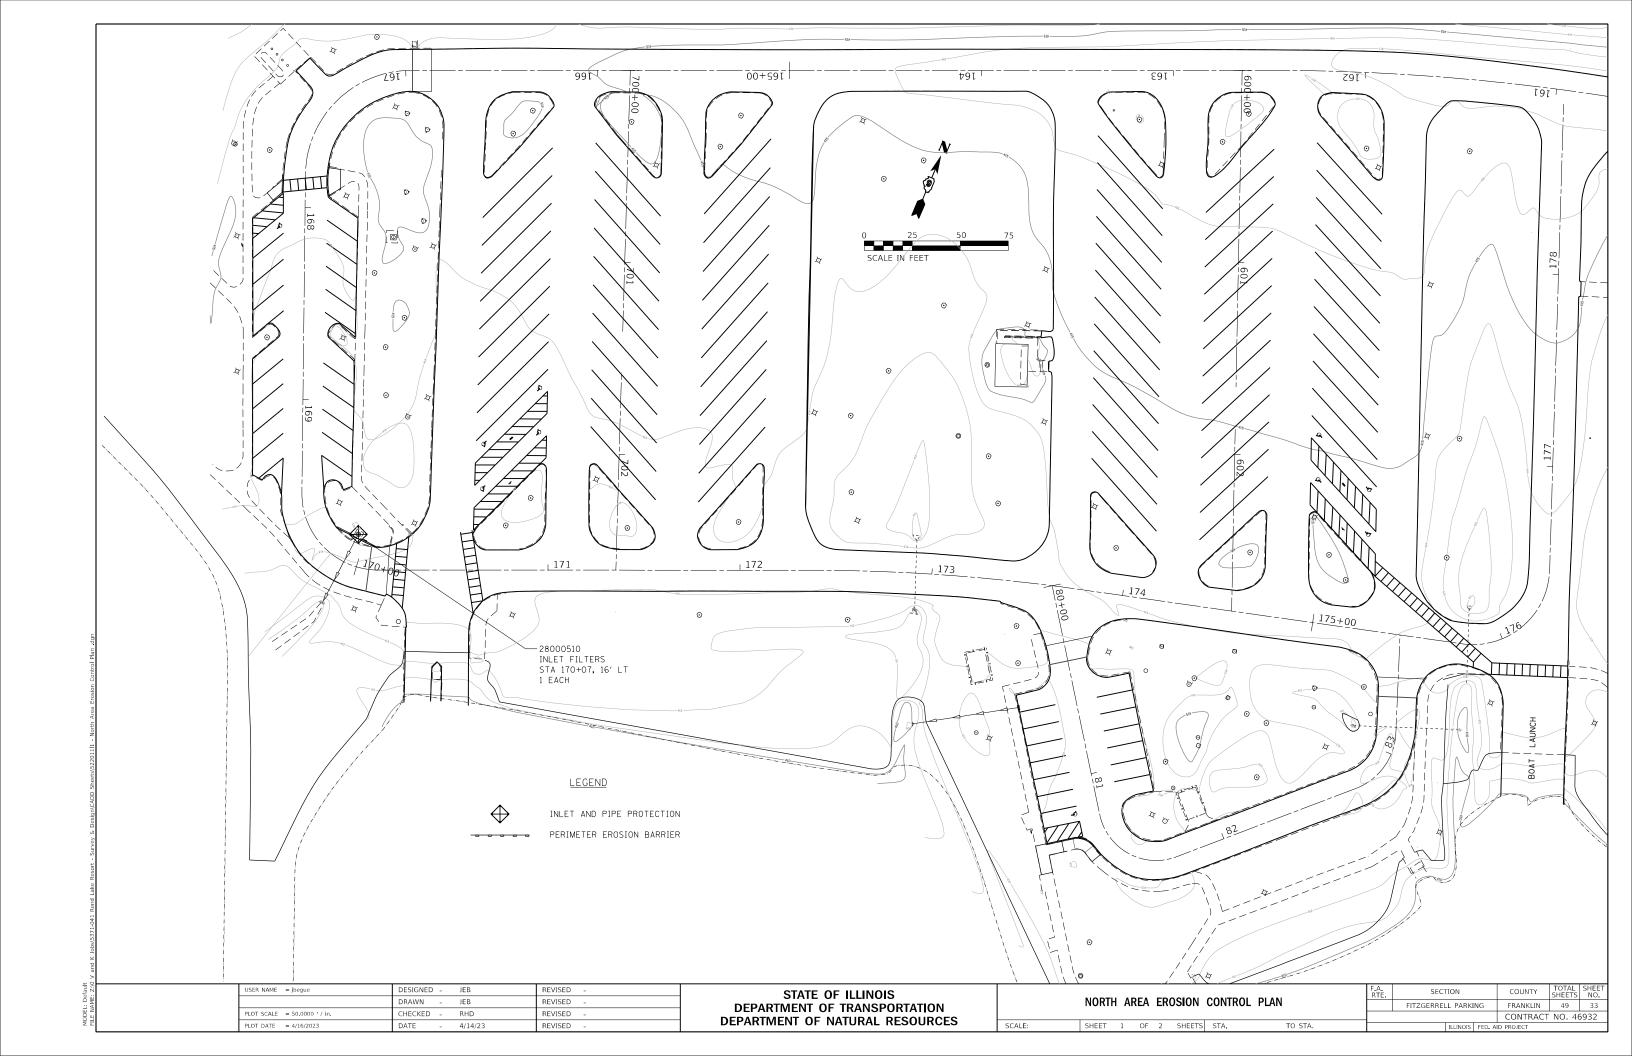

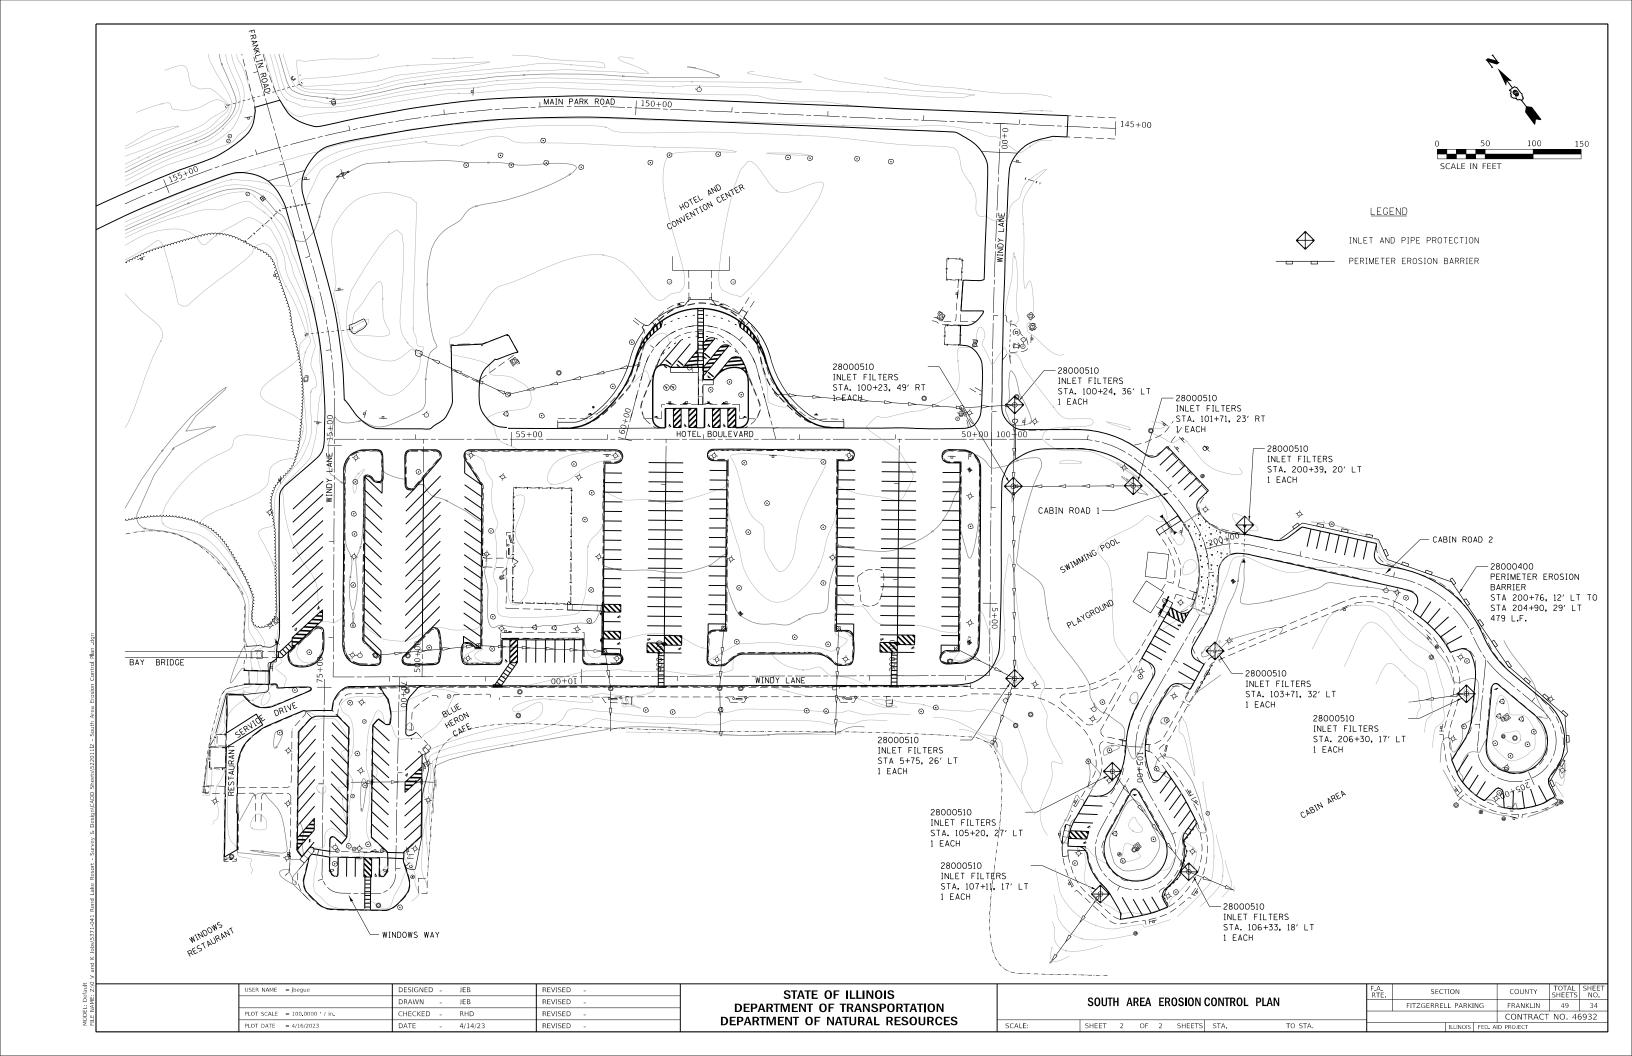

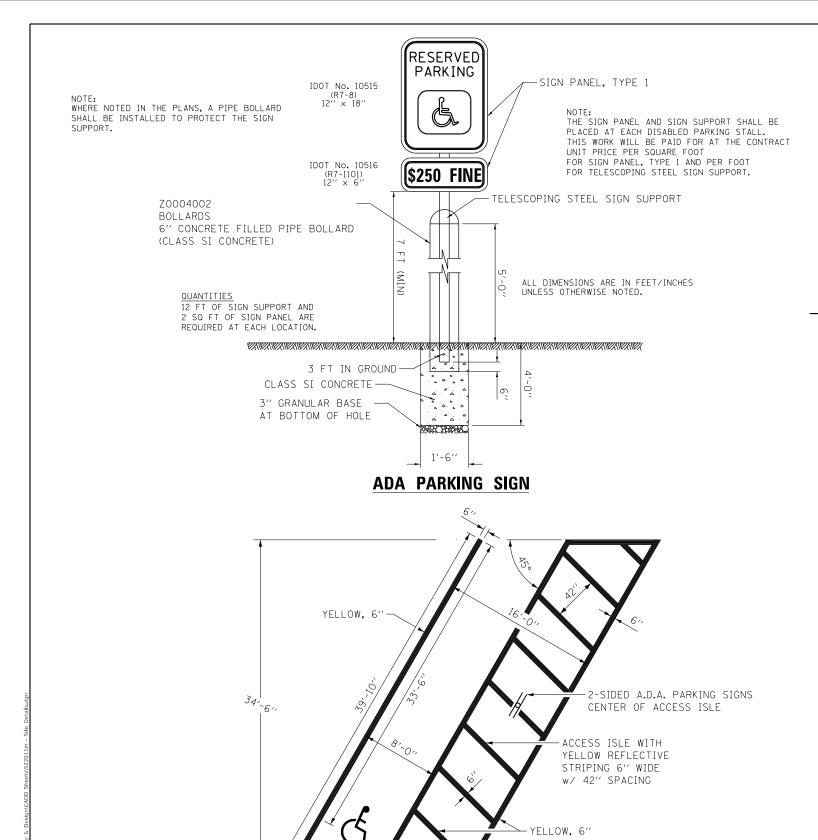

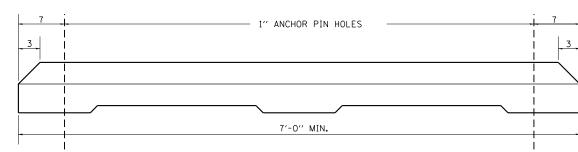

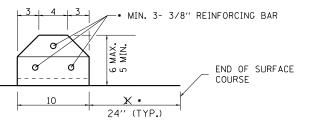

* OR AS DIRECTED BY THE ENGINEER.

GENERAL NOTES


CLASS SI CONCRETE SHALL BE USED THROUGHOUT.

ANCHOR PINS SHALL BE 3/4 DIAMETER, 36 LONG.

THE COST OF THE MATERIAL, LABOR AND EQUIPMENT NECESSARY TO INSTALL THE PARKING BLOCKS WITH ANCHOR PINS SHALL BE INCLUDED IN THE CONTRACT UNIT PRICE PER EACH FOR PARKING BLOCKS.

ALL DIMENSIONS ARE IN INCHES UNLESS OTHERWISE NOTED.

PARKING BLOCKS

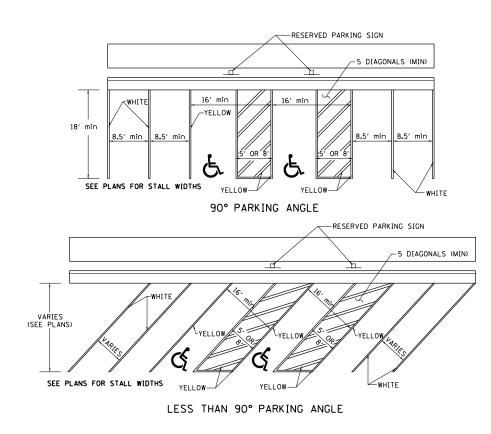

ADA PARKING STALL STRIPING

45°	A.D.A.	PARKING	STRIPING,	YELLOW	(6")
		NOT	TO SCALE		

USER NAME = Joegue	DESIGNED	-	JEB	KEVISED -
	DRAWN	-	SDK	REVISED -
PLOT SCALE = 40.0000 / in.	CHECKED	-	RHD	REVISED -
PLOT DATE = 4/16/2023	DATE	-	4/14/23	REVISED -

YELLOW REFLECTIVE TPM A.D.A. SYMBOL (PER A.D.A. SPECIFICATIONS) (SEE HIGHWAY STANDARD No. 780001)

STATE OF ILLINOIS
DEPARTMENT OF TRANSPORTATION
DEPARTMENT OF NATURAL RESOURCES

					DETAI			F.A. RTE.	SECT	ΓΙΟΝ		COUNTY	TOTAL SHEETS	SHEET NO.
	SITE DETAILS								FITZGERRELL PARKING		FRANKLIN	49	35	
									CONTRACT NO. 46932					932
ALE:	SHEET	1	OF	1	SHEETS	STA.	TO STA.	ILLINOIS FED. AID F		D PROJECT	Т			

LIGHTING SUMMARY OF QUANTITIES

S.P.	PAY ITEM	DESCRIPTION	UNIT	QUANTITY
	80400100	ELECTRIC SERVICE INSTALLATION	EACH	2
	81028370	UNDERGROUND CONDUIT, PVC, 3" DIA.	FOOT	1,565
	81603037	UNIT DUCT, 600V, 2-1C NO.6, 1/C NO.6 GROUND, (XLP-TYPE USE), 1 1/4" DIA. POLYETHYLENE	EACH	11,305
*	82110006	LUMINAIRE, LED, ROADWAY, OUTPUT DESIGNATION F	EACH	127
	82500370	LIGHTING CONTROLLER, BASE MOUNTED, 240VOLT, 200AMP	EACH	2
	83600200	LIGHT POLE FOUNDATION, 24" DIAMETER	FOOT	465
	84200600	REMOVAL OF LIGHTING UNIT, NO SALVAGE	EACH	92
	84200804	REMOVAL OF POLE FOUNDATION	EACH	92
	84500120	REMOVAL OF ELECTRIC SERVICE INSTALLATION	EACH	1
	84500130	REMOVAL OF LIGHTING CONTROLLER FOUNDATION	EACH	1
	85400110	REMOVAL OF LIGHTING CONTROLLER	EACH	1
*	X8302393	LIGHT POLE, ALUMINUM 25 FT M.H., 4 FT. ARM (SPECIAL)	EACH	63
*	X8302395	LIGHT POLE, ALUMINUM 25 FT M.H., 4 FT. ARM,TWIN (SPECIAL)	EACH	32
*	X8200002	FLOOD LIGHTING UNIT	EACH	5
*	X8360110	LIGHT POLE FOUNDATION, SPECIAL	FOOT	16
*		REMOVE AND REATTACH EXISTING RECEPTACLE OUTLET APPARATUS ONTO LIGHT POLE	EACH	13

S.P. COLUMN

* SPECIAL PROVISION

HIGHWAY STANDARDS

821101-02 LUMINAIRE WIRING IN POLE 825021-04 LIGHTING CONTROLLER BASE MOUNTED, 240V 830001-03 LIGHT POLE ALUMINUM MAST ARM 836001-04 LIGHT POLE FOUNDATION

LIGHTING INDEX OF SHEETS

- LIGHTING INDEX OF SHEETS, STANDARDS LIST, AND LIGHTING SUMMARY OF QUANTITIES
 LIGHTING PLANS
 LUMINAIRE PERFORMANCE TABLE
 WIRING DIAGRAMS


- 6 FLOOD LIGHT DETAIL


USER NAME = bbarr	DESIGNED -	REVISED -
	DRAWN -	REVISED -
PLOT SCALE = 100.0000 ' / in.	CHECKED -	REVISED -
PLOT DATE = 3/24/2023	DATE -	REVISED -

STATE OF ILLINOIS **DEPARTMENT OF TRANSPORTATION**

U. SECTION COUNTY TOTAL SHEETS NO.

REND LAKE RESORT 2022 FRANKLIN 49 36 LIGHTING INDEX OF SHEETS, STANDARDS LIST, AND LIGHTING SUMMARY OF QUANTITIES CONTRACT NO. SCALE: NTS SHEET 1 OF 6 SHEETS STA.

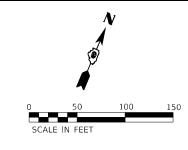

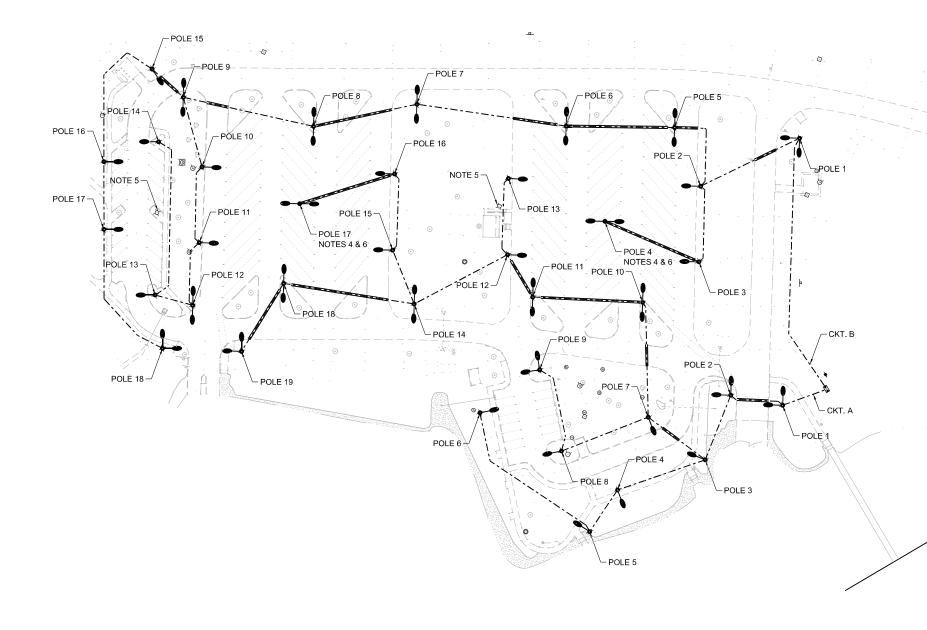

NOTES:

SCALE: 1"=50"

- 1. EXISTING LIGHTING CABLE TO BE REMOVED FROM CONDUIT. EXISTING LIGHTING CONDUIT TO BE ABANDONED IN PLACE.
- 2. EXISTING RECEPTACLE CABLE AND CONDUIT TO REMAIN.
- 3. EXISTING LIGHTING UNIT SHALL BE REMOVED FROM EXISTING FOUNDATION AND REPLACED WITH A NEW LIGHTING UNIT, AS SHOWN ON THE PLANS AND UNLESS NOTED OTHERWISE. EXISTING LIGHT POLE FOUNDATION SHALL BE REMOVED AND REPLACED, AS FOLLOWS:
 - FOR LOCATIONS WHERE AN EXISTING CONCRETE FOUNDATION IS PRESENT AND A RECEPTACLE OUTLET IS NOT ATTACHED TO THE EXISTING LIGHT POLE, THE SHAFT FOUNDATION SHALL BE PARTIALLY REMOVED AND A NEW CONCRETE FOUNDATION SHALL BE INSTALLED WITHIN 5' OF THE EXISTING LOCATION, UNLESS NOTED OTHERWISE ON THE PLANS. THE FINAL LOCATION SHALL BE AS DIRECTED BY THE ENGINEER.
 - FOR LOCATIONS WHERE AN EXISTING METAL FOUNDATION IS PRESENT, THE METAL FOUNDATION SHALL BE REMOVED AND A NEW CONCRETE FOUNDATION SHALL BE INSTALLED AT THE EXISTING LOCATION. WHERE APPLICABLE, THE EXISTING RECEPTACLE OUTLET SHALL BE REATTACHED TO THE NEW LIGHT POLE.
- 4. NEW LIGHT POLE LOCATION. THE FINAL LOCATION SHALL BE AS DIRECTED BY THE ENGINEER.
- 5. EXISTING LIGHT POLE TO BE REMOVED AND NOT REPLACED.
- 6. LIGHT POLE FOUNDATION, SPECIAL (X8360110) TO BE INSTALLED.

LEGEND:

PROPOSED GROUND MOUNTED LIGHTING UNIT BLACK ALUMINUM, 25' MH, 4' TWIN ARM, LED LUMINAIRE, 240V ON CONCRETE FOUNDATION

PROPOSED GROUND MOUNTED LIGHTING UNIT
BLACK ALUMINUM, 25' MH, 4' M.A., LED LUMINAIRE, 240V
ON CONCRETE FOUNDATION

■ PROPOSED LIGHTING CONTROLLER, BASE MOUNTED, SINGLE PHASE, 3-WIRE, 240 VOLT, 200 AMP


 UNIT DUCT, 600V, 2-1C NO.6, 1/C NO.6 GROUND, (XLP-TYPE USE), 1-1/4" DIA. POLYETHYLENE

UNDERGROUND CONDUIT, PVC, 3" DIA.

USER NAME = bbarr	DESIGNED -	REVISED -
	DRAWN -	REVISED -
PLOT SCALE = 100.0000 / in.	CHECKED -	REVISED -
PLOT DATE = 3/24/2023	DATE -	REVISED -

STATE OF ILLINOIS
DEPARTMENT OF TRANSPORTATION

LIGHTING PLAN — NORTH AREA						F.A.U. RTE	SECTION		COUNTY	TOTAL SHEETS	SHEET NO.				
	LIG	iHII	NG	'LA	N - N	DRIH A	AKEA			REND LAKE R	ESORT	2022	FRANKLIN	49	37
												CONTRACT	NO.		
	SHEET	2	OF	6	SHEETS	STA.		TO STA.	ILLINOIS FED. AID PROJECT						

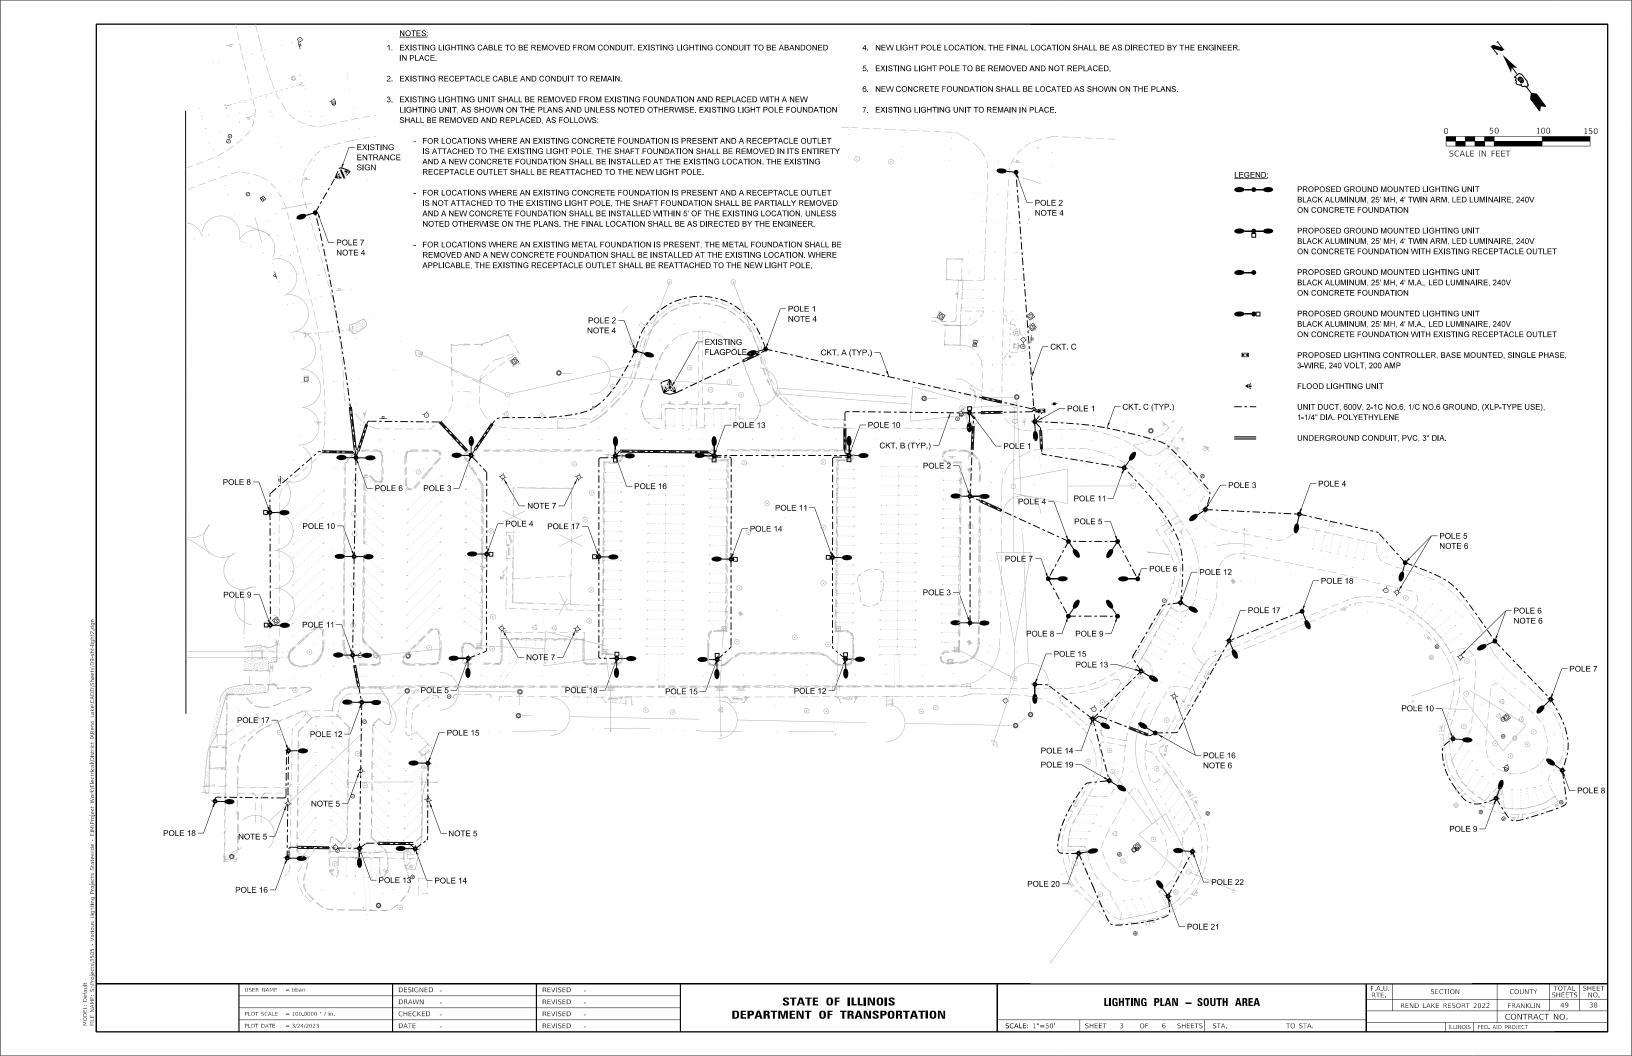



	LU	MINAIRE,	LED, RO	DADWAY	, OUTP	DI DES	IGNA I I	ON F
Project								
Date	Contract N	Number	Section Num	Section Number		ty		
03-15-2023	5-2023			RESORT 2022	FRA	FRANKLIN		
Marked Route	Number			Municipality	,			
Roadway								
Lane Width	*of Lanes	Median Width	I.E.S Surfa	ce Classific	ation 0-Zer	o Value		
12 ft	4	N/A	R3		0.07			
Structure			Number of L					
Mounting Heigh	nt Arm Leng	th Set Back	(Highmast &		ig Only)			
25 ft	4 ft	4 ft	N/A					
Luminaire Description LUMINAIRE, LEI Total Light Lo: 0.7 Layout Spacing (to Ne	ss Factor (LL	U = 0	ing	ON F TYPE III Shields N/A			I.E.S. Lo	MEDIUM Dimming Protocol 0-10V
190 ft		STAGGERED	,,,,,,,,,,,,,,,,,,,,,,,,,,,,,,,,,,,,,,,					
Performance								
Average Illumin		;) L	niformity Rati	O, E AVF/EMIN	ı			
≥ 1.1			4.0:1					
Average Luminance, L _{AVE} (cd/m ²) Uniformit			ity Ratio, L _{AVE}	Uniformity 6	Ratio, L _{MAX} /	L _{MIN} V	eiling Luminance Ratio, L _V /L _{MIN}	
N/A N/A				N/A		N	I/A	
Light Tressp	oss							
Distance to RO	OW (behind po	le) Max. Hori:	zontal Illuminar	nce at ROW,	E _H	Max. Verti	cal Illuminanc	e at ROW, E _V
N/A N/A				N/A				
Notes								

- 2. Lighting calculations shall be performed with all luminaires oriented toward and perpendicular to roadway.
- 3. Total Light Loss Factor (LLF) = the product of "Lumen Maintenance" (LLD) = 0.9, "Dirt Depreciation" (LDD) = 0.8, and "Equipment Factors" (EF) = 0.95.
- Performance requirements shall be the minimum acceptable standards of photometric performance for the luminaire, based on the given conditions above.
- 5. Lighting calculations shall be performed in one direction only.
- 6. Compliance with performance criteria shall be held to one significant digit.

STATE OF ILLINOIS
DEPARTMENT OF TRANSPORTATION

SCALE: NTS

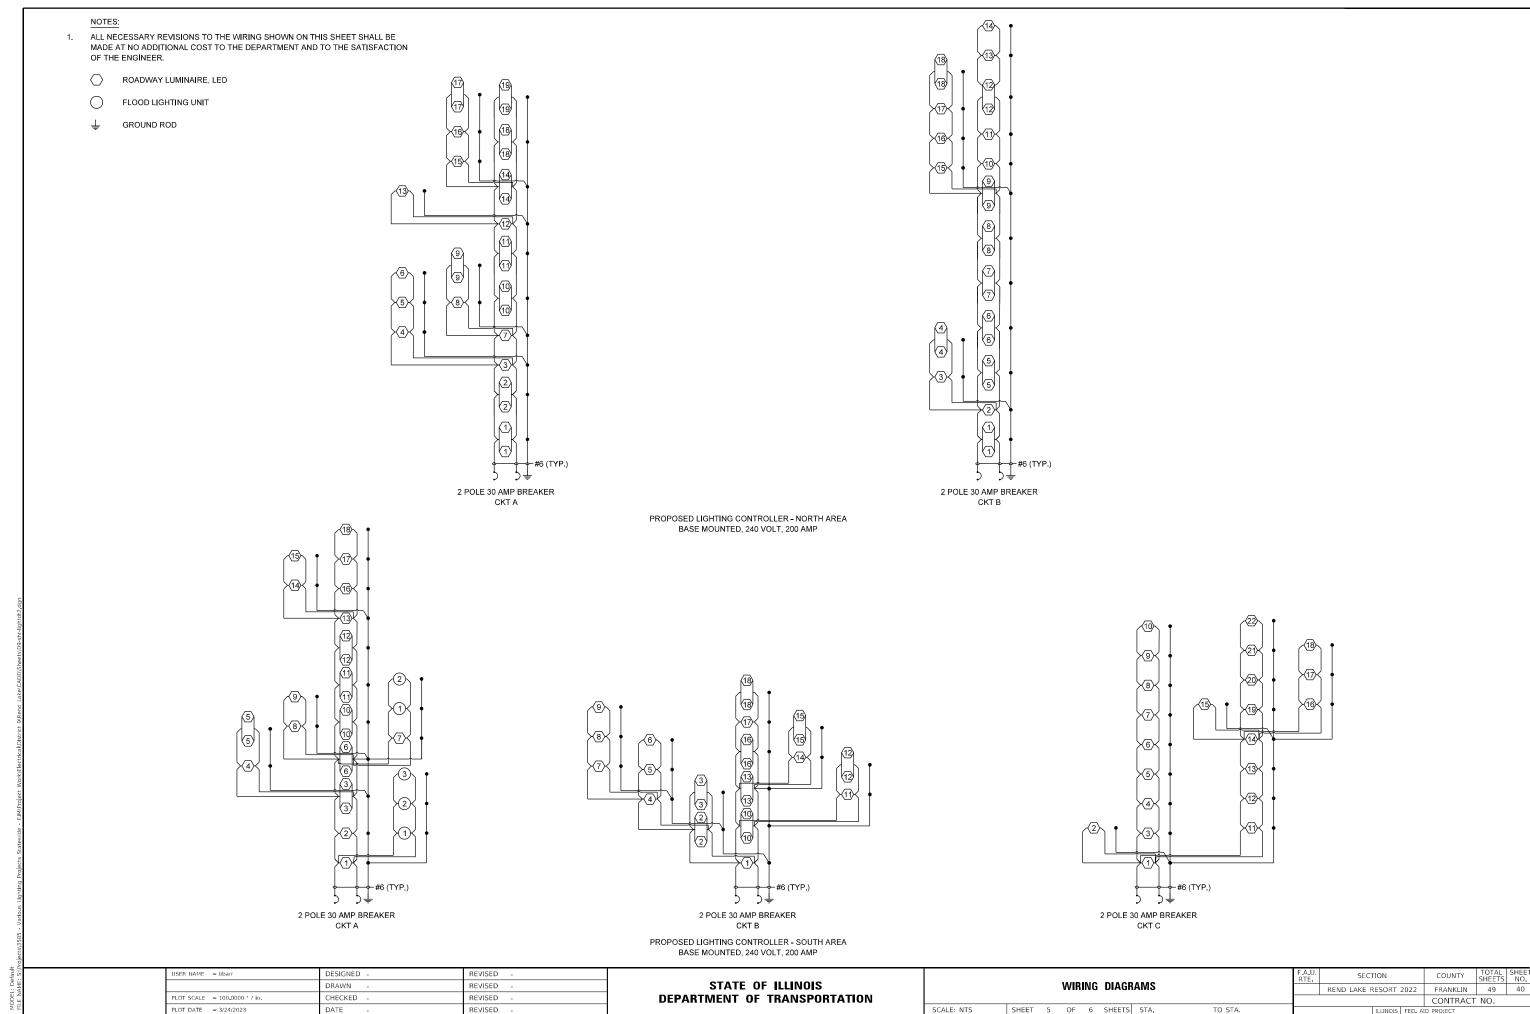

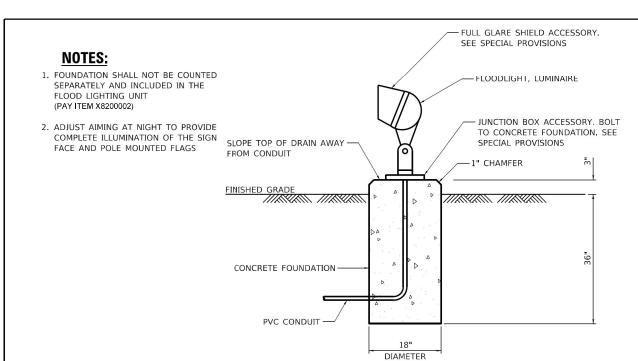

FLOOD LIGHTING UNIT (X8200002)

FLAGPOLE LIGHTING PLAN DETAIL

REVISED

REVISED

REVISED

REVISED


DESIGNED -

DRAWN

CHECKED

DATE

PLOT DATE = 3/24/2023

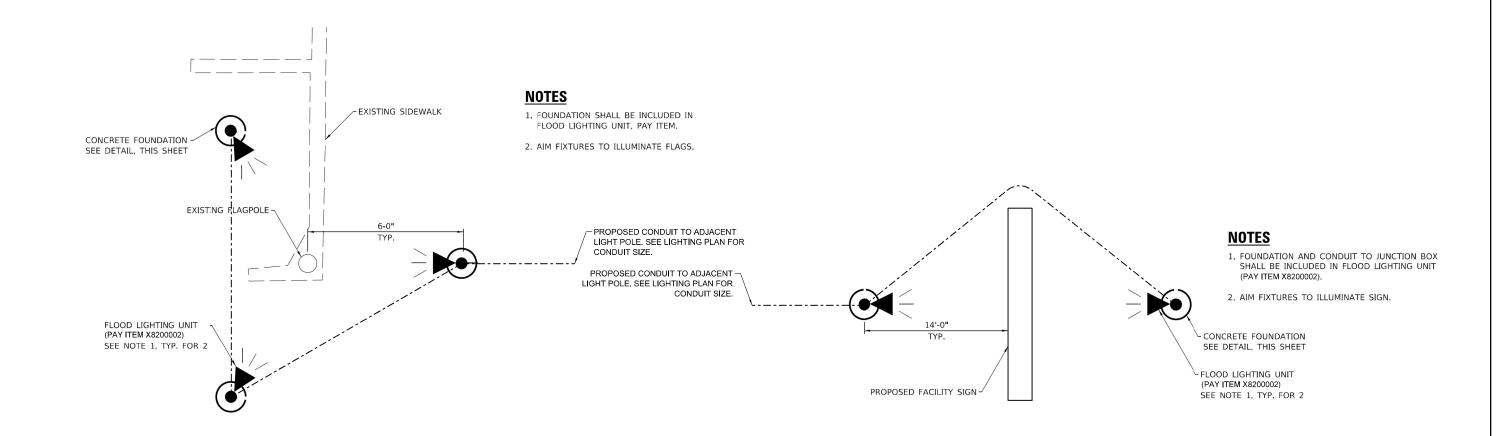

STATE OF ILLINOIS

DEPARTMENT OF TRANSPORTATION

ENTRANCE SIGN LIGHTING DETAIL

SHEET 6 OF 6 SHEETS STA.

SCALE: NTS

FLOOD LIGHTING UNIT DETAILS

TO STA.

SECTION

REND LAKE RESORT 2022 FRANKLIN 49 41

CONTRACT NO.

