## STATE OF ILLINOIS

# DEPARTMENT OF TRANSPORTATION **DIVISION OF HIGHWAYS**

FOR INDEX OF SHEETS, SEE SHEET NO. 2

 $\circ$ 

 $\circ$ 

 $\circ$ 

# PLANS FOR PROPOSED FEDERAL AID HIGHWAY

FAP ROUTE 348 (HARLEM AVENUE) AND VARIOUS LOCATIONS

**BUS SHELTER DEVELOPMENT** SECTION 10-00251-00-MS PROJECT CMM-9003(822) **COOK COUNTY** C-91-563-11

**LOCATION MAP** 

-(4) NE CORNER LAKE & EAST 2 SW CORNER RIDGELAND & SOUTH BLVD -(3) SW CORNER LAKE @ LOMBARD (1) SW CORNER LAKE @ AUSTIN

SOUTHSIDE NORTH BLVD & HARLEM AVE (5)-SE CORNER HARLEM AVE & SOUTH BLVD 6

NE CORNER MADISON & OAK PARK (8)

NE CORNER MADISON & EAST (9)-

ENGINEERING SCALES. REDUCED SIZED PLANS WILL NOT CONFORM TO STANDARD SCALES. IN MAKING MEASUREMENTS ON REDUCED PLANS, THE ABOVE SCALES MAY BE USED.

JOINT UTILITY LOCATION INFORMATION FOR EXCAVATION 1-800-892-0123

CONTRACT NO. 63538

GROSS LENGTH = 257 FEET (.05 MILES)

NET LENGTH = 257 FEET (.05 MILES)

PRINTED BY THE AUTHORITY OF THE STATE OF ILLINOIS

(7)S SIDE OF LAKE ST., EAST OF CUYLER -(11) NW CORNER MADISON @ AUSTIN (10) NE CORNER MADISON & LOMBARD

PROJECT LOCATED IN VILLAGE OF OAK PARK POSTED SPEED = 30 MPH (MAX)TRAFFIC VOLUME = 37,400 VPD (2009) MAX ENGINEER: FULL SIZE PLANS HAVE BEEN PREPARED USING STANDARD

LOCATION OF SECTION INDICATED THUS: -

PROFESSIONAL ENGINEER'S SIGN & SEAL

STATE OF ILLINOIS DEPARTMENT OF TRANSPORTATION

**DIVISION OF HIGHWAYS** 

Dina M. O'llerfe PUTY DIRECTOR OF HIGHWAYS, REG

VILLAGE OF OAK PARK, VILLAGE ENGINEER

SECTION

10-00251-00-MS

COUNTY

СООК

INDEX OF SH	
SHEET NO.	DESCRIPTION
1	COVER SHEET
2	INDEX OF SHEETS/GENERAL NOTES/HIGHWAY STANDARDS/DIST 1 STANDARDS
3	SUMMARY OF QUANTITIES
4-9	PLAN SHEETS - LOCATIONS 1-11
10-13	CONSTRUCTION DETAILS
	DISTRICT ONE DETAILS
14	BE-702 MISC. ELECTRICAL DETAILS
15	BD-08 FRAMES AND LIDS ADJUSTMENT WITH MILLING
16	TC-10 TRAFFIC CONTROL AND PROTECTION FOR SIDE ROADS

### STATE STANDARDS

000001-06	STANDARD SYMBOLS, ABBREVIATIONS, AND PATTERNS
424001-05	CURB RAMPS FOR SIDEWALKS
701301-04	LANE CLOSURE, 2L 2W SHORT TIME OPERATIONS
701311-03	LANE CLOSURE 2L, SW MOVING OPERATIONS-DAY ONLY
701501-06	URBAN LANE CLOSURE, 2L 2W, UNDIVDED
701801-04	LANE CLOSURE MULTILANE 1W OR 2W CROSSWALK OR SIDEWALK CLOSURE
701901-01	TRAFFIC CONTROL DEVICES

### GENERAL NOTES

- 1. THE LIMITS OF REMOVAL AND/OR REPLACEMENT PAY ITEMS WILL BE MARKED IN THE FIELD BY THE ENGINEER.
- 2. THE LOCATION OF THE PROPOSED BUS SHELTER STRUCTURES WILL BE MARKED IN THE FIELD BY THE ENGINEER.
- 3. THE EXISTING BUS SHELTER STRUCTURES WILL BE REMOVED BY OTHERS PRIOR TO THE START OF CONSTRUCTION.
- 4. THE INSTALLATION OF THE NEW BUS SHELTER STRUCTURES WILL BE PERFORMED BY OTHERS.
- 5. EXISTING STREET FURNITURE INCLUDING, BUT NOT LIMITED TO MAILBOXES, NEWSPAPER BOXES, STREETSCAPE FURNITURE, AND REFUSE CONTAINERS WILL BE REMOVED BY OTHERS AND THEN REPLACED BY OTHERS.
- 6. WHERE APPLICABLE, AND AT THE SOLE DISCRETION OF THE ENGINEER, GULFBOX JUNCTIONS MAY BE PLACED IN THE SODDED PARKWAY ADJACENT TO THE NEW P.C. CONCRETE SIDEWALK BUS SHELTER PAD. PAY ITEM QUANTITIES WILL BE ADJUSTED ACCORDINGLY.
- 7. THE CONTRACTOR SHALL ACCESS THE JOB SITE FROM THE ADJACENT VILLAGE OF OAK PARK OWNED PARKING LOT. EQUIPMENT, MATERIAL AND LABOR IS TO STAY OFF OF THE HARLEM AVE. PAVMENT WHENEVER POSSIBLE.
- 8. TWO TYPES OF BUS SHELTER STRUCTURES WILL BE USED ON THIS PROJECT. ONE BUS SHELTER STRUCTURE IS OF A CANTILEVERED ROOF DESIGN AND HAS A FOOTPRINT OF APPROXIMATELY 3 FEET X 8 FEET. THE OTHER BUS SHELTER STRUCTURE IS OF A STANDARD ROOF DESIGN AND HAS A FOOTPRINT OF APPROXIMATELY 6 FEET X 12 FEET.
- 9. ALL REFERENCES TO "STANDARD SPECIFICATIONS" IN THESE GENERAL NOTES SHALL BE INTERPRETED TO MEAN "STANDARD SPECIFICATIONS FOR ROAD AND BRIDGE CONSTRUCTION" ADOPTED BY THE ILLINOIS DEPARTMENT OF TRANSPORTATION, JANUARY 1, 2007.
- 10. THE CONTRACTOR SHALL FURNISH AND INSTALL OVERCURRENT PROTECTION, INCLUDING FUSE HOLDERS AND FUSES, AS SHOWN ON THE PLAN DETAILS. MATERIAL AND INSTALLATION SHALL COMPLY WITH SECTION 1065.01 OF THE STANDARD SPECIFICATIONS. OVERCURRENT PROTECTION, INCLUDING FUSE HOLDERS AND FUSES, SHALL BE CONSIDERED AS INCLUDED IN THE COST OF THE ELECTRIC CABLE PAY ITEM.

### GENERAL NOTES (CONTINUED)

- 10. ALL REFERENCES TO "ENGINEER" SHALL BE INTERPRETED TO MEAN THE RESIDENT ENGINEER.
- 11. PRIOR TO COMMENCEMENT OF CONSTRUCTION, THE CONTRACTOR SHALL VERIFY ALL DIMENSIONS AND CONDITIONS AFFECTING THEIR WORK WITH THE ACTUAL CONDITIONS AT THE JOB SITE. IN ADDITION, THE CONTRACTOR MUST VERIFY THE ENGINEER'S LINE AND GRADE STAKES. IF THERE ARE DISCREPANCIES FROM WHAT IS SHOWN ON THE CONSTRUCTION PLANS, HE/SHE MUST IMMEDIATELY REPORT SAME TO THE ENGINEER BEFORE DOING ANY WORK, OTHERWISE THE CONTRACTOR ASSUMES FULL RESPONSIBILITY. IN THE EVENT OF DISAGREEMENT BETWEEN THE CONSTRUCTION PLANS, STANDARD SPECIFICATIONS AND/OR SPECIAL DETAILS, THE CONTRACTOR SHALL SECURE WRITTEN INSTRUCTIONS FROM THE ENGINEER PRIOR TO PROCEEDING WITH ANY PART OF THE WORK AFFECTED BY OMISSIONS OR DISCREPANCIES, FAILING TO SECURE SUCH INSTRUCTIONS, THE CONTRACTOR WILL BE CONSIDERED TO HAVE PROCEEDED AT HIS OWN RISK AND EXPENSE, IN THE EVENT OF ANY DOUBT OR QUESTION ARISING WITH RESPECT TO THE TRUE MEANING OF THE CONSTRUCTION PLANS OR SPECIFICATIONS, THE DECISION OF THE ENGINEER SHALL BE FINAL AND CONCLUSIVE.
- 12. IT IS THE CONTRACTOR'S RESPONSIBILITY TO ASCERTAIN EXISTING FIELD CONDITIONS PRIOR TO BIDDING ON THE PROJECT.
- 13. BEFORE STARTING ANY EXCAVATION, THE CONTRACTOR SHALL CALL "JULIE" (JOINT UTILITY LOCATION INFORMATION FOR EXCAVATION) FOR LOCATIONS OF BURIED UTILITIES (48 HOURS NOTIFICATION IS REQUIRED).
- 14. SAW CUTTING OF PAVEMENTS, SIDEWALK, ETC. SHALL BE TO FULL DEPTH AND SHALL RESULT IN A CLEAN STRAIGHT EDGE ON THE PORTION REMAINING. ALL SAW CUTTING SHALL BE CONSIDERED INCLUDED IN THE COST OF THE ITEM REMOVED.
- 15. THE CONTRACTOR SHALL PROTECT AND CAREFULLY PRESERVE ALL SECTION OR SUBSECTION MONUMENTS, PROPERTY CORNERS, AND REFERENCE MARKERS UNTIL THE OWNER, HIS AGENT, OR AN AUTHORIZED SURVEYOR HAS WITNESSED OR OTHERWISE REFERENCED THEIR LOCATIONS.

### STORM SEWERS, WATER MAINS AND UTILITIES

- 1. THE CONTRACTOR SHALL BE RESPONSIBLE FOR CONTACTING THE OWNERS OF ALL UTILITIES PRIOR TO CONSTRUCTION TO DETERMINE THE LOCATION OF ALL UTILITY EQUIPMENT. THE CONTRACTOR SHALL COOPERATE WITH ALL UTILITY OWNERS IN ACCORDANCE WITH THE STANDARD SPECIFICATIONS IF UTILITY RELOCATION ADJUSTMENT OR PROTECTION IS NECESSARY.
- 2. THE LOCATION OF EXISTING DRAINAGE STRUCTURES, STORM SEWERS, WATER MAINS, SANITARY SEWERS, AND ANY OTHER PUBLIC UTILITIES AS SHOWN ON THE PLANS IS BASED ON BEST AVAILABLE RECORD DATA. THEIR EXACT LOCATION IS TO BE DETERMINED IN THE FIELD BY THE CONTRACTOR. THIS WORK SHALL BE CONSIDERED AS INCLUDED IN THE COST OF VARIOUS STORM SEWER ITEMS, AND NO ADDITIONAL COMPENSATION WILL BE ALLOWED.
- 3. THE CONTRACTOR SHALL BE RESPONSIBLE FOR THE PROTECTION OF ALL UNDERGROUND AND SURFACE UTILITIES EVEN THOUGH THEY MIGHT NOT BE SHOWN ON THE PLANS. ALL UTILITY PROPERTY DAMAGED DURING CONSTRUCTION SHALL BE REPAIRED OR REPLACED TO THE SATISFACTION OF THE OWNER AT THE CONTRACTOR'S EXPENSE IN ACCORDANCE WITH ARTICLES 105.07 AND 107.31.
- 4. ALL UTILITY COMPANIES SHALL BE NOTIFIED AT LEAST 3 DAYS PRIOR TO THE START OF CONSTRUCTION.
- 5. THE CONTRACTOR SHALL USE ALL NECESSARY PRECAUTIONS AND PROTECTION MEASURES REQUIRED TO MAINTAIN EXISTING UTILITIES, SEWERS, AND APPURTENNANCES THAT MUST BE KEPT IN OPERATION.
- 6. THE CONTRACTOR SHALL ENSURE THAT ALL WATER SYSTEM VALVES, VALVE VAULTS, AND SANITARY SEWER MANHOLES REMAIN READILY ACCESSIBLE TO THE VILLAGE OF OAK PARK FOR EMERGENCY OPERATIONS. THE LOCATIONS OF ALL WATER AND SANITARY FACILITIES SHALL BE MARKED AND READILY VISIBLE AT ALL TIMES.
- 7. ALL LOOSE MATERIAL DEPOSITED IN THE FLOWLINE OF DRAINAGE STRUCTURES, WHICH OBSTRUCTS THE NATURAL FLOW OF WATER SHALL BE REMOVED AT THE CLOSE OF EACH WORKING DAY. PRIOR TO ACCEPTANCE OF THE IMPROVEMENT ALL DRAINAGE STRUCTURES SHALL BE FREE OF DIRT AND DEBRIS. THIS WORK WILL NOT BE PAID FOR SEPARATELY, BUT SHALL BE CONSIDERED AS INCLUDED IN THE UNIT BID PRICES FOR PROPOSED AND ADJUSTED STRUCTURES.

### TRAFFIC CONTROL

SEE TRAFFIC CONTROL HIGHWAY STANDARDS CONCERNING TRAFFIC CONTROL AND PROTECTION.

### HOT-MIX ASPHALT REQUIREMENTS

	MIXTURE TYPE	AIR VOIDS @Ndes
HOT-MIX ASPHALT	SURFACE COURSE, MIX "D", N50 (IL 9.5 mm)	4% <b>©</b> 50 Gyr

THE UNIT WEIGHT USED TO CALCULATE ALL HMA SURFACE MIXTURE QUANTITIES IS 112 LBS/SO YD/IN.

THE "AC TYPE" FOR POLYMERIZED HMA MIXES SHALL BE "SBS/SBR PG70-22" AND FOR NON-POLYMERIZED HMA THE "AC TYPE" SHALL BE "PG 64-22" UNLESS MODIFIED BY DISTRICT ONE SPECIAL PROVISIONS FOR "PERCENT OF RAP". SEE DISTRICT ONE SPECIAL PROVISIONS.

SHEET NO. IDX OF TOT SHEETS STA.

		-		
FILE NAME =	USER NAME = \$USER\$	DESIGNED -	REVISED -	Γ
\$FILES\$		DRAWN - LB	REVISED -	١
	PLOT SCALE = \$SCALE\$	CHECKED - LB	REVISED -	i
	PLOT DATE = \$DATE\$ .	DATE - OCTOBER 2010	REVISED -	۱

	OAK PAR	< BUS	SHELTER	DEVELOPMENT
OAK PARK	IND	EX &	GENERAL	NOTES

# SUMMARY OF QUANTITIES

_TY				0021	Lake	Ridgeland	Lake	Lake	North Blvd	Harlem	Lake	Madison	Madison	Madison	Madison
ECIAL	Pay Item			Total	Austin	South Blvd	Lombard	East	Harlem	South Blvd	Cuyler	Oak Park	East	Lombard	Austin
S	Number	Pay Item	Unit	Quantity	1	2	3	4	5	6	7	8	9	10	11
	20101000	TEMPORARY FENCE	FOOT	112	32.00	16.00	0.00	0.00	0.00	0.00	32.00	0.00	16.00	0.00	16.00
	20101100	TREE TRUNK PROTECTION	EACH	7	2.00	1.00	0.00	0.00	0.00	0.00	2.00	0.00	1.00	0.00	1.00
	31102200	SUB-BASE GRANULAR MATERIAL, TYPE C 5"	SQ YD	436	20.00	18.90	26.60	26.60	39.00	75.50	70.90	58.30	29.50	45.10	25.30
	42400800	DETECTABLE WARNINGS	SQ FT	24	0.00	0.00	0.00	0.00	0.00	16.00	, 0.00	0.00	0.00	8.00	0.00
	44000100	PAVEMENT REMOVAL	SQ YD	54	0.00	0.00	0.00	0.00	0.00	54.00	0.00	0.00	0.00	0.00	0.00
	60300305	FRAMES AND LIDS TO BE ADJUSTED	EACH	3	0.00	0.00	0.00	1.00	0.00	0.00	1.00	0.00	0.00	0.00	1.00
	67100100	MOBILIZATION	LSUM	1	0.09	0.09	0.09	0.09	0.09	0.09	0.09	0.09	0.09	0.09	0.09
	70102620	TRAFFIC CONTROL AND PROTECTION, STANDARD 701501	L SUM	1	0.09	0.09	0.09	0.09	0.09	0.09	0.09	0.09	0.09	0.09	0.09
	70102640	TRAFFIC CONTROL AND PROTECTION, STANDARD 701801	LSUM	1	0.09	0.09	0.09	0.09	0.09	0.09	0.09	0.09	0.09	0.09	0.09
	81000300	CONDUIT IN TRENCH, 1" DIA., GALVANIZED STEEL	FOOT	62	3.00	3.00	3.00	3.00	21.00	12.00	3.00	3.00	5.00	3.00	3.00
	81017505	CONDUIT IN TRENCH, 3/4" DIA., COILABLE NONMETALLIC CONDUIT	FOOT	159	34.00	34.00	0.00	29.00	0.00	0.00	0.00	28.00	34.00	0.00	0.00
	81028020	CONDUIT, BORED AND PULLED, COILABLE NON- METALLIC CONDUIT, 3/4"	FOOT	360	0.00	0.00	38.00	0.00	98.00	57.00	84.00	0.00	0.00	33.00	50.00
	81500120	GULFBOX JUNCTION, COMPOSITE CONCRETE	EACH	11	1.00	1.00	1.00	1.00	1.00	1.00	1.00	1.00	1.00	1.00	1.00
	81702120	ELECTRIC CABLE IN CONDUIT, 600V (XLP-TYPE USE) 1/C NO. 8	FOOT	2,826	232.00	174.00	247.00	212.00	488.00	324.00	432.00	156.00	174.00	171.00	216.00
	81900200	TRENCH AND BACKFILL FOR ELECTRICAL WORK	FOOT	170	25.00	25.00	3.00	17.00	16.00	10.00	3.00	19.00	25.00	6.00	21.00
	X2020410	EARTH EXCAVATION (SPECIAL)	CU YD	15	0.00	1.30	0.00	0.00	0.00	0.00	4.60	0.00	7.30	0.00	0.00
	X4240420	PORTLAND CEMENT CONCRETE SIDEWALK 4 INCH, SPECIAL	SQ FT	104	32.00	0.00	0.00	0.00	0.00	0.00	0.00	0.00	0.00	0.00	72.00
	X4240430	PORTLAND CEMENT CONCRETE SIDEWALK 5 INCH, SPECIAL	SQ FT	3,970	144.00	170.00	240.00	240.00	351.00	762.00	638.00	525.00	266.00	406.00	228.00
	X4400220	CURB REMOVAL AND REPLACEMENT	FOOT	50	0.00	0.00	0.00	0.00	0.00	40.00	0.00	0.00	0.00	10.00	0.00
	X4404700	SIDEWALK REMOVAL (SPECIAL)	SQ FT	2,700	0.00	139.00	240.00	240.00	351.00	282.00	488.00	525.00	29.00	406.00	0.00
	XX000406	BRICK PAVER REMOVAL AND REPLACEMENT	SQ FT	156	48.00	0.00	0.00	0.00	0.00	0.00	0.00	0.00	0.00	0.00	108.00
	XX001621	BRICK PAVER REMOVAL	SQ FT	372	144.00	0.00	0.00	0.00	0.00	0.00	0.00	0.00	0.00	0.00	228.00
	XX002208	6" DIAMETER PIPE BOLLARD, CONCRETE FILLED	EACH	11	0.00	0.00	0.00	0.00	0.00	11.00	0.00	0.00	0.00	0.00	0.00
	XX003689	BUS SHELTER	EACH	1	0.00	0.00	0.00	0.00	0.00	1.00	0.00	0.00	0.00	0.00	0.00
	XX007278	PARKWAY RESTORATION	SQ YD	104	0.00	16.30	8.00	3.30	0.00	8.30	34.60	14.00	19.30	0.00	0.00
	Z0048665	RAILROAD PROTECTIVE LIABILITY INSURANCE	LSUM	1	0.00	0.00	0.00	0.00	0.50	0.50	0.00	0.00	0.00	0.00	0.00
	XX008539	STEP DOWN TRANSFORMER, 1.0 KVA	EACH	5	1.00	0.00	1.00	1.00	0.00	0.00	1.00	0.00	) 👢 0.00	0.00	1.00
	XX008 <i>540</i>	STEP DOWN TRANSFORMER, 2.0 KVA	EACH	2	0.00	0.00	0.00	0.00	1.00	1.00	0.00	0.00	0.00	0.00	<b>10</b> .00.

FILENAME = plan_sheet_Sum Of Qtys b.dc	USER NAME = KOPERNIAK	DESIGNED BY: KOPERNIAK	REVISED: 03/31/2011	_
		DRAWN BY: KOPERNIAK	REVISED:	8
	PLOT SCALE = N.T.S.	CHECKED BY: BUDRICK	REVISED:	á
'	PLOT DATE = MAR 2, 2011	DATE: MAR 2, 2011	REVISED:	4
				_




SUMMARY OF QUANTITIES SHEET NO. XX OF XX SHEETS STA.

CONTRACT NO. 63538

VILLAGE OF OAK PARK




THIS IMAGE IS NOT TO SCALE

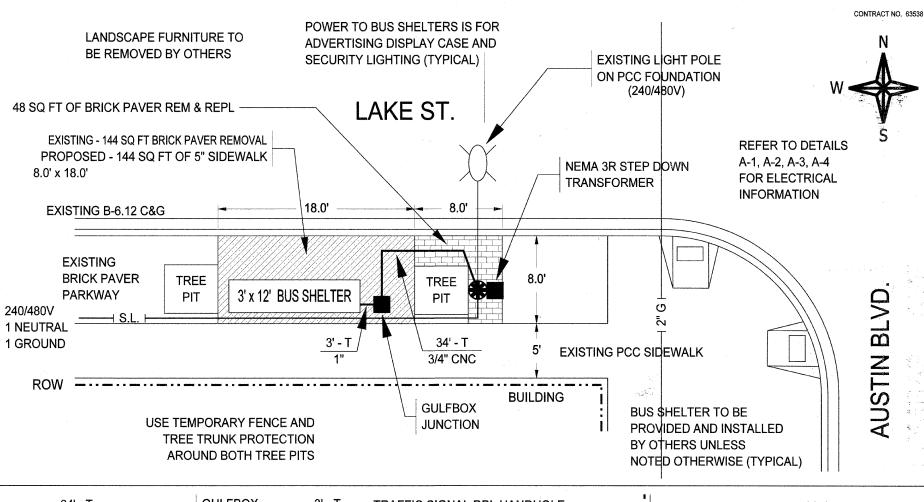



THIS IMAGE IS NOT TO SCALE

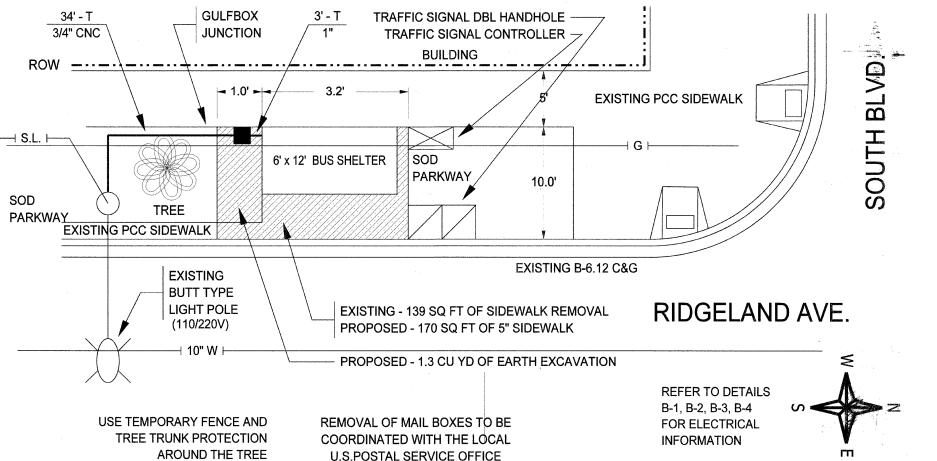

FILENAME =

PLAN\_SHEET\_1B\_REV.DC

 USER NAME =
 KOPERNIAK
 DESIGNED BY:
 KOPERNIAK
 REVISED:
 03/30/2011

 PLOT SCALE =
 1" = 4'
 CHECKED BY:
 BUDRICK
 REVISED:
 04/11/2011

 PLOT DATE =
 FEB 25, 2011
 DATE:
 MAR 2, 2011
 REVISED:





VILLAGE OF OAK PARK

PROPOSED		•••	LAKE ST. AND A	USTIN BLVD. E. AND SOUTH BLVD
CALE:	SHEET NO.	OF	SHEETS	STA.

TO STA.

| SECTION | COUNTY | SHEET | S

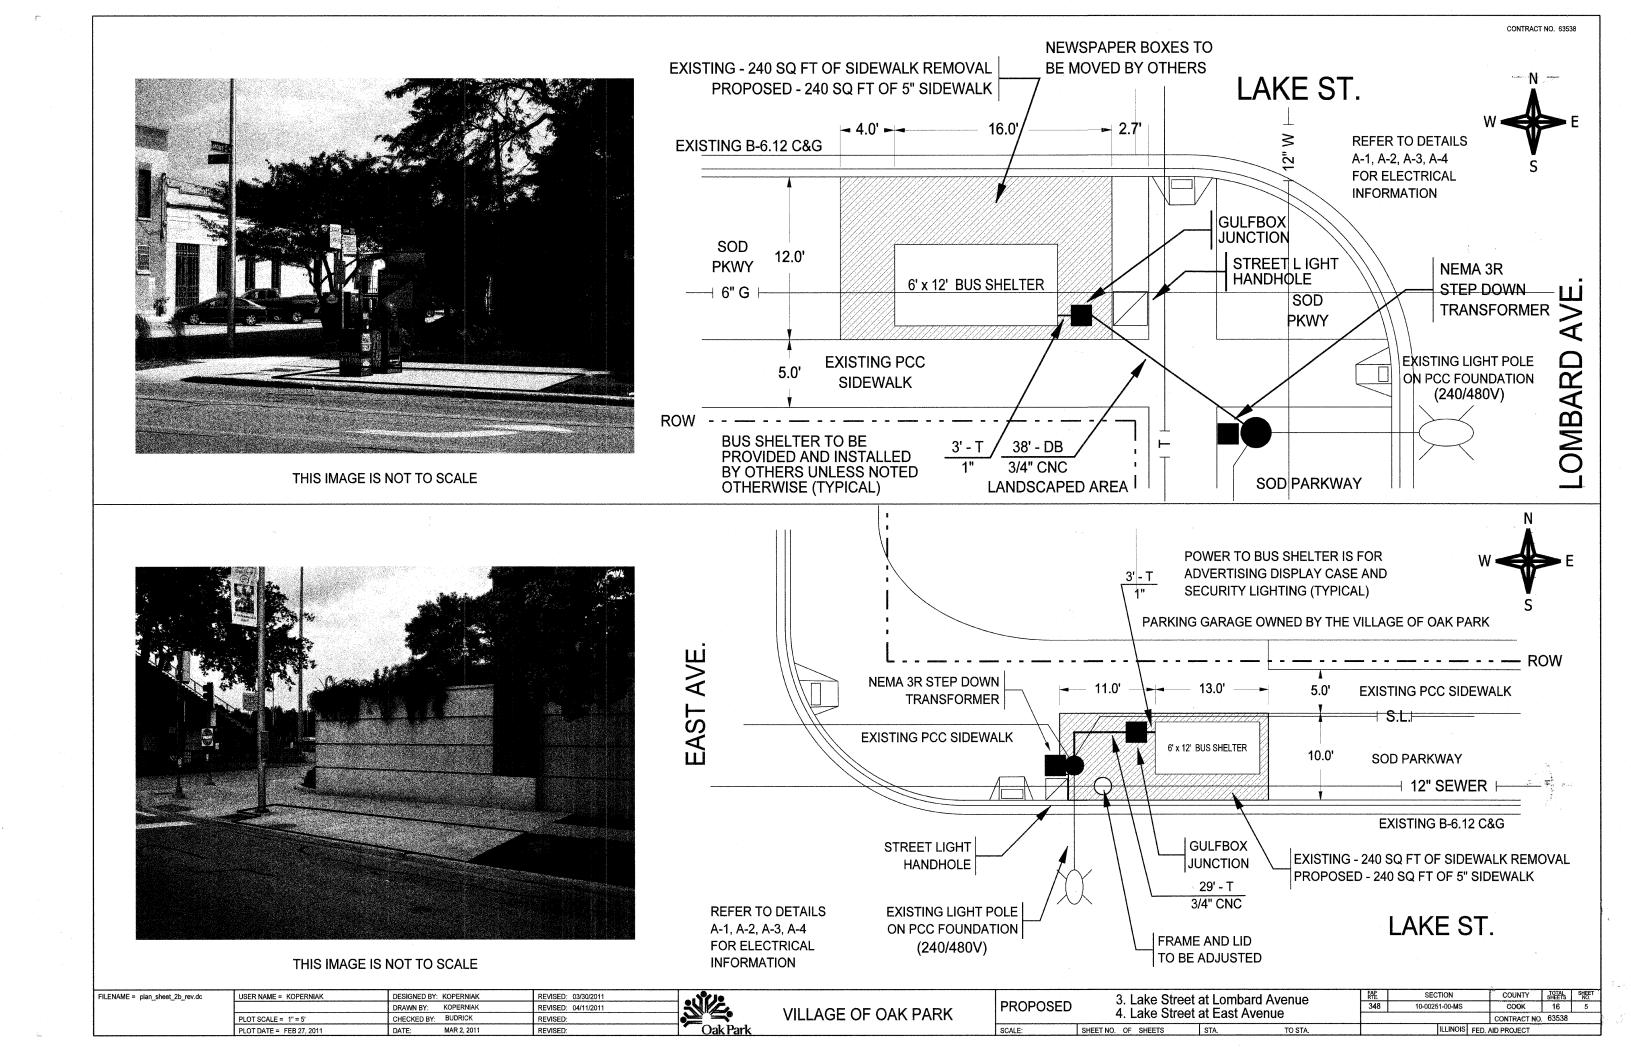

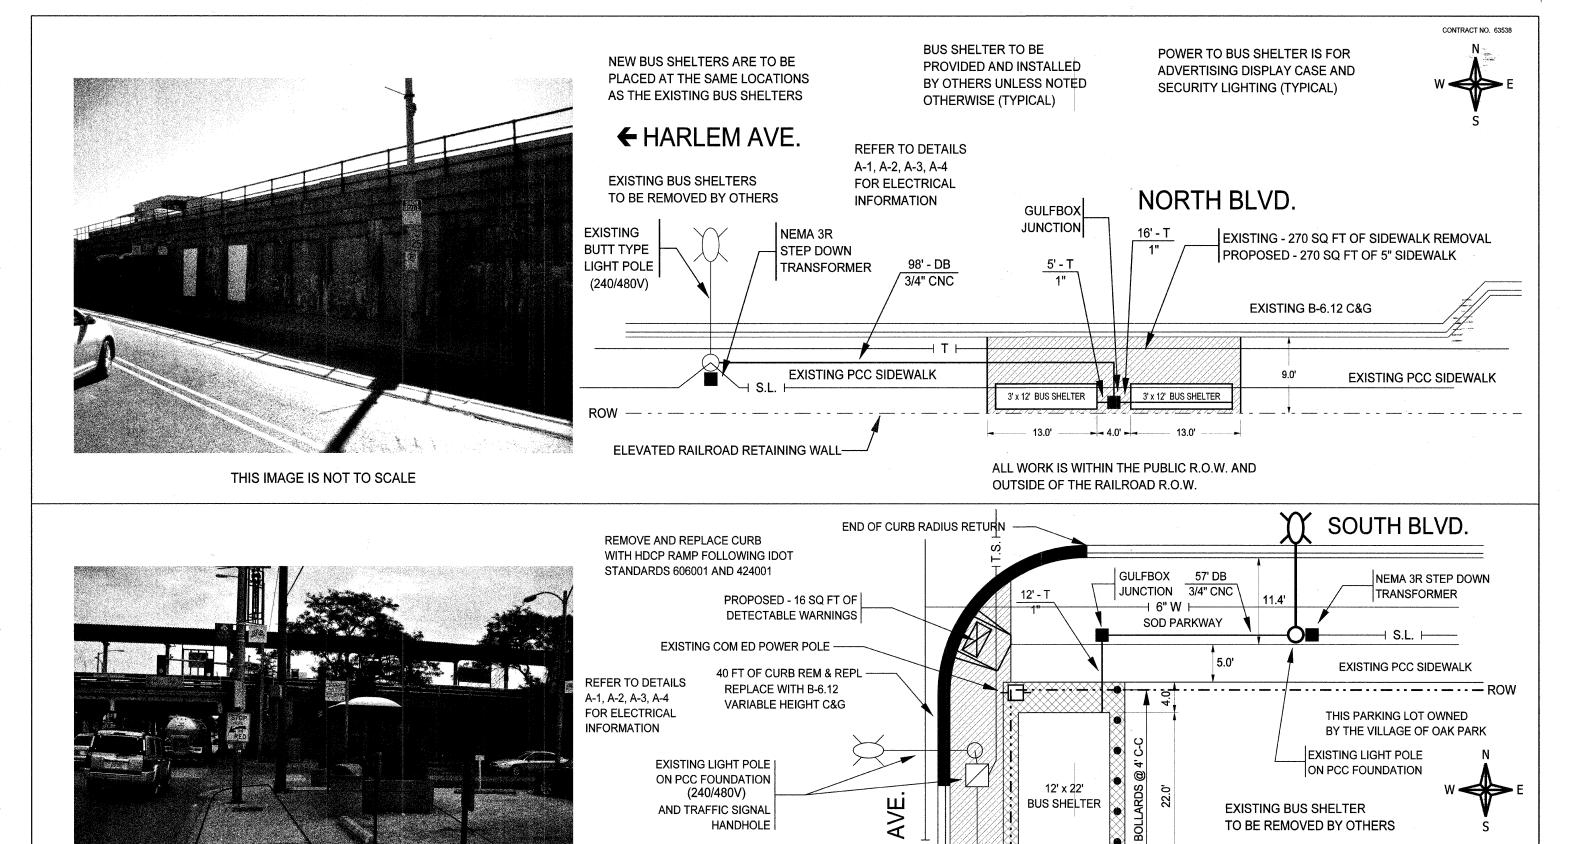

COOK

ILLINOIS FED. AID PROJECT

SHEET NO. OF SHEETS

STA.

CONTRACT NO. 63538

RLEM , 50 8" ₩ LANDSCAPE FURNITURE THIS 12" x 22" BUS SHELTER SHALL BE AND PARKING BLOCKS TO PROVIDED, ASSEMBLED, AND INSTALLED BE REMOVED BY OTHERS BY THE CONTRACTOR 4' C-C EXISTING - 282 SQ FT OF SIDEWALK REMOVAL 14.0' PROPOSED - 282 SQ FT OF 5" SIDEWALK EXISTING - 54 SQ YD OF PAVEMENT REMOVAL PROPOSED - 480 SQ FT OF 5" SIDEWALK 16.0' 7.0' THIS IMAGE IS NOT TO SCALE FILENAME = plan\_sheet\_3b\_rev.dc USER NAME = KOPERNIAK DESIGNED BY: KOPERNIAK REVISED: 03/30/2011 5. North Boulevard, east of Harlem Avenue 6. Harlem Avenue at South Boulevard **PROPOSED** DRAWN BY: KOPERNIAK REVISED: 04/11/2011 VILLAGE OF OAK PARK


CHECKED BY: BUDRICK


MAR 2, 2011


REVISED:


PLOT SCALE = 1" = 5'

PLOT DATE = FEB 25, 2011

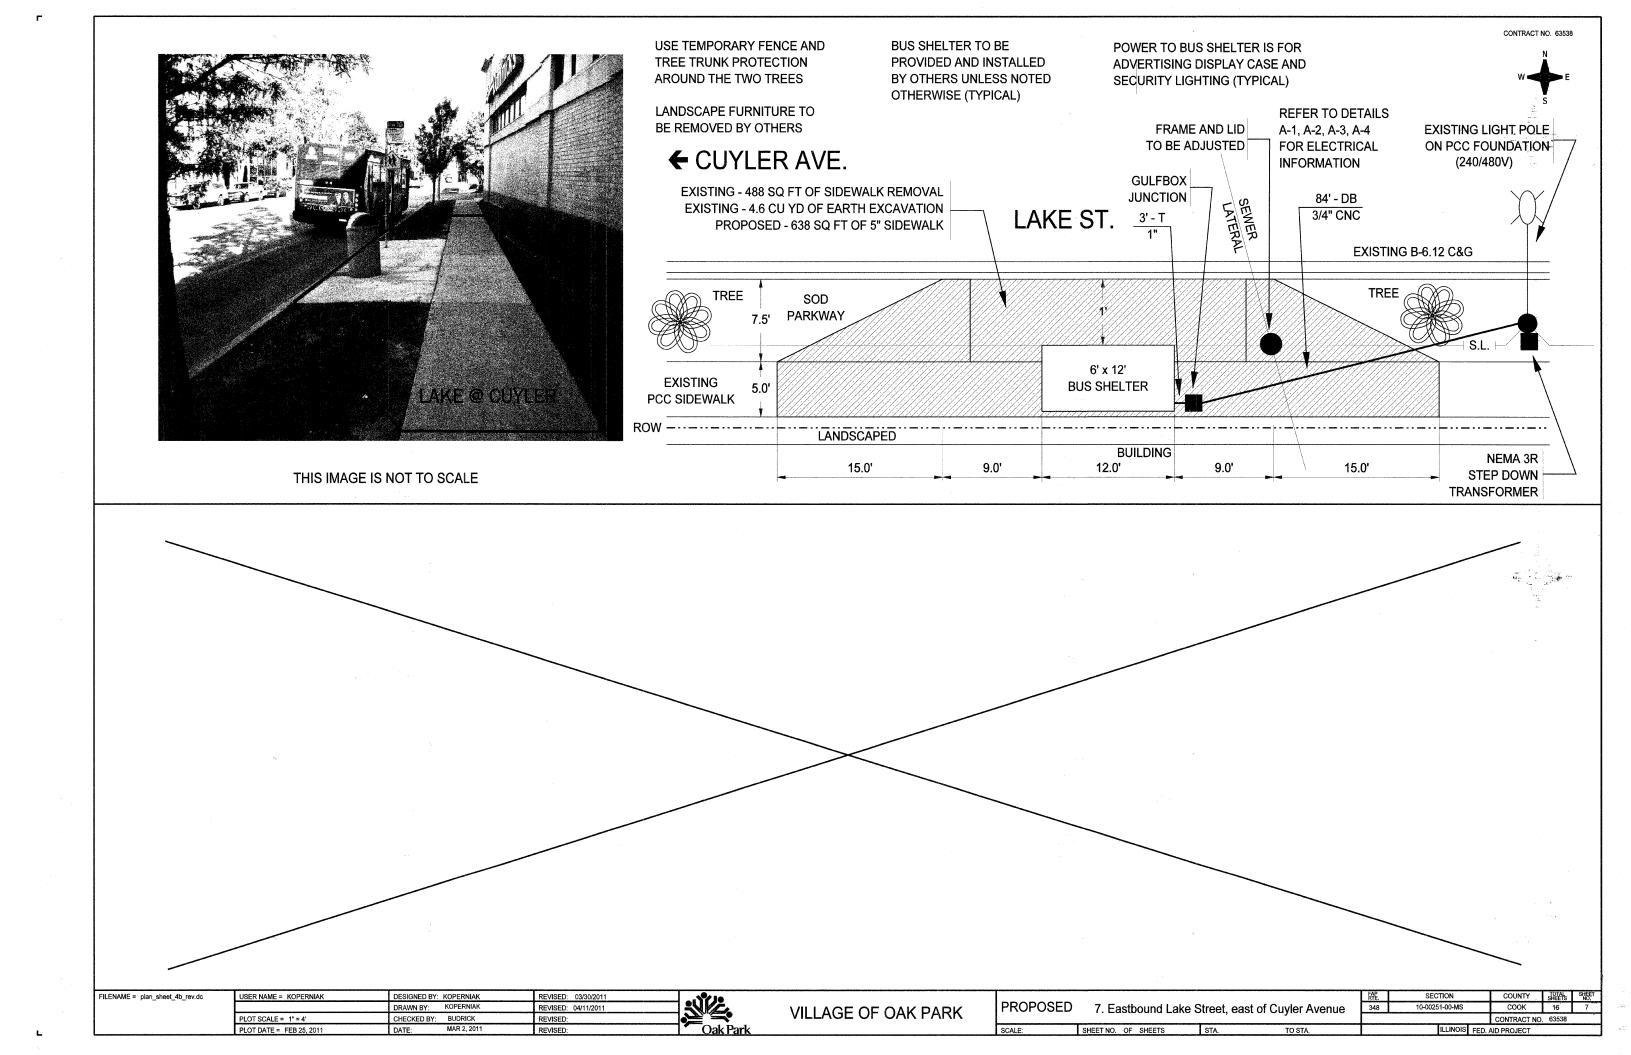


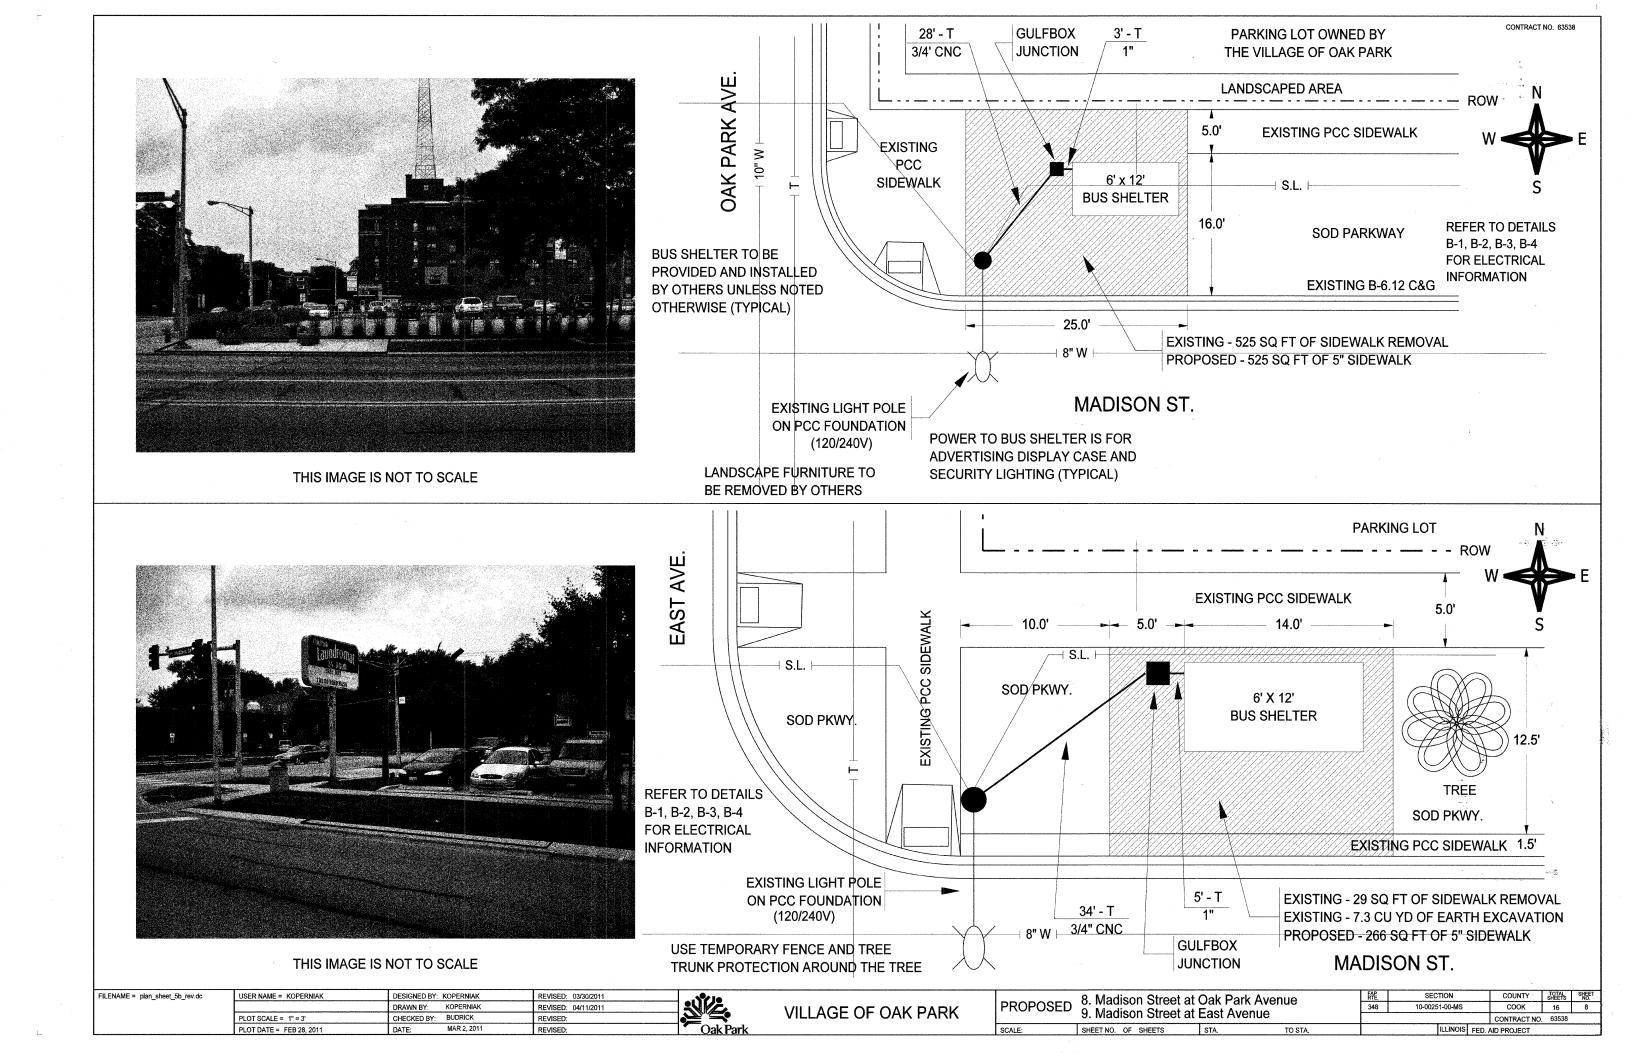

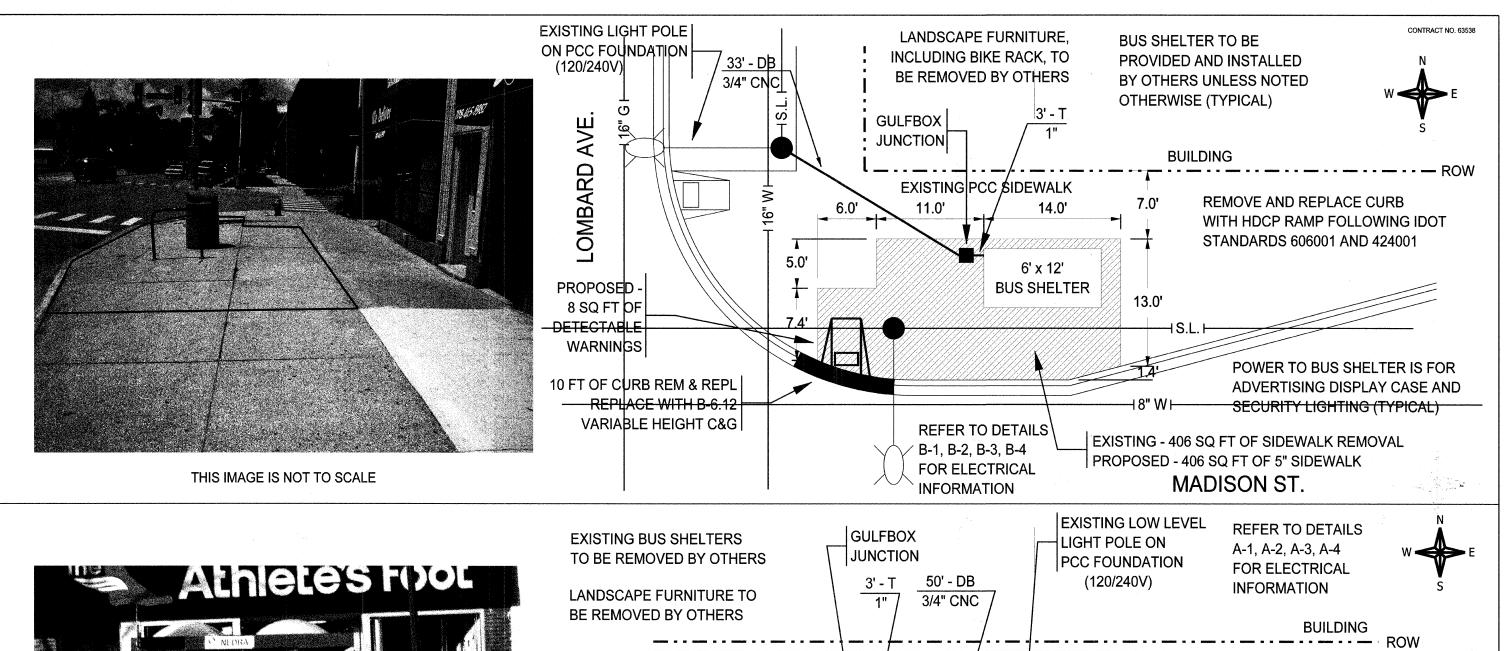


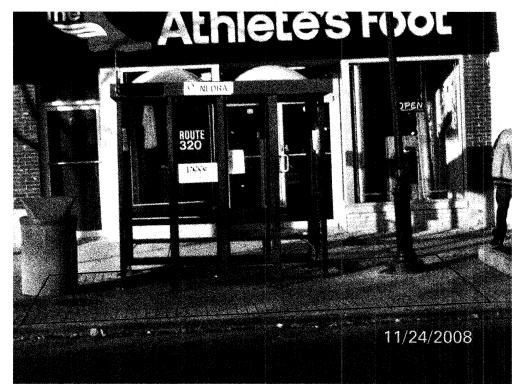


THIS IMAGE IS NOT TO SCALE

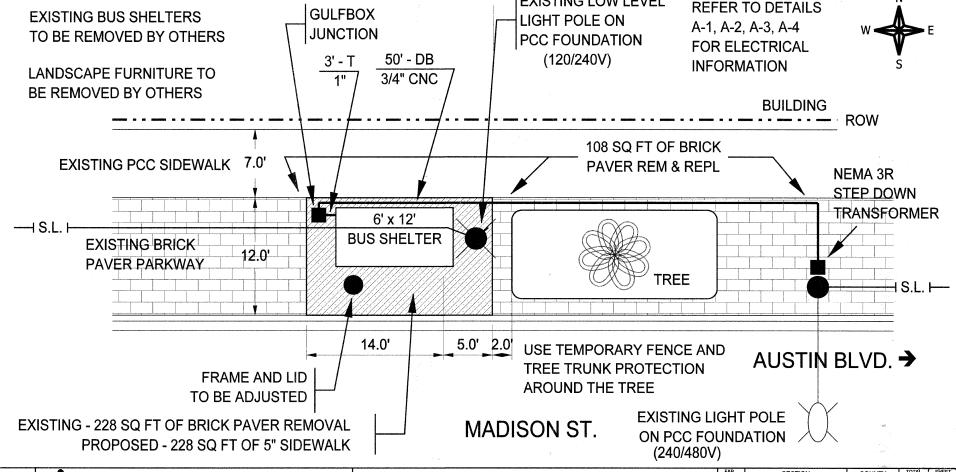


FILENAME = plan\_sheet\_6C\_rev.do USER NAME = KOPERNIAK DESIGNED BY: KOPERNIAK REVISED: 03/31/2011 10. Madison Street at Lombard Avenue11. Madison Street, west of Austin Boulevard **PROPOSED** REVISED: 04/11/2011 VILLAGE OF OAK PARK CHECKED BY: BUDRICK PLOT SCALE = 1" = 5" REVISED: CONTRACT NO. SHEET NO. OF SHEETS STA. PLOT DATE = MAR 1, 2011 ILLINOIS FED. AID PROJECT

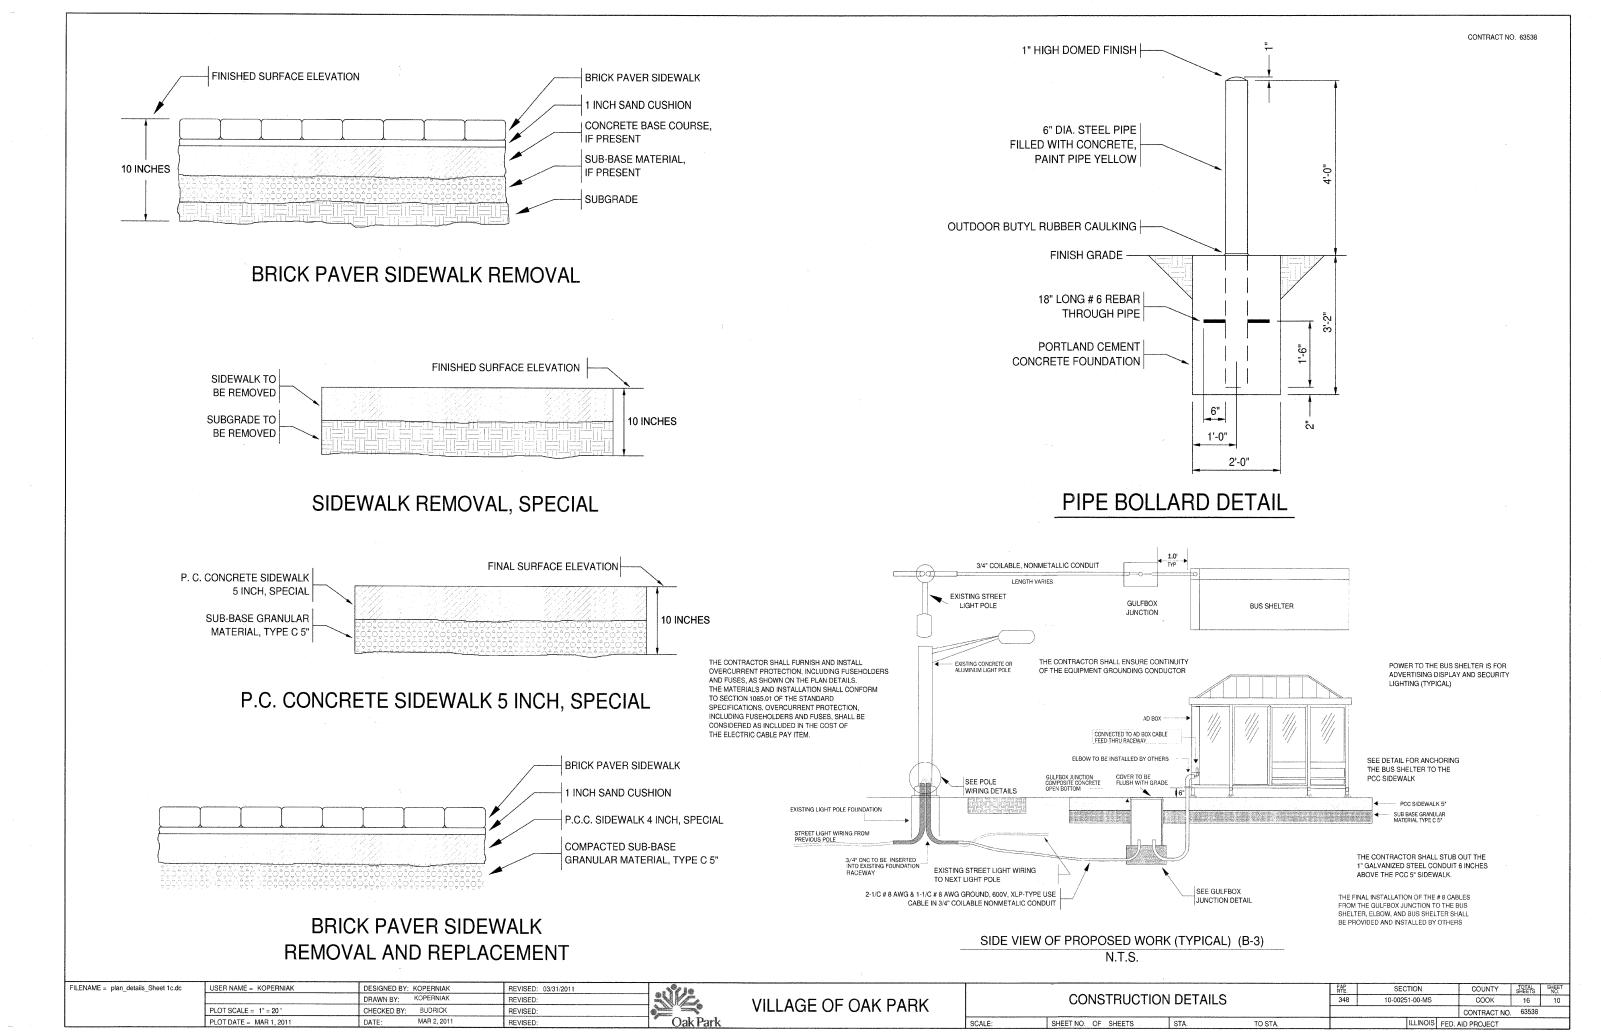

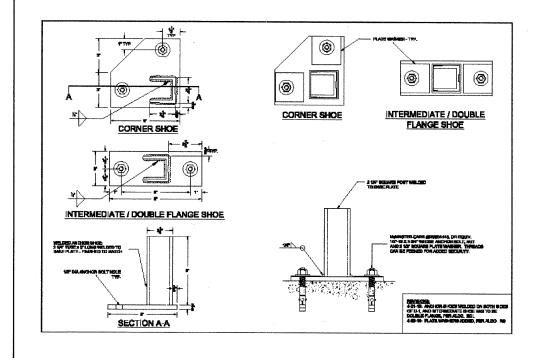

# EXISTING WIRING IS #8 AWG, 600V TYPE RHW (TYP.) FUSEHOLDER FUSEHOLDER LIGHT POLE LIGHT POLE LIGHT POLE A4" CONDUIT, COILABLE, NOMMETALLIC, INSERTED INTO EXISTING CONDUIT FOUNDATION EXISTING POLE WIRING DETAIL (B-1) N.T.S.


# STILL NEEDS TO BE MODIFIED

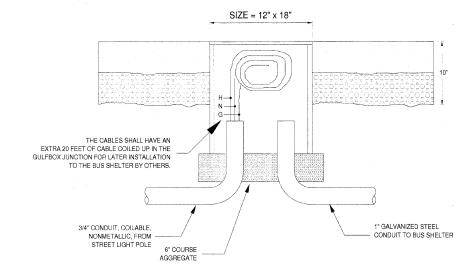



THE CONTRACTOR SHALL FURNISH AND INSTALL OVERCURRENT PROTECTION, INCLUDING FUSEHOLDERS AND FUSES, AS SHOWN ON THE PLAN DETAILS. THE MATERIALS AND INSTALLATION SHALL CONFORM TO SECTION 1085.01 OF THE STANDARD SPECIFICATIONS. OVERCURRENT PROTECTION, INCLUDING FUSEHOLDERS AND FUSES, SHALL BE CONSIDERED AS INCLUDED IN THE COST OF THE ELECTRIC CABLE PAY ITEM.

GULFBOX JUNCTION DETAIL (B-2) N.T.S.

### BUS SHELTER ANCHOR SHOE DETAIL

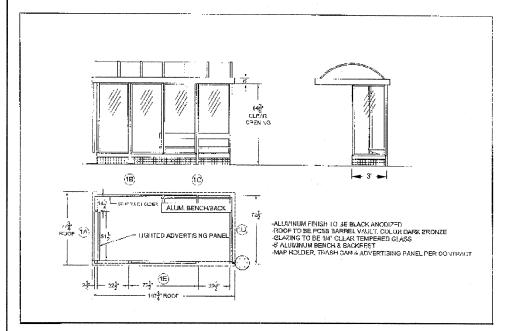

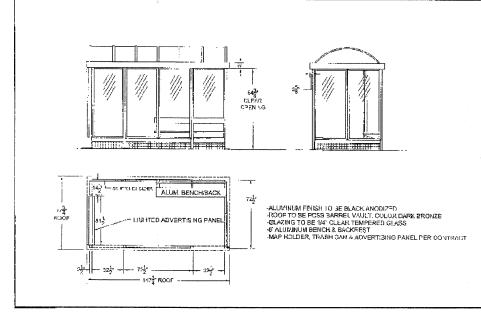

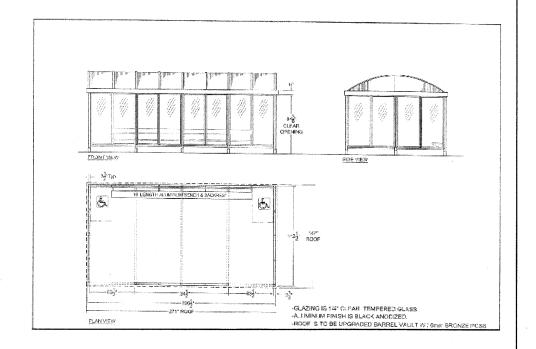


### 3' x 12' BUS SHELTER TO BE PROVIDED AND INSTALLED BY OTHERS

6' x 12' BUS SHELTER TO BE PROVIDED AND INSTALLED BY OTHERS

12' x 22' BUS SHELTER TO BE PROVIDED AND INSTALLED BY CONTRACTOR

- 1	FILENAME = plan_details_sheet 2c.dc	USER NAME = KOPERNIAK	DESIGNED BY:	KOPERNIAK	REVISED: 03/31/2011					*		FAP RTE.	SECTION	COUNTY	TOTAL SHEET NO.
- 1			DRAWN BY:	KOPERNIAK	REVISED:		VILLAGE OF OAK PARK		CONSTRUCTIO	N DETAILS		348	10-00251-00-MS	COOK	16 11
- 1		PLOT SCALE = N.T.S.	CHECKED BY:	BUDRICK	REVISED:	(a)	VILLAGE OF OAK FANK			_				CONTRACT NO	O. 63538
Į		PLOT DATE = MAR 1, 2011	DATE:	MAR 2, 2011	REVISED:	Oak Park		SCALE:	SHEET NO. XX OF XX SHEETS	STA.	TO STA.		ILLINOIS FED	. AID PROJECT	

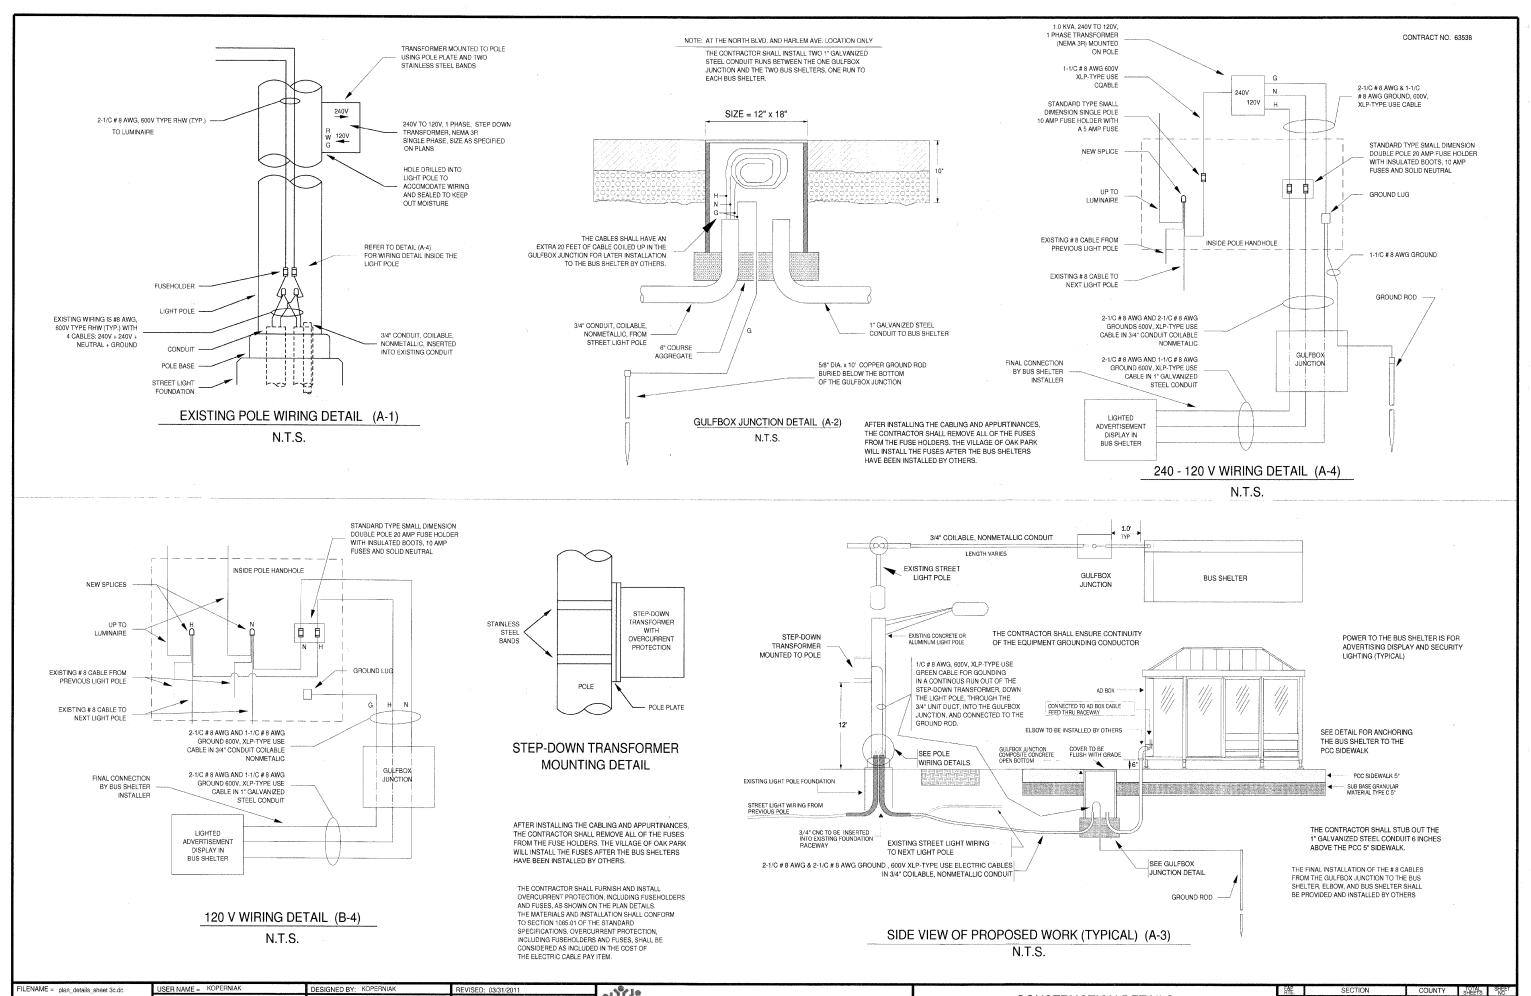

 USER NAME =
 KOPERNIAK
 DESIGNED BY:
 KOPERNIAK
 REVISED:
 03/31/2011


 PLOT SCALE =
 N.T.S.
 CHECKED BY:
 BUDRICK
 REVISED:

 PLOT DATE =
 MAR 2, 2011
 DATE:
 MAR 2, 2011
 REVISED:

V Park

VILLAGE OF OAK PARK CONSTRUCTION DE

	FAP RTE.	SECTION	COUNTY	TOTAL SHEETS	SHEET NO.	
CONSTRUCTION DETAILS		348	10-00251-00-MS	COOK	16	12
				CONTRACT NO	. 63538	
SHEET NO. OF SHEETS	STA. TO STA.		ILLINOIS FED.	AID PROJECT		

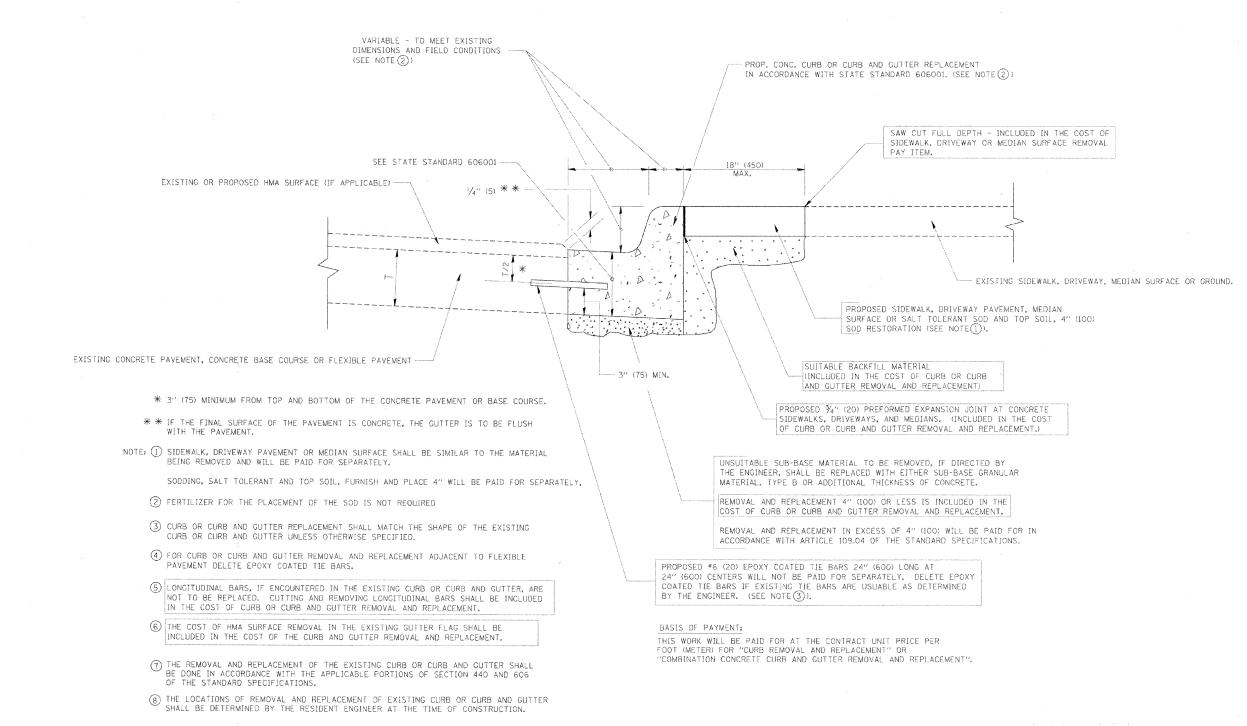


FILENA	AME =		
	13_plan_dea	atils_template	_bd24.dc


USER NAME = KOPERNIAK	DESIGNED BY:	KOPERNIAK	REVISED:
	DRAWN BY:	KOPERNIAK	REVISED:
PLOT SCALE = N.T.S.	CHECKED BY:	BROWN	REVISED:
 PLOT DATE = MAR 4, 2011	DATE:	MAR 3, 2011	REVISED:



SHEET NO. XX OF XX SHEETS

AU.	SECTION	COUNTY	TOTAL SHEETS	SHEET NO.				
348	10-00251-00-MS	COOK	16	13				
CONTRACT NO.63538								
ILLINOIS FED. AID PROJECT								

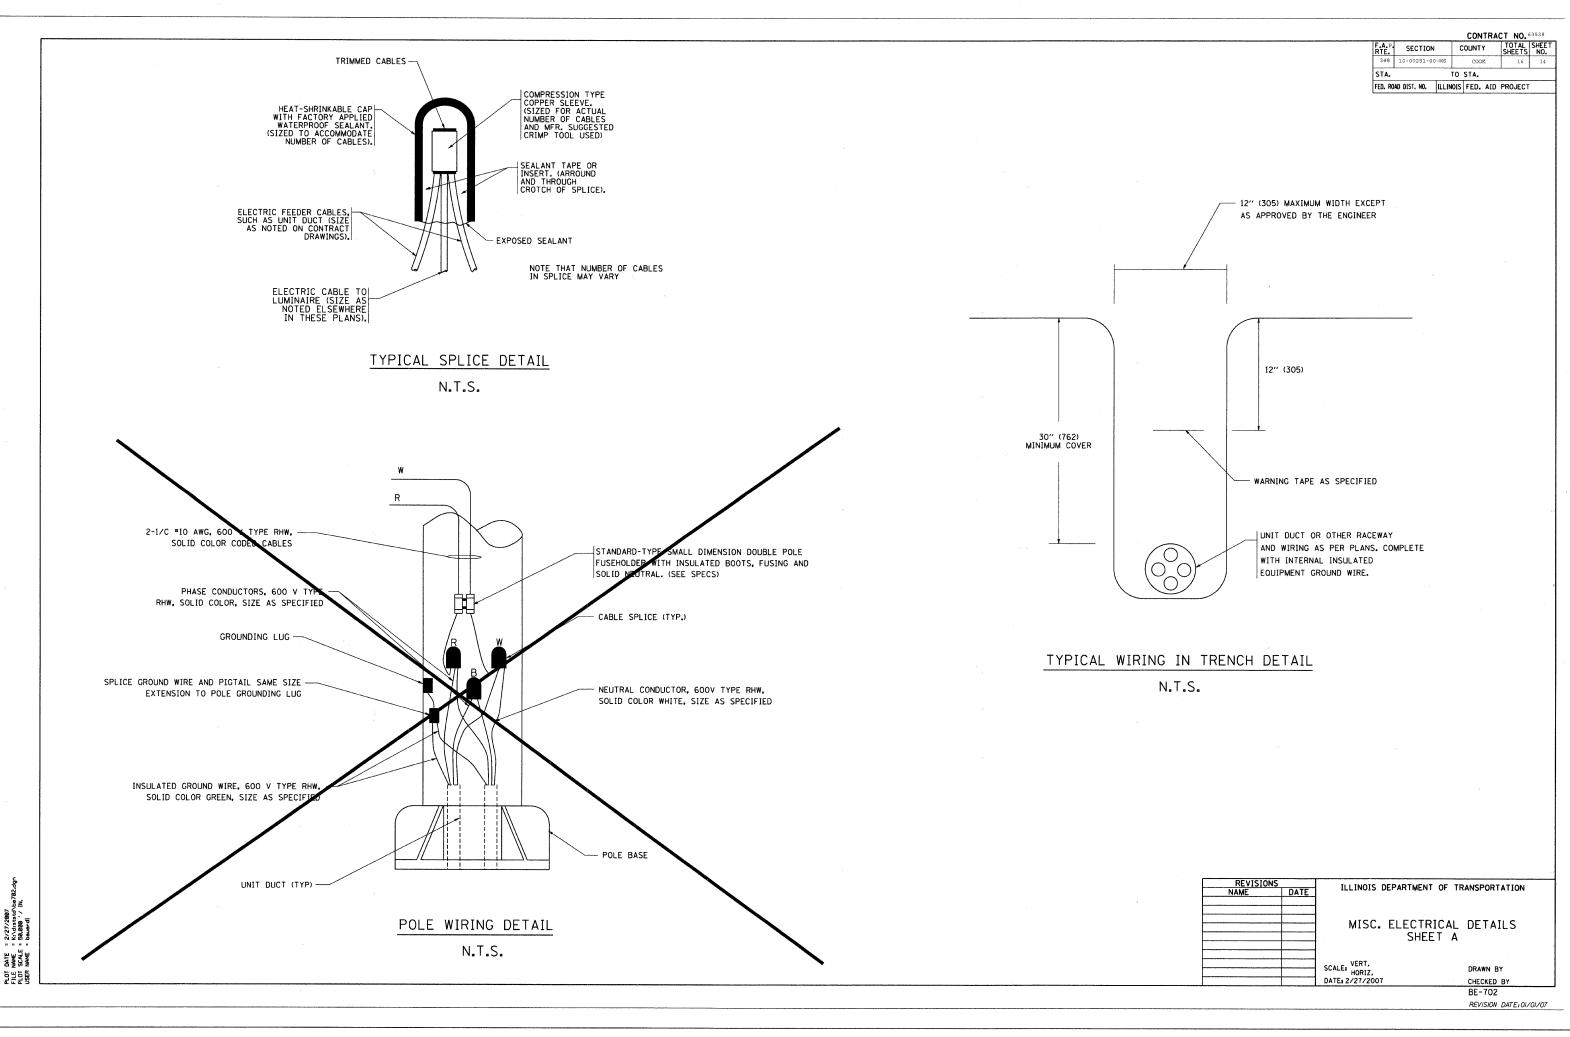

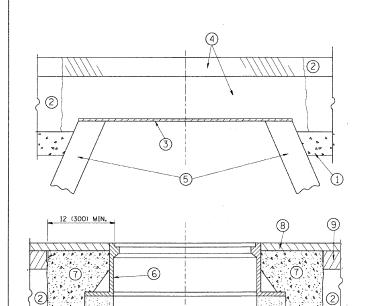

7

EXISTING BROKEN FRAMES AND LIDS SHALL BE REMOVED AND DISPOSED OF BY THE CONTRACTOR AND SHALL BE REPLACED AS DIRECTED BY THE ENGINEER. REPLACEMENT FRAMES AND LIDS WILL BE PAID FOR IN ACCORDANCE WITH ARTICLE 109.04 OF THE STANDARD SPECIFICATIONS UNLESS A SEPARATE PAY ITEM HAS BEEN PROVIDED.

PROPOSED

BRICK, MORTAR, OR CONC. ADJUSTING RINGS

IF THE EXISTING LIDS ARE OPEN, THE FRAME WILL BE ADJUSTED TO THE ELEVATION OF THE MILLED PAVEMENT SURFACE PRIOR TO THE MILLING OPERATION. THE FRAME WILL NOT BE REMOVED AND COVERED BY THE METAL PLATE.

CITY OF CHICAGO CASTINGS ARE THE PROPERTY OF THE CITY AND THE CONTRACTOR SHALL NOTIFY THE CITY FOR REMOVAL AND DISPOSITION OF THE CASTINGS.

THE METAL PLATE USED TO COVER THE STRUCTURE SHALL REMAIN THE PROPERTY OF THE CONTRACTOR.

WHEN STRUCTURES ARE TO BE ADJUSTED OR RECONSTRUCTED, THE LOWERING AND RAISING OF THE FRAMES AND LIDS WILL NOT BE PAID FOR SEPARATELY BUT WILL BE INCLUDED IN THE COST OF THE CORRESPONDING PAY ITEM.

### CONSTRUCTION PROCEDURES

### STAGE 1 (BEFORE PAVEMENT MILLING)

- A) REMOVE A MINIMUM OF 12 (300) OF THE PAVEMENT FROM
- AROUND THE STRUCTURE.
  B) REMOVE THE EXISTING FRAME AND LID FROM THE STRUCTURE.
- C) COVER THE STRUCTURE OPENING WITH A 36 (900) DIAMETER METAL PLATE.

  D) BACKFILL WITH CRUSHED STONE AND A MINIMUM 11/2 (40)
- THICK HMA SURFACE MIX APPROVED BY THE ENGINEER.

### STAGE 2 (AFTER PAVEMENT MILLING)

- A) REMOVE THE HMA SURFACE MIX AND CRUSHED STONE.
- B) INSTALL THE FRAME AND LID; ADJUST THE FRAME TO ITS FINAL SURFACE ELEVATION.
- C) THE SURROUNDING SPACE SHALL BE FILLED WITH CLASS PP-1\*
  CONCRETE TO THE ELEVATION OF THE SURFACE OF THE EXISTING BASE COURSE OR THE BINDER COURSE.
- st unless otherwise specified in the plans.

THE PROCEDURE EXPLAINED ABOVE SHALL CONFORM TO THE APPLICABLE PORTIONS OF SECTIONS 353, 406. 602, AND 603 OF THE STANDARD SPECIFICATIONS.

### LEGEND

- 1 SUB-BASE GRANULAR MATERIAL
- (6) FRAME AND LID (SEE NOTES)
- 2 EXISTING PAVEMENT
- (7) CLASS PP-1\* CONCRETE

- 3 36 (900) DIAMETER METAL PLATE PROPOSED CRUSHED STONE AND HMA SURFACE MIX
- 8 PROPOSED HMA SURFACE COURSE
- (5) EXISTING STRUCTURE
- (9) PROPOSED HMA BINDER COURSE

### LOCATION OF STRUCTURES:

THE CONTRACTOR WILL BE REQUIRED TO KEEP A RECORD OF THE LOCATIONS OF THE BURIED STRUCTURES ACCORDING TO THE STATION AND DISTANCE LEFT OR RIGHT OF THE CENTERLINE OF PAVEMENT. UPON COMPLETION OF THE WORK, THE CONTRACTOR WILL DELIVER THE RECORD TO THE ENGINEER.

BASIS OF PAYMENT: THIS WORK WILL BE PAID FOR AT THE CONTRACT UNIT PRICE PER EACH FOR "FRAMES AND LIDS TO BE ADJUSTED, SPECIAL" NEW FRAMES AND LIDS, WHEN SPECIFIED, WILL BE PAID FOR SEPARATELY.

### DETAILS FOR FRAMES AND LIDS ADJUSTMENT WITH MILLING

ALL DIMENSIONS ARE IN INCHES (MILLIMETERS) UNLESS OTHERWISE SHOWN


FILE NAME =	USER NAME = leysa	DESIGNED - R. SHAH	REVISED - A. ABBAS 03-21-97
o:/pw.work/pw:dot/leysa/d0108315/bd08.dg	1	DRAWN -	REVISED - R. WIEDEMAN 05-14-04
	PLOT SCALE = 49,9999 '/ IN,	CHECKED -	REVISED - R. BORO 01-01-07
	PLOT DATE = 3/18/2011	DATE - 10-25-94	REVISED - R. BORO 03-09-11

STATE OF ILLINOIS **DEPARTMENT OF TRANSPORTATION** 

	DETAILS FOR										
	FRAMES	AND	LIDS	ADJUSTN	IENT WITH	MILLING					
CALE: NONE	SHEET N	0. 1	OF 1	SHEETS	STA.	TO	ST				

SECTION COUNTY COOK CONTRACT NO. 63538 BD600-03 (BD-8) FED. ROAD DIST. NO. 1 ILLINOIS FED. AID PROJECT



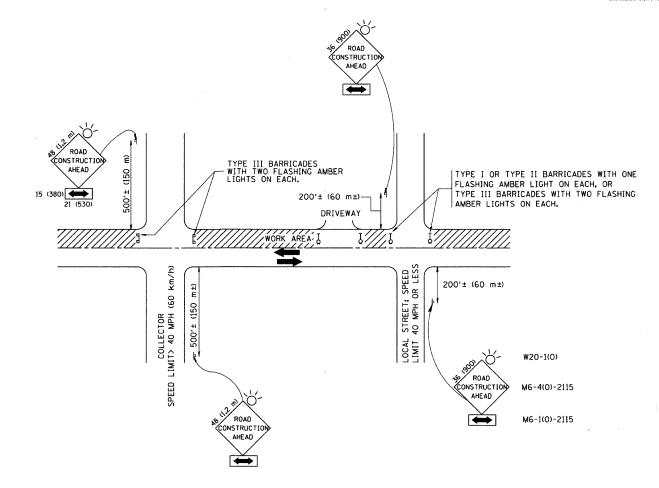

### TRAFFIC CONTROL AND PROTECTION FOR SIDE ROADS, INTERSECTIONS, AND DRIVEWAYS

### NOTES:

- A. FOR NO LANE RESTRICTION ON THE SIDE ROAD OR DRIVEWAYS
- 1. SIDE ROAD WITH A SPEED LIMIT OF 40 MPH (60 km/h) OR LESS AS SHOWN ON THE DRAWING AND AS DIRECTED BY THE ENGINEER:
- Q) ONE ROAD CONSTRUCTION AHEAD SIGN 36 x 36 (900x900) WITH A FLASHER AND FLAG MOUNTED ON IT APPROXIMATELY 200' (60 m) IN ADVANCE OF THE MAIN ROUTE.
- b) THE CLOSED PORTION OF THE MAIN ROUTE SHALL BE PROTECTED BY BLOCKING WITH TYPE I, TYPE II OR TYPE III BARRICADES, 1/3 OF THE CROSS SECTION OF THE CLOSED PORTION.
- 2. SIDE ROAD WITH A SPEED LIMIT GREATER THAN 40 MPH (60 km/h) AS SHOWN ON THE DRAWING AND AS DIRECTED BY THE ENGINEER:
- O) ONE ROAD CONSTRUCTION AHEAD SIGN 48 x 48 (1.2 m x 1.2 m) WITH A FLASHER MOUNTED ON IT APPROXIMATELY 500' (150 m) IN ADVANCE OF THE MAIN ROUTE.
- b) THE CLOSED PORTION OF THE MAIN ROUTE SHALL BE PROTECTED BY BLOCKING WITH TYPE III BARRICADES, 1/2 OF THE CROSS SECTION OF THE CLOSED PORTION.

SCALE: NONE

3. WHEN THE SIDE ROAD LIES BETWEEN THE BEGINNING OF THE MAINLINE SIGNING AND THE WORK ZONE, A SINGLE HEADED ARROW (MG-1) SHALL BE USED IN LIEU OF THE DOUBLE HEADED ARROW (MG-4).

### B. FOR A LANE CLOSURE ON A SIDE ROAD OR DRIVEWAY:

- USE APPLICABLE PORTIONS OF THE TYPICAL APPLICATION OF TRAFFIC CONTROL DEVICES (STD. 701501, STD. 701606 OR THE APPROPRIATE STANDARD), THE SPACING OF SIGNS AND BARRICADES SHALL BE ADJUSTED FOR FIELD CONDITIONS AS DIRECTED BY THE ENGINEER. THE DIRECTIONAL ARROW SHALL BE COVERED OR REMOVED WHEN NO LONGER CONSISTENT WITH THE SIDE ROAD LANE CLOSURE.
- C. ADVANCE WARNING SIGNS ARE TO BE OMITTED ON DRIVEWAY UNLESS OTHERWISE NOTED.
- D. THE TRAFFIC CONTROL AND PROTECTION FOR SIDE ROADS, INTERSECTIONS, AND DRIVEWAYS SHALL BE INCIDENTAL TO THE COST OF SPECIFIED TRAFFIC CONTROL STANDARDS OR ITEMS.

All dimensions are in millimeters (inches) unless otherwise shown.

FILE NAME =	USER NAME = gaglianobt	DESIGNED - LHA	REVISED - J. OBERLE 10-18-95
W:\diststd\22x34\tcl0.dgn		DRAWN -	REVISED - A. HOUSEH 03-06-90
	PLOT SCALE = 50.000 '/ IN.	CHECKED -	REVISED - A. HOUSEH 10-15-96
	PLOT DATE = 1/4/2008	DATE - 06-89	REVISED -T. RAMMACHER 01-06-

STATE	. OF	ILLINOIS	
DEPARTMENT	OF	TRANSPORTATION	

TR	AFFI	C	CON	ITR	OL	ANI	) P	ROTE	TION	FOR		
SIDE	ROA	DS	, IN	TE	RSE	CTIC	ONS	, AND	DRIV	EWAYS	;	
HEET	NO	1	OF	1	5	HEC 1	٠,	STA			TO	STA

RTÉ.	SECTION	COUNTY	SHEETS	SHE	
348	10-00251-00-MS	COOK	16	16	
	TC-10	CONTRACT	NO.	635	
FED. R	OAD DIST, NO. 1   ILLINOIS FED. A	ID PROJECT			