


EXISTING CONDITIONS

- (A) HMA SURFACE COURSE (7-1/2" +/-)
- (B) PARTIALLY REINFORCED P.C.C. PAVEMENT (9'-6"-9')
- (C) HMA SURFACE COURSE (4")
- (D) AGGREGATE SHOULDER (WEDGE)
- (E) GRASSED SURFACE
- (F) SUBGRADE (MATERIAL VARIES)
- (G) COMBINATION CONCRETE CURB AND GUTTER, TYPE B-6.24
- (H) HMA SURFACE TREATMENT (7-1/2" +/-)
- (I) GRAVEL OR CRUSHED STONE SURFACE COURSE, TYPE C (8" MIN.) THICKNESS INCREASED WHERE REQUIRED BY SOIL CONDITIONS
- (J) HMA SHOULDER
- (K) HMA PAVEMENT (4-1/2")
- (L) AGGREGATE BASE COURSE

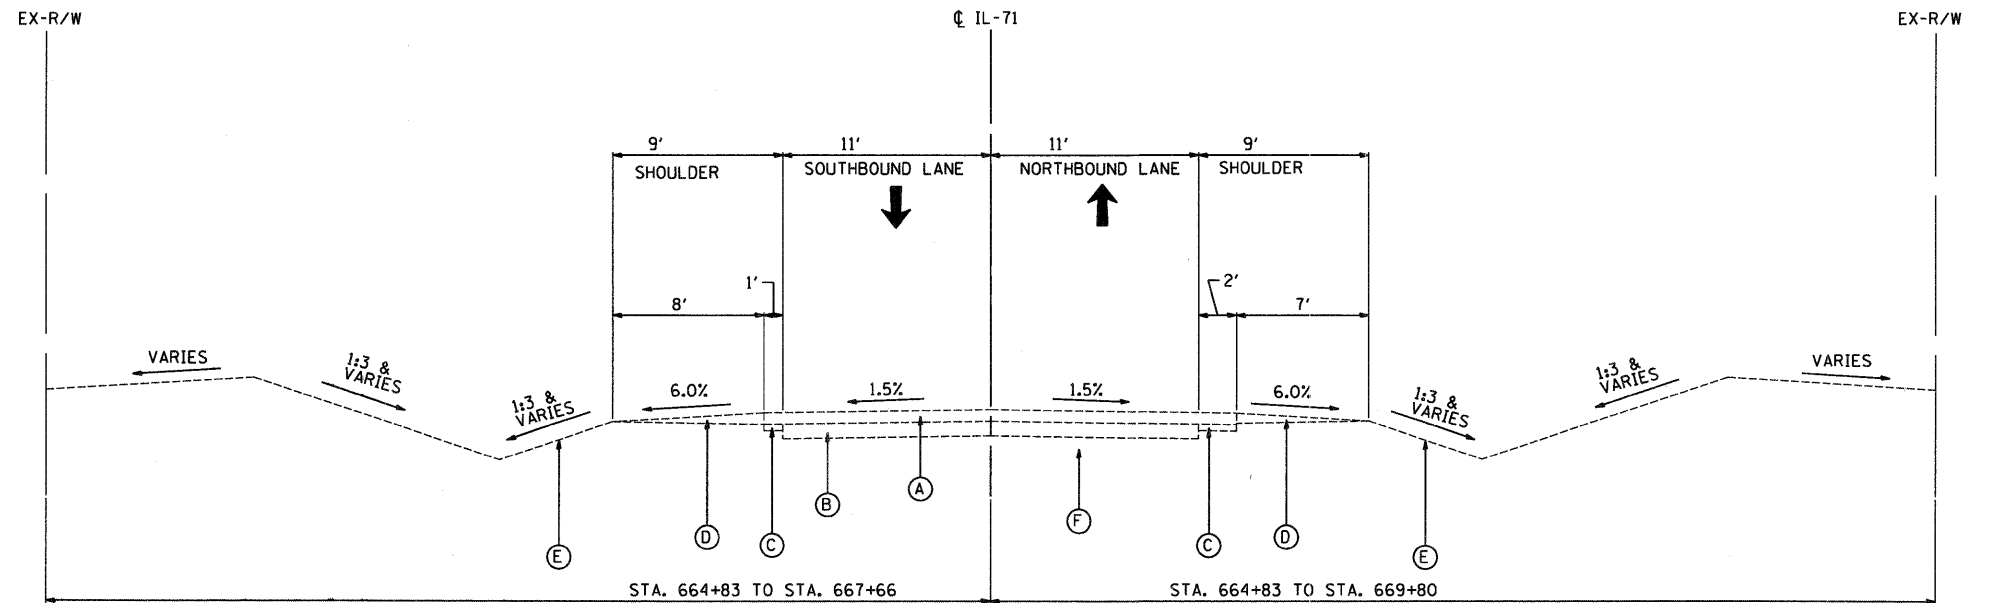


EXISTING TYPICAL SECTION **2E**
ILLINOIS-71
NOTE: EXISTING SLOPES SHOWN ARE APPROXIMATE

SEE ABOVE FOR APPLICABLE STATIONS

PROPOSED LEGEND

- (1) HMA SURFACE COURSE, MIX "D", N70; 1-1/2" (INSTALLED FOLLOWING STAGE 2)
- (2) HMA BINDER COURSE, IL-19.0, N70; 6-1/2"
- (3) PAID AS AGGREGATE SHOULDER, TYPE B; 8"
- (31) AGGREGATE SHOULDER, TYPE B; 6-1/2"
- (32) AGGREGATE SHOULDER, TYPE B; 1-1/2" (INSTALLED FOLLOWING PLACEMENT OF HMA SURFACE COURSE)
- (33) AGGREGATE WEDGE SHOULDER, TYPE B (INSTALLED FOLLOWING PLACEMENT OF HMA SURFACE COURSE)
- (4) SEEDING (CLASS 2A) WITH EROSION CONTROL BLANKET & VEGETATIVE SUSTAINING SOIL; 4"
- (5) GUARDRAIL (SEE PLAN FOR TYPE) (INSTALLED FOLLOWING PLACEMENT OF HMA SURFACE COURSE)
- (6) HMA BASE COURSE WIDENING; 11-1/2"
- (7) SUB-BASE GRANULAR MATERIAL, TYPE A; 6"
- (8) SUB-BASE GRANULAR MATERIAL, TYPE C (SEE NOTES ON ROADWAY PLAN)
- (9) HMA BASE COURSE WIDENING; 9"
- (10) STRIP REFLECTIVE CRACK CONTROL TREATMENT
- (11) LEVELING BINDER (MACHINE METHOD), N70, 3/4" MIN. (INSTALLED FOLLOWING STAGE 2)
- (12) HMA BINDER COURSE, IL-19.0, N70; 5-3/4"
- (13) TEMPORARY PAVEMENT HMA BINDER COURSE, IL-19.0, N70; 8"

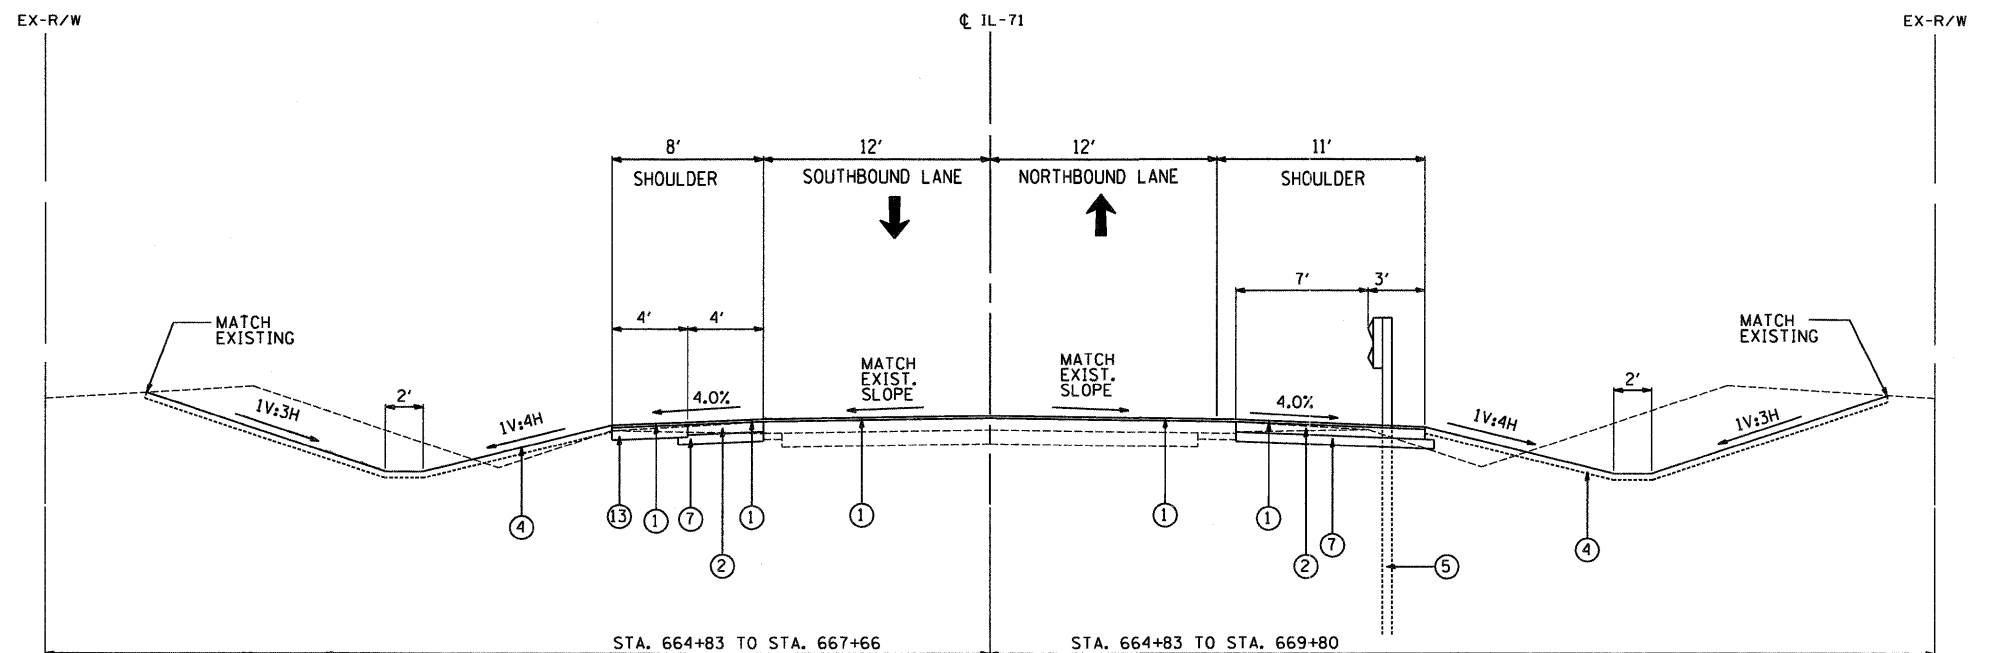

PROPOSED TYPICAL SECTION **2P**
ILLINOIS-71

SEE ABOVE FOR APPLICABLE STATIONS

STATE OF ILLINOIS
DEPARTMENT OF TRANSPORTATION

FAP 311 (IL 71) AT VAN EMMON / RESERVATION ROADS
TYPICAL SECTIONS

SCALE: N.T.S. SHEET NO. -- OF -- SHEETS

F.A.P. RTE.	SECTION	COUNTY	TOTAL SHEETS	SHEET NO.
311	(1-1)N TS	KENDALL	92	7
CONTRACT NO. 66955				
ILLINOIS FED. AID PROJECT				