
EXISTING CONDITIONS

- A HMA SURFACE COURSE (7-1/2" +/-)
- B PARTIALLY REINFORCED P.C.C. PAVEMENT (9"-6"-9")
- C HMA SURFACE COURSE (4")
- D AGGREGATE SHOULDER (WEDGE)
- (E) GRASSED SURFACE
- F SUBGRADE (MATERIAL VARIES)
- G COMBINATION CONCRETE CURB AND GUTTER, TYPE B-6.24
- (H) HMA SURFACE TREATMENT (7-1/2" +/-)
- ① GRAVEL OR CRUSHED STONE SURFACE COURSE, TYPE C (8" MIN.) THICKNESS INCREASED WHERE REQUIRED BY SOIL CONDITIONS
- (J) HMA SHOULDER
- K HMA PAVEMENT (4-1/2")
- AGGREGATE BASE COURSE

PROPOSED LEGEND

- ① HMA SURFACE COURSE, MIX "D", N70; 1-1/2" (INSTALLED FOLLOWING STAGE 2)
- (2) HMA BINDER COURSE, IL-19.0, N70; 6-1/2"
- 3)3233 PAID AS AGGREGATE SHOULDER, TYPE B; 8"
 - 31) AGGREGATE SHOULDER, TYPE B; 6-1/2"
 - AGGREGATE SHOULDER, TYPE B; 1-1/2"
 (INSTALLED FOLLOWING PLACEMENT OF HMA SURFACE COURSE)
 - AGGREGATE WEDGE SHOULDER, TYPE B (INSTALLED FOLLOWING PLACEMENT OF HMA SURFACE COURSE)
 - SEEDING (CLASS 2A) WITH EROSION CONTROL
 BLANKET & VEGETATIVE SUSTAINING SOIL; 4"
 - GUARDRAIL (SEE PLAN FOR TYPE)
 (INSTALLED FOLLOWING PLACEMENT
 OF HMA SURFACE COURSE)
 - 6 HMA BASE COURSE WIDENING: 11-1/2"
 - SUB-BASE GRANULAR MATERIAL, TYPE A; 6"
 - 8 SUB-BASE GRANULAR MATERIAL, TYPE C (SEE NOTES ON ROADWAY PLAN)
 - (9) HMA BASE COURSE WIDENING; 9"
 - STRIP REFLECTIVE CRACK CONTROL TREATMENT
 - (I) LEVELING BINDER (MACHINE METHOD), N70, 3/4" MIN. (INSTALLED FOLLOWING STAGE 2)
 - (12) HMA BINDER COURSE, IL-19.0, N70; 5-3/4"
 - TEMPORARY PAVEMENT
 HMA BINDER COURSE, IL-19.0, N70; 8"

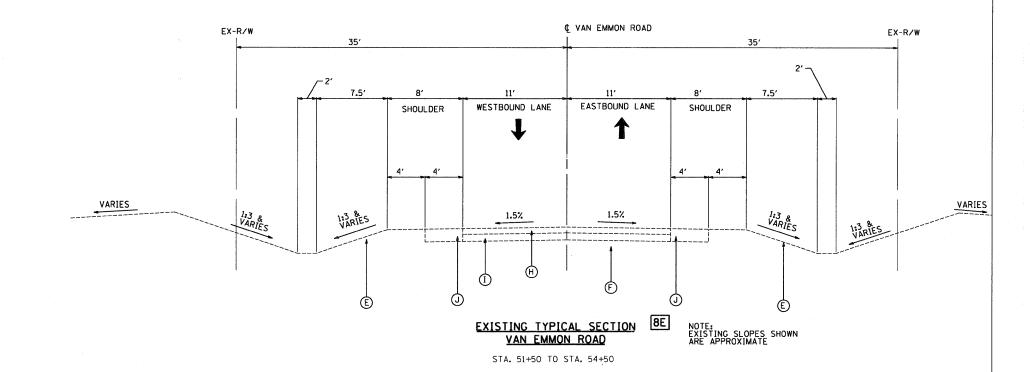

EX-R/W

35'

II'

WESTBOUND LANE

EASTBOUND LANE

EASTBOUND LANE

EASTBOUND LANE

EASTBOUND LANE

EXTCH

EXISTING

EXTEND

MATCH

EXISTING

EXTEND

TO STA. 51+50 TO STA. 54+50

FILE NAME =

STATE OF ILLINOIS
DEPARTMENT OF TRANSPORTATION

FAP 311 (IL 71) AT VAN EMMON / RESERVATION ROADS
TYPICAL SECTIONS

SCALE: N.T.S. SHEET NO. -- OF -- SHEETS

1800 DOIA

028-08/cad/site/dgn/00/D366955-sht-J5:24 PM

300570057700