LEGEND - TRAFFIC CONTROL ITEMS

DRUM WITH MONODIRECTIONAL FLASHING LIGHT




DOUBLE VERTICAL PANEL WITH FLASHING LIGHT



TEMPORARY PAVEMENT MARKING (TYPE AS SPECIFIED ON STAGING PLANS)

- TEMPORARY AGGREGATE WEDGES SHALL BE PLACED AT DROP-OFF AREAS IN ACCORDANCE WITH SUB-PART K OF THE WORK ZONE SAFETY SUPPLEMENTAL POLICY (IDOT DESIGN POLICY TO MINIMIZE DROP-OFF EXPOSURE).
- DRUMS WITH MONODIRECTIONAL LIGHTS SHALL BE PLACED AT PROPOSED GUARDRAIL LOCATIONS FOLLOWING COMPLETION OF EACH RESPECTIVE STAGE AND SHALL REMAIN IN PLACE UNTIL INSTALLATION OF PROPOSED GUARDRAIL. SEE ROADWAY PLANS FOR GUARDRAIL LOCATIONS.
- TRAFFIC CONTROL DURING STAGE 1 SHALL FOLLOW HIGHWAY STANDARD 701326 AND THE STAGE 1 DETAILS IN THE PLANS. THIS WORK SHALL BE PAID FOR AS TRAFFIC CONTROL AND PROTECTION, STANDARD 701326.
- TRAFFIC CONTROL DURING STAGE 2 SHALL BE AS SHOWN IN THE STAGE 2 PLAN DETAILS AND PAID FOR AS TRAFFIC CONTROL AND PROTECTION, (SPECIAL).
- AGGREGATE SURFACE COURSE, TYPE B SHALL BE USED TO CONSTRUCT DROP-OFF TEMPORARY AGGREGATE WEDGES AND TEMPORARY ACCESS DRIVES DURING CONSTRUCTION.

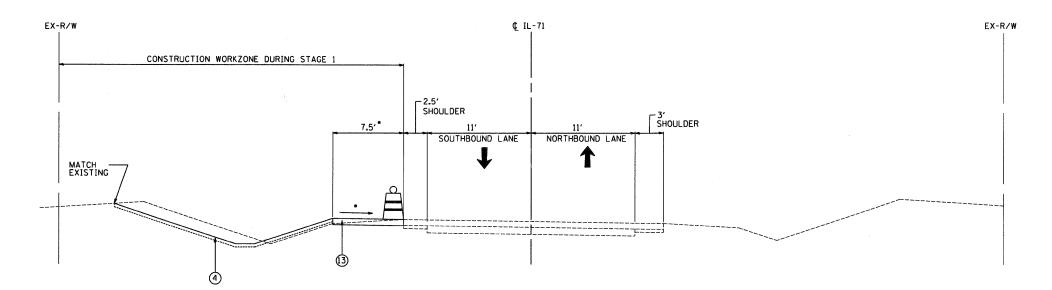


PROPOSED TYPICAL SECTION 7-S1 ILLINOIS-71 STAGE 1

SUPERELEVATED PAVEMENT SHALL MATCH EXISTING SLOPES, SEE CROSS SECTIONS.

STA. 680+50 TO STA. 683+20

PROPOSED LEGEND

- HMA SURFACE COURSE, MIX "D", N70; 1-1/2" (INSTALLED FOLLOWING STAGE 2)
- HMA BINDER COURSE, IL-19.0, N70; 6-1/2"
- 3)3233 PAID AS AGGREGATE SHOULDER, TYPE B; 8"
 - (3) AGGREGATE SHOULDER, TYPE B; 6-1/2"
 - AGGREGATE SHOULDER, TYPE B: 1-1/2"
 (INSTALLED FOLLOWING PLACEMENT OF HMA SURFACE COURSE)
 - AGGREGATE WEDGE SHOULDER, TYPE B (INSTALLED FOLLOWING PLACEMENT OF HMA SURFACE COURSE)
 - SEEDING (CLASS 2A) WITH EROSION CONTROL BLANKET & VEGETATIVE SUSTAINING SOIL; 4"
 - GUARDRAIL (SEE PLAN FOR TYPE) (INSTALLED FOLLOWING PLACEMENT OF HMA SURFACE COURSE)
 - HMA BASE COURSE WIDENING; 11-1/2" 6
 - SUB-BASE GRANULAR MATERIAL, TYPE A: 6"
 - SUB-BASE GRANULAR MATERIAL, TYPE C (SEE NOTES ON ROADWAY PLAN) 8
 - HMA BASE COURSE WIDENING; 9"
 - STRIP REFLECTIVE CRACK CONTROL TREATMENT
 - LEVELING BINDER (MACHINE METHOD), N70, $3/4^{\prime\prime}$ MIN. (INSTALLED FOLLOWING STAGE 2) (11)
 - HMA BINDER COURSE, IL-19.0, N70; 5-3/4"
 - TEMPORARY PAVEMENT HMA BINDER COURSE, IL-19.0, N70; 8"

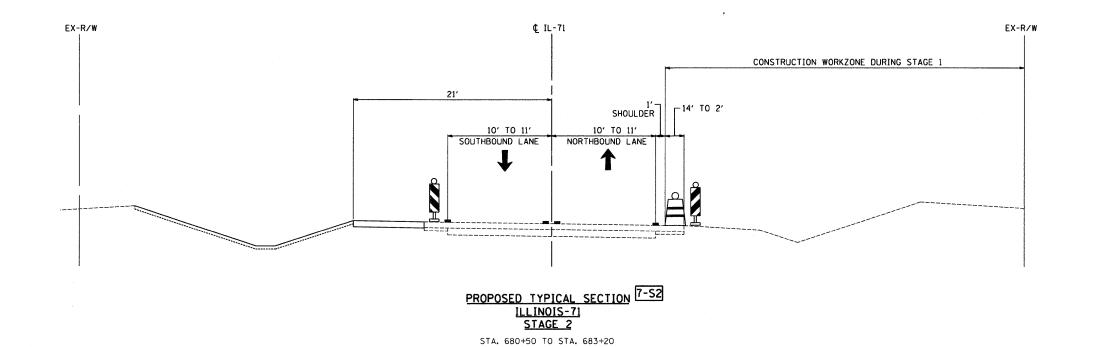

USER NAME = _USER_ DESIGNED - JWB REVISED DRAWN JWB REVISED PLOT SCALE = 5.0000 '/ IN. CHECKED - RS REVISED PLOT DATE = 3/31/2011 DATE - 03/31/2011 REVISED

FAP 311 (IL 71) AT VAN EMMON / RESERVATION ROADS SUGGESTED STAGING AND TRAFFIC CONTROL - TYPICAL SECTIONS SCALE: N.T.S. SHEET NO. -- OF -- SHEETS

COUNTY TOTAL SHEE SHEETS NO. SECTION (1-1)N TS KENDALL 92 41 CONTRACT NO. 66955 ILLINOIS FED. AID PROJECT

FILE NAME =

STATE OF ILLINOIS **DEPARTMENT OF TRANSPORTATION**