



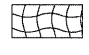
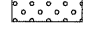
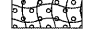
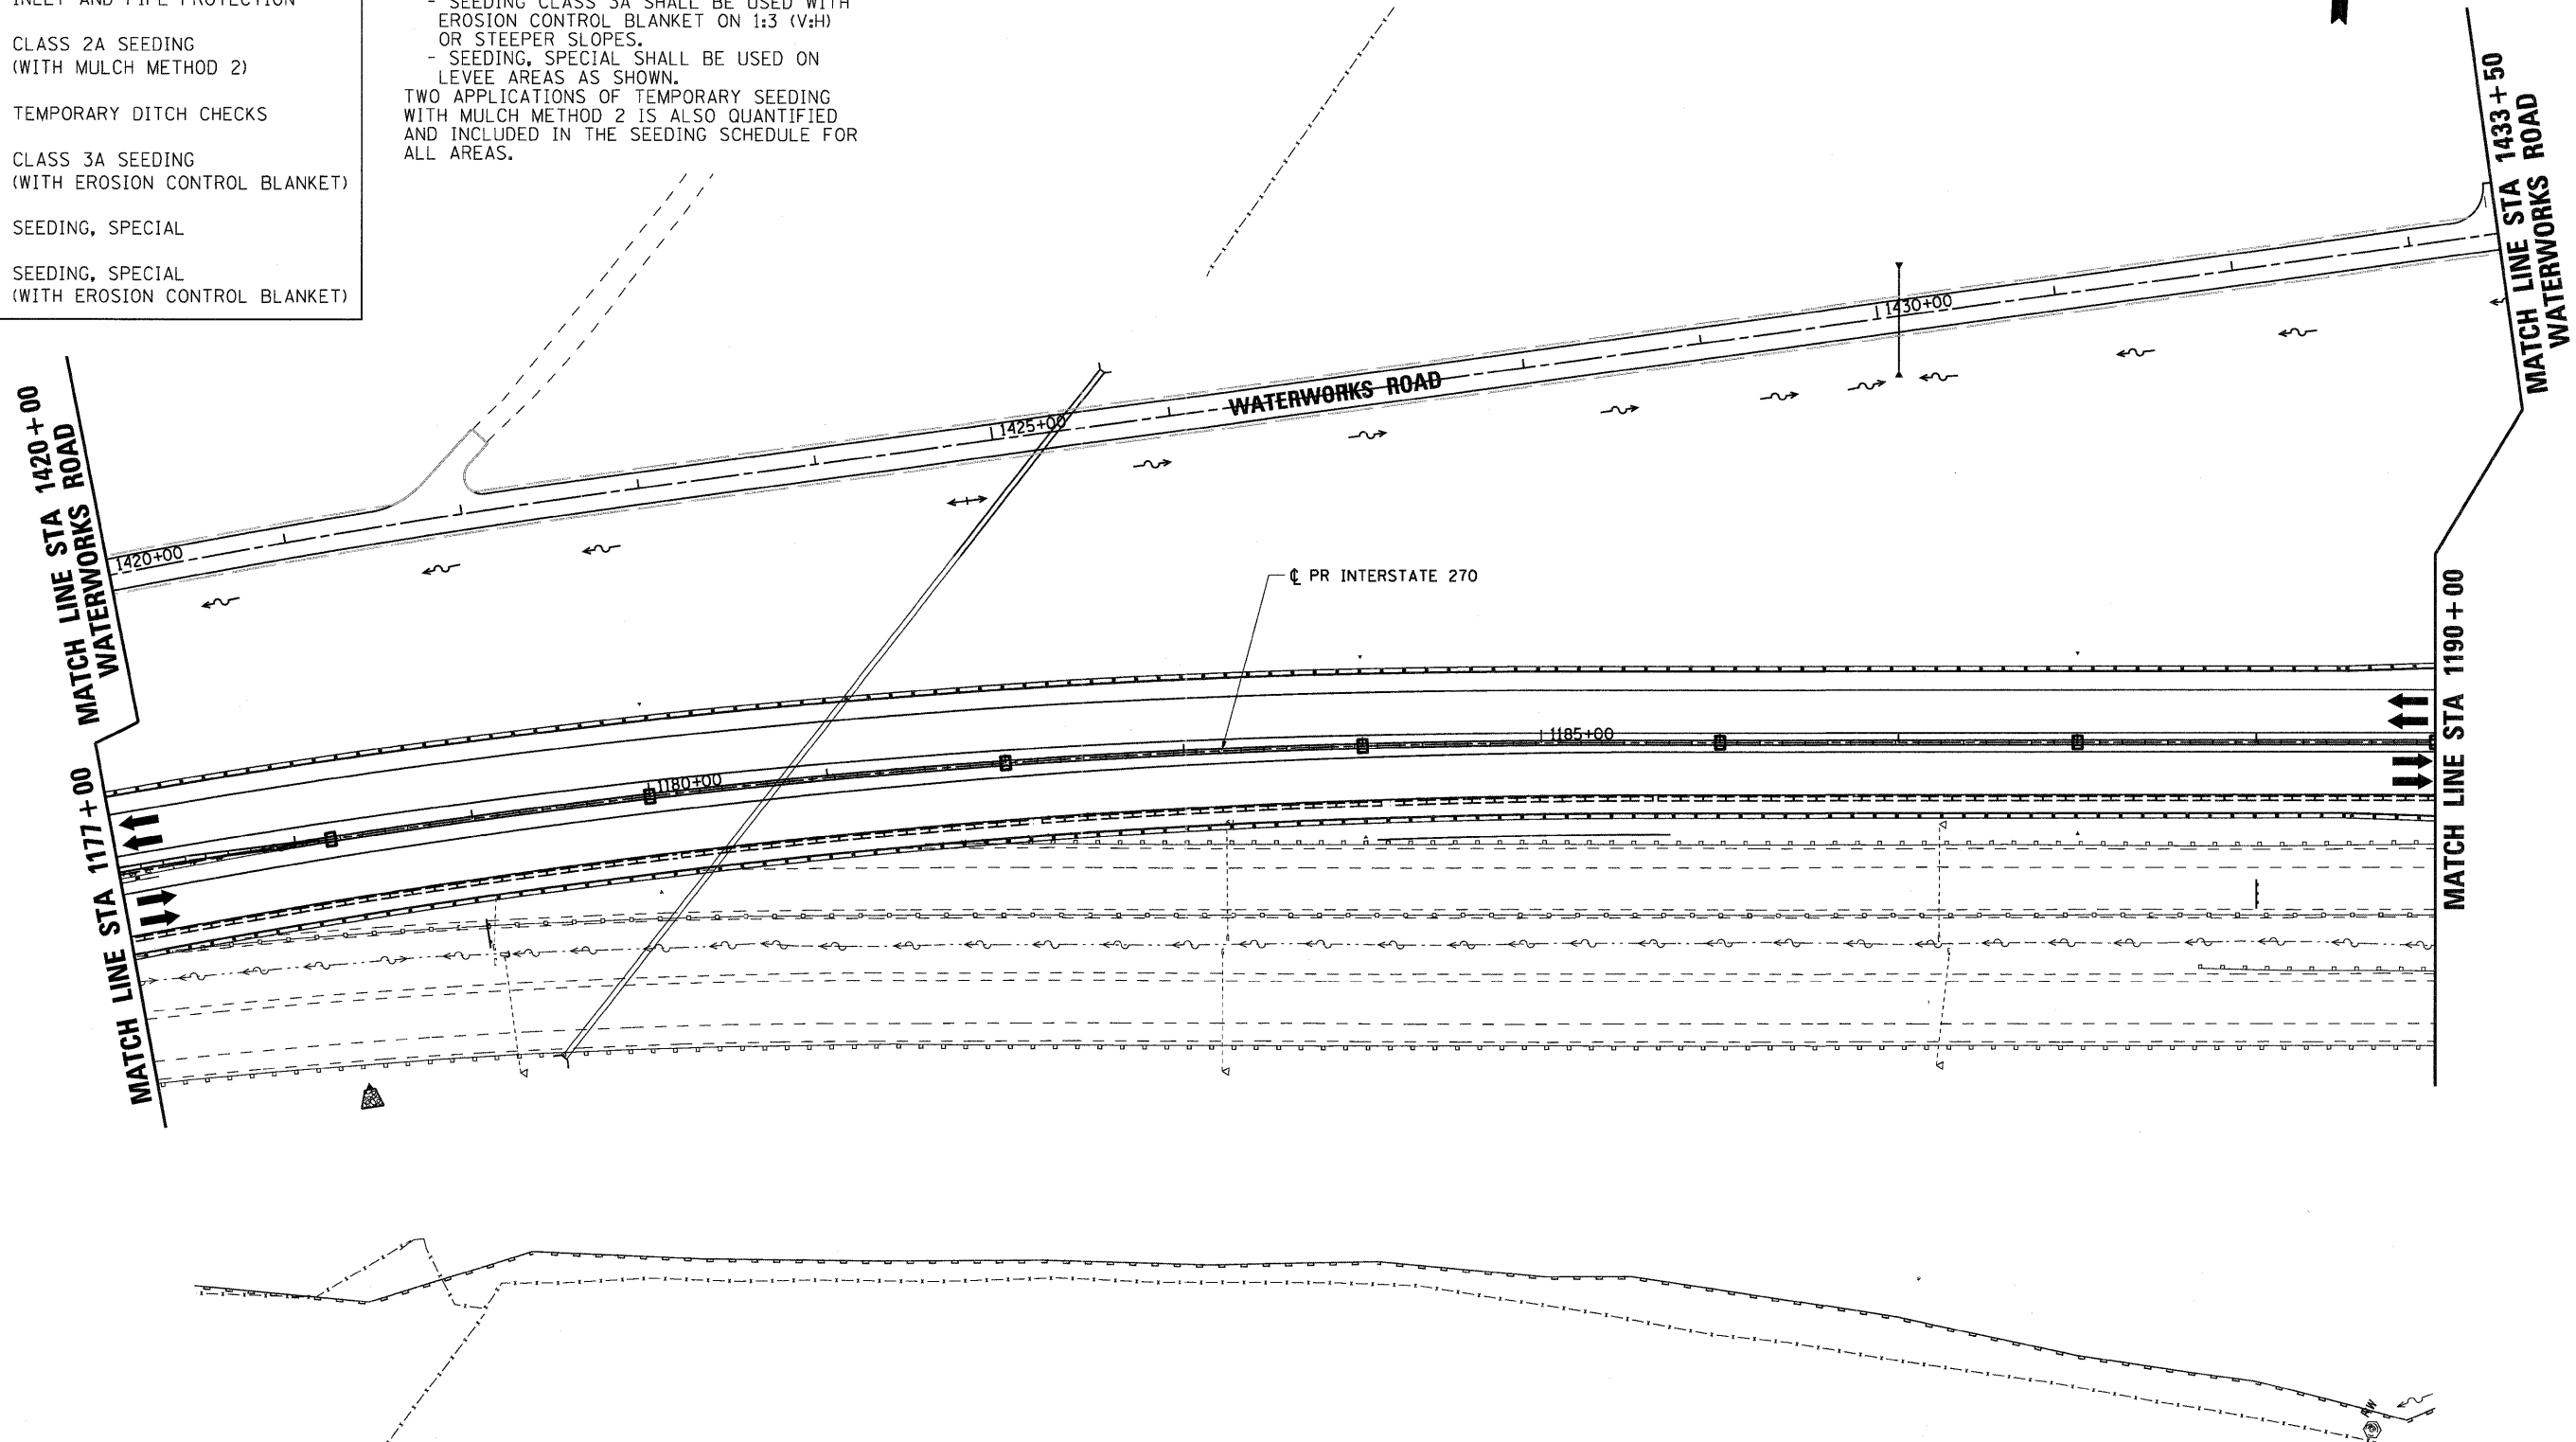


LEGEND

-  PERIMETER EROSION BARRIER
-  INLET AND PIPE PROTECTION
-  CLASS 2A SEEDING
(WITH MULCH METHOD 2)
-  TEMPORARY DITCH CHECKS
-  CLASS 3A SEEDING
(WITH EROSION CONTROL BLANKET)
-  SEEDING, SPECIAL
-  SEEDING, SPECIAL
(WITH EROSION CONTROL BLANKET)

NOTE:
FINAL SEEDING AREAS ARE SHOWN BY STAGE AND TYPE.
- SEEDING CLASS 2A SHALL BE USED WITH MULCH METHOD 2 ON SIDE SLOPES FLATTER THAN 1:3 (V:H).
- SEEDING CLASS 3A SHALL BE USED WITH EROSION CONTROL BLANKET ON 1:3 (V:H) OR STEEPER SLOPES.
- SEEDING, SPECIAL SHALL BE USED ON LEVEE AREAS AS SHOWN.
TWO APPLICATIONS OF TEMPORARY SEEDING WITH MULCH METHOD 2 IS ALSO QUANTIFIED AND INCLUDED IN THE SEEDING SCHEDULE FOR ALL AREAS.

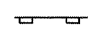

FILE NAME = D876A91-Shr-Eros-04-03.dgn
VOLKERT

| | | |
|-----------------------------|------------------|-----------|
| USER NAME = untitled | DESIGNED - MPW | REVISED - |
| PLOT SCALE = 50.0000' / IN. | DRAWN - CJS | REVISED - |
| PLOT DATE = 3/15/2011 | CHECKED - PMK | REVISED - |
| | DATE - 3/18/2011 | REVISED - |

**STATE OF ILLINOIS
DEPARTMENT OF TRANSPORTATION**

EROSION CONTROL PLAN - STAGE 4

SCALE: 1" = 50' SHEET NO. 25 OF 38 SHEETS STA. 1177+00 TO STA. 1190+00

| F.A.I. RTE. | SECTION | COUNTY | TOTAL SHEETS | SHEET NO. |
|---------------------------|---------|---------|--------------|--------------------|
| 270 | 60-1B-1 | MADISON | 712 | 236 |
| | | | | CONTRACT NO. 76A91 |
| ILLINOIS FED. AID PROJECT | | | | |