


F.A.S. RTE.	SECTION	COUNTY	TOTAL SHEETS	SHEET NO.
1832	5BR-2	WASHINGTON	97	20
STA. _____		TO STA. _____		
FED. ROAD DIST. NO. _____ ILLINOIS FED. AID PROJECT				

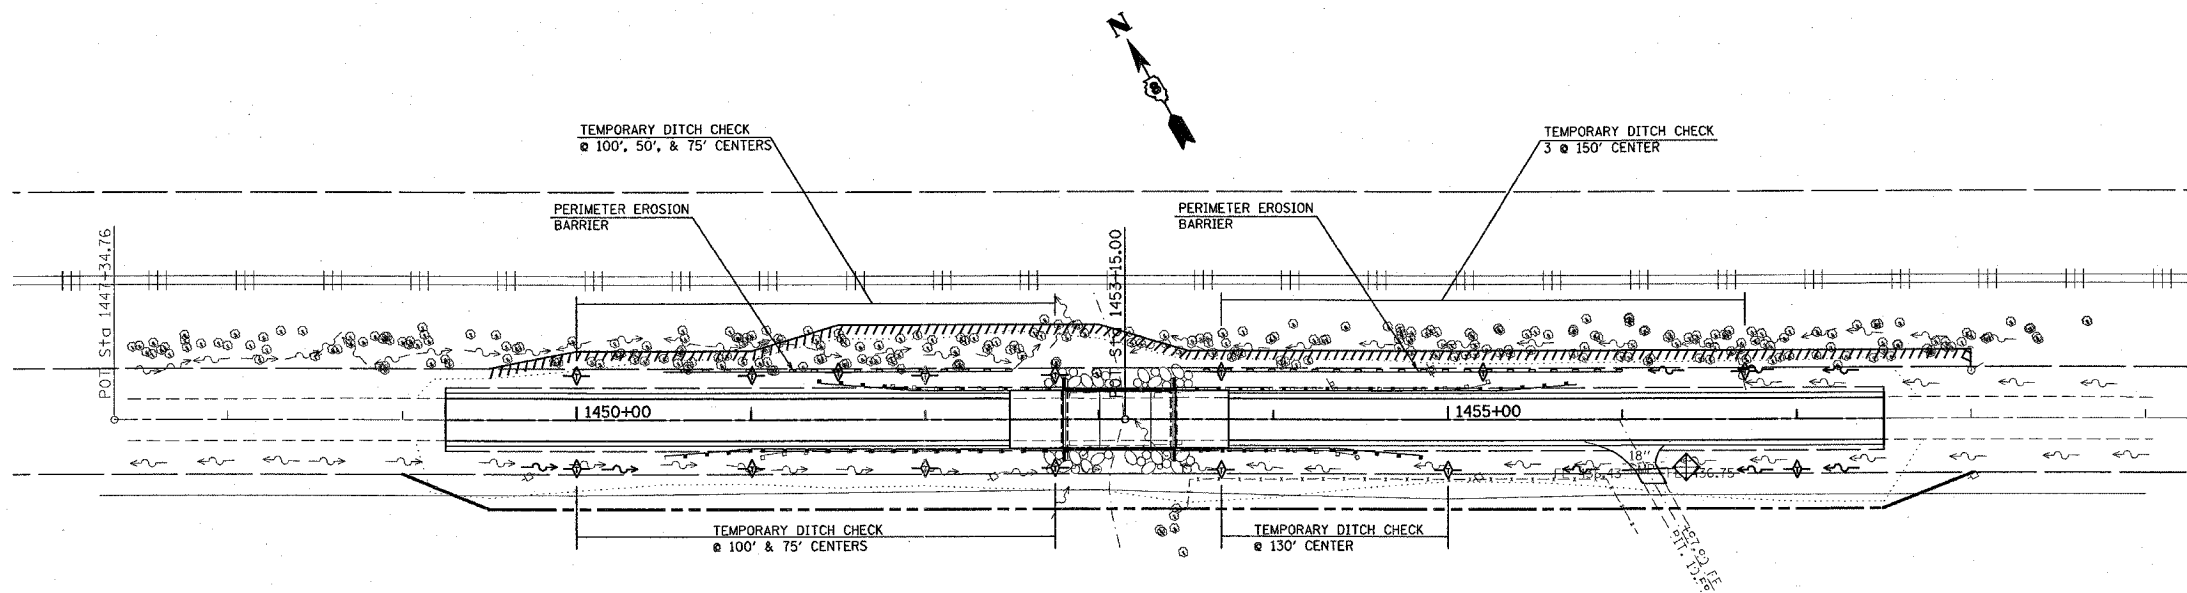


LEGEND

- INLET AND PIPE PROTECTION - STRAW BALES, FILTER FABRIC, AGGREGATES, TREE REMOVAL
- TEMPORARY DITCH CHECK - ROLLED EXCELSIOR, SILT WEDGES/PANELS
- PERIMETER EROSION BARRIER- SILT FILTER FENCE OR OTHER AS APPROVED BY THE ENGINEER

TEMPORARY EROSION CONTROL SCHEDULE

LOCATION	RT/LT	TEMP. EROSION CONTROL SEEDING (POUND)	MULCH METHOD 1 (ACRE)	PERIMETER EROSION BARRIER (FOOT)	TEMP. DITCH CHECK (EACH)	INLET AND PIPE PROTECTION (EACH)
1449+25.00 TO 1457+50.00	LT	31.50	0.35			
1449+25.00 TO 1457+50.00	RT	39.60	0.44			
1450+00.00 TO 1452+75.00	LT				5	
1450+00.00 TO 1452+75.00	RT				4	
1450+50.00 TO 1452+50.00	LT			200		
1453+50.00 TO 1456+00.00	LT			250		
1453+70.00 TO 1456+70.00	LT				3	
1453+70.00 TO 1457+00.00	RT				3	
1455+97.00	PE					1
TOTAL		71.10	0.79	450	15	1

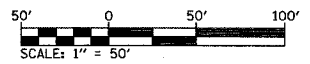

S.N. 095-0077

REVISIONS	
NAME	DATE

ILLINOIS DEPARTMENT OF TRANSPORTATION
EROSION CONTROL PLAN
 FAS ROUTE 1832
 SECTION 5BR-2
 WASHINGTON COUNTY
 SCALE: VERT. _____
 HORIZ. _____
 DATE _____ DRAWN BY _____
 CHECKED BY _____

PLOT DATE = 12/7/2007
 FILE NAME = c:\proje\5br\1832\plan\er091108a.dgn
 PLOT SCALE = 1/8" = 1' / IN.
 REFERENCE = #1832