


EROSION CONTROL LEGEND

	INLET FILTER		TEMPORARY EROSION CONTROL BLANKET (TECB) & TEMPORARY EROSION CONTROL SEEDING (TECS)		PROPOSED PAVEMENT
	TEMPORARY DITCH CHECK		MULCH, METHOD 2 (MM 2) & TEMPORARY EROSION CONTROL SEEDING (TECS)		INLET AND PIPE PROTECTION
	PERIMETER EROSION BARRIER (PEB)		EROSION CONTROL MEASURES (TECB, MM 2 AND TECS) PLACED IN PREVIOUS STAGES		TEMPORARY PAVEMENT PLACED IN PREVIOUS STAGES
	TEMPORARY PAVEMENT				

NOTE: THE PIPES AND STRUCTURES SHOWN ARE PROPOSED, UNLESS OTHERWISE CALLED AS TEMPORARY. SEE PROPOSED DRAINAGE PLANS FOR PROPOSED PIPE AND STRUCTURE INFORMATION.

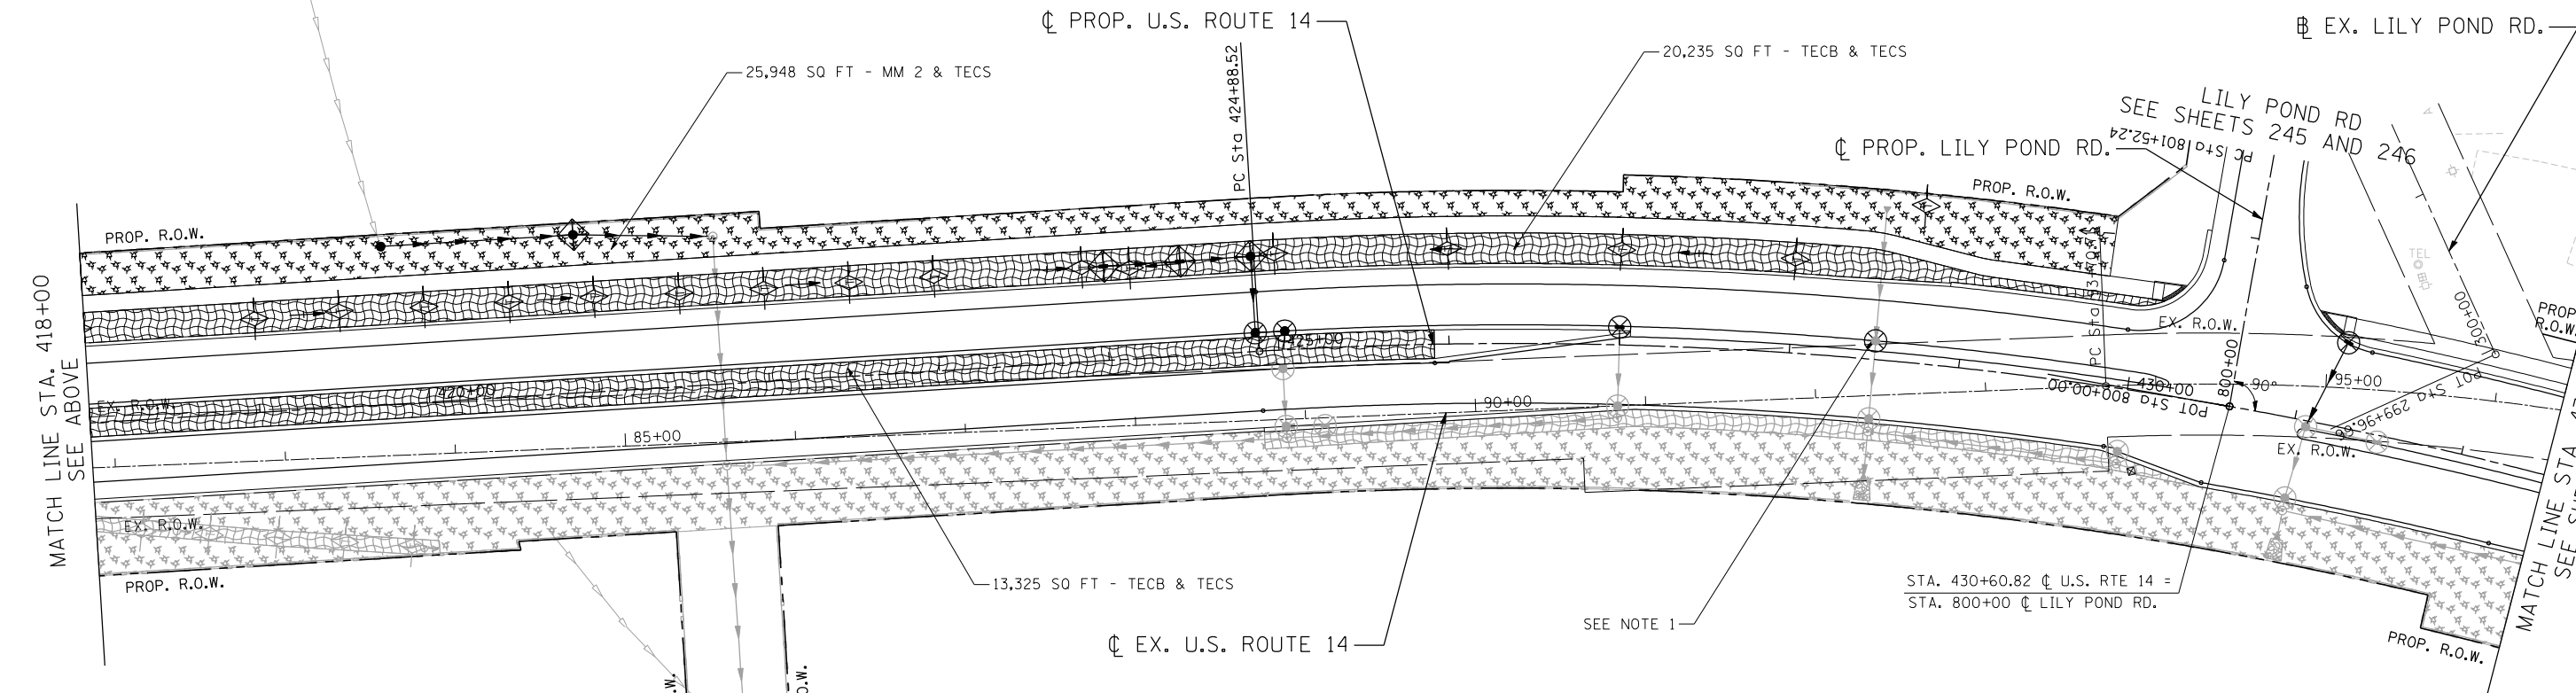

NOTE
1. REMOVE TEMP PIPE CULVERT AND PLUG THE HOLE. THE COST FOR PLUGGING IS INCLUDED IN THE PROPOSED DRAINAGE STRUCTURE OF TYPE AND SIZE SPECIFIED ON THE PLANS.

FILE NAME = #FILEL#
 USER NAME = HECHTBR
 DESIGNED -
 DRAWN - MRK
 CHECKED - TKL
 DATE - 11/01/13
 REVISED -
 REVISED -
 REVISED -
 REVISED -
 STATE OF ILLINOIS
 DEPARTMENT OF TRANSPORTATION
 U.S. ROUTE 14
 EROSION CONTROL
 STAGE 2.1
 STA. 404+00 TO STA. 432+50
 SCALE: 1"=50'
 SHEET NO. OF SHEETS STA. TO STA.
 F.A.P. RTE. SECTION COUNTY TOTAL SHEETS SHEET NO.
 305 27R-2 MCHENRY 673 241
 FED. ROAD DIST. NO. 1 ILLINOIS FED. AID PROJECT CONTRACT NO. 62268

FILE NAME = #FILEL#	USER NAME = HECHTBR	DESIGNED -	REVISED -	STATE OF ILLINOIS DEPARTMENT OF TRANSPORTATION U.S. ROUTE 14	EROSION CONTROL STAGE 2.1 STA. 404+00 TO STA. 432+50	F.A.P. RTE.	SECTION	COUNTY	TOTAL SHEETS	SHEET NO.	
exp U.S. Services Inc. Chicago, IL	PLOT SCALE = #SCALE#	DRAWN - MRK	REVISED -			305	27R-2	MCHENRY	673	241	
11-06-2013 16:16:19	PLOT DATE = #DATE#	CHECKED - TKL	REVISED -			CONTRACT NO. 62268					
		DATE - 11/01/13	REVISED -			FED. ROAD DIST. NO. 1 ILLINOIS FED. AID PROJECT					