■ BOLINGBROOK'S CLOW

INTERNATIONAL

VILLAGE OF BOLINGBROOK BOLINGBROOK'S CLOW INTERNATIONAL AIRPORT (1C5) BOLINGBROOK, WILL COUNTY, ILLINOIS


INSTALL PRECISION APPROACH PATH INDICATOR (PAPI) FOR RUNWAY 18/36

ILLINOIS PROJECT NO. 1C5-5132

CONTRACT NO. BO008 SBG PROJECT NUMBER: 3-17-SBGP-TBD

> ISSUED FOR BID 06/06/2025




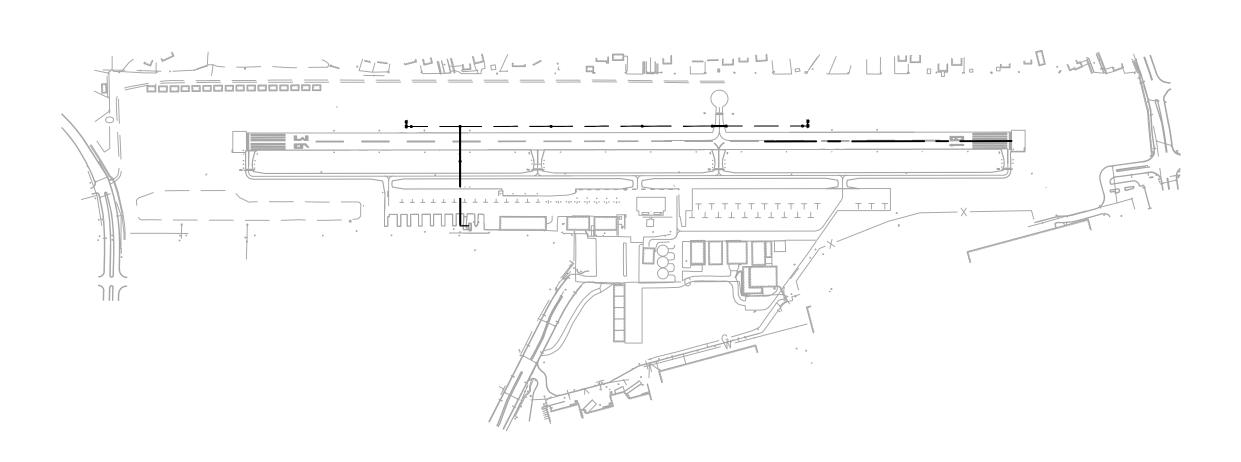





4201 WINFIELD ROAD SUITE 600 WARRENVILLE, IL 60555 (630) 487-5550



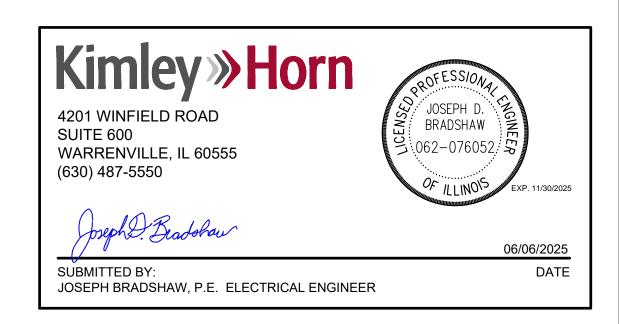

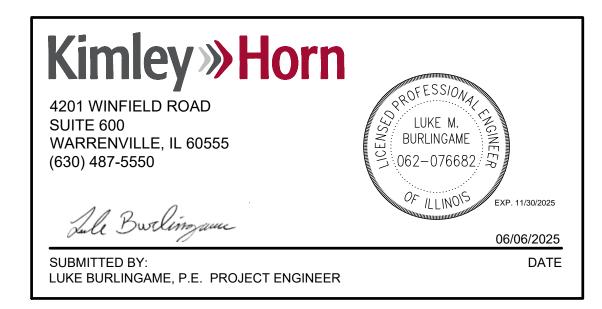



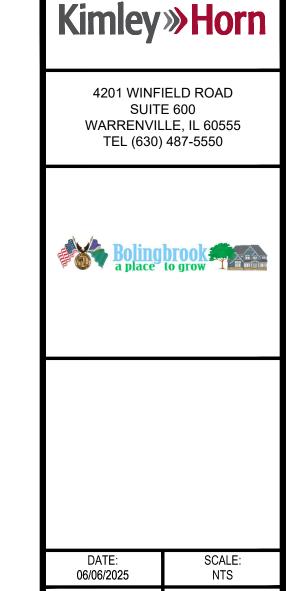

DRAWING NO. GC-000 PROJECT NUMBER:

168001006

LOCATION MAP

LAKE MICHIGAN

THIS RECORD CONTAINS SENSITIVE SECURITY INFORMATION THAT IS CONTROLLED IN 49 CFR PART 1520. NO PART OF THIS RECORD MAY BE DISCLOSED TO PERSONS WITHOUT A "NEED TO KNOW", AS DIRECTED IN 49 CFR PART 1520, EXCEPT WITH THE WRITTEN PERMISSION OF THE

		SHEET INDEX
COUNT	SHEET NO.	SHEET NAME
1	GC-000	COVER SHEET
2	GC-101	SHEET INDEX, SOQ, LEGEND AND ABBREVIATIONS
3	GC-102	ACCESS, SAFETY AND GENERAL NOTES
4	GC-103	HORIZONTAL AND VERTICAL CONTROL PLAN
5	PH-100	CONSTRUCTION SAFETY AND PHASING PLAN
6	PH-501	CONSTRUCTION SAFETY AND PHASING DETAILS
7	E100	ELECTRICAL SCOPE OF WORK
8	E101	ELECTRICAL LAYOUT
9	E102	ELECTRICAL LAYOUT
10	E103	ELECTRICAL LAYOUT
11	E104	ELECTRICAL LAYOUT
12	E201	ELECTRICAL DETAILS
13	E202	ELECTRICAL DETAILS
14	E203	RUNWAY 18 PAPI SITING
15	E204	RUNWAY 36 PAPI SITING
16	E205	PAPI FOUNDATION AND INSTALLATION DETAILS
17	E301	ELECTRICAL VAULT PLAN
18	E401	ELECTRICAL CIRCUIT MAP - BASE BID
19	E402	ELECTRICAL CIRCUIT MAP - ALT 1
20	E501	PAPI SITING ELEVATIONS

	BASE BID							
NO.	ITEM	DESCRIPTION	UNIT	QUANTITY	FIELD QUANTITY			
1	AR108108	1/C #8 5 KV CABLE	LINEAR FOOT	1565.0				
2	AR110202	2" PVC DUCT, DIRECT BURY	LINEAR FOOT	270.0				
3	AR125615	ABBREVIATED PAPI (L-881 SYSTEM)	EACH	1				
4	AR150520	MOBILIZATION	LUMP SUM	1				
5	AR801714	PROVIDE AND INSTALL NEW H-20 LOAD RATED CONCRETE HANDHOLE	EACH	3				
6	AR801717	INSTALL NEW 240V, 6.6A, 5KW CONSTANT CURRENT REGULATOR IN VAULT	LUMP SUM	1				
7	AR801718	2-2" SCH. 40 PVC DIRECTIONAL BORE	LINEAR FOOT	440.0				

	ALTERNATIVE BID 1						
NO.	ITEM	DESCRIPTION	UNIT	QUANTITY	FIELD QUANTITY		
1	AS108108	1/C #8 5 KV CABLE	LINEAR FOOT	3245.0			
2	AS110202	2" PVC DUCT, DIRECT BURY	LINEAR FOOT	1465.0			
3	AS125615	ABBREVIATED PAPI (L-881 SYSTEM)	EACH	1			
4	AS801714	PROVIDE AND INSTALL NEW H-20 LOAD RATED CONCRETE HANDHOLE	EACH	5			
5	AS801718	2-2" SCH. 40 PVC DIRECTIONAL BORE	LINEAR FOOT	65.0			

THIS RECORD CONTAINS SENSITIVE SECURITY INFORMATION THAT IS CONTROLLED IN 49 CFR PART 1520. NO PART OF THIS RECORD MAY BE DISCLOSED TO PERSONS WITHOUT A "NEED TO KNOW", AS DIRECTED IN 49 CFR PART 1520, EXCEPT WITH THE WRITTEN PERMISSION OF THE ADMINISTRATION, THE TRANSPORTATION SECURITY ADMINISTRATION OR THE SECRETARY OF TRANSPORTATION. UNAUTHORIZED RELEASE MAY RESULT IN CIVIL PENALTY OR OTHER ACTION. FOR US GOVERNMENT AGENCIES, PUBLIC DISCLOSURE IS GOVERNED BY 5 U.S.C. 552 AND 49 CFR PART 1520.

LEGEND

ROFA	RUNWAY OBJECT FREE AREA	\triangle \bullet	FOUND SURVEY MONUMENT
RSA	RUNWAY SAFETY AREA	×656.15	SPOT ELEVATION
TOFA	TAXIWAY OBJECT FREE AREA	E	EXISTING ELECTRICAL HANDHOLE
TSA	TAXIWAY SAFETY AREA	E	EXISTING ELECTRICAL MANHOLE
	PROPOSED STORM SEWER PIPE	\boxtimes	EXISTING ELECTRICAL CABINET
ST	EXISTING STORM SEWER PIPE	#	EXISTING ELECTRICAL DUCT MARKER
657	EXISTING CONTOUR	T	EXISTING COMMUNICATIONS/TELEPHONE PEDESTAL
657	PROPOSED CONTOUR	T	EXISTING COMMUNICATIONS/TELEPHONE MANHOLE
	BITUMINOUS PAVEMENT SAWING	\otimes	EXISTING NATURAL GAS VALVE
	LIMITS OF GRADING	S	EXISTING SANITARY SEWER MANHOLE
SF	SILT FENCE	W	EXISTING WATER MANHOLE
————S———	EXISTING SANITARY SEWER LINE	U	EXISTING UTILITY
——s—	PROPOSED SANITARY SEWER LINE	D	EXISTING STORM SEWER INLET
——т—	EXISTING TELEPHONE LINE		PROPOSED STORM SEWER INLET
WTR	EXISTING WATER LINE	*	EXISTING AIRCRAFT TIE DOWN
———w——	PROPOSED WATER LINE	*	PROPOSED AIRCRAFT TIE DOWN
×	EXISTING CHAIN LINK FENCE	•	EXISTING RETROREFLECTIVE MARKER
	EXISTING WROUGHT IRON FENCE	•	PROPOSED RETROREFLECTIVE MARKER
— — COMM — —	EXISTING COMMUNICATIONS CABLE	® BL-X	BORING LOCATION
сом	PROPOSED COMMUNICATIONS CABLE		INLET PROTECTION
G	EXISTING NATURAL GAS LINE	BMX	SURVEY BENCHMARK
GAS	PROPOSED NATURAL GAS SLEEVE	⊕ ↓ CPx	
E	EXISTING POWER CONDUIT	▽ ∾	CONTROL POINT
ELEC	PROPOSED ELECTRICAL CONDUIT	∑ ∀	EXISTING HYDRANT AND VALVE
- - UD-	PROPOSED UNDERDRAIN	∞ →	PROPOSED WATERMAIN STRUCTURE

AC	ADVISORY CIRCULAR	MIN	MINIMUM
AOA	AIR OPERATIONS AREA	MH	MANHOLE
APPROX	APPROXIMATELY	N	NORTH
BM	BENCHMARK	NE	NORTHEAST
СВ	CATCH BASIN	NO	NUMBER
CL	CENTERLINE	NW	NORTHWEST
CP	CONTROL POINT	NTS	NOT TO SCALE
COMM	COMMUNICATIONS	OC	ON-CENTER
CY	CUBIC YARD	OFA	OBJECT FREE AREA
E	EAST	PC	POINT OF CURVATURE
EA	EACH	POC	POINT ON CURVE
EG	EXISTING GROUND	PR	PROPOSED
EL	ELEVATION	PT	POINT OF TANGENCY
EX	EXISTING	R	RADIUS
FAA	FEDERAL AVIATION	RCP	REINFORCED CONCRETE PIPE
	ADMINISTRATION	RSA	RUNWAY SAFETY AREA
FFE	FINISHED FLOOR ELEVATION	RT	RIGHT
FG	FINISHED GRADE	S	SOUTH
FL	FLOWLINE	SE	SOUTHEAST
FOD	FOREIGN OBJECT DEBRIS	SOQ	SUMMARY OF QUANTITIES
FT	FEET	STA	STATION
GAL	GALLON	SW	SOUTHWEST
GB	GRADE BREAK	SY	SQUARE YARD
IDOT	ILLINOIS DEPARTMENT OF TRANSPORTATION	TOFA	TAXILANE/TAXIWAY OBJECT FREE AREA
INV	INVERT	TSA	TAXILANE/TAXIWAY SAFETY AREA
LF	LINEAR FOOT	TW	TAXIWAY
LP	LOW POINT	TYP	TYPICAL
LS	LUMP SUM	UNO	UNLESS NOTED OTHERWISE
LT	LEFT	VAR	VARIES
MAX	MAXIMUM	W	WEST



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DATE:	SCALE:
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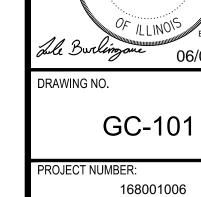
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ATH INDICATOR (PAPI)

ABBREVIATIONS

ABBREVIATIONS

AC	ADVISORY CIRCULAR	MIN	MINIMUM
AOA	AIR OPERATIONS AREA	MH	MANHOLE
APPROX	APPROXIMATELY	N	NORTH
BM	BENCHMARK	NE	NORTHEAST
CB	CATCH BASIN	NO	NUMBER
CL	CENTERLINE	NW	NORTHWEST
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	ADMINISTRATION	RSA	RUNWAY SAFETY AREA
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FOD	FOREIGN OBJECT DEBRIS	SOQ	SUMMARY OF QUANTITIES
FT	FEET	STA	STATION
GAL	GALLON	SW	SOUTHWEST
GB	GRADE BREAK	SY	SQUARE YARD
IDOT	ILLINOIS DEPARTMENT OF	TOFA	TAXILANE/TAXIWAY OBJECT FREE
	TRANSPORTATION		AREA
INV	INVERT	TSA	TAXILANE/TAXIWAY SAFETY AREA
LF	LINEAR FOOT	TW	TAXIWAY
LP	LOW POINT	TYP	TYPICAL
LS	LUMP SUM	UNO	UNLESS NOTED OTHERWISE
LT	LEFT	VAR	VARIES
MAX	MAXIMUM	W	WEST
		• •	



CERTIFICATION:

LUKE M. BURLINGAME

2 062-076682 5



ACCESS AND SAFETY NOTES:

I. ACCESS AND VEHICLE PARKING:

- ACCESS POINT AND HAUL ROUTE FOR ALL CONTRACTOR PERSONNEL, VEHICLES AND EQUIPMENT ARE AS SHOWN ON THE CONSTRUCTION SAFETY AND PHASING PLAN. IT SHALL BE THE CONTRACTOR'S RESPONSIBILITY TO OBTAIN PERMITS AND COORDINATE OFF SITE HAUL ROUTES WITH THE APPROPRIATE OWNER WHO HAS JURISDICTION OVER THE AFFECTED ROUTE. ON-SITE HAUL ROUTES SHALL BE MAINTAINED BY THE CONTRACTOR AND SHALL BE RESTORED TO THEIR ORIGINAL CONDITION UPON COMPLETION OF BEING USED AS A HAUL ROUTE. HAUL ROUTES ARE TO REMAIN CLEAN AND PASSABLE AT ALL TIMES.
- B. CONTRACTOR SHALL FURNISH AND INSTALL A PROFESSIONALLY PAINTED SIGN MEETING OWNER APPROVAL AT THE CONSTRUCTION ENTRANCE TO DIRECT MATERIAL SUPPLIERS AND EMPLOYEES TO THE CONSTRUCTION SITE. THE SIGN SHALL READ "CONSTRUCTION VEHICLES ONLY NO VENDORS ALLOWED".
- C. ALL CONTRACTOR VEHICLES AND PERSONNEL SHALL REMAIN WITHIN THE DESIGNATED CONSTRUCTION LIMITS OR HAUL ROUTES. NO CONTRACTOR VEHICLES WILL BE ALLOWED ON OTHER AIRFIELD OPERATIONS AREAS.
- D. THE LIMITS OF CONSTRUCTION, MATERIAL STORAGE AREAS, EQUIPMENT STORAGE AREA, PARKING AREA AND OTHER AREAS DEFINED AS REQUIRED FOR THE CONTRACTOR'S EXCLUSIVE USE DURING CONSTRUCTION SHALL BE MARKED BY THE CONTRACTOR. TEMPORARY BARRICADES, FLAGGING AND FLASHING WARNING LIGHTS WILL BE REQUIRED AT CRITICAL ACCESS POINTS. TYPE OF MARKING AND WARNING DEVICES SHALL BE APPROVED BY THE ENGINEER AND AIRPORT MANAGER.
- E. ALL ACCESS GATES SHALL BE KEPT CLOSED DURING CONTRACTOR'S WORK HOURS. THE CONTRACTOR SHALL CLOSE AND LOCK ACCESS GATE AT THE COMPLETION OF EACH WORK DAY. AIRPORT MANAGER WILL PROVIDE LOCK AND KEYS FOR ACCESS GATE.
- AT THE COMPLETION OF EACH WORKDAY OR WHEN NOT IN USE, CONSTRUCTION EQUIPMENT SHALL BE STORED IN THE CONTRACTOR'S STAGING AREA AND/OR DESIGNATED EQUIPMENT STAGING AREAS. CLOSED AREAS OF APRON PAVEMENT MAY BE USED FOR TEMPORARY STAGING OF EQUIPMENT WITH THE APPROVAL OF THE AIRPORT MANAGER.

II. COORDINATION AND COMMUNICATION DURING CONSTRUCTION:

- CONTRACTOR SHALL ADVISE AND THEN VERIFY WITH RESIDENT ENGINEER 72 HOURS IN ADVANCE AS TO THE NEED FOR NOTICES TO AIR MISSIONS (NOTAMS). NO RUNWAY, TAXIWAY OR APRON SHALL BE CLOSED WITHOUT APPROVAL FROM THE AIRPORT MANAGER AND THE RESIDENT ENGINEER.
- B. CONTRACTOR SHALL APPOINT A CONSTRUCTION SUPERINTENDENT, SUBJECT TO THE APPROVAL OF THE AIRPORT MANAGER, WHO SHALL BE PRESENT ON THE CONSTRUCTION SITE AT ALL TIMES DURING WORKING HOURS WHILE JOB IS IN PROGRESS. THE SUPERINTENDENT SHALL BE DESIGNATED THE RESPONSIBLE CONTRACTOR'S REPRESENTATIVE WHO SHALL BE AVAILABLE ON A 24-HOUR BASIS.
- C. PRIOR TO CONSTRUCTION IN THE RESPECTIVE WORK AREAS, THE CONTRACTOR SHALL CORDON OFF THE WORK AREA AS SHOWN ON DRAWINGS PH-101 THROUGH PH-103 BY USING LOW PROFILE BARRICADES. CONTRACTOR SHALL MAINTAIN, MOVE AND REMOVE BARRICADES (AS DIRECTED BY THE ENGINEER) TO DELINEATE AREAS CLOSED TO AIRCRAFT TRAFFIC.
- D. PRIOR TO COMMENCEMENT OF CONSTRUCTION, CONTRACTOR SHALL SUBMIT TO AIRPORT MANAGER THE NAME AND TELEPHONE NUMBER OF THE INDIVIDUAL(S) WHO WILL BE ON CALL 24 HOURS PER DAY FOR EMERGENCY MAINTENANCE OF AIRPORT HAZARD LIGHTING & BARRICADES.
- E. THE CONTRACTOR SHALL HAVE ON-SITE AT ALL TIMES DURING WORKING HOURS, AN AIRPORT RADIO TO CONTINUOUSLY MONITOR AIRCRAFT TRAFFIC ON AND AROUND THE AIRPORT. THE COMMON TRAFFIC ADVISORY FREQUENCY IS 122.90. IT IS THE RESPONSIBILITY OF THE CONTRACTOR TO MONITOR AND GIVE WAY TO ALL AIRCRAFT TRAFFIC.

III. TRAFFIC CONTROL:

- A. ALL CONSTRUCTION EQUIPMENT AND VEHICLES SHALL BE MARKED WITH COMPANY PAINTED DESIGNS, INSIGNIAS OR OTHER COMPANY MARKINGS, WHICH ARE CLEARLY VISIBLE. CONTRACTOR SHALL PROVIDE EACH VEHICLE WITH A FLAG ON A STAFF ATTACHED TO THE VEHICLE SO THAT THE FLAG WILL BE READILY VISIBLE. THE FLAG SHOULD BE AT LEAST 3 FOOT SQUARE, AND HAVE A CHECKERED PATTERN OF INTERNATIONAL ORANGE AND WHITE. ALL VEHICLES ON THE AIRFIELD SHALL BE LIT WITH A BEACON AND FLASHERS.
- B. CONSTRUCTION EQUIPMENT SHALL HAVE AUTOMATIC SIGNALING DEVICES TO SOUND AN ALARM WHEN MOVING IN REVERSE.
- C. ONLY RUBBER TIRED VEHICLES WILL BE ALLOWED ON PAVEMENT.
- D. NO PEDESTRIAN TRAFFIC OUTSIDE THE CONSTRUCTION WORK SITE WILL BE PERMITTED.
- E. ANY DAMAGE TO AIRPORT ROADS, AIRFIELD PAVEMENT, PARKING AREAS, STORAGE AREAS OR TURF AREAS DUE TO CONSTRUCTION EQUIPMENT OR CONSTRUCTION TRAFFIC SHALL BE REPAIRED TO ORIGINAL CONDITION TO THE SATISFACTION OF, AND AT NO EXPENSE TO THE OWNER.
- F. ANY WORKERS AND/OR EQUIPMENT NOT IN COMPLIANCE WITH CONSTRUCTION SAFETY AND PHASING PLAN SHALL IMMEDIATELY BE REMOVED FROM THE WORK AREA AND THEY WILL NOT BE PERMITTED TO WORK ON THE SITE THROUGHOUT THE REMAINDER OF THE PROJECT.

IV. EQUIPMENT AND STOCKPILE HEIGHT:

- A. THE MAXIMUM ALLOWABLE HEIGHT OF CONSTRUCTION EQUIPMENT OPERATING IN THE AOA SHALL BE IN CONFORMANCE WITH THE FAA FORM 7460 DEVELOPED FOR THIS PROJECT. EQUIPMENT MUST NOT PENETRATE THE ROFA OF ANY ACTIVE RUNWAY, OR TOFA OF ANY ACTIVE TAXIWAY, AS DEFINED IN FAA AC 150/5300-13, (CURRENT EDITION). ANY DEVIATIONS FROM THE APPROVED FAA FORM 7460 MUST BE APPROVED BY THE AIRPORT AND RESUBMITTED TO THE FAA. ADDITIONAL FAA SUBMITTAL SHALL HAVE NO IMPACT ON THE CONSTRUCTION SCHEDULE.
- B. CONTRACTOR SHALL NOT STOCKPILE CONSTRUCTION MATERIALS, SPOILS, DEBRIS OR REFUSE IN ANY AREA WHERE SUCH STOCKPILES WOULD PENETRATE APPROACH SURFACES. STOCKPILING OF MATERIAL WITHIN THE SAFETY AREA AND THE OBJECT FREE AREA OF AN ACTIVE RUNWAY OR TAXIWAY IS PROHIBITED.
- C. ALL STOCKPILES ADJACENT TO ACTIVE RUNWAY SAFETY AREAS OR OBSTACLE FREE ZONES SHALL BE IDENTIFIED WITH AN ORANGE & WHITE CONSTRUCTION FLAG AND A 360 DEGREE RED OBSTRUCTION LIGHT PLACED AT THE HIGHEST POINT OF THE STOCKPILE.
- D. STOCKPILED MATERIAL SHALL BE CONTAINED IN A MANNER TO PREVENT MOVEMENT AND/OR DUST RESULTING FROM AIRCRAFT PROPELLER WASH OR WIND CONDITIONS. IN ADDITION, STOCKPILED MATERIAL SHALL HAVE SILT FENCE PLACED AROUND IT TO PREVENT FOD FROM MOVING ONTO THE AIRFIELD PAVEMENTS OR POLLUTING WATERCOURSES.

V. EXCAVATION AND TRENCHES:

- A. ALL BARRICADES LOCATED WITHIN OR ADJACENT TO AREAS OF AIRCRAFT OPERATION SHALL BE LOW PROFILE TYPE AS DETAILED ON SHEET PH-501.
- B. OPEN TRENCHES AND EXCAVATIONS AT THE CONSTRUCTION SITE SHALL BE PROMINENTLY MARKED WITH ORANGE BARRICADES WITH FLASHING RED LIGHTS ACCEPTABLE TO THE AIRPORT MANAGER.
- C. ALL CONSTRUCTION AREAS THAT POSE A HAZARD TO OPERATING AIRCRAFT SHALL BE PROPERLY MARKED WITH LOW-PROFILE BARRICADES.
- D. LOW PROFILE BARRICADES SHALL BE KEPT OUTSIDE THE LIMITS OF ANY ACTIVE RUNWAY SAFETY AREA OR TAXIWAY OBJECT FREE AREA.

VI. OTHER SAFETY REQUIREMENTS:

- A. CONTRACTOR SHALL MAINTAIN SAFETY PRACTICES THAT CONFORM TO OCCUPATIONAL SAFETY AND HEALTH ADMINISTRATION (OSHA) REGULATIONS.
- B. WASTE AND LOOSE MATERIALS CAPABLE OF CAUSING DAMAGE TO AIRCRAFT SHALL NOT BE LEFT WITHIN ACTIVE AIRCRAFT MOVEMENT AREAS. MATERIAL DROPPED WITHIN THESE AREAS SHALL BE CLEANED UP IMMEDIATELY TO THE SATISFACTION OF THE AIRPORT MANAGER OR THE ENGINEER.
- C. ALL TRASH RECEPTACLES SHALL BE PROPERLY COVERED TO PREVENT FOD.
- D. THE CONTRACTOR SHALL CONTROL BLOWING DUST FROM ANY HAUL ROUTE OR WORK AREA REGARDLESS OF SOURCE.
- E. THE CONTRACTOR SHALL BE REQUIRED TO USE A WATER TRUCK AND A SWEEPER DURING ALL CONSTRUCTION ACTIVITIES AND AS DIRECTED BY THE AIRPORT MANAGER. COST FOR THE DUST CONTROL AND SWEEPING WILL NOT BE PAID FOR SEPARATELY, BUT WILL BE CONSIDERED INCIDENTAL TO THE CONTRACT.
- F. THE CONTRACTOR MUST ATTEND A MANDATORY SAFETY TRAINING MEETING LED BY THE AIRPORT STAFF PRIOR TO THE START OF CONSTRUCTION.
- G. PRIOR TO THE COMPLETION OF EACH WORK DAY, ALL AIRFIELD PAVEMENT SURFACES WITHIN AND ADJACENT TO THE WORK AREA AND THOSE USED AS HAUL ROUTES SHALL BE SWEPT CLEAN.

VII. CONTRACTOR SAFETY PLAN SUBMITTALS:

- F. CONTRACTOR SHALL FURNISH A SAFETY PLAN COMPLIANCE DOCUMENT (SPCD) THAT PROVIDES DETAILED INFORMATION REGARDING COMPLIANCE WITH THE PROJECT'S CONSTRUCTION SAFETY AND PHASING PLAN IN CONJUNCTION WITH HIS/HER PROJECT SCHEDULE. CONTRACTOR SHALL PROVIDE SPCD 10 DAYS PRIOR TO THE PRE-CONSTRUCTION MEETING. INFORMATION SHALL INCLUDE BUT NOT BE LIMITED TO THE FOLLOWING ITEMS:
 - 1. PROPOSED ACCESS POINTS, STAGING AREA AND HAUL ROUTES.
 - 2. ANY TEMPORARY MARKINGS TO BE USED.
 - 3. THE LOCATION AND TYPE OF BARRICADES OR OTHER TRAFFIC CONTROL DEVICES.
- 4. AREAS TO WHICH CONSTRUCTION OPERATIONS WILL BE LIMITED, ALONG WITH PROPOSED MEASURES TO MINIMIZE THE POSSIBILITY OF CONTRACTOR EQUIPMENT AND/OR WORKERS ACCIDENTALLY ENTERING ANY AOA.
- ANY REQUESTED TEMPORARY AMENDMENTS TO THE AIRPORT SECURITY PLAN FOR SPECIAL CONDITION OR MODIFICATIONS.
- B. CONTRACTOR SPCD SHALL COMPLY WITH ALL REQUIREMENTS INDICATED IN THESE DRAWINGS, SPECIFICATIONS AND SPECIAL PROVISIONS, AND FAA ADVISORY CIRCULAR (AC) 150/5370-2, OPERATIONAL SAFETY ON AIRPORTS DURING CONSTRUCTION, (CURRENT EDITION).

GENERAL NOTES:

- 1. IT IS THE RESPONSIBILITY OF THE CONTRACTOR TO SUBMIT, OBTAIN AND PAY FOR ALL APPLICABLE PERMITS, FEES AND LICENSES FOR CONSTRUCTION AND EQUIPMENT.
- 2. TRAFFIC MAINTENANCE, INCLUDING BUT NOT LIMITED TO, BARRICADES, TAXIWAY CLOSURE MARKERS, ETC SHALL NOT BE PAID FOR SEPARATELY BUT SHALL BE CONSIDERED INCIDENTAL TO THE CONTRACT.
- 3. THE CONTRACTOR SHALL BE RESPONSIBLE FOR MAINTAINING CONSTANT COORDINATION BETWEEN THE SUBCONTRACTORS AND THE ENGINEER. ALL CONSTRUCTION ACTIVITIES PLANNED BY THE CONTRACTOR SHALL BE REVIEWED AND APPROVED BY THE ENGINEER AND OWNER.
- 4. LIMITS OF WORK SHALL BE VERIFIED IN THE FIELD BY THE CONTRACTOR AND APPROVED BY THE ENGINEER PRIOR TO BEGINNING WORK.
- 5. THERE SHALL BE NO PERMANENT WASTE SITES ON AIRPORT PROPERTY. ANY TEMPORARY WASTE AREA WILL BE APPROVED BY THE ENGINEER AND SHALL BE KEPT IN A NEAT CONDITION. THE OWNER MAY DIRECT THE CONTRACTOR TO REMOVE WASTE IF NOT PROPERLY MAINTAINED.
- 6. PRIOR TO COMPLETION OF THE PROJECT THE CONTRACTOR SHALL RESTORE ALL DAMAGED AREAS (NOT DESIGNATED FOR CONSTRUCTION) TO THEIR PRE-CONSTRUCTION CONDITION.
- 7. LOCATING, FLAGGING, AND PROTECTING ALL EXISTING UTILITIES DURING THE DURATION OF THE CONSTRUCTION PROJECT IS THE RESPONSIBILITY OF THE CONTRACTOR. THE LOCATIONS OF THE EXISTING UTILITIES ON THE CONTRACT DRAWINGS WERE OBTAINED FROM EXISTING RECORDS AND NO GUARANTEE OF ACCURACY OR SUFFICIENCY FOR THIS INFORMATION IS ASSUMED BY THE OWNER OR ENGINEER. ANY DAMAGE TO ANY EXISTING UTILITIES WILL BE REPAIRED OR REPLACED BY THE CONTRACTOR TO THE SATISFACTION OF AND AT NO EXPENSE TO THE AIRPORT MANAGER.
- 8. THE CONSTRUCTION COVERED BY THE PLANS SHALL CONFORM TO ALL APPLICABLE STANDARDS AND SPECIFICATIONS OF THE FAA AND IDOT.
- 9. ALL WORKMANSHIP AND MATERIALS SHALL BE SUBJECT TO INSPECTION AND APPROVAL OF THE ENGINEER
- 10. CONTRACTOR SHALL EXAMINE THE FINISHED SURFACE, GRADES, TOPSOIL QUALITY, AND TOPSOIL DEPTH PRIOR TO LANDSCAPING. NO WORK SHALL BE CONDUCTED UNTIL UNSATISFACTORY CONDITIONS HAVE BEEN CORRECTED. CONTRACTOR SHALL VERIFY LIMITS OF WORK WITH THE ENGINEER BEFORE STARTING.
- 11. CONTRACTOR SHALL IMPORT AND/OR PROVIDE SALVAGED TOPSOIL MEETING THE REQUIREMENTS OF THE ILLINOIS DEPARTMENT OF TRANSPORTATION SPECIFICATIONS.
- 12. THE CONTRACTOR SHALL FURNISH AND PLACE A MINIMUM OF 4.00 INCHES OF TOPSOIL, WITH THE LOWER PORTION BLENDED INTO EXISTING SOILS.
- 13. PROPOSED ELEVATIONS INDICATED ARE FOR TOP OF FINAL GRADE, PAVEMENT, OR STRUCTURE UNLESS INDICATED OTHERWISE.
- 14. ELEVATIONS DENOTED AS "MATCH" ARE INTENDED TO MEET EXISTING GRADE ELEVATIONS. CONTRACTOR SHALL VERIFY ELEVATIONS AT TIE-INS AND MATCH POINTS PRIOR TO BEGINNING CONSTRUCTION AND VERIFY WITH THE ENGINEER.
- 15. ADEQUATE DRAINAGE SHALL BE MAINTAINED AT ALL TIMES DURING CONSTRUCTION. ANY DRAINAGE FEATURE OR STRUCTURE DISTURBED DURING CONSTRUCTION SHALL BE RESTORED TO EXISTING CONDITIONS OR BETTER SUBJECT TO THE APPROVAL OF THE AIRPORT MANAGER. ANY REWORK OR ADDITIONAL WORK REQUIRED BECAUSE OF THE CONTRACTOR'S FAILURE TO MAINTAIN ADEQUATE DRAINAGE WILL BE AT THE CONTRACTOR'S EXPENSE.
- 16. THE CONTRACTOR SHALL REMOVE STANDING WATER FROM THE PROJECT WORK LIMITS AS NECESSARY TO PROTECT SUBGRADE, SUBBASE, AND/OR BASE COURSE TO NEW PAVEMENT, SURROUNDING PAVEMENT-TO-REMAIN, OR OTHER COMPLETED WORKS.
- 17. CONTRACTOR IS RESPONSIBLE FOR COORDINATING AND PAYING ALL UTILITY CONNECTION FEES AND OBTAINING ALL PERMITS REQUIRED FOR THE UTILITY CONSTRUCTION AND CONNECTIONS. THIS INCLUDES ALL FEES ASSOCIATED WITH CONNECTION CHARGES AND METERS.
- 18. THE CONTRACTOR SHALL NOTE THAT OTHER CONTRACTORS MAY BE WORKING IN THE VICINITY OF THE PROJECT AND MAY REQUIRE ACCESS TO THEIR WORK AREAS. THE CONTRACTOR SHALL NOT DIRECTLY COMMUNICATE WITH THE CONTRACTORS ON OTHER PROJECTS UNLESS AUTHORIZED TO DO SO. COOPERATION OF THE CONTRACTOR WITH ADJACENT PROJECTS IS EXPECTED.



4201 WINFIELD ROAD SUITE 600 WARRENVILLE, IL 60555 TEL (630) 487-5550



DATE: SCALE:
06/06/2025 NTS

DRAWN BY: CHECKED BY:
LMB JY

REV. DATE DESCRIPTION

ISSUED FOR BID

0 06/06/2025

ID GENERAL NOTES APPROACH PATH INDICATOR (PAPI)

SIO

NSTALL PRECISION APPRIOR RUNWAY 18/36
/ILLAGE OF BOLINGBROO

CERTIFICATION:

LUKE M.
BURLINGAME


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06/06/2025

DRAWING NO.

GC-102



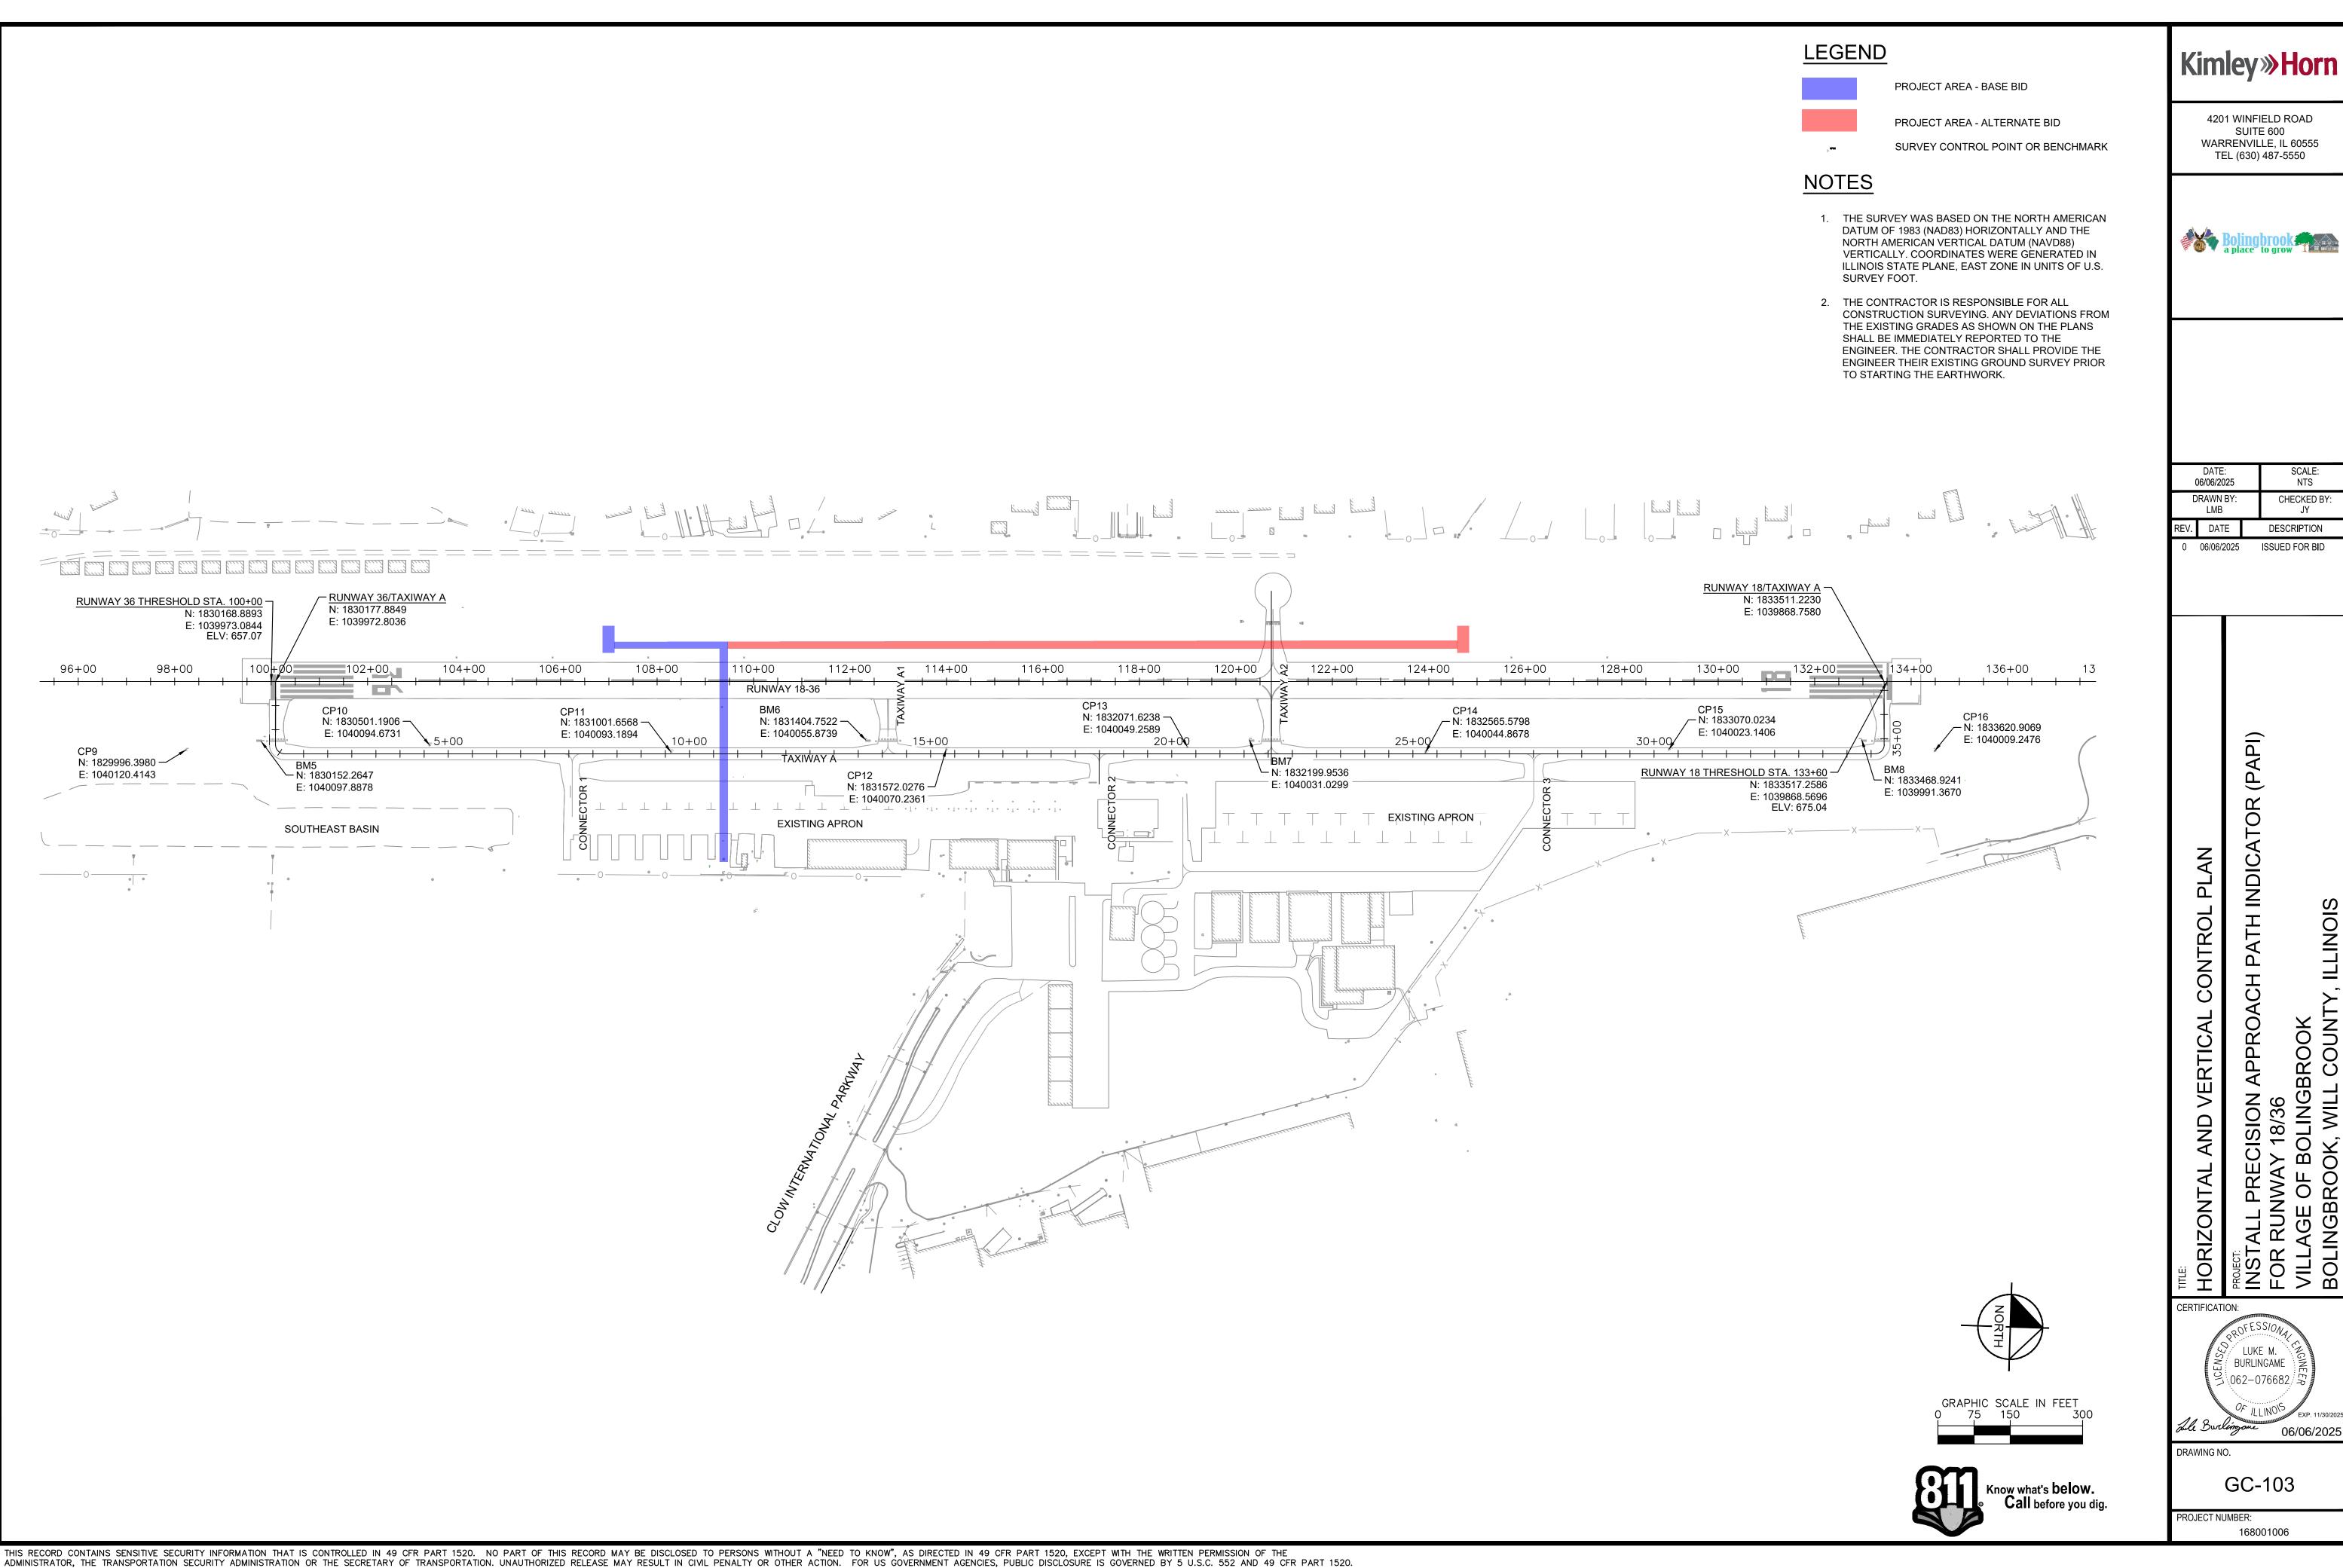


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AIRSPACE CRITICAL LOCATIONS (7460)


POINT #	DESCRIPTION	NORTHING	EASTING	MAX STRUCTURE HEIGHT	ELEVATION	OVERALL OBJECT HEIGHT	LATITUDE	LONGITUDE	AERONAUTICAL STUDY NUMBER
1	CONTRACTOR EQUIPMENT	1830754.88	1039794.87	25'	651'	676'	N41° 41' 34.49"	W88° 07' 47.85"	2025-AGL-8342-NRA
2	CONTRACTOR EQUIPMENT	1832744.43	1039732.85	25'	665'	690'	N41° 41' 54.14"	W88° 07' 48.61"	2025-AGL-8342-NRA
3	CONTRACTOR EQUIPMENT	1832747.55	1039832.72	25'	668'	693'	N41° 41' 54.17"	W88° 07' 47.29"	2025-AGL-8342-NRA
4	CONTRACTOR EQUIPMENT	1830757.99	1039894.82	25'	659'	684'	N41° 41' 34.52"	W88° 07' 46.53"	2025-AGL-8342-NRA
5	CONTRACTOR EQUIPMENT	1831079.75	1039884.78	25'	660'	685'	N41° 41' 37.69"	W88° 07' 46.66"	2025-AGL-8342-NRA
6	CONTRACTOR EQUIPMENT	1831155.24	1039882.43	25'	660'	685'	N41° 41' 38.44"	W88° 07' 46.68"	2025-AGL-8342-NRA
7	CONTRACTOR EQUIPMENT	1831169.37	1040335.86	25'	659'	684'	N41° 41' 38.57"	W88° 07' 40.71"	2025-AGL-8342-NRA
8	CONTRACTOR EQUIPMENT	1831093.89	1040338.21	25'	658'	683'	N41° 41' 37.82"	W88° 07' 40.68"	2025-AGL-8342-NRA

PHASE	DURATION (WORKING DAYS)*	AIRFIELD CLOSURES	WORK ELEMENTS**	WORK RESTRICTIONS
1	20	1.TAXIWAY A SOUTH OF TAXIWAY A1	1. INSTALLATION OF CABLE IN UNIT DUCT. 2. ELECTRICAL VAULT MODIFICATIONS. 3. INSTALLATION OF NEW L-881 PAPI.	RUNWAY 18-36 SHALL BE CLOSED ANYTIME WORK ENTERS THE RUNWAY SAFETY AREA. ALL EQUIPMENT MUST BE LOWERED WHEN NOT IN USE AND MAY NOT BE LEFT INSIDE OF THE RUNWAY OBJECT FREE AREA.
2	10	1. RUNWAY 18/36 WHEN WORKING INSIDE THE RUNWAY SAFETY AREA	1. INSTALLATION OF NEW L-881 PAPI. 2. INSTALLATION OF CABLES, CABLES IN UNIT DUCT, AND ASSOCIATED MATERIALS.	1. RUNWAY 18-36 SHALL BE CLOSED ANYTIME WORK ENTERS THE RUNWAY SAFETY AREA. 2. ALL EQUIPMENT MUST BE LOWERED WHEN NOT IN USE AND MAY NOT BE LEFT INSIDE OF THE RUNWAY OBJECT FREE AREA.

* DURATIONS DO NOT INCLUDE TIME REQUIRED FOR THE FAA FLIGHT CHECK **THESE ARE MAJOR WORK ELEMENTS ONLY, THE CONTRACTOR IS RESPONSIBLE FOR VERIFYING ALL WORK ELEMENTS WITHIN EACH OPERATIONAL PHASE

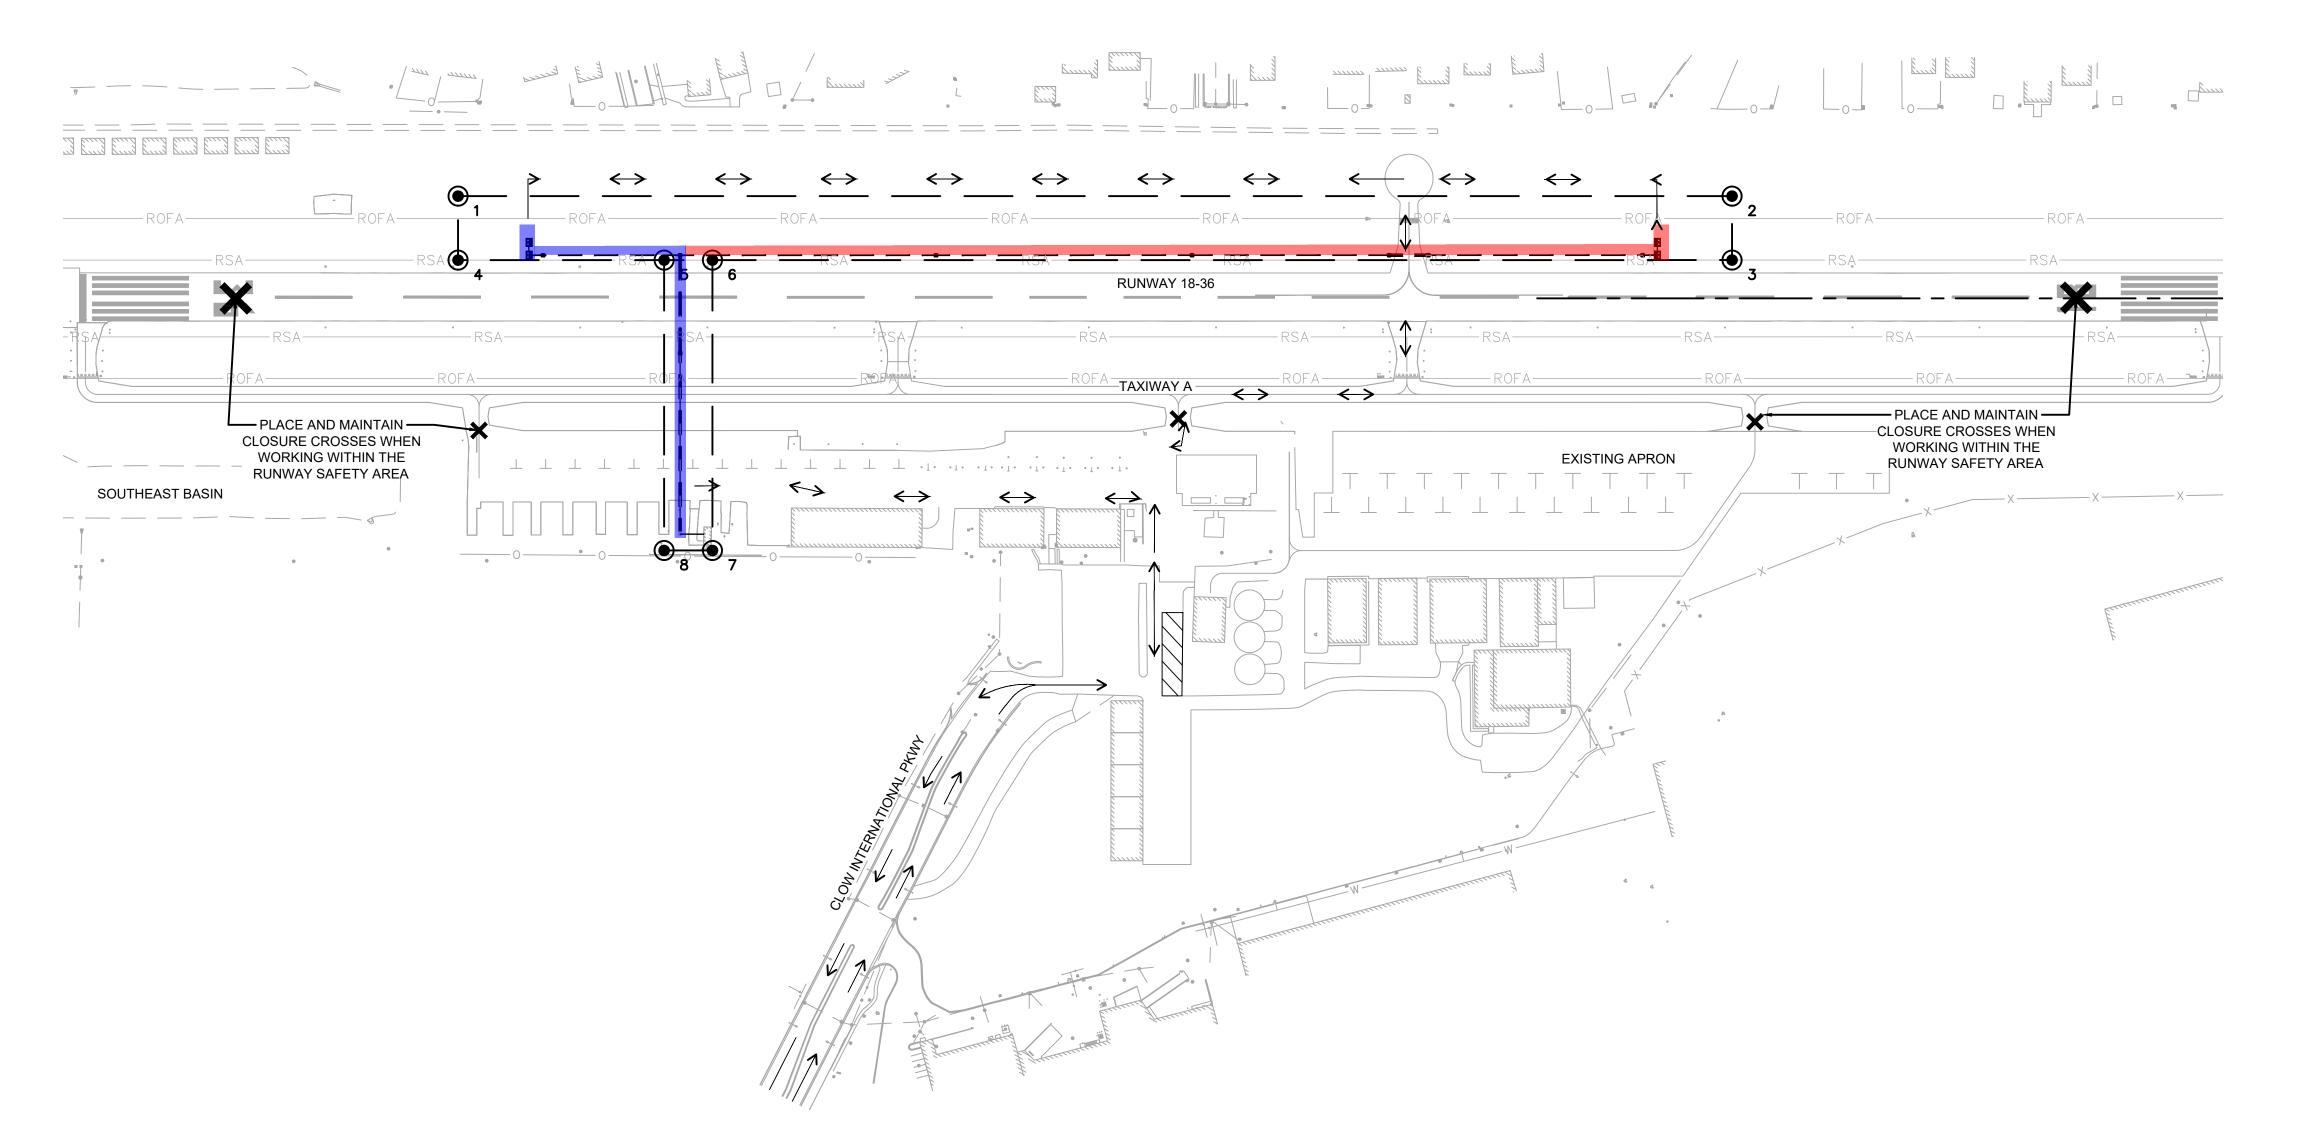


LEGEND

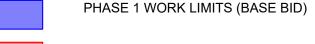





PHASE 2 WORK LIMITS (ALTERNATE BID)

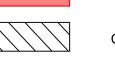

CONTRACTOR STAGING AND STORAGE AREA



AIRSPACE EVALUATION LIMITS AIRSPACE CRITICAL LOCATION



RUNWAY OBJECT FREE AREA

CONTRACTOR HAUL ROUTE

RUNWAY SAFETY AREA



TAXIWAY OR RUNWAY CLOSURE CROSS (SEE DETAIL ON SHEET PH-501)

GENERAL NOTES

- THE CONTRACTOR SHALL PROVIDE A CONSTRUCTION SCHEDULE TO THE AIRPORT AND RESIDENT ENGINEER FOR APPROVAL IN ACCORDANCE WITH THESE PHASING PLANS, SPECIFICATIONS, AND GENERAL PROVISIONS.
- THE CONTRACTOR SHALL NOTIFY THE AIRPORT MANAGER AND RESIDENT ENGINEER A MINIMUM OF 72 HOURS IN ADVANCE OF A RUNWAY CLOSURE
- PRIOR TO IMPLEMENTATION OF THIS PLAN, THE AIRPORT WILL ANALYZE ALL CONSTRUCTION ACTIVITY AND/OR OTHER SPECIALIZED ACTIVITY ON THE AIRPORT AND DETERMINE THE LIMITATIONS TO BE IMPOSED.
- 4. SUBSTANTIAL COMPLETION OF WORK SHALL INCLUDE ALL WORK REQUIRED TO OPEN TAXIWAY, TAXILANE, APRONS AND HANGARS TO OPERATIONAL USE BY AIRCRAFT.
- WORK WITHIN ACTIVE TAXIWAY SAFETY AND/OR OBJECT FREE AREAS SHALL BE PERFORMED IN ACCORDANCE WITH THE PHASING PLANS AND SHALL BE COORDINATED WITH THE
- THE CONTRACTOR SHALL BE AWARE AND YIELD TO ALL ACTIVE AIRCRAFT OPERATIONS DURING CONSTRUCTION.
- THE CONTRACTOR SHALL ACCESS EACH WORK AREA BY THE HAUL ROUTES SHOWN ON THE PLANS. ANY DEVIATION TO THE HAUL ROUTES MUST BE APPROVED BY THE AIRPORT AND RESIDENT ENGINEER.
- THE CONTRACTOR SHALL MAINTAIN ACCESS TO SERVICE ROADS AND AIRPORT TENANT AREAS AT ALL TIMES.
- THE CONTRACTOR SHALL UTILIZE THE AIRPORT ENTRANCE AT CLOW INTERNATIONAL PARKWAY TO GAIN ACCESS TO THE JOB SITE.
- 10. THE USE OF OFF-ROAD TRUCKS ARE NOT PERMITTED ON THE AIRPORT SERVICE DRIVES OR OTHER ROADWAYS. THE CONTRACTOR CAN ONLY UTILIZE TRUCKING EQUIPMENT
- 11. THE CONTRACTOR SHALL LIMIT TRUCK TRAFFIC BACKING UP ON CLOW INTERNATIONAL PARKWAY.
- 12. THE CONTRACTOR SHALL CONDUCT POWER VACUUM CLEANING IMMEDIATELY FOLLOWING ANY ACCESS ONTO OR CROSSING OF THE PAVEMENT BY CONSTRUCTION TRAFFIC.
- 13. NOTICE OF PROPOSED CONSTRUCTION WAS SUBMITTED ON JUNE 09, 2025 TO THE FAA OBSTRUCTION EVALUATION/ AIRPORT AIRSPACE ANALYSIS (OE/AAA).



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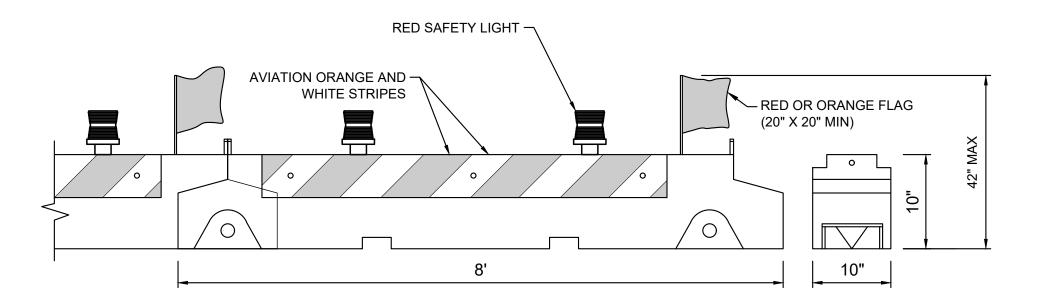
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CERTIFICATION: LUKE M. BURLINGAME . / 062-076682 - 6 06/06/2025

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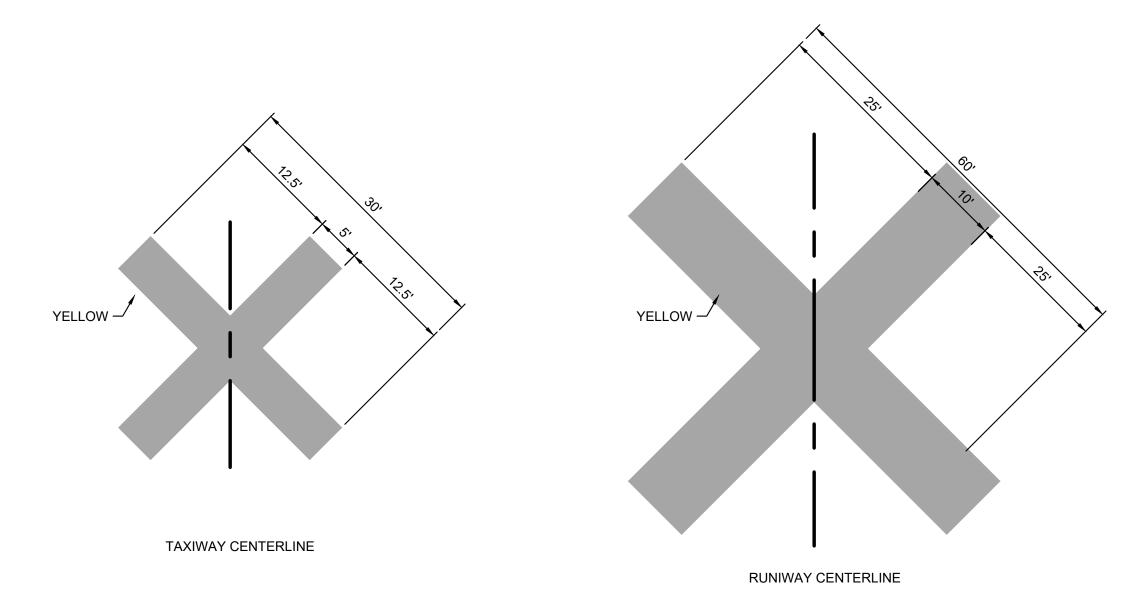
PH-101 PROJECT NUMBER: 168001006

Know what's **below**. Call before you dig.




BARRICADE NOTES:

- 1. THE CONTRACTOR SHALL FURNISH AND MAINTAIN PORTABLE LOW PROFILE CONSTRUCTION BARRICADES ON THIS PROJECT. IT SHALL BE THE CONTRACTOR'S RESPONSIBILITY TO MAINTAIN THE BARRICADES IN WORKING ORDER THROUGHOUT THE PROJECT. MAINTENANCE WILL LIKELY INCLUDE, BUT IS NOT LIMITED TO: REPLACEMENT LAMPS, FLAGS, BARRICADES ETC. BARRICADES SHALL BE INSPECTED FOR SATISFACTORY OPERATION EVERY TWO (2) HOURS DURING WORKING HOURS. NO SEPARATE PAYMENT WILL BE MADE FOR SUPPLYING, MAINTAINING AND MOVING BARRICADES BUT SHALL BE CONSIDERED INCIDENTAL TO PAY ITEM AR150520, MOBILIZATION.
- 2. AT PROJECT COMPLETION, ALL BARRICADES SHALL BE REMOVED FROM THE AIRPORT PROPERTY AND SHALL REMAIN THE PROPERTY OF THE CONTRACTOR.
- 3. LOW PROFILE CONSTRUCTION BARRICADES:
- A. SHALL BE MULTI-BARRIER MODEL No. AR-10X96, LO PRO MODEL No. AB96, NAC MODEL No. GD9670, OR APPROVED EQUAL.
- B. SHALL HAVE AT LEAST TWO (2) OMNI-DIRECTIONAL LOW INTENSITY FLASHING RED LIGHT ATTACHED TO EACH BARRICADE. LAMPS SHALL ALTERNATE PER FAA AC 70/7460-1 AND IDOT REQUIREMENTS.
- C. THE FINAL LOCATION FOR THE BARRICADES SHALL BE ESTABLISHED IN THE FIELD WITH CONCURRENCE FROM THE RESIDENT ENGINEER.
- D. SHALL HAVE AT LEAST TWO (2) ORANGE OR RED FLAGS (FOR CLARITY, ORIENTATION IN DETAIL ABOVE SHOWN FOR GENERAL PURPOSE AND DOES NOT REFLECT ACTUAL FLAG PLACEMENT).
- E. SHALL BE SECURED TO THE PAVEMENT BY FILLING WITH WATER OR SAND BAGS. SAND BAGS SHALL BE THE SAME COLOR AS THE BARRICADES.
- F. BARRICADES SECURED BY WATER OR SAND SHALL BE CHECKED ON A DAILY BASIS FOR LEAKS.
- G. SHALL BE POSITIONED END TO END OR INTERLOCKED WITH NO GAP.



NOTES:

- TAXIWAY/RUNWAY CLOSURE MARKERS SHALL BE CONSTRUCTED OF AN EASILY REMOVABLE MATERIAL, SUCH AS PLYWOOD OR FABRIC, AND HELD IN PLACE WITH SAND BAGS PAINTED YELLOW. TAXIWAY/RUNWAY CLOSURE MARKERS SHALL BE YELLOW IN COLOR.
- 2. THE CONTRACTOR SHALL PLACE TAXIWAY/RUNWAY CLOSURE MARKERS ON THE CENTERLINE OF THE TAXIWAY OR RUNWAY TO BE CLOSED AS SHOWN ON PLANS OR AS DIRECTED BY
- 3. TAXIWAY/RUNWAY CLOSURE MARKERS SHALL BE CONSIDERED INCIDENTAL TO ITEM AR150520, MOBILIZATION.

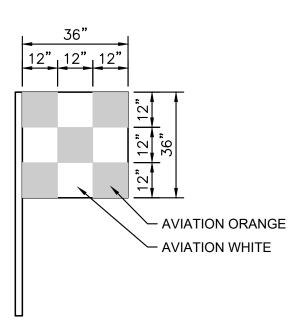

VEHICLE AND EQUIPMENT FLAG NOTES:


- 1. ALL CONSTRUCTION MECHANIZED EQUIPMENT AUTHORIZED WITHIN THE MOVEMENT AREA OR RELATED SAFETY AREAS SHALL BE MARKED WITH A 3'X3' ORANGE AND WHITE CHECKERED FLAG WITH EACH BOX BEING 1 'SQUARE.
- 2. THE FLAG SHALL BE LOCATED ON THE UPPERMOST PORTION OF THE VEHICLE/MOTORIZED EQUIPMENT, OR BE ESCORTED BY A VEHICLE SO EQUIPPED.
- 3. VEHICLE AND EQUIPMENT FLAGS SHALL BE CONSIDERED INCIDENTAL AR150520, MOBILIZATION.




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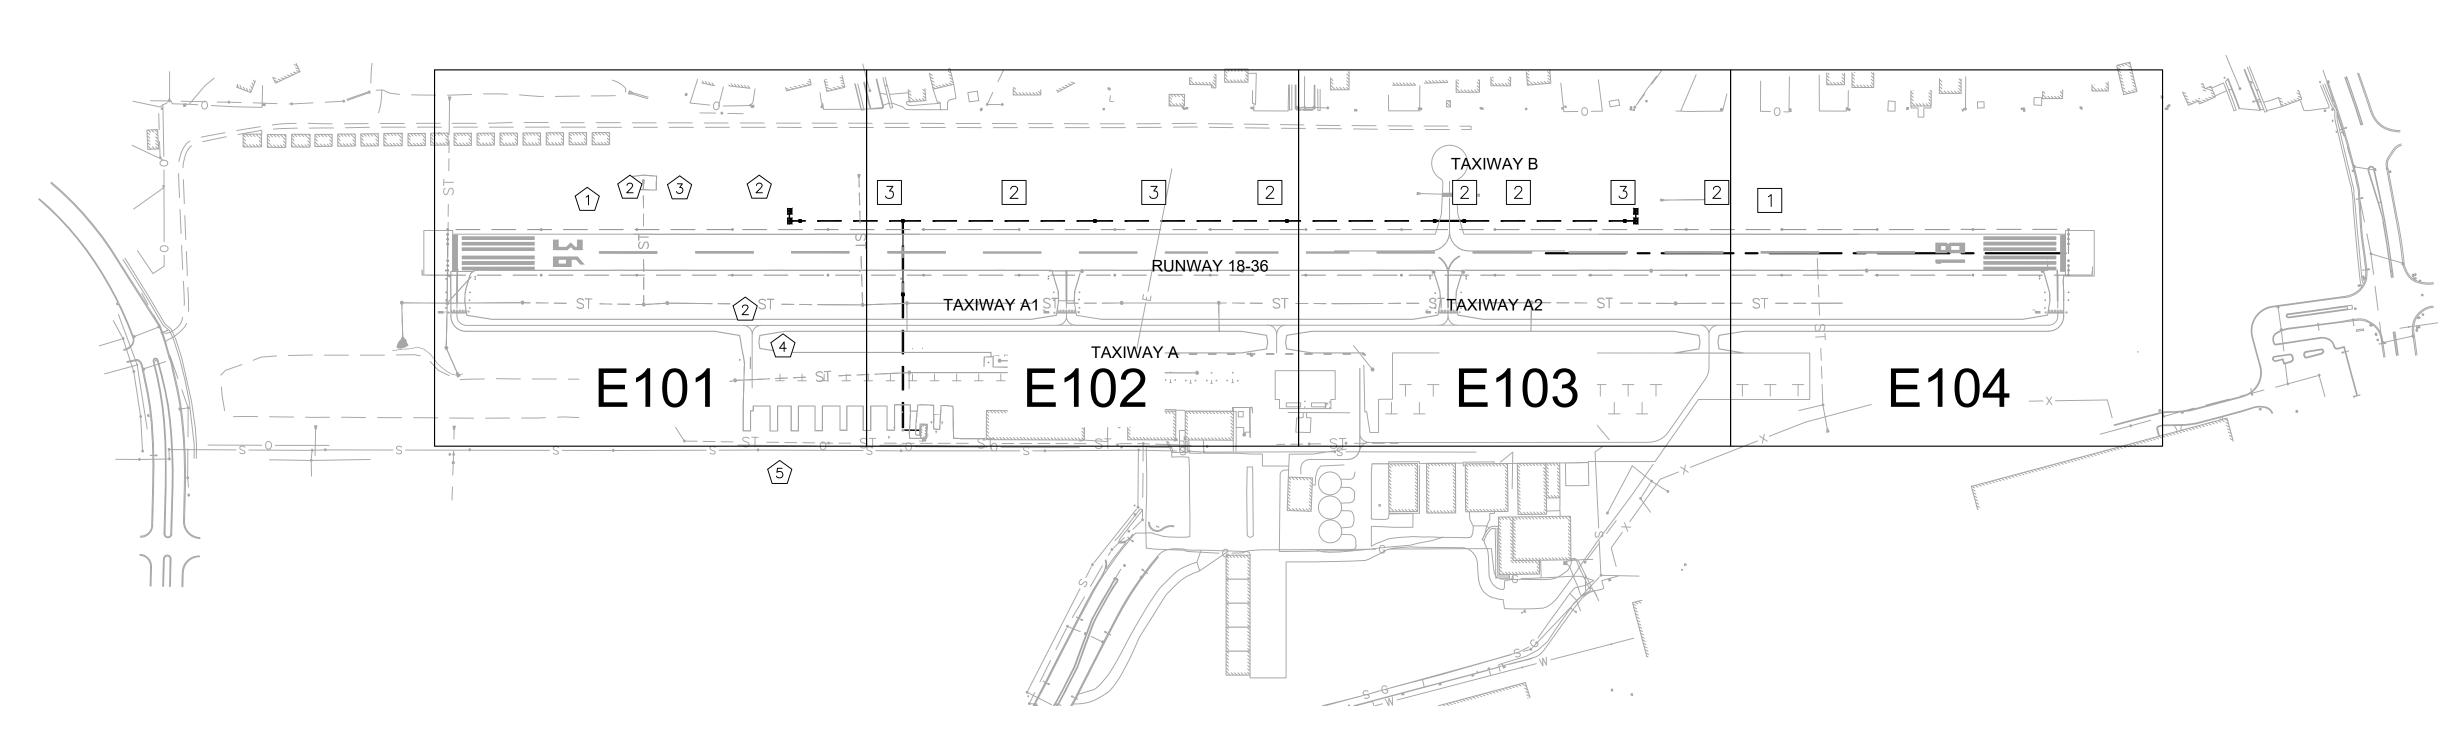
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PROJECT NUMBER:

168001006

CERTIFICATION:

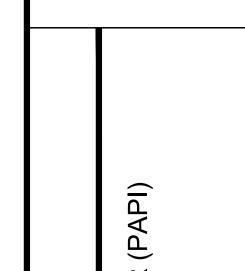

ELECTRICAL SCOPE OF WORK - BASE BID

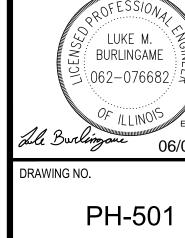- 1) INSTALL NEW TWO-BOX LED PAPI ON RUNWAY 36 END.
- 2) PROVIDE AND INSTALL NEW H-20 LOAD RATED CONCRETE HANDHOLE.
- (3) INSTALL NEW 2-2" DIRECT BURIED SCH 40 PVC DUCT BANK.
- DIRECTIONAL BORE 2-2" SCH 80 HDPE CONDUIT FOR PAPI CIRCUIT.
- (5) INSTALL NEW 5KW CONSTANT CURRENT REGULATOR IN EXISTING ELECTRICAL VAULT.

ELECTRICAL SCOPE OF WORK - ALT 1

- 1 INSTALL NEW TWO-BOX LED PAPI ON RUNWAY 18 END.
- 2 PROVIDE AND INSTALL NEW H-20 LOAD RATED CONCRETE HANDHOLE.
- 3 INSTALL NEW 2-2" DIRECT BURIED SCH 40 PVC DUCT BANK.

ABBREVIATIONS

AIR TRAFFIC CONTROL TOWER

CONDUIT

CONSTANT CURRENT REGULATOR. CONCRETE ENCASED (PER P-610)

DIRECT EARTH BURIAL, PER P-152 OR P-153

DIRECTIONAL BORE/DRILL

EXISTING EQUIPMENT OR FACILITY FEDERAL AVIATION ADMINISTRATION

MANUFACTURER

MEDIUM INTENSITY RUNWAY LIGHTS

NEW EQUIPMENT OR FACILITY

OFFSET ALONG SURVEY DATUM BASELINE.

PRECISION APPROACH PATH INDICATOR

PB PULL BOX

POINT OF CONNECTION (WITH EXISTING CONDUIT OR DUCT)

POLYVINYLCHLORIDE: CONDUIT MATERIAL PVC

REMOVE EQUIPMENT OR FACILITY

RUNWAY END IDENTIFIER LIGHTS

RUNWAY SAFETY AREA

R/W, RWY RUNWAY

DISTANCE ALONG SURVEY DATUM BASE LINE

TFMR TRANSFORMER

TSA TAXIWAY SAFETY AREA


T/W, TWY TAXIWAY

TYP. TYPICAL UNLESS OTHERWISE NOTED

SYMBOL LIST

NEW CONDUIT ---- EXISTING CONDUIT CONCRETE HANDHOLE

STYLE B L-881 PRECISION APPROACH PATH INDICATOR (PAPI)

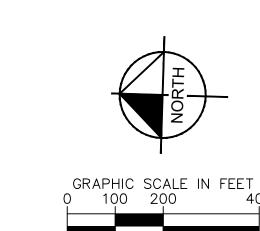





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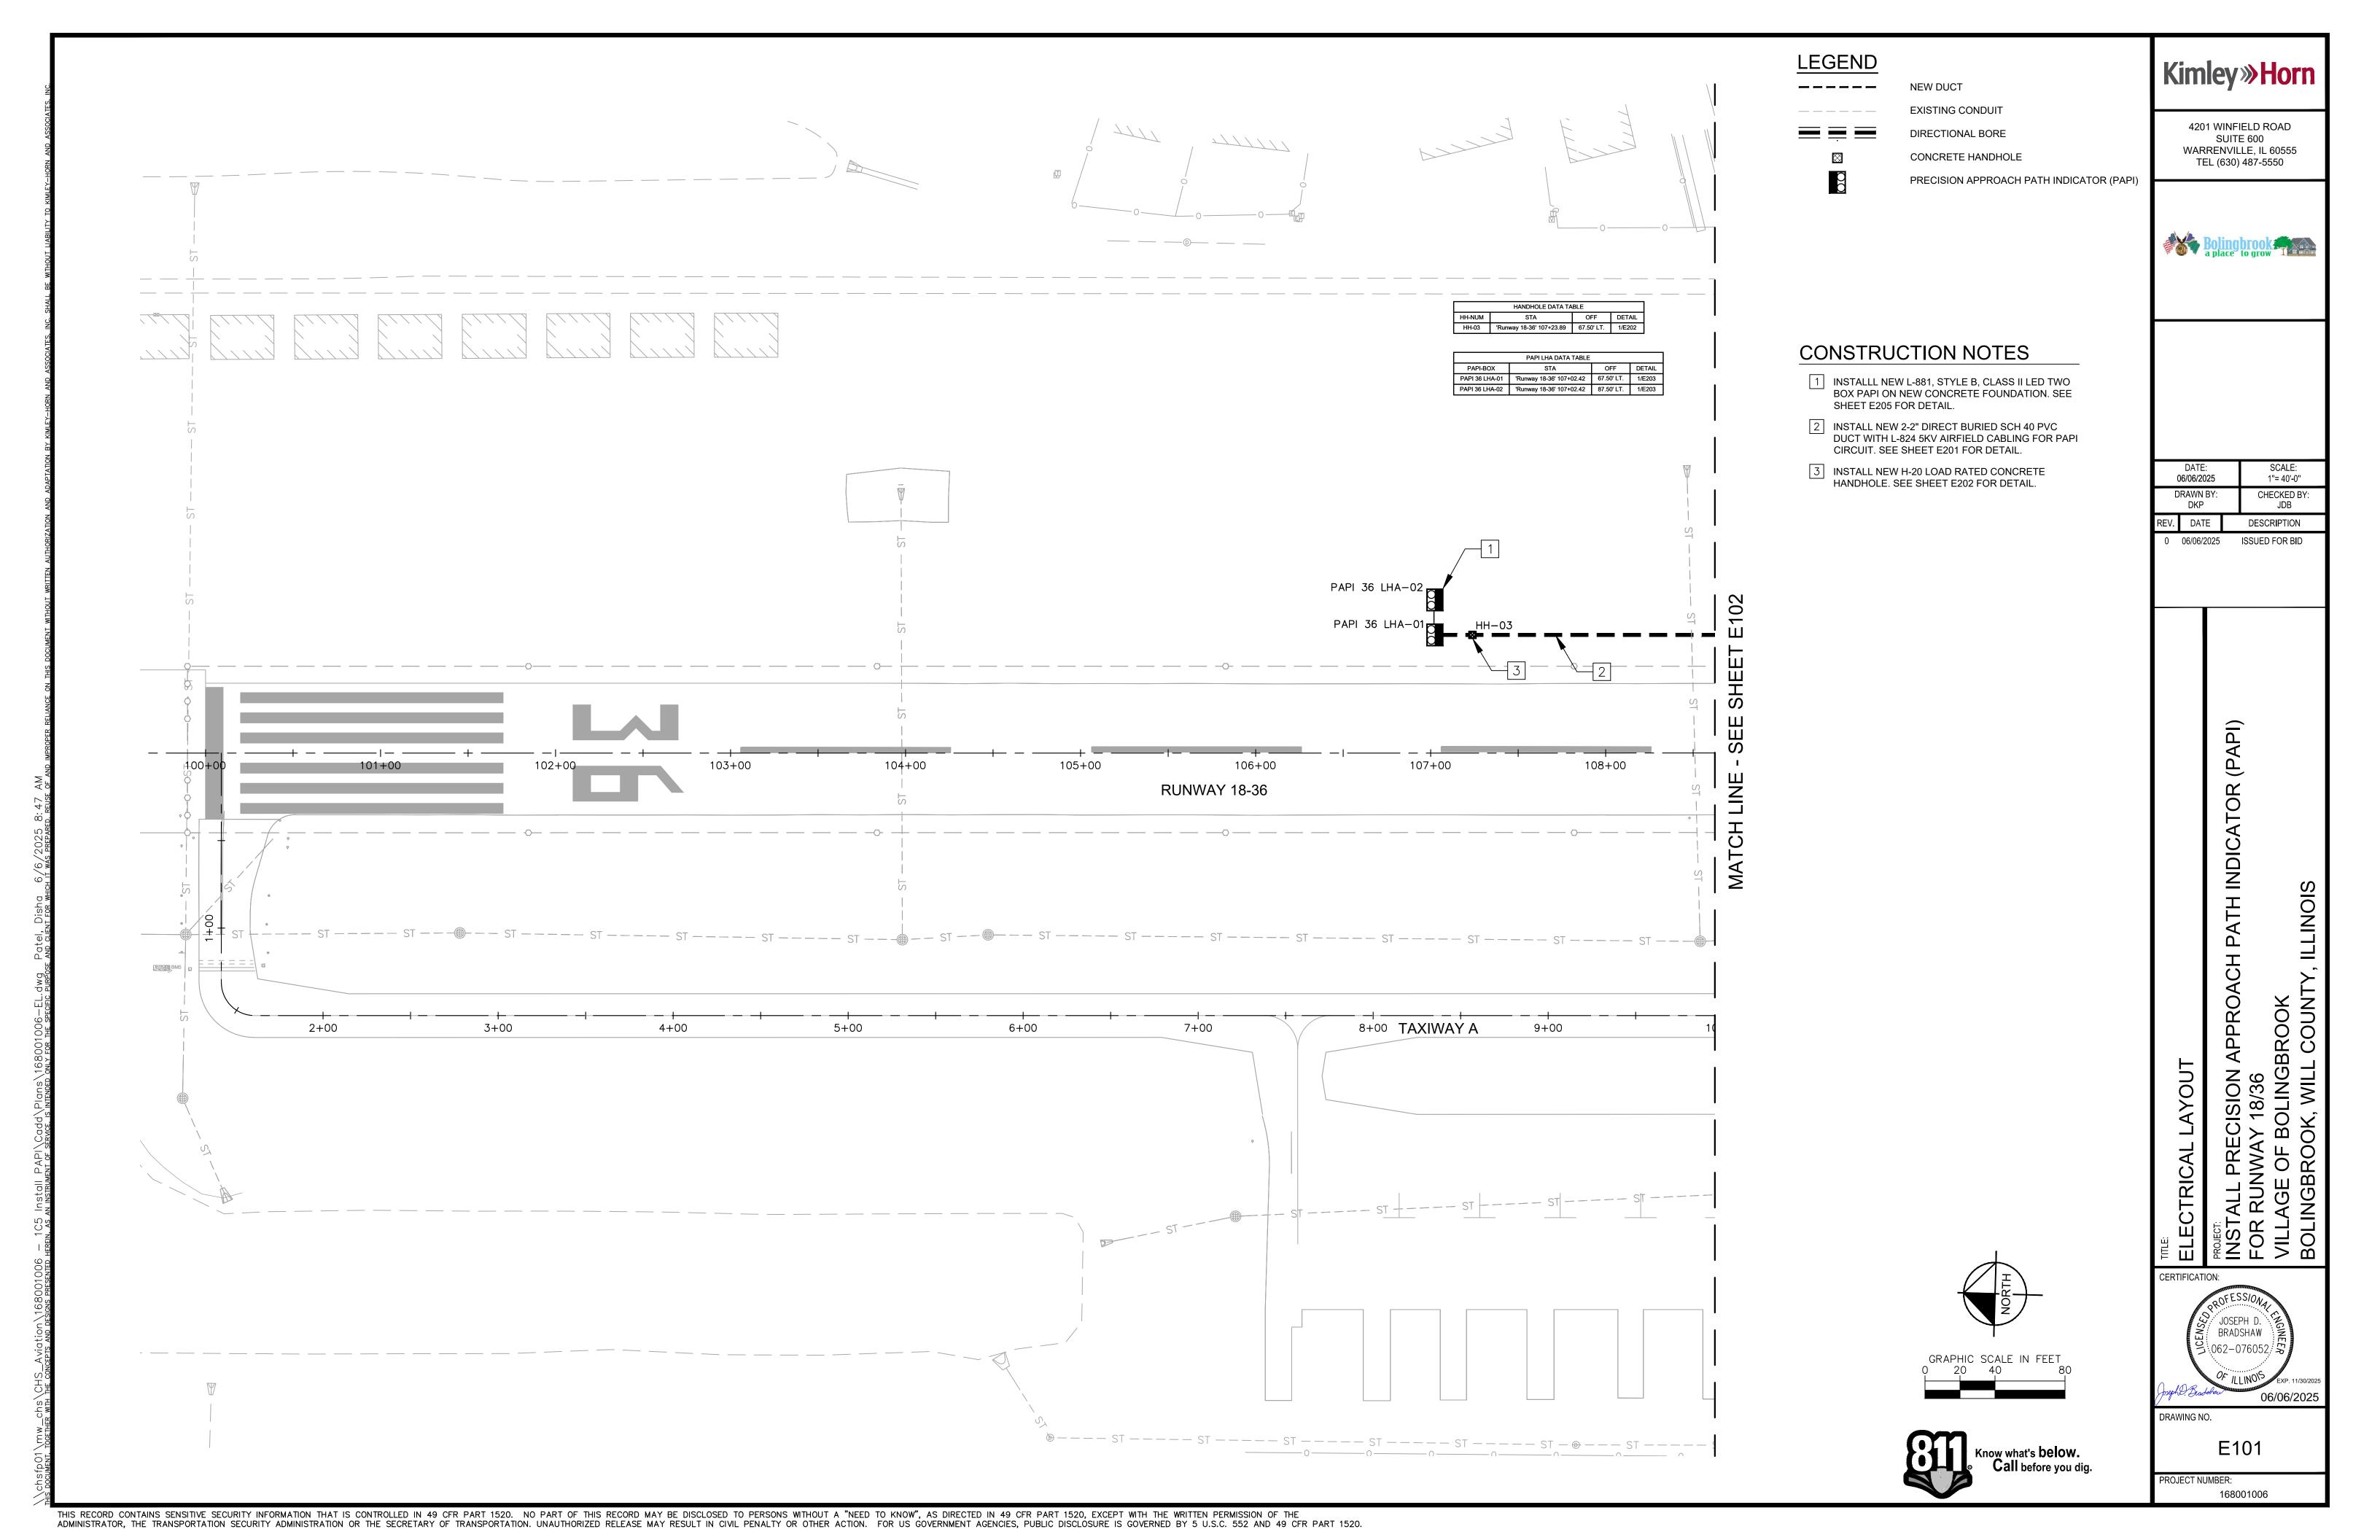
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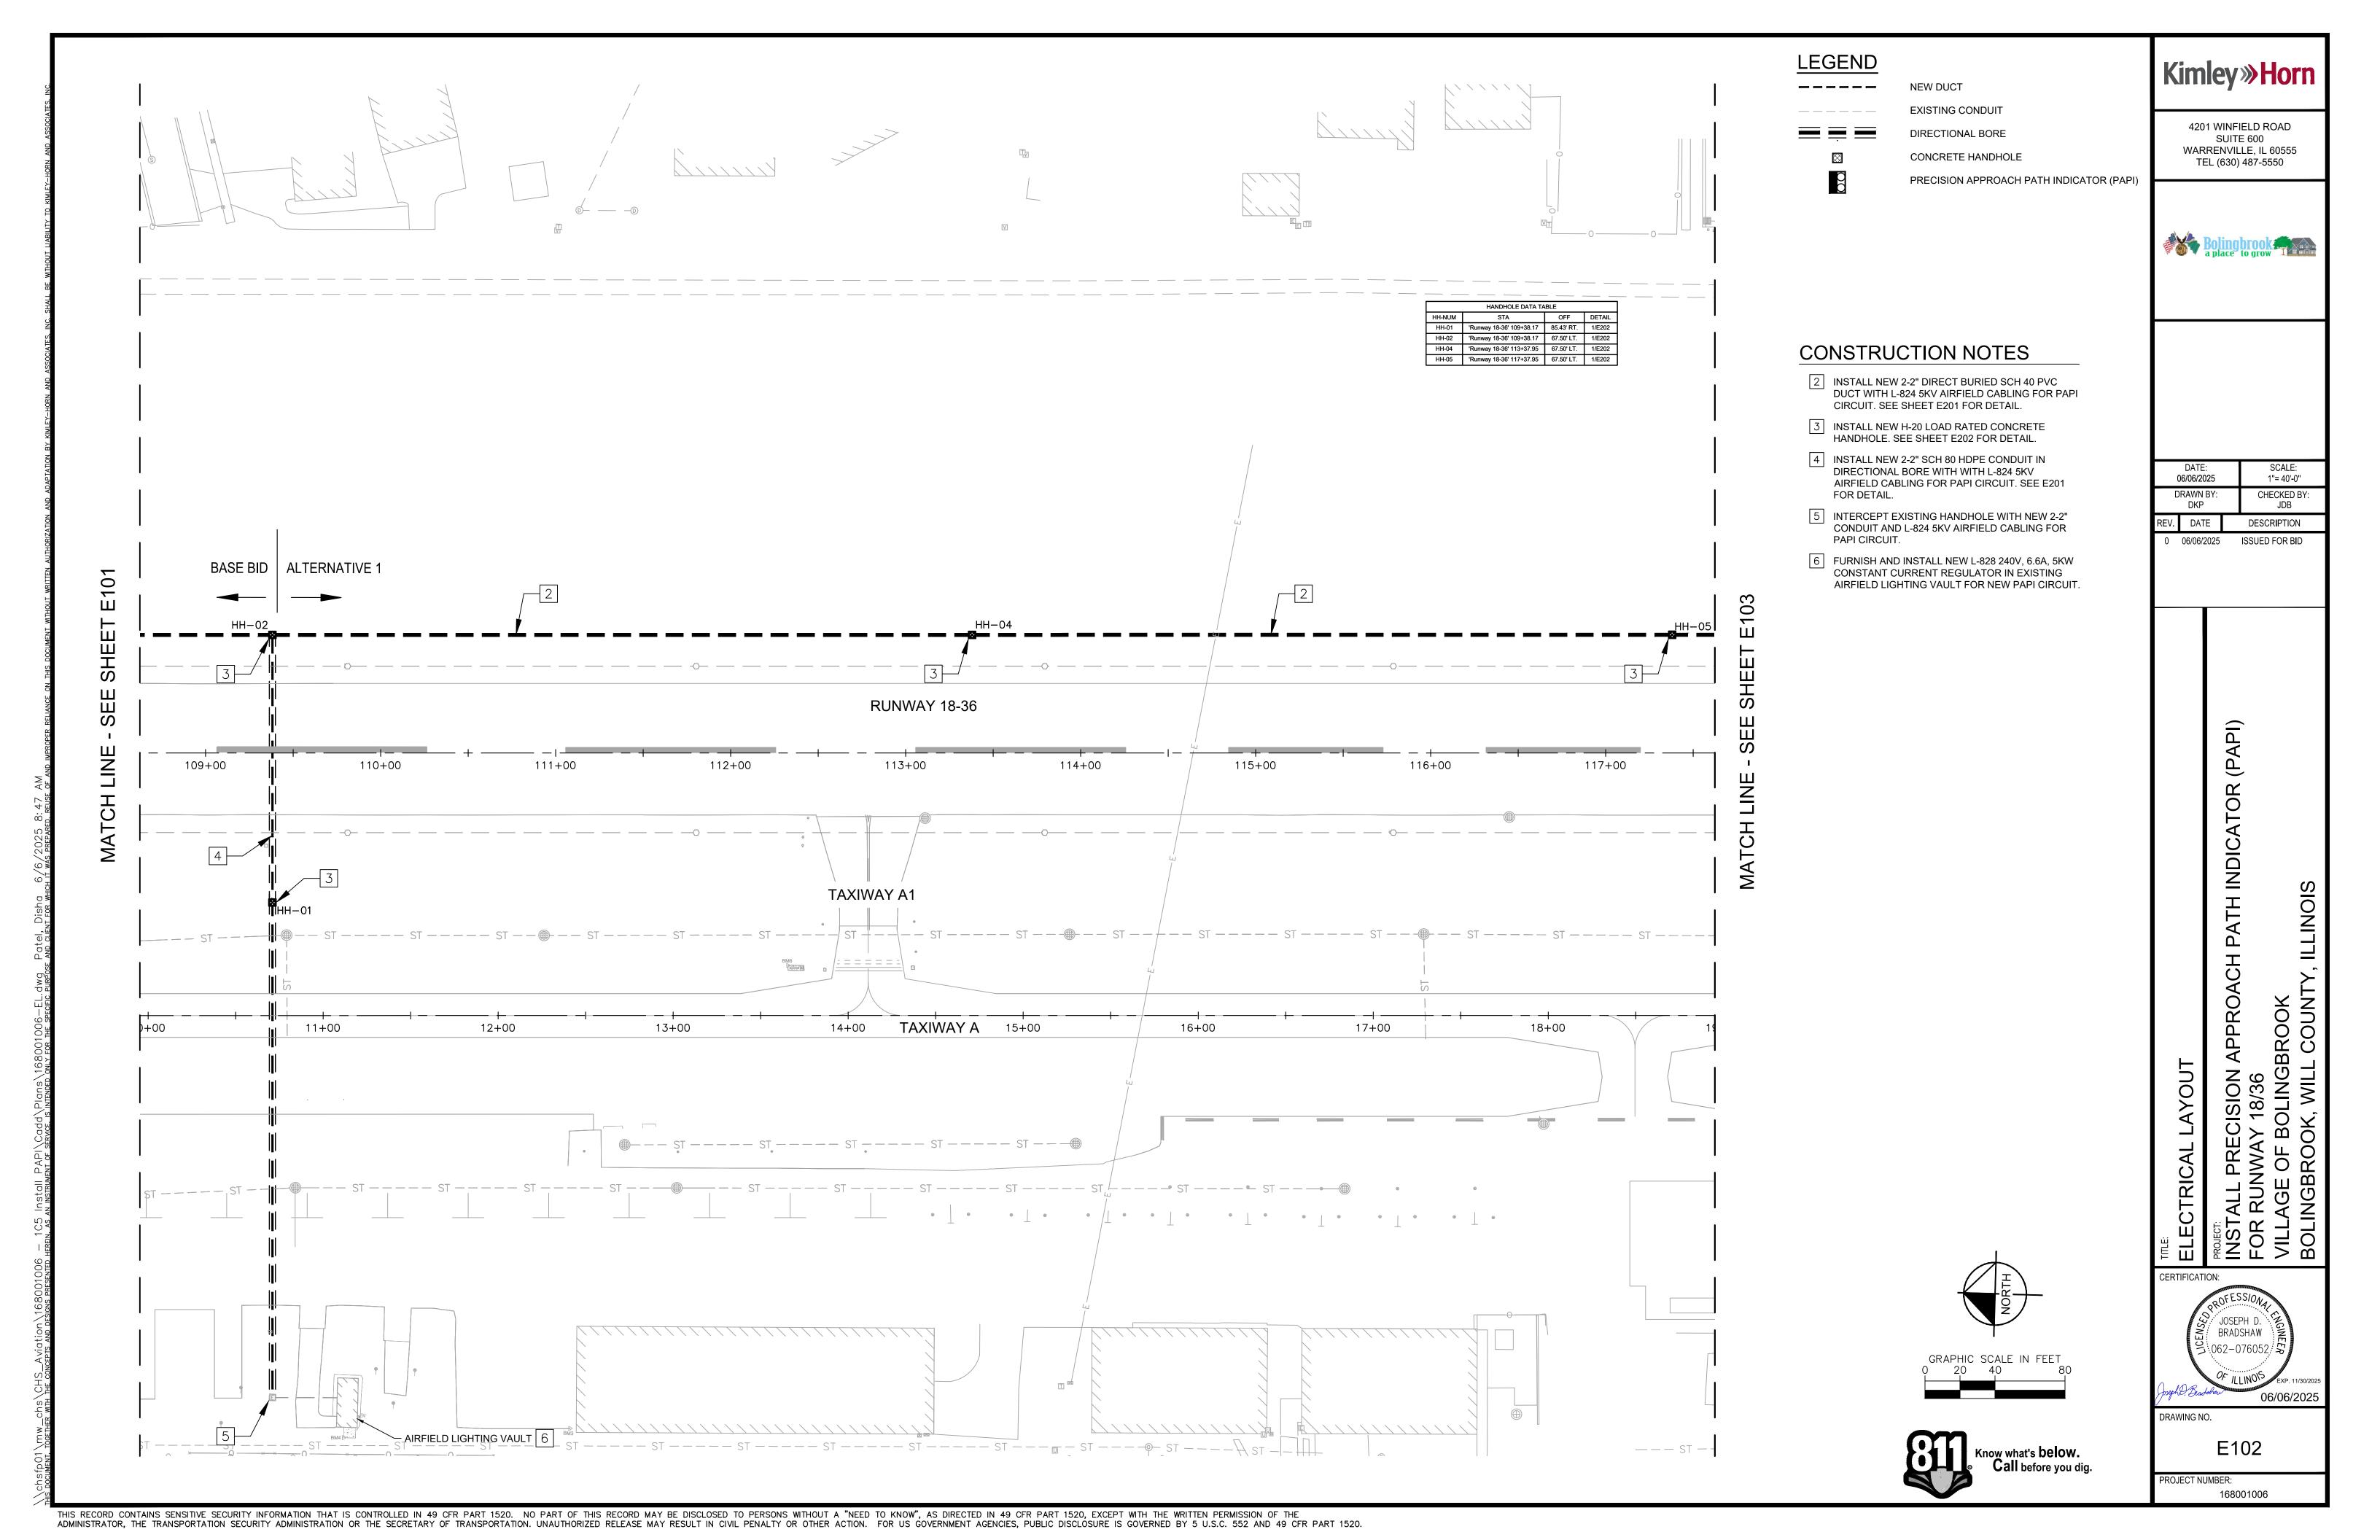
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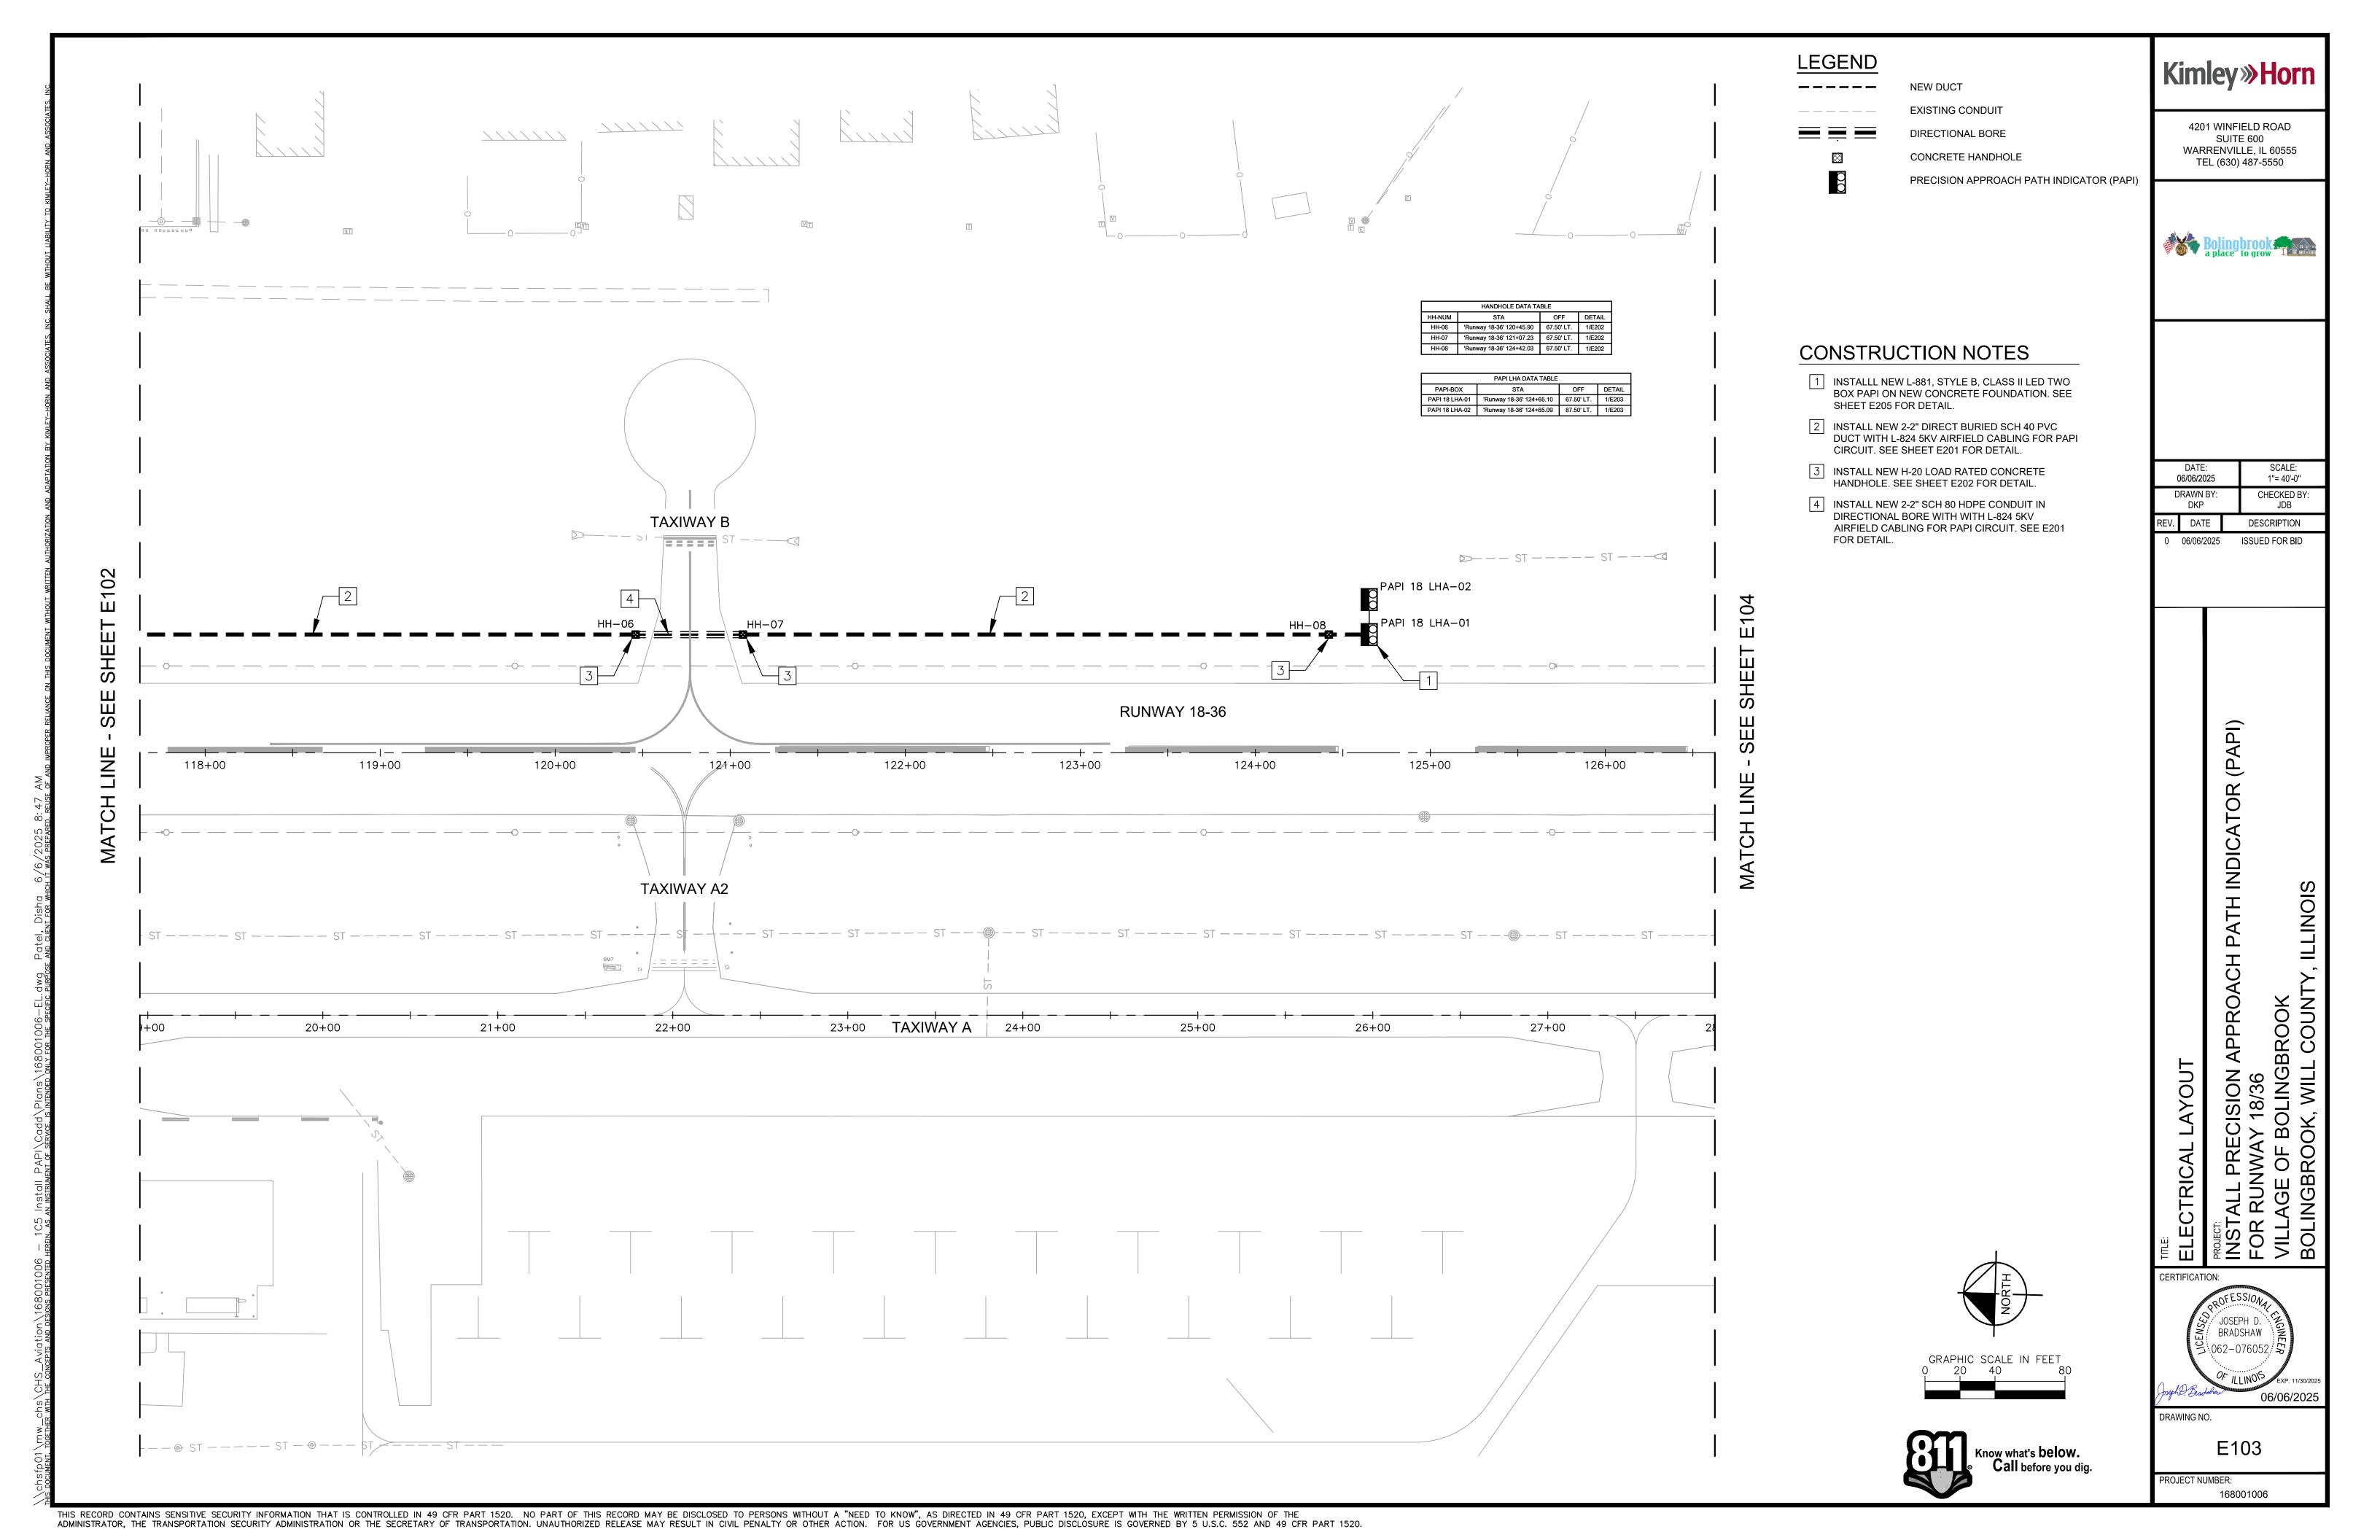
CERTIFICATION: JOSEPH D. BRADSHAW 19.062-076052 F


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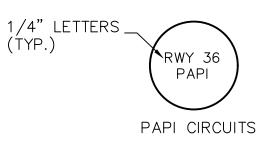
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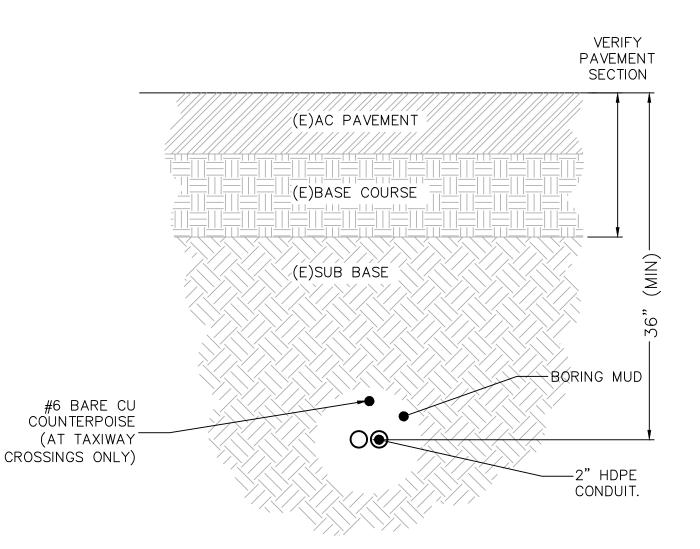




NOTES:

- 1. BLANK SERVCO BRONZE MARKERS OR EQUIVALENT TO BE EMBEDDED IN FRESH CONCRETE AT TIME OF POUR. LOCATE ON SIDE OF BASE TOWARD R/W OR T/W OR AS DIRECTED BY OWNER. AFTER CONCRETE IS CURED, STAMP WITH FIXTURE AND CIRCUIT IDENTIFICATION AS SHOWN ON PLANS.
- 2. ALL LIGHTING SYSTEM (SIGNS AND LIGHTS) CABLES ENTERING OR LEAVING OR PASSING THROUGH A MANHOLE, HANDHOLE, PULLBOX, OR LIGHTING FIXTURE BASE SHALL BE IDENTIFIED ON EACH SIDE OF EACH L-823 CONNECTOR KIT WITH AN INDIVIDUAL IDENTIFICATION TAG INDICATING THE LIGHTING CIRCUIT.
- 3. NO LIGHTING SYSTEM CABLE SHALL BE PULLED "STRAIGHT THROUGH" A HANDHOLE, MANHOLE, JUNCTION BOX OR LIGHT BASE. EACH CABLE SHALL PROVIDED WITH THE SPECIFIED LOOP OF SLACK CABLE AND, UNLESS OTHERWISE NOTED, SHALL BE SPLICED IN EACH MANHOLE, HANDHOLE, JUNCTION BOX AND LIGHT BASE WITH L-823 CONNECTOR KITS AND HEAT-SHRINKABLE SHEATHS AND COLOR CODING. "HOMERUNS" SHALL BE RUN AS CONTINUOUSLY AS POSSIBLE WITHOUT SPLICES IN MANHOLES OR HANDHOLES. "HOMERUNS" ARE THE CIRCUIT PORTION FROM THE LAST HANDHOLE/MANHOLE CONTAINING BRANCHES OF THE CIRCUITS IN SEPARATE DIRECTIONS OF THE FIELD.
- 4. TAGS SHALL BE NON-CORROSIVE MATERIAL OF TYPE AND SIZE AS SPECIFIED UNDER IL AIRPORT CONSTRUCTION SPECIFICATIONS ITEM 108, CONNECT TO CABLE WITH PLASTIC CABLE TIE.
- 5. ALL NOMINAL 600V POWER CABLES OR MULTI-PAIR SIGNAL CABLES SHALL BE IDENTIFIED WITH INDIVIDUAL IDENTIFICATION TAGS ONE TIME AS THEY PASS THROUGH EACH HANDHOLE OR MANHOLE AND ON BOTH SIDES OF ANY SPLICES.

1) POWER AND COMMUNICATION CABLE TAGS scale: NTS

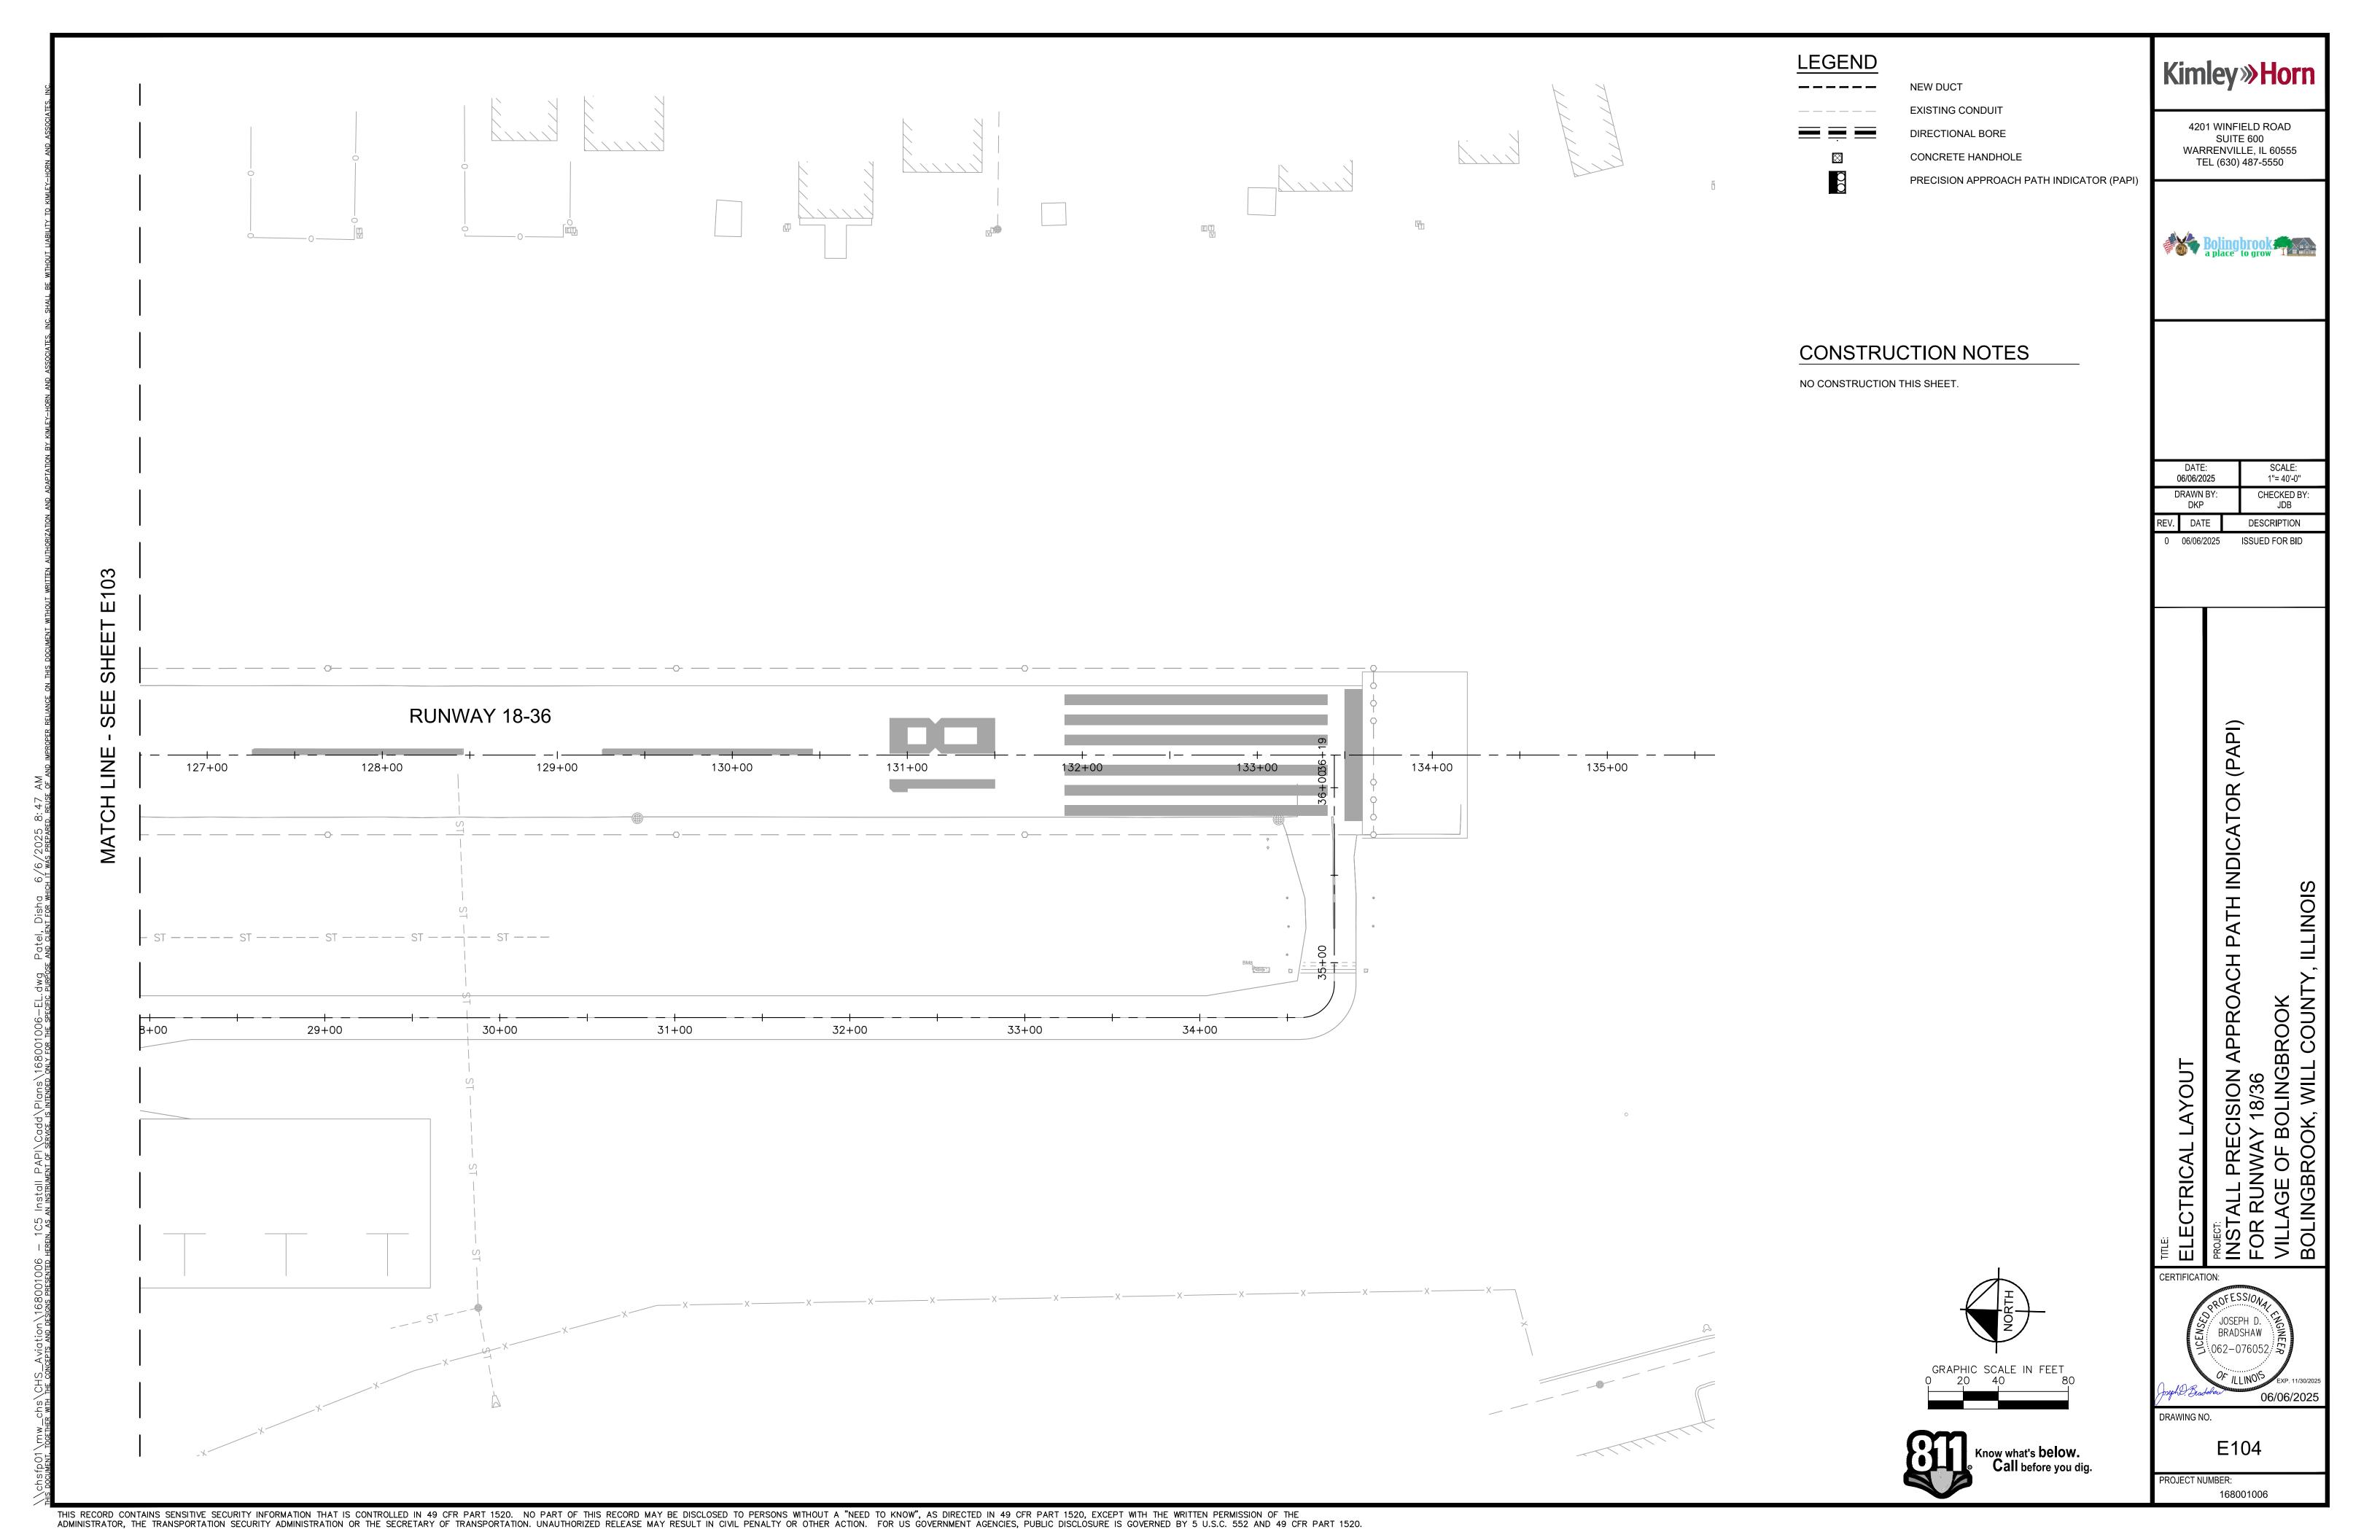



CONDUIT/DUCT & CABLE INSTALLATION NOTES:

- SEE PLANS FOR REQUIRED DUCT SECTIONS. ALL OF THE SECTIONS SHOWN ON THIS DRAWING MAY NOT BE USED ON THIS PROJECT.
- 2. PROVIDE PULL ROPES IN ALL (NEW) UNUSED CONDUITS. PLUG UNUSED CONDUIT ENDS IN HANDHOLES OR MANHOLES.
- 3. WARNING TAPE IS REQUIRED IN ALL AREAS OF THE AIRPORT.
- 4. UNLESS OTHERWISE NOTED, INSTALL A BARE COPPER (BC) COUNTERPOISE CONDUCTOR (#6 FOR AIRFIELD POWER, #1/0 FOR FAA POWER AND COMM) WITH EACH DUCT ASSEMBLY AND EACH SINGLE CONDUIT. EXOTHERMICALLY WELD TO GROUND RODS PER IL AIRPORT CONSTRUCTION SPECIFICATIONS ITEM 108 AND 110.
- 5. INSTALL LIGHTING SERIES CIRCUITS AS FOLLOWS:

 A. START INSTALLATION IN BOTTOM CONDUITS OF DUCT ARRAY, LEAVING THE UPPER CONDUITS EMPTY.
- 7. BACKFILL NOTES: REFER TO SPECIFICATION IL AIRPORT CONSTRUCTION SPECIFICATIONS ITEM 110-3.5.
- 8. REFER TO SPECIFICATION ITEM L-110 FOR CONDUIT/DUCT SPACER SYSTEM.

a: 2-2"C DIRECTIONAL BORE DETAIL SCALE: NTS

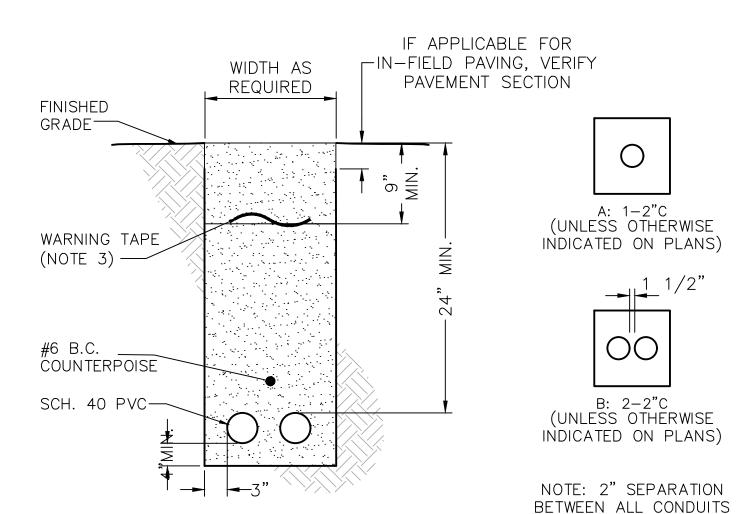


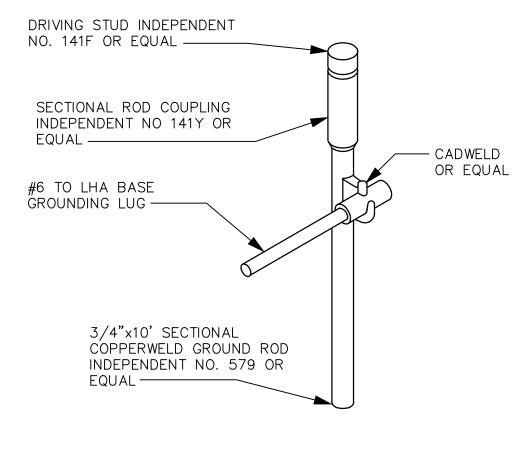


6 GROUNDING SYS. GROUND ROD DETAIL SCALE: NTS

TYPICAL TRENCH SECTION — DIRECT BURY

SCALE: NTS

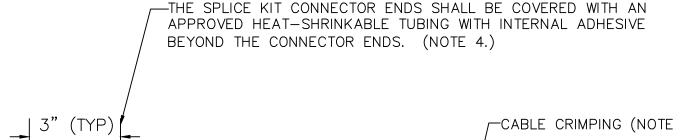

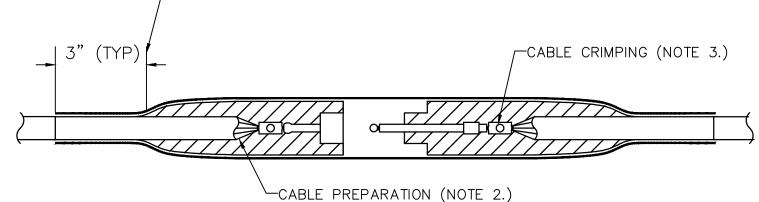

L-823 LINE RECEPTACLE END


L-823 LOAD PLUG END

FOR SPLICES INSIDE CAN, JUNCTION BOXES AND HANDHOLES


NOTES:

- 1. PROVIDE MALE & FEMALE L-823 CONNECTORS AS REQUIRED ON EACH CONDUCTOR IN EACH BASE, HANDHOLE OR MANHOLE TO ALLOW ISOLATION OF HOMERUN CIRCUIT.
- 2. ALL CABLE ENDS SHALL BE PREPARED, IF REQUIRED BY THE MANUFACTURER, WITH THE USE OF A TAPERING TOOL SPECIFICALLY DESIGNED FOR USE WITH L—824 CABLES. KNIFES SHALL NOT BE ALLOWED.
- 3. PLUG AND RECEPTACLE END FITTINGS SHALL BE CRIMPED ONTO THE CONDUCTOR BY USE OF AN AIRPORT PERSONNEL ACCEPTED HANDHELD RATCHETING TYPE CRIMPING TOOL. EACH CABLE TERMINATION SHALL BE SECURED BY TWO CRIMPS AS PER MANUFACTURER RECOMMENDATIONS.
- 4. ALL CABLE CONNECTORS SHALL BE MADE WITH L-823 CONNECTOR & WITH A 12" (APPROX.) LENGTH OF HEAT-SHRINKABLE RUBBER SHEATH OVER THE PLUG ASSEMBLY. CABLE CONNECTOR KITS SHALL BE SIZED FOR TYPE B CABLE.
- 5. AT THE POINT OF CONNECTION WITH THE EXISTING FIELD CIRCUITS, INSTALL NEW L-823 PLUGS ON BOTH THE NEW AND EXISTING CABLES. VERIFY INSULATION TYPES OF BOTH NEW & EXISTING CABLES & COORDINATE WITH TERMINATION KITS TO ASSURE PROPER AND WATERPROOF FIT.
- 6. THERE SHALL BE NO SPLICES BETWEEN LIGHTS, ONLY IN BASES OR HANDHOLES.



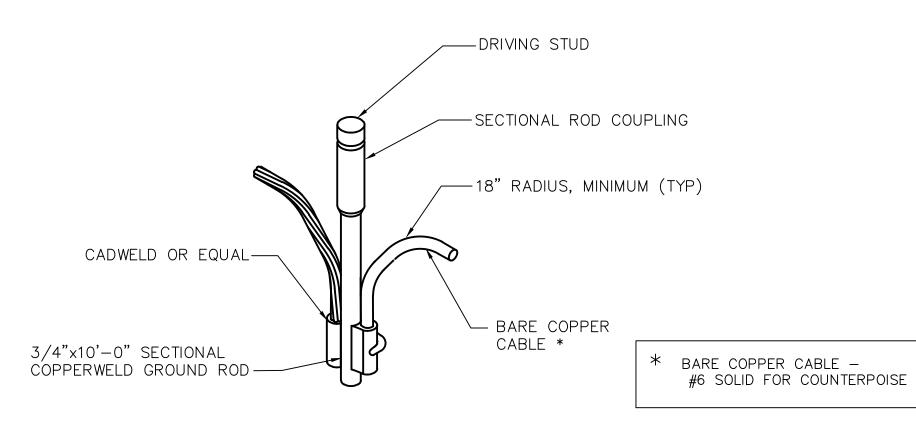

4 COUNTERPOISE SYS. GROUND ROD DETAIL scale: nts

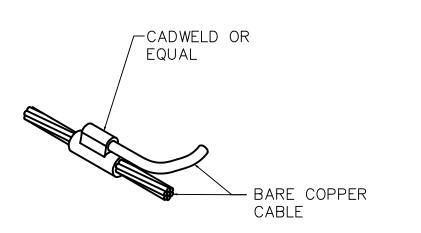

5 COUNTERPOISE SYSTEM GROUNDING DETAIL
scale: NTS

Kimley»Horn

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DATE: SCALE: N/A

DRAWN BY: CHECKED BY: JDB

REV. DATE DESCRIPTION

REV. DATE DESCRIPTION

0 06/06/2025 ISSUED FOR BID

ROACH PATH INDICATOR (PAPI)

NSTALL PRECISION APPROACH FOR RUNWAY 18/36

CERTIFICATION:

CERTIFICATION:

Sept. 11/30/202

Appl. Bradshaw

OF //LLINO/S

EXP. 11/30/202

O6/06/2025


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Know what's **below.**Call before you dig.

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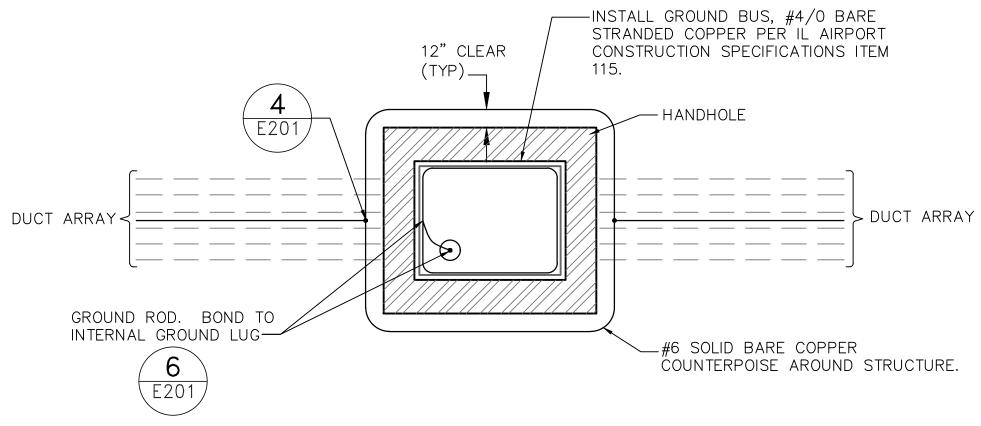
168001006

THIS RECORD CONTAINS SENSITIVE SECURITY INFORMATION THAT IS CONTROLLED IN 49 CFR PART 1520. NO PART OF THIS RECORD MAY BE DISCLOSED TO PERSONS WITHOUT A "NEED TO KNOW", AS DIRECTED IN 49 CFR PART 1520, EXCEPT WITH THE WRITTEN PERMISSION OF THE ADMINISTRATION, THE TRANSPORTATION SECURITY ADMINISTRATION OR THE SECRETARY OF TRANSPORTATION. UNAUTHORIZED RELEASE MAY RESULT IN CIVIL PENALTY OR OTHER ACTION. FOR US GOVERNMENT AGENCIES, PUBLIC DISCLOSURE IS GOVERNED BY 5 U.S.C. 552 AND 49 CFR PART 1520.




- 1. PROVIDE GALVANIZED STEEL RACK ARMS, BOLTED TO CHANNELS INSET IN HANDHOLE WALLS. PROVIDE MINIMUM (2) ARMS FOR EVERY
- 2. CABLE RACKING SHALL BE LIMITED TO THE UPPER HALF OF THE HANDHOLE.
- 3. PROVIDE CIRCUIT TAGS FOR EVERY L-823 CABLE SPLICE.
- 4. PROVIDE A MINIMUM OF EIGHT FEET OF CABLE BETWEEN ENTRY POINT AND L-823 SPLICE.
- 5. RACK CABLES ON SIDE(S) OF ENTRY/EXIT CONDUITS.
- 6. #2 AWG BARE COPPER PIGTAIL SHALL BOND THE GROUNDING BUS TO METALLIC CABLE RACK PER IL AIRPORT CONSTRUCTION SPECIFICATIONS ITEM 115.
- 7. DUCT/CONDUIT ARRAY SHALL ENTER HANDHOLE IN LOWER HALF OF THE HANDHOLE.
- 8. PROVIDE BELL END FOR EVERY CONDUIT IN THE ARRAY.
- 9. GROUT AROUND/BETWEEN CONDUITS & CONCRETE WALL.

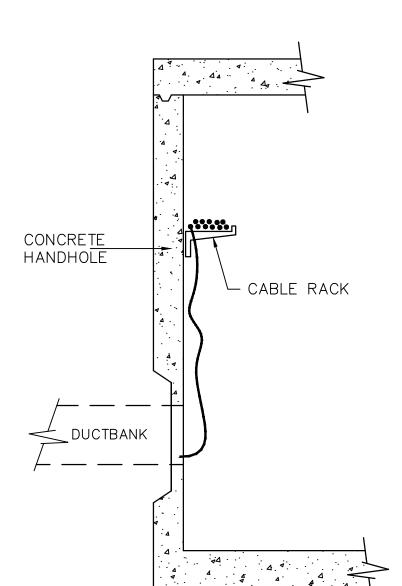



ALL COUNTERPOISE WIRES FOR DUCT BANKS AND CONDUITS TO BE CLAMPED TO COUNTERPOISE LOOP AROUND STRUCTURE

HANDHOLE COUNTERPOISE DETAIL SCALE: NTS

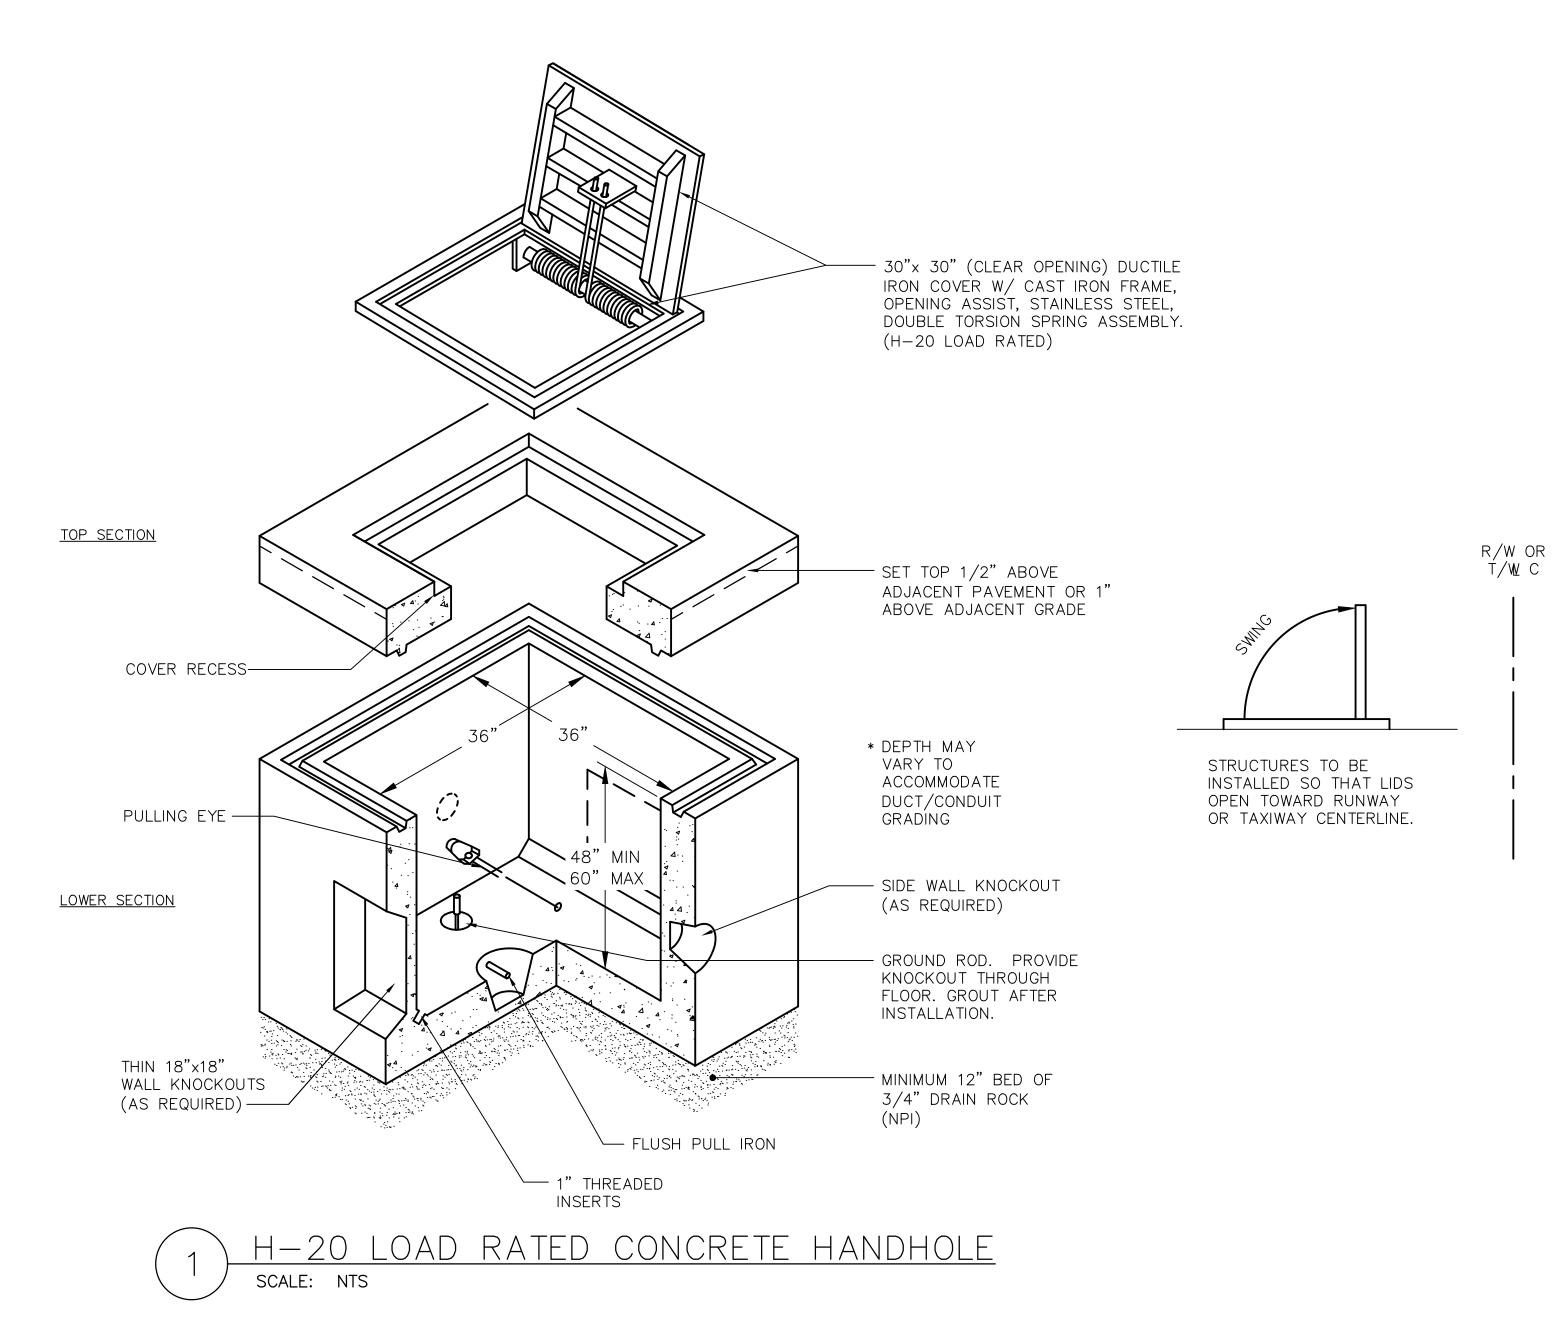

HANDHOLE NOTES:

- ALL STEEL, OTHER THAN REBAR, TO BE HOT DIPPED GALVANIZED AFTER FABRICATION. PROVIDE ALL HANDHOLES WITH CABLE RACKS AND PULLING EYES PER SPECIFICATIONS.
- INSTALL HANDHOLES PARALLEL TO ADJACENT RUNWAY OR TAXIWAY CENTERLINE.
- PROVIDE GROUND ROD FOR EACH HANDHOLE PER SPECIFICATIONS.
- GROUT ALL CONDUIT PENETRATIONS.
- PROVIDE MANUFACTURER'S DRAWINGS AND STRUCTURAL CALCULATIONS FOR ALL CONCRETE ELEMENTS OF HANDHOLES AND FABRICATED TRAFFIC LIDS.
- NOTE; DO NOT CONNECT COUNTERPOISE TO GROUNDING SYSTEM. ROUTE COUNTERPOISE AROUND HANDHOLES. SEE DETAIL 3 THIS SHEET.





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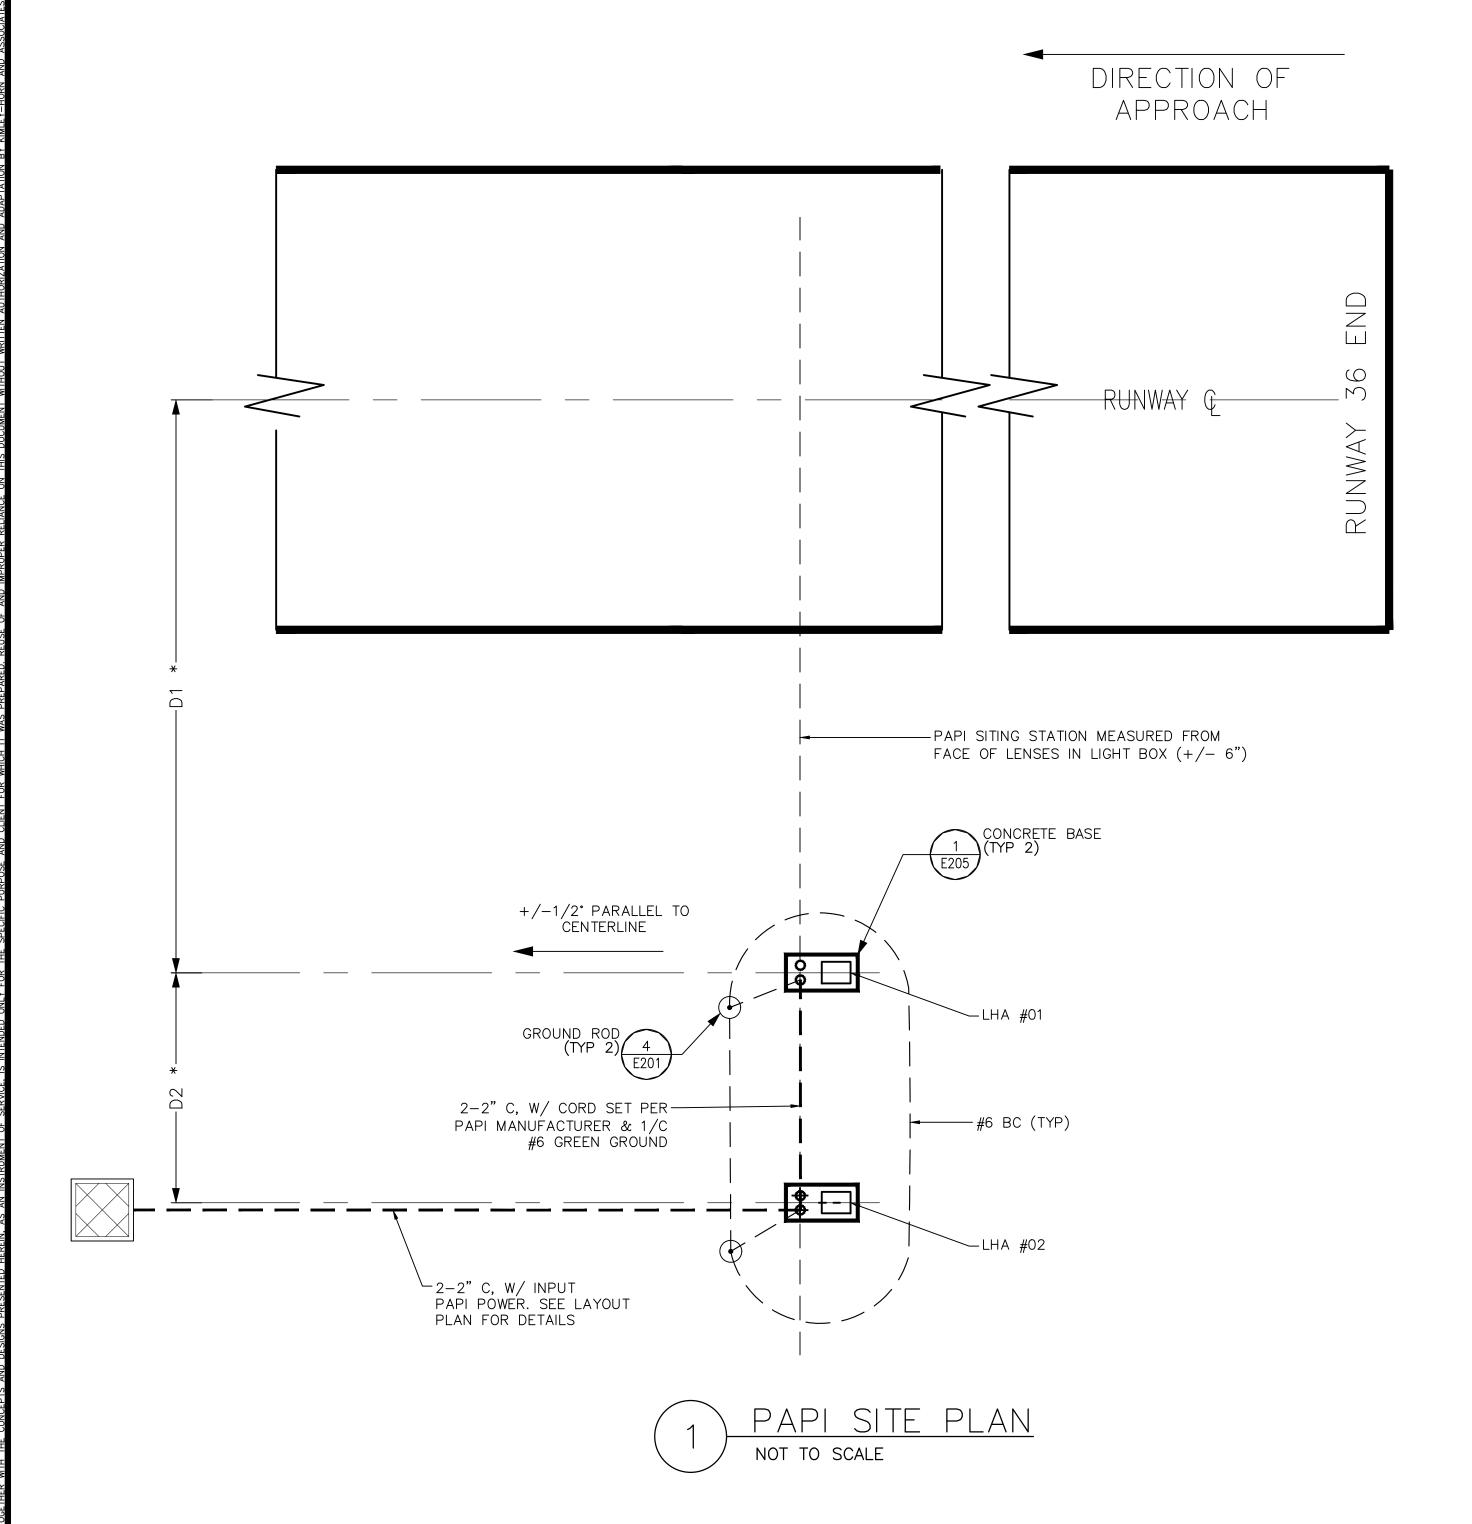
THIS RECORD CONTAINS SENSITIVE SECURITY INFORMATION THAT IS CONTROLLED IN 49 CFR PART 1520. NO PART OF THIS RECORD MAY BE DISCLOSED TO PERSONS WITHOUT A "NEED TO KNOW", AS DIRECTED IN 49 CFR PART 1520, EXCEPT WITH THE WRITTEN PERMISSION OF THE ADMINISTRATION, THE TRANSPORTATION SECURITY ADMINISTRATION OR THE SECRETARY OF TRANSPORTATION. UNAUTHORIZED RELEASE MAY RESULT IN CIVIL PENALTY OR OTHER ACTION. FOR US GOVERNMENT AGENCIES, PUBLIC DISCLOSURE IS GOVERNED BY 5 U.S.C. 552 AND 49 CFR PART 1520.


	PAPI SITING CRITERIA SCHEDULE											
R/\	DISTANCE FROM THRESHOLD	D1 DIST. FROM R/W Q TO Q OF LHA #1 (FT)	D2 LIGHT HOUSING ASSEMBLY (LHA) SPA. O.C. (FT.)	R/W CL ELEV. PAPI SITING STA (FT)**	LIGHT CENTER ELEVATION (FT)	AIMING ANGLE BASED ON 3° 00' GLIDE PATH*		EFFECTIVE VISUAL THRESHOLD CROSSING HEIGHT (TCH)	THRESHOLD R/W CENTERLINE ELEVATION (FT)**	R/W		
36	702.4	67'-6"	20'-0"	660.2'	661.2' (NOT TO EXCEED 1'	LHA#01	LHA#02	40.0'	357.0'	36		
	702.4	0, 0	20 0	000.2	ABOVE RUNWAY CL)	3° 15'	2° 45'	10.0	337.0			

SCHEDULE NOTE:

* COORD W/ AIRPORT FOR AIMING ANGLES PRIOR INSTALLING PLACARD AFTER FLIGHT TESTING.

** CONTRACTOR TO VERIFY ELEVATIONS IN THE FIELD PRIOR TO PAPI INSTALLATION.



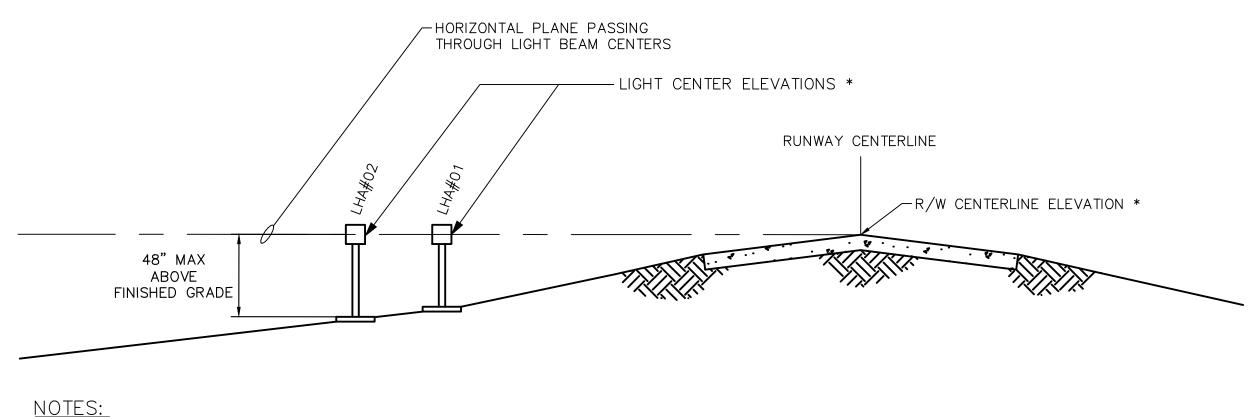

NOTES: 1. SEE PAPI CRITERIA SCHEDULE FOR THESE * DATA.







4201 WINFIELD ROAD SUITE 600 WARRENVILLE, IL 60555 TEL (630) 487-5550



(DATE: 06/06/2025	SCALE: N/A					
	RAWN BY: DKP	CHECKED BY: JDB					
DEV	DATE	DESCRIPTION					

0 06/06/2025 ISSUED FOR BID

L PRECISION APPROACH FINWAY 18/36
E OF BOLINGBROOK
BROOK, WILL COUNTY, ILL

CERTIFICATION: JOSEPH D. .. BRADSHAW **1**9.062-076052/ 06/06/2025

DRAWING NO.

E203


	PAPI SITING CRITERIA SCHEDULE										
R/W	DISTANCE FROM THRESHOLD	D1 DIST. FROM R/W Q TO Q OF LHA #1 (FT)	D2 LIGHT HOUSING ASSEMBLY (LHA) SPA. O.C. (FT.)	R/W CL ELEV. PAPI SITING STA (FT)**	LIGHT CENTER ELEVATION (FT)	AIMING ANGLE BASED ON 3° 00' GLIDE PATH*		BASED ON 3° 00' EFFECTIVE VISUAL		R/W	
18	894.90'	67'-6"	20'-0"	667.9'	668.9 (NOT TO EXCEED 1' ABOVE RUNWAY CL)	LHA#01 3° 15'	LHA#02 2° 45'	40.0'	674.90'	18	


SCHEDULE NOTE:

* COORD W/ AIRPORT FOR AIMING ANGLES PRIOR INSTALLING PLACARD AFTER FLIGHT TESTING.

** CONTRACTOR TO VERIFY ELEVATIONS IN THE FIELD PRIOR TO PAPI INSTALLATION.



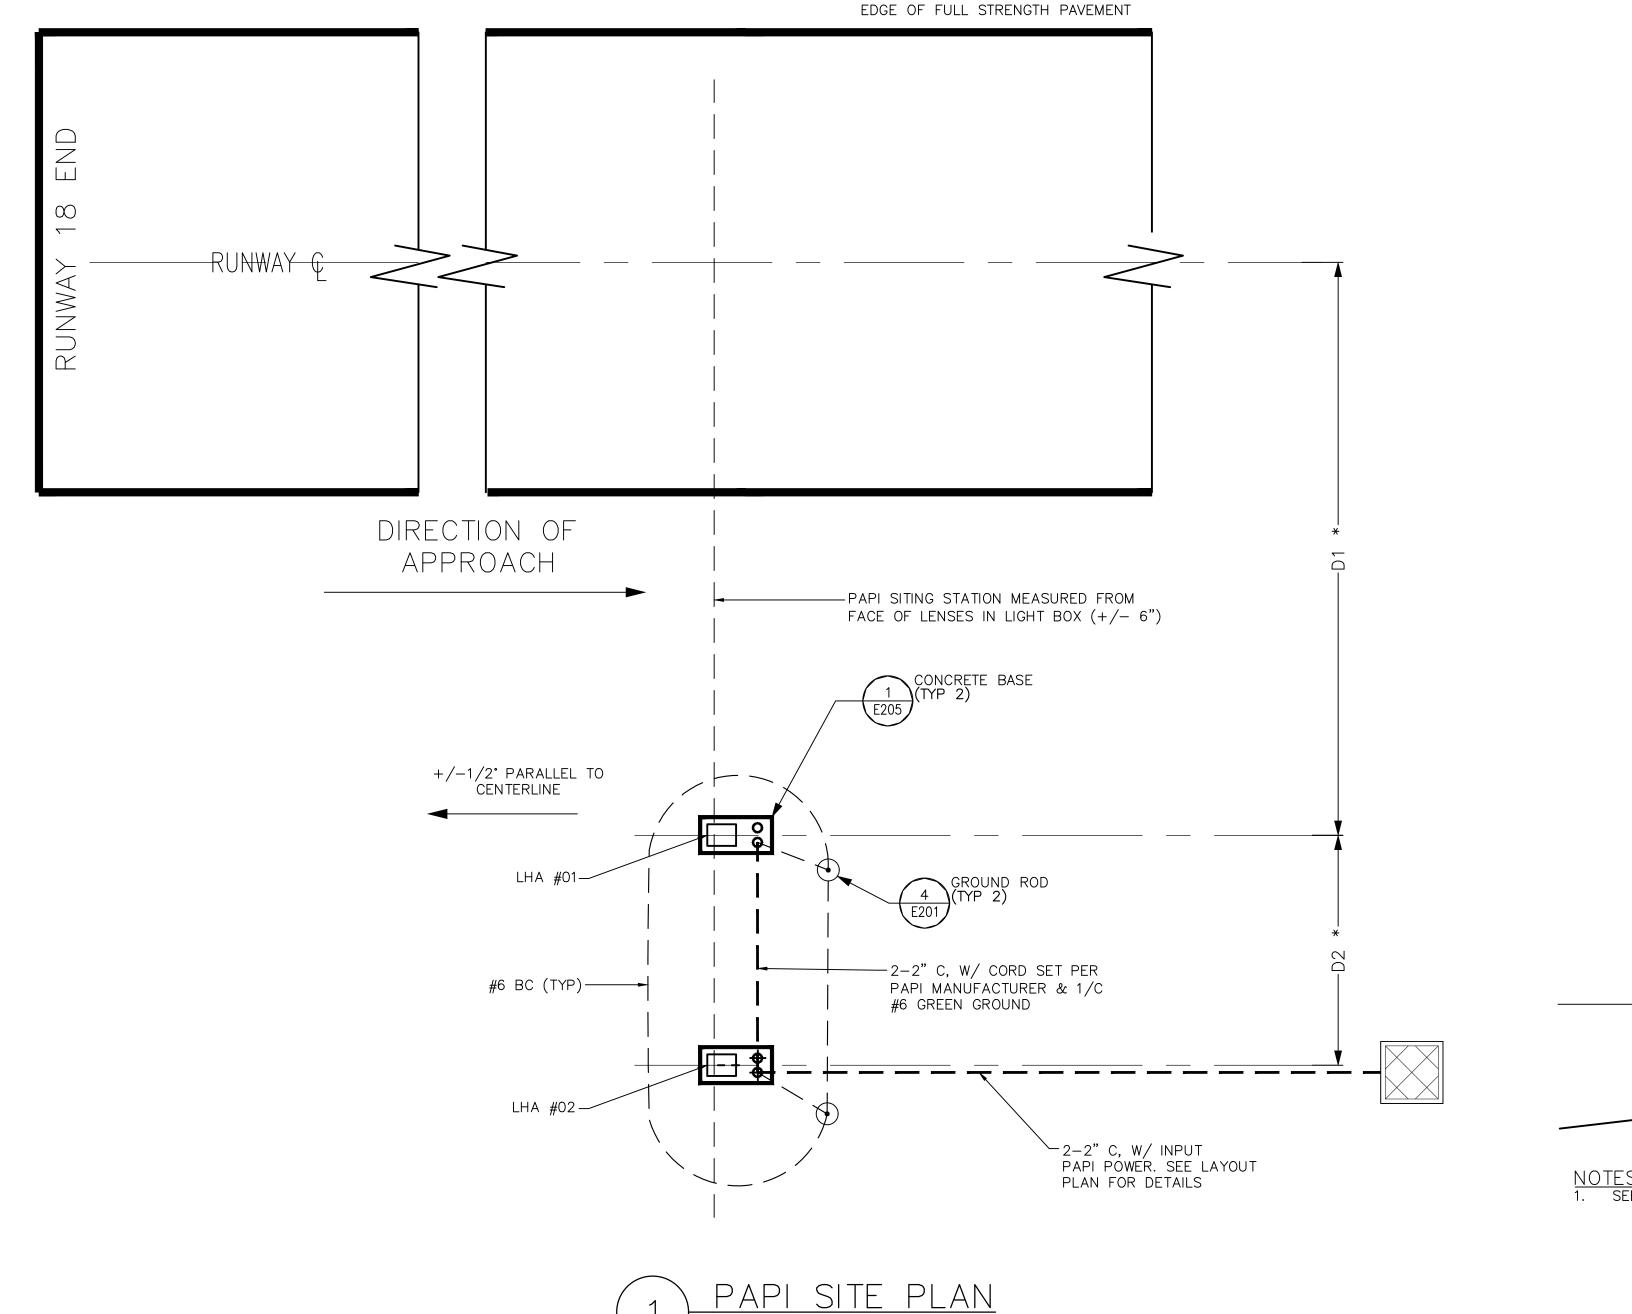

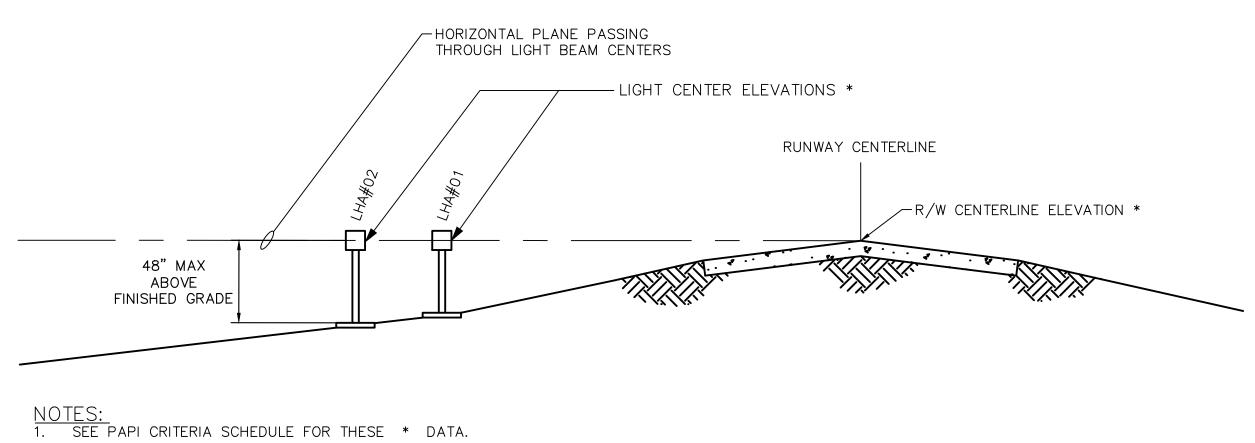

TYPICAL PAPI SECTION NOT TO SCALE





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	DATE:	SCALE:					
(06/06/2025		N/A				
D	RAWN BY: DKP		CHECKED BY: JDB				
REV.	DATE	DESCRIPTION					

0 06/06/2025 ISSUED FOR BID

PRECISION APPROACH FINWAY 18/36 E OF BOLINGBROOK


CERTIFICATION: BRADSHAW 9.062-076052


DRAWING NO.

E204

PROJECT NUMBER: 168001006

NOT TO SCALE

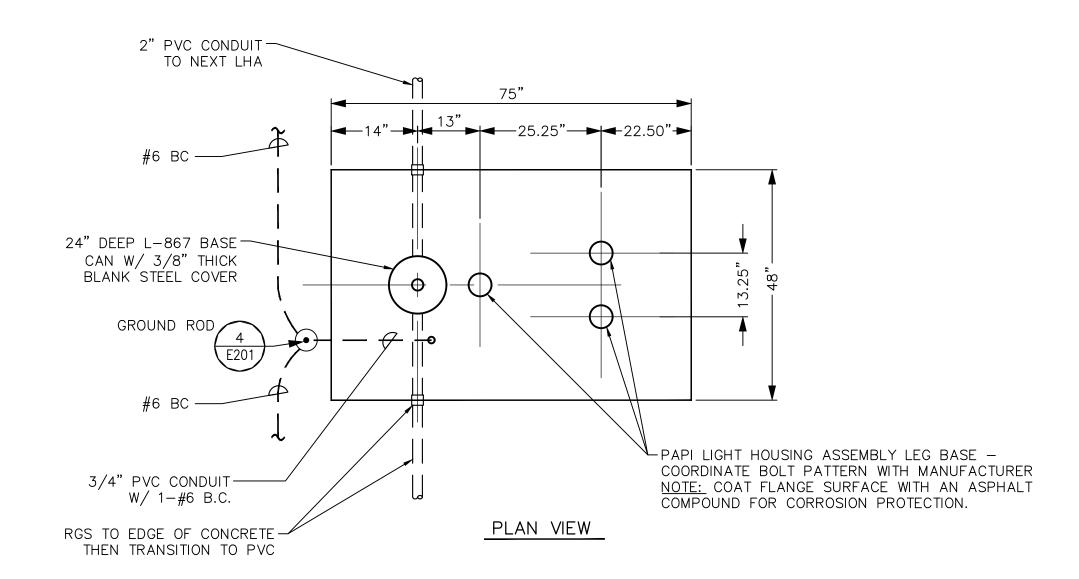


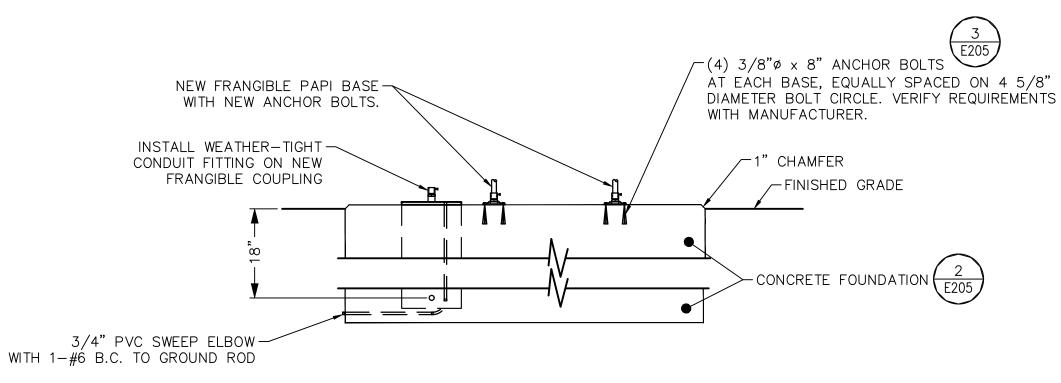


ELEVATION

NOTE: FINISH TOP OF CONCRETE BASE WITH 1/4"/FT. SLOPE, BOTH DIRECTIONS FROM LONGITUDINAL AXES.


1 PAPI LHA INSTALLATION SCALE: NTS

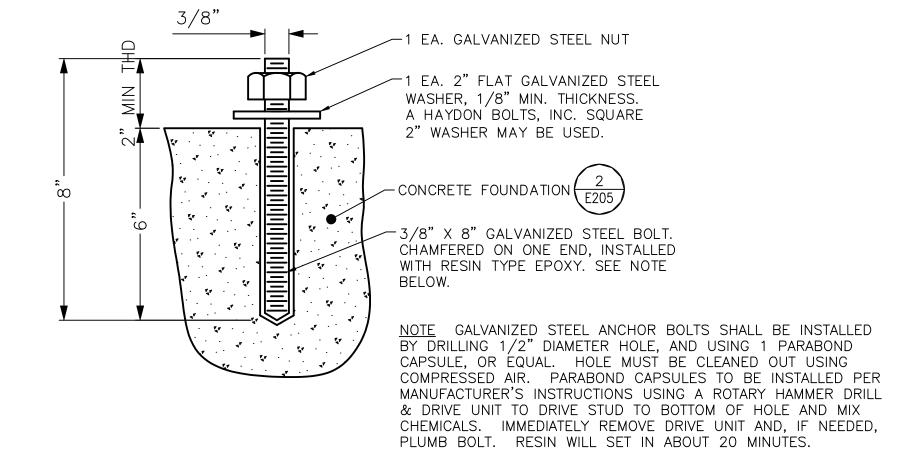



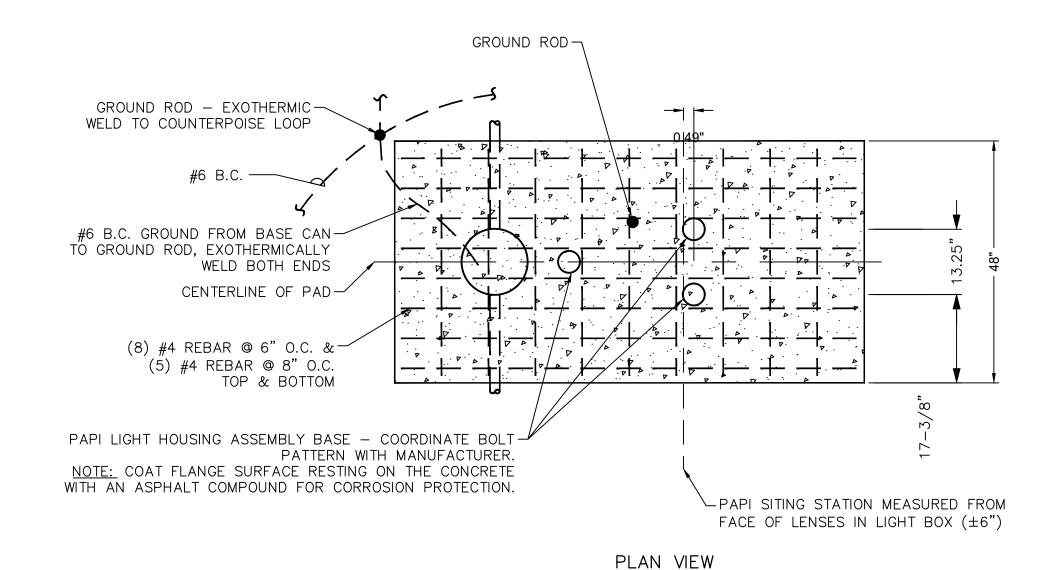

NOTE: FOUNDATION DIMENSIONS ARE
FOR REFERENCE ONLY. CONTRACTOR

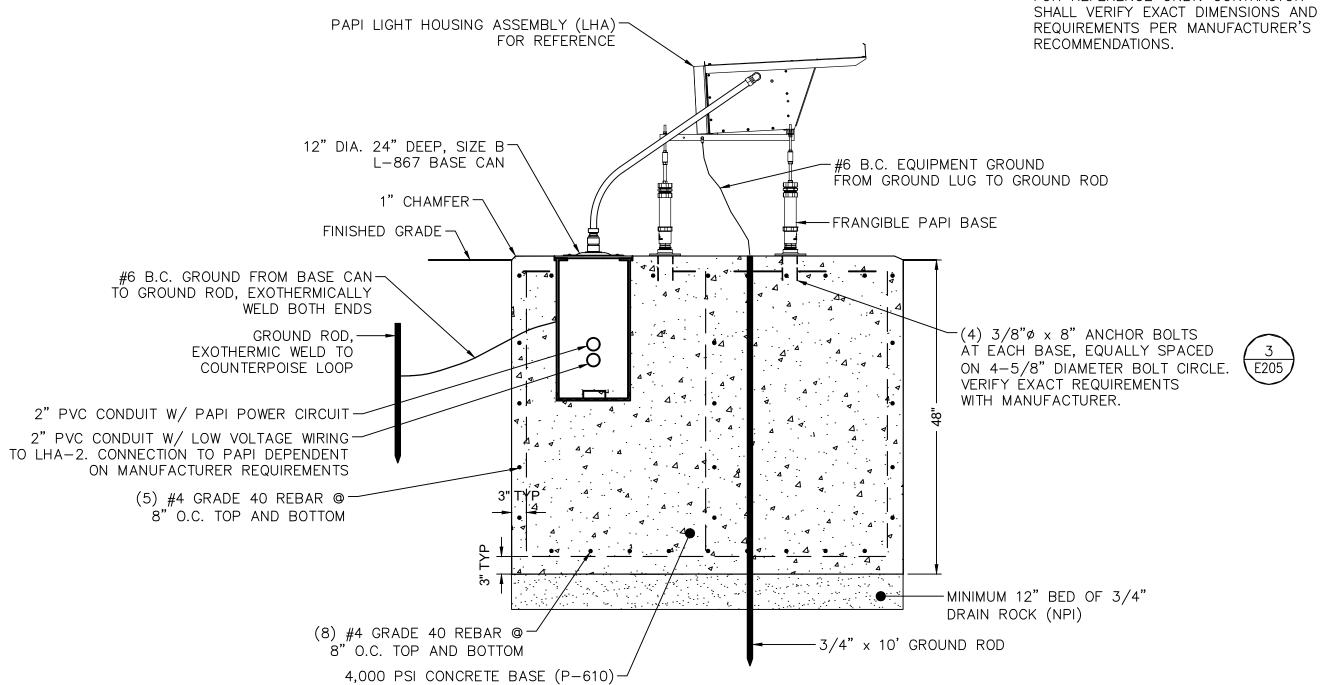

<u>ELEVATION</u>

NOTE: FINISH TOP OF CONCRETE BASE WITH 1/4"/FT. SLOPE, BOTH DIRECTIONS FROM LONGITUDINAL AXIS.



Know what's below.
Call before you dig.



4201 WINFIELD ROAD SUITE 600 WARRENVILLE, IL 60555 TEL (630) 487-5550



DATE: SCALE:
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DRAWN BY: CHECKED BY:
DKP JDB

DRAWN BY:
DKP

DATE

DESCRIPTION

0 06/06/2025

ISSUED FOR BID

ETAILS DICATOR (PAPI)

ALL PRECISION APPROACH PATH IN RUNWAY 18/36
GE OF BOLINGBROOK

CERTIFICATION:

CERTIFICATION:

POF ESSION
BRADSHAW

OF ILLINO'S
EXP. 11/30/2

O6/06/202

DRAWING NO.


E205




CONTRACTOR TO INSTALL NEW BREAKERS AS REQUIRED IN PANEL 'AC-1' TO ACCOMMODATE NEW CCR.

GENERAL CONSTRUCTION NOTES:


- 1. RE-ESTABLISH ALL CONNECTIONS FOR RELOCATED EQUIPMENT TO ENSURE A COMPLETE AND WORKING SYSTEM.
- 2. ALL NEW EQUIPMENT AND WORK REQUIRED FOR THE INSTALLATION OF THE NEW L-828 REGULATOR, INCLUDING NEW SERIES CIRCUIT CUTOUT, WIRES, BREAKERS, AND REGULATOR TESTING AND COMMISSIONING, IS INCIDENTAL TO THE REGULATOR BID ITEM AR801717
- 3. LAYOUT NOT TO SCALE. VERIFY ALL DIMENSIONS PRIOR TO EQUIPMENT INSTALLATION.

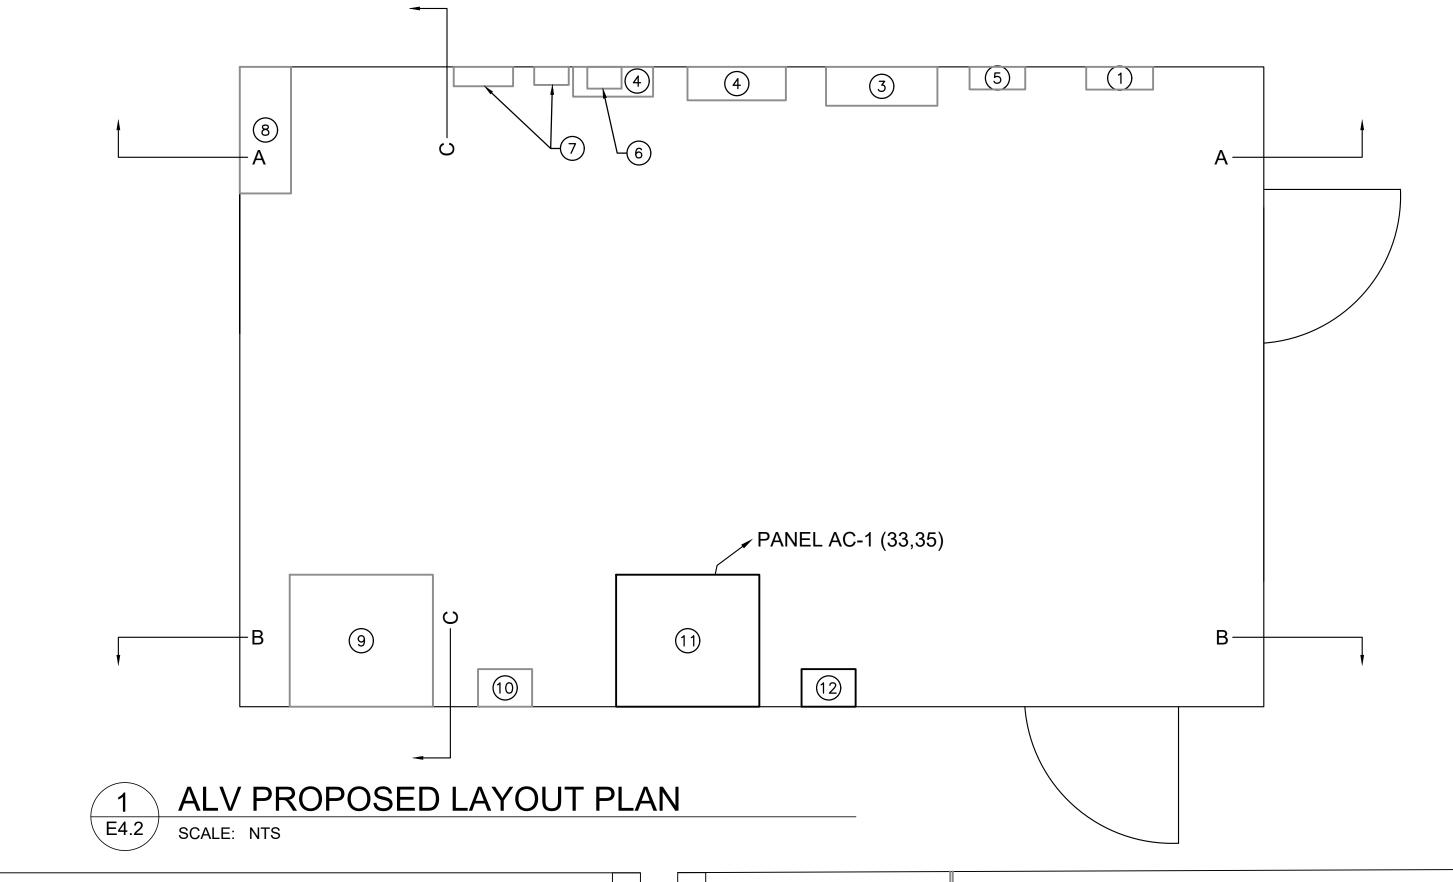

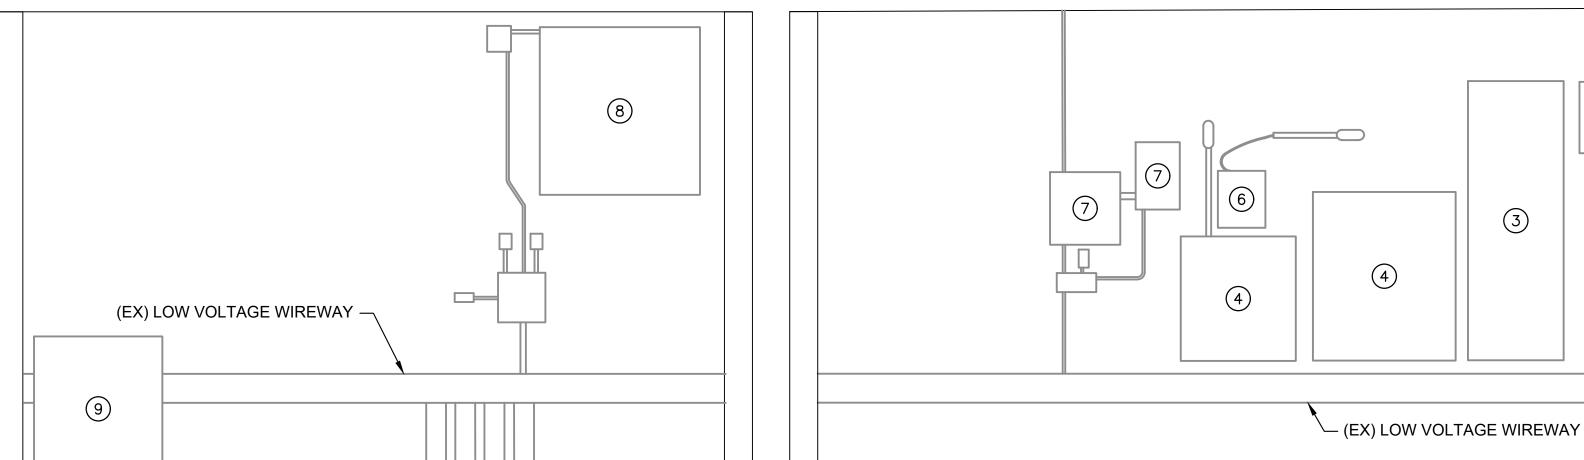

					P	ANELI	IAME: A	AC-1					
l	VOLTS: 120/240V							AIC RATING: 42K					
SUPPLY FROM: SES		PHASES: 1							MAINS TYPE: MCB				
N	MOUNTING: SURFACE					WIRES:	3		MAINS RATING: 200 A			200 A	
EN	CLOSURE: NEMA 3R									MCB	RATING:	200 A	
		LOAD									LOAD		
CKT	CIRCUIT DESCRIPTION	TYPE	TRIP	POLES		VA)	В (VA)	POLES	TRIP	TYPE	CIRCUIT DESCRIPTION	CKT
1	(E) INTERIOR LIGHTS	L	15	1	EX	EX			2	60	E	(E) LIGHTNING ARRESTOR	2
3	(E) EXTERIOR LIGHTS	L	15	1			EX	EX				(L) LIGITIVING ARTICLE FOR	4
5	(E) INTERIOR RECEPT.	R	20	1	EX	EX			2	25	E	(E) HEATER EH1	6
7	(E) EXHAUST FAN	E	20	1			EX	EX		20	<u></u>	(L) HEATER EITI	8
9	(E) CONTROL POWER	E	15	1	EX	EX			2	25	E	(E) HEATER EH2	10
11	(E) FACP	0	20	1			EX	EX	2	25		(C) FICATEIX ETIZ	12
13	(E) SPARE		15	1	EX	EX			2	80		(E) SPARE	14
15	(E) GFI NORTH EXTERIOR	R	20	1			EX	EX	2	00		(L) SI AIL	16
17	(E) SPARE		25	1	EX								18
19	(E) SPARE		30	1									20
21	(E) SPARE	2	20	2									22
23	(E) SPAILE		20										24
25	(E) SPARE		20	2									26
27	(E) SPAILE		20										28
29	(E) SPARE		20	2									30
31	(E) SI AILE		20										32
33	(N) REGULATOR PAPIS	Е	40	2	330								34
35	(N) REGOLATORT ATIS	Е	40				330						36
37	(E) REGULATOR RUNWAY	Е	80	2	EX	EX							38
39	TEGULATUR RUNWAT	E	00				EX	EX					40
41													42
			TOTA	L LOAD:	330	VA	330	VA					
			TOTAL	_AMPS:	1.4	Α	1.4	Α					

PANEL 'AC-1' PANEL SCHEDULE

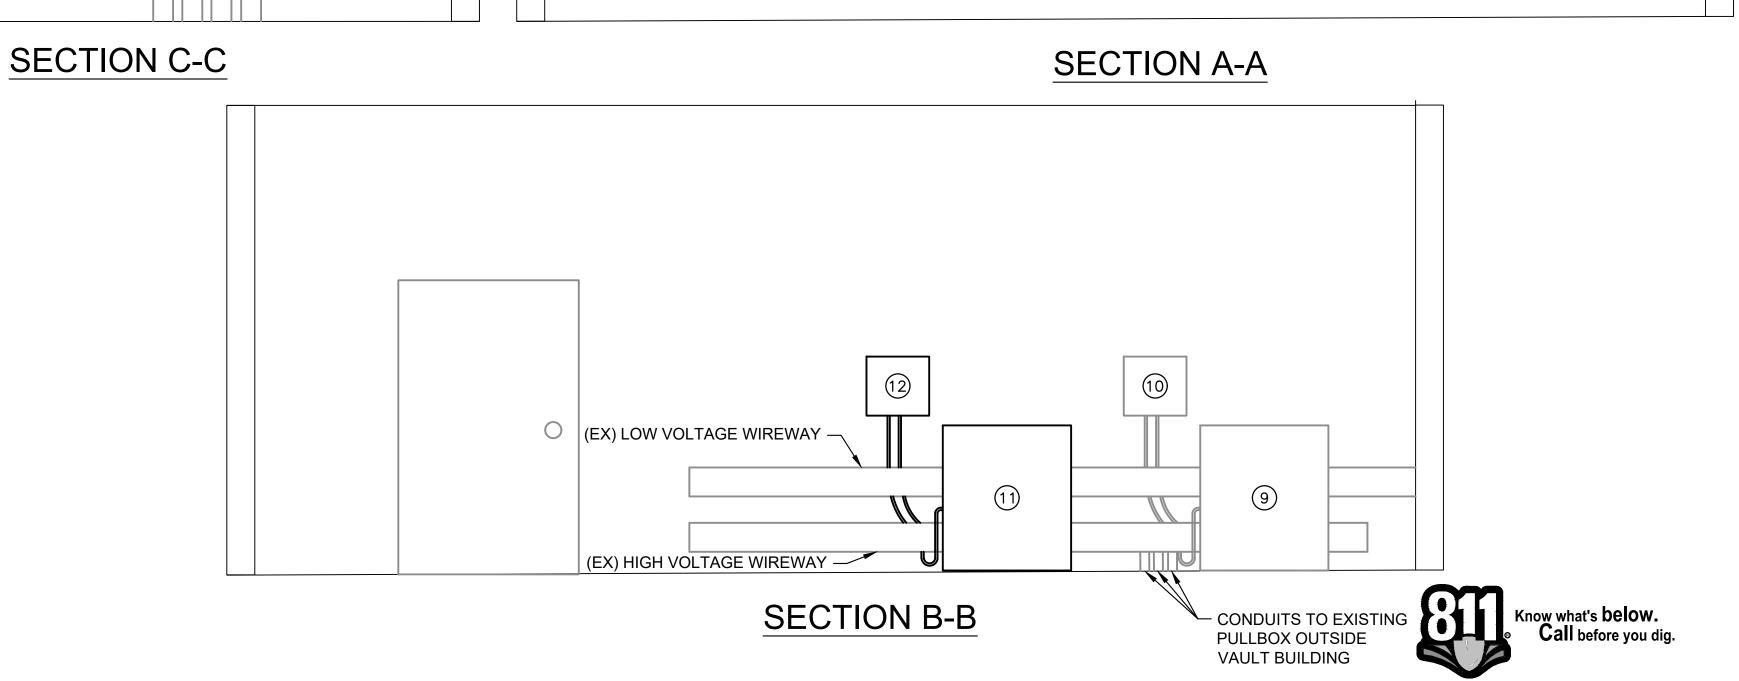

5

Kimley >>> Horn

4201 WINFIELD ROAD
SUITE 600
WARRENVILLE, IL 60555
TEL (630) 487-5550

DATE: SCALE: 06/06/2025 N/A

DRAWN BY: CHECKED BY: JDB

REV. DATE DESCRIPTION

0 06/06/2025 ISSUED FOR BID

T PLAN
ON APPROACH PATH INDICATOR (PAPI)

INSTALL PRECISION APP FOR RUNWAY 18/36 VILLAGE OF BOLINGBRO

CERTIFICATION:

ROF ESSIONAL

JOSEPH D.

BRADSHAW

OF ILLINO'S

EXP. 11/30.

DRAWING NO.

DRAWING NO.

