FOR INDEX OF SHEETS, SEE SHEET 2
FOR LIST OF STATE STANDARDS, SEE SHEET 2

STATE OF ILLINOIS DEPARTMENT OF TRANSPORTATION


08-03-2018 LETTING ITEM 012

PLANS FOR PROPOSED FEDERAL-AID HIGHWAY


FAU ROUTE 2638 (WESTMORE-MEYERS ROAD)
IL ROUTE 38 (ROOSEVELT ROAD) TO ST CHARLES ROAD
RESURFACING, SIDEWALKS, PAVEMENT MARKING
SECTION 17-00158-00-RS
PROJECT HF60 (663)
VILLAGE OF LOMBARD
DUPAGE COUNTY
C-91-242-17

TRAFFIC DATA

WESTMORE-MEYERS ROAD (FAU 2638)
MINOR ARTERIAL
TRAFFIC = 13,100 ADT (2016)
POSTED SPEED = 30 MPH
DESIGN SPEED = 30 MPH

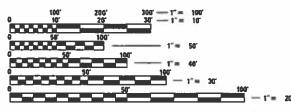

FULL SIZE PLANS HAVE BEEN PREPARED USING STANDARD ENGINEERING SCALES. REDUCED SIZED PLANS WILL NOT CONFORM TO STANDARD SCALES. IN MAKING MEASUREMENTS ON REDUCED PLANS, THE ABOVE SCALES MAY BE USED.

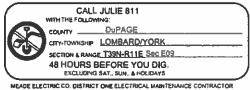

MEADE ELECTRIC CO. DISTRICT ONE ELECTRICAL MAINTENANCE CONTRACTOR LOCATES 100T ELECTRICAL EQUIPMENT AND UNDERGROUND CABLES 773-287-7872. R 11 E

3rd PM


Great Western Trial And Trial

GROSS LENGTH = 10,568 FT. = 2.00 MILE


NET LENGTH = 10,568 FT. = 2.00 MILE


END IMPROVEMENTS SAINT CHARLES ROAD STA 206+37.00

BEGIN IMPROVEMENTS ROOSEVELT ROAD STA 100+69.00

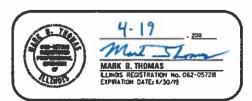

CHRISTOPHER B. BURKE ENGINEERING, LTD.
9575 W. Higgins Road, Suite 600
Rosemont, Illinois 60018
(847) 823-0500
PROFESSIONAL DESIGN FIRM NO. 184-001175
EXPIRATION DATE: 04/30/19

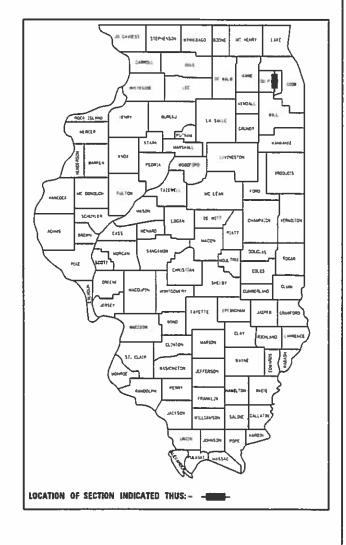

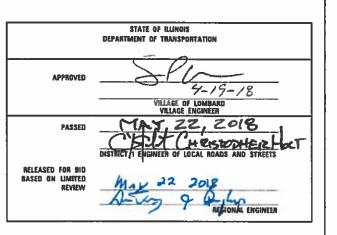

PRINTED BY THE AUTHORITY OF THE STATE OF ILLINOIS

CONTRACT NO. 61E93

OFFICE ENGINEER: CHARLES F. RIDDLE, P.E., SCHAU

0

INDEX OF SHEETS

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| 2 | GENERAL NOTES, INDEX OF SHEETS, INDEX OF STANDARDS |
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| 5 | TYPICAL SECTIONS |
| 6 | ALIGNMENT, TIES AND BENCHMARK PLAN |
| 7-10 | ROADWAY PLANS |
| 11-14 | PATH CROSSING DETAILS |
| 15-16 | CONSTRUCTION DETAILS |
| 17 | DETECTOR LOOP REPLACEMENT PLAN |
| 18-25 | DISTRICT 1 DETAILS |

HIGHWAY STANDARDS

| 000001-06 | STANDARD SYMBOLS, ABBREVIATIONS AND PATTERNS |
|-----------|---|
| 280001-07 | |
| 424001-10 | PERPENDICULAR CURB RAMPS |
| 424016-04 | MID-BLOCK CURB RAMPS FOR SIDEWALKS |
| 424021-04 | DEPRESSED CORNER FOR SIDEWALKS |
| 424026-02 | ENTRANCE / ALLEY PEDESTRIAN CROSSINGS |
| 604001-04 | FRAME AND LIDS TYPE 1 |
| 604051-04 | FRAME AND GRATE TYPE 11 |
| 606001-07 | CONC, CURB TYPE B AND COMB, CONC CURB AND GUTTER |
| 701101-05 | OFF-RD OPERATIONS, MULTILANE, 15' TO 24" FROM PAVEMENT EDGE |
| 701427-05 | LANE CLOSURE, MULTILANE, INTERMITTENT OR MOVING OPER., |
| | FOR SPEEDS <= 40 MPH |
| 701602-09 | URBAN LANE CLOSURE, MULTILANE, 2W WITH BIDIRECTIONAL TURN LANE |
| 701606-10 | URBAN SINGLE LANE CLOSURE, MULTILANE, 2W WITH MOUNTABLE MEDIAN |
| 701611-01 | URBAN HALF ROAD CLOSURE, MULTILANE, 2W WITH MOUNTABLE MEDIAN |
| 701701-10 | URBAN LANE CLOSURE, MULTILANE INTERSECTION |
| 701801-06 | SIDEWALK, CORNER OR CROSSWALK CLOSURE |
| 701901-07 | TRAFFIC CONTROL DEVICES |
| 720001-01 | SIGN PANEL MOUNTING DETAILS |
| 720006-04 | SIGN PANEL ERECTION DETAILS |
| 720011-01 | METAL POSTS FOR SIGNS, MARKERS AND DELINEATORS |
| 728001-01 | TELESCOPING STEEL SIGN SUPPORT |
| 729001-01 | APPLICATIONS OF TYPES A AND B METAL POSTS (FOR SIGNS & MARKERS) |
| 731001-01 | BASE FOR TELESCOPING STEEL SIGN SUPPORT |
| 780001-05 | TYPICAL PAVEMENT MARKINGS |
| | |

GENERAL NOTES

SPECIFICATIONS, STANDARDS AND SPECIAL PROVISIONS

ALL CONSTRUCTION SHALL BE DONE IN ACCORDANCE WITH THE "STANDARD SPECIFICATIONS FOR ROAD AND BRIDGE CONSTRUCTION", ADOPTED APRIL 1, 2016; THE "SUPPLEMENTAL SPECIFICATIONS AND RECURRING SPECIAL PROVISIONS", ADOPTED JANUARY 1, 2018; THE LATEST EDITION OF THE "ILLINOIS MANUAL ON UNIFORM TRAFFIC CONTROL DEVICES FOR STREETS AND HIGHWAYS" (IMUTCD); "THE STANDARD SPECIFICATIONS FOR WATER AND SEWER MAIN CONSTRUCTION IN ILLINOIS" JUNE 2014 SEVENTH EDITION; THE "ILLINOIS URBAN MANUAL " AND THE "ILLINOIS URBAN MANUAL FIELD MANUAL FOR INSPECTION OF EROSION AND SEDIMENT CONTROL BEST MANAGEMENT PRACTICES"; THE "AMERICANS WITH DISABILITIES ACT OF 1990 ACCESSIBILITY GUIDELINES"; THE "DRAFT" REHABILITATION ACT OF 1973 (SECTION 504); THE "DETAILS" IN THE PLANS; AND THE "SPECIAL PROVISIONS" INCLUDED IN THE CONTRACT DOCUMENTS.

ANY REFERENCE TO STANDARDS THROUGHOUT THE PLANS OR SPECIAL PROVISIONS SHALL BE INTERPRETED AS THE LATEST IDOT HIGHWAY STANDARD.

CODES OF THE IEPA TITLE 35, AND O.S.H.A. SHALL BE ADHERED TO FOR THE CONSTRUCTION OF THIS PROJECT. IT WILL BE THE CONTRACTOR'S RESPONSIBILITY TO ENSURE ADHERENCE TO THESE (NOT THE VILLAGE OR CHRISTOPHER B. BURKE ENGINEERING).

ALL TRAFFIC CONTROL AND OTHER ADVISORY SIGNS NEEDED FOR CONSTRUCTION ARE TO BE FURNISHED BY THE CONTRACTOR IN ACCORDANCE WITH SECTION 700 OF THE STANDARD SPECIFICATIONS.

UTILITIES

THE CONTRACTOR SHALL BE RESPONSIBLE FOR CONTACTING THE OWNERS OF ALL EXISTING FACILITIES SO THAT THE UTILITIES AND THEIR APPURTENANCES MAY BE LOCATED AND ADJUSTED OR MOVED, IF NECESSARY, PRIOR TO THE START OF CONSTRUCTION OPERATIONS. THE CONTRACTOR SHALL COOPERATE WITH ALL UTILITY OWNERS AS PROVIDED FOR IN THE STANDARD SPECIFICATIONS.

THE LOCATIONS OF EXISTING DRAINAGE STRUCTURES, STORM AND SANITARY SEWERS, WATER SERVICE LINES AND OTHER UTILITY LINES ARE APPROXIMATE, AND THE VILLAGE DOES NOT GUARANTEE THEIR ACCURACY. THEIR EXACT HORIZONTAL AND VERTICAL LOCATIONS ARE TO BE DETERMINED IN THE FIELD BY THE CONTRACTOR.

THE CONTRACTOR SHALL BE RESPONSIBLE FOR THE PROTECTION OF ALL UNDERGROUND OR SURFACE UTILITIES EVEN THOUGH THEY MAY NOT BE SHOWN ON THE PLANS. ANY UTILITY THAT IS DAMAGED DURING CONSTRUCTION SHALL BE REPAIRED OR REPLACED TO THE SATISFACTION OF THE ENGINEER OR THE VILLAGE.

BEFORE STARTING ANY EXCAVATION, THE CONTRACTOR SHALL CALL "JULIE" AT 800-892-0123 FOR FIELD LOCATIONS OF BURIED ELECTRIC, TELEPHONE, GAS AND CABLE TELEVISION FACILITIES (48 HOURS NOTIFICATION IS REQUIRED.)

WHENEVER DURING CONSTRUCTION OPERATIONS ANY LOOSE MATERIAL IS DEPOSITED IN THE FLOW LINE OF DRAINAGE STRUCTURES SUCH THAT THE NATURAL FLOW OF WATER IS OBSTRUCTED, IT SHALL BE REMOVED AT THE CLOSE OF EACH WORKING DAY. AT THE CONCLUSION OF CONSTRUCTION OPERATIONS, ALL UTILITY STRUCTURES SHALL BE FREE FROM DIRT AND DEBRIS.

ANY EXISTING OR PROPOSED STORM SEWER DAMAGED BY THE CONTRACTOR DURING CONSTRUCTION SHALL BE REPLACED BY THE CONTRACTOR.

THE CONTRACTOR SHALL NOT OPEN OR SHUT ANY WATER VALVES OR FIRE HYDRANTS. CONTACT WATER DEPARTMENT FOR THEM TO TURN VALVES OR OPERATE HYDRANTS. UNAUTHORIZED USE SHALL SUBJECT THE OFFENDER TO ARREST AND PROSECUTION.

STAKING

THE CONTRACTOR SHALL PROTECT AND CAREFULLY PRESERVE ALL SECTION OR SUBSECTION MONUMENTS OR PROPERTY OR REFERENCE MARKERS UNTIL THE ENGINEER, HIS AGENT OR AN AUTHORIZED SURVEYOR HAS WITNESSED OR OTHERWISE REFERENCED THEIR LOCATIONS.

ALL RADII FOR PROPOSED CURB AND GUTTER ARE TO THE EDGE OF PAVEMENT.

MISCELLANEOUS

DIMENSIONS: IT SHALL BE THE CONTRACTOR'S RESPONSIBILITY TO VERIFY ALL DIMENSIONS AND CONDITIONS EXISTING IN THE FIELD PRIOR TO ORDERING MATERIALS AND BEGINNING CONSTRUCTION.

AGGREGATE BASE REPAIR, CURB AND GUTTER REMOVAL AND REPLACEMENT, SIDEWALK REMOVAL AND REPLACEMENT, AND STRUCTURES TO BE ADJUSTED WILL BE DETERMINED BY THE ENGINEER IN THE FIELD.

RELOCATING EXISTING SIGNS: EXISTING SIGNS WHICH ARE IN CONFLICT WITH PROPOSED IMPROVEMENTS SHALL BE REMOVED AND REINSTALLED UPON COMPLETION OF CONFLICTING IMPROVEMENTS IN ACCORDANCE WITH THE ILLINOIS DEPARTMENT OF TRANSPORTATION "MANUAL OF UNIFORM TRAFFIC CONTROL DEVICES" AND THE "STANDARD SPECIFICATIONS FOR ROAD AND BRIDGE CONSTRUCTION". STOP SIGNS, SPEED LIMIT SIGNS, AND STREET NAME SIGNS SHALL BE UP AND VISIBLE AT ALL TIMES.

CURB AND GUTTER TO BE REMOVED AT DRIVEWAYS SHALL BE REPLACED WITH DEPRESSED CURB AND GUTTER.

WITH THE EXCEPTION OF ROOSEVELT ROAD (IL ROUTE 38), ALL TRAFFIC SIGNALS WITHIN THE PROJECT LIMITS USE VIDEO DETECTION.

PAVING

HOT-MIX ASPHALT BINDER COURSE SHALL NOT BE PLACED ADJACENT TO CURB AND GUTTER UNTIL THE CURB AND GUTTER HAS BEEN PROPERLY CURED AND BACKFILLED TO THE SATISFACTION OF THE ENGINEER.

THE THICKNESSES OF HOT-MIX ASPHALT MIXTURES SHOWN ON THE PLANS ARE NOMINAL. DEVIATIONS MAY OCCUR DUE TO IRREGULARITIES IN THE SURFACE, BINDER, OR BASE UPON WHICH THE HOT-MIX ASPHALT MATERIALS ARE PLACED. THE THICKNESSES SHOWN ON THE PLANS ARE THE MINIMUM ACCEPTABLE THICKNESSES.

LANDSCAPING

RESTORATION WORK WILL BE PAID FOR UP TO TWO FEET ADJACENT TO RECONSTRUTED CURB AND GUTTER OR SIDEWALK. AREAS OUTSIDE THE TWO FOOT ZONE THAT ARE DAMAGED OR DISTURBED BY THE CONTRACTOR SHALL BE RESTORED BY THE CONTRACTOR AT HIS/HER OWN EXPENSE.

CONTRACTOR SHALL BE CAUTIOUS NOT TO DISTURB ANY PARKWAY TREES DURING CONSTRUCTION, ANY TREES THAT ARE DAMAGED OR DISTURBED DURING THE CONSTRUCTION SHALL BE REPLACED IN KIND BY THE CONTRACTOR AT HIS/HER OWN EXPENSE, NO ADDITIONAL COMPENSATION WILL BE ALLOWED.

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| | PLOT SCALE = 40' | CHECKED JGS | REVISED - |
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STATE OF ILLINOIS DEPARTMENT OF TRANSPORTATION

SCALE: NONE

SHEET 1

| | | | OF LON | | | FAU RTE. | SECTION | COUNTY | TOTAL SHEETS | SHEET NO. |
|----|----------------------|------|--------|------|----------------|-------------|-----------------|------------|-----------------|--------------|
| WI | WESTMORE-MEYERS ROAD | | | 2638 | 17-00158-00-RS | DuPAGE | 25 | 2 | | |
| | _ (| iENI | RAL NO | TES | | | | CONTRAC | Γ NO. | 61E93 |
| 1 | ΩE | 1 | SHEETS | STA | TO STA | | TILITNOTS EED A | ID PROJECT | | |

| CODE NUMBER | ITEM | UNIT | TOTAL QUANTI | |
|----------------|--|-------|-----------------|--|
| 20200100 | EARTH EXCAVATION | CU YD | 70 | |
| 21101600 | TOPSOIL FURNISH AND PLACE, VARIABLE DEPTH | SQ YD | 228 | |
| 25000210 | SEEDING, CLASS 2A | ACRE | 0.25 | |
| 25100630 | EROSION CONTROL BLANKET | SQ YD | 228 | |
| 28000510 | INLET FILTERS | EACH | 112 | |
| 31101180 | SUBBASE GRANULAR MATERIAL, TYPE B 2" | SQ YD | 592 | |
| 40600290 | BITUMINOUS MATERIALS (TACK COAT) | POUND | 3784 | |
| 40600990 | TEMPORARY RAMP | SQ YD | 600 | |
| 40603085 | HOT-MIX ASPHALT BINDER COURSE, IL-19.0, N70 | TON | 7277 | |
| 40603340 | HOT-MIX ASPHALT SURFACE COURSE, MIX "D", N70 | TON | 6469 | |
| 42300200 | PORTLAND CEMENT CONCRETE DRIVEWAY PAVEMENT, 6 INCH | SQ YD | 25 | |
| 12300400 | SQ YD | 70 | | |
| 12400200 | PORTLAND CEMENT CONCRETE SIDEWALK 5 INCH | SQ FT | 5849 | |
| 12400800 | DETECTABLE WARNINGS | SQ FT | 210 | |
| 14000100 | PAVEMENT REMOVAL | SQ YD | 113 | |
| 14000166 | HOT-MIX ASPHALT SURFACE REMOVAL, 4 1/4" | SQ YD | 56070 | |
| 14000200 | DRIVEWAY PAVEMENT REMOVAL | SQ YD | 120 | |
| 14000500 | COMBINATION CURB AND GUTTER REMOVAL | FOOT | 3669 54 | |
| 14000600 | SIDEWALK REMOVAL | SQ FT | | |
| 44201325 | CLASS C PATCHES, TYPE I, 8 INCH | SQ YD | | |
| 14201329 | CLASS C PATCHES, TYPE II, 8 INCH | SQ YD | 66 | |
| 14201333 | CLASS C PATCHES, TYPE III, 8 INCH | SQ YD | 50 | |
| 14201335 | CLASS C PATCHES, TYPE IV, 8 INCH | SQ YD | 50 | |
| 14201737 | CLASS D PATCHES, TYPE I, 8 INCH | SQ YD | 150 | |
| 14201741 | CLASS D PATCHES, TYPE II, 8 INCH | SQ YD | 150 | |
| 14201745 | CLASS D PATCHES, TYPE III, 8 INCH | SQ YD | 150 | |
| 14201747 | CLASS D PATCHES, TYPE IV, 8 INCH | SQ YD | 150 | |
| 60250200 | CATCH BASINS TO BE ADJUSTED | EACH | 10 | |
| 50260100 | INLETS TO BE ADJUSTED | EACH | 10 | |

| | CODE | ITEM | UNIT | TOTAL QUANTITY |
|---|-----------------|--|---------|-------------------|
| | 60262700 | INLETS TO BE RECONSTRUCTED | EACH | 2 |
| | 60266600 | VALVE BOXES TO BE ADJUSTED | EACH | 2 |
| | 60404800 | FRAMES AND GRATES, TYPE 11 | EACH | 5 |
| | 60406000 | FRAMES AND LIDS, TYPE 1, OPEN LID | EACH | 5 |
| | 60406100 | FRAMES AND LIDS, TYPE 1, CLOSED LID | EACH | 5 |
| | 60603800 | COMBINATION CONCRETE CURB AND GUTTER, TYPE B-6.12 | FOOT | 610 |
| | 60605000 | COMBINATION CONCRETE CURB AND GUTTER, TYPE B-6.24 | FOOT | 100 |
| | 60605900 | COMBINATION CONCRETE CURB AND GUTTER, TYPE B-9.12 | FOOT | 120 |
| | 67100100 | MOBILIZATION | LSUM | 1 |
| | 70102625 | TRAFFIC CONTROL AND PROTECTION, STANDARD 701606 | L SUM | 1 |
| | 70102632 | TRAFFIC CONTROL AND PROTECTION, STANDARD 701602 | L SUM | 1 |
| | 70102634 | TRAFFIC CONTROL AND PROTECTION, STANDARD 701611 | L SUM | 1 |
| | 70102635 | TRAFFIC CONTROL AND PROTECTION, STANDARD 701701 | LSUM | 1 |
| | 70102640 | TRAFFIC CONTROL AND PROTECTION, STANDARD 701801 | L SUM | 1 |
| | 70300100 | SHORT TERM PAVEMENT MARKING | FOOT | 6500 |
| | 70300150 | SHORT TERM PAVEMENT MARKING REMOVAL | SQ FT | 2200 |
| × | 70300210 | TEMPORARY PAVEMENT MARKING LETTERS AND SYMBOLS | SQ FT | 584 |
| | 70300220 | TEMPORARY PAVEMENT MARKING - LINE 4" | FOOT | 47260 |
| | 70300240 | TEMPORARY PAVEMENT MARKING - LINE 6" | FOOT | 8580 |
| | 70300260 | TEMPORARY PAVEMENT MARKING - LINE 12" | FOOT | 788 |
| | 70300280 | TEMPORARY PAVEMENT MARKING - LINE 24" | FOOT | 1326 |
| Δ | 72000100 | SIGN PANEL - TYPE 1 | SQ FT | 24 |
| Δ | 72400310 | REMOVE SIGN PANEL - TYPE 1 | SQ FT | 25 |
| Δ | 72400500 | RELOCATE SIGN PANEL ASSEMBLY - TYPE A | EACH | 2 |
| Δ | 72800100 | TELESCOPING STEEL SIGN SUPPORT | FOOT | 16 |
| Δ | 73100100 | BASE FOR TELESCOPING STEEL SIGN SUPPORT | EACH | 2 |
| Δ | 78000100 | THERMOPLASTIC PAVEMENT MARKING - LETTERS AND SYMBOLS | SQ FT | 312 |
| Δ | 78000200 | THERMOPLASTIC PAVEMENT MARKING - LINE 4" | FOOT | 23630 |
| Δ | 78000400 | THERMOPLASTIC PAVEMENT MARKING - LINE 6" | FOOT | 4286 |
| | NDICATES SPECIA | | | |
| _ | • | VILLAGE OF LOMBARD FAU | SECTION | COUNTY TOTAL |

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| | Default | PLOT DATE = 5/24/2018 | DATE _ | REVISED - | |

STATE OF ILLINOIS
DEPARTMENT OF TRANSPORTATION

VILLAGE OF LOMBARD
WESTMORE-MEYERS ROAD
SUMMARY OF QUANTITIES

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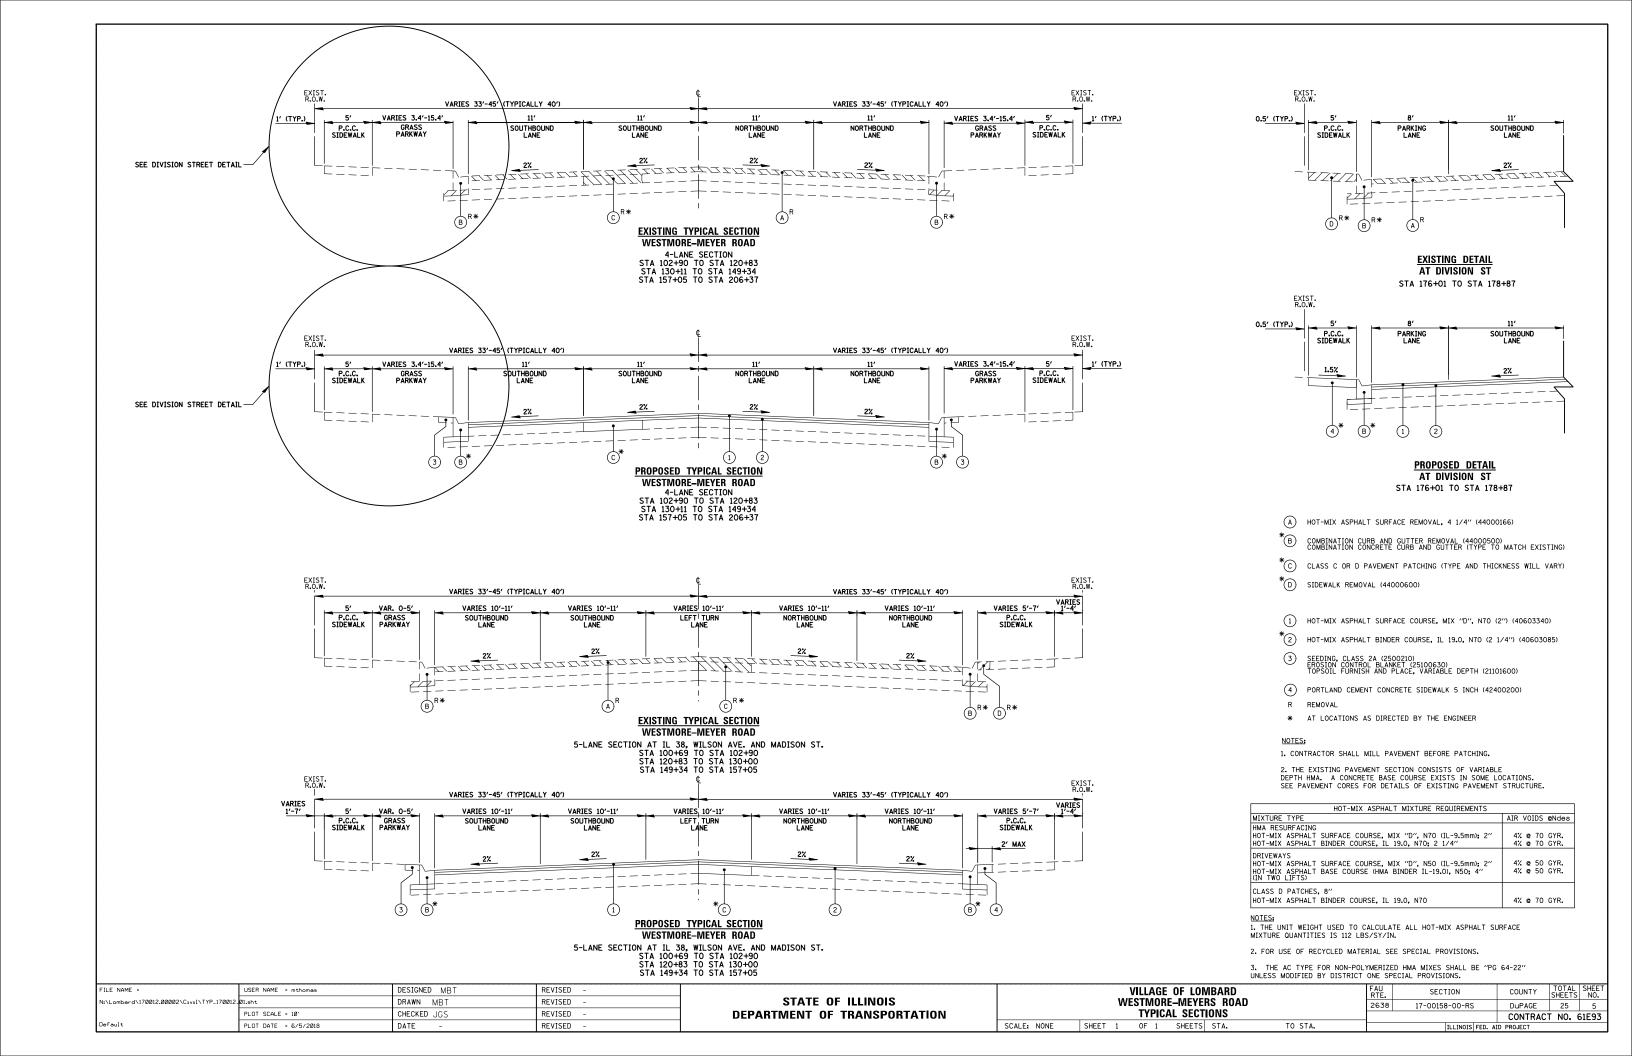
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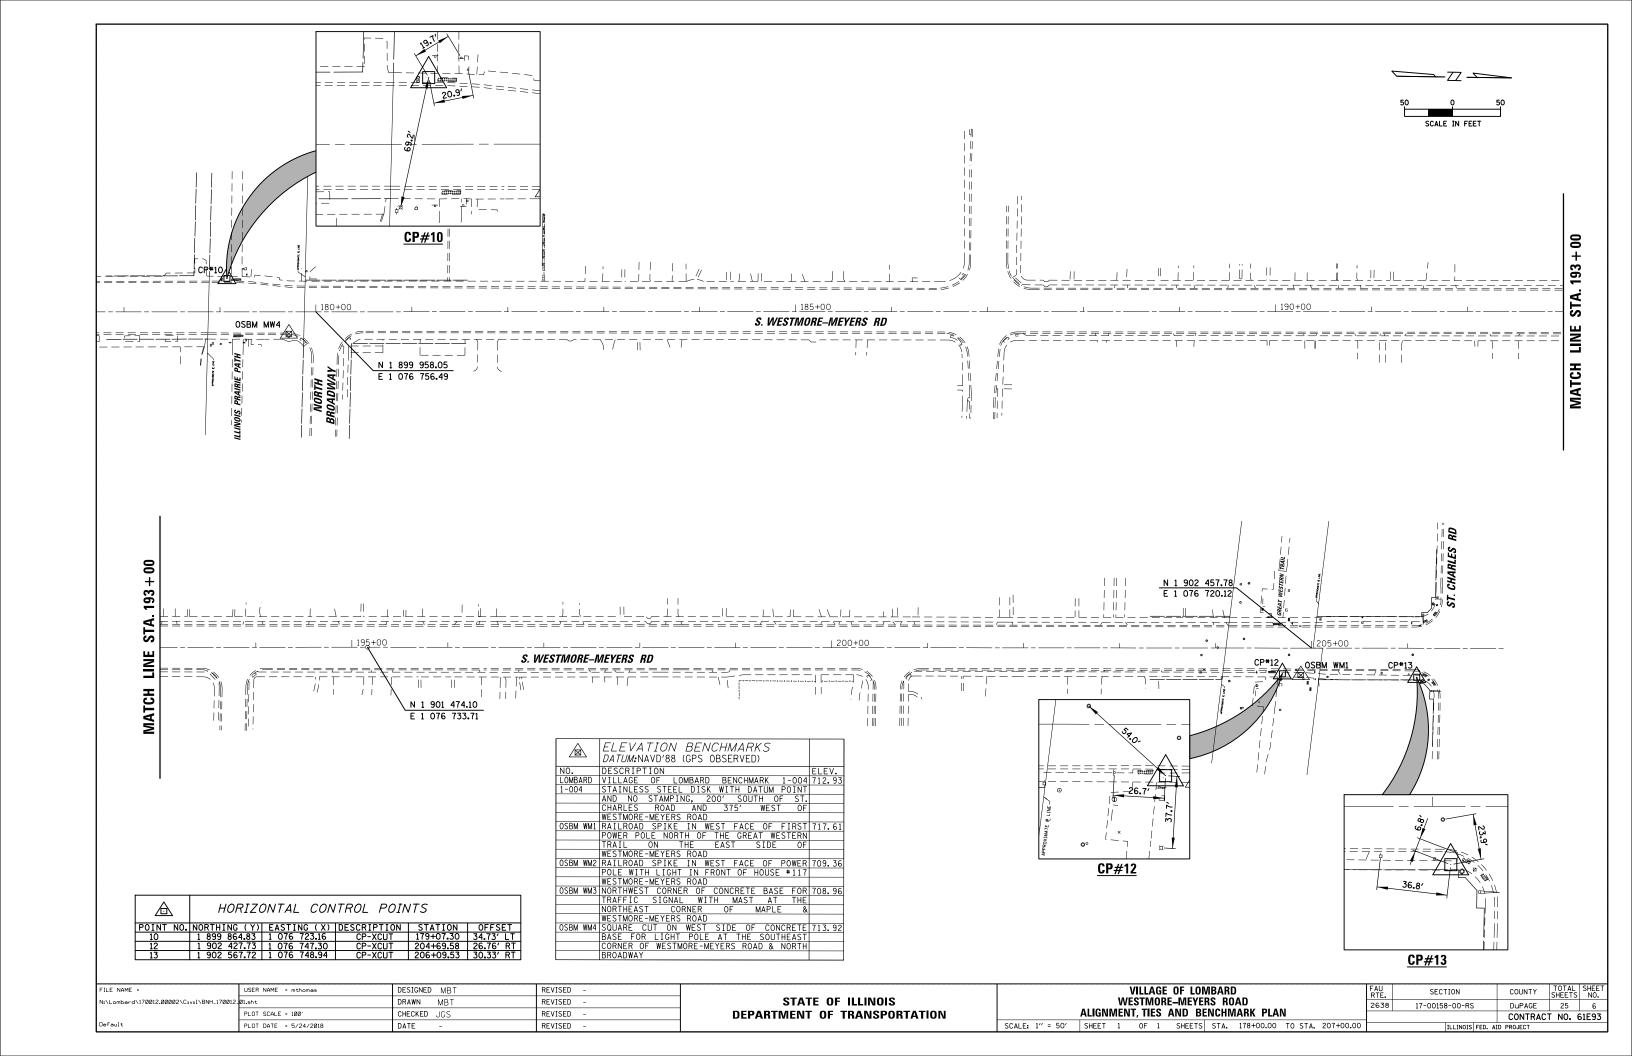
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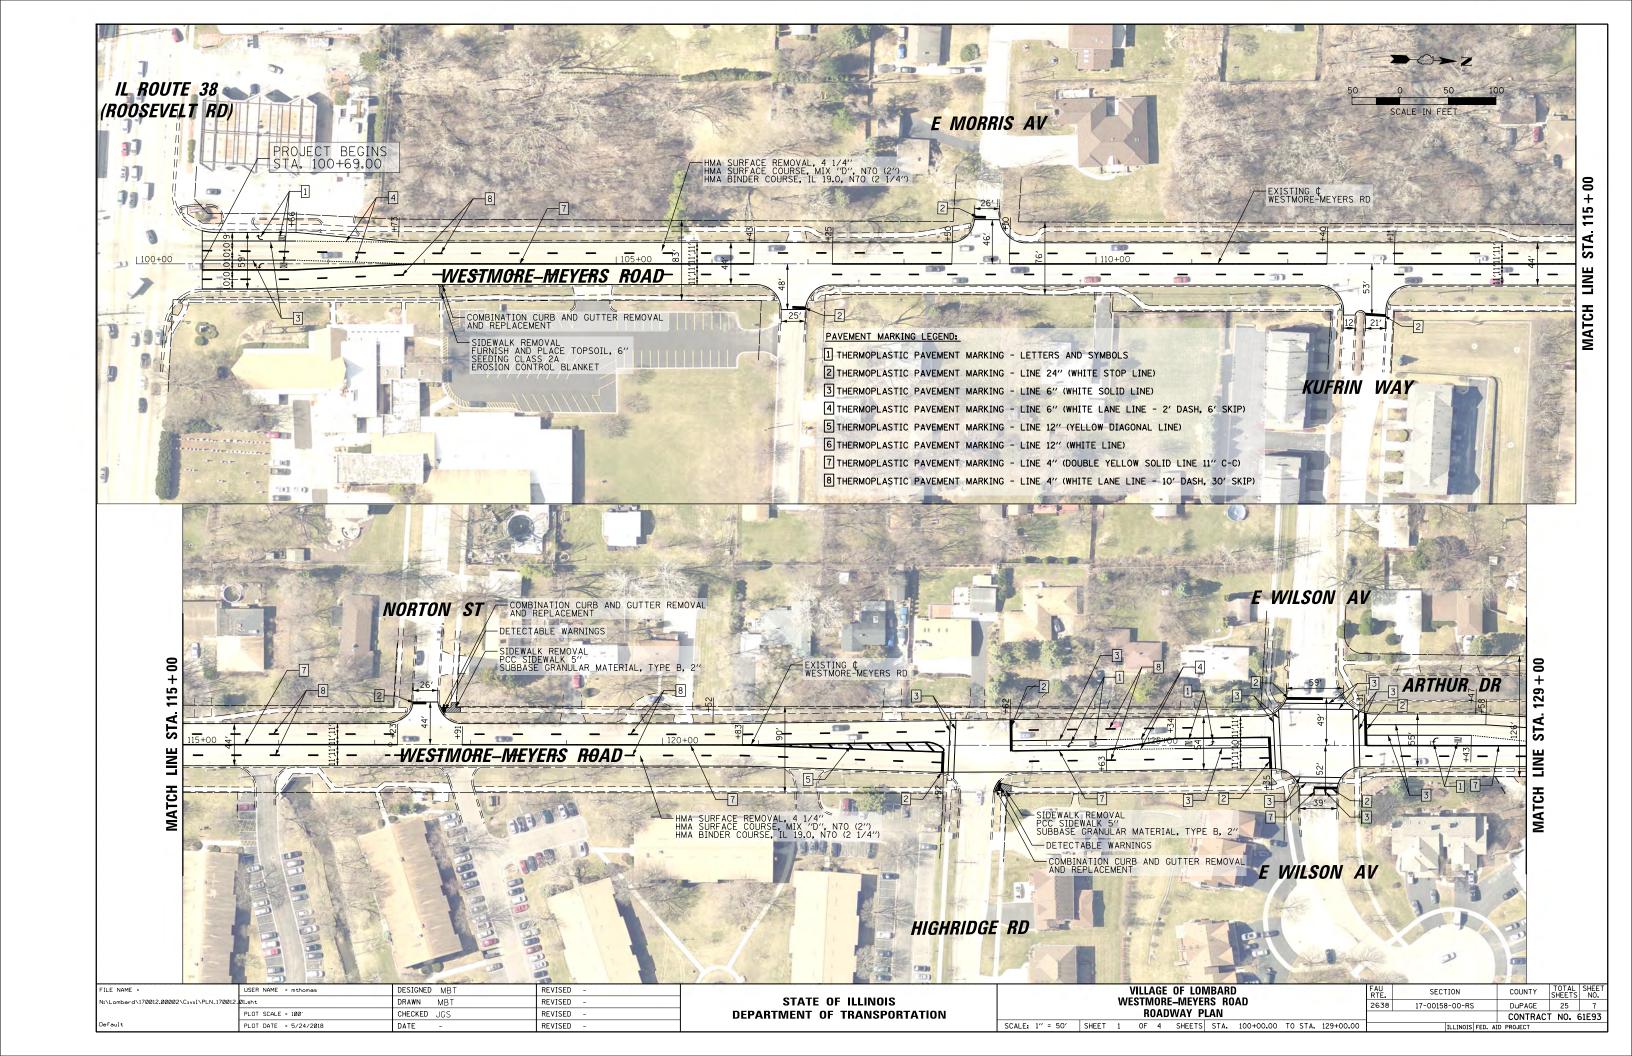
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|---|----------------|---|--------|-------------------|
| Δ | 78000500 | THERMOPLASTIC PAVEMENT MARKING - LINE 8" | FOOT | 98 |
| Δ | 78000600 | THERMOPLASTIC PAVEMENT MARKING - LINE 12" | FOOT | 394 |
| Δ | 78000650 | THERMOPLASTIC PAVEMENT MARKING - LINE 24" | FOOT | 890 |
| Δ | 83600200 | LIGHT POLE FOUNDATION, 24" DIAMETER | FOOT | 11 |
| Δ | 84200804 | REMOVAL OF POLE FOUNDATION | EACH | 1 |
| Δ | 84400105 | RELOCATE EXISTING LIGHTING UNIT | EACH | 1 |
| Δ | 87800100 | CONCRETE FOUNDATION, TYPE A | FOOT | 12 |
| Δ | 88600600 | DETECTOR LOOP REPLACEMENT | FOOT | 296 |
| Δ | 89502376 | REBUILD EXISTING HANDHOLE | EACH | 3 |
| | X0323455 | ADJUST MONITORING WELLS | EACH | 1 |
| , | X0326806 | WASHOUT BASIN | LSUM | 1 |
| Δ | X0326899 | SOLAR-POWERED FLASHING BEACON ASSEMBLY (COMPLETE) | EACH | 2 |
| Δ | X5091725 | BICYCLE RAILING, SPECIAL | FOOT | 286 |
| | X6030310 | FRAMES AND LIDS TO BE ADJUSTED (SPECIAL) | EACH | 75 |
| Δ | X8130130 | JUNCTION BOX TO BE ADJUSTED | EACH | 2 |
| | Z0004522 | HOT-MIX ASPHALT DRIVEWAY PAVEMENT, 6" | SQ YD | 25 |
| | Z0013798 | CONSTRUCTION LAYOUT | LSUM | 1 |
| | Z0030850 | TEMPORARY INFORMATION SIGNING | SQ FT | 52 |
| Δ | Z0033028 | MAINTENANCE OF LIGHTING SYSTEM | CAL MO | 3 |


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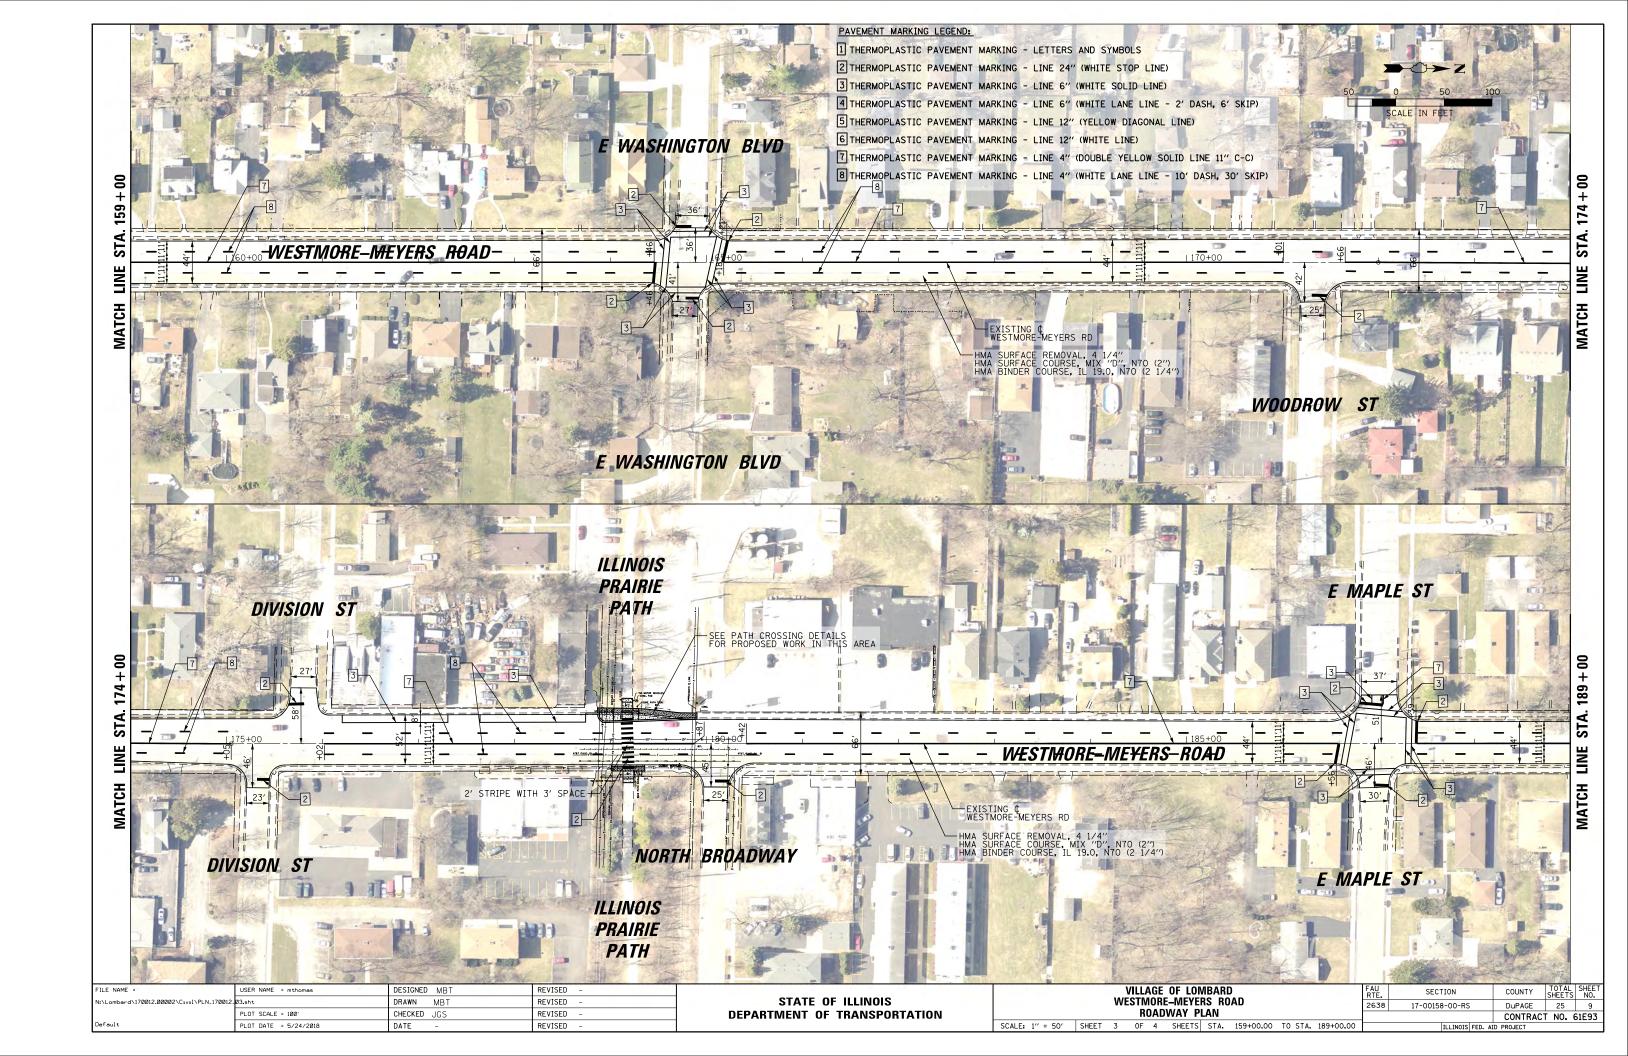
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| | PLOT SCALE = 40' | CHECKED JGS | REVISED - | DEPARTMENT OF TRANSPORTATION | | SUMMARY OF QUANTITIES | | | | CONTRACT | T NO. 61E93 |
| Default | PLOT DATE = 5/24/2018 | DATE - | REVISED - | | SCALE: NONE | SHEET 1 OF 2 SHEETS STA. | TO STA. | | ILLINOIS FED. AI | D PROJECT | |













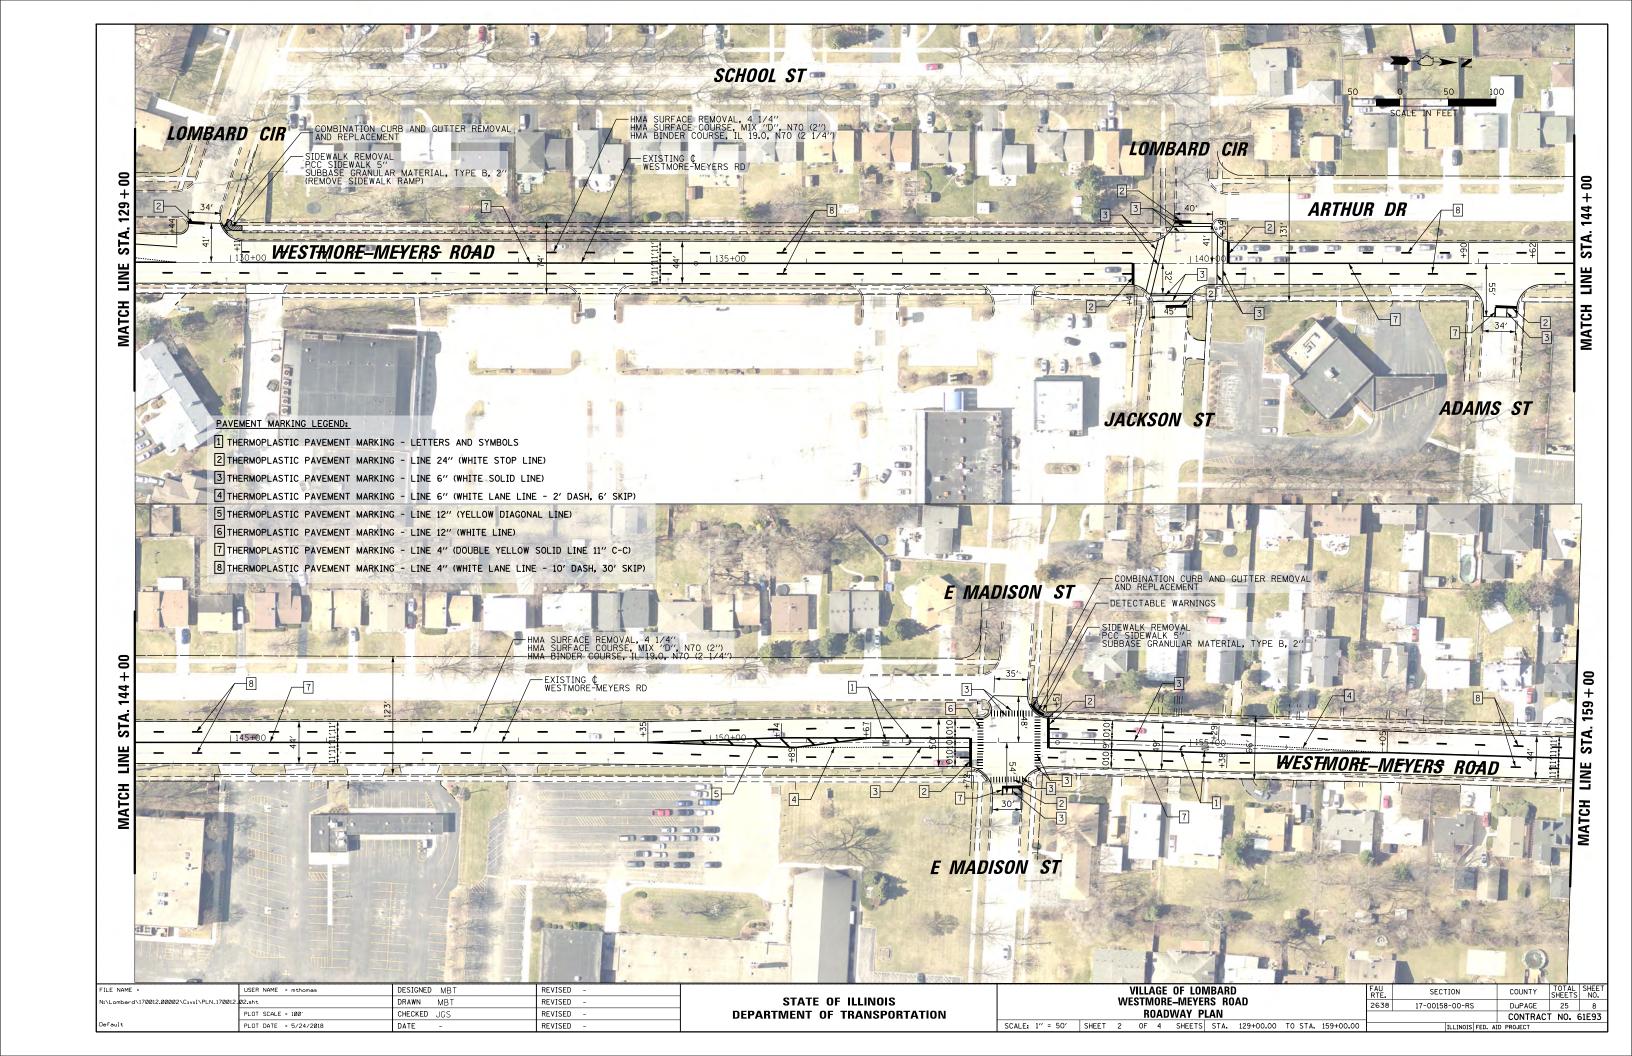


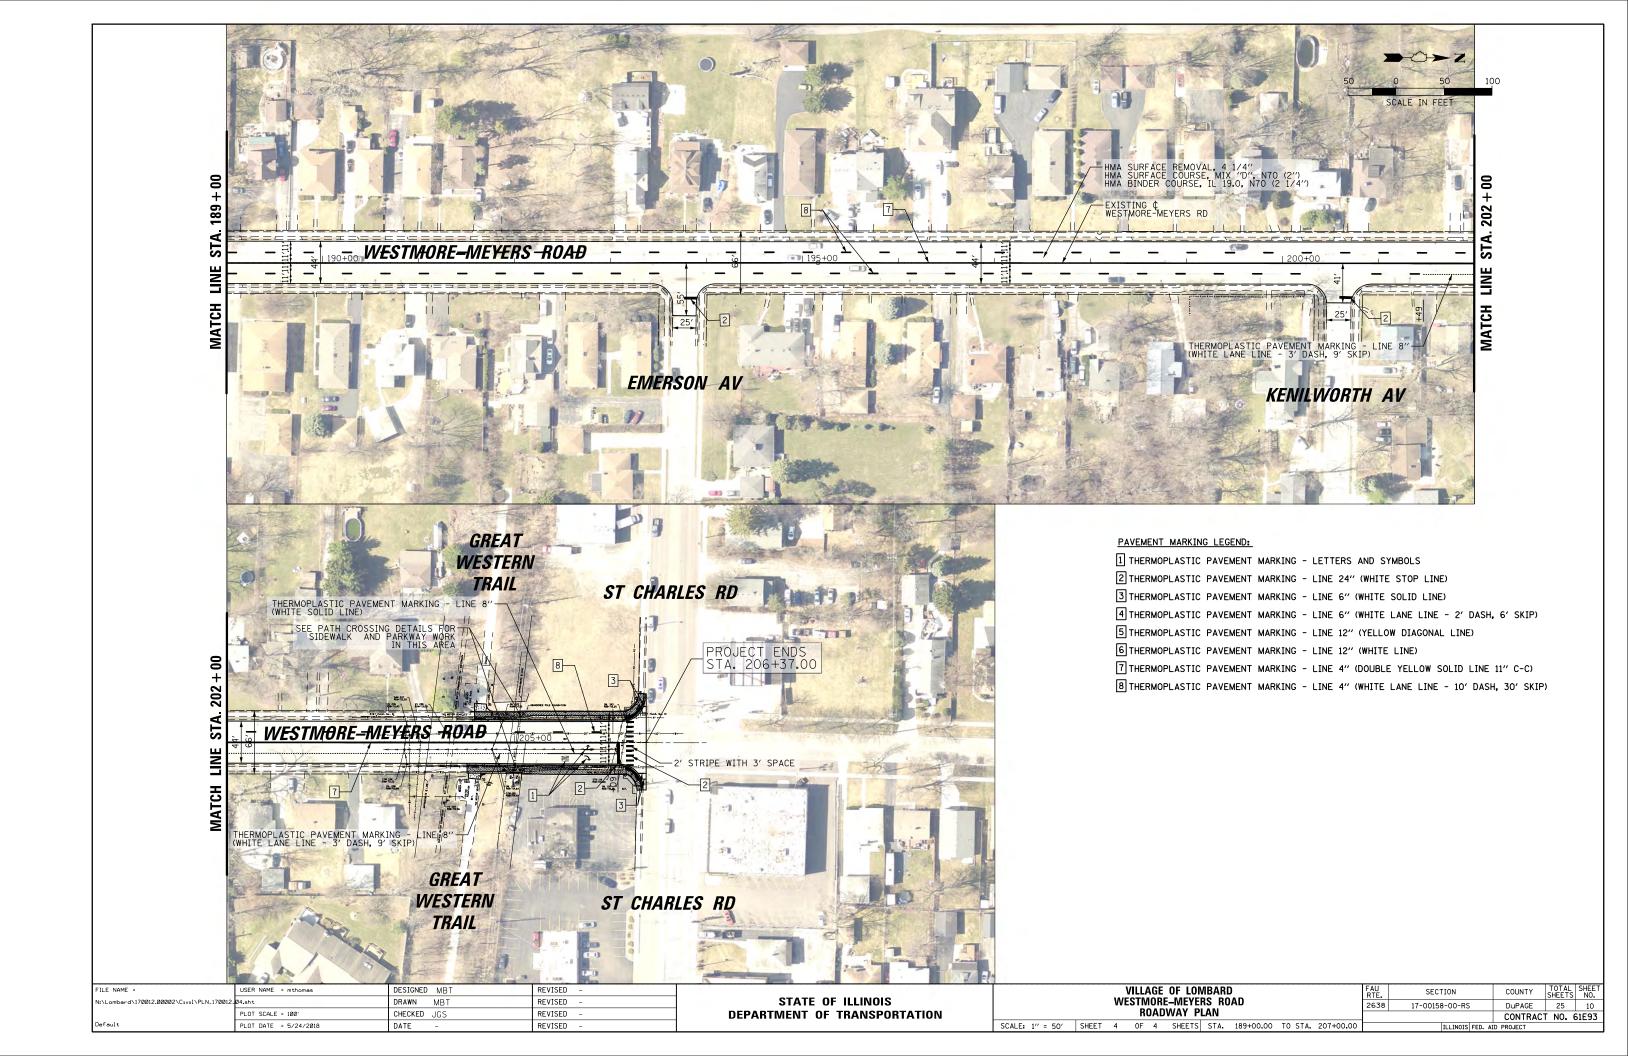


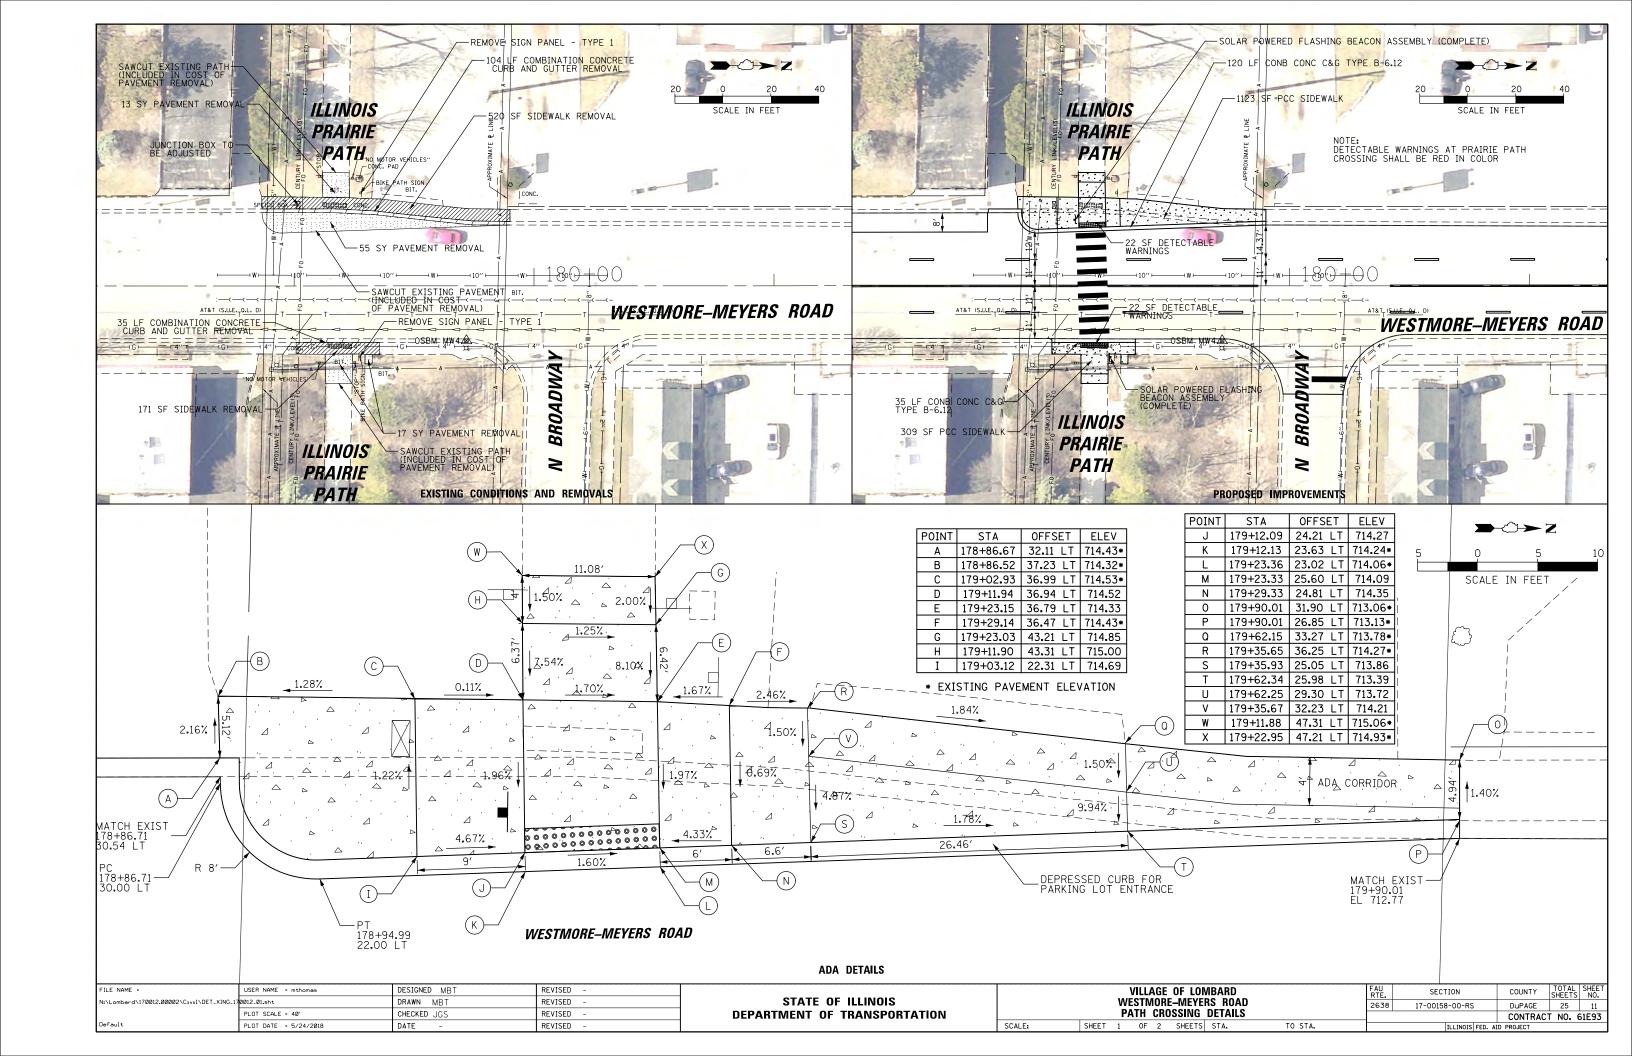


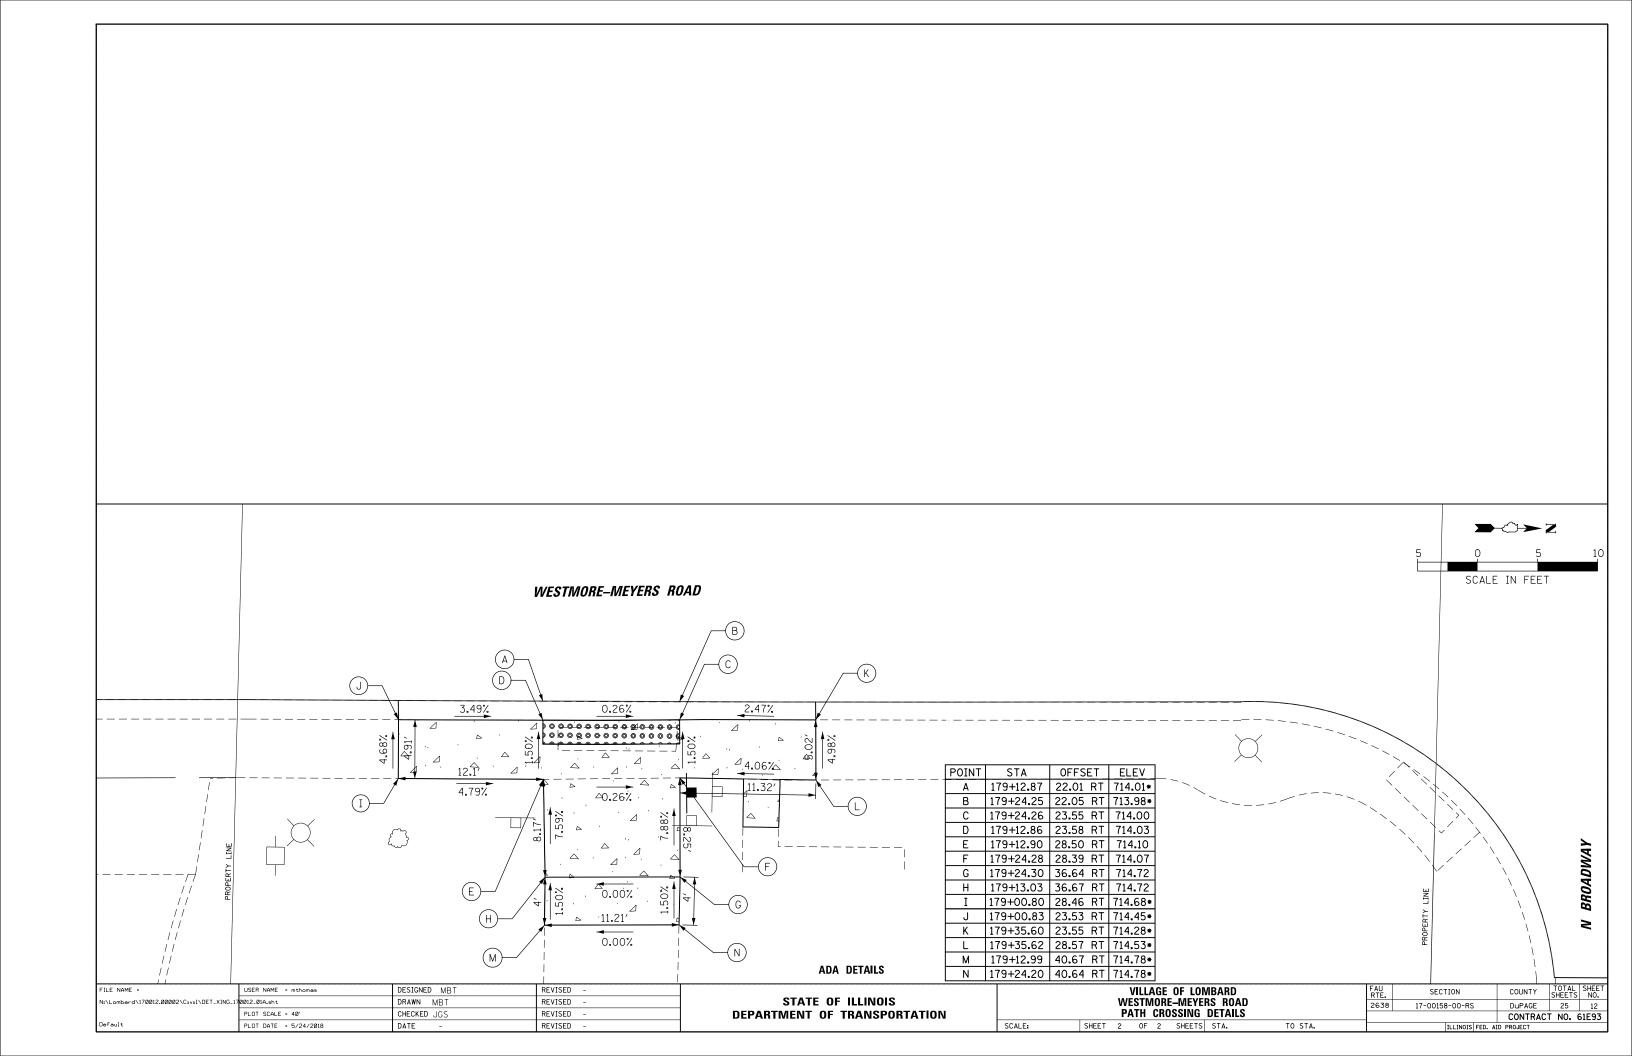

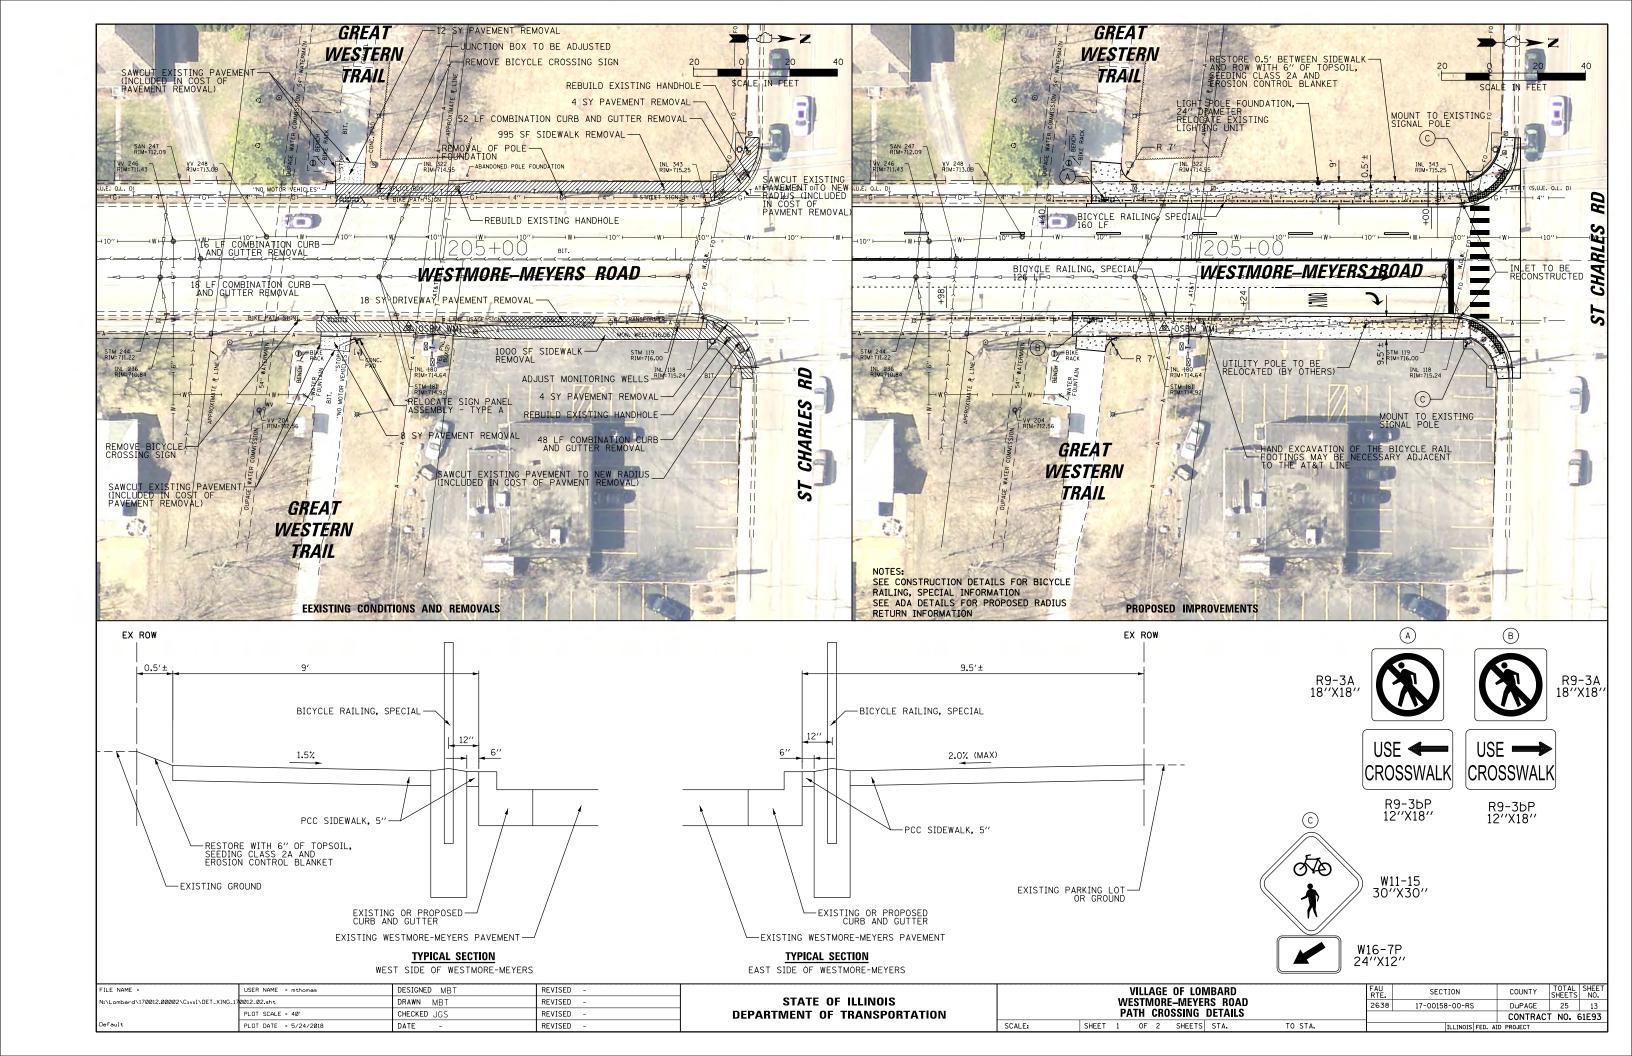

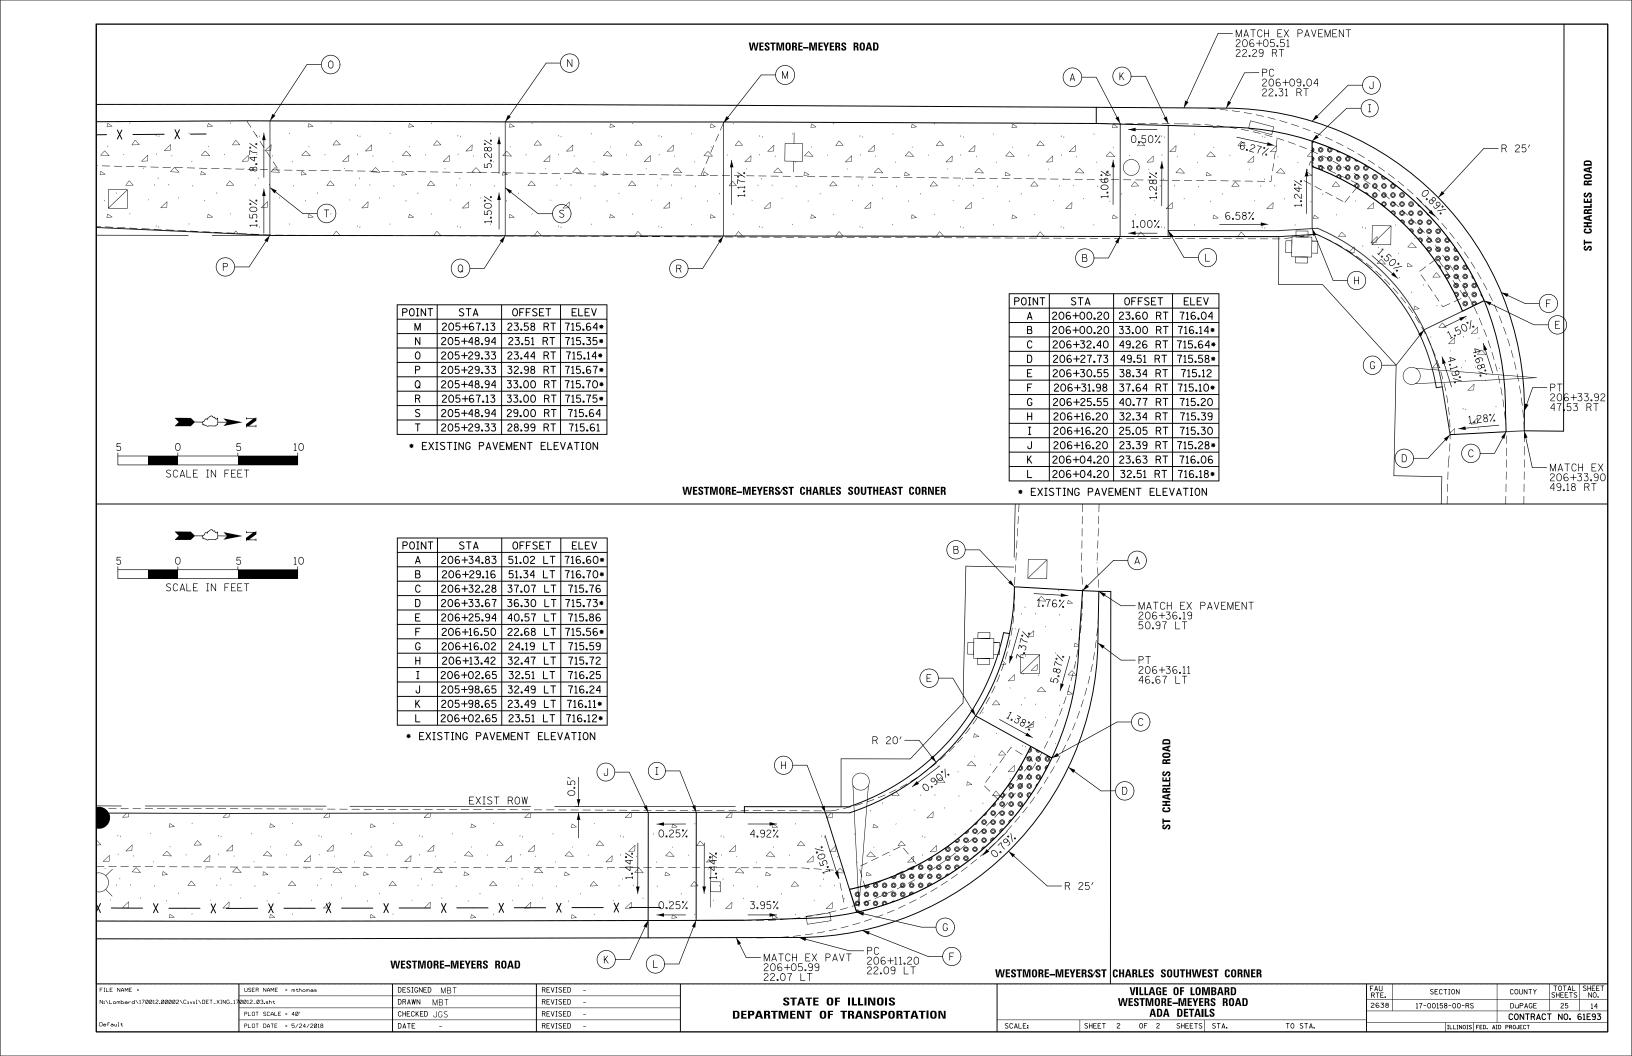


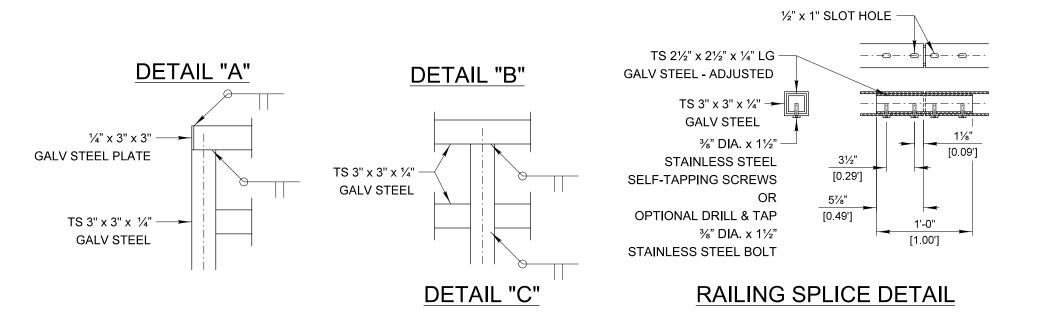


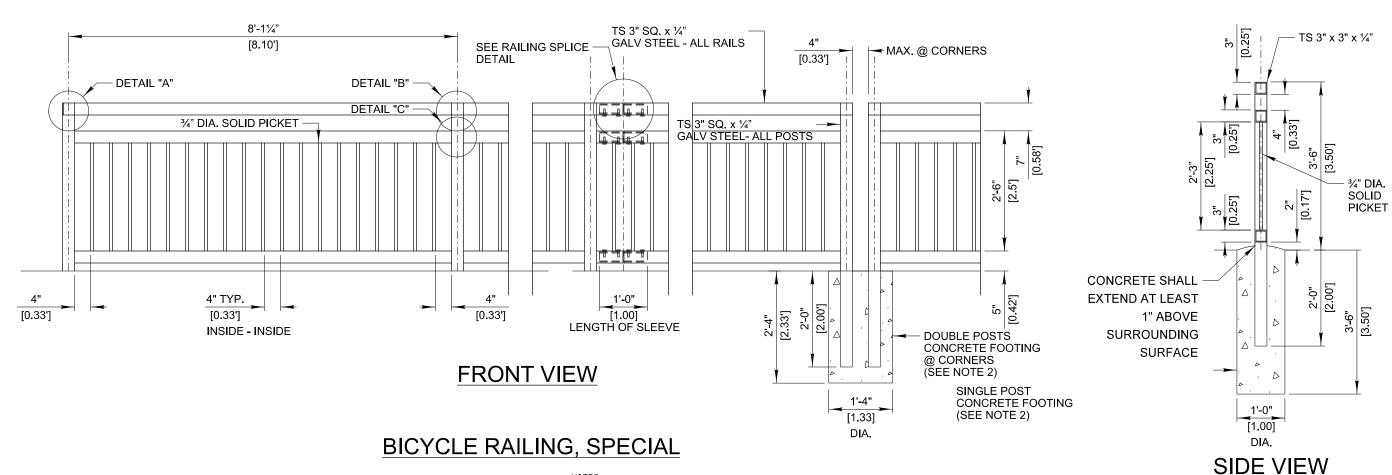



- 1. THE DOUBLE POSTS AT THE CORNERS ARE INTENDED TO CHANGE THE HORIZONTAL ALIGNMENT.
- 2. WHERE THE BICYCLE RAILING, SPECIAL IS LOCATED AT AN EXISTING OR PROPOSED SIDEWALK, A HOLE SHALL BE CORED IN THE SIDEWALK FOR THE FOUNDATION. THE COST OF CORING SHALL BE INCLUDED IN THE COST OF BICYCLE RAILING, SPECIAL.
- 3. ALL BOLTS, NUTS AND WASHERS SHALL BE STAINLESS STEEL.
- 4. SHOP DRAWINGS BASED ON INDIVIDUAL PLAN VIEW LOCATIONS MUST BE SUBMITTED TO THE ENGINEER FOR APPROVAL.

| FILE NAME = | USER NAME = mthomas | DESIGNED MBT | REVISED - | | VILLAGE OF LOMBARD | FAU SECTI | ION | COUNTY TOTA | IL SHEET |
|-------------------------------------|-----------------------|--------------|-----------|------------------------------|---|----------------|-------------------|--------------|------------|
| N:\Lombard\170012.00002\Civil\DET_1 | 70012_01.sht | DRAWN MBT | REVISED - | STATE OF ILLINOIS | WESTMORE-MEYERS ROAD | 2638 17-00158- | -00-RS | DuPAGE 25 | 45 |
| | PLOT SCALE = 2' | CHECKED JGS | REVISED - | DEPARTMENT OF TRANSPORTATION | CONSTRUCTION DETAILS | | | CONTRACT NO. | 61E93 |
| Default | PLOT DATE = 5/24/2018 | DATE - | REVISED - | | SCALE: NTS SHEET 1 OF 1 SHEETS STA. TO STA. | 10 | ILLINOIS FED. AID | PROJECT | |

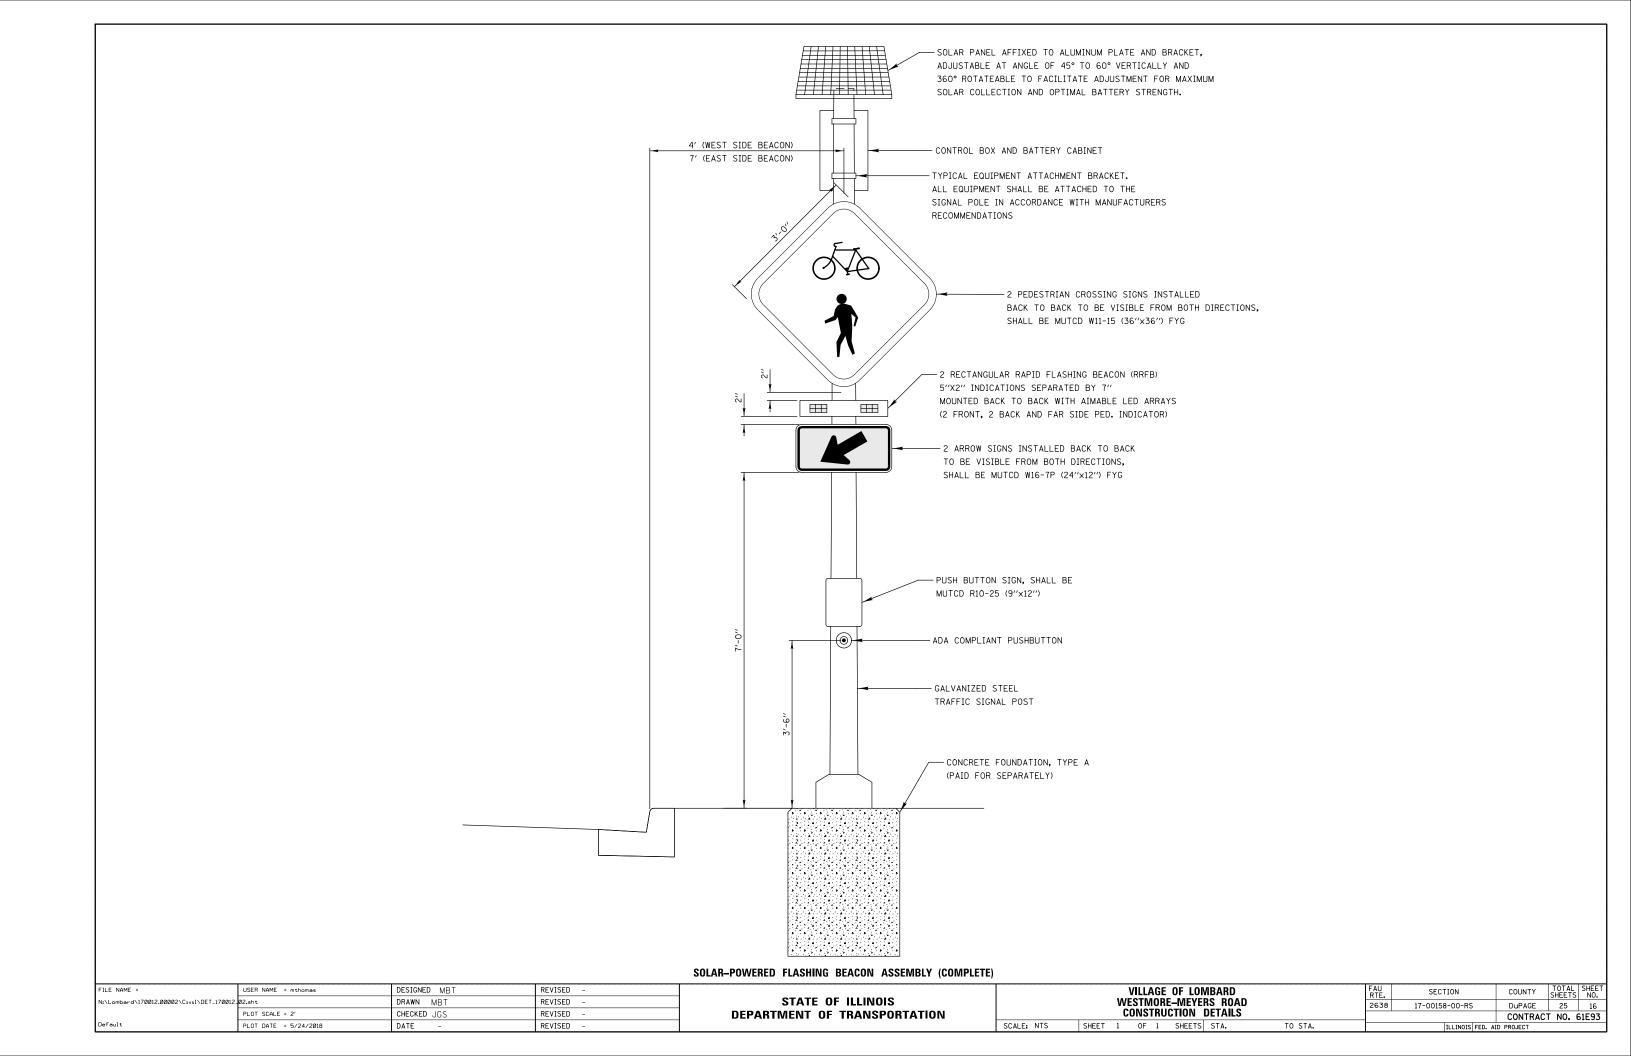

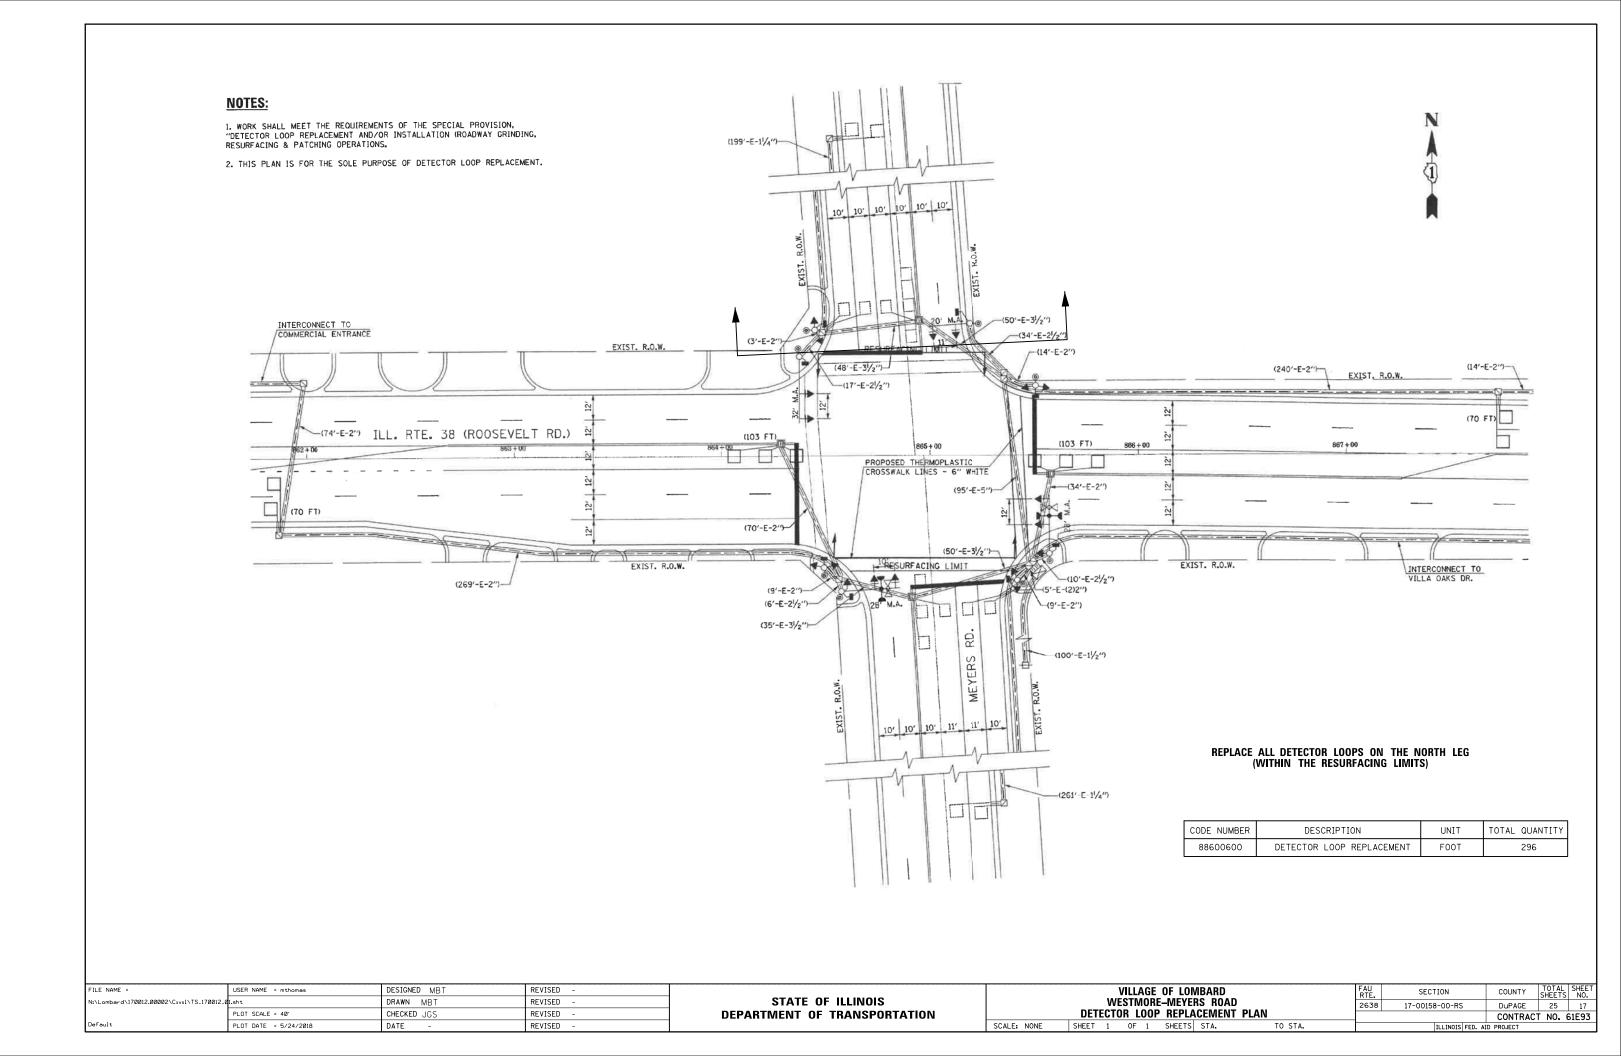

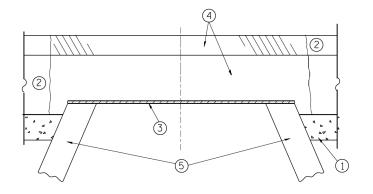

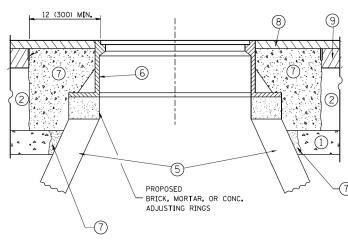

EXISTING BROKEN FRAMES AND LIDS SHALL BE REMOVED AND DISPOSED OF BY THE CONTRACTOR AND SHALL BE REPLACED AS DIRECTED BY THE ENGINEER. REPLACEMENT FRAMES AND LIDS WILL BE PAID FOR IN ACCORDANCE WITH ARTICLE 109.04 OF THE STANDARD SPECIFICATIONS UNLESS A SEPARATE PAY ITEM HAS BEEN PROVIDED.

IF THE EXISTING LIDS ARE OPEN, THE FRAME WILL BE ADJUSTED TO THE ELEVATION OF THE MILLED PAVEMENT SURFACE PRIOR TO THE MILLING OPERATION. THE FRAME WILL NOT BE REMOVED AND COVERED BY THE METAL PLATE.

CITY OF CHICAGO CASTINGS ARE THE PROPERTY OF THE CITY AND THE CONTRACTOR SHALL NOTIFY THE CITY FOR REMOVAL AND DISPOSITION OF THE CASTINGS.

THE METAL PLATE USED TO COVER THE STRUCTURE SHALL REMAIN THE PROPERTY OF THE CONTRACTOR.

WHEN STRUCTURES ARE TO BE ADJUSTED OR RECONSTRUCTED, THE LOWERING AND RAISING OF THE FRAMES AND LIDS WILL NOT BE PAID FOR SEPARATELY BUT WILL BE INCLUDED IN THE COST OF THE CORRESPONDING PAY ITEM.

SCALE: NONE

CONSTRUCTION PROCEDURES

STAGE 1 (BEFORE PAVEMENT MILLING)

- A) REMOVE A MINIMUM OF 12 (300) OF THE PAVEMENT FROM
- AROUND THE STRUCTURE.

 B) REMOVE THE EXISTING FRAME AND LID FROM THE STRUCTURE.
- C) COVER THE STRUCTURE OPENING WITH A 36 (900) DIAMETER METAL PLATE.

 D) BACKFILL WITH CRUSHED STONE AND A MINIMUM $1\frac{1}{2}$ (40)
- THICK HMA SURFACE MIX APPROVED BY THE ENGINEER.

STAGE 2 (AFTER PAVEMENT MILLING)

- A) REMOVE THE HMA SURFACE MIX AND CRUSHED STONE.
- B) INSTALL THE FRAME AND LID; ADJUST THE FRAME TO ITS FINAL SURFACE ELEVATION.
- C) THE SURROUNDING SPACE SHALL BE FILLED WITH CLASS PP-1* CONCRETE TO THE ELEVATION OF THE SURFACE OF THE EXISTING BASE COURSE OR THE BINDER COURSE.
- * UNLESS OTHERWISE SPECIFIED IN THE PLANS.

THE PROCEDURE EXPLAINED ABOVE SHALL CONFORM TO THE APPLICABLE PORTIONS OF SECTIONS 353, 406, 602, AND 603 OF THE STANDARD SPECIFICATIONS EXCEPT THAT "THE CONTRACTOR SHALL ADJUST THE STRUCTURES TO THE FINISHED PAVEMENT ELEVATION NO MORE THAN 5 CALENDAR DAYS PRIOR TO PLACEMENT OF THE FINAL LIFT OF SURFACE UNLESS APPROVED BY THE

LEGEND

- 1 SUB-BASE GRANULAR MATERIAL
- (6) FRAME AND LID (SEE NOTES)
- 2 EXISTING PAVEMENT
- (7) CLASS PP-1* CONCRETE
- 3 36 (900) DIAMETER METAL PLATE
- PROPOSED CRUSHED STONE AND HMA SURFACE MIX
- (8) PROPOSED HMA SURFACE COURSE
- (5) EXISTING STRUCTURE
- 9 PROPOSED HMA BINDER COURSE

LOCATION OF STRUCTURES:

THE CONTRACTOR WILL BE REQUIRED TO KEEP A RECORD OF THE LOCATIONS OF THE BURIED STRUCTURES ACCORDING TO THE STATION AND DISTANCE LEFT OR RIGHT OF THE CENTERLINE OF PAVEMENT. UPON COMPLETION OF THE WORK, THE CONTRACTOR WILL DELIVER THE RECORD TO THE ENGINEER.

BASIS OF PAYMENT:

REMOVING FRAMES AND LIDS ON DRAINAGE AND UTILITY STRUCTURES IN THE PAVEMENT PRIOR TO MILLING, AND ADJUSTING TO FINAL GRADE PRIOR TO PLACING THE SURFACE COURSE, WILL BE PAID FOR AT THE CONTRACT UNIT PRICE EACH FOR "FRAMES AND LIDS TO BE ADJUSTED

THIS WORK WILL NOT BE PAID FOR WHEN DRAINAGE AND UTILITY STRUCTURES ARE SPECIFIED FOR PAYMENT AS STRUCTURE RECONSTRUCTION.

NEW FRAMES AND LIDS, WHEN SPECIFIED, WILL BE PAID FOR SEPARATELY.

DETAILS FOR FRAMES AND LIDS ADJUSTMENT WITH MILLING


ALL DIMENSIONS ARE IN INCHES (MILLIMETERS) UNLESS OTHERWISE SHOWN

| FILE NAME = | USER NAME = bauerdl | DESIGNED - R. SHAH | REVISED | - R. WIEDEMAN 05-14-04 |
|--|-----------------------------|-------------------------|---------|------------------------|
| c:\pw_work\pwidot\bauerdl\d0108315\bd08. | dgn | DRAWN - | REVISED | - R. BORO 01-01-07 |
| | PLOT SCALE = 1968.5000 '/ m | CHECKED - | REVISED | - R. BORO 03-09-11 |
| | PLOT DATE = 12/6/2011 | DA TE - 10-25-94 | REVISED | - R. BORO 12-06-11 |

STATE OF ILLINOIS **DEPARTMENT OF TRANSPORTATION**

DETAILS FOR FRAMES AND LIDS ADJUSTMENT WITH MILLING SHEET NO. 1 OF 1 SHEETS STA.

SECTION COUNTY 17-00158-00-RS DuPAGE 25 BD600-03 (BD-8) CONTRACT NO. 61E93 ID PROJECT

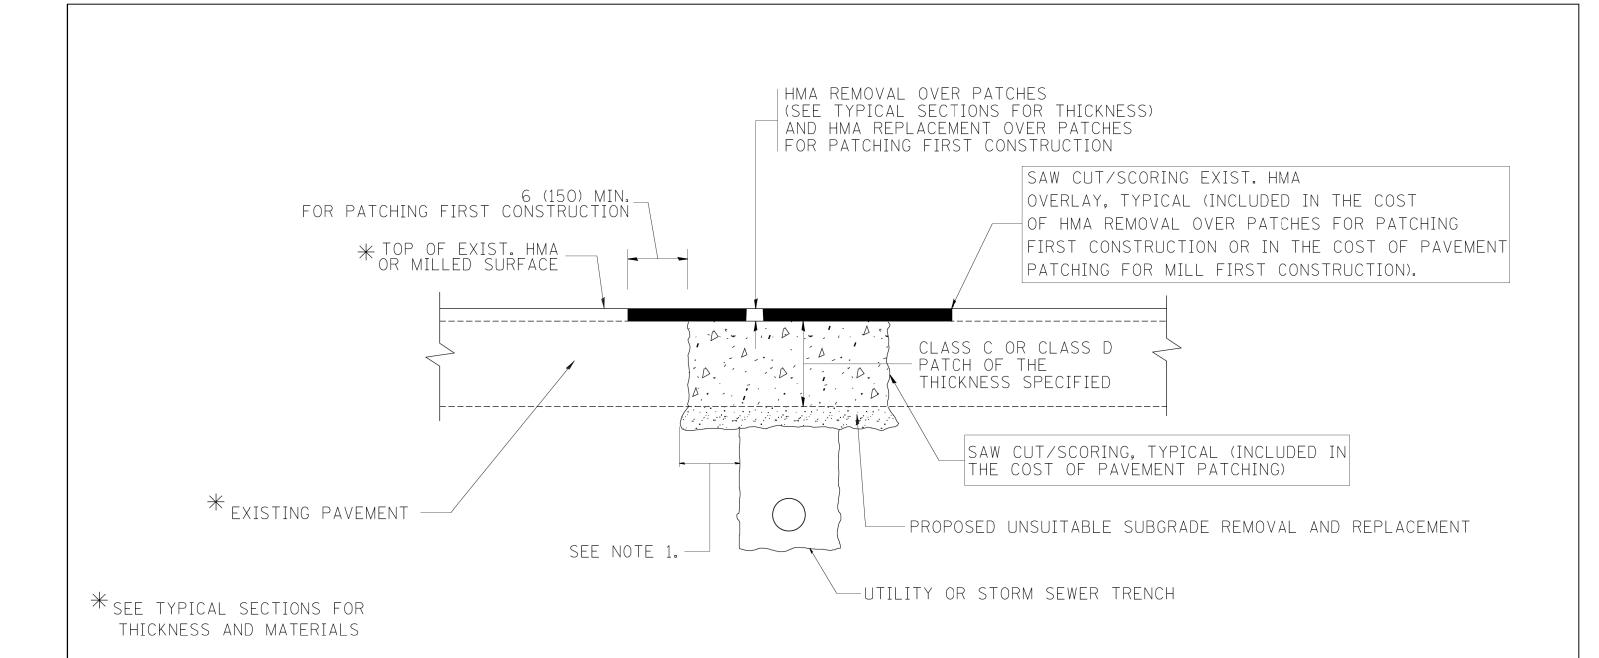

NOTES:

- 1. THE WIDTH OF THE FULL DEPTH PATCH OVER A TRENCH SHALL BE 12 (300) WIDER ON EACH SIDE OF THE TRENCH.
- 2. FOR METHOD OF MEASUREMENT AND BASIS OF PAYMENT, SEE RECURRING SPECIAL PROVISION "PATCHING WITH HOT-MIX ASPHALT OVERLAY REMOVAL".

SEQUENCE OF CONSTRUCTION (PATCHING FIRST)


- 1. REMOVE THE EXISTING HMA MATERIAL OVER THE AREA TO BE PATCHED.
- 2. REMOVE AND REPLACE WITH CLASS C OR D PATCH.
- 3. REPLACE HMA MATERIAL OVER THE AREA TO BE PATCHED.

SEQUENCE OF CONSTRUCTION (MILLING FIRST)


- 1. MILL HMA FIRST IF THERE IS AT LEAST 41/2 INCHES OR MORE OF HMA MATERIAL ON TOP OF THE EXISTING PAVEMENT OR IF THE PAVEMENT IS FULL DEPTH HMA. A MINIMUM OF 2 INCHES OF HMA MATERIAL SHALL BE IN PLACE AFTER MILLING.
- 2. REMOVE AND REPLACE WITH FULL DEPTH CLASS D PATCHES TO TOP OF MILLED SURFACE.

ALL DIMENSIONS ARE IN INCHES (MILLIMETERS) UNLESS OTHERWISE SHOWN.

| c:\projects\diststd22x34\bd22.dgn | | DESIGNED - R. SHAH DRAWN - | REVISED - A. ABBAS 04-27-98 REVISED - R. BORO 01-01-07 | STATE OF ILLINOIS | PAVEMENT PATCHING FOR | RTE. SECTION 2638 17-00158-00-RS | COUNTY SHEETS NO. DuPAGE 25 19 |
|-----------------------------------|----------------------------|-----------------------------|---|------------------------------|--|---|---------------------------------|
| | PLOT SCALE = 50.000 '/ IN. | CHECKED - | REVISED - R. BORO 09-04-07 | DEPARTMENT OF TRANSPORTATION | HMA SURFACED PAVEMENT | BD400-04 (BD-22) | CONTRACT NO. 61E93 |
| | PLOT DATE = 10/27/2008 | DATE - 10-25-94 | REVISED - K. ENG 10-27-08 | | SCALE: NONE SHEET NO. 1 OF 1 SHEETS STA. TO STA. | • | . AID PROJECT |

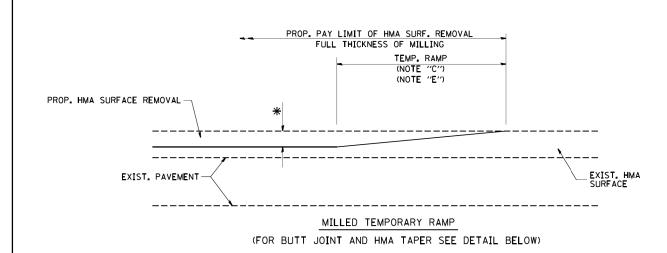


OPTION 1

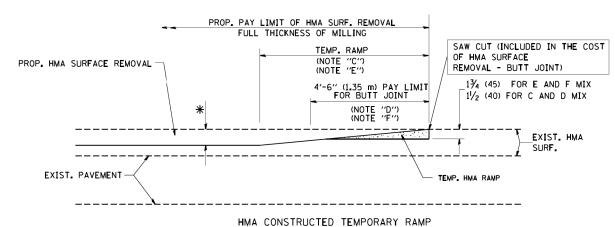

(FOR BUTT JOINT AND HMA TAPER SEE DETAIL BELOW)

OPTION 2


TYPICAL TEMPORARY RAMP

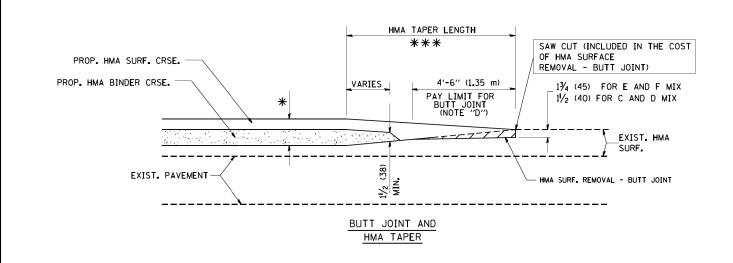


TYPICAL BUTT JOINT AND HMA TAPER FOR MILLING AND RESURFACING

FILE NAME = DESIGNED - M. DE YONG R. SHAH 10-25-94 USER NAME = gaglianobt REVISED W:\diststd\22x34\bd32.dgn DRAWN REVISED A. ABBAS 03-21-97 CHECKED REVISED M. GOMEZ 04-06-01 LOT SCALE = 50.0000 '/ IN. DATE 06-13-90 REVISED R. BORO 01-01-07

STATE OF ILLINOIS DEPARTMENT OF TRANSPORTATION

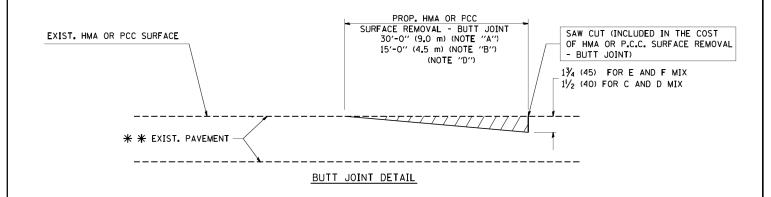

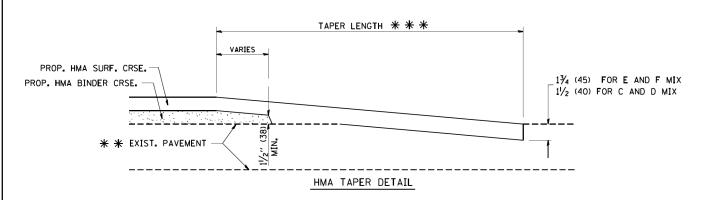

TYPICAL BUTT JOINT AND HMA TAPER FOR RESURFACING ONLY

* * PC CONCRETE, HMA OR HMA RESURFACED PAVEMENT.

NOTES

A: MAINLINE ROADWAYS AND MAJOR SIDE ROADS.

B: MINOR SIDE ROADS.

C: THE TEMP. RAMP SHALL BE CONSTRUCTED IMMEDIATELY UPON REMOVAL OF THE EXISTING HMA SURFACE.

D: THE BUTT JOINT SHALL BE CONSTRUCTED IMMEDIATELY PRIOR TO PLACING THE PROPOSED HMA COURSES.

E: TAPER THE TEMP. RAMP AT A RATE OF 3'-0" (900 mm) PER 1 INCH (25 mm) OF MILLING THICKNESS.

F: INSTALLATION AND REMOVAL OF THE 4'-6" (1.35 m) TEMP. RAMP IS INCLUDED IN COST OF HMA SURFACE REMOVAL - BUTT JOINT

G: SEE ARTICLE 406.08 AND 406.14 OF THE STANDARD SPECIFICATIONS FOR "HMA AND/OR PCC SURFACE REMOVAL, BUTT JOINT".

* SEE TYPICAL SECTIONS FOR MILLING THICKNESS.

* * * 20'-0" (6.1 m) PER 1 (25) RESURFACING (NOTE "A") 10'-0" (3.0 m) PER 1 (25) RESURFACING (NOTE "B")

BASIS OF PAYMENT:

THE BUTT JOINT WILL BE PAID FOR AT THE CONTRACT UNIT PRICE PER SQUARE YARD (SQUARE METER)
FOR "HOT-MIX ASPHALT SURFACE REMOVAL - BUTT JOINT" OR FOR "PORTLAND CEMENT CONCRETE SURFACE REMOVAL- BUTT JOINT".

SCALE: NONE

ALL DIMENSIONS ARE IN INCHES (MILLIMETERS) UNLESS OTHERWISE SHOWN.

LIGHT POLE FOUNDATION DEPTH TABLE 30 FT. (9.144 m) TO 35 FT. (10.668 m) MOUNTING HEIGHT

| F 12 (102000 II | II) MODIALING | 111 | | |
|----------------------------------|--|---|--|--|
| DESIGN DEPTH "D" OF FOUNDATION | | | | |
| SINGLE ARM POLE | TWIN ARM POLE | | | |
| 11'-0'' (3 _* 35 m) | 12'-8'' (3.85 m) | | | |
| 9'-0'' (2.74 m) | 14′-10′′ (4 . 52 m) | | | |
| 7'-6'' (2 . 29 m) | 8'-7'' (2 . 61 m) | | | |
| 9'-6'' (2 . 90 m) | 10'-7" (3 . 22 m) | | | |
| 9'-0'' (2.74 m) | 9'-10'' (2.99 m) | | | |
| 8'-3'' (2 . 51 m) | 9′-7′′ (2.91 m) | | | |
| | DESIGN DEPTH "I SINGLE ARM POLE 11'-0" (3.35 m) 9'-0" (2.74 m) 7'-6" (2.29 m) 9'-6" (2.90 m) 9'-0" (2.74 m) 8'-3" | SINGLE ARM POLE 11'-0" (3.35 m) (3.85 m) 9'-0" (2.74 m) (4.52 m) 7'-6" (2.29 m) (2.61 m) 9'-6" (2.90 m) (3.32 m) 9'-0" (2.74 m) (2.90 m) 9'-0" (2.74 m) (2.99 m) 8'-3" | | |

CONTRACTOR TO MEASURE EXISTING BOLT SIZE PRIOR TO ORDERING MATERIALS

5" (127.0)

ANCHOR BOLT DETAIL

DIA. DIA.

6" (152-4)

5/8" T. X 4" DIA. WASHER, TACK WELDED


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CONTRACTOR TO MEASURE BOLT CIRCLE RIOR TO ORDERING MATERIALS CENTER RACEWAYS IN FOUNDATION RACEWAYS PARALLEL TO EDGE OF PAVEMENT

TOP VIEW

THIS DETAIL HAS BEEN MODIFIED FOR THIS PROJECT


ANCHOR ROD

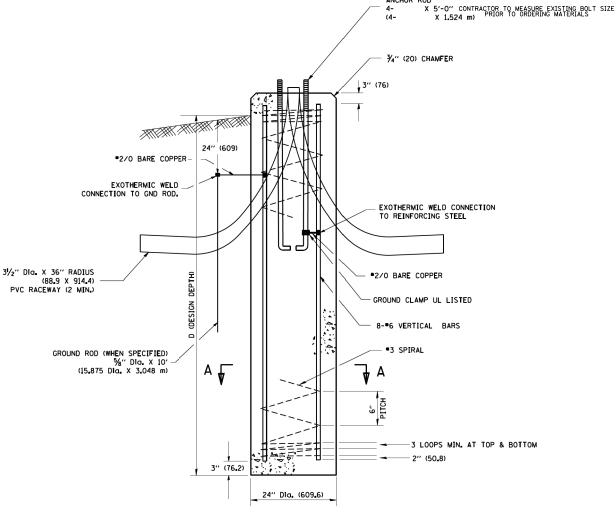


NOTES

- 1. ALL DIMENSIONS ARE IN INCHES (MILLIMETERS) UNLESS OTHERWISE SHOWN,
- THE ANCHOR RODS AND RACEWAYS SHALL BE PROPERLY SECURED IN PLACE BEFORE THE CONCRETE IN PLACED.
- 3. THE FOUNDATION SHALL NOT PROTRUDE MORE THAN 4 IN. (100 mm) ABOVE THE FINISHED GRADE WITHIN A 60 IN. (1.5 m) CHORD ACROSS THE FOUNDATION, WITH ANCHOR RODS INCLUDED, IN ACCORDANCE WITH AASHTO GUIDELINES. IF THE FOUNDATION HEIGHT, INCLUDING ANCHOR RODS, EXTENDS BEYOND THESE SPECIFIED LIMITS, THE FOUNDATION SHALL BE REPLACED AT THE CONTRACTOR'S EXPENSE. SEE FOUNDATION EXTENSION DETAIL.
- 4. THE HOLE FOR THE FOUNDATION SHALL BE MADE BY DRILLING WITH AN AUGER, OF THE SAME DIAMETER AS THE FOUNDATION. IF SOIL CONDITIONS REQUIRE THE USE OF A LINER TO FORM THE HOLE, THE LINER SHALL BE WITHDRAWN AS THE CONCRETE IS DEPOSITED.
- 5. THE TOP OF THE FOUNDATION SHALL BE CONSTRUCTED LEVEL. A LINER OR FORM SHALL BE USED TO PRODUCE A UNIFORM SMOOTH SIDE TO THE TOP OF THE FOUNDATION. FOUNDATION TOP SHALL BE CHAMFERED 3/4-IN. (20 mm).
- THE CONCRETE SHALL BE CLASS SI. CONCRETE SHALL CURE ACCORDING TO ARTICLE 1020.13 BEFORE LIGHT POLES ARE INSTALLED.
- 7. THE ANCHOR ROD SHALL BE A HOOK ROD TYPE. COLD BENDING OF THE ANCHOR ROD WILL NOT BE ALLOWED. THE RADIUS OF THE HOOK BEND SHALL NOT BE LESS THAN 4 TIMES THE NOMINAL DIAMETER OF THE ANCHOR ROD. A TACK WELDED ANCHOR ROD MAY BE SUBSTITUTED WITH THE APPROVAL OF THE ENGINEER.
- 8. THE ANCHOR RODS SHALL BE ACCORDING TO ASTM F1554 GRADE 725 (GRADE 105), NUTS SHALL BE HEXAGON NUTS ACCORDING TO ASTM A 194 2H OR ASTM A 563 DH, AND WASHERS SHALL BE ACCORDING TO ASTM F 436.
- 9. ANCHOR RODS, NUTS AND WASHERS SHALL BE COMPLETELY GALVANIZED BY EITHER THE HOT-DIPPED PROCESS CONFORMING WITH AASHTO M 232, THE MECHANICAL PLATING METHOD CONFORMING TO AASHTO M 298, CLASS 50 WITH A MAXIMUM COATING THICKNESS OF 150 UM(6 MILS) OR THE ELECTROLYTIC PROCESS ACCORDING TO ASTM F 1136.
- 10. THE ANCHOR RODS SHALL BE THREADED A MINIMUM OF 6 INCHES (150 mm) WITH A MINIMUM OF 3 INCHES (75 mm) OF THREADED ANCHOR ROD EMBEDDED IN THE FOUNDATION.
- 11. ANCHOR RODS SHALL PROJECT 2¾" (69.9 mm) ABOVE THE TOP OF THE FOUNDATION. IF BREAKAWAY COUPLINGS ARE SPECIFIED, THE CONTRACTOR SHALL CAREFULLY COORDINATE THE ANCHOR ROD PROJECTION WITH THE INSTALLATION REQUIREMENTS OF THE BREAKAWAY COUPLINGS.
- 12. THE CONTRACTOR SHALL USE A *3 SPIRAL AT 6" (152.4 mm) PITCH OR MAY SUBSTITUTE *3 TIES AT 12" (304.8 mm) O.C. WITH THE APPROVAL OF THE ENGINEER.
- 13. THE CABLE TRENCHES AND FOUNDATION SHALL BE BACK FILLED AND COMPACTED AS SPECIFIED BEFORE THE LIGHT POLE IS ERECTED.
- 14. THE RACEWAYS SHALL PROJECT 1" (25.4 mm) ABOVE THE TOP OF THE FOUNDATION.

FOUNDATION DETAIL

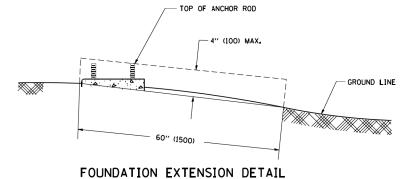

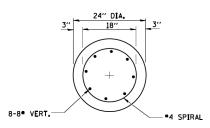


SECTION A-A

| FILE NAME = | USER NAME = gaglianobt | DESIGNED - | REVISED - |
|----------------------------|-----------------------------|------------|-----------|
| W:\diststd\22x34\be300.dgn | | DRAWN - | REVISED - |
| | PLOT SCALE = 50.0000 '/ IN. | CHECKED - | REVISED - |
| i | PLOT DATE - 1/4/2008 | DATE - | DEVISED _ |

STATE OF ILLINOIS DEPARTMENT OF TRANSPORTATION

| LIGHT POLE FOUNDATION | | | | RTE. SECTION | | COUNTY | TOTAL SHEETS | SHEET NO. |
|---|-------------------------|------|---------|--------------|---------------------------------|-----------|-----------------|--------------|
| 30' (9.144 m) TO 35' (10.668 m) M.H. 11 1/2" (292 mm) BOLT CIRCLE | | | | | 17-00158-00-RS | DuPAGE | 25 | 21 |
| 30 (5.14 | | | BE-300 | CONTRACT | NO. | 61E93 | | |
| SCALE: NONE | SHEET NO. 1 OF 1 SHEETS | STA. | TO STA. | FED. RO | DAD DIST. NO. 1 ILLINOIS FED. A | D PROJECT | | |

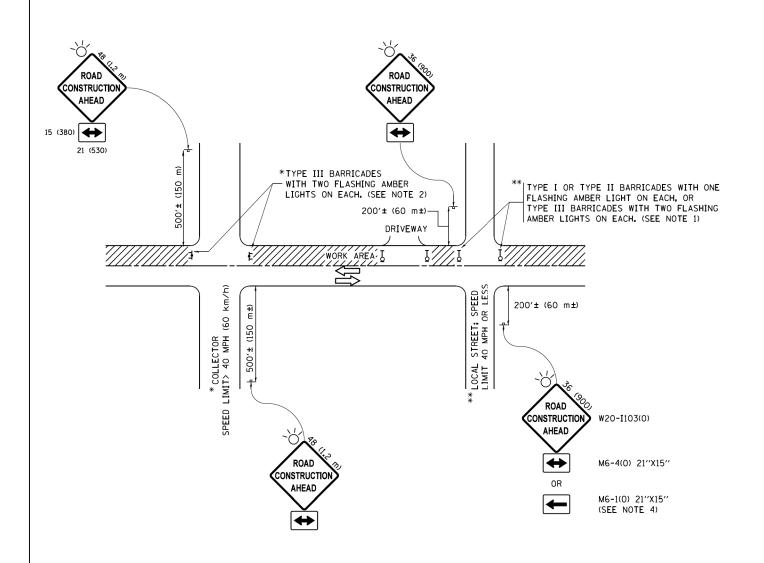

NOTES:

- 1. SIDE ROAD WITH A SPEED LIMIT OF 40 MPH (60 km/h) OR LESS AS SHOWN ON THE DRAWING AND AS DIRECTED BY THE ENGINEER:
 - a) ONE "ROAD CONSTRUCTION AHEAD" SIGN 36 x 36 (900x900) WITH A FLASHER MOUNTED ON IT APPROXIMATELY 200" (60 m) IN ADVANCE OF THE MAIN ROUTE.
 - b) THE CLOSED PORTION OF THE MAIN ROUTE SHALL BE PROTECTED BY BLOCKING WITH TYPE I, TYPE II OR TYPE III BARRICADES, 1/3 OF THE CROSS SECTION OF THE CLOSED PORTION.
- 2. SIDE ROAD WITH A SPEED LIMIT GREATER THAN 40 MPH (60 km/h) AS SHOWN ON THE DRAWING AND AS DIRECTED BY THE ENGINEER:
 - a) ONE "ROAD CONSTRUCTION AHEAD" SIGN 48 x 48 (1.2 m x 1.2 m) WITH A FLASHER MOUNTED ON IT APPROXIMATELY 500" (150 m) IN ADVANCE OF THE MAIN ROUTE.
 - b) THE CLOSED PORTION OF THE MAIN ROUTE SHALL BE PROTECTED BY BLOCKING WITH TYPE III BARRICADES, 1/2 OF THE CROSS SECTION OF THE CLOSED PORTION.
- 3. CONES MAY BE SUBSTITUTED FOR BARRICADES OR DRUMS AT HALF THE SPACING DURING DAY OPERATIONS. CONES SHALL BE A MINIMUM OF 28 (710)
- 4. WHEN THE SIDE ROAD LIES BETWEEN THE BEGINNING OF THE MAINLINE SIGNING AND THE WORK ZONE, A SINGLE HEADED ARROW (M6-1) SHALL BE USED IN LIEU OF THE DOUBLE HEADED ARROW (M6-4).

SCALE: NONE


- 5. WHEN WORK IS BEING PERFORMED ON A SIDE ROAD OR DRIVEWAY, FOLLOW THE APPLICABLE STANDARD(S). THE DIRECTIONAL ARROW (M6-1 OR M6-4) SHALL BE COVERED OR REMOVED WHEN NO LONGER CONSISTENT WITH THE TRAFFIC CONTROL SET-UP.
- 6. ADVANCE WARNING SIGNS ARE TO BE OMITTED ON DRIVEWAYS UNLESS OTHERWISE SPECIFIED IN THE PLANS OR BY THE ENGINEER
- 7. THE TRAFFIC CONTROL AND PROTECTION FOR SIDE ROADS, INTERSECTIONS, AND DRIVEWAYS SHALL BE INCLUDED IN THE COST OF SPECIFIED TRAFFIC CONTROL STANDARDS OR ITEMS.

All dimensions are in inches (millimeters) unless otherwise shown.

| FILE NAME = | USER NAME = footemj | DESIGNED - L.H.A. | REVISED | - A. HOUSEH 10-15-96 |
|--|---|--|---------|------------------------|
| pw:\\ILØ84EBIDINTEG.:ll:no:s.gov:PWIDOT\Do | cuments\IDOT Offices\District 1\Projects\Dist | St ORAWM \CADD o to\CADsheets\tc10.dgn | REVISED | -T. RAMMACHER 01-06-00 |
| | PLOT SCALE = 50.000 '/ in. | CHECKED - | REVISED | - A. SCHUETZE 07-01-13 |
| Default | PLOT DATE = 9/15/2016 | DATE - 06-89 | REVISED | - A. SCHUETZE 09-15-16 |

| STATI | E OF | ILLINOIS |
|------------|------|----------------|
| DEPARTMENT | 0F | TRANSPORTATION |

| TRAFFIC CONTROL AND PROTECTION FOR | FAU RTE. | SECTION | |
|--|-------------|----------------|--|
| SIDE ROADS, INTERSECTIONS, AND DRIVEWAYS | 2638 | 17-00158-00-RS | |
| SIDE HOADS, HETEHOLOTIONS, AND DINVEWATO | | TC-10 | |
| SHEET 1 OF 1 SHEETS STA. TO STA. | | ILLINOIS FED. | |

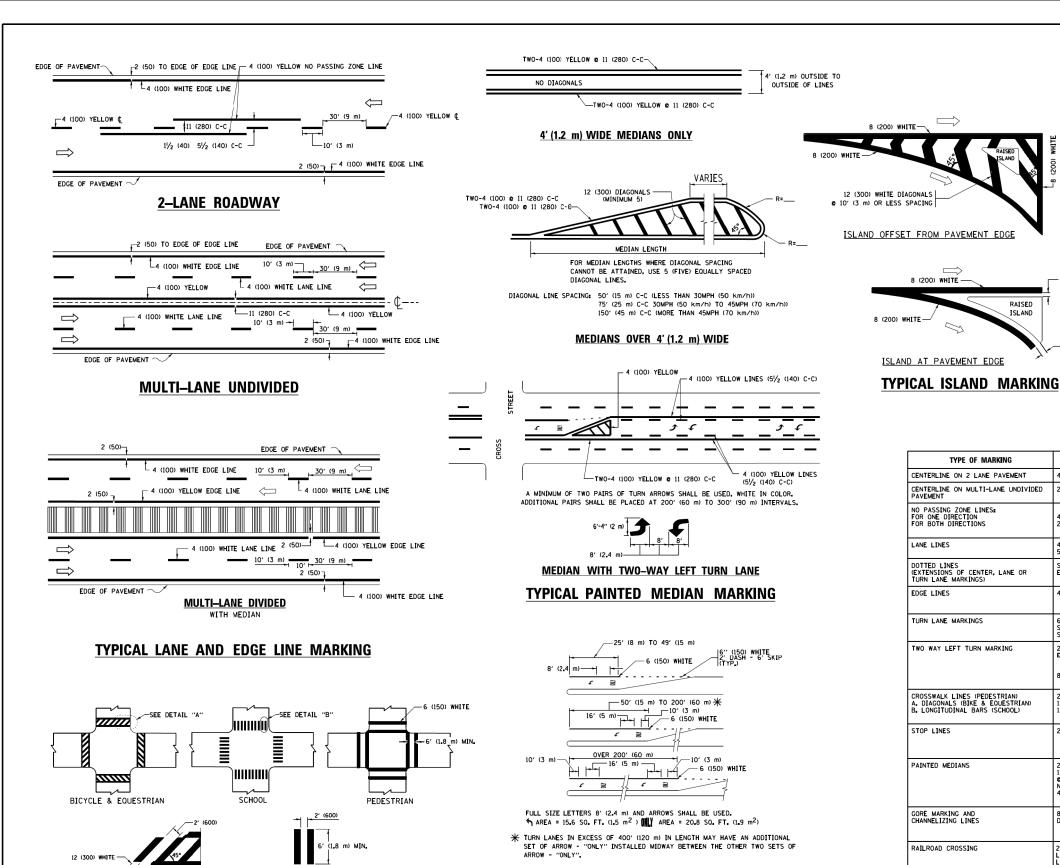

500 580 665 750 40 (1020) **COMBINATION** LEFT AND U-TURN 5'-4" (1620) √ 32 R (810) LANE REDUCTION TRANSITION * LANE REDUCTION ARROWS REQUIRED AT SPEEDS OF 45 MPH OR GREATER OR WHEN SPECIFIED IN PLANS. **U_TURN**

D(FT)

SPEED LIMIT

50

55

6'-4" (1930)

__ 2 (50)

2 (50)

RAISED

8 (200) WHITE -

| TYPE OF MARKING | WIDTH OF LINE | PATTERN | COLOR | SPACING /REMARKS |
|---|---|------------------------------------|---|--|
| CENTERLINE ON 2 LANE PAVEMENT | 4 (100) | SKIP-DASH | YELLOW | 10' (3 m) LINE WITH 30' (9 m) SPACE |
| CENTERLINE ON MULTI-LANE UNDIVIDED PAVEMENT | 2 @ 4 (100) | SOLID | YELLOW | 11 (280) C-C |
| NO PASSING ZONE LINES FOR ONE DIRECTION FOR BOTH DIRECTIONS | 4 (100) 2 c 4 (100) | SOLID SOLID | YELLOW YELLOW | 5/2 (140) C-C FROM SKIP-DASH CENTERLINE 11 (280) C-C OMIT SKIP-DASH CENTERLINE BETWEEN |
| LANE LINES | 4 (100) 5 (125) ON FREEWAYS | SKIP-DASH SKIP-DASH | WHITE WHITE | 10' (3 m) LINE WITH 30' (9 m) SPACE |
| DOTTED LINES (EXTENSIONS OF CENTER, LANE OR TURN LANE MARKINGS) | SAME AS LINE BEING EXTENDED | SKIP-DASH | SAME AS LINE BEING EXTENDED | 2' (600) LINE WITH 6' (1.8 m) SPACE |
| EDGE LINES | 4 (100) | SOLID | YELLOW-LEFT WHITE-RIGHT | OUTLINE MEDIANS IN YELLOW |
| TURN LANE MARKINGS | 6 (150) LINE: FULL SIZE LETTERS & SYMBOLS (8' (2.4m)) | SOLID | WHITE | SEE TYPICAL TURN LANE MARKING DETAIL |
| TWO WAY LEFT TURN MARKING | 2 © 4 (100) EACH DIRECTION 8' (2.4m) LEFT ARROW | SKIP-DASH AND SOLID IN PAIRS | YELLOW | 10' (3 m) LINE WITH 30' (9 m) SPACE FOR SKIP-DASH, 5½ (140) C-C BETWEEN SOLID LINE AND SKIP-DASH LINE SEE TYPICAL TWO-WAY LEFT TURN MARKING DETAIL |
| CROSSWALK LINES (PEDESTRIAN) A. DIAGONALS (BIKE & EQUESTRIAN) B. LONGITUDINAL BARS (SCHOOL) | 2 e 6 (150) 12 (300) e 45° 12 (300) e 90° | SOLID SOLID SOLID | WHITE WHITE WHITE | NOT LESS THAN 6' (].8 m) APART 2' (600) APART 2' (600) APART 2' (600) APART SEE TYPICAL CROSSWALK MARKING DETAILS. |
| STOP LINES | 24 (600) | SOLID | WHITE | PLACE 4' (1,2 m) IN ADVANCE OF AND PARALLEL TO CROSSWALK, IF PRESENT. OTHERWISE, PLACE AT DESIRED STOPPING POINT. PARALLEL TO CROSSROAD CENTERLINE, WHERE POSSIBLE |
| PAINTED MEDIANS | 2 @ 4 (100) WITH 12 (300) DIAGONALS @ 45° NO DIAGONALS USED FOR 4' (1.2 m) WIDE MEDIANS | SOLID | YELLOW: TWO WAY TRAFFIC WHITE: ONE WAY TRAFFIC | 11 (280) C-C FOR THE DOUBLE LINE SEE TYPICAL PAINTED MEDIAN MARKING. |
| GORE MARKING AND CHANNELIZING LINES | 8 (200) WITH 12 (300) DIAGONALS @ 45° | SOLID | WHITE | DIAGONALS: 15' (4,5 m) C-C (LESS THAN 30MPH (50 km/h)) 20' (6 m) C-C 30MPH (50 km/h) TO 45MPH (70 km/h)) 30' (9 m) C-C (OVER 45MPH (70 km/h)) |
| RAILROAD CROSSING | 24 (600) TRANSVERSE LINES; "RR" IS 6' (1.8 m) LETTERS; 16 (400) LINE FOR "X" | SOLID | WHITE | SEE STATE STANDARD 780001 AREA 0F1 "R"=3.6 SO. FT. (0.33 m ²) EACH "X"=54.0 SO. FT. (5.0 m ²) |
| SHOULDER DIAGONALS (REQUIRED FOR SHOULDERS > 8') | 12 (300) c 45° | SOLID | WHITE - RIGHT YELLOW - LEFT | 50' (15 m) C-C (LESS THAN 30MPH (50 km/h)) 75' (25 m) C-C (30 MPH (50 km/h) TO 45MPH (70 km/h)) 150' (45 m) C-C (0VER 45MPH (70 km/h)) |
| U TURN ARROW | SEE DETAIL | SOLID | WHITE | 16 _* 3 SF |
| 2 ARROW COMBINATION LEFT AND U TURN | SEE DETAIL | SOLID | WHITE | 30.4 SF |

FOR FURTHER DETAILS ON PAVEMENT MARKING REFER TO STANDARD SPECIFICATIONS FOR ROAD AND BRIDGE CONSTRUCTION AND STATE STANDARD 780001.

SCALE: NONE

All dimensions are in inches (millimeters) unless otherwise shown.

FILE NAME = USER NAME = leysa DESIGNED - EVERS REVISED - C. JUCIUS 09-09-09 /:\diststd\22x34\tc13.dgn DRAWN REVISED - C. JUCIUS 07-01-13 CHECKED REVISED - C. JUCIUS 12-21-15 PLOT SCALE = 50.000 '/ in. PLOT DATE = 6/23/2017 DATE 03-19-90 REVISED -C- JUCTUS 04-12-16

TYPICAL CROSSWALK MARKING

 $oldsymbol{st}$ markings shall be installed parallel to the centerline of

-12 (300) WHITE

DETAIL "B"

- 6 (150) WHITE

THE ROAD WHICH IT CROSSES


DETAIL "A"


STATE OF ILLINOIS **DEPARTMENT OF TRANSPORTATION**

TYPICAL LEFT (OR RIGHT) TURN LANE

TYPICAL TURN LANE MARKING


| DISTRICT ONE TYPICAL PAVEMENT MARKINGS | | | | FAU RTE. | SECTION | COUNTY | TOTAL SHEETS | SHEET NO. | | |
|--|---------------------------------|------|--------|-------------|----------------|--------|------------------|--------------|-------|-------|
| | | | | 2638 | 17-00158-00-RS | DuPAGE | 25 | 23 | | |
| | TIFICAL FAVEIVILIVI IVIANKIIVUS | | | | | | TC-13 | CONTRACT | NO. (| 61E93 |
| | SHEET 1 | OF 1 | SHEETS | STA. | TO STA. | | ILLINOIS FED. AI | D PROJECT | | |

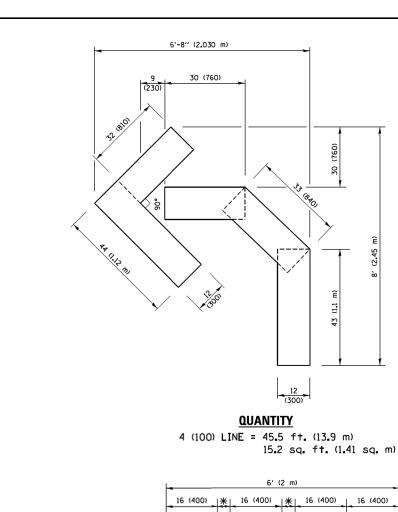

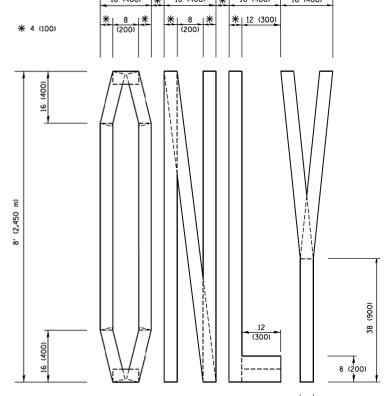

4 (100) LINE = 64.1 ft. (19.5 m) 21.4 sq. ft. (1.99 sq. m)

QUANTITY

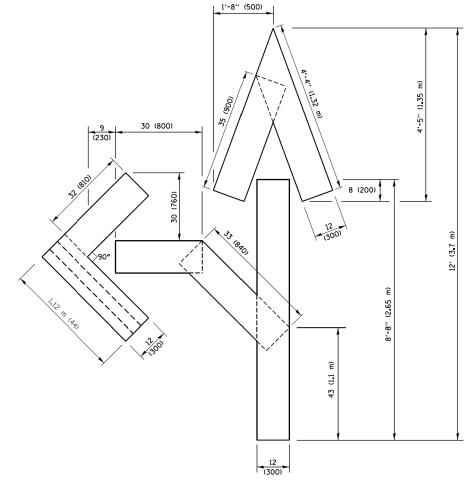


QUANTITY

4 (100) LINE = 82.5 ft. (25.1 m) 27.5 sq. ft. (2.53 sq. m)

NOTE:

ALL QUANTITIES OF PLACEMENT ARE REPRESENTED IN LINEAR FEET OF 4" LINES TO MATCH THE 4" TEMPORARY TAPE PAY ITEM AND REPRESENTS THE TOTAL QUANTITY OF 4" TAPE REQUIRED.

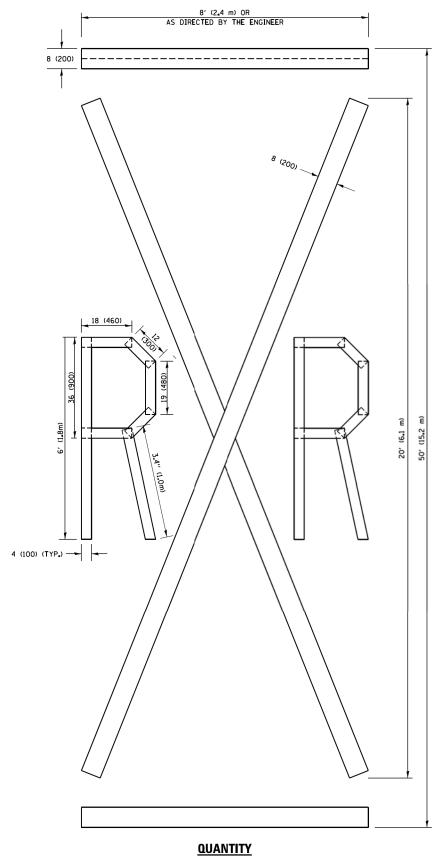


4 (100) LINE = 225.9 ft. (68.9 m) 75.3 sq. ft. (6.99 sq. m)

All dimensions are in inches (millimeters) unless otherwise shown.

| FILE NAME = | USER NAME = footemj | DESIGNED - | KENIZED | -1. RAMMACHER 03-02-98 | |
|---|---|---|---------|------------------------|--|
| pw:\\IL084EBIDINTEG.:111:no1s.gov:PWIDOT\Do | cuments\IDOT Offices\District 1\Projects\Dist | St ORAWM \CADData\CADsheets\tc16.dgn | REVISED | -E. GOMEZ 08-28-00 | |
| | PLOT SCALE = 50.0000 '/ in. | CHECKED - | REVISED | -E. GOMEZ 08-28-00 | |
| | PLOT DATE = 9/15/2016 | DATE - 09-18-94 | REVISED | - A. SCHUETZE 09-15-16 | |

STATE OF ILLINOIS
DEPARTMENT OF TRANSPORTATION

| | | RTE. | SECTION | | | | | |
|---------------------------|-------------|-------------|---------|---------------------|------|---------|----------------|-----------------------------|
| SHORT TERM PAVEMENT MARKI | | | MARKING | LETTERS AND SYMBOLS | | 2638 | 17-00158-00-RS | |
| | | | | | | | | TC-16 |
| | SCALE: NONE | SHEET NO. 1 | l OF 1 | SHEETS | STA. | TO STA. | FED. R | OAD DIST. NO. 1 ILLINOIS FI |

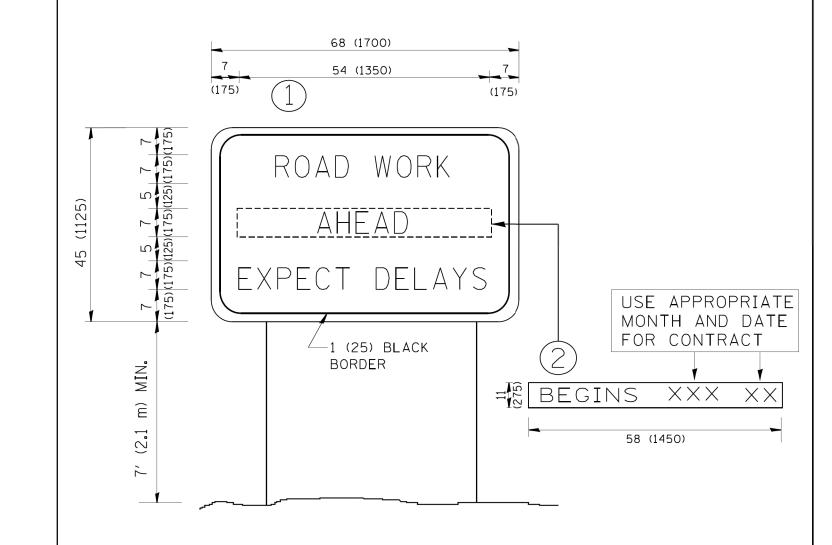

NOTES:

- 1. USE BLACK LETTERING ON ORANGE BACKGROUND.
- 2. ERECT SIGNS IN ADVANCE OF THE LOCATION FOR THE "ROAD CONSTRUCTION AHEAD" SIGN AT LOCATIONS AS DIRECTED BY THE ENGINEER.
- 3. ERECT SIGN () WITH INSTALLED PANEL (2) ONE WEEK PRIOR TO THE START OF CONSTRUCTION.
- 4. REMOVE PANEL (2) SOON AFTER THE START OF CONSTRUCTION.
- 5. SEE SPECIAL PROVISION FOR "TEMPORARY INFORMATION SIGNING" FOR ADDITIONAL INFORMATION.
- 6. ONE SIGN ASSEMBLY EQUALS 25.70 SQ. FT. (2.3 SQ. M.)
- 7. SHALL BE PAID FOR AS TEMPORARY INFORMATION SIGNING.

ALL DIMENSIONS ARE IN INCHES (MILLIMETERS) UNLESS OTHERWISE SHOWN.

| FILE NAME = | USER NAME = gaglianobt | DESIGNED - | REVISED - R. MIRS 09-15-97 | | ARTERIAL ROAD | FAU SECTION | COUNTY TOTAL SHEET |
|---------------------------|----------------------------|------------|--------------------------------|------------------------------|--|-------------------------------------|--------------------|
| W:\diststd\22x34\tc22.dgn | | DRAWN - | REVISED - R. MIRS 12-11-97 | STATE OF ILLINOIS | | 2638 17-00158-00-RS | DuPAGE 25 25 |
| | PLOT SCALE = 50.000 '/ IN. | CHECKED - | REVISED -T. RAMMACHER 02-02-99 | DEPARTMENT OF TRANSPORTATION | INFORMATION SIGN | TC-22 | CONTRACT NO. 61E93 |
| | PLOT DATE = 1/4/2008 | DATE - | REVISED - C. JUCIUS 01-31-07 | | SCALE: NONE SHEET NO. 1 OF 1 SHEETS STA. TO STA. | FED. ROAD DIST. NO. 1 ILLINOIS FED. | |