



LEGEND:

- PROPOSED MANHOLE
- PROPOSED CATCH BASIN
- PROPOSED STORM SEWER
- ▶ PROPOSED FLARED END SECTION
- EXISTING MANHOLE
- EXISTING CATCH BASIN
- EXISTING INLET
- ▶ EXISTING FLARED END SECTION
- EXISTING STORM SEWER
- EXISTING PIPE CULVERT

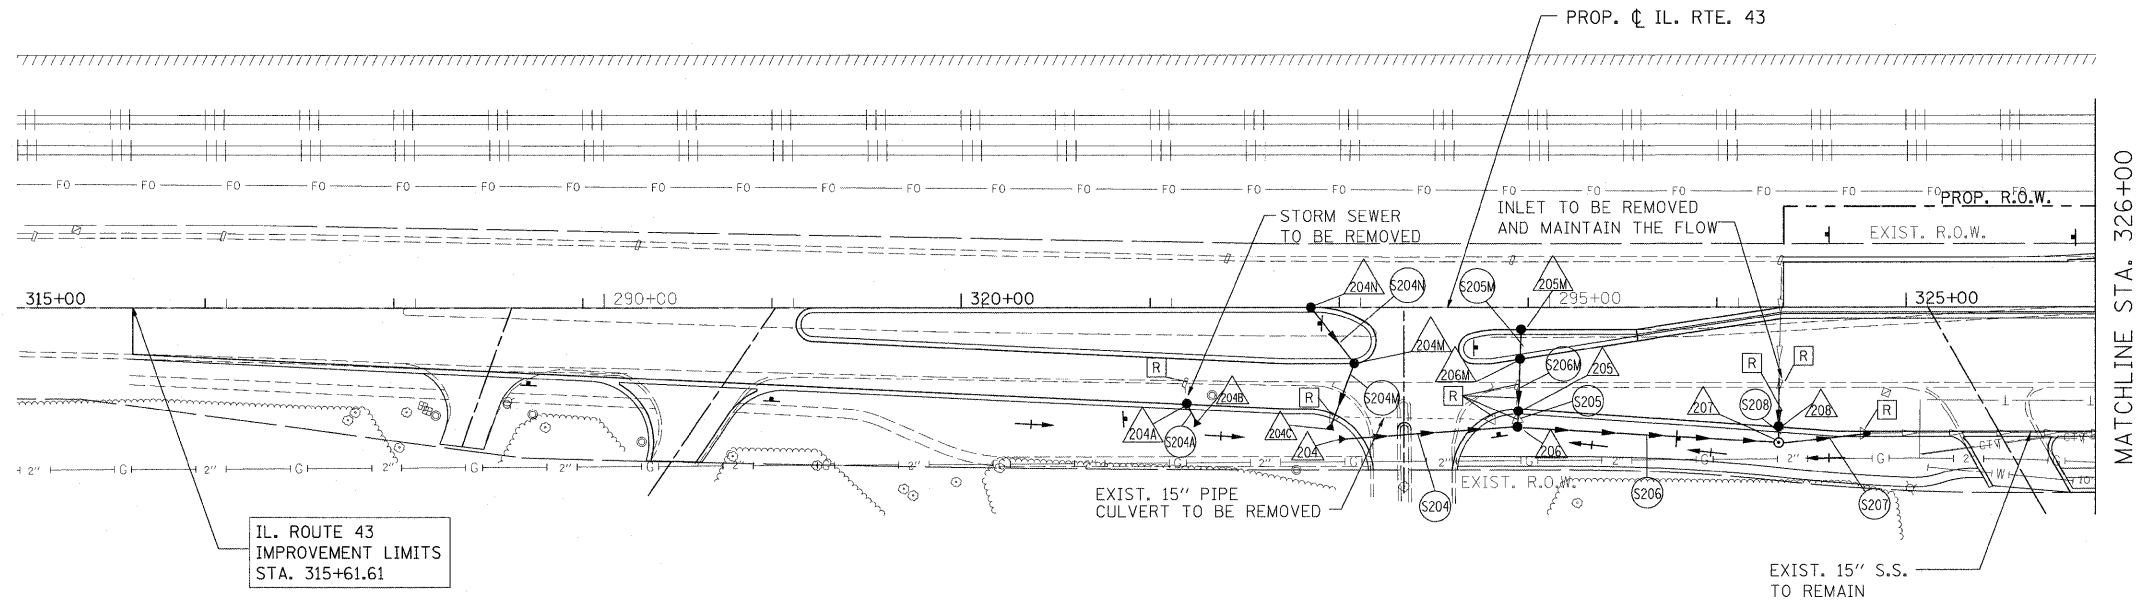

- ▲ PROPOSED STORM STRUCTURE
- PROPOSED STORM SEWER
- [R] EXISTING STRUCTURE TO BE REMOVED
- [AB] EXISTING STORM SEWER TO BE ABANDONED
- [ADJ] EXISTING STRUCTURE TO BE ADJUSTED
- [C] EXISTING STRUCTURE TO BE CLEANED

NOTE:
STORM WATER STRUCTURE OFFSET LOCATIONS GIVEN ON THE DETAILED PLANS ARE TO THE FOLLOWING POINTS: A) FOR STRUCTURES FALLING IN THE CURB LINE - TO THE EDGE OF PAVEMENT; B) FOR ALL OTHER STRUCTURE LOCATIONS - TO THE CENTER OF THE STRUCTURE.

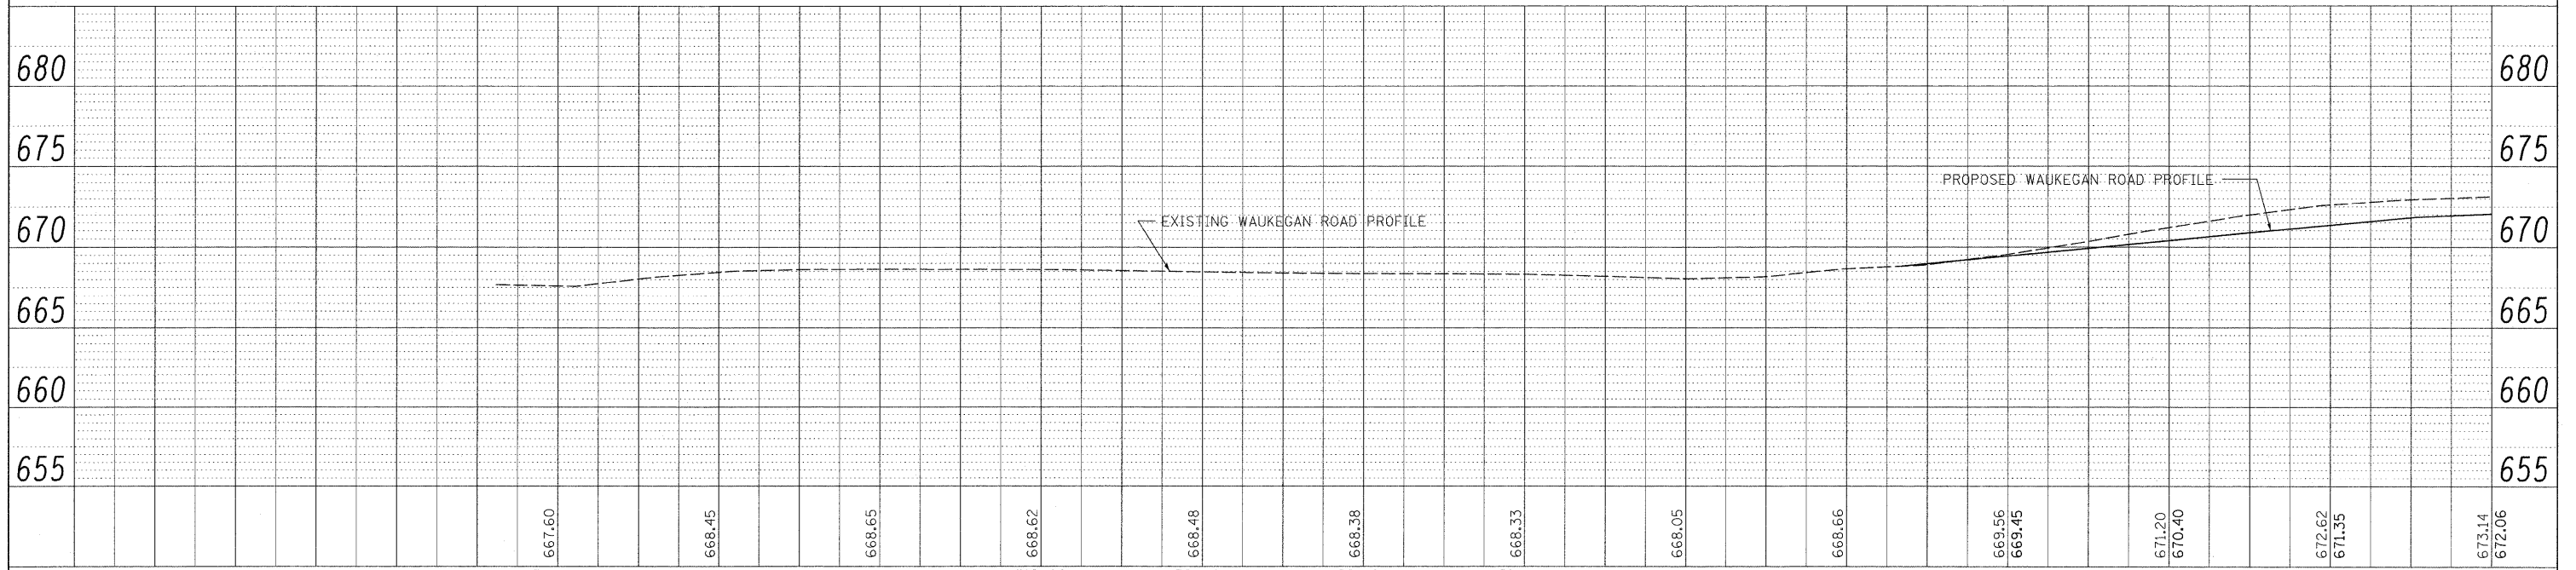

PLAN	SUBMITTED	DATE
NOTE BOOK	PLOTTED	BY
NO.	REVISIONS CHECKED	
	REVISIONS CHECKED	
	CADD FILE NAME	

PROFILE	SUBMITTED	DATE
NOTE BOOK	PLOTTED	BY
NO.	REVISIONS CHECKED	
	REVISIONS CHECKED	
	STRUCTURE NOTATIONS CHRD	

FILE NAME = W:\ILRTE22\2009 REVISIONS\CADD Sheets\DI	USER NAME = #USER# 00860-shr-drain-wauk.dgn	DESIGNED - LP	REVISIONS -	STATE OF ILLINOIS DEPARTMENT OF TRANSPORTATION				WAUKEGAN ROAD DRAINAGE PLAN AND PROFILE				F.A.P. RTE. 337	SECTION 20R-4	COUNTY LAKE	TOTAL SHEETS 232	SHEET NO. 102					
PLOT SCALE = #SCALE#	CHECKED - JP	REVISIONS -	SCALE: 1"=50'									SHEET NO. 102 OF 232 SHEETS		STA. 315+61.61 TO STA. 326+00.00		CONTRACT NO. 60860					
PLOT DATE = 5/15/2010	DATE - 05/14/2010	REVISIONS -	ILLINOIS FED. AID PROJECT																		