



- NOTES:
1. "STONE OUTLET STRUCTURE SEDIMENT TRAP" SHALL BE SIZED FOR 1/2 ACRE STORAGE. SEE DETAIL SHEET ED1 FOR DETAILS.
 2. PERIMETER EROSION BARRIER HAS BEEN OFFSET FOR CLARITY.

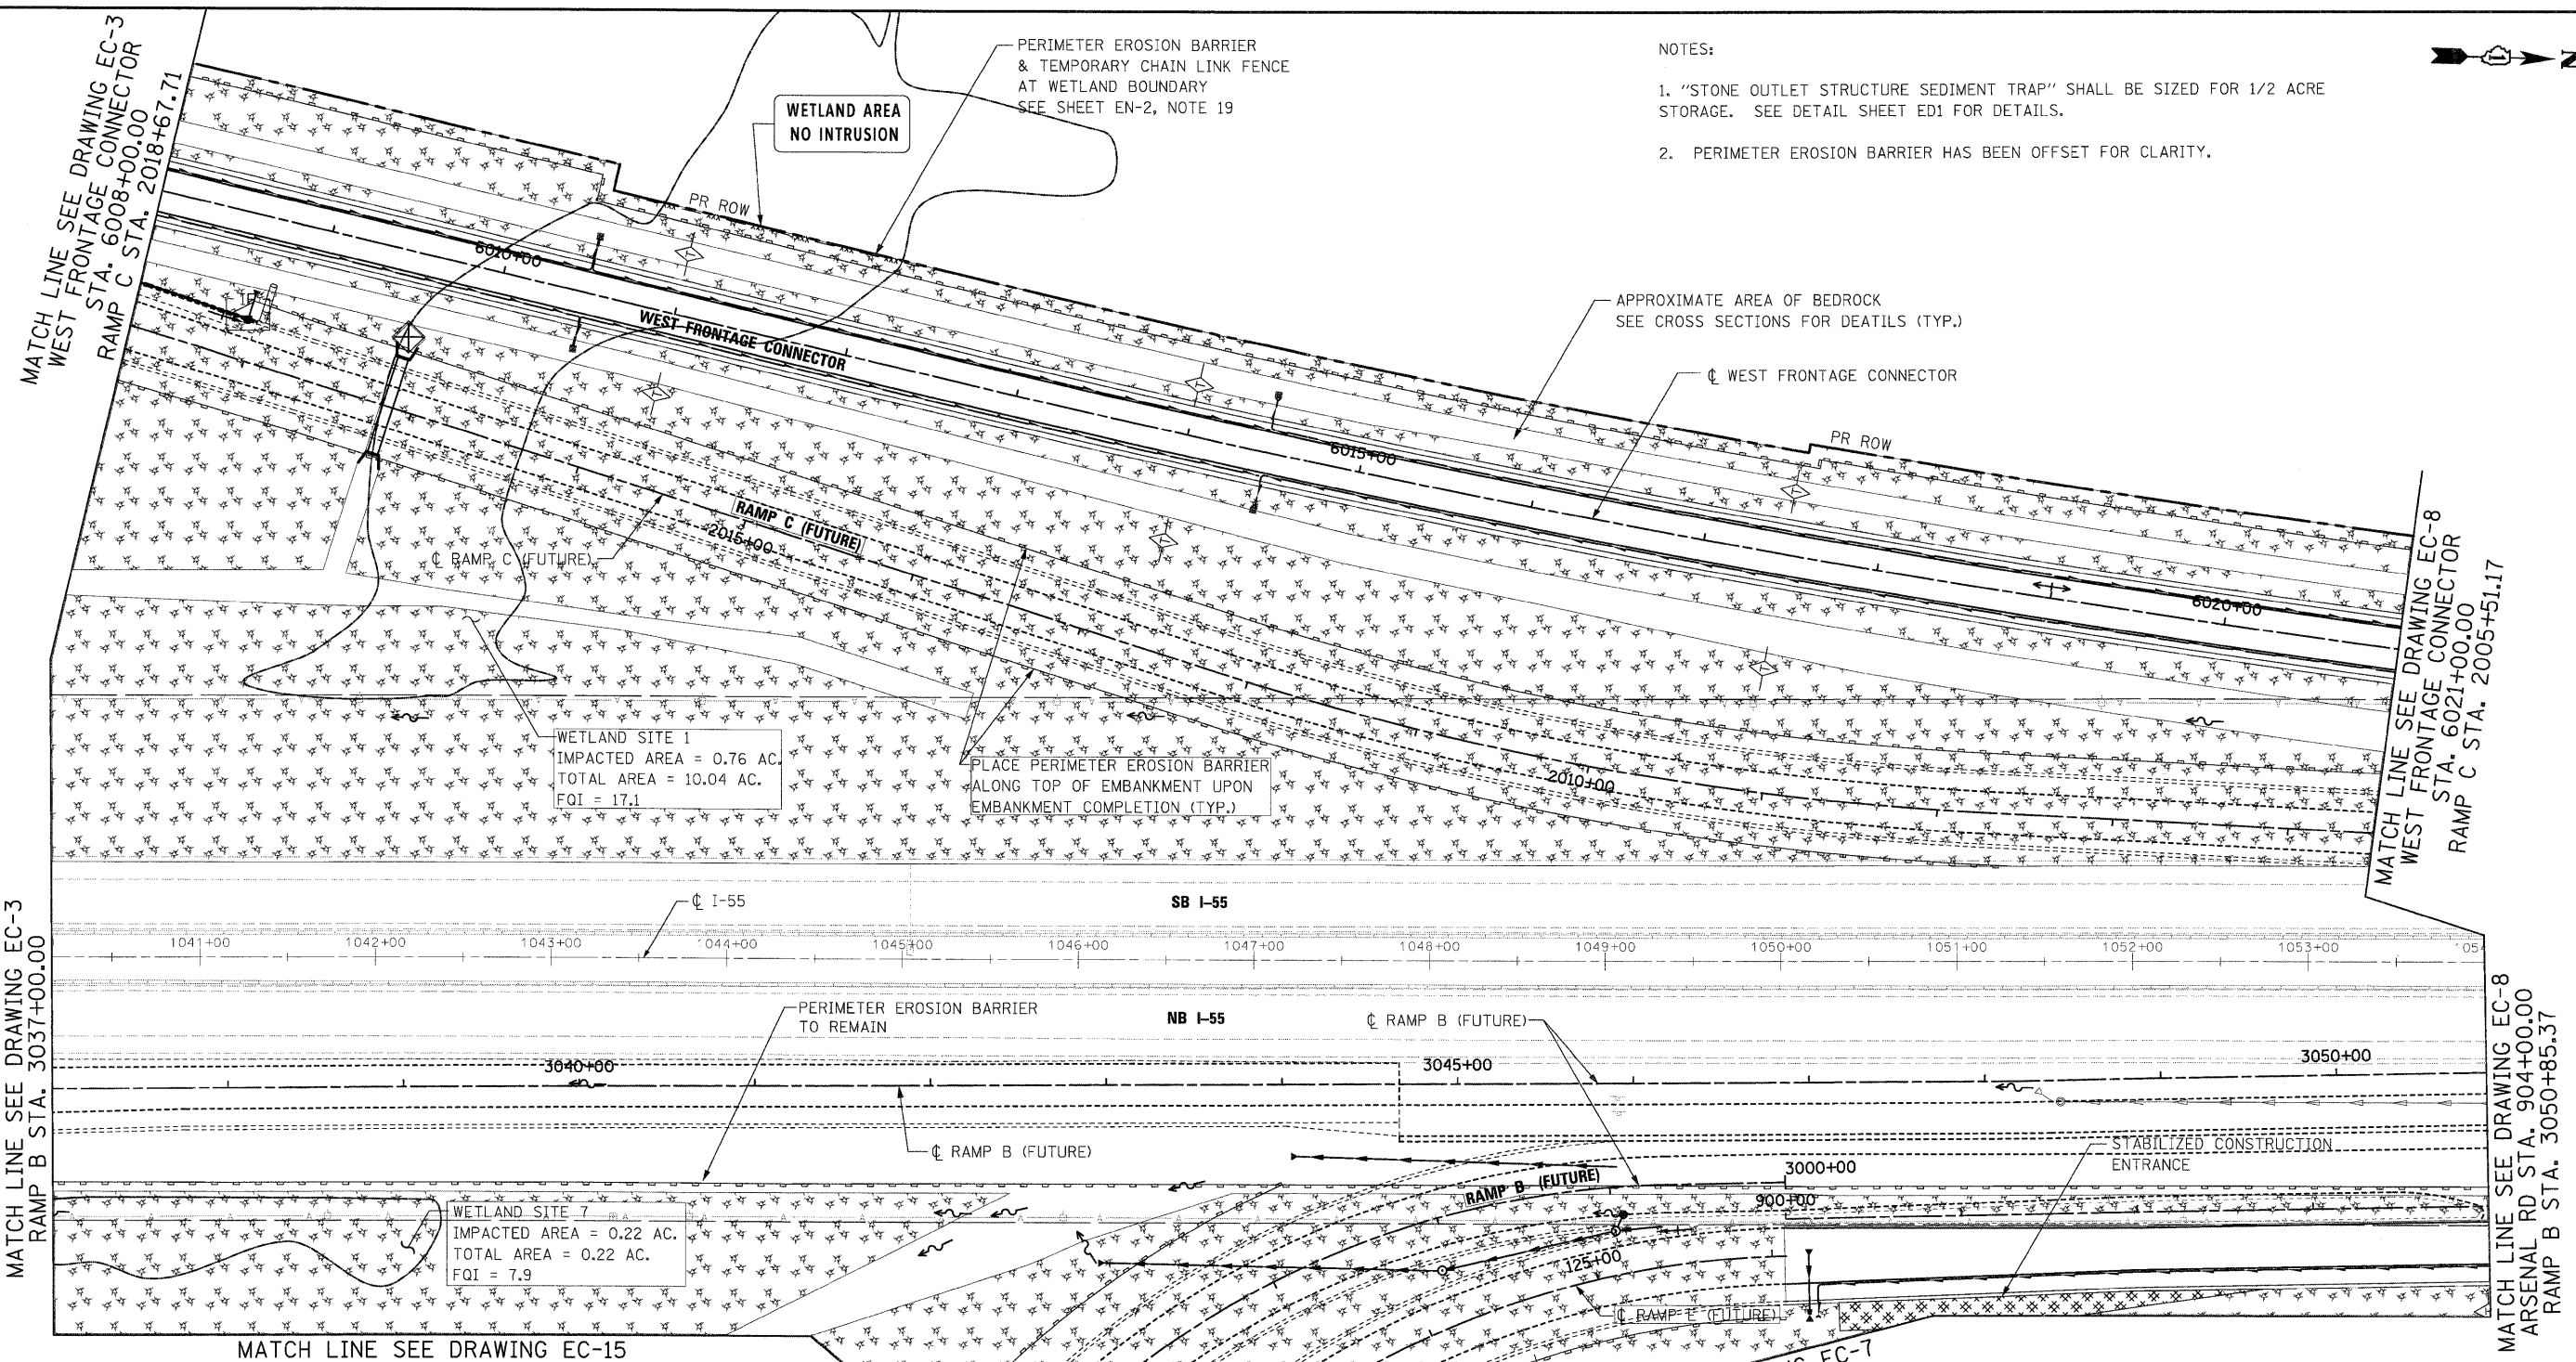

- EROSION CONTROL LEGEND
- INLET AND PIPE PROTECTION
 - TEMPORARY DITCH CHECK
 - PERIMETER EROSION BARRIER
 - TEMPORARY EROSION CONTROL SEEDING WITH MULCH METHOD 2
 - TEMPORARY CHAIN LINK FENCE
 - EC, TEMPORARY PIPE SLOPE DRAIN
 - IF INLET FILTER
 - STABILIZED CONSTRUCTION ENTRANCE
 - STONE OUTLET STRUCTURE SEDIMENT TRAP
 - DITCH FLOW
 - SWALE
 - DRAINAGE SUMMIT

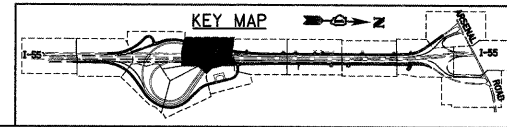

McDonough Associates Inc.
Engineers / Architects
130 East Randolph Street, Chicago, Illinois 60601

FILE NAME = D160C31-SHT-EROS15.dgn	USER NAME = TKLuegel	DESIGNED - JCL	REVISED -
PLOT SCALE = 1"=50'		DRAWN - JCL	REVISED -
PLOT DATE = 12/11/2009		CHECKED - DLT	REVISED -
		DATE - 12/18/09	REVISED -

STATE OF ILLINOIS
DEPARTMENT OF TRANSPORTATION

EROSION AND SEDIMENT CONTROL PLAN

SCALE: 1"=50' SHEET NO. 5 OF 15 SHEETS STA. TO STA.

F.A.I. RTE.	SECTION	COUNTY	TOTAL SHEETS	SHEET NO.
55	(99-1&2)AC-3	WILL	524	132
FED. ROAD DIST. NO. 1 ILLINOIS FED. AID PROJECT				CONTRACT NO. 60C31

FINAL