


DATE \_\_\_\_\_ BY \_\_\_\_\_  
 PLAN SURVEYED \_\_\_\_\_  
 PLOTTED \_\_\_\_\_  
 NOTE BOOK \_\_\_\_\_  
 NO. \_\_\_\_\_  
 CHECKED \_\_\_\_\_  
 DATE \_\_\_\_\_  
 FILE NAME \_\_\_\_\_

DATE \_\_\_\_\_ BY \_\_\_\_\_  
 PLAN SURVEYED \_\_\_\_\_  
 PLOTTED \_\_\_\_\_  
 NOTE BOOK \_\_\_\_\_  
 NO. \_\_\_\_\_  
 CHECKED \_\_\_\_\_  
 DATE \_\_\_\_\_  
 FILE NAME \_\_\_\_\_

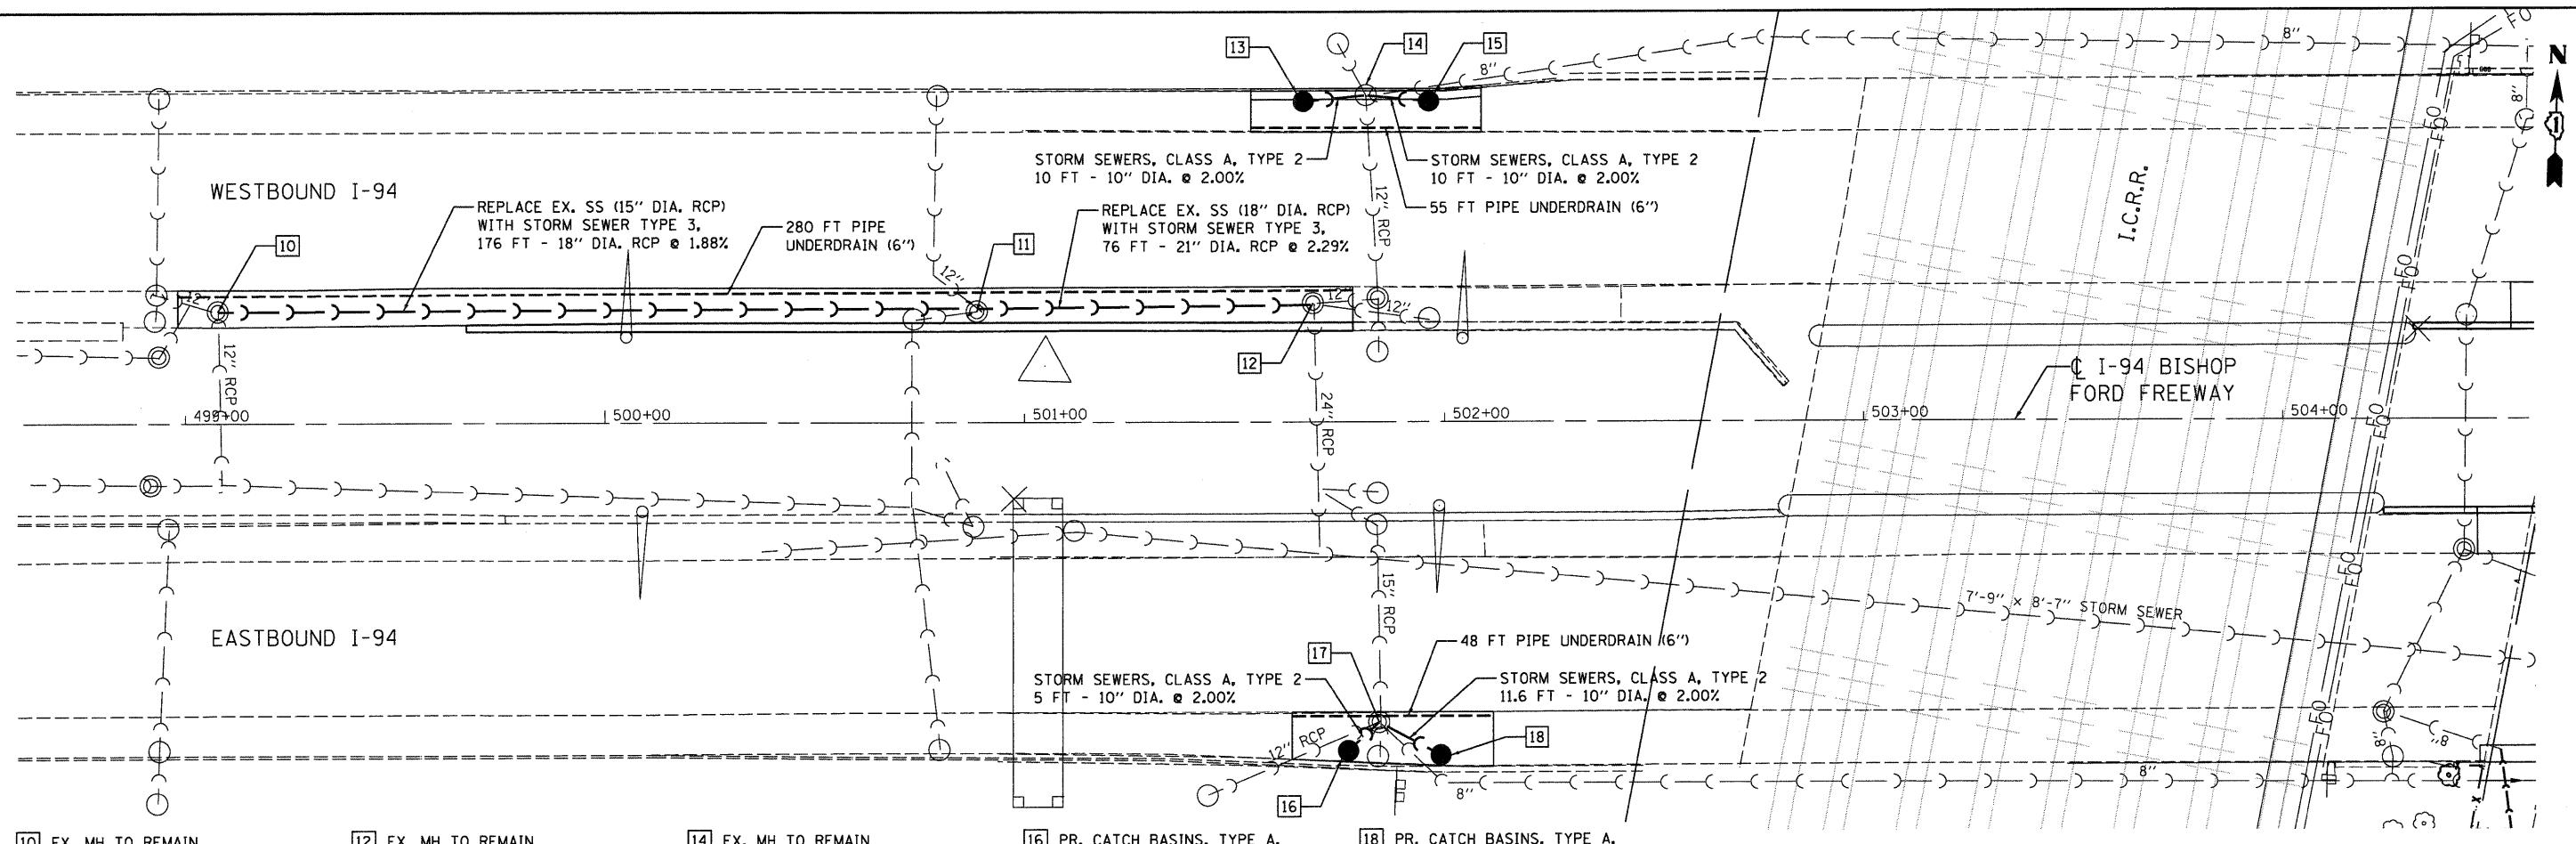

10 EX. MH TO REMAIN  
 STA 499+08.00, 26.4' LT  
 (CENTER OF FRAME & LID)  
 RIM ELEV = 572.71  
 E INV = 563.61

11 EX. MH TO REMAIN  
 STA 500+88.71, 26.2' LT  
 (CENTER OF FRAME & LID)  
 RIM ELEV = 570.19  
 W INV = 560.30  
 E INV = 560.29



12 EX. MH TO REMAIN  
 STA 501+68.77, 28.1' LT  
 (CENTER OF FRAME & LID)  
 RIM ELEV = 569.96  
 W INV = 558.56

13 PR. CATCH BASINS, TYPE A,  
 4'-DIA, TYPE 1 FRAME, OPEN LID  
 STA 501+66.46, 76.2' LT  
 (CENTER OF FRAME & LID)  
 RIM ELEV = 569.75  
 E INV = 564.10

14 EX. MH TO REMAIN  
 STA 501+81.39, 77.6' LT  
 (CENTER OF FRAME & LID)  
 RIM ELEV = 569.56  
 W INV = 563.90  
 E INV = 564.10

**NOTES:**

1. CONTRACTOR SHALL VERIFY LOCATION AND CHECK FIELD CONDITIONS OF EXISTING DRAINAGE STRUCTURES PRIOR TO CONSTRUCTION.
2. CONTRACTOR SHALL COORDINATE DRAINAGE IMPROVEMENTS WITH TRAFFIC CONTROL AT BRIDGE CONSTRUCTION.
3. USE TRENCH BACKFILL AT NEW SEWER LOCATIONS.

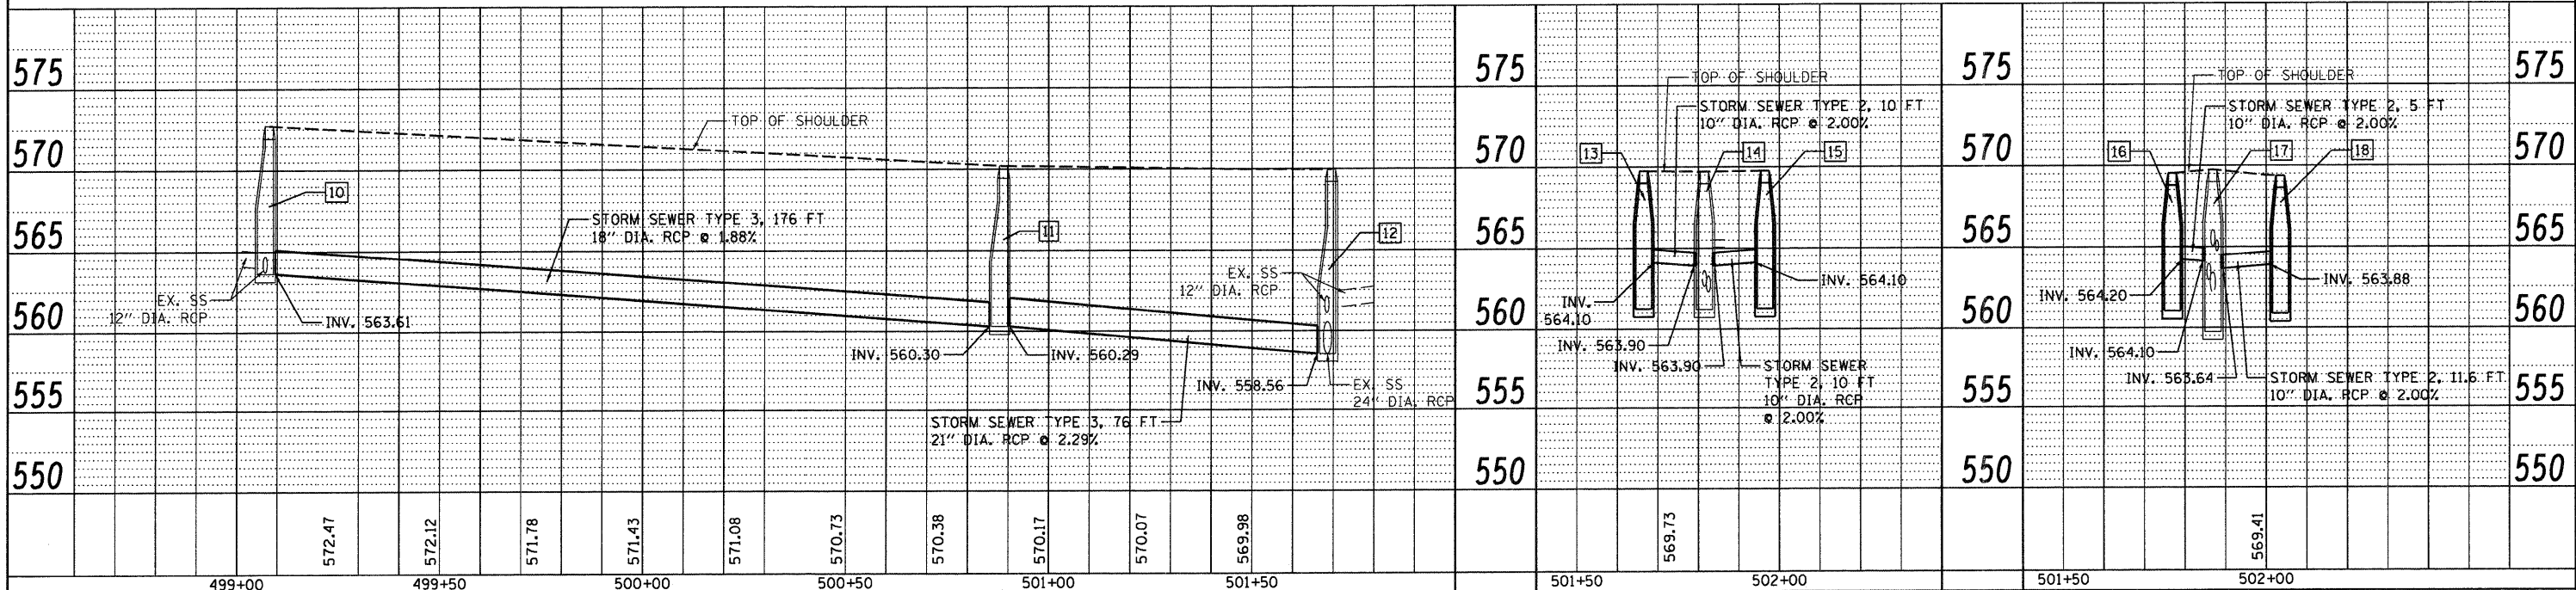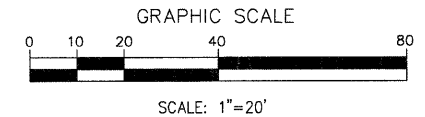

<b>FILE NAME</b> = ...NDI-60F65-shd21-dr2.dgn	<b>DESIGNED</b> - ITY	<b>REVISED</b> -		<b>STATE OF ILLINOIS</b> <b>DEPARTMENT OF TRANSPORTATION</b>	<b>DRAINAGE PLAN AND PROFILE</b> <b>I-94 BISHOP FORD FREEWAY</b>	F.A.I. RTE. 94	SECTION 1314B-1	COUNTY COOK	TOTAL SHEETS 110	SHEET NO. 21	
<b>PLOT TIME</b> = 12:42:31 PM	<b>CHECKED</b> - TRP	<b>REVISED</b> -	600 WEST FLORIAN STREET CHICAGO, ILLINOIS 60611-1229	TEL 312 454 9100 FAX 312 959 1217 WEB www.stateofillinois.com	SCALE: 1" = 50'	SHEET NO. 2 OF 2 SHEETS	STA. XXX+XX.XX TO STA. XXX+XX.XX	<b>CONTRACT NO. 60F65</b>			
<b>PLDT DATE</b> = 7/16/2010	<b>DATE</b> = 07/19/2010	<b>REVISED</b> -			ILLINOIS FED. AID PROJECT						