


**DEMOLITION LEGEND**



SIDEWALK REMOVAL

EXISTING CONDITIONS AND DEMOLITION

SCALE: 1" = 20'

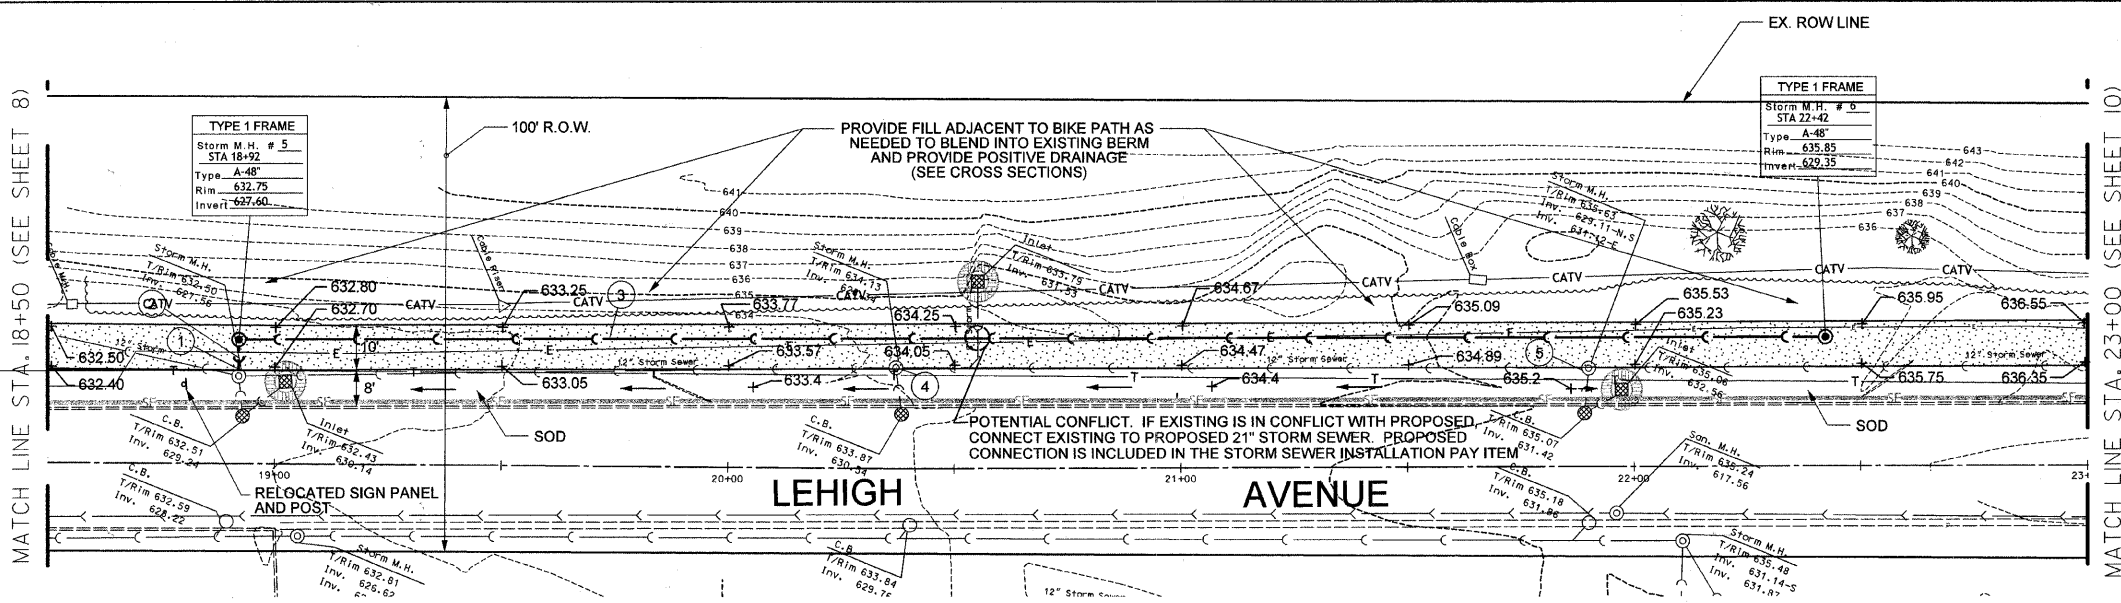

**PAVING LEGEND**



PORTLAND CEMENT CONCRETE, 6"



INLET FILTERS



SEDIMENT CONTROL, SILT FENCE




ABOVE GRADE INLET FILTER

NOTE: CONTRACTOR SHALL LOCATE EXISTING COMED AND OTHER UTILITIES PRIOR TO STORM SEWER INSTALLATION. UTILITY LOCATION AND IF NECESSARY STORM SEWER LOCATION CHANGE IS INCLUDED IN STORM SEWER INSTALLATION PAY ITEM

SITE ENGINEERING PLAN

SCALE: 1" = 20'

SCALE:  
HORIZONTAL: 1" = 20'  
VERTICAL: 1" = 2'

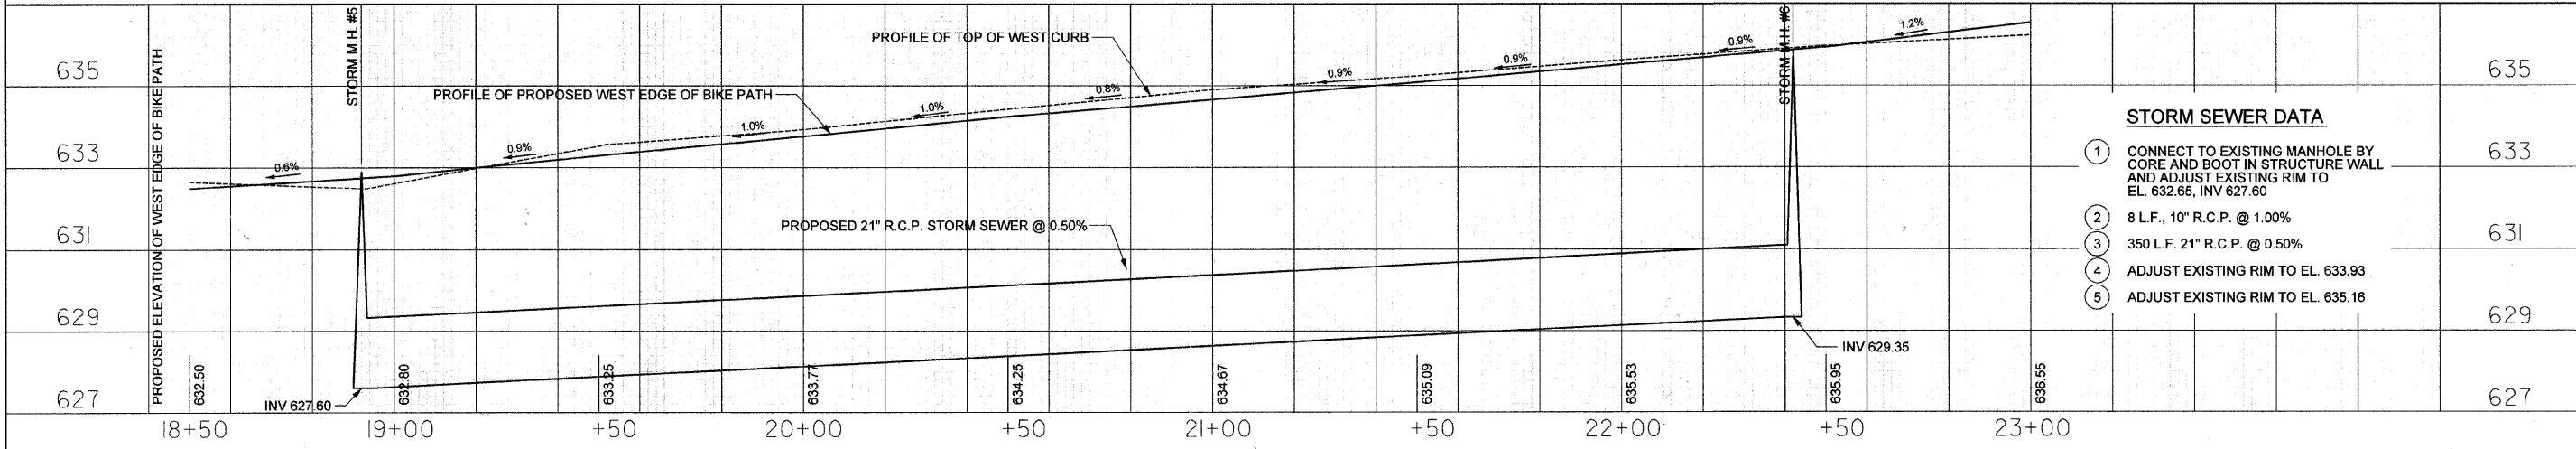

- STORM SEWER DATA**
- ① CONNECT TO EXISTING MANHOLE BY CORE AND BOOT IN STRUCTURE WALL AND ADJUST EXISTING RIM TO EL. 632.65, INV 627.60
  - ② 8 L.F., 10" R.C.P. @ 1.00%
  - ③ 350 L.F. 21" R.C.P. @ 0.50%
  - ④ ADJUST EXISTING RIM TO EL. 633.93
  - ⑤ ADJUST EXISTING RIM TO EL. 635.16

FILE NAME =	USER NAME = #USER#	DESIGNED RA	REVISED -
#FILE#		DRAWN SP	REVISED -
	PLOT SCALE = 1" = 20'	CHECKED RA	REVISED -
	PLOT DATE = 6/28/2010	DATE	REVISED -

STATE OF ILLINOIS  
DEPARTMENT OF TRANSPORTATION

PLAN AND PROFILE - STA. 18+50 TO 23+00  
TECHNY TRAIL - SEGMENT 3 BIKE PATH

SCALE: 1" = 20'    SHEET NO. 9 OF 17 SHEETS    STA. 18+50 TO STA. 23+00

F.A. RTE.	SECTION	COUNTY	TOTAL SHEETS	SHEET NO.
2766	08-00168-00-BT	COOK	18	9
GLENVIEW, ILLINOIS			CONTRACT NO. 63492	
ILLINOIS FED. AID PROJECT				