
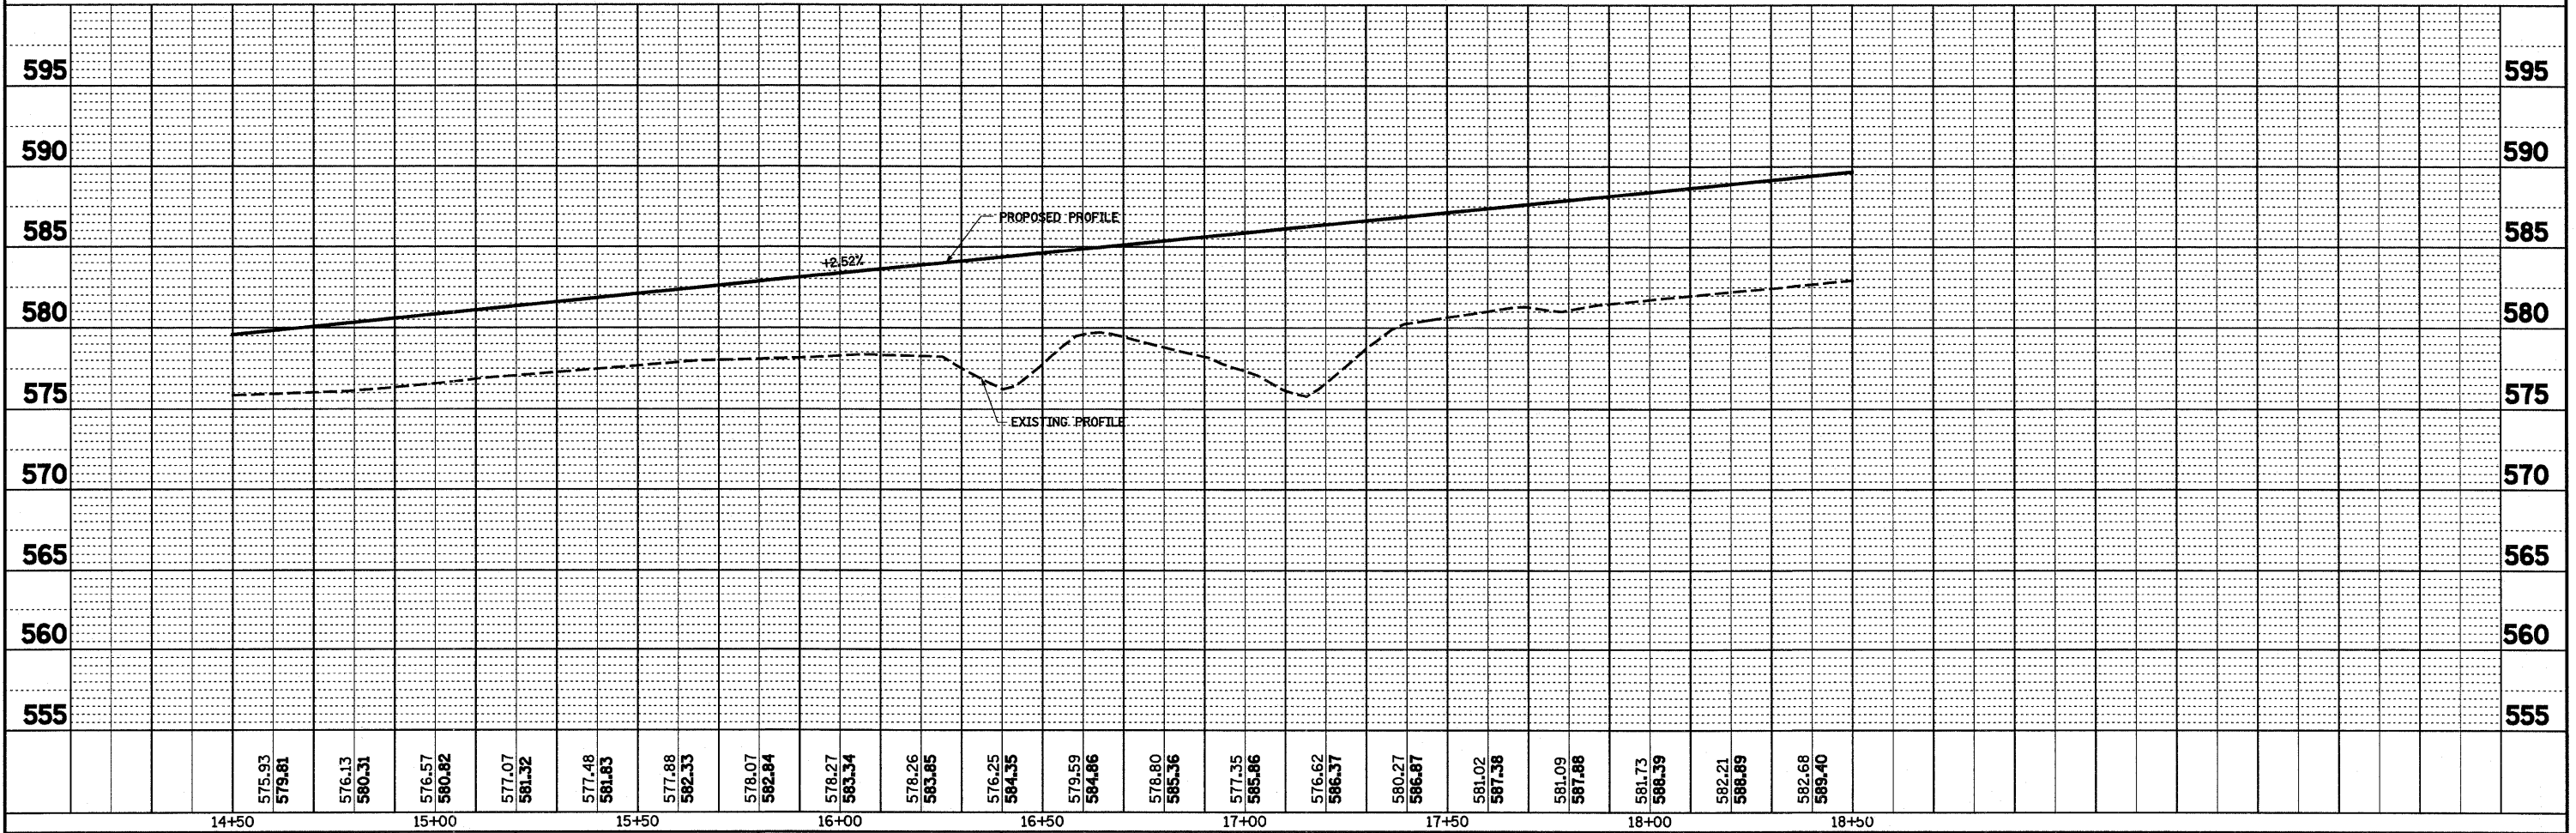
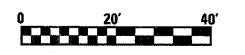
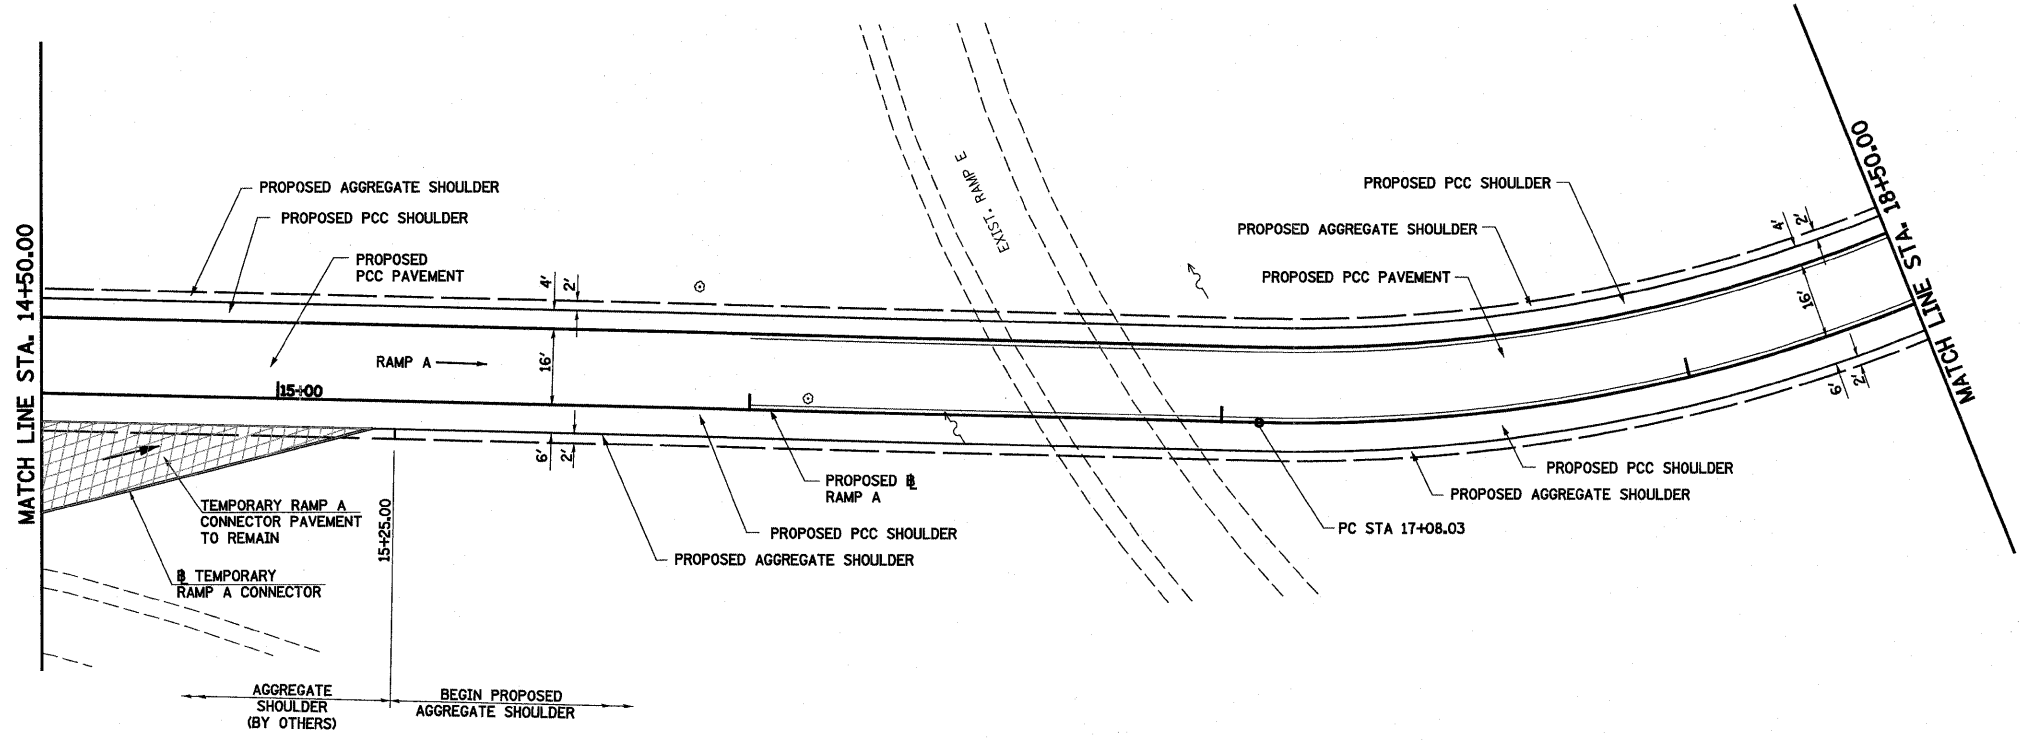


DATE	
BY	
REVIEWED	
PLANNED	
ALIGNED	
CHECKED	
NO. _____	
NOTE BOOK	
NO. _____	
FILE NAME	

DATE	
BY	
REVIEWED	
PLANNED	
GRADES	
CHECKED	
BLM. NOTED	
NO. _____	
NOTE BOOK	
NO. _____	
FILE NAME	

PROP. FAYETTE RAMP A
 CURVE C54
 PI STA. = 18+64.45
 $\Delta = 48^\circ 09' 41''$ (LT)
 $D = 16^\circ 22' 13''$
 $R = 350.00'$
 $T = 156.42'$
 $L = 294.20'$
 $E = 33.36'$
 $e = 7.90\%$
 $T.R. = 39'$
 $S.E. RUN = 205'$
 $P.C. STA. = 17+08.03$
 $P.T. STA. = 20+02.23$

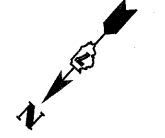

FILE NAME =	USER NAME = paul	DESIGNED - JWS	REVISED -	STATE OF ILLINOIS DEPARTMENT OF TRANSPORTATION	PLAN AND PROFILE, RAMP A, FAYETTE AVENUE	F.A.T. RTE.	SECTION	COUNTY	TOTAL SHEETS	SHEET NO.	
S:\Projects\403-00072-57-70\dgn\FayetteRampA.dgn		DRAWN - PDB	REVISED -			57/70	(25-3)I-6	EFFINGHAM	839	60	
PLOT SCALE = 48.0000' / IN.		CHECKED - BRM	REVISED -			SCALE: 1"=20'		SHEET NO. 3 OF 12 SHEETS		STA. 14+50.00 TO STA. 18+50.00	
PLOT DATE = 6/24/2010		DATE - 11-16-07	REVISED -			FED. ROAD DIST. NO.		ILLINOIS FED. AID PROJECT		CONTRACT NO. 74293	