
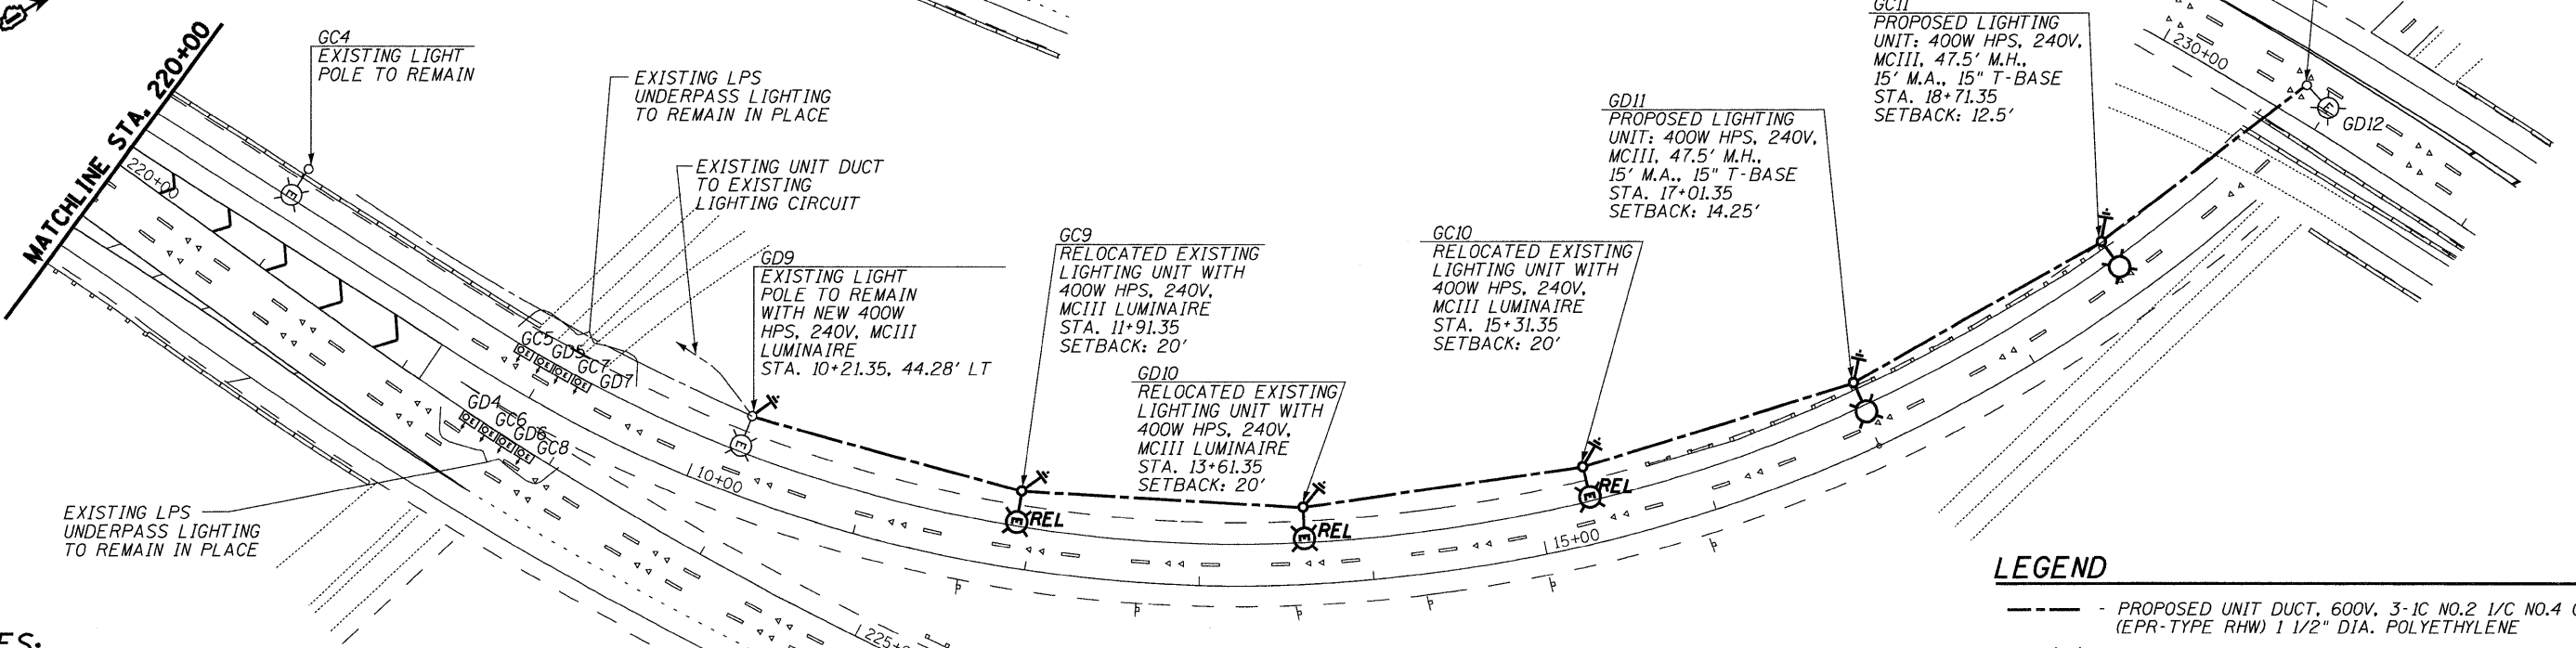


**EXISTING LIGHTING PLAN**

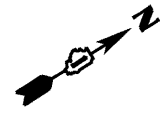


**PROPOSED RAMP LIGHTING PLAN**

**NOTES:**

1. NEW POLE LABELING WILL BE INCIDENTAL TO THE CONTRACT.
2. SETBACK IS MEASURED FROM THE EDGE OF TRAVELED PAVEMENT TO THE FACE OF TRANSFORMER BASE.
3. THE CONTRACTOR IS RESPONSIBLE FOR MAINTAINING EXISTING LIGHTING CIRCUITS UNTIL RAMP CONSTRUCTION IS COMPLETE AND INSTALLING PROPOSED LIGHTING UNITS AND CIRCUITS AFTER THE RAMP CONSTRUCTION IS COMPLETE.

**LEGEND**

- PROPOSED UNIT DUCT, 600V, 3-1C NO.2 1/2 NO.4 GROUND, (EPR-TYPE RHW) 1 1/2" DIA. POLYETHYLENE
- ⊙ - EXISTING LIGHTING UNIT
- ⊙ - PROPOSED LIGHTING UNIT
- ⊙ REL - RELOCATED EXISTING LIGHTING UNIT
- ⊕ - GROUND ROD, 5/8" x 10'

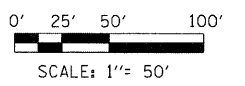

**LOCO, INC.**  
CONSULTING ENGINEERS  
1560 WALL ST, SUITE 222  
NAPERVILLE, ILLINOIS 60563 PH (630) 577-9100

USER NAME = #USER#	DESIGNED - MJY & ST	REVISED -
PLOT SCALE = #SCALE#	DRAWN - ST	REVISED -
PLOT DATE = #DATE#	CHECKED - WHE	REVISED -
	DATE - 07/08/2009	REVISED -

**STATE OF ILLINOIS  
DEPARTMENT OF TRANSPORTATION**

<b>EXISTING/PROPOSED LIGHTING PLAN</b>		
<b>I-80 RAMP (EASTBOUND TO NORTH BOUND I-57)</b>		
SCALE: 1"=50'	SHEET NO. 1 OF 4 SHEETS	STA. XX TO STA. XX

F.A.I. RTE.	SECTION	COUNTY	TOTAL SHEETS	SHEET NO.
80	(95-5-1, ETC, 1819-824) RS-2	WILL & COOK	80	36
C-91-145-09			CONTRACT NO. 60F61	
FED. ROAD DIST. NO.		ILLINOIS FED. AID PROJECT		