
## CONSTRUCTION SEQUENCING

- 1. ALL WORK SHALL BE PERFORMED IN THE DRY.
- 2. PRE-CONSTRUCTION MEETING WITH ENGINEER AND NCC SWCD IS REQUIRED.
- 3. CONTRACTOR SHALL INSTALL SILT FENCE AND REQUIRED COFFERDAM UPSTREAM AND DOWNSTREAM OF CULVERT IMPROVEMENTS. A CONTINGENCY PLAN OF INSTALLING SANDBAGS WRAPFED IN 30 MIL PLASTIC IS IN PLACE AND WILL BE INSTALLED IF THE PROPOSED COFFERDAMS WERE TO FAIL PER NCC SWCD.
- 4. CONTRACTOR SHALL PROVIDE NECESSARY BY—PASS PUMPING OF THE CREEK SO NOT TO INUNDATE THE WORK AREA, THE BY—PASS PLAN MUST BE APPROVED BY NCC SWCD PRIOR TO INITIAL OPERATION.
- 5. CONTRACTOR SHALL REMOVE AND DISPOSE OF EXISTING PIPE CULVERTS, HEADWALL, AND RAIL ROAD TIES.
- 6. CONTRACTOR SHALL INSTALL NEW 2'X9.5' BOX CULVERT AS SHOWN IN THE PLANS.
- 7. CONTRACTOR SHALL RESTORE AND STABILIZE THE EAST AND WEST BANK PRIOR TO REMOVAL OF THE COFFERDAMS.
- 8. SEE SHEETS 2 & 7 FOR ADDITIONAL SOIL EROSION CONTROL AND SEDIMENT CONTROL

## PROPOSED CONDITION PLAN NOTES

- The contractor is responsible for means and methods of dewatering devices. The contractor shall devise a method of dewatering excavations satisfactory to the Engineer.
- The contractor shall use a non-erodible cofferdam to prevent water from entering the excavation. The locations of the cofferdam shown are approximate.
- The contractor shall be prepared to remove the cofferdam from preventing stream flow in case a rain event occurs during construction. The contractor may, at his cost, use bypass pumping capable of handling the upstream flow.
- Subgrade soils shall be compacted to 95% standard practor density unless otherwise noted. Base course stone and trench backfill shall be compacted to 95% standard proctor density unless otherwise noted.
- 5. All proposed green areas are to have all debris removed and replaced with six inches of sandy topsoil, seed and erosion control blanket. Topsoil shall be furnished and placed by the contractor. All topsoil shall be pulverized, free of clods, stone, sticks, and debris.
- Roadways shall be kept clean of all debris and soils at all times. It is the contractor's responsibility to sweep and wash the road on a daily basis or more frequently as maybe necessary.
- 7. The contractor shall repair any pavement that has been domaged during construction. At the completion of the project, the contractor shall thoroughly clean the work area and any roadways leading to the work area with a street sweeper.
- 8. Disturbance to wetland shall be minimized. Restore all disturbed areas per Soil Erosion and Sediment Control Plan.
- 11. Contractor shall install bicycle railing according to plans and details. Steel posts painted brown shall be used on top of precast box. Steel posts shall be attached to top slab of precast box culvert according to case 4 of IDOT Highway Standard 630101-08.

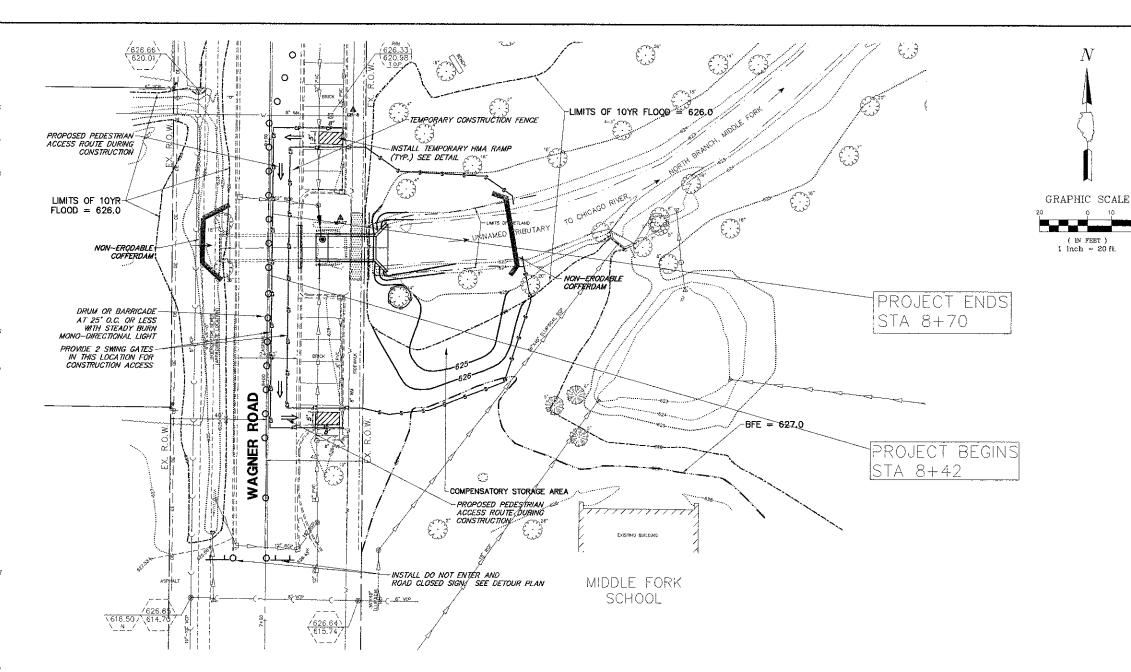

8'-4" PVC PIPE

HMA

TEMPORARY HMA RAMP DETAIL

| FILE NAME = 3509.213-Wagner-PR1.dwg | USER NAME = BRIAN WESOLOWSKI | DESIGNED - BVS DRAWN - BVS | REVISED ~ 6/29/12<br>REVISED - 7/25/12 | SUNSET RIDGE ROAD & WAGNER ROAD | PROPOSED CULVERT EXTENSION PLAN                | FAU SECTION                          | COUNTY TOTAL SHEET NO. |
|-------------------------------------|------------------------------|----------------------------|--|---------------------------------|--|--------------------------------------|------------------------|
|                                     | PLOT SCALE = 1" = .0833"     | CHECKED - LJD              | REVISED -                              | SECTION 10-00050-00-SW          |  | 2777   10-0050-00-SW   COOK   15   5 |                        |
|                                     | PLOT DATE == 4/30/2012       | DATE - 4/30/12             | REVISED -                              | VILLAGE OF NORTHFIELD, ILLINOIS | SCALE: 1"=20' SHEET NO. OF SHEETS STA. TO STA. | ILLINOIS (                           | FED. AID PROJECT       |