## INDEX OF SHEETS

SHEET DESCRIPTION

1 COVER SHEET

2 GENERAL NOTES & SUMMARY OF QUANTITIES


3-7 DYNAMIC MESSAGE SIGN DETAILS

8-16 COMM. CENTER UNINTERUPTIBLE POWER SUPPLY

## PROJECT LOCATED IN CITY OF CHICAGO

## **DESIGN DESIGNATION**

SOUTH OF 67TH STREET	ADT (2010)	DESIGN SPEED	POSTED SPEED
I-94 (DAN RYAN)	266,800	60 MPH	55 MPH
I-94 (BISHOP FORD)	123,400	60 MPH	55 MPH
I–57	107,600	60 MPH	55 MPH
RAMPS	(VARIES)	40 MPH	35 MPH
NORTH OF 67TH STREET	ADT (2010)	DESIGN SPEED	POSTED SPEED
I-90/1-94 NB LOCAL LANES	53,270	60 MPH	45 MPH
I-901-94 SB LOCAL LANES	47,185	60 MPH	45 MPH
RAMPS	(VARIES)	40 MPH	30 MPH

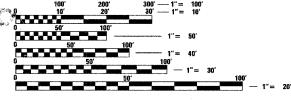

FULL SIZE PLANS HAVE BEEN PREPARED USING STANDARD ENGINEERING SCALES. REDUCED SIZED PLANS WILL NOT CONFORM TO STANDARD SCALES. IN MAKING MEASUREMENTS ON REDUCED PLANS, THE ABOVE SCALES MAY BE USED.

DIGGE


CHICAGO UTILITY ALERT NETWORK (312) 744-7000


**CONTRACT NO. 62947** 

## STATE OF ILLINOIS DEPARTMENT OF TRANSPORTATION DIVISION OF HIGHWAYS

# PLANS FOR PROPOSED FEDERAL AID HIGHWAY

F.A.I. ROUTE 94/90 (DAN RYAN EXPRESSWAY) (NB)
SECTION 2005–020I
PROJECT: IM-094-3(399) 055
31ST STREET TO I–57 INTERCHANGE
DYNAMIC MESSAGE SIGN PROCUREMENT
COOK COUNTY
C-91-192-05

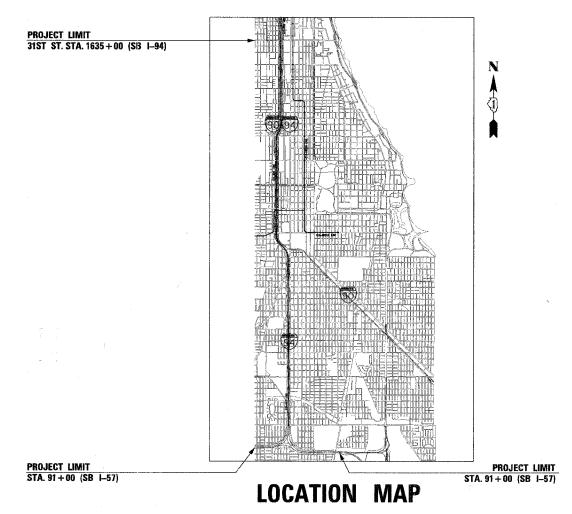

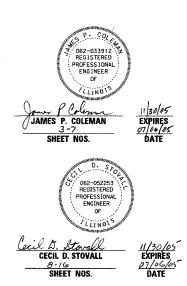


# AD DAVIESS STEVENSON WINNESSACO BOOME MC NENTY LAKE CAMPOLL OGLE RESEAL RE

SECTION

D-91-419-01

90/94 2005-0201

COUNTY

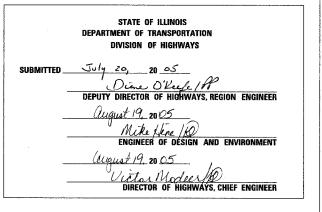

LOCATION OF SECTION INDICATED THUS:-

PRINTED BY THE AUTHORITY OF THE STATE OF ILLINOIS

CTE AECOM

SCALE 0.84" = 1 MILE

GROSS LENGTH OF PROJECT = 52,800 FET (10 MILES)

NET LENGTH OF PROJECT = 52,800 FT (10 MILES)

## GENERAL NOTES

1. THE DEPARTMENT CONTACT PERSONS FOR THIS CONTRACT ARE MARTIN ANDERSON, BUREAU CHIEF OF ELECTRICAL OPERATIONS, 847-705-4351 AND JEFF GALAS, TRAFFIC SYSTEMS CENTER MANAGER, 708-524-2145, THE CONTRACTOR MUST COORDINATE AND COOPERATE WITH THE DEPARTMENT AND THE INVOLVED PARTIES AS DIRECTED BY THE DEPARTMENT.

2. CRITICAL PATCH WORK SCHEDULE REQUIREMENT

THE CONTRACTOR WILL SUBMIT TO THE ENGINEER A SATISFACTORY PROGRESS SCHEDULE AND CRITICAL PATH SCHEDULE WHICH SHOW THE PROPOSED SEQUENCE OF WORK AT THE TIME OF PRE-CONSTRUCTION CONFERENCE.

3. THE ENGINEERING DESIGN IN THESE PLANS IS BASED UPON FIELD INVESTIGATIONS OF CURRENT CONDITIONS, REVIEW OF EXISTING AS-BUILT DOCUMENTATION, AND INFORMATION OBTAINED FROM PRELIMINARY DESIGN DOCUMENTS FOR THE RECONSTRUCTION PROJECT. DUE TO THE CHANGING NATURE OF THESE ITEMS, THE ACTUAL CONDITIONS MAY BE DIFFERENT THAN THOSE DEPICTED. THE CONTRACTOR SHALL VERIFY THE EXISTING FIELD CONDITIONS PRIOR TO ANY CONSTRUCTION ACTIVITIES AND CORRELATE THESE CONDITIONS WITH THE PROPOSED CONSTRUCTION ACTIVITIES OF THIS AND OTHER CONTRACTS. THE CONTRACTOR SHALL IDENTIFY TO THE ENGINEER ANY SIGNIFICANT DIFFERENCES BETWEEN THESE PLANS AND THE EXISTING FIELD CONDITIONS OR PROPOSED CONSTRUCTION THAT COULD IMPACT HIS EFFORTS PRIOR TO BEGINNING WORK. CORRECTIVE ACTIONS FOR PROBLEMS ENCOUNTERED AFTER THE CONTRACTOR HAS BEGUN WORK WILL BE INCLUDED IN THE TASK UNLESS PREVIOUSLY IDENTIFIED TO THE ENGINEER.

4. THE CONTRACTOR SHALL BE REQUIRED TO PAY, ON BEHALF OF IDOT, ANY UTILITY FEES FOR ELECTRICAL OR TELEPHONE SERVICE INCLUDING SET-UP DELIVERY COSTS NECESSARY TO EXTEND THE UTILITY POWER OR TELEPHONE TO THE SURVEILLANCE/COMMUNICATIONS EQUIPMENT LOCATIONS IN ACCORDANCE WITH ARTICLE 109.05 OF THE STANDARD SPECIFICATIONS.

5. ALL ELECTRICAL WORK SHALL CONFORM TO THE NATIONAL ELECTRIC CODE (NEC).

6. THE CONTRACTOR SHALL SUBMIT SHOP DRAWINGS, CONSTRUCTION METHODOLOGIES, PRODUCT MANUFACTURER SPECIFICATIONS, OWNERS MANUALS, AND USERS MANUALS BEFORE PROCURING AND INSTALLING ANY SURVEILLANCE/COMMUNICATIONS EQUIPMENT AS PART OF THIS CONTRACT. ALL PROPOSED SURVEILLANCE/COMMUNICATIONS WORK SHALL BE REVIEWED AND APPROVED BY THE DEPARTMENT IN CONSULTATION WITH THE DESIGN ENGINEER.

7. THE CONTRACTOR SHALL COORDINATE WITH THE DEPARTMENT ALL WORK TO BE CONDUCTED AT THE COMMUNICATIONS CENTER (201 WEST CENTER COURT, SCHAUMBURG). THE CONTRACTOR SHALL CONTACT THE DEPARTMENT 72 HOURS BEFORE COMMENCING ANY WORK AT THIS LOCATION.

SECT]ON		N	COUNTY	TOTAL SHEET SHEETS NO.	
	2005-02	101	COOK	16	2
STA.		TO	STA.		
FED. RO	AD DIST. NO.	ILLINOIS	FED. AID	PROJECT	
	62947				


URBAN 96% FED

				10% STATE			
SUMMARY OF QUANTITIES							
				SURVEILLANCE			
CODE NO.	ITEM DESCRIPTION	UNIT	QUANTITY	Y032-IF			
X0324831	UNINTERRUPTIBLE POWER SUPPLY UPGRADE	LSUM	1	1			
X0325097	CABINET, MODEL 334, DYNAMIC MESSAGE SIGN, MATERIAL ONLY	EACH	2	2			
X0325098	CABINET, MODEL 334, UNINTERRUPTIBLE POWER SYSTEM, MATERIAL	EACH	13	13			
X0325099	CNLY CABINET, MODEL 334 EQUIPMENT, DYNAMIC MESSAGE SIGN, MATERIAL ONLY	EACH	2	2			
X0325100	CABINET, MODEL 334 EQUIPMENT, UNINTERRUPTIBLE POWER SYSTEM,	EACH	13	13			
X0325101	MATERIAL ONLY LED DYNAMIC MESSAGE SIGN FULL MATRIX CONFIGURATION, MATERIAL ONLY	EACH	13	13			

GN-01

REVISIONS NAME DATE	ILLINOIS DEPARTMENT OF TRANSPORTATION F.A.I. 94/90 (DAN RYAN EXPRESSWAY) 31st STREET to I-57	
	GENERAL NOTES & OF QUANTIT	
	SCALE: NOT TO SCALE	DRAWN BY: MJL
	DATE: September 23, 2005	CHECKED BY: GFR




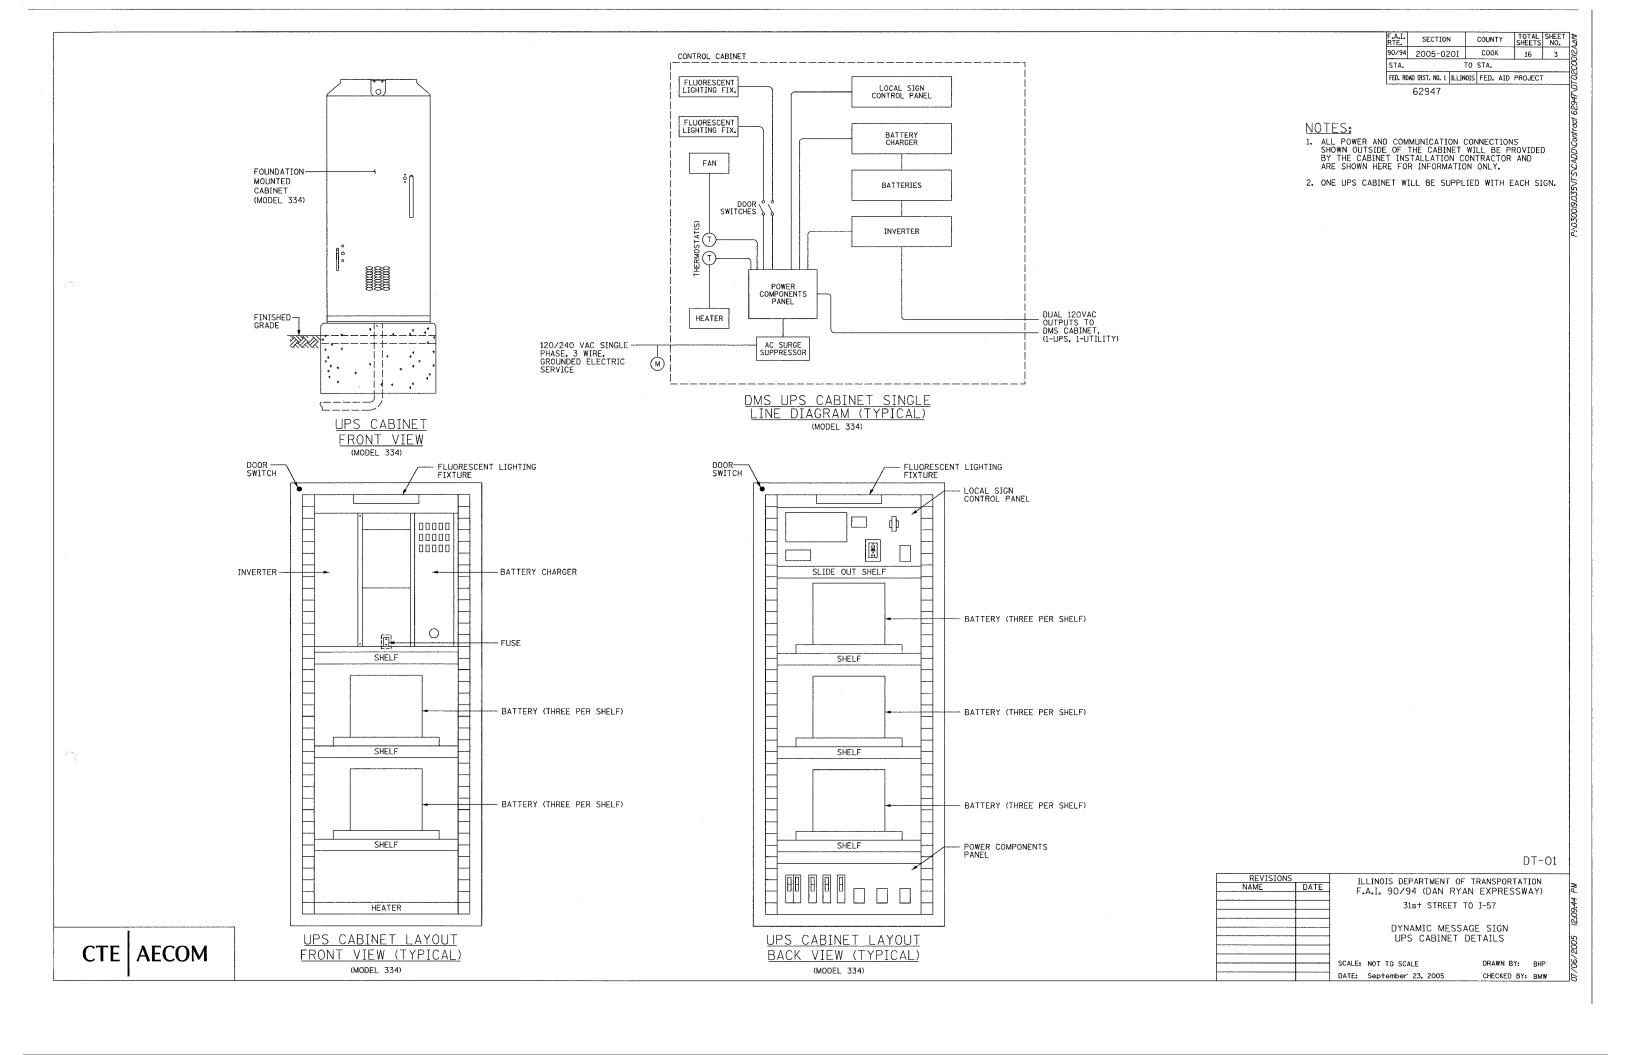

F.A.I. RTE.	SECTION	ı	COUNTY	TOTAL SHEETS	SHEET NO.
90/94	2005-02	102	соок	16	4
STA.		TO	STA.		
FED. R	OAD DIST, NO. 1	ILLINOIS	FED. AID	PROJECT	
	62947				


## NOTES:


- ALL POWER AND COMMUNICATION CONNECTIONS
   SHOWN OUTSIDE OF THE CABINET WILL BE PROVIDED
  BY THE CABINET INSTALLATION CONTRACTOR AND
  ARE SHOWN HERE FOR INFORMATION ONLY.
- 2. DMS CONTROLLER CABINETS WILL ONLY BE SUPPLIED WITH SIGNS DMS-A AND DMS-B.

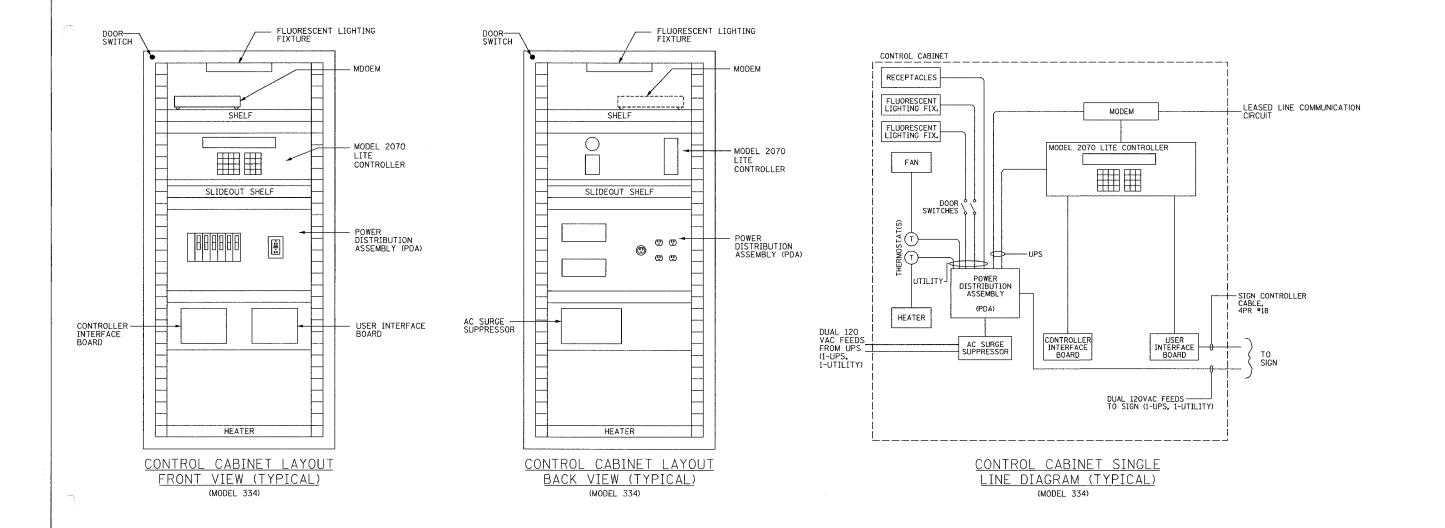


DT-02

REVISIONS	ILLINOIS DEPARTMENT OF TRANSPORTATION					
NAME DATE	F.A.I. 90/94 (DAN RYAN					
	I ALL JOY JA (DAN ICIAN	EVI I/E33W	(1)			
	31st STREET TO I-57					
	DYNAMIC MESSAGE SIGN					
	CONTROLLER CABINET	T DETAILS				
		. 04.//120				
	SCALE: NOT TO SCALE	DRAWN BY:	BHP			
	0.1777 0 1 1 00 0007					
	DATE: September 23, 2005	CHECKED BY:	BMW			

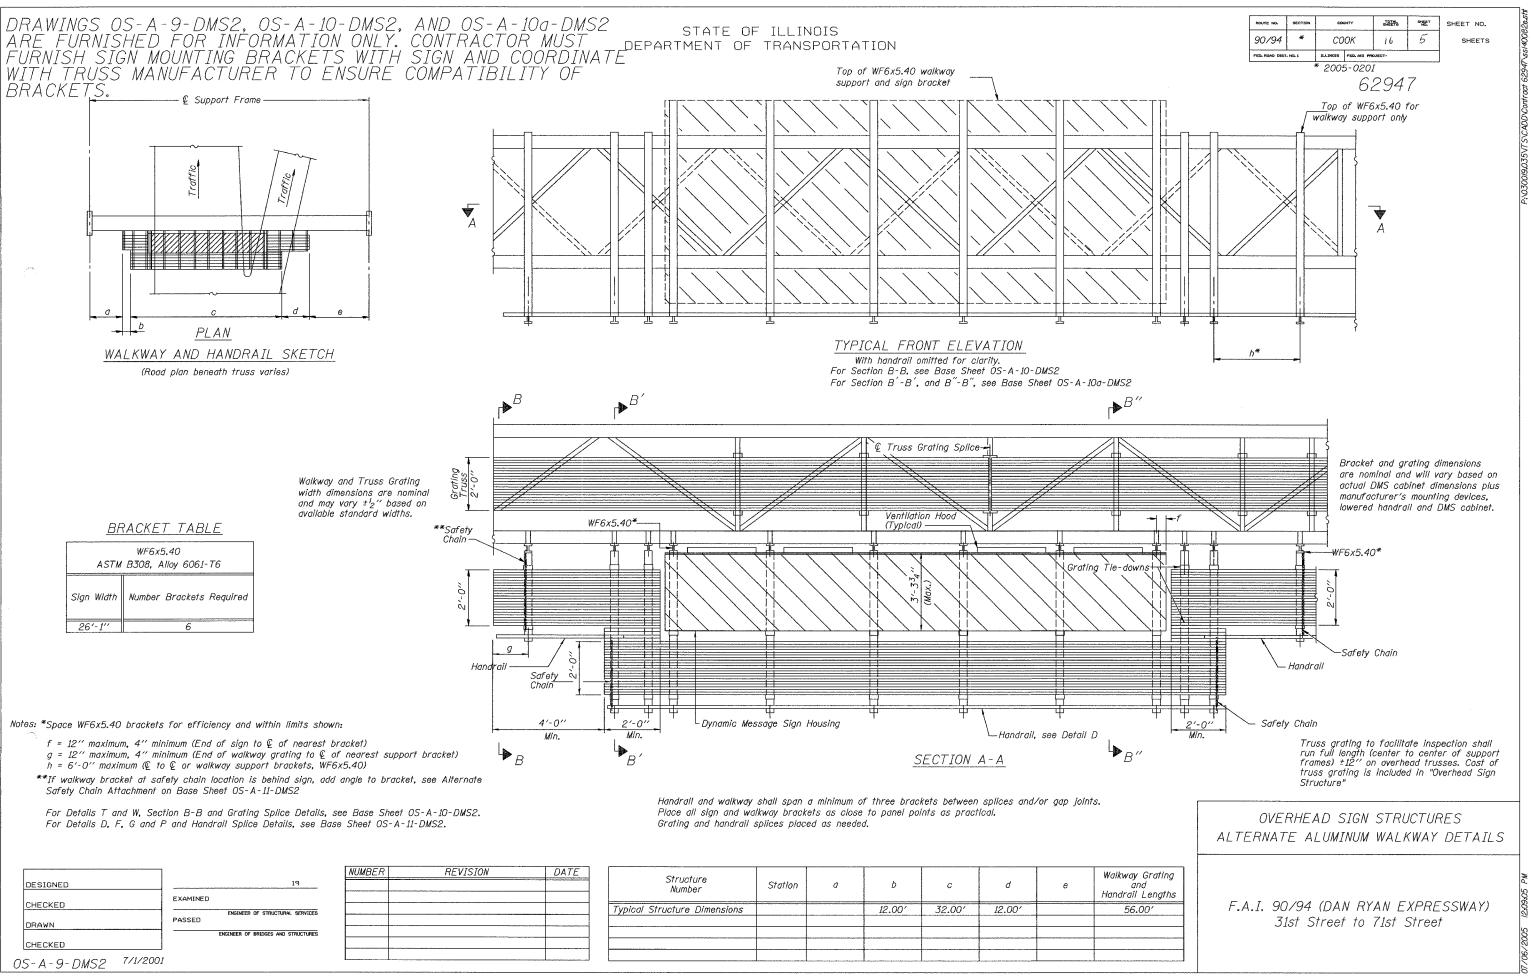


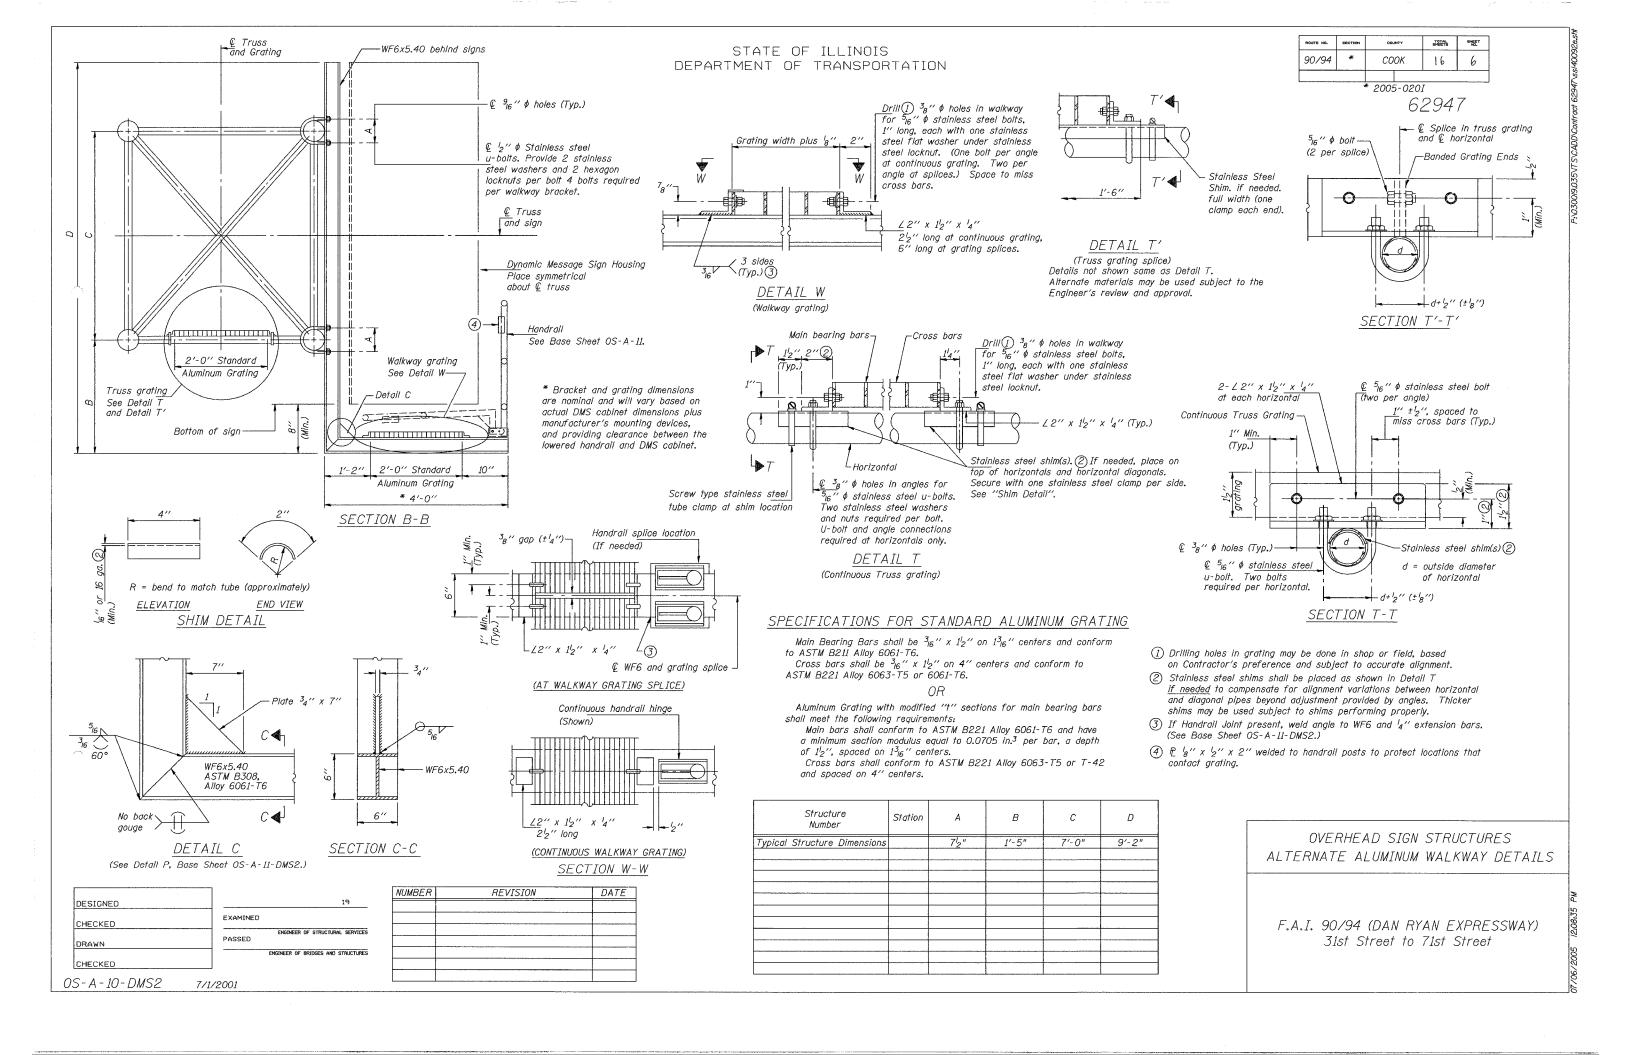

## STATE OF ILLINOIS DEPARTMENT OF TRANSPORTATION

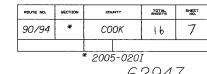



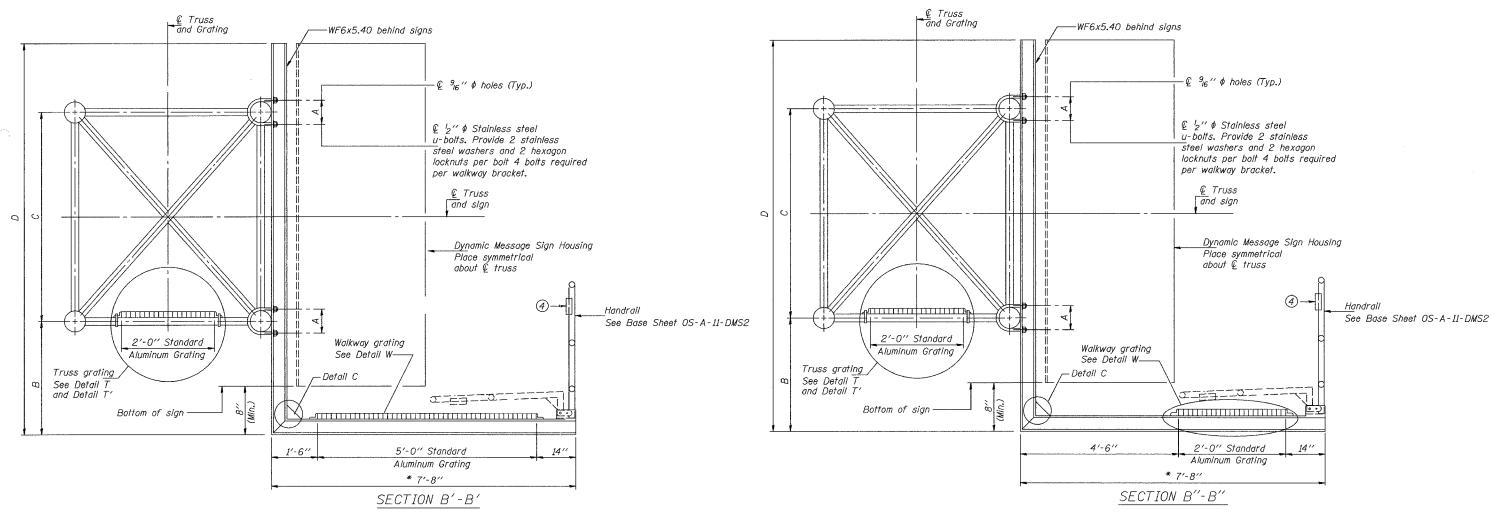

\* Bracket and grating dimensions are nominal and will vary based on actual DMS cabinet dimensions plus manufacturer's mounting devices, and providing clearance between the lowered handrall and DMS cabinet.

Note:

For dimentions "A" to "D" and remaining details. see sheet OS-A-10-DMS2

OVERHEAD SIGN STRUCTURES
ALTERNATE ALUMINUM WALKWAY DETAILS


F.A.I. 90/94 (DAN RYAN EXPRESSWAY)
31st Street to 71st Street

DESIGNED	19
CHECKED	EXAMINED
DRAWN	ENGINEER OF STRUCTURAL SERVICES PASSED
	ENGINEER OF BRIDGES AND STRUCTURES
CHECKED	

OS-A-10a-DMS2 7/1/2001

NUMBER	REVISION	DATE

## UPS SYSTEM LEGEND AND SYMBOLS

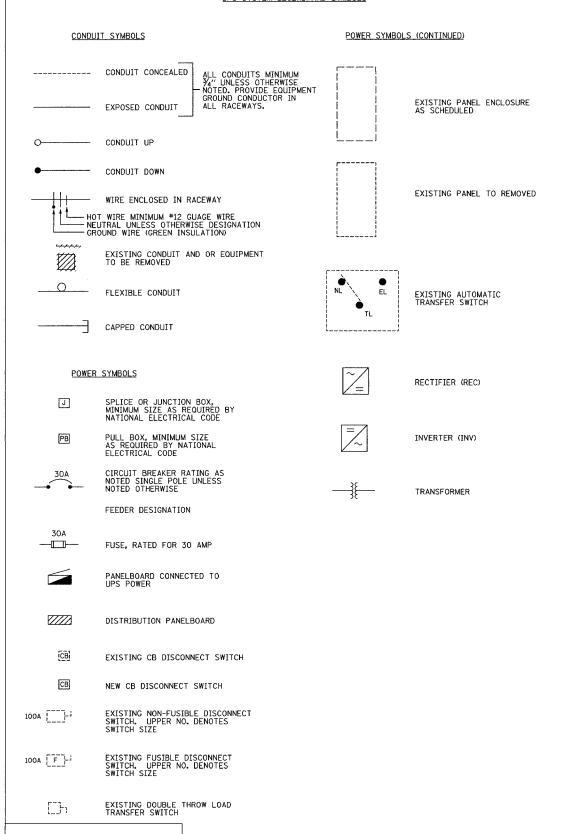

Edwards MKelcey

## ABBREVIATIONS

AC	ALTERNATING CURRENT
AFF AIC	ABOVE FINISHED FLOOR AMPS
AMP, A	
AMPAY	AMPERE AMPACITY AMPERE TRIP
AT	AMPERE TRIP AUTOMATIC TRANSFER SWITCH
ATS AUX	AUTOMATIC TRANSFER SWITCH AUXILIARY
AWG	AMERICAN WIRING GUAGE
BATT	BATTERY
BR BRKR	BRANCH BREAKER
С	CONDUIT
CAP	CAPACITY
CB CCT. CKT	CIRCUIT BREAKER CIRCUIT
CCT, CKT CONT	CONTACTOR
DC	DIRECT CURRENT DISCONNECT
DISC DN	DISCONNECT DOWN
DPDT	DOUBLE POLE DOUBLE THROW
EC	EMPTY CONDUIT
ECH	ELECTRIC CABINET HEATER
EMERG	EMERGENCY BANEL
EMP EMT	EMERGENCY PANEL ELECTRIC METALLIC TUBING
EO	ELECTRICALLY OPERATED
F	FUSE
FDR	FEEDER
FLA FLC	FULL LOAD AMPERES FULL LOAD CURRENT
FLR	FLOOR
GA GEN	GAGE, GAUGE GENERATOR
GRD, GND	GROUND
HDG	HOT - DIPPED, GALVANIZED
HP HZ	HORSEPOWER
IC	HERTZ (CYCLE) INTERRUPTING CAPACITY
INV	INVERTER
ITC JB	INTERFACE
KV	JUNCTION BOX KILOVOLT KILOVOLT-AMPERE
KVA	KILOVOLT-AMPERE
KW KWHR	KILOWATT KILOWATT-HOUR
M	METER
MAN MAX	MANUAL MAXIMUM
MTG	MOUNTING
NC	NORMALLY CLOSED
NEG NEUT, N	NEGATIVE NEUTRAL
NIC	NOT IN CONTRACT NORMALLY OPEN, NUMBER
NO	NORMALLY OPEN, NUMBER
PB PF	PULL BOX POWER FACTOR
PH	PHASE
PNL	PANELBOARD
POS	POSITIVE
PRI RECPT	PRIMARY PECEPTACLE
REC	RECEPTACLE RECTIFIER RESISTANCE
REST	RESISTANCE
RGS	RIGID GALVANIZED STEEL CONDUIT
SCA SEC	SHORT CIRCUIT AMPERES SECONDARY
SEC SP	SECONDARY SINGLE POLE SINGLE POLE DOUBLE THROW
SPDT SPST	SINGLE POLE DOUBLE THROW SINGLE POLE SINGLE THROW
SS	STAINLESS STEEL
SW	SWITCH
SWBD TERM	SWITCHBOARD TERMINAL
TGL	TOGGLE
TP UNO	TAMPER PROOF UNLESS NOTED OTHERWISE
UPS	UNINTERRUPTIBLE POWER SUPPLY
V	VOLT VOLT-AMPER
VA VIF	VOLT-AMPER VERIFY IN FIELD
XFMR, TRANSF	TRANSFORMER
,	

	SECTION		COUNTY	TOTAL	SHEET NO.
	2005-0201	1	соок	16	8
STA.		ТО	STA.		
FED. RO	AD DIST. NO IL	LINOIS	FED. AID	PROJECT	-


62947


## NOTES

- 1. PLANS ARE NOT TO BE SCALED. THESE PLANS ARE INTENDED TO BE DIAGRAMMATIC OUTLINE ONLY UNLESS OTHERWISE NOTED. THE WORK SHALL INCLUDE FURNISHING MATERIALS, EQUIPMENT AND APPURTENANCES, AND LABOR NECESSARY TO EFFECT ALL INSTALLATIONS AS INDICATED ON THE DRAWINGS.
- 2. ALL CONTRACTORS WILL VISIT THE JOB SITE (SCHAUMBRUG COMMUNICATION CENTER)
  AND SHALL FAMILIARIZE THEMSELVES WITH ALL CONDITIONS AFFECTING THE GENERAL
  CONSTRUCTION DEMOLITION AND ELECTRICAL INSTALLATION AND SHALL MAKE PROVISIONS
  AS TO THE COST THEREOF. CONTRACTOR SHALL BE RESPONSIBLE FOR FAMILIARIZING
  HIMSELF WITH ALL CONTRACTDOCUMENTS, FIELD CONDITIONS AND DIMENSIONS CONFIRMING
  THAT THE WORK MAY BE ACCOMPLISHED AS SHOWN.
- 3. THE ELECTRICAL CONTRACTOR SHALL NOTIFY THE ENGINEER OF ANY DISCREPANCIES BETWEEN THE DRAWINGS, THE GENERAL NOTES, AND THE SEQUENCE OF CONSTRUCTION PHASING AND FIELD CONDITIONS, CLARIFICATION SHALL BE REQUESTED IN WRITING PRIOR TO SUBMISSION OF BIDS.
- 4. THE SUBMISSION OF A PROPOSAL SHALL BE CONSTRUED AS EVIDENCE THAT SUCH EVIDENCE AN EXAMINATION HAS BEEN MADE AND LATER CLAIMS FOR LABOR, EQUIPMENT, OR MATERIAL REQUIRED OR FOR DIFFICULTIES ENCOUNTERED, WHICH WOULD HAVE BEEN FORESEEN HAD SUCH AN EXAMINATION BEEN MADE, WILL NOT BE RECOGNIZED.
- 5. THE ELECTRICAL CONTRACTOR UPON AGREEMENT AND APPROVAL OF THE DRAWINGS ASSUMES FULL RESPONSIBILITY FOR THE MATERIALS, AND WORKMANSHIP OF THE WORK DESCRIBED IN THESE NOTES AND DRAWINGS, AND HE WILL BE EXPECTED TO COMPLY WITH THE SPIRIT AS WELL AS THE LETTER IN WHICH THEY WERE WRITTEN.

UPS-01

REVISIONS	TILINOIS DEPARTMENT	T OF TRANSPORTATION
NAME DA	TE   TECHNOLO DEI MICHIGA	
	F.A.T. 94/90 (DAN	RYAN EXPRESSWAY)
	31st STREE	
	31ST STREE	ET to I-57
	LININTERRUPTIR	LE POWER SUPPLY
		AND ABBREVIATIONS
		MINICATION CENTED
	- (SCHAUMBURG COM	MUNICATION CENTER)
		1,5
	SCALE: NOT TO SCALE	DRAWN BY: JM
	DATE: SEPTEMBER 23, 2005	MUNICATION CENTER)  DRAWN BY: JM  CHECKED BY: CS

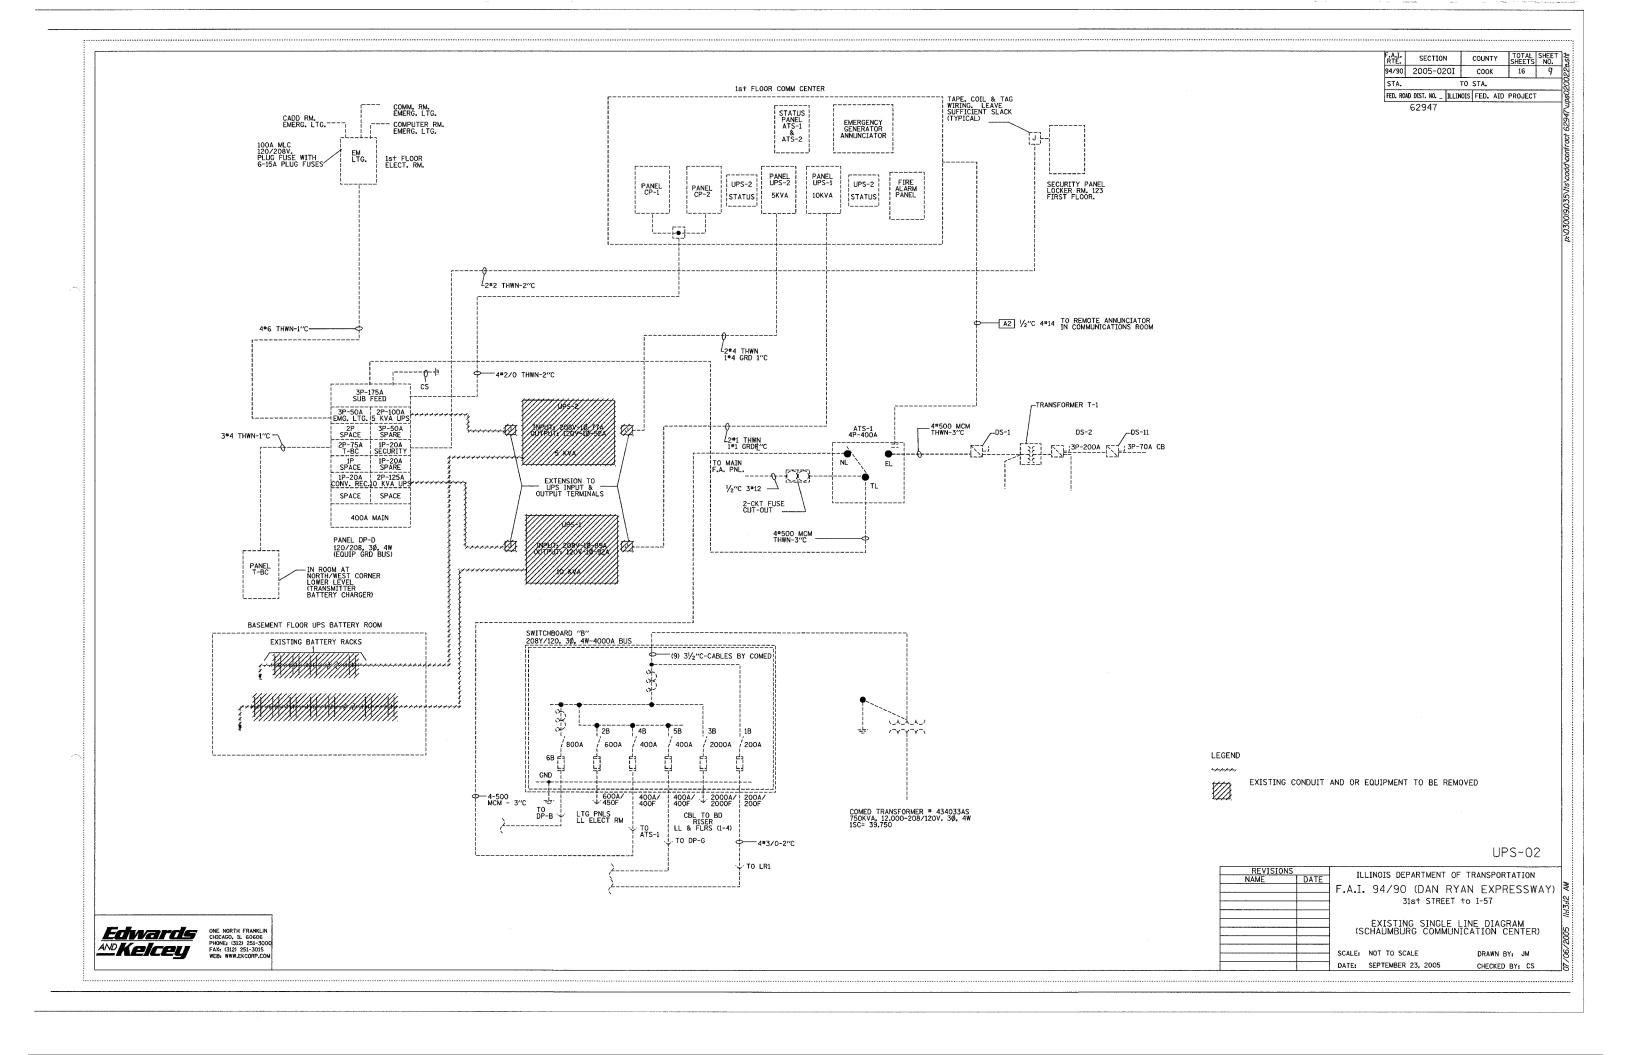

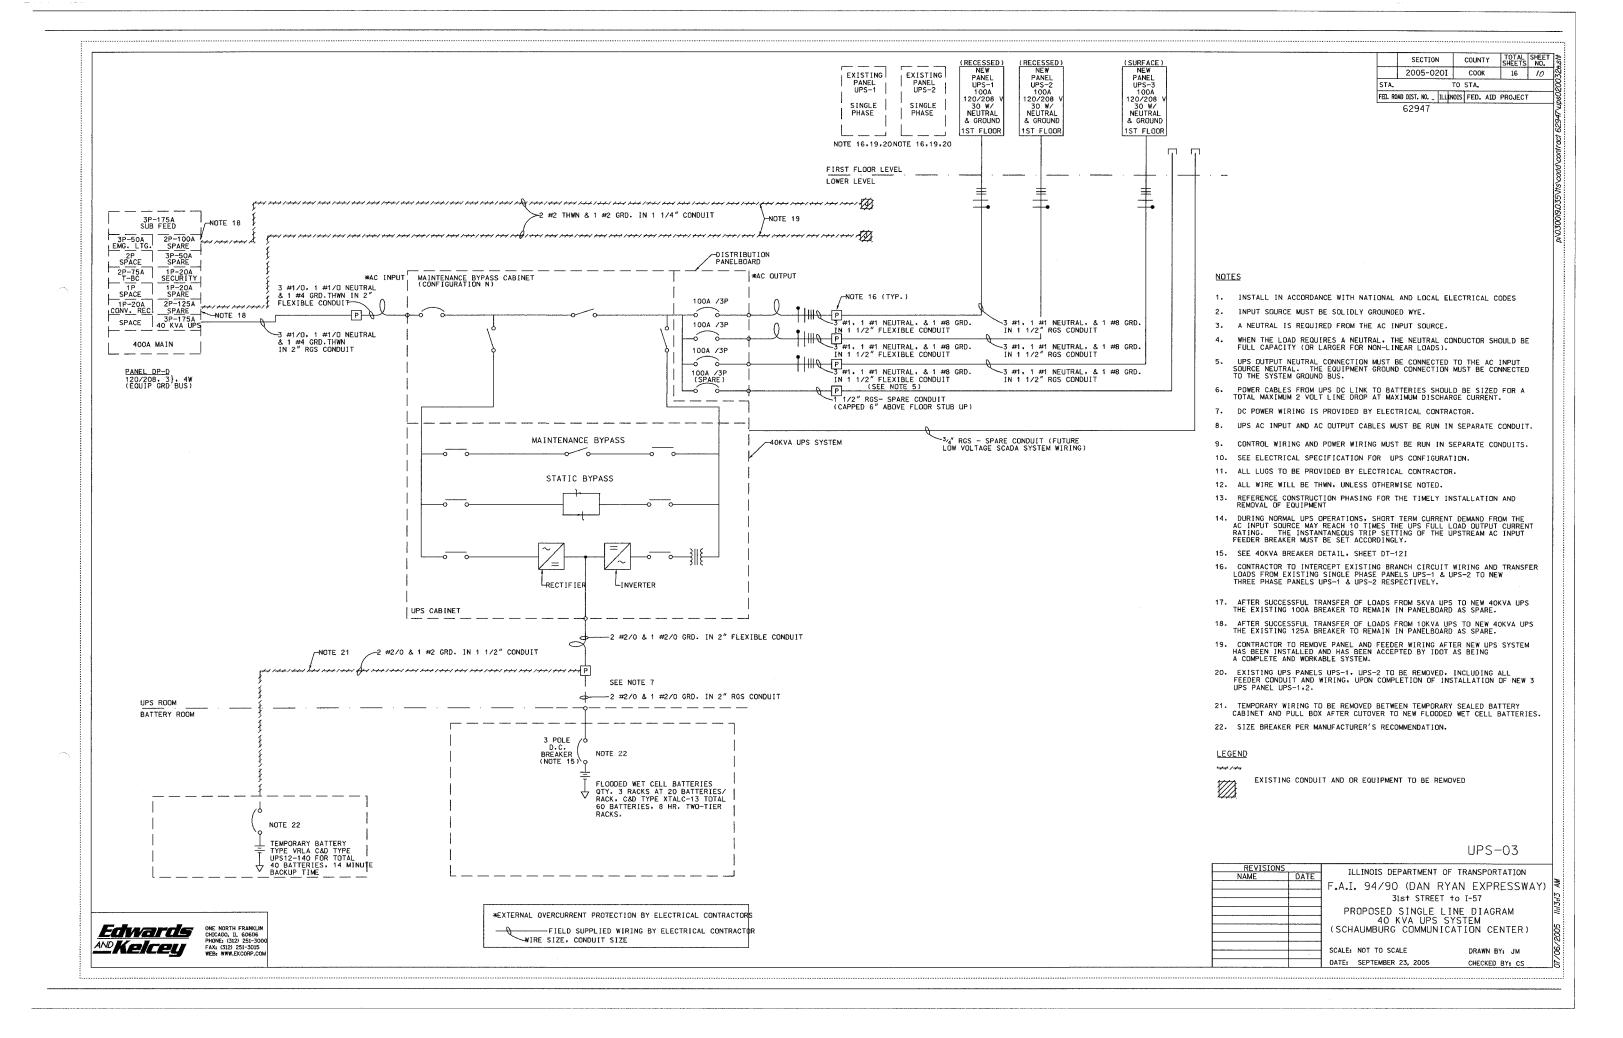

NOTES

- 1. FOR GENERAL NOTES, ABBREVIATIONS AND SYMBOL LIST, SEE SHEET UPS-01.
- 2. THE CONTRACTOR SHALL ENSURE THE EXISTING UPS SYSTEMS TO REMAIN OPERATIONAL 24 HOURS PER DAY. ANY INTERRUPTION OF UPS POWER SHALL BE COORDINATED WITH JOOT A MINIMUM OF 48 HOURS IN ADVANCE FOR ANY CUT-OVER OR PRIOR APPROVED INTERRUPTION OF SERVICE.
- 3. EXITING UPS SYSTEMS TO BE DISCONNECTED AND REMOVED IN PRESCRIBE SEQUENCE, AFTER NEW UPS INSTALLATION IS INSTALLED AND CONNECTED AND ALL EXISTING LOADS ARE TRANSFERRED FROM THE EXISTING UPS SYSTEMS.
- 4. THE CONTRACTOR SHALL DISCONNECT AND COMPLETELY REMOVE THE TWO EXISTING UPS SYSTEMS FROM THE EXISTING UPS EQUIPMENT ROOM AND ALL THE ASSOCIATED CONDUIT AND WIRING BACK TO THEIR SOURCES.
- 5. EXISTING UPS SYSTEMS SHALL BE INVENTORIED AND DELIVERED TO THE IDOT MAINTENANCE STORAGE SHOP OR AS OTHERWISE DIRECTED BY IDOT.
- 6. SEE EQUIPMENT IDENTIFICATION KEY THIS SHEET FOR CIRCLED ITEMS.


EQUIPMENT IDENTIFICATION KEY

- 1 UPS-1
- 2 DOUBLE THROW MANUAL TRANSFER SWITCH
- 3 JUNCTION BOX
- 4 DISCONNECT SWITCH-DP-S1
- 5) UPS-2

- EXISTING BATTERY C.B. DISCONNECT SWITCH

- 6 DOUBLE THROW MANUAL TRANSFER SWITCH
- (7) JUNCTION BOX
- 8 DISCONNECT SWITCH-DP-S2

-90° ELBOW BATT FEED -SWITCH DISCONNECT 480V EXISTING EXISTING TRANSFORMER EXISTING
UPS ROOM
ENVIRONMENTAL
AIR SYSTEM EXISTING SEALED BATTERIES FOR 50KVA UPS EXISTING PANELBOARD DP-D — EXISTING FIELD BOOK STORAGE EXISTING 480V DISCONNECT SWITCH EXISTING 50KVA UPS EXISTING DS-1 EXISTING EXISTING UPS ROOM -EXISTING PANELBOARD -EXISTING DISCONNECT SWITCH EXISTING COATS -EXISTING SWITCHBOARD EXISTING X-FRMR T-2 EXISTING ATS-2 EXISTING PANELBOARD DP-C (480VLTS) EXISTING DS-4 EXISTING DS-3

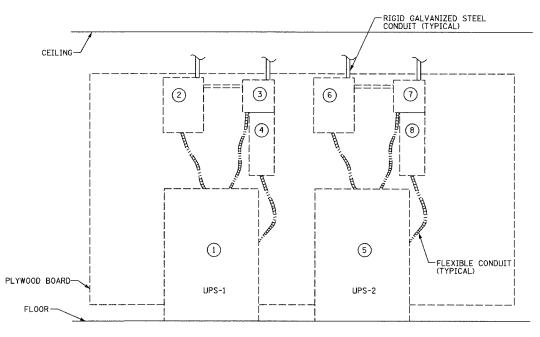

EXISTING UPS SERVICE & DISTRIBUTION EQUIPMENT NOT TO SCALE

LIPS-04

		01507
REVISIONS NAME DATE	ILLINOIS DEPARTMENT OF	TRANSPORTATION
57112	F.A.I. 94/90 (DAN RY	AN EXPRESSWAY)
	31st STREET t	o I-57
	EXISTING UPS ROOM EQ	
	(SCHAUMBURG COMMUNIC	CATION CENTER)
	SCALE: AS SHOWN ON PLANS	DRAWN BY: JM
	DATE: SEPTEMBER 23, 2005	CHECKED BY: CS

PARTIAL LOWER LEVEL PLAN

5' 10' 2

EXISTING BATTERY RACK

BATTERY ROOM


Edivards

AND KEICEU

ONE NORTH FRANKLIN CHICAGO, IL 60606

FAG. (32)2 251-3007

FAG. (32)2 2

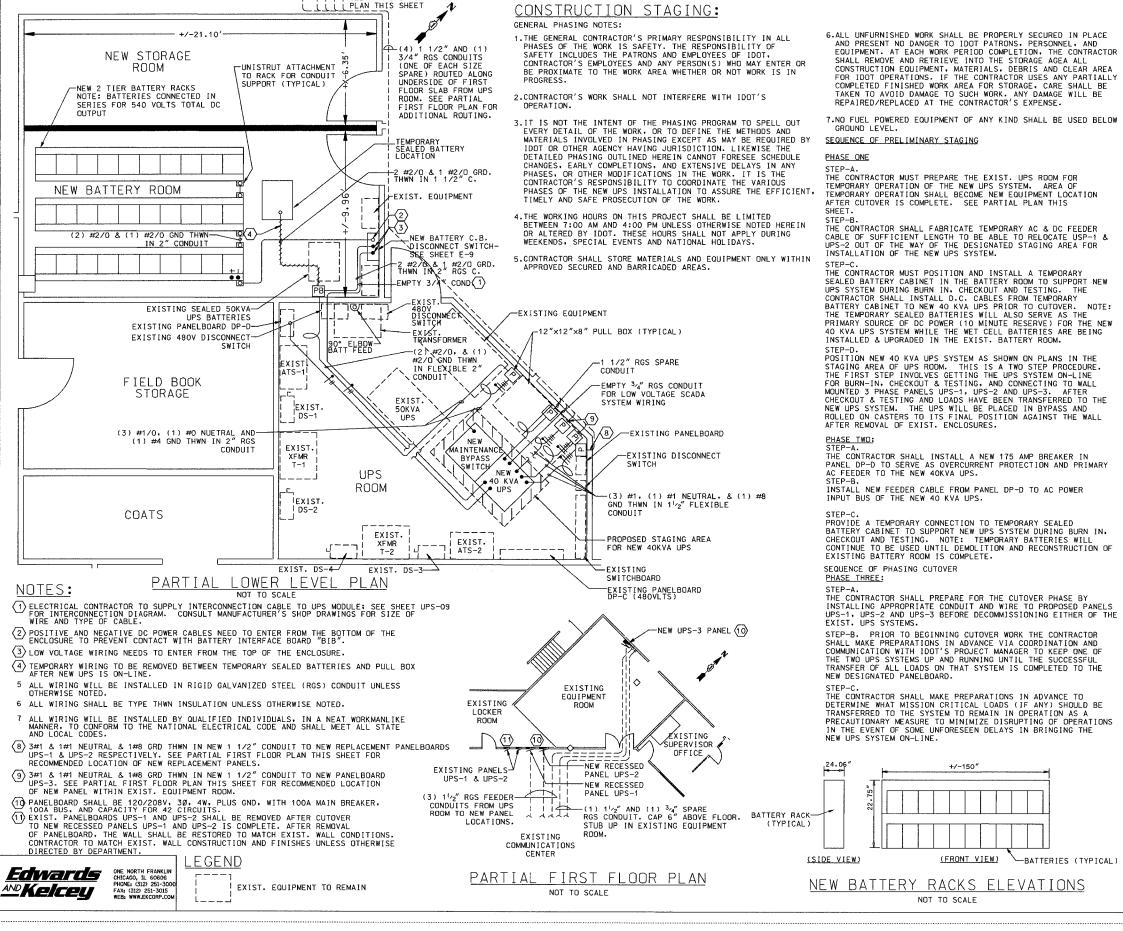

TOTAL SHEET NO. SECTION COUNTY 2005-020I COOK 16 12 STA. TO STA. FED. ROAD DIST. NO. \_ ILLINOIS FED. AID PROJECT

6294

BEFORE CUTOVER THE CONTRACTOR SHALL INSTALL 3 NEW FEEDER CABLES FROM NEW UPS DISTRIBUTION PANELBOARD TO THE FOLLOWING:

## UPS-1 PANELBOARD 1ST FLOOR COMMUNICATIONS ROOM:

CONTRACTOR TO INSTALL NEW FEEDER CABLE AND CONDUIT TO UPS-1. CONTRACTOR MUST BE AWARE THAT FLOOR MUST BE CORE DRILLED TO ROUTE CONDUIT RISER TO 1ST FLOOR. SUGGESTED CONDUIT ROUTING IS SHOWN FOR CONTRACTOR REFERENCE DNLY. CONTRACTOR ROUTING IS SHOWN FOR CONTRACTOR REFERENCE ONLY. CONTRACTOR SHALL DETERMINE BEST CONDUIT ROUTING PATH AND CORE DRILLING LOCATIONS AND REVIEW WITH IDOT PRIOR TO PROCEEDING. REFERENCE PARTIAL ELECTRICAL PLAN. THIS SHEET. NOTE: NEW PANELBOARD SHALL BE RECESSED TYPE. AFTER INSTALLATION OF PANELBOARD THE WALL SHALL BE RESTORED TO MATCH PRIOR EXIST. CONDITION INCLUDING BUT NOT LIMITED TO PAINT TO MATCH EXSITING WALL COLORS. COORDINATE WITH IDOT PROJECT ENGINEER PRIOR TO ALTERING WALL IN ANYWAY.

## UPS-2 PANELBOARD 1ST FLOOR COMMUNICATIONS ROOM.

CONTRACTOR TO INSTALL NEW FEEDER CABLE AND CONDUIT TO UPS-2. CONTRACTOR MUST BE AWARE THAT FLOOR MUST BE CORE DRILLED TO ROUTE CONDUIT RISER TO 1ST FLOOR. CONTRACTOR SHALL DETERMINE BEST CONDUIT ROUTING PATH AND CORE DRILLING LOCATIONS AND REVIEW WITH IDOT PRIOR TO PROCEEDING. REFERENCE PARTIAL ELECTRICAL PLAN, THIS SHEET.
NOTE: NEW PANELBOARD SHALL BE RECESSED TYPE. AFTER
INSTALLATION OF PANELBOARD THE WALL SHALL BE RESTORED TO
MATCH PRIOR EXIST. CONDITION INCLUDING BUT NOT LIMITED TO
PAINT TO MATCH EXSITING WALL COLORS. COORDINATE WITH IDOT THIS SHEET. PAINT TO MATCH EXSITING WALL COLORS. COORDINATE WITH IDOT PROJECT ENGINEER PRIOR TO ALTERING WALL IN ANYWAY. INSTALLATION OF PANELBOAD UPS-3 SHALL BE THE SAME AS DESCRIBED FOR UPS-1 AND UPS-2 ABOVE. ALL THE AFORMENTIONED PANELBOARDS SHALL BE 100 AMP, 120/208 VOLT. THREE PHASE, 4 WIRE PLUS GROUND BAR. PANELS SHALL HAVE CAPACITY FOR 42 CIRCUITS.

THE ABOVE WIRES SHOULD BE PRE-PULLED IN ADVANCE OF CUTOVER DATE LEAVING 5 FEET OF WIRED COILED FOR FINAL TERMINATION AT PANELBOARD. NOTE: THE EXIST. POWER DISTRIBUTION SYSTEM MUST BE LEFT OPERATIONAL UNTIL PRIOR APPROVAL IS RECEIVED FROM IDOT FOR AN ACCEOTABLE CUTOVER DATE AND TIME.

APPROVAL IS RECEIVED FROM IDUI FUN AN AUCEUIADLE CUIVELY DATE AND TIME.

AFTER THE SUCCESSFUL TRANSFER OF LOADS OF THE 1ST SYSTEM, THE SAME PROCEDURE SHOULD BE FOLLOWED FOR TRANSFER OF LOADS FOR THE 2ND UPS SYSTEM.

AFTER CUTOVER IS COMPLETE BEGIN REMOVAL OF ENCLOSURES ITEMS 2, 3, 4, 6, 7 & 8 FROM WALL IN UPS ROOM. CONTRACTOR IS TO DELIVER EXIST. ITEMS 1 AND 2 (10KVA & 5KVA RESPECTIVELY) TO DESIGNATED MAINTENANCE STORAGE AREA AS DIRECTED BY IDOT. NOTE: CONDUITS FOR ITEMS 3 AND 4 ARE TO REMOVED BACK TO SOURCE.

UPGRADE AND REPLACEMENT OF BATTERIES AFTER UPS ON-LINE PHASE FOUR:

STEP-A

THE CONTRACTOR SHALL START THE REMOVAL OF EXIST, WET CELL BATTERIES FROM EXIST, BATTERY ROOM. STEP-B.

BATTERIES SHALL BE REMOVED AND DISPOSED OF TO MEET ALL EPA REGULATIONS AND GUIDELINES FOR DISPOSAL OF HAZARDOUS MATERIAL.

STEP-C.
INSTALL NEW BATTERY RACKS TO COMPLY WITH SEISMIC 1 CONSIDERATIONS FOR EARTHQUAKES.

JEF APPLICABLE, INCREASE SIZE OF EXIST. WALL MOUNTED BATTERY BREAKER TO COMPLY WITH MANUFACTURERS RECOMMENDATION.

STEP-E.
CONTRACTOR TO INSTALL NEW CONDUIT AND WIRING FROM BATTERY
BANK TO NEW 40 KVA UPS SYSTEM AS REQUIRED TO MEET
MANUFACTURERS REQUIREMENTS. NOTE: EXIST. CONDUIT AND/OR
CC CABLING MAY BE RE-USED OR RUN IN PARALLEL WITH NEW
WIRNG TO MEET INCREASED CAPACITY REQUIREMENTS FOR NEW
ADVA 40KVA UPS.

BATTERY ROOM FACILITY MODIFICATIONS
CONTRACTOR TO COORDINATE WITH DEPARTMENT THE PARTIAL
REMOVAL OF EXIST, WALLS AT EXIST, LOWER LEVEL BATTERY
ROOM AS NECESSARY FOR THE CONSTRUCTION OF NEW DIVIDING
WALL PARTITION AND NEW DOOR INSTALLATION FOR THE NEW WALL PARTITION AND NEW DOUR INSTALLATION FOR THE NEW STORAGE ROOM. CONTRACTOR TO MATCH EXIST. WALL CONSTRUCTION AND FINISHES UNLESS OTHERWISE DIRECTED BY DEPARTMENT. THE CEILING AREA AROUND THE AIR CONDITIONING DUCTS SHALL BE SEALED. A NEW DOOR SHALL BE INSTALLED ON NORTHEAST WALL OF STORAGE ROOM AS SHOWN ON PARTIAL LOWER LEVEL PLAN. DOOR/FRAME SIZE, MATERIAL, HARDWARE, FINISH
SHALL MATCH THAT OF EXIST, BATTERY ROOM DOOR AND SHALL
HAVE A MATCHED KEY LOCK PER DIRECTION OF THE ENGINEER. UPS-05

REVISIONS		ILLINOIS DEPARTMENT OF TRANSPORTATION	- 1
IAME	DATE		_
		F.A.I. 94/90 (DAN RYAN EXPRESSWAY)	₹
		31st STREET to 1-57	3,13
			11:13
		(SCHAUMBURG COMMUNICATION CENTER)	06/2005
			10
		SCALE: AS SHOWN ON PLANS DRAWN BY: JM	8
		DATE: SEPTEMBER 23, 2005 CHECKED BY: CS	8

	SECTION	•	COUNTY	TOTAL SHEETS	SHEET NO.
	2005-02	201	COOK	16	13
STA.		Ŧ	O STA.		
FED. RO	AD DIST. NO	ILLINO	IS FED. AII	PROJECT	•
62947					


NOTES:


- 1. ALL DIMENSIONS ARE IN INCHES.
- 2. 24" MINIMUM CLEARANCE ABOVE UNIT REQUIRED FOR AIR EXHAUST.
- 3. INSTALLATION AND SERVICE ACCESS REQUIRED IN FRONT ONLY. RH SIDE ACCESS RECOMMENDED FOR MAXIMUM EASE OF INSTALLATION.
- 4. KEEP CABINET WITHIN 15 DEG. OF VERTICAL WHILE HANDLING.
- 5. TOP AND BOTTOM CABLE ENTRY AVAILABLE THROUGH REMOVABLE ACCESS PLATES. REMOVE PUNCH TO SUIT CONDUIT SIZE AND REPLACE.
- 6. COLOR IBM OFF WHITE.
- 7. UNIT BOTTOM IS STRUCTURALLY ADEQUATE FOR FORKLIFT HANDLING.
- 8. OPEN DOOR TO REPLACE AIR FILTER,
  DISPOSABLE TYPE, SIZE 1 x 25 x 25
- 9. THREADED MOUNTING HOLES USED FOR SEISMIC ANCHORING OR FLOOR STAND. NOTE, IF FLOOR STAND IS USED THE WEIGHT OF THE UNIT MUST BE SUPPORTED UNDER ALL CASTERS.
- 10. EACH MOUNTING LOCATION IS SUPPORTED BY (2) 10 GA. (.135") GALVANIZED STEEL. THE THREADED 12MM INSERT IS APPROX. 3/4" DEEP. MOUNTING BOLTS MUST BE THREADED INTO UNIT MOUNTING HOLES FROM UNDERNEATH UNIT BASE.
- 11. INCLUDES SIDE PANEL. REFER TO DETAIL A FOR DIMENSION TO FRAME WITH SIDE PANEL REMOVED. SIDE PANELS ARE REMOVED BETWEEN ADJACENT UNITS WHICH ARE BOLTED TOGETHER.
- 12. LEVELING FEET ARE NOT DESIGNED TO CARRY THE FULL WEIGHT OF THE CABINET. FINGER-TIGHT LEVELER AGAINST THE FLOOR. THEN TIGHTEN WITH A WRENCH LESS THAN 2 TURNS FOR FRICTION FIT AGAINST FLOOR.

	VOLT	AGE	WEIGHT			COOLING AIR	
RATING	INPUT	OUTPUT	LBS	KG	REJECTION BTU/HR	CFM	
40	208	208	2200	1000	11000	720	

UPS-06

REVISIONS NAME DATE		ILI	INOIS DEPARTMENT OF	TRANSPORTATION
		EAT	04/00 (DAN DV	AN EXPRESSWAY)
		L. H.I.		
			31st STREET	1 70 1-57
			OUTLINE D	RAWING
			40 KVA UPS NPOWE	
		SCALE:	NOT TO SCALE	DRAWN BY: JM
		DATE:	SEPTEMBER 23, 2005	CHECKED BY: CS

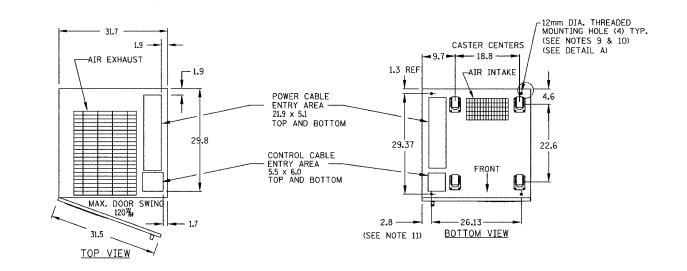

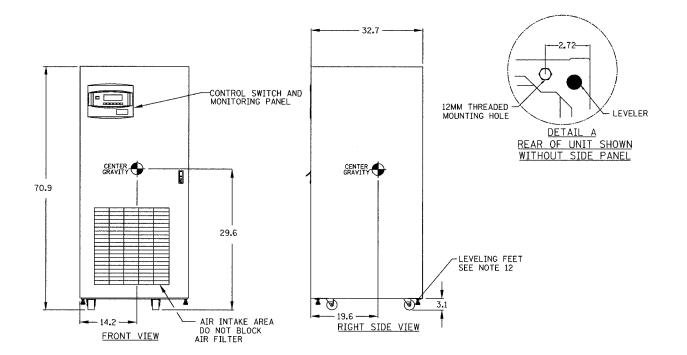

AND KEICEU

ONE NORTH FRANKLIN CHICAGO, IL 60606

AND KEICEU


FAX: (312: 251-305)


FEB: WWW\_ECKORP.COM

	SECTION	COUNTY	TOTAL SHEETS	SHEET NO.	HSS
	2005-0201	COOK	16	14	20
STA.	•	TO STA.			S
FED. RO	AD DIST. NO ILLIN	OIS FED. AID	PROJECT		Usur
	62947				Š


## NOTES:

- 1. ALL DIMENSIONS ARE IN INCHES.
- 2. TOP AND BOTTOM CABLE ENTRY AVAILABLE THROUGH REMOVABLE ACCESS PLATES. REMOVE, PUNCH TO SUIT CONDUIT SIZE, AND REPLACE.
- 3. CONTROL WIRING AND POWER WIRING MUST BE RUN IN SEPARATE CONDUIT. OUTPUT CABLES MUST BE RUN IN A SEPARATE CONDUIT FROM INPUT
- 4. ALUMINUM AND COPPER CLAD ALUMINUM CABLES ARE NOT RECOMMENDED.
- 5. ALL WIRING IS TO BE IN ACCORDANCE WITH NATIONAL AND LOCAL ELECTRICAL CODES.

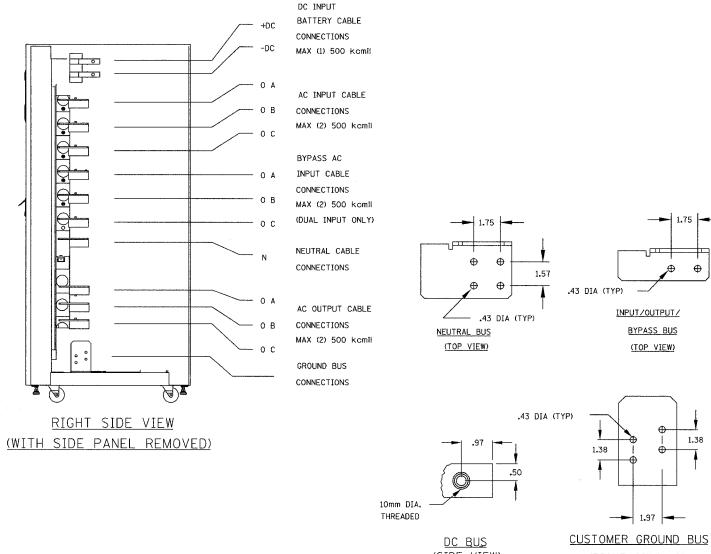

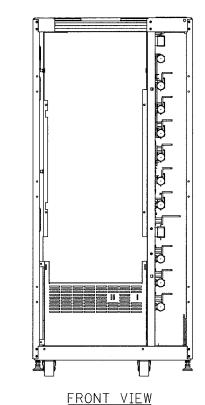

(WITH FRONT PANELS REMOVED)

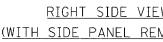

(SIDE VIEW)

(RIGHT SIDE VIEW)

UPS-07


REVISION		71.1	INOIS DEPARTMENT O	E TRANSPORTATION		
NAME	DATE	1 1	ILLINOIS DEPARTMENT OF TRANSPORTATION			
			94/90 (DAN R)	YAN EXPRESSWAY		
		1	31st STREE	T to I-57		
			TERMINAL 40 KVA UPS			
		SCALE:	NOT TO SCALE	DRAWN BY: JM		
		DATE:	SEPTEMBER 23, 2005	CHECKED BY: CS		







- 1. ALL DIMENSIONS ARE IN INCHES.
- 2. MIN CLEARANCE 36 FRONT, 12 TOP FOR AIR
- 3. KEEP CABINET WITHIN 15 DEGREES OF VERTICAL WHILE HANDLING.
- 4. TOP AND BOTTOM CABLE ENTRY AVAILABLE THROUGH REMOVABLE ACCESS PLATES. REMOVE, PUNCH TO SUIT CONDUIT SIZE, AND REPLACE.
- 5. CONTROL WIRING AND POWER WIRING MUST BE RUN IN SEPARATE CONDUIT. OUTPUT CABLES MUST BE RUN IN A SEPARATE CONDUIT FROM INPUT CABLES.
- 6. ALUMINUM AND COPPER CLAD ALUMINUM CABLES ARE NOT RECOMMENDED.
- 7. ALL WIRING IS TO BE IN ACCORDANCE WITH NATIONAL AND LOCAL ELECTRICAL CODES.
- 8. INTER CABINET WIRING BETWEEN THE UPS AND THE MB CABINET IS SUPPLIED BY LIEBERT, INSTALLATION BY OTHERS.
- 9. MAINTENANCE BYPASS CABINET IS NOT A STAND ALONE UNIT. IT IS BOLTED TO THE RIGHT SIDE OF THE UPS.
- 10. COLOR IBM OFF WHITE.
- 11. UNIT BOTTOM IS STRUCTURALLY ADEQUATE FOR FORKLIFT HANDLING.
- 12. THREADED MOUNTING HOLES USED FOR SEISMIC ANCHORING OR FLOOR STAND. NOTE, IF FLOOR STAND IS USED THE WEIGHT OF THE UNIT MUST BE BE SUPPORTED UNDER ALL CASTERS.
- 13. EACH MOUNTING LOCATION IS SUPPORTED BY (2) 10 GA. (.135") GALVANIZED STEEL. THE THREADED 12MM INSERT IS APPROX. 3/4" DEEP. MOUNTING BOLTS MUST BE THREADED INTO UNIT MOUNTING HOLES FROM UNDERNEATH UNIT BASE.
- 14. INCLUDES SIDE PANEL, REFER TO DETAIL A FOR DIMENSION TO FRAME WITH SIDE PANEL REMOVED. SIDE PANELS ARE REMOVED BETWEEN ADJACENT UNITS WHICH ARE BOLTED TOGETHER.

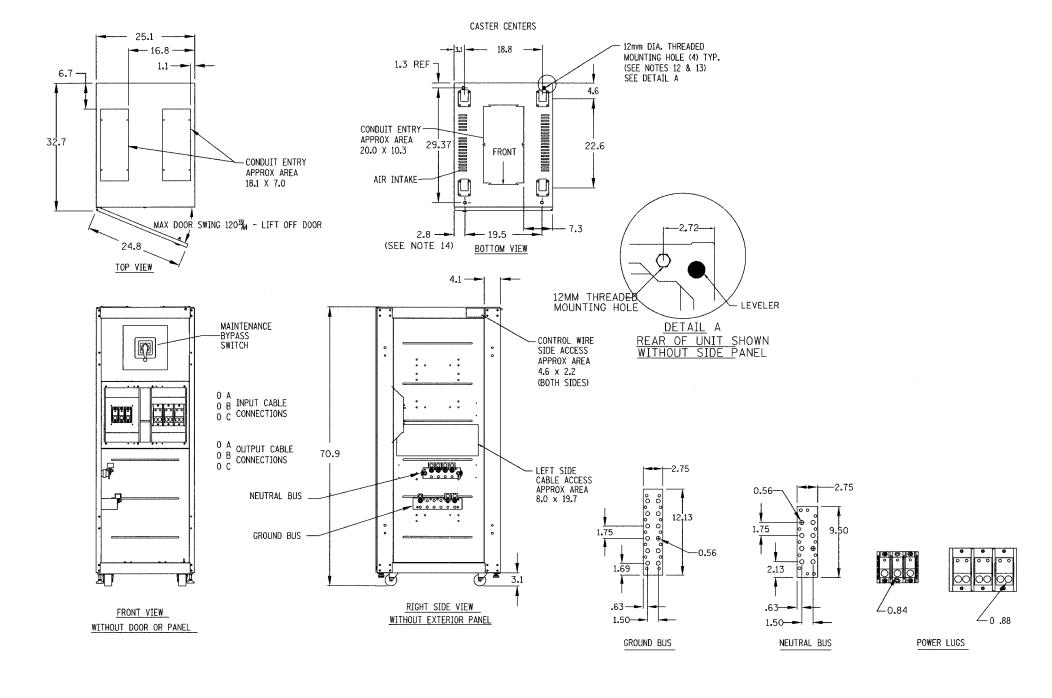



UPS-08

REVISIONS		TI	LINOIS DEPARTMENT O	DE TRANSPORTATION
NAME	DATE	1 1	CINOIS DE ANTIMENT C	I INANSI ONTATION
		F.A.I.	94/90 (DAN R	YAN EXPRESSWAY)
			31st STRE	ET to I-57
		1	TERMINAL	DETAILS
			25" MAINTENANCE	BYPASS CARINET
		CONFIGURATION "N" SINGLE INPUT		
		,	(NPOW	
		1	(IVI OW	EIO
		SCALE:	AS SHOWN	DRAWN BY: JM
		DATE:	SEPTEMBER 23, 2005	CHECKED BY: CS

*Edwards* AND Kelcey



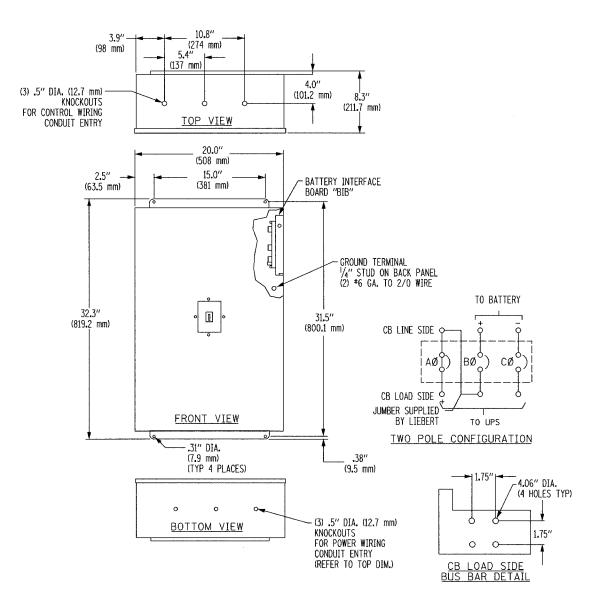

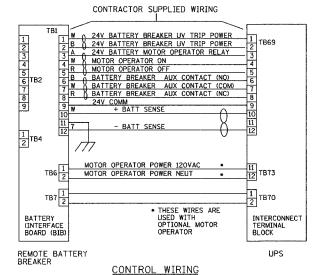

## NOTES

- NEMA 1 ENCLOSURE PROVIDED IS SUITABLE FOR WALL MOUNTING ONLY. APPROX. WEIGHT IS 60 LB.
- 2. HARDWARE FOR CONNECTING CABLES TO THE BREAKER SUPPLIED.
- 3. CIRCUIT BREAKER, SQUARE D TYPE KHL36XXX FOR 40KVA. C.B. TO BE SUPPLIED BY MANUFACTURER.
- 4. COLOR: IBM OFF-WHITE.
- MOUNT ENCLOSURE AND PULL ALL CABLES INTO ENCLOSURE PRIOR TO INSTALLING "BIB" BOARD.
- NUMBER NOT USED.
- POSITIVE AND NEGATIVE DC POWER CABLES NEED TO ENTER FROM THE BOTTOM OF THE ENCLOSURE TO PREVENT CONTACT WITH THE "BIB" BOARD.
- 8. LOW VOLTAGE WIRING NEED TO ENTER FROM THE TOP OF THE ENCLOSURE.
- 9. LINE SIDE POWER CONNECTIONS TO LUGS: (1) \*2/O PER CONNECTION FOR 40KVA UPS. LOAD SIDE POWER CONNECTIONS TO BUS BARS, SEE DETAIL.

UPS-09

REVISIONS	THE THIOTIC DEPARTMENT OF T	DANCDODTATION		
NAME DATE	ILLINOIS DEPARTMENT OF TRANSPORTATION			
	🗌 F.A.I. 94/90 (DAN RYA)	N EXPRESSWAY)		
	31st STREET to	I-57		
	OUTLINE DRAWING	REMOTE		
	BATTERY BREAKER (NPOWER)	- 40 KVA		
	SCALE: NOT TO SCALE	DRAWN BY: JM		
	DATE: SEPTEMBER 23, 2005	CHECKED BY: CS		

Edwards
ONE NORTH FRANKLIN CHICAGO, IL 60606
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