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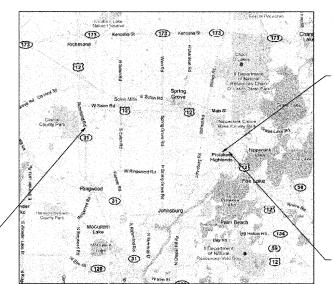
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STATE OF ILLINOIS
DEPARTMENT OF TRANSPORTATION
DIVISION OF HIGHWAYS

# PROPOSED HIGHWAY PLANS

VARIOUS ROUTES
SECTION 2010–124–1
VARIOUS LOCATIONS
SCOUR COUNTERMEASURES
LAKE AND MCHENRY COUNTIES

C-91-182-11



LOCATION 3: S.N. 056-0020, U.S. ROUTE 12 OVER NIPPERSINK CREEK OVERFLOW

- LOCATION 2: S.N. 056-0057, U.S. ROUTE 12 OVER NIPPERSINK CREEK

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ET, SUITE 100 | McHENRY, ILLINOIS 60050
800728-7605 | Fax: 615.395.1761 | HRGreen.com
SIONAL DESIGN FIRM #184-001322


FOR INDEX OF SHEETS, SEE SHEET NO. 2

**IMPROVEMENTS LOCATED IN THE** 

VILLAGE OF GURNEE VILLAGE OF SPRING GROVE

VILLAGE OF RICHMOND


LOCATION 4: S.N. 056-0037, ILLINOIS ROUTE 31 OVER NIPPERSINK CREEK

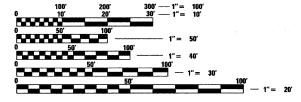

FULL SIZE PLANS HAVE BEEN PREPARED USING STANDARD ENGINEERING SCALES. REDUCED SIZED PLANS WILL NOT CONFORM TO STANDARD SCALES. IN MAKING MEASUREMENTS ON REDUCED PLANS, THE ABOVE SCALES MAY BE USED.

J.U.L.I.E.
JOINT UTILITY LOCATION INFORMATION FOR EXCAVATION
1-800-892-0123
OR 811

**CONTRACT NO. 60M86** 

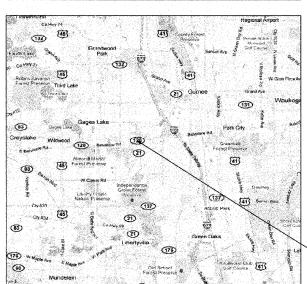

LOCATION 1: S.N. 049-0044 (WB) AND S.N. 049-0045 (EB) ILLINOIS ROUTE 120 OVER STREAM

| F.A. | SECTION | COUNTY | TOTAL SHEET | SHEE

D-91-182-11



STATE OF ILLINOIS
DEPARTMENT OF TRANSPORTATION
DIVISION OF HIGHWAYS

SUBMITTED JULY 2 20 11

Diage M. O'Kelly
DEPUTY DIRECTOR OF HIGHWAYS, REGION ENGINEER

Hugust 19 20 11

Scott E. Stitt P.E. ba
acting ENGINEER OF DESIGN AND ENVIRONMENT

August 19 20 11

Christia M. Raada
DIRECTOR OF HIGHWAYS, CHIEF ENGINEER

Christophy M. Huston

EXPIRES: 11-30-201(

PRINTED BY THE AUTHORITY OF THE STATE OF ILLINOIS

### INDEX OF SHEETS

COVER SHEET

1

- 2 INDEX OF SHEETS, LIST OF STATE STANDARDS, AND GENERAL NOTES SCOUR COUNTERMEASURES
- 3 SUMMARY OF QUANTITIES
- LOCATION MAPS
- 5-6 SCOUR COUNTERMEASURES ILLINOIS ROUTE 120 OVER A STREAM
- 7-8 SCOUR COUNTERMEASURES U.S. ROUTE 12 OVER NIPPERSINK CREEK
- 9-10 SCOUR COUNTERMEASURES U.S. ROUTE 12 OVER NIPPERSINK CREEK OVERFLOW
- 11-12 SCOUR COUNTERMEASURES ILLINOIS ROUTE 31 OVER NIPPERSINK CREEK
- 13-16 CROSS SECTIONS SCOUR COUNTERMEASURES
- 17 TRAFFIC CONTROL AND PROTECTION FOR SIDE ROADS, INTERSECTIONS, AND DRIVEWAYS
- ARTERIAL ROAD INFORMATION SIGN
- 19-21 DEWATERING SYSTEM DETAILS SCOUR COUNTERMEASURES

### LIST OF STATE STANDARDS

STANDARD NO.	DESCRIPTION
701006- <i>03</i>	OFF-RD OPERATIONS, 2L, 2W, 15' TO 24" FROM PAVEMENT EDGE
701426- 04	LANE CLOSURE, MULTILANE, INTERMITTENT OR MOVING OPER., FOR SPEEDS >= 45
701501- <i>06</i>	URBAN LANE CLOSURE, 2L, 2W, UNDIVIDED
701601- 07	URBAN LANE CLOSURE, MULTILANE, 1W OR 2W WITH NONTRAVERSABLE MEDIAN
701602-05	URBAN LANE CLOSURE, MULTILANE, 2W WITH BIDIRECTIONAL LEFT TURN LANE
701901- 01	TRAFFIC CONTROL DEVICES

### COMMITMENTS

 FOR LOCATION 1 (ILLINOIS ROUTE 120 OVER STREAM), DUE TO THE PRESENCE OF THE STATE LISTED IOWA DARTER (ETHEOSTOMA EXILE) AT THE PROJECT LOCATION, NO INSTREAM WORK SHALL OCCUR FROM APRIL 1 THROUGH JUNE 30 OF ANY PROJECT YEAR.

### GENERAL NOTES

- 1. BEFORE STARTING ANY EXCAVATION, THE CONTRACTOR SHALL CALL "JULIE" (JOINT UTILITY LOCATION INFORMATION FOR EXCAVATION) AT 8-1-1 OR (800) 892-0123 FOR FIELD LOCATIONS OF BURIED ELECTRIC, TELEPHONE, AND GAS FACILITIES (48 HOUR NOTIFICATION IS REQUIRED).
- 2. THE CONTRACTOR WILL NOT BE ALLOWED TO SET UP A YARD OR FIELD OFFICE ON STATE PROPERTY WITHOUT WRITTEN PERMISSION FROM THE DEPARTMENT.
- 3. EXCAVATION INTO THE STREAM BED FOR STONE RIPRAP INSTALLATION SHALL NOT BE DEEPER THAN THE BOTTOM OF THE FOOTING ON THE PIER OR ABUTMENT TO BE PROTECTED.
- 4. DEBRIS REMOVAL, IF ENCOUNTERED, SHALL BE INCLUDED IN THE COST OF THE STONE RIPRAP.
- 5. IT SHALL BE THE CONTRACTORS RESPONSIBILITY TO VERIFY ALL DIMENSIONS & CONDITIONS EXISTING IN THE FIELD PRIOR TO CONSTRUCTION ORDERING OF MATERIAL.
- 6. THE CONTRACTOR SHALL CONTACT THE DISTRICT ONE ARTERIAL TRAFFIC CONTROL SUPERVISOR AT (847) 705-4470 A MINIMUM OF 72 HOURS IN ADVANCE OF BEGINNING WORK.
- 7. ALL AREAS (INCLUDING WETLAND AREAS) OUTSIDE THE LIMITS OF RIPRAP PLACEMENT AND/OR EXCAVATION WHICH ARE DISTURBED (WHERE EXISTING SOIL CONTOURS HAVE BEEN ALTERED AND/OR EXISTING VEGETATION HAD BEEN DESTROYED BY THE CONTRACTORS OPERATIONS) SHALL BE RESTORED BY REGRADING TO THE ORIGINAL CONTOURS AND/OR SEEDING WITH SEEDING, CLASS 4, AND MULCHING WITH EROSION CONTROL BLANKETS. PLACE TEMPORARY SEEDING AND TEMPORARY EROSION CONTROL BLANKETS AS NEEDED. THIS WORK WILL NOT BE PAID FOR SEPERATELY, BUT THE COSTS SHALL BE CONSIDERED INCLUDED IN THE CONTRACT UNIT PRICES FOR THE CONSTRUCTION ITEMS INVOLVED, AND NO ADDITIONAL COMPENSATION WILL BE ALLOWED.
- 8. THE CONTRACTOR IS ADVISED TO AVOID OR MINIMIZE ANY DISTURBANCE TO EXISTING VEGETATION
  OUTSIDE THE LIMITS OF RIPRAP PLACEMENT AND CHANNEL EXCAVATION.
- THE CONTRACTOR MUST PROTECT PAVEMENT WHEN DUMPING RIPRAP ONTO PAVEMENT AND WILL BE RESPONSIBLE FOR RESTORING PAVEMENT MARKINGS.
- 10. ANY GUARDRAIL OR SIGNS DAMAGED BY THE CONTRACTOR'S OPERATIONS SHALL BE REPLACED IN KIND AT THE CONTRACTORS EXPENSE.
- 11. THE CONTRACTOR SHALL BE REQUIRED TO PROVIDE ACCESS TO ABUTTING PROPERTY AT ALL TIMES DURING THE CONSTURCTION OF THIS PROJECT.
- 12. DO NOT SCALE PLANS FOR CONSTRUCTION DIMENSIONS.
- 13. THE CONTRACTOR SHALL SUBMIT DEWATERING AND SEDIMENT CONTROL PLANS FOR EACH SITE TO THE ENGINEER FOR APPROVAL.
- 14. THE CONTRACTOR SHALL CONTACT THE ENGINEER AFTER DEWATERING FOR FINAL RIPRAP OR SLOPE MATTRESS PLACEMENT.
- 15. NIGHT TIME CLOSURES WILL NOT BE REQUIRED FOR THIS PROJECT.
- 16. UNLESS OTHERWISE NOTED, EXCAVATION OF MATERIAL REQUIRED TO INSTALL STONE RIPRAP OR SLOPE MATTRESS SHALL BE INCLUDED IN THE ITEM BEING INSTALLED.

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STATE OF ILLINOIS
DEPARTMENT OF TRANSPORTATION

INDEX OF	SHEETS, LIST OF	STATE STAP	NDARDS, AND	GENERAL I	NOTES	F.A. RTE.	SEC	TION
	SCOU	R COUNTERN	IEASURES			VAR.	2010	-124-I
SCALE:	SHEET NO. 1	OF 1 SHEETS	STA.	TO STA.		FED. ROA	D DIST. NO.	ILLINOIS

		SUMMARY OF QUANTITIES		URBAN		00	014	
	CODE NO.	ITEM	UNIT	100% STATE TOTAL QUANTITY	LOCATION 1 IL RTE 120 LAKE CO	LOCATION 2 US RTE 12 MCHENRY CO	LOCATION 3 US RTE 12 OF MCHENRY CO	LOCATION 4 IL RTE 31 MCHENRY CO
	28100107	STONE RIPRAP, CLASS A4	SQ YD	340		122		218
	28200200	FILTER FABRIC	SQ YD	185 <b>6</b>	433	494	201	728
	28401000	SLOPE MATTRESS 12"	SQ YD	605			201	404
	67000400	ENGINEER'S FIELD OFFICE, TYPE A	CAL MO	4	1	. 1	1	1
	67100100	MOBILIZATION	L SUM	1	0.25	0.25	0.25	0.25
•	70102620	TRAFFIC CONTROL AND PROTECTION, STANDARD 701501	L SUM	1				1
•	70102630	TRAFFIC CONTROL AND PROTECTION, STANDARD 701601	L SUM	1	1			
•	70102632	TRAFFIC CONTROL AND PROTECTION, STANDARD 701602	L SUM	1		0.5	0.5	·
	X0301852	DEWATERING STRUCTURE NO. 1	EACH	1	1	*		,
	X0301853	DEWATERING STRUCTURE NO. 2	EACH	1		. 1		
	X0301854	DEWATERING STRUCTURE NO. 3	EACH	1			1	
	X0301855	DEWATERING STRUCTURE NO. 4	EACH	1				1
	Z0030850	TEMPORARY INFORMATION SIGNING	SQ FT	205.6	51.4	51.4	51.4	51.4
	28401600	SLOPE MATTRESS 18"	SQ YD	705	433	272		
	28400100	GABIONS	CUYD	100	20	24	20	36

SPECIALTY ITEMS

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PLOT DATE = 7/19/2011 REVISED -REVISED -

STATE OF ILLINOIS
DEPARTMENT OF TRANSPORTATION


SUMMARY OF QUANTITIES SCALE: N/A SHEET NO. 1 OF 1 SHEETS STA.

TO STA.

TRAFFIC DATA
SPEED LIMIT = 45 MPH
2009 ADT = 13,200

- LOCATION 2 - MCHENRY COUNTY STRUCTURE NUMBER: 056-0057 U.S. ROUTE 12 OVER NIPPERSINK CREEK LOCATED IN MCHENRY TOWNSHIP VILLAGE OF SPRING GROVE



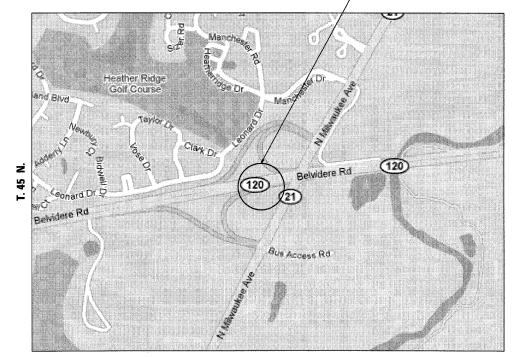


TRAFFIC DATA SPEED LIMIT = 55 MPH 2009 ADT = 37,900

TRAFFIC DATA SPEED LIMIT = 45 MPH 2009 ADT = 13,200


R. 11 E.

- LOCATION 3 - MCHENRY COUNTY STRUCTURE NUMBER: 056-0020 U.S. ROUTE 12 OVER NIPPERSINK CREEK OVERFLOW LOCATED IN BURTON AND MCHENRY TOWNSHIPS VILLAGE OF SPRING GROVE

- LOCATION 1 - LAKE COUNTY STRUCTURE NUMBER: 049-0044 (WB) & 049-0045 (EB) ILLINOIS ROUTE 120 OVER A STREAM LOCATED IN WARREN TOWNSHIP VILLAGE OF GURNEE

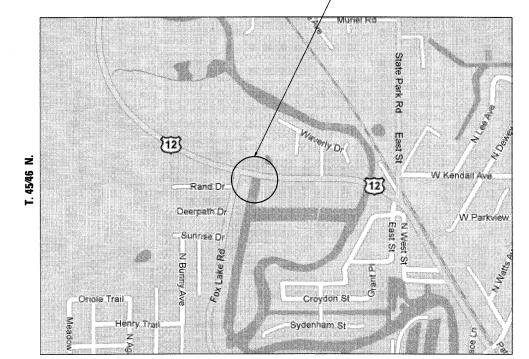

R. 9 E.

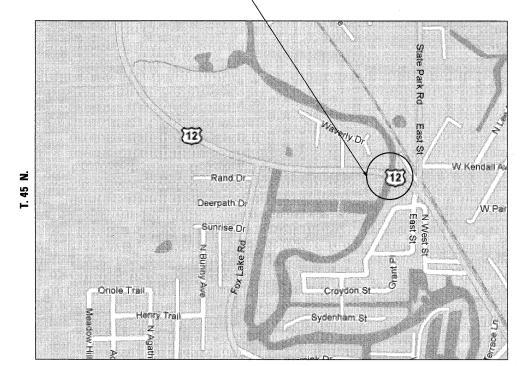

R. 9 E.

TRAFFIC DATA
SPEED LIMIT = 55 MPH
2009 ADT = 5,600

LOCATION 4 - MCHENRY COUNTY
STRUCTURE NUMBER: 055-0037
ILLINOIS ROUTE 31 OVER NIPPERSINK CREEK
LOCATED IN RICHMOND TOWNSHIP
VILLAGE OF RICHMOND

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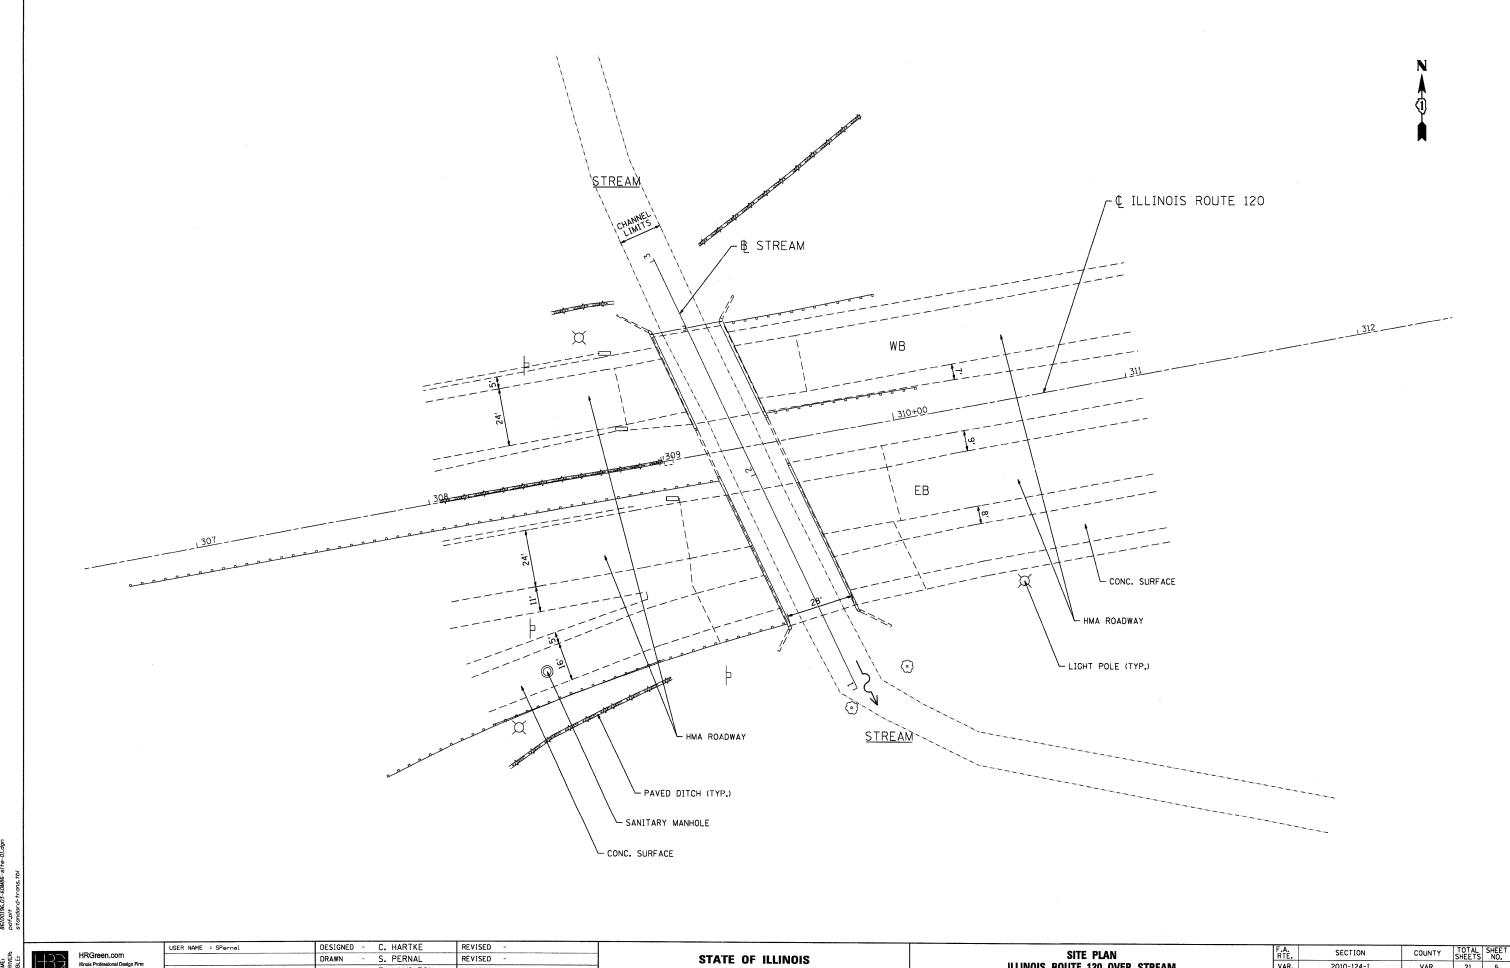
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# 184-001322

 USER NAME = SPernal	DESIGNED	-	C. HARTKE	REVISED -
	DRAWN	-	S. PERNAL	REVISED -
PLOT SCALE = N/A	CHECKED	-	T. HAMILTON	REVISED -
PLOT DATE = 7/20/2011	DATE	-	7/20/11	REVISED -

STATE OF ILLINOIS
DEPARTMENT OF TRANSPORTATION

_							
	LOCATION MAPS		F.A. RTE.	SECTION	COUNTY	TOTAL SHEETS	SHEET NO.
	SCOUR COUNTERMEASURES	3	VAR.	2010-124-1	VAR.	21	4
	6015				CONTRACT	NO.	60M86
	SCALE: N/A SHEET NO. 1 OF 1 SHEETS STA.	TO STA.	FED. RO	AD DIST. NO. ILLINOIS FED. AL	D PROJECT		


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CHECKED - T. HAMILTON
DATE - 7/19/11 PLOT SCALE = 1'=20' REVISED PLOT DATE = 7/19/2011 REVISED

STATE OF ILLINOIS
DEPARTMENT OF TRANSPORTATION

SITE PLAN
ILLINOIS ROUTE 120 OVER STREAM SCALE: 1"=20" SHEET NO. 1 OF 2 SHEETS STA. 308+00 TO STA. 311+00




CHECKED - T. HAMILTON
DATE - 7/19/11 PLOT SCALE = 1'=20' REVISED REVISED PLOT DATE = 7/19/2011

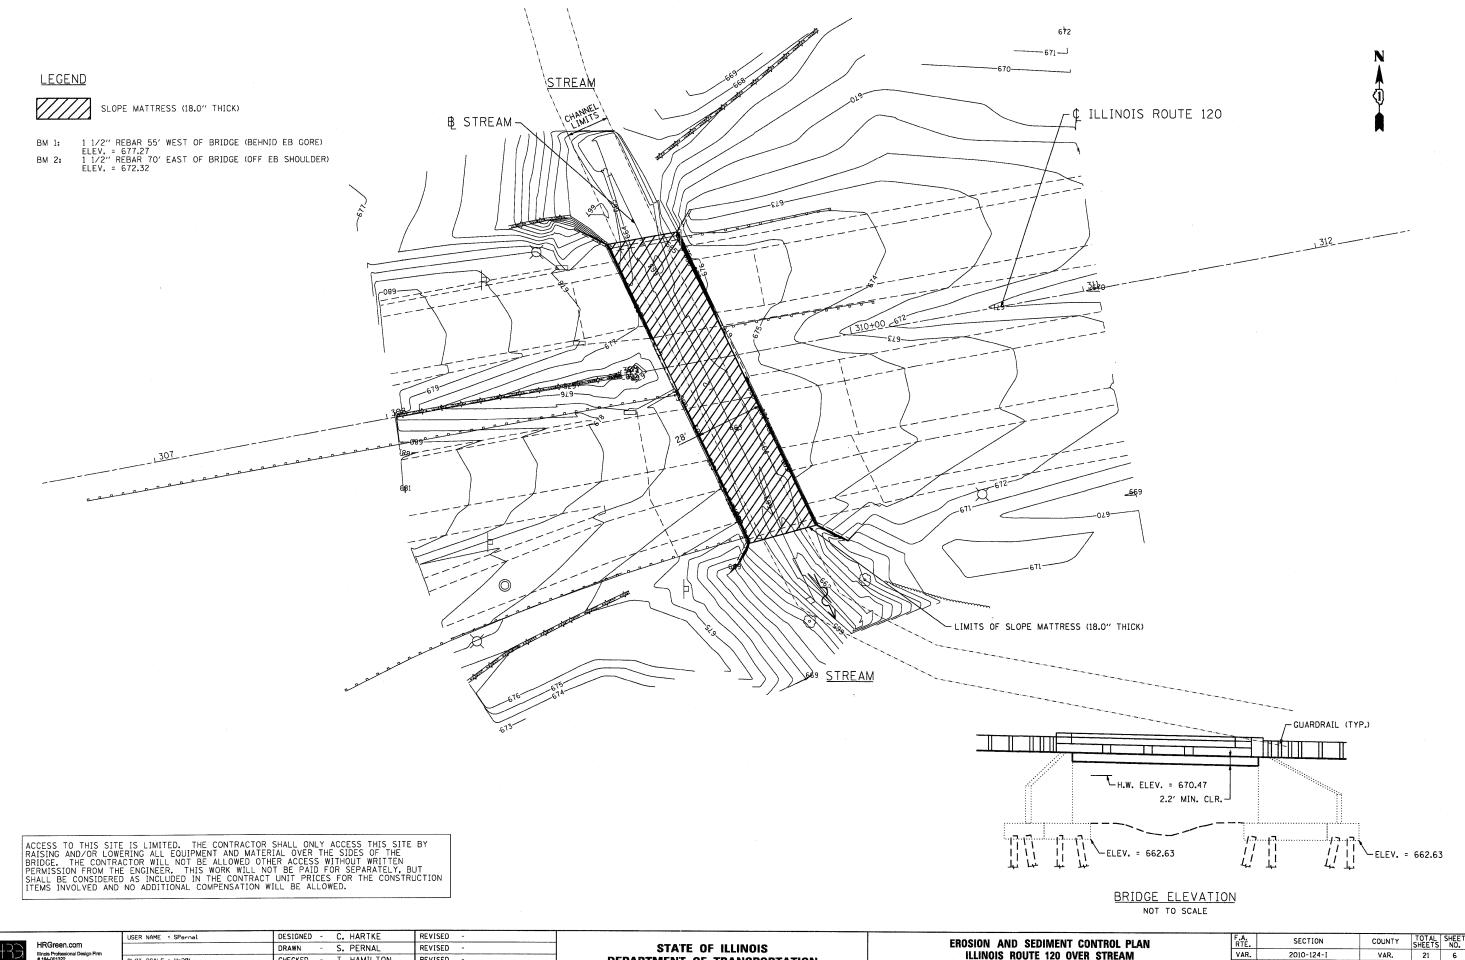**DEPARTMENT OF TRANSPORTATION** 

ILLINOIS ROUTE 120 OVER STREAM SHEET NO. 2 OF 2 SHEETS STA. 308+00 TO STA. 311+00

VAR. 21 6 SN. 049-0044 & 049-0045 CONTRACT NO. 60M86 FED. ROAD DIST. NO. | ILLINOIS FED. AID PROJECT

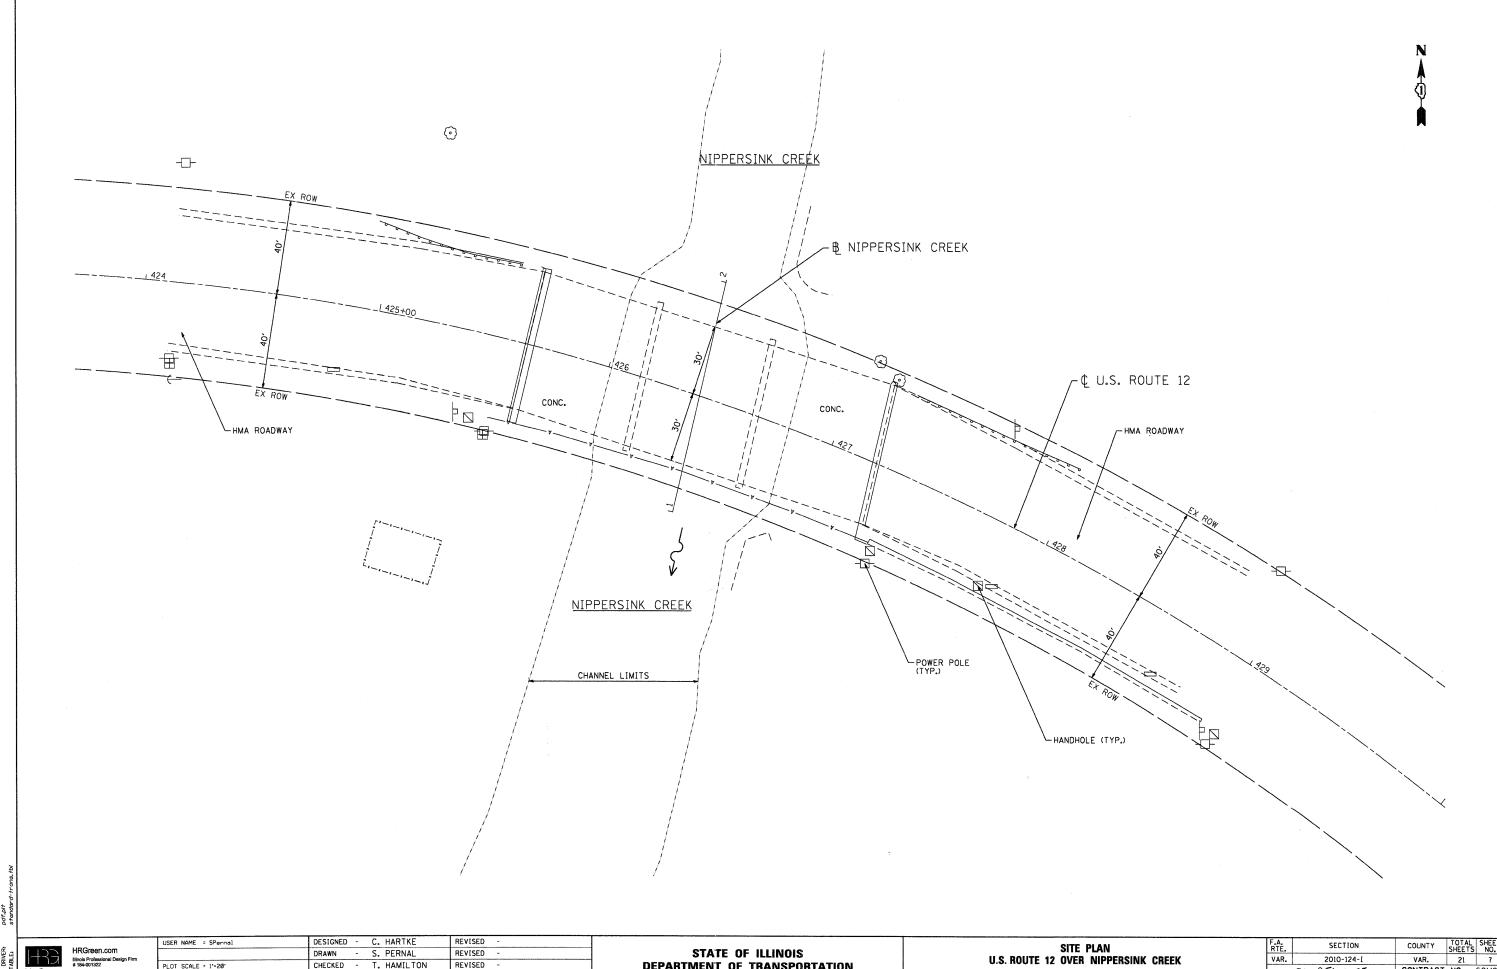

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CHECKED - T. HAMILTON REVISED -PLOT SCALE = 1'=20' PLOT DATE = 7/19/2011 - 7/19/11 REVISED -


STATE OF ILLINOIS DEPARTMENT OF TRANSPORTATION

SHEET NO. 1 OF 2 SHEETS STA. 425+00 TO STA. 428+00

COUNTY TOTAL SHEETS NO.

VAR. 21 7

CONTRACT NO. 60M86 2010-124-I FED. ROAD DIST. NO. | ILLINOIS FED. AID PROJECT

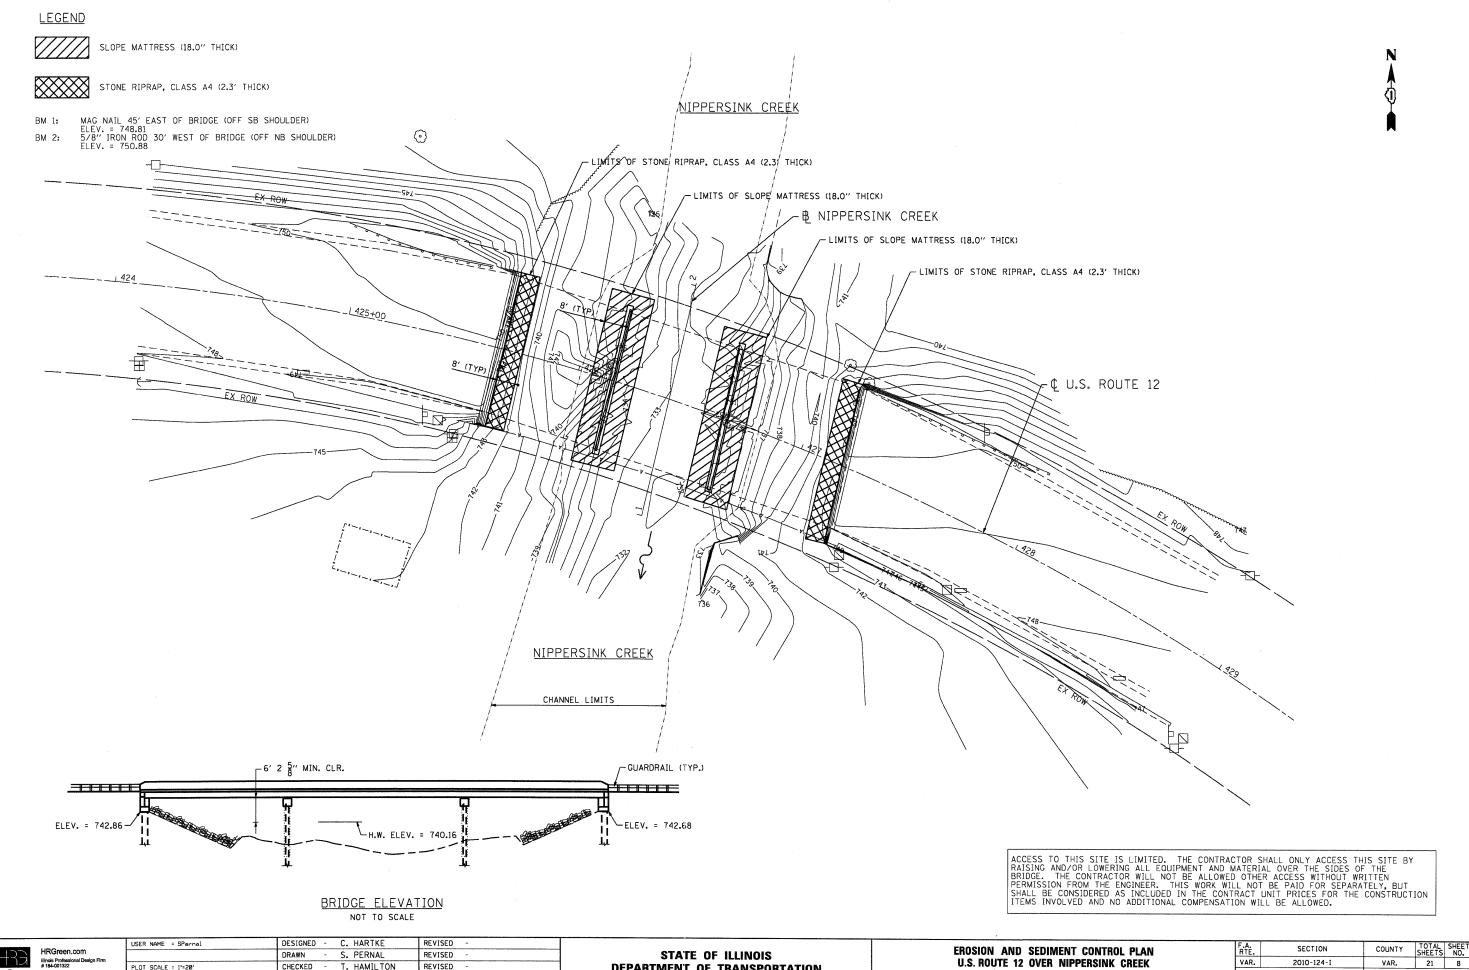


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**DEPARTMENT OF TRANSPORTATION** 

U.S. ROUTE 12 OVER NIPPERSINK CREEK SHEET NO. 2 OF 2 SHEETS STA. 425+00 TO STA. 428+00


SN. 056-0057 CONTR CONTRACT NO. 60M86

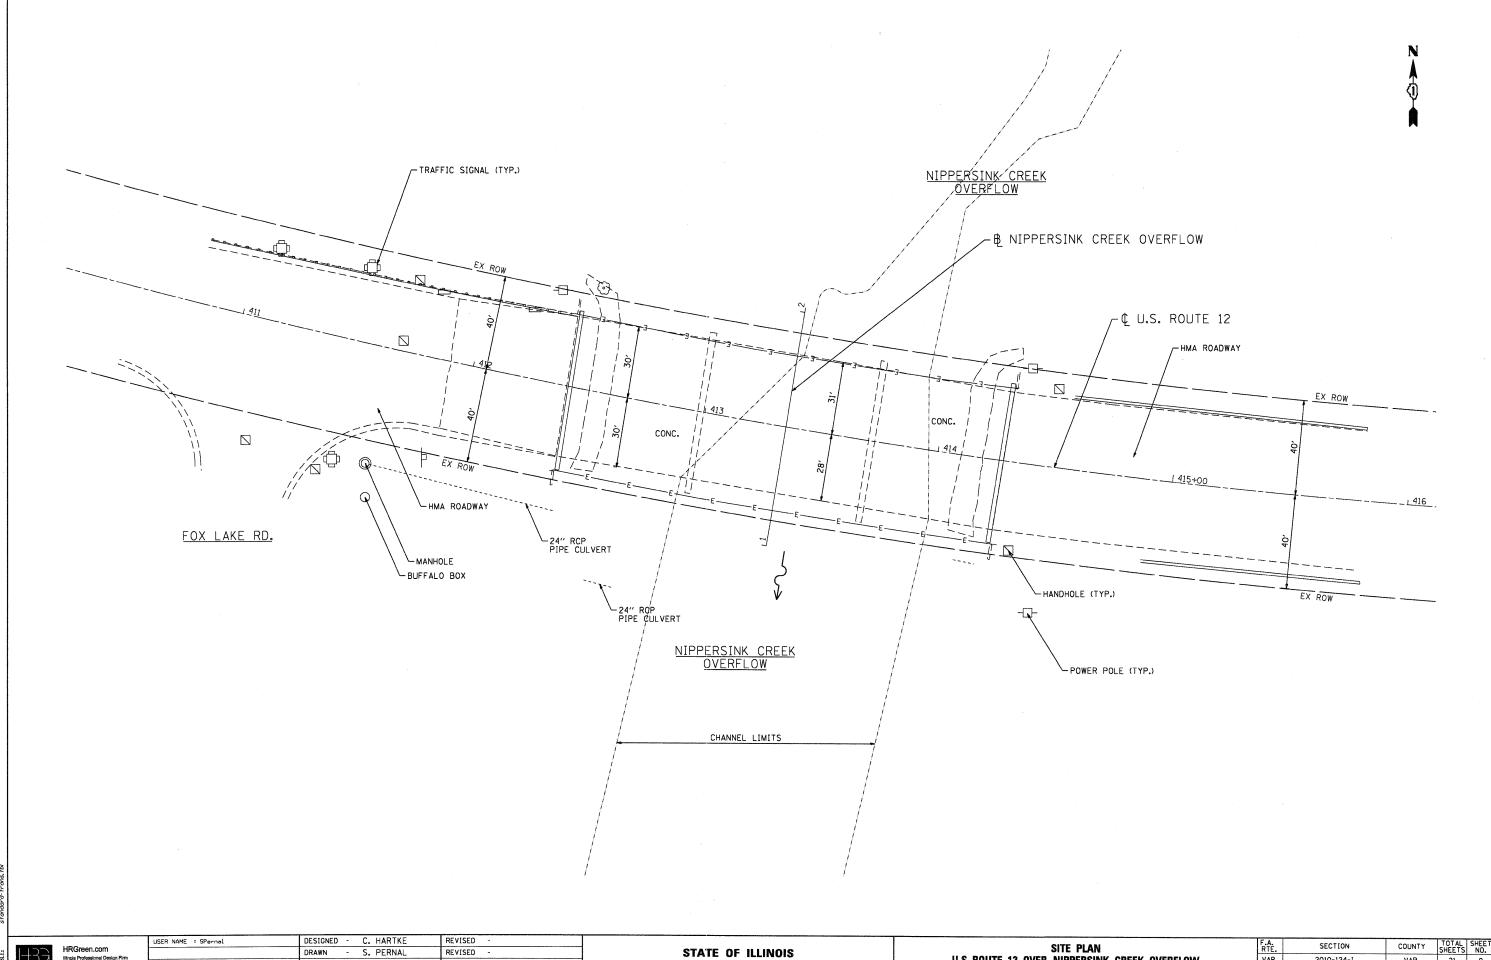

CHECKED - T. HAMILTON PLOT SCALE = 1'=20' REVISED PLOT DATE = 7/19/2011 - 7/19/11 REVISED

**DEPARTMENT OF TRANSPORTATION** 

SITE PLAN
U.S. ROUTE 12 OVER NIPPERSINK CREEK OVERFLOW SCALE: 1"=20' SHEET NO. 1 OF 2 SHEETS STA. 411+00 TO STA. 415+00

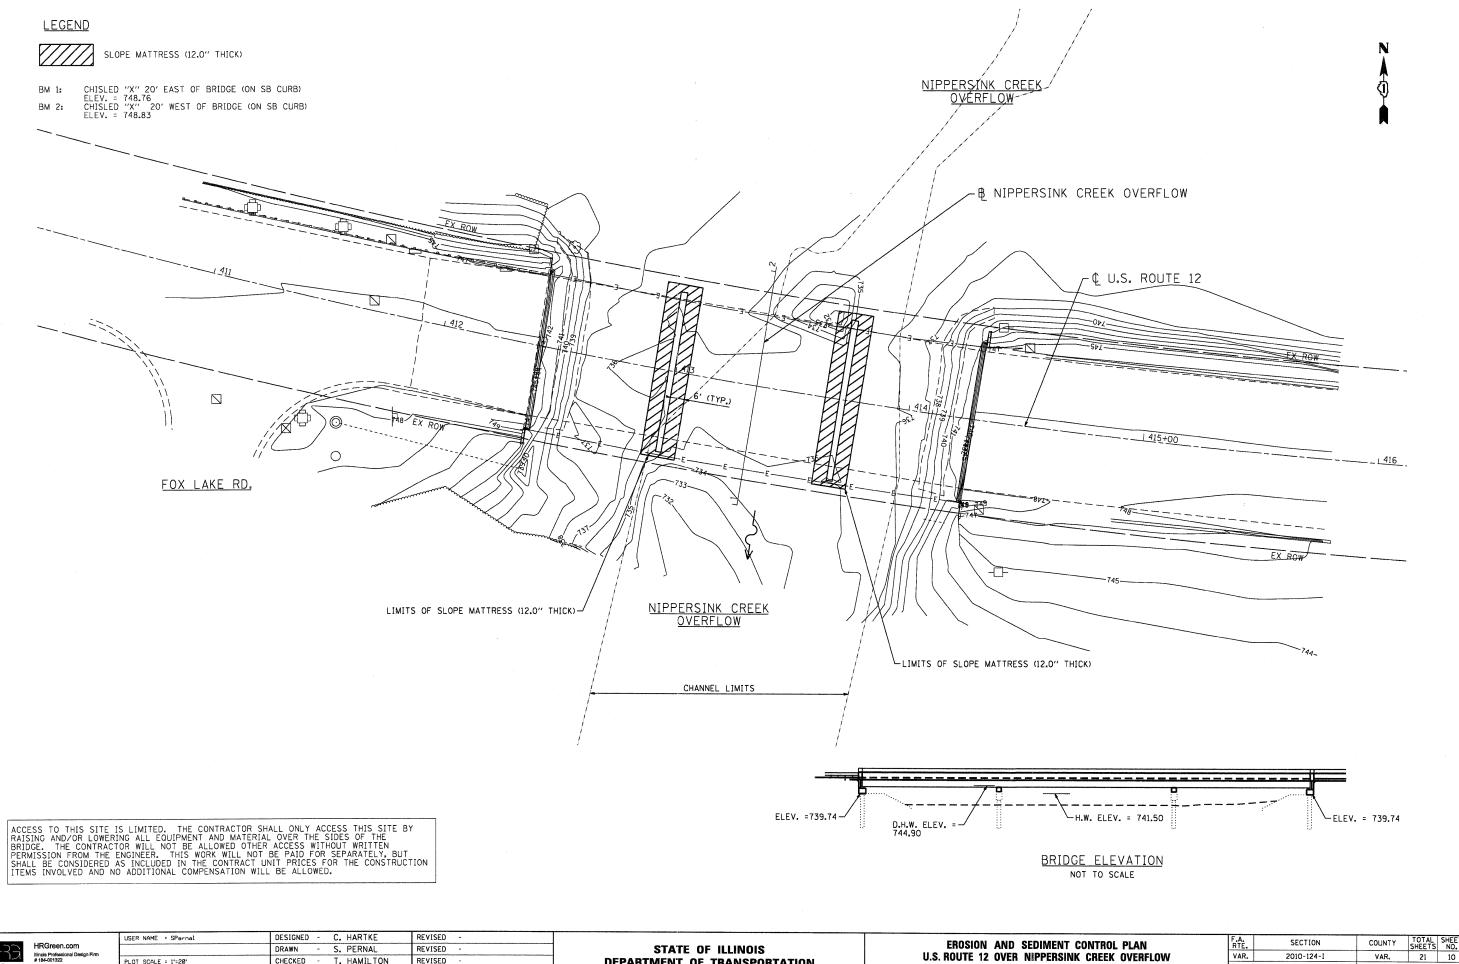

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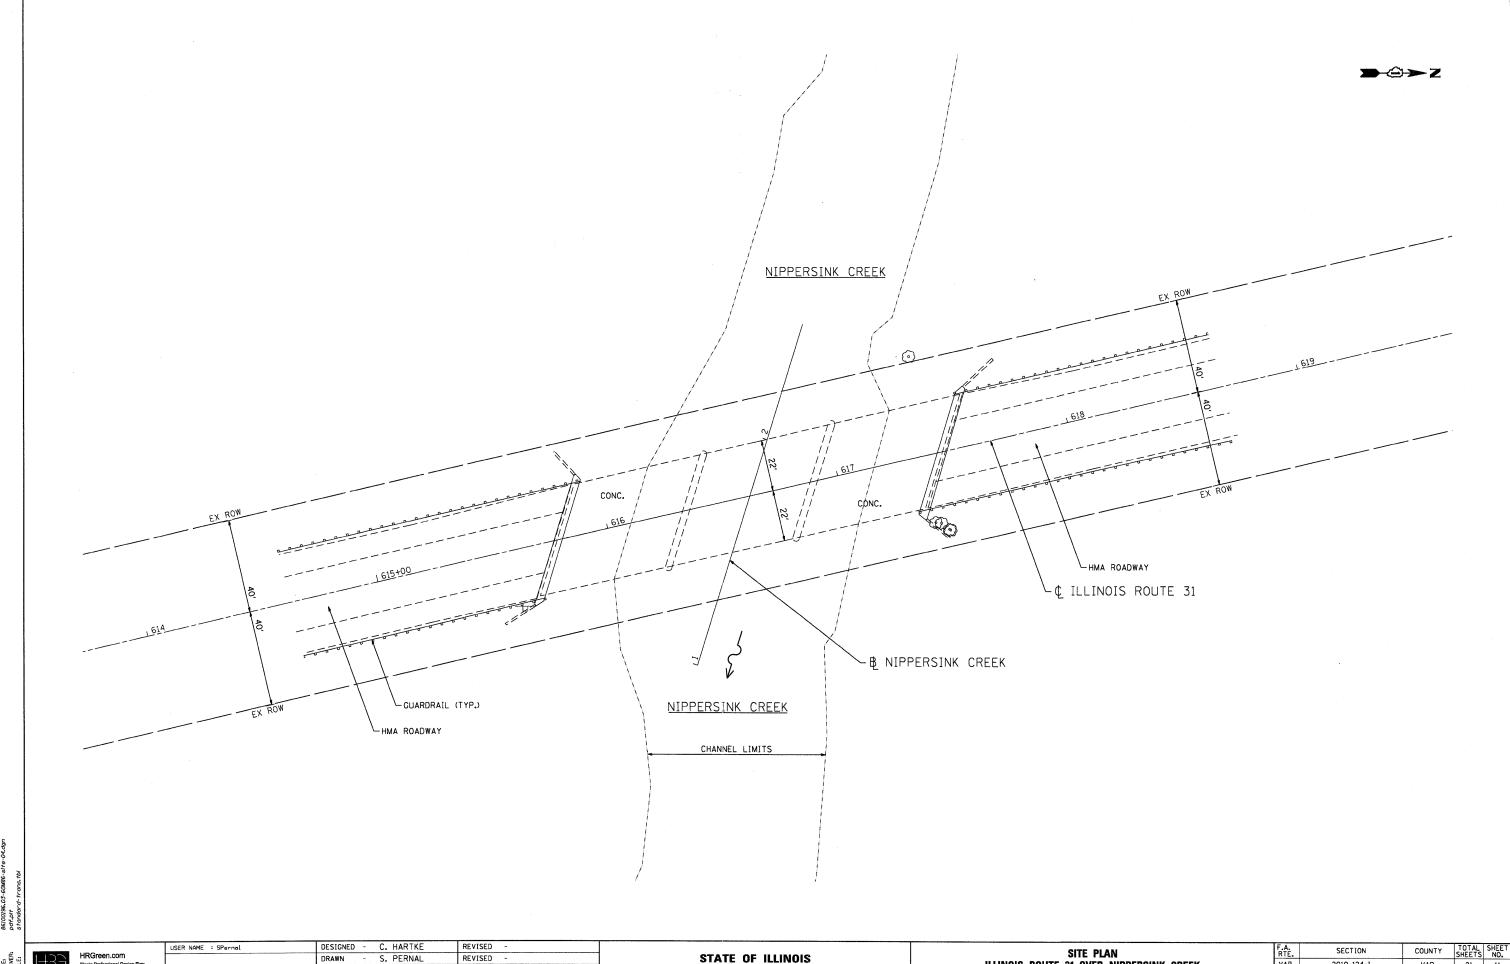
**DEPARTMENT OF TRANSPORTATION** 

SHEET NO. 2 OF 2 SHEETS STA. 411+00 TO STA. 415+00

SCALE: 1"=20"

VAR. 21 10 FED. ROAD DIST. NO. ILLINOIS FED. AID PROJECT CONTRACT NO. 60M86


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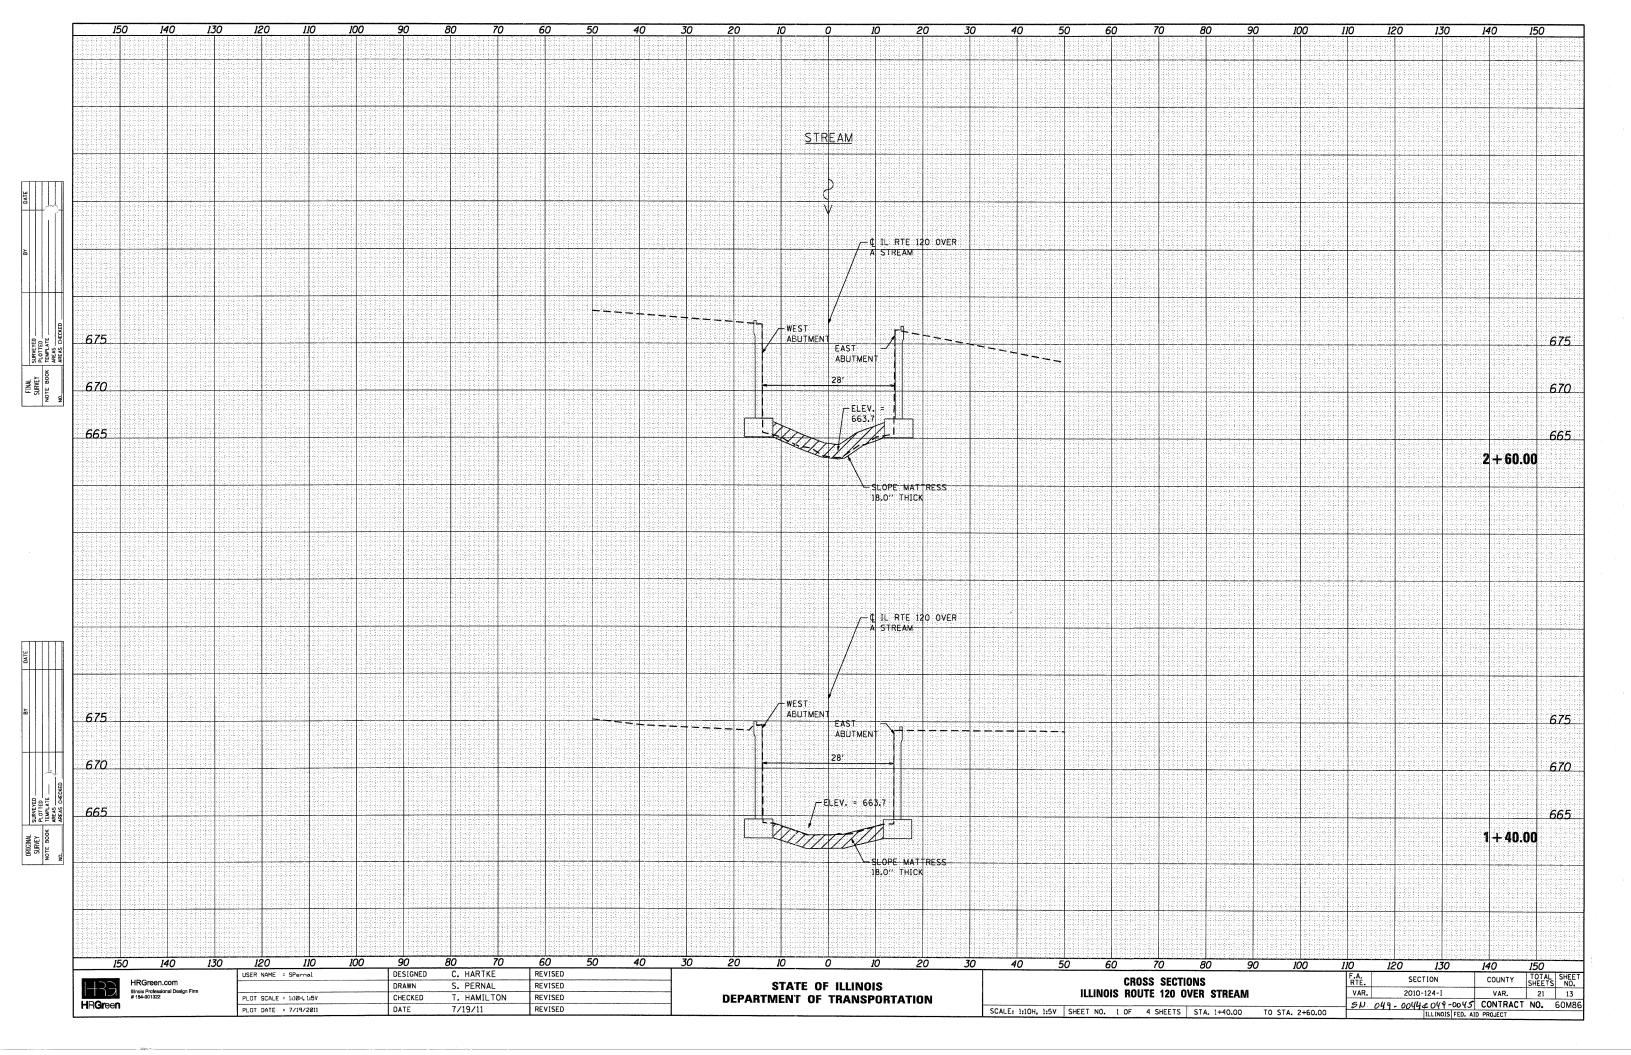
STATE OF ILLINOIS DEPARTMENT OF TRANSPORTATION


SITE PLAN ILLINOIS ROUTE 31 OVER NIPPERSINK CREEK SCALE: 1"=20' SHEET NO. 1 OF 2 SHEETS STA. 614+50 TO STA. 618+50





VAR. 21 12 CONTRACT NO. 60M86 FED. ROAD DIST. NO. | ILLINOIS FED. AID PROJECT


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TRAFFIC CONTROL AND PROTECTION FOR SIDE ROADS, INTERSECTIONS, AND DRIVEWAYS
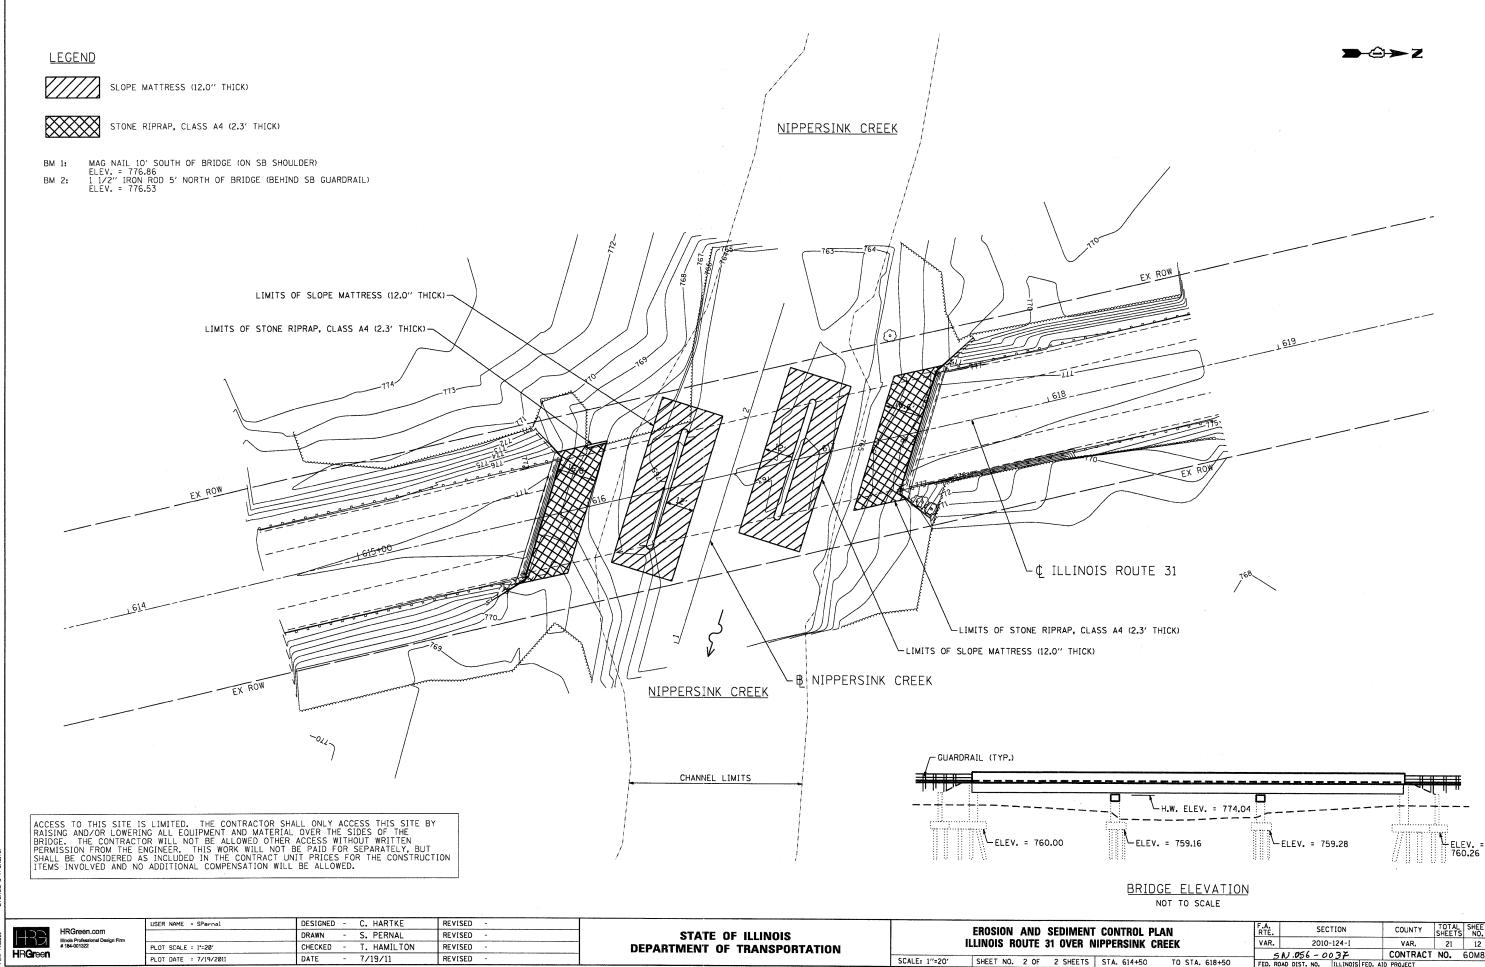
## NOTES:

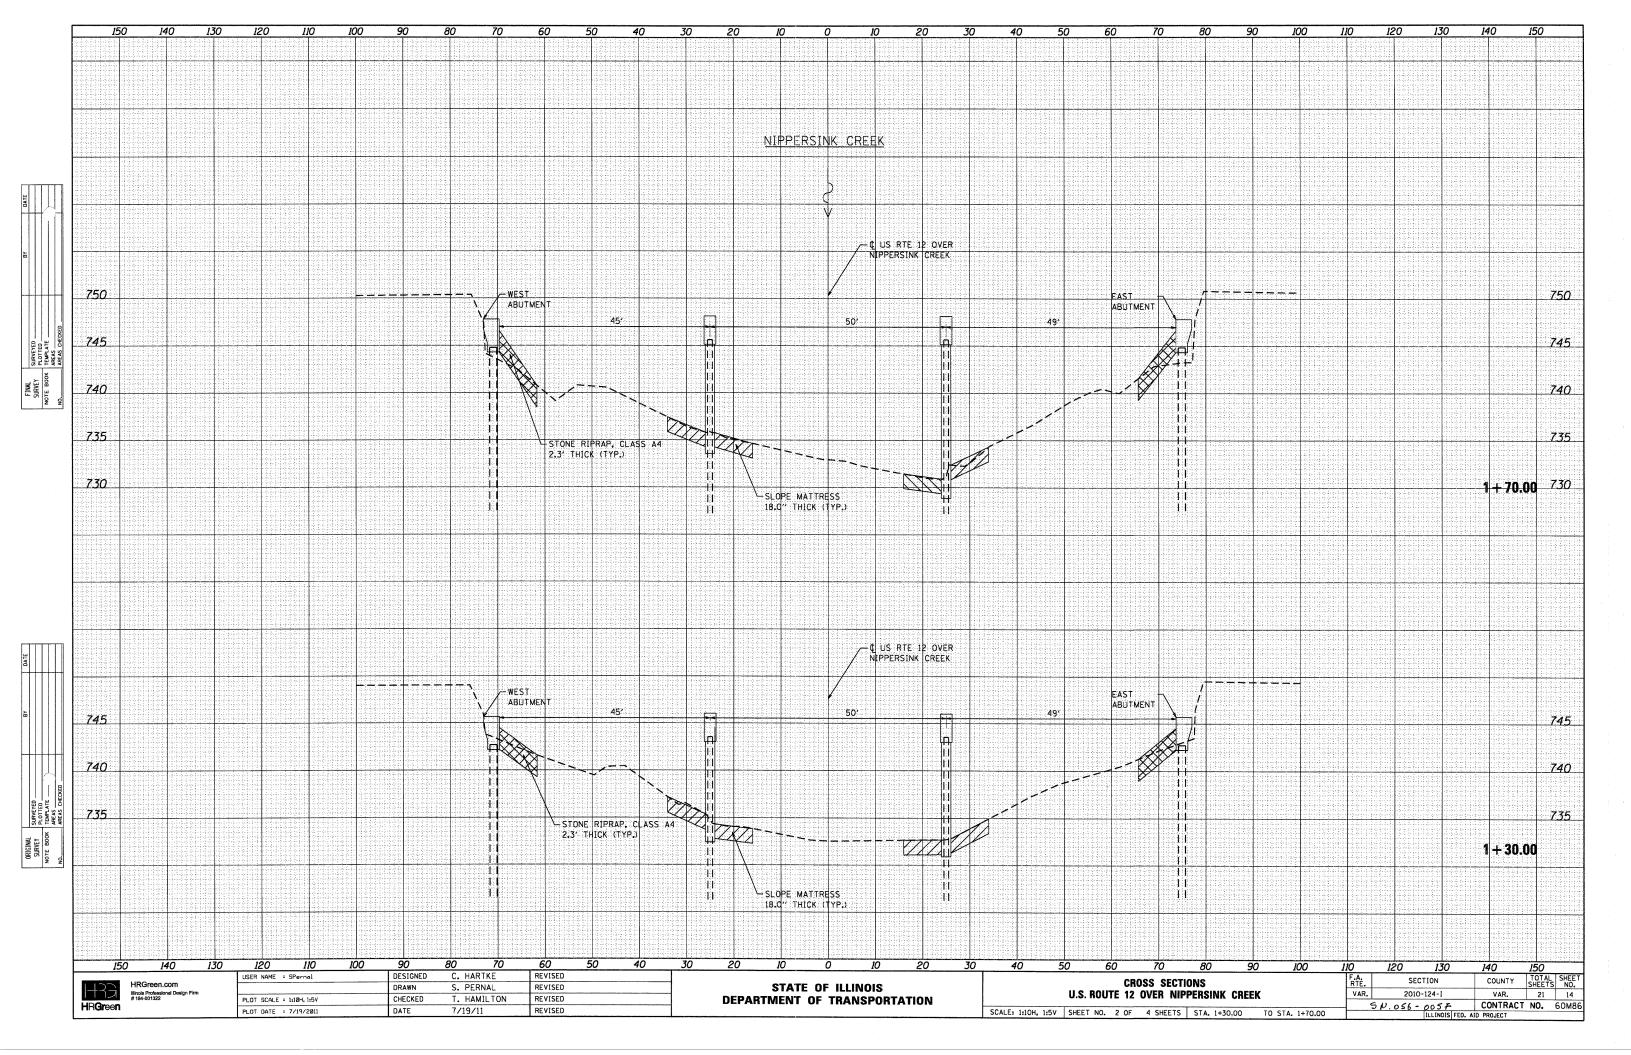- A, FOR NO LANE RESTRICTION ON THE SIDE ROAD OR DRIVEWAYS
- 1. SIDE ROAD WITH A SPEED LIMIT OF 40 MPH (60 km/h) OR LESS AS SHOWN ON THE DRAWING AND AS DIRECTED BY THE ENGINEER:
- OF ONE ROAD CONSTRUCTION AHEAD SIGN 36 x 36 (900×900) WITH A FLASHER AND FLAG MOUNTED ON IT APPROXIMATELY 200' (60 m) IN ADVANCE OF THE MAIN ROUTE.
- b) THE CLOSED PORTION OF THE MAIN ROUTE SHALL BE PROTECTED BY BLOCKING WITH TYPE I, TYPE II OR TYPE III BARRICADES, 1/3 OF THE CROSS SECTION OF THE CLOSED PORTION.
- 2. SIDE ROAD WITH A SPEED LIMIT GREATER THAN 40 MPH (60 km/h) AS SHOWN ON THE DRAWING AND AS DIRECTED BY THE ENGINEER:
- 01 ONE ROAD CONSTRUCTION AHEAD SIGN 48 x 48 (1.2 m x 1.2 m) WITH A FLASHER MOUNTED ON IT APPROXIMATELY 500' (150 m) IN ADVANCE
- b) THE CLOSED PORTION OF THE WAIN ROUTE SHALL BE PROTECTED BY BLOCKING WITH TYPE III BARRICADES, 1/2 OF THE CROSS SECTION OF THE CLOSED PORTION.
- 3. WHEN THE SIDE ROAD LIES BETWEEN THE BEGINNING OF THE WAINLINE SIGNING AND THE WORK ZONE, A SINGLE HEADED ARROW (M6-1) SHALL BE USED IN LIEU OF THE DOUBLE HEADED ARROW (M6-4).

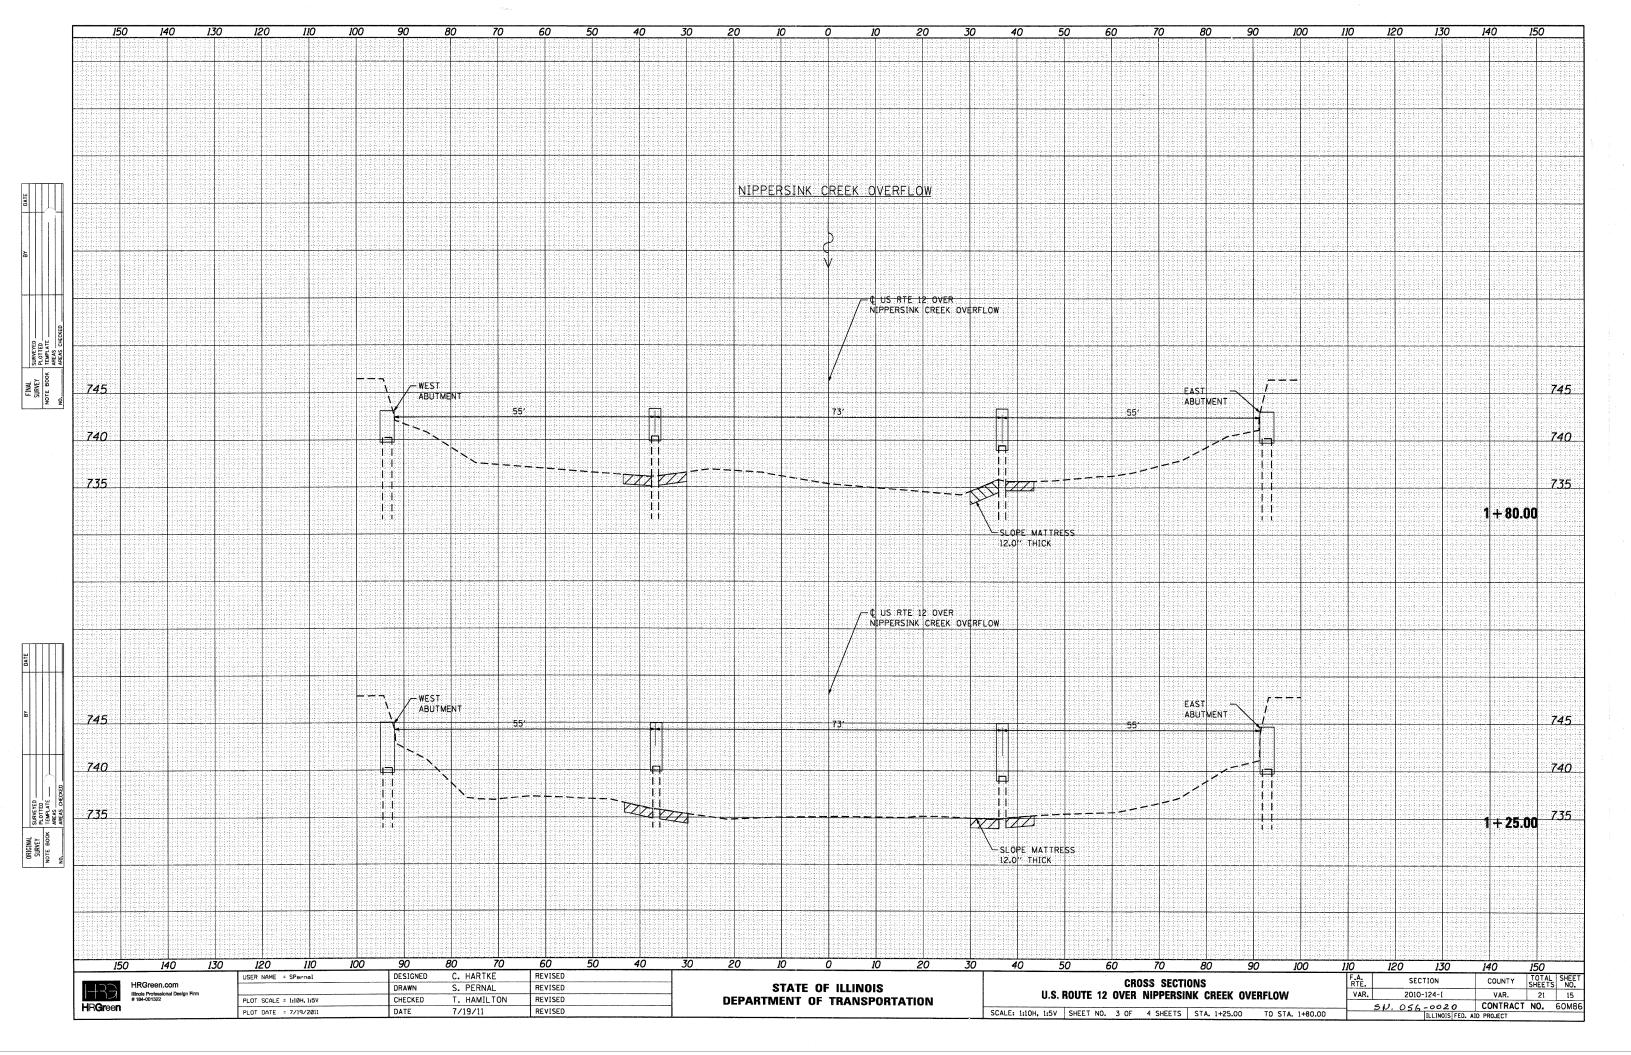- B. FOR A LANE CLOSURE ON A SIDE ROAD OR DRIVEWAYS
- USE APPLICABLE PORTIONS OF THE TYPICAL APPLICATION OF TRAFFIC CONTROL DEVICES (STD. 701501, STD. 701606 OR THE APPROPRIATE STANDARD). THE SPACING OF SIGNS AND BARRICADES SHALL BE ADJUSTED FOR FIELD CONDITIONS AS DIRECTED BY THE ENGINEER. THE DIRECTIONAL ARROW SHALL BE COVERED OR REMOVED WHEN NO LONGER CONSISTENT WITH THE
- C. ADVANCE WARNING SIGNS ARE TO BE OMITTED ON DRIVEWAY UNLESS
- D. THE TRAFFIC CONTROL AND PROTECTION FOR SIDE ROADS, INTERSECTIONS, AND DRIVEWAYS SHALL BE INCIDENTAL TO THE COST OF SPECIFIED TRAFFIC CONTROL STANDARDS OR ITEMS.

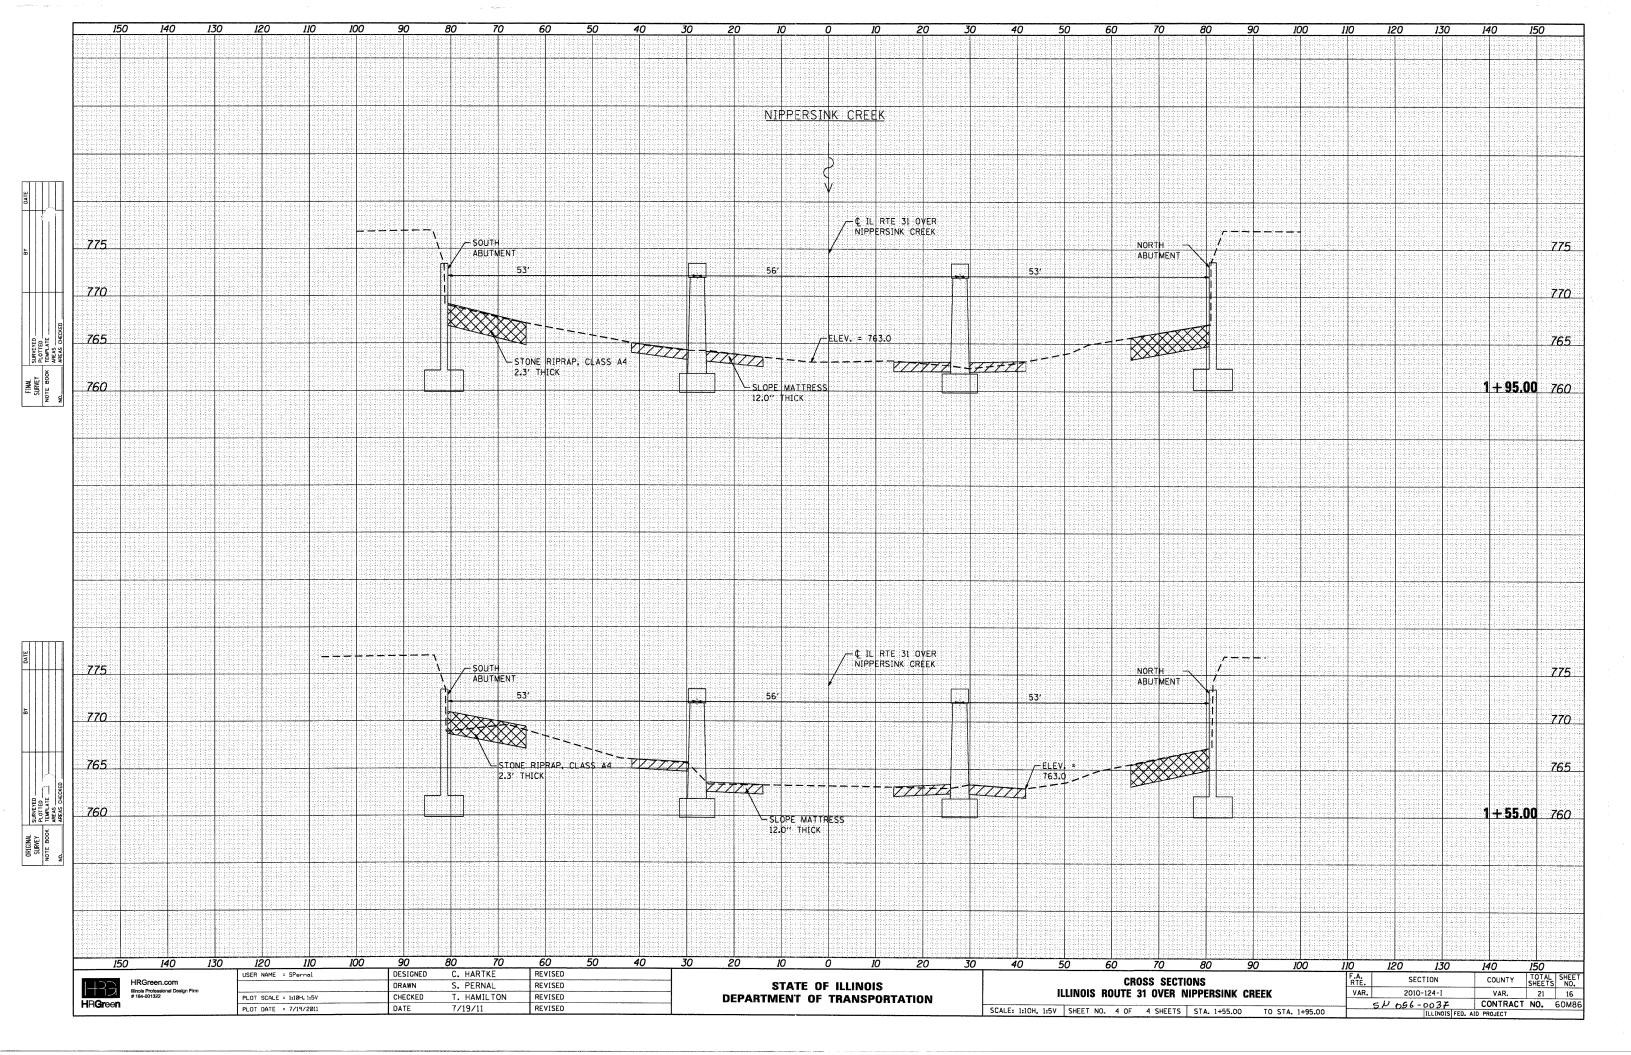
All dimensions are in millimeters (inches) Unless otherwise shown,

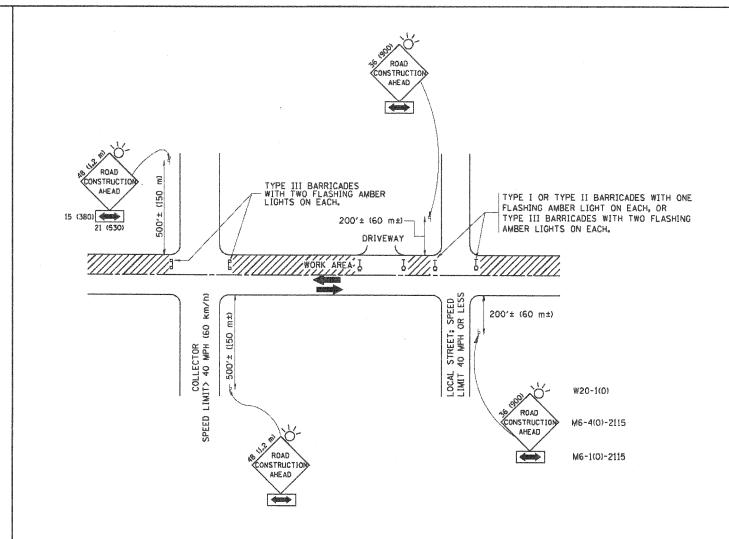HRGreen.com **HRGreen** 

USER NAME = geglienobt	DESIGNED - LHA	REVISED - J. OBERLE 10-18-95
	DRAWN -	REVISED - A. HOUSEH 03-06-96
PLOT SCALE : 50.000 '/ IN,	CHECKED -	REVISED - A. HOUSEH 10-15-96
PLOT DATE : 1/4/2008	DATE - 06-89	REVISED -T. RAMMACHER 01-06-00

STATE OF ILLINOIS DEPARTMENT OF TRANSPORTATION

TRAFFIC CONTROL AND PROTECTION FOR	F.A.	SECTION	COUNTY	TOTAL SHEETS	SHEET NO.
SIDE ROADS, INTERSECTIONS, AND DRIVEWAYS	VAR.	2010-124-1	VAR.	21	17
		TC-10	CONTRACT	NO.	60M86
SCALE: NONE SHEET NO. 1 OF 5 SHEETS STA. TO STA.	FEO. R	OAD DIST. NO. 1 ILLINOIS FED. AT	D PROJECT		

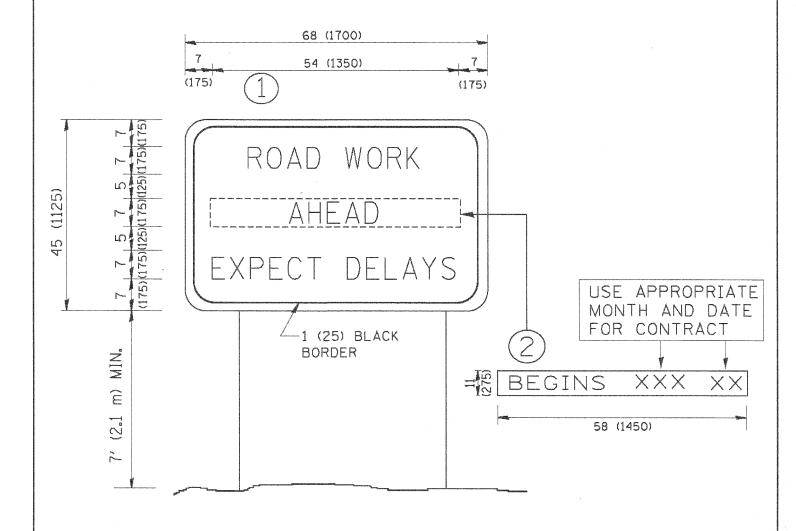

# NOTES:

- 1. USE BLACK LETTERING ON ORANGE BACKGROUND.
- 2. ERECT SIGNS IN ADVANCE OF THE LOCATION FOR THE "ROAD CONSTRUCTION AHEAD" SIGN AT LOCATIONS AS DIRECTED BY THE ENGINEER.
- 3. ERECT SIGN () WITH INSTALLED PANEL (2) ONE WEEK PRIOR TO THE START OF CONSTRUCTION.
- 4. REMOVE PANEL 2 SOON AFTER THE START OF CONSTRUCTION.
- 5. SEE SPECIAL PROVISION FOR "TEMPORARY INFORMATION SIGNING" FOR ADDITIONAL INFORMATION.
- 6. ONE SIGN ASSEMBLY EQUALS 25.70 SQ. FT. (2.3 SQ. M.)
- 7. SHALL BE PAID FOR AS TEMPORARY INFORMATION SIGNING.

ALL DIMENSIONS ARE IN INCHES (MILLIMETERS)
UNLESS OTHERWISE SHOWN.

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NITACT: SIPROJECT. CONTACT)
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USER NAME = geglienobt	DESIGNED -	REVISED	-	R. MIRS 09-15-97
	DRAWN -	REVISED	-	R. MIRS 12-11-97
PLOT SCALE = 52,000 // IN.	CHECKED -	REVISED	-7.	RAMMACHER 02-02-99
PLOT DATE = 1/4/2008	DATE -	REVISED	-	C. JUCIUS 01-31-07

STATI	E OF	ILLINOIS
DEPARTMENT	OF T	TRANSPORTATION

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		ARTERIAL ROAD					F.A. RTÉ.	1	SE	CTION		COUNTY	TOTAL SHEETS	SHEE NO.			
-	INFORMATION SIGN						VAR.		2010	)-124-I		VAR.	21	18			
-	66116	h (19) a 19"										TC-2	***			NO.	60M8
_	SCALEs	NUNE	SHEET	NO.	2 OF	5	SHEETS	STA.	TO STA.	FED. F	ROAD DE	ST. ND. 1	ILL[NOIS	FEO. AII	) PROJECT		

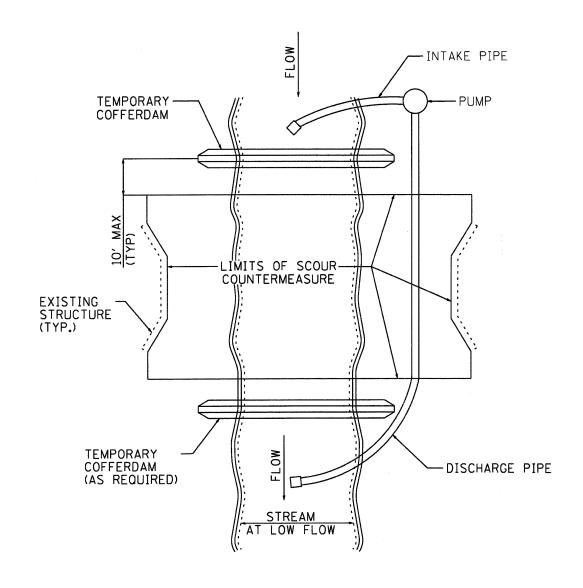


FIGURE D1. TEMPORARY COFFERDAM WITH PUMP BYPASS

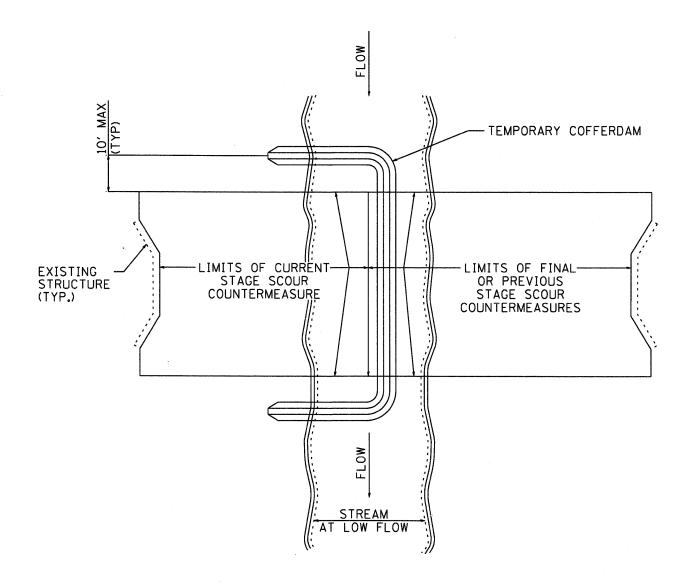


FIGURE D2. STAGED IN-STREAM COFFERDAM DIVISION

NOTE: DEWATERING SYSTEM DETAILS SHALL BE USED IN CONJUCTION WITH THE PROJECT SPECIAL PROVISIONS.

PLOT DRIVER: pdf.

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STATE OF ILLINOIS
DEPARTMENT OF TRANSPORTATION

DEWATERING SYSTEM DETAILS
SCOUR COUNTERMEASURES

SHEET NO. 3 OF 5 SHEETS STA. TO STA.


F.A. SECTION COUNTY TOTAL SHEET NO.

VAR. 2010-124-I VAR. 21 19

CONTRACT NO. 60M86

.

SCALE: N/A

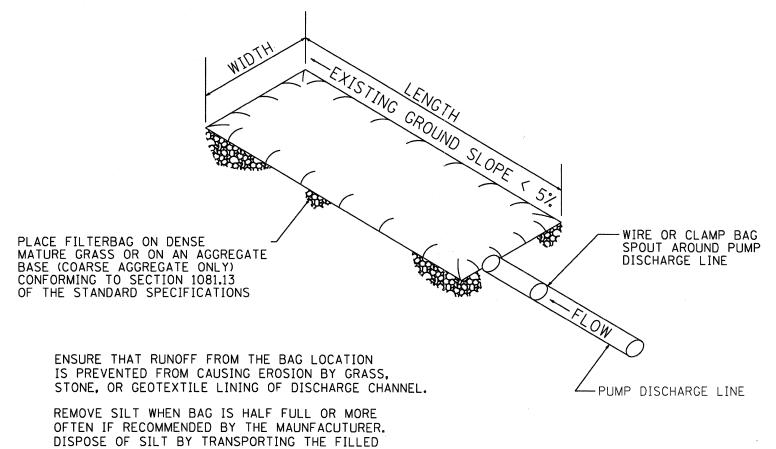

BAG TO DISPOSAL AREA. SLIT THE BAG, BLEND SILT INTO EXISTING TOPOGRAPHY, SEED AND MULCH

MAINTAIN EXTRA FILTER BAGS ON SITE. REPLACE DAMAGED BAGS PROMPTLY.

TYPICAL FLOW RATE: 10 GPM × W × L

FIGURE S1. SEDIMENT FILTER BAG

NOTE: DEWATERING SYSTEM DETAILS SHALL BE USED IN CONJUCTION WITH THE PROJECT SPECIAL PROVISIONS.


1: \$FPROJECT.CONTACT)
\$fCLIENT)
7/19/2011 3:19:34 PM
86100196.03-det-04.dgn
pdf.pH
standard-trans.tbl

PROJECT CONTACT: SFLOMENT SPROJECT CONTACT: SPROJECT CONTACT: SPROJECT CONTACT: SPROJECT SPRO


HR3 IR <b>Gr</b> een		USER NAME = SPernal	DESIGNED -	REVISED -	
	HRGreen.com Illinois Professional Design Firm		DRAWN -	REVISED -	
	# 184-001322	PLOT SCALE = N/A	CHECKED -	REVISED -	
		PLOT DATE = 7/19/2011	DATE - 7/19/11	REVISED -	

STATI	E OF	ILLINOIS
DEPARTMENT	OF	TRANSPORTATION

	DEWATERING SYSTEM DETAILS									A. SECTION		COUNTY	TOTAL	SHEET NO.
SCOUR COUNTERMEASURES										VAR. 2010-124-I		VAR.	21	20
	SCALE: N/A	CUEET NO		4.05		CHEETC	67.					CONTRACT	NO.	60M86
_	SCALE: N/A	SHEET NO	· <u> </u>	4 OF		SHEETS	STA.	TO STA.	FED. RO	DAD DIST. NO.	ILLINOIS FED. A	ID PROJECT		

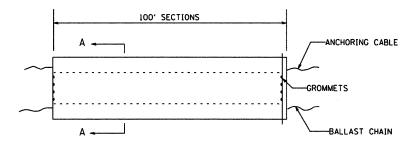

**ELEVATION** 

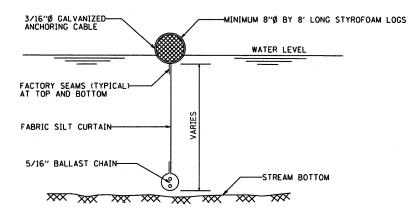


# SECTION A-A

# FLOTATION BOOM


# NOTES:

- FLOTATION BOOM SHALL BE ANCHORED TO PREVENT DRIFT SHOREWARD OR DOWNSTREAM. ANCHORAGES SHALL BE INSTALLED ON BOTH SHORE AND STREAM SIDE.
- 2. SHORE ANCHORS SHALL CONSIST OF A POST WITH DEADMAN OR APPROVED EQUAL. STREAM ANCHORS SHALL BE SUFFICIENT SIZE TO STABILIZE THE BARRIER WITH NUMBER AND SPACING DEPENDENT ON WATERWAY VELOCITIES.
- FABRIC SECTIONS SHALL BE CONNECTED END TO END WITH MINIMUM 5/8" DIAMETER POLYPROPYLENE ROPE
- 4. DESIGN OF BOOM AND ANCHORAGE SHALL BE IN ACCORANDANCE WITH MANUFACTURER'S RECOMENDATIONS. BOTTOM OF BOOM SHALL REACH BOTTOM OF WATERWAY USING ONE OR TWO VERTICAL SECTIONS AS REQUIRED.
- 5. MAINTENANCE SHALL BE PERFORMED AS NEEDED. CONTRACTOR SHALL REMOVE THE BOOM AT COMPLETION OF WORK IN A MANNER THAT WILL PREVENT SILTATION OF THE WATERWAY.

APPLICATION: FLOTATION BOOMS TO BE USED TO CONTROL EROSION, TURBIDITY AND DEBRIS WHEN WORKING IN WATERWAYS.

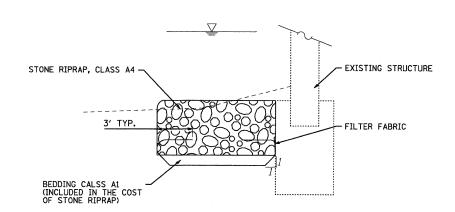

## FILTER FABRIC/ RIPRAP DETAIL

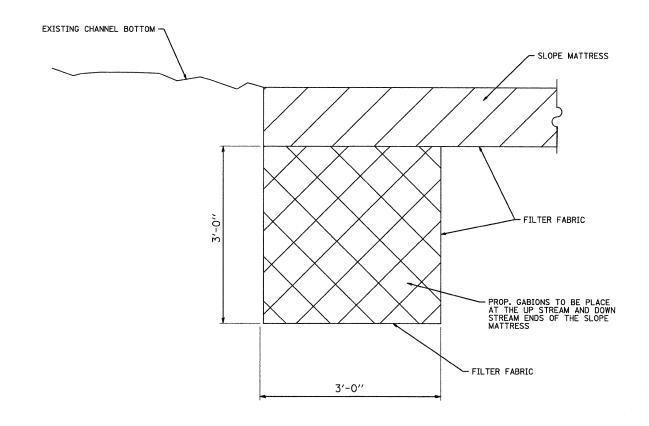

MATTRESS ANCHORING DETAIL

**HRGreen** 

HRGreen.com

_	USER NAME = JGuerri	DESIGNED	-		REVISED	-	
		DRAWN			REVISED		
	D. O. C.						
	PLOT SCALE = N/A	CHECKED			REVISED	-	
	PLOT DATE = 7/21/2011	DATE	-	7/21/11	REVISED	-	

STATE OF ILLINOIS **DEPARTMENT OF TRANSPORTATION** 

		F.A. SECTION		COUNTY	TOTAL SHEETS	SHEET NO.					
	SCOUR C	OUNTERM		VAR.	2010-	-124-I	VAR.	21	21		
						CONTRACT	NO.	60M8			
SCALE: N/A SHEET	T NO. 5 OF	5 SHEETS	STA.	TO STA.		FED. RO	DAD DIST. NO.	ILLINOIS FED. A	ID PROJECT		