

STATE OF ILLINOIS  
DEPARTMENT OF TRANSPORTATION

F.A.P. RTE.	SECTION	COUNTY	TOTAL SHEETS	SHEET NO.
104	105N-4	LAKE	113	1
ILLINOIS			CONTRACT NO. 60W06	

FOR INDEX OF SHEETS, SEE SHEET NO. 2

PROJECT IS LOCATED IN THE VILLAGE OF LAKE VILLA

TRAFFIC DATA:

ILL ROUTE 59:  
2011 ADT = 10,600 - 13,500  
SPEED LIMIT = 45 MPH

PETITE LAKE ROAD:  
2008 ADT = 3,500  
SPEED LIMIT = 40 MPH

PROPOSED  
HIGHWAY PLANS


FAP 104: IL. RTE. 59 (FOX LAKE ROAD)  
IL 132 (GRAND AVE.) TO HIGHWOODS DRIVE  
AND AT PETITE LAKE ROAD

SECTION 105N-4

PROJECT: ACNHPP-0104(021)

RESURFACING, INTERSECTION RECONSTRUCTION AND  
TRAFFIC SIGNAL INSTALLATION  
LAKE COUNTY

C-91-159-13

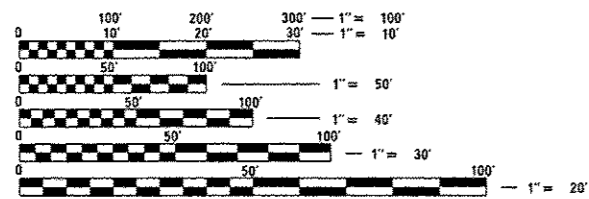

FULL SIZE PLANS HAVE BEEN PREPARED USING STANDARD ENGINEERING SCALES. REDUCED SIZED PLANS WILL NOT CONFORM TO STANDARD SCALES. IN MAKING MEASUREMENTS ON REDUCED PLANS, THE ABOVE SCALES MAY BE USED.

J.U.L.I.E.  
JOINT UTILITY LOCATION INFORMATION FOR EXCAVATION  
1-800-892-0123  
OR 811

PROJECT ENGINEER: JENPAI CHANG (847) 705-4432  
PROJECT MANAGER: FAWAD AQUEEL (847) 705-4247


CONTRACT NO. 60W06

IL ROUTE 59  
PROJECT ENDS  
STATION 526+88

IL ROUTE 59 RESURFACING LIMITS:  
STA. 447+96 TO STA. 491+58.60 &  
STA. 508+42.30 TO STA. 526+88

IL 59 INTERSECTION LIMIT:  
STA. 491+58.60 TO STA. 508+42.30

IL ROUTE 59  
PROJECT BEGINS  
STATION 447+96

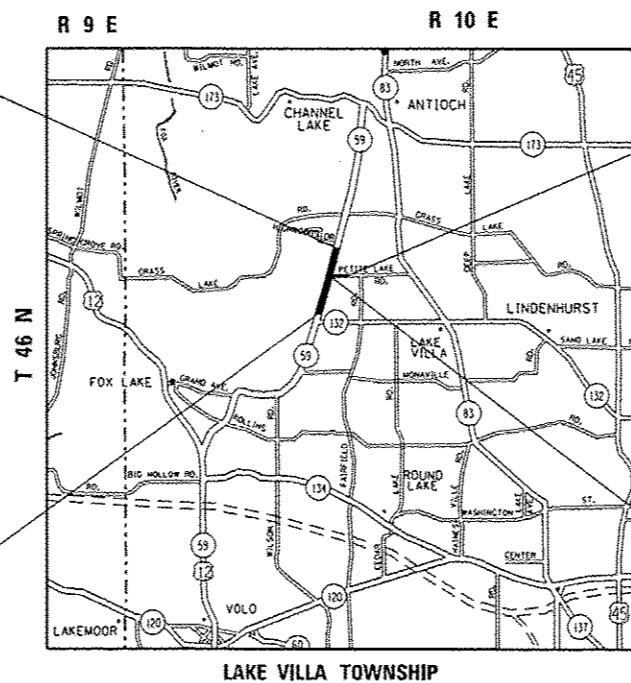

RECONSTRUCTION  
PETITE LAKE ROAD  
PROJECT ENDS  
STATION 208+67

RECONSTRUCTION  
PETITE LAKE ROAD  
PROJECT BEGINS  
STATION 200+45.32

ILL ROUTE 59: GROSS AND NET LENGTH = 7,892.00 FT. = 1.49 MILES  
PETITE LAKE ROAD: GROSS AND NET LENGTH = 848.42 FT. = 0.16 MILE

STATE OF ILLINOIS  
DEPARTMENT OF TRANSPORTATION

SUBMITTED August 12, 2016

*[Signature]*  
REGIONAL ENGINEER

Sept 30, 2016  
*[Signature]*  
ENGINEER OF DESIGN AND ENVIRONMENT

Sept 30, 2016  
*[Signature]*  
DIRECTOR OF PROGRAM DEVELOPMENT

PRINTED BY THE AUTHORITY  
OF THE STATE OF ILLINOIS

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LIST OF STATE STANDARDS:

STANDARD NO.	DESCRIPTION
00001-06	STANDARD SYMBOLS, ABBREVIATIONS, AND PATTERNS
280001-07	TEMPORARY EROSION CONTROL SYSTEM
406201-01	MAILBOX TURNOUT
424001-08	PERPENDICULAR CURB RAMPS FOR SIDEWALKS
442201-03	CLASS C AND D PATCHES
482001-02	HMA SHOULDER ADJACENT TO FLEXIBLE PAVEMENT
482011-03	HMA SHLD, STRIPS / SHLDS, WITH RESURFACING OR WIDENING AND RESURFACING PROJECTS
542301-03	PRECAST REINFORCED CONCRETE FLARED END SECTION
542311-06	GRATING FOR CONCRETE FLARED END SECTION FOR 24" THRU 54" (600mm THRU 1350mm) PIPE
602001-02	CATCH BASIN TYPE A
602011-02	CATCH BASIN TYPE C
602401-03	MANHOLE TYPE A
602601-04	PRECAST REINFORCED CONCRETE FLAT SLAB TOP
604001-04	FRAME AND LIDS TYPE 1
604091-03	FRAME AND GRATE TYPE 24
604036-03	GRATE TYPE 8
606001-06	CONCRETE CURB TYPE B AND COMBINATION CONCRETE CURB AND GUTTER
630001-10	STEEL PLATE BEAM GUARDRAIL
630201-06	PCC / HMA STABILIZATION AT STEEL PLATE BEAM GUARDRAIL
630301-06	SHOULDER WIDENING FOR TYPE 1 (SPECIAL) GUARDRAIL TERMINALS
725001	REFLECTOR AND TERMINAL MARKER PLACEMENT
782006	REFLECTOR MARKERS AND MOUNTING DETAILS
701006-05	OFF-RD OPERATIONS, 2L, 2W, 15' (4.5 m) TO 24" (600 mm) FROM PAVEMENT EDGE
701011-04	OFF-RD MOVING OPERATIONS, 2L, 24, DAY ONLY
701301-04	LANE CLOSURE, 2L, 2W, SHORT TIME OPERATIONS
701306-03	LANE CLOSURE, 2L, 2W, SLOW MOVING OPERATIONS DAY ONLY, FOR SPEEDS >= 45 MPH
701311-03	LANE CLOSURE, 2L, 2W, MOVING OPERATIONS DAY ONLY
701326-04	LANE CLOSURE, 2L, 2W, PAVEMENT WIDENING OPERATIONS FOR SPEED >= 45 MPH
701336-06	LANE CLOSURE, 2L, 2W, WORK AREA IN SERIES FOR SPEEDS >= 45 MPH
701501-06	URBAN LANE CLOSURE, 2L, 2W, UNDIVIDED
701701-10	URBAN LANE CLOSURE, MULTILANE INTERSECTION
701901-05	TRAFFIC CONTROL DEVICES
814001-03	HANDHOLES
814006-02	DOUBLE HANDHOLES
857001-01	STANDARD PHASE DESIGNATION DIAGRAMS AND PHASE SEQUENCES
873001-02	TRAFFIC SIGNAL GROUNDING & BONDING
877001-06	STEEL MAST ARM ASSEMBLY AND POLE 16 FEET THROUGH 55 FEET

878001-10	CONCRETE FOUNDATION DETAILS
880001-01	SPAN WIRE MOUNTED SIGNALS AND FLASHING BEACON INSTALLATION
880006-01	TRAFFIC SIGNAL MOUNTING DETAILS
886001-01	DETECTOR LOOP INSTALLATIONS

LIST OF LAKE COUNTY STANDARDS:

STANDARD NO.	DESCRIPTION
LC2050	TEMPORARY DITCH CHECK INSTALLATION FOR ROADWAY OR DITCH
LC5402	JOINT TIES FOR CONCRETE PIPE
LC7800	TYPICAL PAVEMENT MARKINGS FOR COUNTY HIGHWAYS

GENERAL NOTES:

- BEFORE STARTING ANY EXCAVATION, THE CONTRACTOR SHALL CALL "JULIE AT (800) 892-0123 OR 811 FOR FIELD LOCATIONS OF BURIED ELECTRIC, TELEPHONE AND GAS FACILITIES, (48 HOURS NOTIFICATION IS REQUIRED).
- THE CONTRACTOR SHALL COORDINATE CONSTRUCTION ACTIVITIES WITH UTILITY COMPANIES AND LAKE COUNTY AND THE VILLAGE OF LAKE VILLA.
- THE CONTRACTOR WILL NOT BE ALLOWED TO SET UP A YARD OR FIELD OFFICE ON STATE PROPERTY WITHOUT WRITTEN PERMISSION FROM THE DEPARTMENT.
- BEFORE BEGINNING ANY WORK, THE CONTRACTOR SHALL RETAIN AND RECORD FOR FUTURE REFERENCE, ALL EXISTING PAVEMENT MARKING LINES (AND RAISED REFLECTIVE PAVEMENT MARKERS) IN ORDER THAT THESE LOCATIONS CAN BE RE-ESTABLISHED FOR STRIPING, EXACT LOCATIONS OF ALL PAVEMENT MARKINGS SHALL BE AS DIRECTED BY THE ENGINEER.
- TEN (10) FOOT TRANSITIONS SHALL BE USED TO MATCH PROPOSED CURB AND GUTTER AND MEDIAN ITEMS OF WORK TO EXISTING CURBS AND GUTTER AND MEDIANS IN THE FIELD, UNLESS OTHERWISE SHOWN, THE TRANSITIONS SHALL BE PAID AT THE CONTRACT UNIT PRICE FOR THE PROPOSED ITEMS OF WORK SPECIFIED.
- WHEN THE MILLED PAVEMENT IS OPEN TO TRAFFIC THE MAXIMUM GRADE DIFFERENTIAL BETWEEN PASSES OF THE MILLING MACHINE SHALL NOT EXCEED 1-1/2 INCHES (40 mm) WHERE THE SPEED LIMIT IS 40 MPH (80 km/h) OR LESS AND 1 INCH (25 mm) WHERE THE SPEED LIMIT IS GREATER THAN 40 MPH (80 km/h), WITH WRITTEN APPROVAL OF THE ENGINEER, A MAXIMUM GRADE DIFFERENTIAL OF 3 INCHES (75 mm) MAY BE ALLOWED IF THE EDGE OF THE MILLING IS SLOPED A MINIMUM 1:3 (V:H)
- BUTT JOINTS WILL BE INSTALLED AT THE ENDS OF ALL RESURFACING (WHERE RESURFACING MEETS EXISTING PAVEMENT) ACCORDING TO THE "BUTT JOINT AND HOT-MIX ASPHALT TAPER DETAILS" SHEET INCLUDED IN THE PLANS, UNLESS OTHERWISE SPECIFIED.
- THE THICKNESS OF THE HMA MIXTURE SHOWN ON THE PLANS IS THE NOMINAL THICKNESS. DEVIATIONS FROM THE NOMINAL THICKNESS WILL BE PERMITTED WHEN SUCH DEVIATIONS OCCUR DUE TO IRREGULARITIES IN THE EXISTING SURFACE OR BASE ON WHICH THE HMA MIXTURE IS PLACED.
- ANY DAMAGE TO EXISTING PAVEMENT MARKINGS OR RAISED REFLECTIVE PAVEMENT MARKERS OUTSIDE THE REMOVAL LINE SHOWN ON THE PLANS SHALL BE REPLACED AT THE CONTRACTOR'S EXPENSE.
- ALL PAVEMENT PATCHING LOCATIONS WILL BE DETERMINED IN THE FIELD BY THE ENGINEER.
- LOCATION OF COMBINATION CONCRETE CURB AND GUTTER REMOVAL AND REPLACEMENT (OR COMBINATION CURB AND GUTTER, WITH THE TYPE SPECIFIED ON THE PLANS), WILL BE DETERMINED IN THE FIELD BY THE ENGINEER.

FILE NAME *	USER NAME = jedamarm	DESIGNED -	REVISED -	<p style="text-align: center;"><b>STATE OF ILLINOIS</b> <b>DEPARTMENT OF TRANSPORTATION</b></p>	<p style="text-align: center;"><b>INDEX OF SHEETS, STATE STANDARDS AND GENERAL NOTES</b> <b>IL RTE. 59 (FOX LAKE RD.) AT PETITE LAKE ROAD</b></p>		F.A.P. RTE.	SECTION	COUNTY	TOTAL SHEETS	SHEET NO.
pu\VL084E810INTEG\Illinois.gov\PI45489\... \DOT Offices\District 1\Projects\PI45489\... \Design\PI45489-aht-gennote.doc	PLANTING	REVISOR	REVISION				104	105N-4	LAKE	113	2
PLOT SCALE = 100.0000 / / in.	CHECKED -	REVISED -					CONTRACT NO. 60W06				
PLOT DATE = 8/19/2016	DATE -	REVISED -					SCALE:	SHEET NO.	OF SHEETS	STA.	TO STA.

Rev.

GENERAL NOTES CONTINUED:

12. DRAINAGE ADJUSTMENT OR RECONSTRUCTION LOCATIONS WILL BE DETERMINED IN THE FIELD BY THE ENGINEER.
13. FOR FRAMES AND LIDS ADJUSTMENT WITHOUT MILLING, REUSE EXISTING FRAMES AND LIDS UNLESS OTHERWISE SPECIFIED IN THE PLANS.
14. FRAMES AND GRATES ADJUSTMENT OF PRIVATE UTILITIES WITHIN THE PROJECT LIMITS SHALL BE DONE BY THEIR RESPECTIVE OWNERS AND ARE NOT PART OF THIS CONTRACT.
15. PAVEMENT MARKING TAPE, TYPE III SHALL BE USED FOR SHORT TERM PAVEMENT MARKING ON ALL FINAL SURFACES. THE COST OF THE PAVEMENT MARKING TAPE, TYPE III AND ITS REMOVAL SHALL BE INCLUDED IN THE COST OF SHORT TERM PAVEMENT MARKING.
16. THE CONTRACTOR SHALL CONTACT THE DISTRICT TRAFFIC CONTROL SUPERVISOR AT (847)705-4470 A MINIMUM OF 72 HOURS IN ADVANCE OF BEGINNING WORK.
17. THE RESIDENT ENGINEER SHALL CONTACT WALTER CZARNY, AREA TRAFFIC FIELD ENGINEER (OR TECHNICIAN), AT (847) 715-8419 A MINIMUM OF TWO (2) WEEKS PRIOR TO THE PLACEMENT OF PERMANENT PAVEMENT MARKINGS.
18. IT SHALL BE THE CONTRACTOR'S RESPONSIBILITY TO VERIFY ALL DIMENSIONS AND CONDITIONS EXISTING IN THE FIELD PRIOR TO ORDERING MATERIALS AND BEGINNING CONSTRUCTION. THIS SHALL INCLUDE LOCATING THE MAST ARM AND FOUNDATIONS AND VERIFYING THE MAST ARM LENGTHS.
19. THE CONTRACTOR SHALL BE REQUIRED TO PROVIDE ACCESS TO ABUTTING PROPERTY AT ALL TIMES DURING THE CONSTRUCTION OF THIS PROJECT.
20. FOR STORM SEWER CONSTRUCTED UNDER ROADWAY, BACKFILLING METHODS TWO AND THREE AUTHORIZED UNDER PROVISIONS OF ARTICLE 550.07 OF THE STANDARD SPECIFICATIONS WILL NOT BE ALLOWED.
20. THE CONTRACTOR WILL BE REQUIRED TO KEEP A RECORD OF THE LOCATIONS OF BURIED STRUCTURES ACCORDING TO THE STATION OFFSET LEFT OR RIGHT OF THE CENTERLINE OF PAVEMENT, UPON COMPLETION OF THE WORK. THE CONTRACTOR WILL DELIVER THE RECORD TO THE ENGINEER.
21. EXISTING BROKEN FRAMES AND LIDS SHALL BE REMOVED AND DISPOSED OF BY THE CONTRACTOR AND SHALL BE REPLACED AS DIRECTED BY THE ENGINEER. REPLACEMENT FRAMES AND LIDS WILL BE PAID FOR ACCORDING TO ARTICLE 109.04 OF THE STANDARD SPECIFICATIONS UNLESS A SEPARATE PAY ITEM HAS BEEN PROVIDED.
22. THE DEPARTMENT HAS NOT OBTAINED ANY PERMITS FOR OFFSITE BORROW, WASTE, USE (BWU) AREAS. PRIOR TO WORKING IN BWU AREAS, IF THE CONTRACTOR CHOOSES TO USE ACTIVITIES REQUIRING PERMITS IT IS THE CONTRACTOR'S RESPONSIBILITY TO SECURE THE PROPER PERMITS. IN ADDITION TO THE BORROW REVIEW (BDE 2289) and USE/WASTE REVIEW (BDE 2290) SUBMITTALS, THE CONTRACTOR SHALL SUBMIT AN EROSION AND SEDIMENT CONTROL (ESC) PLAN FOR EVERY BWU SITE TO THE DEPARTMENT FOR ACCEPTANCE. GUIDELINES FOR ACCEPTABLE BWU PRACTICES CAN BE FOUND IN SECTION II.G.1 AND 2 of the SWPPP. THE COST OF ALL MATERIALS AND LABOR NECESSARY TO COMPLY WITH THE ABOVE PROVISIONS TO PREPARE AND IMPLEMENT ESC PLANS WILL NOT BE PAID FOR SEPARATELY, BUT SHALL BE CONSIDERED AS INCLUDED IN THE UNIT BID PRICES OF THE CONTRACT AND NO ADDITIONAL COMPENSATION WILL BE ALLOWED.
23. ALL PIPE UNDERDRAINS SHALL BE PLACED AT A DEPTH OF 30" BELOW THE TOP OF THE PROPOSED PAVEMENT OR AS DEEP AS POSSIBLE AND IN ACCORDANCE WITH CHECK SHEET #19 OF THE SUPPLEMENTAL SPECIFICATIONS AND RECURRING SPECIAL PROVISIONS. THE COST OF MAKING PIPE UNDERDRAIN CONNECTIONS TO DRAINAGE STRUCTURES SHALL BE INCLUDED IN THE COST OF PIPE UNDERDRAINS ITEM.
24. DO NOT SCALE PLANS FOR CONSTRUCTION DIMENSIONS.
25. THE EXACT LOCATION OF ALL UTILITIES SHALL BE FIELD VERIFIED BY THE CONTRACTOR BEFORE ORDERING ANY MATERIALS AND STARTING ANY WORK. FOR LOCATIONS OF UTILITIES, LOCALLY OWNED EQUIPMENT, LEASED ENFORCEMENT CAMERA SYSTEM FACILITIES AND IDOT UNDERGROUND FACILITIES, CONTACT THE LOCAL COUNTIES, MUNICIPALITIES AND IDOT FOR LOCATES.
26. RESTORATION OF THE TRAFFIC SIGNAL WORK AREA SHALL BE INCLUDED IN THE RELATED PAY ITEMS SUCH AS FOUNDATION, CONDUIT, HANHOLE, ETC., AND NO EXTRA COMPENSATION SHALL BE ALLOWED. ALL ROADWAY SURFACE SUCH AS SHOULDERS, MEDIAN, SIDEWALKS, PAVEMENT ETC. SHALL BE REPLACED IN KIND. ALL DAMAGE TO MOWED LAWNS SHALL BE REPLACED WITH AN APPROVED SOD, AND ALL DAMAGE TO UNMOWED FIELDS SHALL BE SEEDED IN ACCORDANCE WITH THE STANDARD SPECIFICATIONS 250 AND 252 RESPECTIVELY.
27. IF THIS CONTRACT REQUIRES THE SERVICES OF AN ELECTRICAL CONTRACTOR, THE CONTRACTOR SHALL BE RESPONSIBLE AT HIS/HER OWN EXPENSE FOR LOCATING EXISTING IDOT ELECTRICAL FACILITIES PRIOR TO PERFORMING ANY WORK. IF THIS CONTRACT DOES NOT REQUIRE THE SERVICES OF AN ELECTRICAL CONTRACTOR, THE CONTRACTOR MAY REQUEST ONE FREE LOCATE FOR EXISTING IDOT ELECTRICAL FACILITY FROM THE DISTRICT ONE ELECTRICAL MAINTENANCE CONTRACTOR PRIOR TO THE START OF ANY WORK. ADDITIONAL REQUESTS SHALL BE AT THE EXPENSE OF THE CONTRACTOR. THE LOCATIONS OF UNDERGROUND TRAFFIC FACILITIES DOES NOT RELIEVE THE CONTRACTOR OF THEIR RESPONSIBILITY TO REPAIR ANY FACILITIES DAMAGED DURING CONSTRUCTION AT THEIR EXPENSE.

28. THE CONTRACTOR SHALL CHECK THE PROPOSED TRAFFIC SIGNAL EQUIPMENT LOCATIONS FOR OVERHEAD UTILITY CONFLICTS. THE CONTRACTOR SHALL COORDINATE ANY CONFLICTS WITH THE UTILITY COMPANIES AND THE RESIDENT ENGINEER BEFORE ORDERING MATERIALS.
29. FULL DEPTH SAWCUT OF REMOVAL ITEMS AS NOTED ON THE PLANS, SPECIFIED IN THE STANDARD SPECIFICATIONS, OR AS REQUIRED BY THE RESIDENT ENGINEER SHALL BE INCLUDED IN THE COST OF THE ITEM BEING REMOVED.
30. THIS PROJECT REQUIRES A US ARMY CORPS OF ENGINEERS (USACE) 404 PERMIT THAT WILL BE SECURED BY THE DEPARTMENT. ALL CONDITIONS OF THE 404 PERMIT, FOUND IN THE SPECIAL PROVISIONS, MUST BE FOLLOWED. AS A CONDITION OF THIS PERMIT, THE CONTRACTOR WILL NEED TO SUBMIT AN IN-STREAM WORK PLAN (INCLUDING WORK WITHIN WETLANDS) TO THE DEPARTMENT FOR APPROVAL. GUIDELINES ON ACCEPTABLE IN-STREAM WORK TECHNIQUES (INCLUDING WORK WITHIN WETLANDS) CAN BE FOUND ON THE USACE WEBSITE. THE USACE DEFINES AND DETERMINES IN-STREAM WORK. THE COST OF ALL MATERIALS AND LABOR NECESSARY TO COMPLY WITH THE ABOVE PROVISIONS TO PREPARE AND IMPLEMENT AN IN-STREAM WORK PLAN (INCLUDING WORK WITHIN WETLANDS) WILL NOT BE PAID FOR SEPARATELY, BUT SHALL BE CONSIDERED AS INCLUDED IN THE UNIT BID PRICES OF THE CONTRACT AND NO ADDITIONAL COMPENSATION WILL BE ALLOWED.

COMMITMENT:

- NO CONSTRUCTION ACTIVITIES WILL BE ALLOWED IN THE MONTH OF DECEMBER FOR THE DRIVEWAYS ACCESS (APPROX. AT STA. 203+37.5, STA. 204+03, AND STA. 205+32.70) ALONG THE NORTH SIDE ON PETITE LAKE ROAD.
- THE DEPARTMENT WILL AVOID THE BARN DURING CONSTRUCTION. (APPROXIMATELY AT STATION 204+03).

FILE NAME =	USER NAME = ledezmar	DESIGNED -	REVISED -	<b>STATE OF ILLINOIS DEPARTMENT OF TRANSPORTATION</b>	<b>INDEX OF SHEETS, STATE STANDARDS AND GENERAL NOTES IL. RTE. 59 (FOX LAKE RD.) AT PETITE LAKE ROAD</b>	F.A.P. RTE.	SECTION	COUNTY	TOTAL SHEETS	SHEET NO.	
p:\11\084EBID\INTEG.illinois.gov\PI\DOT Documents\DOT Offices\District 1\Projects\P145409\Drawings\Design\P145409-shr-gennote.dgn		CHECKED -	REVISED -			104	105N-4	LAKE	113	3	
Default	PLOT SCALE = 100.0000' / 1in.	DATE -	REVISED -			<b>CONTRACT NO. 60W06</b>					
	PLOT DATE = 9/19/2016					SCALE:	SHEET	OF	SHEETS	STA.	TO
						ILLINOIS FED. AID PROJECT					

*URBAN*

SUMMARY OF QUANTITIES				CONSTRUCTION TYPE CODE					
CODE NO	ITEM	UNIT	TOTAL QUANTITIES	IL 59 RESURF 0005	IL 59 WIDENING RESURF 0004	PETITE LAKE RD RECON 0004	FED STATE COUNTY 0021	LAKE VILLA FIRE DEPT 0021	FED LAKE VILLA TWP 0004
20100110	TREE REMOVAL ( 6 TO 15 UNITS DIAMETER)	UNIT	247		109	138			
20100210	TREE REMOVAL ( OVER 15 UNITS DIAMETER)	UNIT	186		99	87			
20101000	TEMPORARY FENCE	FOOT	1000			1000			
20101200	TREE ROOT PRUNING	EACH	12		6	6			
20200100	EARTH EXCAVATION	CU YD	13480		6211	7269			
20201200	REMOVAL AND DISPOSAL OF UNSUITABLE MATERIAL	CU YD	1200		1200				
20700220	POROUS GRANULAR EMBANKMENT	CU YD	8		8				
20800150	TRENCH BACKFILL	CU YD	202		92	110			
21001000	GEOTECHNICAL FABRIC FOR GROUND STABILIZATION	SQ YD	4815			4815			
21101615	TOPSOIL FURNISH AND PLACE, 4"	SQ YD	10900	20	6140	4487			253
25000210	SEEDING, CLASS 2A	ACRE	2.3		1.3	0.95			0.05
25000400	NITROGEN FERTILIZER NUTRIENT	POUND	138		78	57			3
25000500	PHOSPHORUS FERTILIZER NUTRIENT	POUND	138		78	57			3
25000600	POTASSIUM FERTILIZER NUTRIENT	POUND	138		78	57	* SPECIALTY ITEMS		3
							▲ NON-PARTICIPATING ITEMS		
25100630	EROSION CONTROL BLANKET	SQ YD	8870		6140	2730			

*URBAN*

SUMMARY OF QUANTITIES				CONSTRUCTION TYPE CODE					
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* 25100635	HEAVY DUTY EROSION CONTROL BLANKET	SQ YD	2010			2010			
* 25200110	SODDING, SALT TOLERANT	SQ YD	1060	1060					
* 25200200	SUPPLEMENTAL WATERING	UNIT	53			53			
28000250	TEMPORARY EROSION CONTROL SEEDING	POUND	600		500	100			
28000305	TEMPORARY DITCH CHECKS	FOOT	518		366	152			
28000400	PERIMETER EROSION BARRIER	FOOT	2625		1625	1000			
28000500	INLET AND PIPE PROTECTION	EACH	46		24	22			
28100105	STONE RIPRAP, CLASS A3	SQ YD	1122		1110	12			
28100107	STONE RIPRAP, CLASS A4	SQ YD	28		28				
28200200	FILTER FABRIC	SQ YD	1258		1138	120			
30300112	AGGREGATE SUBGRADE IMPROVEMENT 12"	SQ YD	7293		2665	4628			
35101800	AGGREGATE BASE COURSE, TYPE B 6"	SQ YD	2642		520	622			1500
35501308	HOT-MIX ASPHALT BASE COURSE, 6"	SQ YD	547		547				
35501312	HOT-MIX ASPHALT BASE COURSE, 7"	SQ YD	377		377				
35600704	HOT-MIX ASPHALT BASE COURSE WIDENING, 7"	SQ YD	1308		1308				* SPECIALTY ITEMS
									▲ NON-PARTICIPATING ITEMS

URBAN

SUMMARY OF QUANTITIES			CONSTRUCTION TYPE CODE						
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40201000	AGGREGATE FOR TEMPORARY ACCESS	TON	2160			2160			
40600290	BITUMINOUS MATERIALS (TACK COAT)	POUND	23195	17575	5620				
40600400	MIXTURE FOR CRACKS, JOINTS, AND FLANGEWAYS	TON	48	39	9				
40600827	POLYMERIZED LEVELING BINDER (MACHINE METHOD), IL-4.75, N50	TON	1607	1074	533				
40600982	HOT-MIX ASPHALT SURFACE REMOVAL - BUTT JOINT	SO YD	266	266					
40603080	HOT-MIX ASPHALT BINDER COURSE, IL-19.0, N50	TON	1327			1327			
40603085	HOT-MIX ASPHALT BINDER COURSE, IL-19.0, N70	TON	336		336				
40603335	HOT-MIX ASPHALT SURFACE COURSE, MIX "D", N50	TON	379		63	72			244
40603565	POLYMERIZED HOT-MIX ASPHALT SURFACE COURSE, MIX "E", N70	TON	3510	2504	1006				
42001300	PROTECTIVE COAT	SO YD	867	40	247	580			
42400200	PORTLAND CEMENT CONCRETE SIDEWALK 5 INCH	SO FT	410		410				
42400800	DETECTABLE WARNINGS	SO FT	54		40	14			

URBAN

SUMMARY OF QUANTITIES			CONSTRUCTION TYPE CODE						
CODE NO	ITEM	UNIT	TOTAL QUANTITIES	IL 59 RESURF 0005	IL 59 WIDENING RESURF 0004	PETITE LAKE RD RECON 0004	FED STATE COUNTY 0021	LAKE VILLA FIRE DEPT 0021	FED LAKE VILLA TWP 0004
44000100	PAVEMENT REMOVAL	SO YD	2317		92	2225			
44000159	HOT-MIX ASPHALT SURFACE REMOVAL, 2 1/2"	SO YD	31561	24793	6768				
44000200	DRIVEWAY PAVEMENT REMOVAL	SO YD	1575		1065	510			
44000500	COMBINATION CURB AND GUTTER REMOVAL	FOOT	151		151				
44004250	PAVED SHOULDER REMOVAL	SO YD	1248		1248				
44201803	CLASS D PATCHES, TYPE II, 13 INCH	SO YD	726	552	174				
44201807	CLASS D PATCHES, TYPE III, 13 INCH	SO YD	461	331	130				
44201809	CLASS D PATCHES, TYPE IV, 13 INCH	SO YD	351	221	130				
48102100	AGGREGATE WEDGE SHOULDER, TYPE B	TON	170	170					
48203019	HOT-MIX ASPHALT SHOULDERS, 5 1/2"	SO YD	2831		2831				
50102400	CONCRETE REMOVAL	CU YD	1.7		1.7				
50105220	PIPE CULVERT REMOVAL	FOOT	499		305	194			
50200100	STRUCTURE EXCAVATION	CU YD	8		8				
50800205	REINFORCEMENT BARS, EPOXY COATED	POUND	6130		6130				
50901720	BICYCLE RAILING	FOOT	353		353				* SPECIALTY ITEMS
52200015	PERMANENT SHEET PILING	SO FT	595		595				▲ NON-PARTICIPATING ITEMS
54001001	BOX CULVERT END SECTIONS, CULVERT NO. 1	EACH	1		1				

*URBAN*

SUMMARY OF QUANTITIES			TOTAL QUANTITIES	CONSTRUCTION TYPE CODE				
CODE NO	ITEM	UNIT		IL 59 RESURF 0005	IL 59 WIDENING RESURF 0004	PETITE LAKE RD RECON 0004	FED STATE COUNTY 0021	LAKE VILLA FIRE DEPT 0021
54002020	EXPANSION BOLTS 3/4 INCH	EACH	24		24			
52200020	TEMPORARY SOIL RETENTION SYSTEM	SQ FT	131		131			
54003000	CONCRETE BOX CULVERTS	CU YD	20.3		20.3			
54213657	PRECAST REINFORCED CONCRETE FLARED END	EACH	1		1			
	SECTIONS 12"							
54213660	PRECAST REINFORCED CONCRETE FLARED END	EACH	25		17	8		
	SECTIONS 15"							
54261424	CONCRETE END SECTION, STANDARD 542001,	EACH	4		2	2		
	24", 1:4							
542A0220	PIPE CULVERTS, CLASS A, TYPE 1 15"	FOOT	318		208	110		
550A0050	STORM SEWERS, CLASS A, TYPE 1 12"	FOOT	482		72	410		
550A0070	STORM SEWERS, CLASS A, TYPE 1 15"	FOOT	484		354	130		
550A0120	STORM SEWERS, CLASS A, TYPE 1 24"	FOOT	105		24	81		
550A4000	STORM SEWERS, CLASS A, TYPE 1	FOOT	270		270			
	EQUIVALENT ROUND-SIZE 18"							
55100700	STORM SEWER REMOVAL 15"	FOOT	24		24			
55100900	STORM SEWER REMOVAL 18"	FOOT	218		218			
55101200	STORM SEWER REMOVAL 24"	FOOT	24		24			
							* SPECIALTY ITEMS	
							▲ NON-PARTICIPATING ITEMS	
60107600	PIPE UNDERDRAINS 4"	FOOT	2465		800	1665		

*URBAN*

SUMMARY OF QUANTITIES			TOTAL QUANTITIES	CONSTRUCTION TYPE CODE				
CODE NO	ITEM	UNIT		IL 59 RESURF 0005	IL 59 WIDENING RESURF 0004	PETITE LAKE RD RECON 0004	FED STATE COUNTY 0021	LAKE VILLA FIRE DEPT 0021
60201340	CATCH BASINS, TYPE A, 4'-DIAMETER, TYPE	EACH	8		3	5		
	24 FRAME AND GRATE							
60204505	CATCH BASINS, TYPE A, 5'-DIAMETER, TYPE	EACH	1		1			
	8 GRATE							
60205040	CATCH BASINS, TYPE A, 5'-DIAMETER, TYPE	EACH	2			2		
	24 FRAME AND GRATE							
60207605	CATCH BASINS, TYPE C, TYPE 8 GRATE	EACH	1			1		
60208240	CATCH BASINS, TYPE C, TYPE 24 FRAME AND	EACH	5		1	4		
	GRATE							
60219000	MANHOLES, TYPE A, 4'-DIAMETER, TYPE 8	EACH	1			1		
	GRATE							
60219540	MANHOLES, TYPE A, 4'-DIAMETER, TYPE 24	EACH	1		1			
	FRAME AND GRATE							
60221700	MANHOLES, TYPE A, 5'-DIAMETER, TYPE 8	EACH	4		4			
	GRATE							
60250200	CATCH BASINS TO BE ADJUSTED	EACH	11	10		1		
60500050	REMOVING CATCH BASINS	EACH	1			1		
60500205	FILLING CATCH BASINS	EACH	1			1		
60600095	CLASS SI CONCRETE (OUTLET)	CU YD	1		1			
								* SPECIALTY ITEMS
								▲ NON-PARTICIPATING ITEMS

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*URBAN*

SUMMARY OF QUANTITIES			TOTAL QUANTITIES	CONSTRUCTION TYPE CODE				
CODE NO	ITEM	UNIT		IL 59 RESURF 0005	IL 59 WIDENING RESURF 0004	PETITE LAKE RD RECON 0004	FED STATE COUNTY 0021	LAKE VILLA FIRE DEPT 0021
60600605	CONCRETE CURB, TYPE B	FOOT	180			180		
60605000	COMBINATION CONCRETE CURB AND GUTTER, TYPE B-6.24	FOOT	1680			1680		
60610400	COMBINATION CONCRETE CURB AND GUTTER, TYPE M-6.24	FOOT	675		675			
* 63000001	STEEL PLATE BEAM GUARDRAIL, TYPE A, 6 FOOT POSTS	FOOT	100		100			
* 63100167	TRAFFIC BARRIER TERMINAL, TYPE 1 (SPECIAL) TANGENT	EACH	2		2			
63200310	GUARDRAIL REMOVAL	FOOT	306		306			
* 66900200	NON-SPECIAL WASTE DISPOSAL	CU YD	2600		1300	1300		
* 66900450	SPECIAL WASTE PLANS AND REPORTS	LSUM	1		1			
* 66900530	SOIL DISPOSAL ANALYSIS	EACH	5		3	2		
67000400	ENGINEER'S FIELD OFFICE, TYPE A	CAL MO	12	5	7			
67100100	MOBILIZATION	L SUM	1	0.25	0.75			
70103815	TRAFFIC CONTROL SURVEILLANCE	CAL DA	21		21			
70106800	CHANGEABLE MESSAGE SIGN	CAL MO	1		1			* SPECIALTY ITEMS
70300100	SHORT TERM PAVEMENT MARKING	FOOT	7692	4380	2508	804		▲ NON-PARTICIPATING ITEMS

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SUMMARY OF QUANTITIES			TOTAL QUANTITIES	CONSTRUCTION TYPE CODE				
CODE NO	ITEM	UNIT		IL 59 RESURF 0005	IL 59 WIDENING RESURF 0004	PETITE LAKE RD RECON 0004	FED STATE COUNTY 0021	LAKE VILLA FIRE DEPT 0021
70300150	SHORT TERM PAVEMENT MARKING REMOVAL	SQ FT	2564	1460	836	268		
70300210	TEMPORARY PAVEMENT MARKING LETTERS AND SYMBOLS	SQ FT	598	254.8	270.4	72.8		
70300220	TEMPORARY PAVEMENT MARKING - LINE 4"	FOOT	34820	24670	7490	2660		
70300230	TEMPORARY PAVEMENT MARKING - LINE 5"	FOOT	1671			1671		
70300240	TEMPORARY PAVEMENT MARKING - LINE 6"	FOOT	1630	852	581	197		
70300260	TEMPORARY PAVEMENT MARKING - LINE 12"	FOOT	1280	447	585	248		
70300280	TEMPORARY PAVEMENT MARKING - LINE 24"	FOOT	120	43	52	25		
70400100	TEMPORARY CONCRETE BARRIER	FOOT	1085	1085				
70400200	RELOCATE TEMPORARY CONCRETE BARRIER	FOOT	885	885				
70600260	IMPACT ATTENUATORS, TEMPORARY (FULLY REDIRECTIVE, NARROW), TEST LEVEL 3	EACH	14	14				
70600332	IMPACT ATTENUATORS, RELOCATE (FULLY REDIRECTIVE, NARROW), TEST LEVEL 3	EACH	9	9				
* 72000100	SIGN PANEL - TYPE 1	SQ FT	7			7		
* 72000200	SIGN PANEL - TYPE 2	SQ FT	21			21		
* 72400100	REMOVE SIGN PANEL ASSEMBLY - TYPE A	EACH	12		9	3		* SPECIALTY ITEMS ▲ NON-PARTICIPATING ITEMS

SUMMARY OF QUANTITIES				CONSTRUCTION TYPE CODE						SUMMARY OF QUANTITIES				CONSTRUCTION TYPE CODE					
CODE NO	ITEM	UNIT	TOTAL QUANTITIES	IL 59 RESURF 0005	IL 59 WIDENING RESURF 0004	PETITE LAKE RD RECON 0004	FED STATE COUNTY 0021	LAKE VILLA FIRE DEPT 0021		CODE NO	ITEM	UNIT	TOTAL QUANTITIES	IL 59 RESURF 0005	IL 59 WIDENING RESURF 0004	PETITE LAKE RD RECON 0004	FED STATE COUNTY 0021	LAKE VILLA FIRE DEPT 0021	
* 72400500	RELOCATE SIGN PANEL ASSEMBLY - TYPE A	EACH	4		2	2				* 81028220	UNDERGROUND CONDUIT, GALVANIZED STEEL, 3" DIA.	FOOT	81					81	
* 72501000	TERMINAL MARKER - DIRECT APPLIED	EACH	2		2														
* 78000100	THERMOPLASTIC PAVEMENT MARKING - LETTERS AND SYMBOLS	50 FT	597.2	254	270.4	72.8				* 81028240	UNDERGROUND CONDUIT, GALVANIZED STEEL, 4" DIA.	FOOT	257					257	
* 78000200	THERMOPLASTIC PAVEMENT MARKING - LINE 4"	FOOT	34820	24670	7490	2660				* 81400100	HANDHOLE	EACH	4					4	
* 78000300	THERMOPLASTIC PAVEMENT MARKING - LINE 5"	FOOT	1671			1671				* 81400200	HEAVY-DUTY HANDHOLE	EACH	6					6	
* 78000400	THERMOPLASTIC PAVEMENT MARKING - LINE 6"	FOOT	1630	852	581	197				* 81400300	DOUBLE HANDHOLE	EACH	1					1	
* 78000600	THERMOPLASTIC PAVEMENT MARKING - LINE 12"	FOOT	1412	447	585	380				* 87301215	ELECTRIC CABLE IN CONDUIT, SIGNAL NO. 14 2C	FOOT	653					653	
* 78000650	THERMOPLASTIC PAVEMENT MARKING - LINE 24"	FOOT	120	43	52	25				* 87301225	ELECTRIC CABLE IN CONDUIT, SIGNAL NO. 14 3C	FOOT	932					932	
* 78100100	RAISED REFLECTIVE PAVEMENT MARKER	EACH	394	299	95					* 87301245	ELECTRIC CABLE IN CONDUIT, SIGNAL NO. 14 5C	FOOT	1309					1309	
* 78200005	GUARDRAIL REFLECTORS, TYPE A	EACH	3		3					* 87301255	ELECTRIC CABLE IN CONDUIT, SIGNAL NO. 14 7C	FOOT	814					814	
* 78200011	BARRIER WALL REFLECTORS, TYPE C	EACH	77		77					* 87301295	ELECTRIC CABLE IN CONDUIT, SIGNAL NO. 20 3C	FOOT	251					251	
<del>* 72501000</del>	<del>TERMINAL MARKER - DIRECT APPLIED</del>	<del>EACH</del>	<del>2</del>		<del>2</del>					* 87301305	ELECTRIC CABLE IN CONDUIT, LEAD-IN, NO. 14 1 PAIR	FOOT	1510					1510	
78300200	RAISED REFLECTIVE PAVEMENT MARKER REMOVAL	EACH	314	238	76														
* 81028200	UNDERGROUND CONDUIT, GALVANIZED STEEL, 2" DIA.	FOOT	1021				1021												

*\* speciality items*

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URBAN

SUMMARY OF QUANTITIES				CONSTRUCTION TYPE CODE					SUMMARY OF QUANTITIES				CONSTRUCTION TYPE CODE				
CODE NO	ITEM	UNIT	TOTAL QUANTITIES	IL 59 RESURF 0005	IL 59 WIDENING RESURF 0004	PETITE LAKE RD RECON 0004	FED STATE COUNTY 0021	LAKE VILLA FIRE DEPT 0021	CODE NO	ITEM	UNIT	TOTAL QUANTITIES	IL 59 RESURF 0005	IL 59 WIDENING RESURF 0004	PETITE LAKE RD RECON 0004	FED STATE COUNTY 0021	LAKE VILLA FIRE DEPT 0021
* 87301800	ELECTRIC CABLE IN CONDUIT, SERVICE, NO. 4 2 C	FOOT	447				447		* 88030070	SIGNAL HEAD, LED, 1-FACE, 4-SECTION, BRACKET MOUNTED	EACH	3				3	
* 87301900	ELECTRIC CABLE IN CONDUIT, EQUIPMENT GROUNDING CONDUCTOR, NO. 6 1C	FOOT	891				891		* 88030080	SIGNAL HEAD, LED, 1-FACE, 4-SECTION, MAST ARM MOUNTED	EACH	1				1	
* 87502500	TRAFFIC SIGNAL POST, GALVANIZED STEEL 16 FT.	EACH	4				4		* 88030100	SIGNAL HEAD, LED, 1-FACE, 5-SECTION, BRACKET MOUNTED	EACH	1				1	
* 87700160	STEEL MAST ARM ASSEMBLY AND POLE, 24 FT.	EACH	1				1		* 88030110	SIGNAL HEAD, LED, 1-FACE, 5-SECTION, MAST-ARM MOUNTED	EACH	1				1	
* 87700230	STEEL MAST ARM ASSEMBLY AND POLE, 38 FT.	EACH	1				1		* 88102717	PEDESTRIAN SIGNAL HEAD, LED, 1-FACE, BRACKET MOUNTED WITH COUNTDOWN TIMER	EACH	4				4	
* 87702920	STEEL COMBINATION MAST ARM ASSEMBLY AND POLE 38 FT.	EACH	1				1		* 88200400	TRAFFIC SIGNAL BACKPLATE, FORMED PLASTIC	EACH	6				6	
87800100	CONCRETE FOUNDATION, TYPE A	FOOT	16				16		* 88500100	INDUCTIVE LOOP DETECTOR	EACH	7				7	
* 87800150	CONCRETE FOUNDATION, TYPE C	FOOT	4				4		* 88600100	DETECTOR LOOP, TYPE I	FOOT	308				308	
* 87800400	CONCRETE FOUNDATION, TYPE E 30-INCH DIAMETER	FOOT	37				37		* 88600600	DETECTOR LOOP REPLACEMENT	FOOT	20	20				
* 88030020	SIGNAL HEAD, LED, 1-FACE, 3-SECTION, MAST-ARM MOUNTED	EACH	4				4		* 88600700	PERFORMED DETECTOR LOOP	FOOT	265				265	
* 88030050	SIGNAL HEAD, LED, 1-FACE, 3-SECTION, BRACKET MOUNTED	EACH	4				4		* 88700200	LIGHT DETECTOR	EACH	2					2
	* Specialty Items								* 88700300	LIGHT DETECTOR AMPLIFIER	EACH	1					1
									* 88800100	PEDESTRIAN PUSH-BUTTON	EACH	4				4	

FILE NAME =	USER NAME = jedszmara	DESIGNED -	REVISED -
OFFICE OF DESIGN & CONSTRUCTION	OFFICE OF DESIGN & CONSTRUCTION	CHECKED -	REVISED -
PLLOT SCALE = 1/4" = 100'	PLLOT DATE = 8/22/2016	DATE -	REVISED -

STATE OF ILLINOIS  
DEPARTMENT OF TRANSPORTATION

IL 59: IL 132 TO HIGHWOODS DR. AND AT PETITIE LAKE RD.  
SUMMARY OF QUANTITIES

F.A.P. RTE. 104	SECTION 105N-4	COUNTY LAKE	TOTAL SHEETS 113	SHEET NO. 9
CONTRACT NO. 60W06				
FED. ROAD DIST. NO. 1 ILLINOIS FED. AID PROJECT				

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URBAN

URBAN

SUMMARY OF QUANTITIES			TOTAL QUANTITIES	CONSTRUCTION TYPE CODE				
CODE NO	ITEM	UNIT		IL 59 RESURF 0005	IL 59 WIDENING RESURF 0004	PETITE LAKE RD RECON 0004	FED STATE COUNTY 0021	LAKE VILLA FIRE DEPT 0021
* C200652	SHRUB, ARONIA MELANOCARPA AUTUMN MAGIC, (AUTUMN MAGIC BLACK CHOKEBERRY), 2' HEIGHT, BALLED AND BURLAPPED	EACH	70	70				
* C200348	SHRUB, HAMAMELIS VIRGINIANA (COMMON WITCHHAZEL), 4' HEIGHT, BALLED AND BURLAPPED	EACH	80		80			
* C2011948	SHRUB, VIBURNUM DENTATUM RALPH SENIOR (AUTUMN JAZZ ARROWWOOD VIBURNUM), 4' HEIGHT, BALLED AND BURLAPPED	EACH	70	70				
* C2012436	SHRUB, VIBURNUM LENTAGO (NANNYBERRY VIBURNUM), 3' HEIGHT, BALLED AND BURLAPPED	EACH	70	70				
* C2C016G3	SHRUB, CORNUS RACEMOSA (GRAY DOGWOOD), CONTAINER GROWN, 3-GALLON	EACH	50		50			
* C2C06004	SHRUB, RHUS COPALLINA VAR. LATIFOLIA MORTON (PRAIRIE FLAME SHINING SUMAC), 3' HEIGHT, CONTAINER	EACH	192	70	122			
* C2C09636	SHRUB, SAMBUCUS CANADENSIS (AMERICAN ELDER), 3' HEIGHT, CONTAINER	EACH	116	76	40			
X0301852	DEWATERING STRUCTURE NO. 1	EACH	1	1				
* X0324085	EMERGENCY VEHICLE PRIORITY SYSTEM LINE SENSOR CABLE, NO. 20 3/C	FOOT	251				251	

SUMMARY OF QUANTITIES			TOTAL QUANTITIES	CONSTRUCTION TYPE CODE				
CODE NO	ITEM	UNIT		IL 59 RESURF 0005	IL 59 WIDENING RESURF 0004	PETITE LAKE RD RECON 0004	FED STATE COUNTY 0021	LAKE VILLA FIRE DEPT 0021
X0327979	PAVEMENT MARKING REMOVAL - GRINDING	SO FT	15239	9440	3747	2052		
* X1400107	FULL-ACTUATED CONTROLLER AND TYPE SUPER P CABINET	EACH	1			1		
* X1400150	SERVICE INSTALLATION, GROUND MOUNTED, METERED	EACH	1			1		
X2020110	GRADING AND SHAPING SHOULDERS	UNIT	80	80				
X4021000	TEMPORARY ACCESS (PRIVATE ENTRANCE)	EACH	18		12	6		
X4401198	HOT-MIX ASPHALT SURFACE REMOVAL, VARIABLE DEPTH	SO YD	4285		4285			
<del>S220015</del>	<del>PERMANENT SHEET PILING</del>	<del>SO FT</del>	<del>595</del>		<del>595</del>			
X5537800	STORM SEWERS TO BE CLEANED 12"	FOOT	400	400				
X6030310	FRAMES AND LIDS TO BE ADJUSTED (SPECIAL)	EACH	10	10				
X7010216	TRAFFIC CONTROL AND PROTECTION, (SPECIAL)	L SUM	1	0.25	0.75			
X7040125	PINNING TEMPORARY CONCRETE BARRIER	EACH	323		323			
* X8620200	UNINTERRUPTABLE POWER SUPPLY, SPECIAL	EACH	1			1		
Z0004562	COMBINATION CONCRETE CURB AND GUTTER REMOVAL AND REPLACEMENT	FOOT	120	120				
Z0013798	CONSTRUCTION LAYOUT	L SUM	1		1			

Δ = 100% STATE  
X = Specialty Items

FILE NAME =	USER NAME =	DESIGNED -	REVISED -
PROJECT NO. =	PROJECT NAME =	CHECKED -	REVISED -
PLOT SCALE =	PLOT DATE =	DATE -	REVISED -

STATE OF ILLINOIS  
DEPARTMENT OF TRANSPORTATION

IL 59: IL 132 TO HIGHWOODS DR. AND AT PETITE LAKE RD.  
SUMMARY OF QUANTITIES

F.A.P. RTE. 104	SECTION 105N-4	COUNTY LAKE	TOTAL SHEETS 113	SHEET NO. 10
CONTRACT NO. 60W06				
FED. ROAD DIST. NO. 1 ILLINOIS FED. AID PROJECT				

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SUMMARY OF QUANTITIES				CONSTRUCTION TYPE CODE						SUMMARY OF QUANTITIES				CONSTRUCTION TYPE CODE						
CODE NO	ITEM	UNIT	TOTAL QUANTITIES	IL 59 RESURF 0005	IL 59 WIDENING RESURF 0004	PETITE LAKE RD RECON 0004	FED STATE COUNTY 0021	LAKE VILLA FIRE DEPT 0021		CODE NO	ITEM	UNIT	TOTAL QUANTITIES	IL 59 RESURF 0005	IL 59 WIDENING RESURF 0004	PETITE LAKE RD RECON 0004	FED STATE COUNTY 0021	LAKE VILLA FIRE DEPT 0021		
Z0018500	DRAINAGE STRUCTURES TO BE CLEANED	EACH	10	10																
Z0030850	TEMPORARY INFORMATION SIGNING	50 FT	204.9	204.9																
Z0064800	SELECTIVE CLEARING	UNIT	19			19														
<del>520000</del>	<del>TEMPORARY SOIL RETENTION SYSTEM</del>	<del>50 FT</del>	<del>131</del>		<del>131</del>															
	MANHOLES, TYPE A, 5' -DIAMETER, TYPE B	EACH	1		1															
	GRATE, RESTRICTOR PLATE																			
Ø Z0076600	TRAINEES	HOUR	500	500																
Ø Z0076604	TRAINEES - TRAINING PROGRAM GRADUATE	HOUR	500	500																

Ø 0042  
A NP= 100% STATE

FILE NAME =	USER NAME = laskznorm	DESIGNED -	REVISED -
OFFICE: \laskznorm\Projects\PH5409\CAD\Drawn\Drawn\PH5409.dwg		CHECKED -	REVISED -
PLOT SCALE = 100.0000' / 1"		DATE -	REVISED -
PLOT DATE = 8/22/2016			

**STATE OF ILLINOIS  
DEPARTMENT OF TRANSPORTATION**

**IL 59: IL 132 TO HIGHWOODS DR. AND AT PETITE LAKE RD.  
SUMMARY OF QUANTITIES**

F.A.P. RTE. 104	SECTION 105N-4	COUNTY LAKE	TOTAL SHEETS 113	SHEET NO. 11
CONTRACT NO. 60W06				
SCALE: SHEET NO. OF SHEETS STA. TO STA. FED. ROAD DIST. NO. 1 ILLINOIS FED. AID PROJECT				

Rev.

EARTHWORK SCHEDULE (LAKE COUNTY)  
IL. 59 (FOX LAKE ROAD)

① LOCATION	② EARTH EXCAVATION	③ EARTH EXCAVATION ADJUSTED FOR SHRINKAGE	④ EMBANKMENT	⑤ EARTHWORK BALANCE WASTE (+) OR SHORTAGE (-)
STATION	CUBIC YARD	CUBIC YARD	CUBIC YARD	CUBIC YARD

IL. RTE 59

STA. 490+00 TO STA. 491+00	81.75	69.50	00.25	+69.25
STA. 491+00 TO STA. 492+00	173.25	147.50	02.00	+145.50
STA. 492+00 TO STA. 493+00	296.75	252.25	05.25	+247.00
STA. 493+00 TO STA. 494+00	297.25	252.75	01.25	+251.50
STA. 494+00 TO STA. 495+00	316.25	268.75	17.00	+251.75
STA. 495+00 TO STA. 496+00	141.25	120.00	69.25	+50.75
STA. 496+00 TO STA. 497+00	187.75	159.50	80.00	+79.50
STA. 497+00 TO STA. 498+00	670.25	569.75	20.25	+549.50
STA. 498+00 TO STA. 499+00	609.25	517.75	04.75	+513.00
STA. 499+00 TO STA. 500+00	445.50	378.75	00.00	+378.75
STA. 500+00 TO STA. 501+00	514.00	437.00	89.75	+347.25
STA. 501+00 TO STA. 502+00	489.25	415.75	121.75	+294.00
STA. 502+00 TO STA. 503+00	274.00	233.00	428.50	-195.50
STA. 503+00 TO STA. 504+00	155.75	132.50	602.00	-469.50
STA. 504+00 TO STA. 505+00	473.50	402.5	85.25	+317.25
STA. 505+00 TO STA. 506+00	513.25	436.25	05.75	+430.50
STA. 506+00 TO STA. 507+00	258.75	220.00	68.00	+152.00
STA. 507+00 TO STA. 508+00	195.75	166.50	60.00	+106.50
STA. 508+00 TO STA. 508+46	116.75	99.25	14.75	+84.50
TOTAL (1)	6211.00	5280.00	1876.00	+3604.00

EARTHWORK SCHEDULE CONTINUATION (LAKE COUNTY)  
PETITE LAKE ROAD

① LOCATION	② EARTH EXCAVATION	③ EARTH EXCAVATION ADJUSTED FOR SHRINKAGE	④ EMBANKMENT	⑤ EARTHWORK BALANCE WASTE (+) OR SHORTAGE (-)
STATION	CUBIC YARD	CUBIC YARD	CUBIC YARD	CUBIC YARD

PETITE LAKE ROAD

STA. 200+50 TO STA. 202+00	3029.75	2375.25	00.00	+2375.25
STA. 202+00 TO STA. 203+00	1818.50	1545.75	00.00	+1545.75
STA. 203+00 TO STA. 204+00	1281.25	1089.00	01.50	+1087.50
STA. 204+00 TO STA. 205+00	288.25	245.00	81.50	+163.50
STA. 205+00 TO STA. 206+00	219.25	186.25	120.25	+66.00
STA. 206+00 TO STA. 207+00	293.00	249.00	285.25	-36.25
STA. 207+00 TO STA. 208+00	223.50	190.00	387.00	-197.00
STA. 208+00 TO STA. 208+65.07	114.75	97.50	160.25	-62.75
TOTAL (2)	7269.00	5978.00	1036.00	+4942.00

SUMMARY

TOTAL (1)	6211.00	5280.00	1876.00	+3604.00
TOTAL (2)	7269.00	5978.00	1036.00	+4942.00
GRAND TOTAL	13480.00	11258.00	2912.00	+8546.00

COLUMN 1: LOCATION FROM PLAN

COLUMN 2: QUANTITY OF EARTH EXCAVATION (CUT) FROM CROSS SECTIONS

COLUMN 3: QUANTITY OF EARTH EXCAVATION (CUT) ADJUSTED FOR A SHRINKAGE FACTOR OF 15%

COLUMN 4: QUANTITY OF EMBANKMENT (FILL) FROM CROSS SECTIONS

COLUMN 5: (COLUMN 3 - COLUMN 4)

(+) = QUANTITY OF FURNISHED EXCAVATION NEEDED

(-) = QUANTITY TO BE WASTED

PETITE LAKE RD, PIPE UDERDRAIN, 4" (NORTH SIDE)

STATION	DESCRIPTION	LENGTH
STA. 201+03.71 - STA. 203+86.12	LONGITUDINAL (NORTH)	282.82'
STA. 203+86.12 - STA. 205+15.69	LONGITUDINAL (NORTH)	129.80'
STA. 205+15.69 - STA. 206+95.86	LONGITUDINAL (NORTH)	179.76'
TOTAL		592.38'

PETITE LAKE RD, PIPE UDERDRAIN, 4" (SOUTH SIDE)

STATION	DESCRIPTION	LENGTH
STA. 200+44.40 - STA. 205+15.59	LONGITUDINAL (SOUTH)	470.82'
STA. 205+15.69 - STA. 206+94.60	LONGITUDINAL (SOUTH)	179.40'
TOTAL		650.22'

IL RTE. 59, PIPE UNDERDRAIN, 4" (WEST SIDE)

STATION	DESCRIPTION	LENGTH
STA. 492+00 TO STA. 493+00	LONGITUDINAL	100'
STA. 501+00 TO STA. 502+00	LONGITUDINAL	100'
STA. 503+00 TO STA. 504+00	LONGITUDINAL	100'
STA. 505+50 TO STA. 506+50	LONGITUDINAL	100'
TOTAL		400'

IL RTE. 59, PIPE UNDERDRAIN, 4" (EAST SIDE)

STATION	DESCRIPTION	LENGTH
STA. 492+00 TO STA. 493+00	LONGITUDINAL	100'
STA. 501+00 TO STA. 502+00	LONGITUDINAL	100'
STA. 503+00 TO STA. 504+00	LONGITUDINAL	100'
STA. 505+50 TO STA. 506+50	LONGITUDINAL	100'
TOTAL		400'

TREE REMOVAL SCHEDULE (LAKE COUNTY)  
IL. RTE. 59 (FOX LAKE ROAD) - RIGHT SIDE

LOCATION STATION	OFFSTET (FEET)	DESCRIPTION			REASON FOR REMOVAL
		CIRCUMFERENCE (INCH)	6 TO 15 UNITS	OVER 15 UNITS	
494+35.39	26.24 (RT)	30.00	10		IN PROPOSED HMA SHOULDER
494+75.78	25.84 (RT)	30.00	10		IN PROPOSED HMA SHOULDER
496+31.53	34.58 (RT)	35.00	11		IN FRONT SLOPE (EMBANKMENT AREA)
498+02.36	25.59 (RT)	50.00		16	IN PROPOSED HMA SHOULDER
498+16.71	27.55 (RT)	50.00		16	IN PROPOSED HMA SHOULDER
498+29.48	29.09 (RT)	50.00		16	IN PROPOSED HMA SHOULDER
498+48.60	26.68 (RT)	48.00		16	IN PROPOSED HMA SHOULDER
498+48.60	26.68 (RT)	48.00		16	IN PROPOSED HMA SHOULDER
498+83.69	29.77 (RT)	60.00		19	IN BACK OF CURB (EXCAVATION AREA)
500+79.48	45.89 (RT)	22.00	7		IN BACK SLOPE (EXCAVATION AREA)
500+99.87	43.73 (RT)	24.00	8		IN BACK SLOPE (EXCAVATION AREA)
501+32.84	43.99 (RT)	28.00	9		IN BACK SLOPE (EXCAVATION AREA)
501+64.66	44.28 (RT)	36.00	12		IN BACK SLOPE (EXCAVATION AREA)
TOTAL			67	83	

TREE REMOVAL SCHEDULE (LAKE COUNTY)  
PETITE LAKE ROAD - RIGHT SIDE

LOCATION STATION	OFFSTET (FEET)	DESCRIPTION			REASON FOR REMOVAL
		CIRCUMFERENCE (INCH)	6 TO 15 UNITS	OVER 15 UNITS	
200+39.99	35.38 (RT)	38.00	12		IN MULTI PATH (EXCAVATION AREA)
200+88.70	32.63 (RT)	42.00	14		IN PARKWAY (EXCAVATION AREA)
201+21.24	34.27 (RT)	36.00	12		IN MULTI PATH (EXCAVATION AREA)
201+83.10	31.47 (RT)	24	8		IN PARKWAY (EXCAVATION AREA)
202+52.76	33.29 (RT)	60.00		19	IN MULTI PATH (EXCAVATION AREA)
202+89.31	34.65 (RT)	36.00	12		IN MULTI PATH (EXCAVATION AREA)
203+00.23	33.71 (RT)	18.00	6		IN MULTI PATH (EXCAVATION AREA)
203+40.92	35.43 (RT)	48.00		16	IN MULTI PATH (EXCAVATION AREA)
203+85.36	37.51 (RT)	54.00		17	IN MULTI PATH (EXCAVATION AREA)
204+56.91	36.52 (RT)	42.00	14		IN MULTI PATH (EXCAVATION AREA)
205+17.06	40.18 (RT)	60.00		19	IN MULTI PATH (EMBANKMENT AREA)
205+38.35	35.17 (RT)	48.00		16	IN MULTI PATH (EMBANKMENT AREA)
206+29.35	37.75 (RT)	42.00	14		IN MULTI PATH (EMBANKMENT AREA)
TOTAL			92	87	

TREE REMOVAL SCHEDULE (LAKE COUNTY)  
IL. RTE. 59 (FOX LAKE ROAD) - LEFT SIDE

LOCATION STATION	OFFSTET (FEET)	DESCRIPTION			REASON FOR REMOVAL
		CIRCUMFERENCE (INCH)	6 TO 15 UNITS	OVER 15 UNITS	
496+05.85	28.31 (LT)	36	12		IN FRONT SLOPE (EMBANKMENT AREA)
497+69.67	27.03 (LRT)	18.00	6		IN FRONT SLOPE (EXCAVATION AREA)
496+21.25	26.51 (LT)	18.00	6		IN BACK OF CURB (EXCAVATION AREA)
499+04.12	27.23 (LT)	48.00		16	IN FRONT SLOPE (EXCAVATION AREA)
503+88.77	40.40 (LT)	24.00	8		IN FRONT SLOPE (EXCAVATION AREA)
508+30.06	43.06 (LT)	30.00	10		IN FRONT SLOPE (EXCAVATION AREA)
TOTAL			42	16	


TREE REMOVAL SCHEDULE (LAKE COUNTY)  
PETITE LAKE ROAD - LEFT SIDE

LOCATION STATION	OFFSTET (FEET)	DESCRIPTION			REASON FOR REMOVAL
		CIRCUMFERENCE (INCH)	6 TO 15 UNITS	OVER 15 UNITS	
200+75.29	31.78 (LT)	20.00	6		IN BACK SLOPE (EXCAVATION AREA)
200+94.32	31.15 (LT)	28.00	9		IN BACK SLOPE (EXCAVATION AREA)
201+10.60	31.05 (LT)	36.00	12		IN BACK SLOPE (EXCAVATION AREA)
201+61.91	31.44 (LT)	28.00	9		IN BACK SLOPE (EXCAVATION AREA)
201+78.26	31.29 (LT)	30.00	10		IN BACK SLOPE (EXCAVATION AREA)
TOTAL			46		



**LEGEND**

- ① EXISTING HMA SURFACING, ±2.5"
- ② EXISTING HMA BASE COURSE, ±6"
- ③ EXISTING HMA PAVEMENT, ±11"
- ④ EXISTING HMA BASE CSE WIDENING, ±9"
- ⑤ EXISTING PCC PAVEMENT, ±6"
- ⑥ EXISTING SUB-BASE GRAN. MATERIAL
- ⑦ EXISTING HMA SHOULDER
- ⑧ EXISTING AGGREGATE SHOULDER, ±6"
- ⑨ EXISTING CONC. COMB. C&G TYPE B-6.24
- ⑩ EXISTING CONC. COMB. C&G TYPE B-6.12
- ⑪ PROPOSED PAVEMENT REMOVAL
- ⑫ PROPOSED SHOULDER PAVEMENT REMOVAL
- ⑬ PROPOSED HMA BINDER COURSE, IL-19.0, N70, VARIES (PROFILE CORRECTION BINDER) (USED WHEN THICKNESS IS > 2 1/4")
- ⑭ PROPOSED HMA BASE COURSE, 7" (USED WHEN WIDENING GREATER OR EQUAL TO 6')
- ⑮ PROPOSED HMA SURF. REMOVAL, 2-1/2"
- ⑯ PROPOSED POLY. HMA SURF. CSE MIX "E", N70, 1-3/4"
- ⑰ PROPOSED POLY. LEVELING BINDER (MM), IL-4.75, N50, 3/4"
- ⑱ PROPOSED HMA BASE COURSE WIDENING, 7" (USED WHEN WIDENING LESS THAN 6')
- ⑲ PROPOSED HMA SHOULDER, 5 1/2"
- ⑳ PROPOSED HMA SURF CSE MIX "D", N50 (IL-9.5mm), 3"
- ㉑ PROPOSED HMA SURF. CSE MIX "D", N50, 2" (PETITE LAKE ROAD)
- ㉒ PROPOSED HMA BINDER COURSE, 7.5" (PETITE LAKE ROAD)
- ㉓ PROPOSED HMA SURF CSE MIX "D", N50 (IL-9.5mm), 3"
- ㉔ PROPOSED AGGREGATE SUBGRADE IMPROVEMENT, 12"
- ㉕ PROPOSED CONC. COMB. C&G REM. & REPLACEMENT (LOCATIONS TO BE DETERMINED BY THE ENGINEER)
- ㉖ PROPOSED COMB. C&G TYPE B-6-24
- ㉗ PROPOSED COMB. C&G TYPE M-6.24
- ㉘ PROPOSED AGG. BASE COURSE TYPE B, 6" (SHARED PATH)
- ㉙ PROPOSED AGGREGATE WEDGE SHOULDER, TYPE B
- ㉚ PROPOSED GRADING AND SHAPING SHOULDERS
- ㉛ PROPOSED PIPE UNDERDRAIN, 4"
- ㉜ PROPOSED LANDSCAPED PARKWAY
- ㉝ PROPOSED SWALE/DITCH
- ㉞ PROPOSED GEOTECHNICAL FABRIC FOR GROUND STABILIZATION

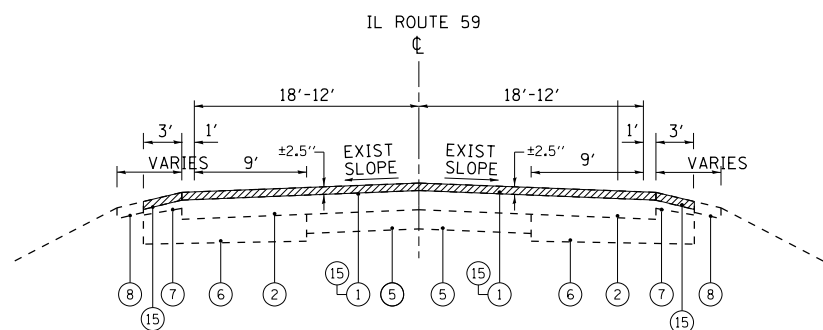


STA. 447+96 TO STA. 449+14  
3' EXIST. HMA SHLD  
3' AGG. SHLD.  
STA. 449+14 TO STA. 453+00  
8' HMA SHLD  
STA. 472+18 TO COLUMBIA  
BAY RD  
EXIST. CONC. C&G

**IL 59 (FOX LAKE RD)  
EXISTING TYPICAL SECTION  
RESURFACING AREA**

STA. 447+96 TO STA. 451+08  
STA. 472+18 TO COLUMBIA BAY RD.

STA. 447+96 TO STA. 451+45  
8' EXIST. HMA SHLD  
3' AGG. SHLD.


STA. 461+36 TO STA. 463+70  
1' EXIST. HMA SHLD  
3' AGG. SHLD.  
STA. 480+16 TO STA. 483+26  
3' EXIST. HMA SHLD  
3' EXIST. AGG. SHLD  
STA. 483+26 TO DERING LN.  
EXIST DEPRESSED C&G  
14' EXIST. HMA SHLD

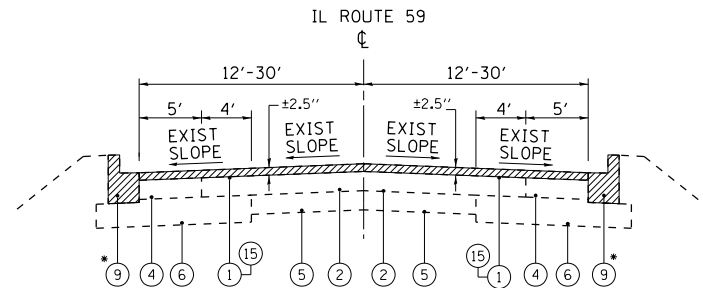

**IL 59 (FOX LAKE RD)  
EXISTING TYPICAL SECTION  
RESURFACING AREA**

STA. 461+36 TO STA. 472+18  
STA. 481+16 TO STA. 486+08

STA. 461+36 TO STA. 464+74  
1' EXIST. HMA SHLD.  
3' EXIST. AGG. SHLD.  
STA. 481+16 TO STA. 484+29  
3' EXIST. HMA SHLD.  
3' EXIST. AGG. SHLD.

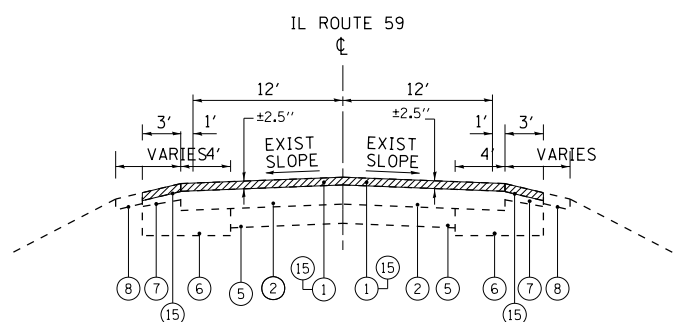


STA. 478+45 TO STA. 484+30  
3' EXIST. HMA SHLD  
3' AGG. SHLD.

**IL 59 (FOX LAKE RD)  
EXISTING TYPICAL SECTION  
RESURFACING AREA**

STA. 451+08 TO STA. 461+36  
COLUMBIA BAY RD. TO STA. 481+16  
STA. 508+42.30 TO STA. 526+88

STA. 478+45 TO STA. 484+30  
3' EXIST. HMA SHLD  
3' AGG. SHLD.

W. DERING LANE @ IL 59  
EXIST C&G AT RADIUS RETURN  
STA. 488+60 TO STA. 491+58.60  
3' EXIST HMA SHLD

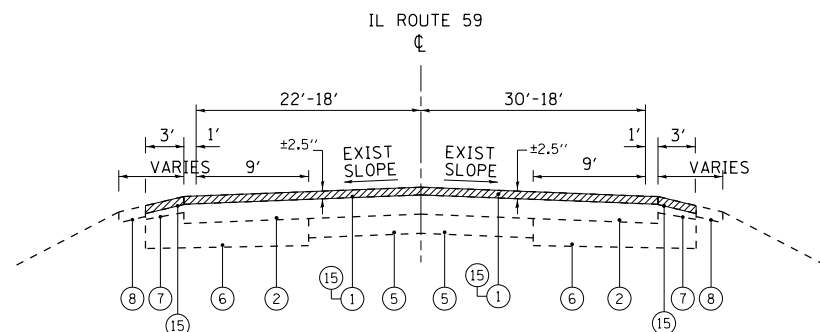

**IL 59 (FOX LAKE RD)  
EXISTING TYPICAL SECTION  
AT DERING LANE  
RESURFACING AREA**

STA. 486+08 TO STA. 491+58.6

W. DERING LANE @ IL 59  
EXIST C&G AT RADIUS RETURN  
STA. 488+60 TO STA. 491+58.60  
3' EXIST HMA SHLD

**NOTE:**

ADDITIONAL SUBBASE AGGREGATE MATERIAL UNDER AND BEHIND CURB AND GUTTER/HMA SHLD. 5 1/2" SHALL NOT BE PAID FOR SEPARATELY BUT WILL BE CONSIDERED AS INCLUDED IN THE COST PER SQUARE YARD OF "AGGREGATE SUBGRADE IMPROVEMENT, 12".

ANY SAW CUTTING REQUIRED TO REMOVE AN ITEM ADJACENT TO AN ITEM TO BE SAVED WILL BE CONSIDERED AS PART OF THE REMOVAL ITEM AND WILL NOT BE PAID FOR SEPARATELY.


"THE CONTRACTOR SHALL MILL FIRST BEFORE PATCHING".

\* PROFILE CORRECTION FROM STA 499+00 TO 505+00

FILE NAME =	USER NAME = ldezma	DESIGNED -	REVISED -	<b>STATE OF ILLINOIS DEPARTMENT OF TRANSPORTATION</b>	<b>IL 59 (IL 132 TO W HIGHWOODS DR) EXIST &amp; PROP TYPICAL SECTIONS</b>	F.A.P. RTE.	SECTION	COUNTY	TOTAL SHEETS	SHEET NO.
pw:\IL084EBIDINTEG.illinois.gov\PIWIDOT\Documents\DOT Offices\District 1\Projects\P14540\Drawings\Design\P45409-sh-typical.dgn	PLLOT SCALE = 100.0000' / 1in.	CHECKED -	REVISED -			104	105N-4	LAKE	113	14
Default	PLLOT DATE = 9/19/2016	DATE -	REVISED -			CONTRACT NO. 60W06			ILLINOIS FED. AID PROJECT	
						SCALE:	SHEET	OF	SHEETS	STA.

**LEGEND**

- ① EXISTING HMA SURFACING, ±2.5"
- ② EXISTING HMA BASE COURSE, ±6"
- ③ EXISTING HMA PAVEMENT, ±11"
- ④ EXISTING HMA BASE CSE WIDENING, ±9"
- ⑤ EXISTING PCC PAVEMENT, ±6"
- ⑥ EXISTING SUB-BASE GRAN. MATERIAL
- ⑦ EXISTING HMA SHOULDER
- ⑧ EXISTING AGGREGATE SHOULDER, ±6"
- ⑨ EXISTING CONC. COMB. C&G TYPE B-6.24
- ⑩ EXISTING CONC. COMB. C&G TYPE B-6.12
- ⑪ PROPOSED PAVEMENT REMOVAL
- ⑫ PROPOSED SHOULDER PAVEMENT REMOVAL
- ⑬ PROPOSED HMA BINDER COURSE, IL-19.0, N70, VARIES (PROFILE CORRECTION BINDER) (USED WHEN THICKNESS IS > 2 1/4")
- ⑭ PROPOSED HMA BASE COURSE, 7" (USED WHEN WIDENING GREATER OR EQUAL TO 6')
- ⑮ PROPOSED HMA SURF. REMOVAL, 2-1/2"
- ⑯ PROPOSED POLY. HMA SURF. CSE MIX "E", N70, 1-3/4"
- ⑰ PROPOSED POLY. LEVELING BINDER (MM), IL-4.75, N50, 3/4"
- ⑱ PROPOSED HMA BASE COURSE WIDENING, 7" (USED WHEN WIDENING LESS THAN 6')
- ⑲ PROPOSED HMA SHOULDER, 5 1/2"
- ⑳ PROPOSED HMA SURF CSE MIX "D", N50 (IL-9.5mm), 3"
- ㉑ PROPOSED HMA SURF. CSE MIX "D", N50, 2" (PETITE LAKE ROAD)
- ㉒ PROPOSED HMA BINDER COURSE, 7.5" (PETITE LAKE ROAD)
- ㉓ PROPOSED HMA SURF CSE MIX "D", N50 (IL-9.5mm), 3"
- ㉔ PROPOSED AGGREGATE SUBGRADE IMPROVEMENT, 12"
- ㉕ PROPOSED CONC. COMB. C&G REM. & REPLACEMENT (LOCATIONS TO BE DETERMINED BY THE ENGINEER)
- ㉖ PROPOSED COMB. C&G TYPE B-6-24
- ㉗ PROPOSED COMB. C&G TYPE M-6.24
- ㉘ PROPOSED AGG. BASE COURSE TYPE B, 6" (SHARED PATH)
- ㉙ PROPOSED AGGREGATE WEDGE SHOULDER, TYPE B
- ㉚ PROPOSED GRADING AND SHAPING SHOULDERS
- ㉛ PROPOSED PIPE UNDERDRAIN, 4"
- ㉜ PROPOSED LANDSCAPED PARKWAY
- ㉝ PROPOSED SWALE/DITCH
- ㉞ PROPOSED GEOTECHNICAL FABRIC FOR GROUND STABILIZATION

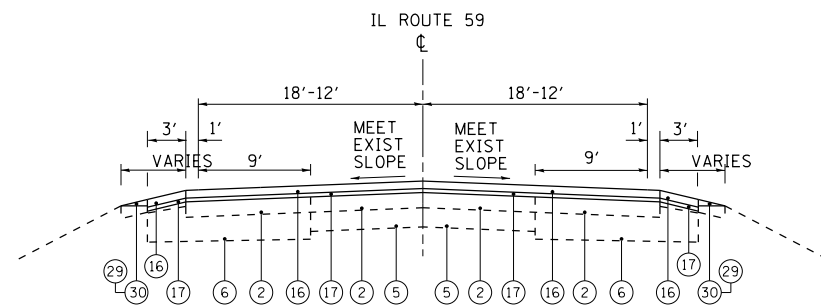


STA. 447+96 TO STA. 449+14  
3' EXIST. HMA SHLD  
3' AGG. SHLD.

STA. 449+14 TO STA. 453+00  
8' HMA SHLD

STA. 472+18 TO COLUMBIA BAY RD  
EXIST. CONC. C&G

**IL 59 (FOX LAKE RD)  
PROPOSED TYPICAL SECTION  
RESURFACING AREA**

STA. 447+96 TO STA. 451+08  
STA. 472+18 TO COLUMBIA BAY RD.

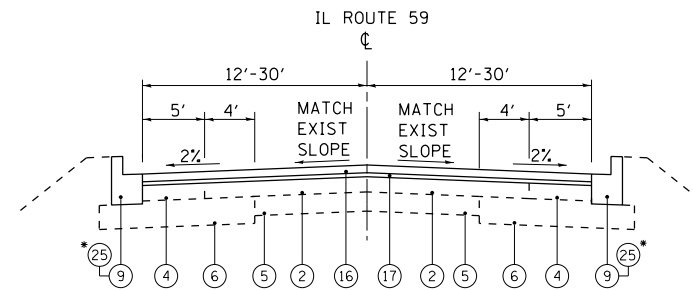

STA. 461+36 TO STA. 463+70  
1' EXIST. HMA SHLD  
3' AGG. SHLD.

STA. 480+16 TO STA. 483+26  
3' EXIST. HMA SHLD  
3' EXIST. AGG. SHLD


STA. 483+26 TO DERING LN.  
EXIST DEPRESSED C&G  
14' EXIST. HMA SHLD

**IL 59 (FOX LAKE RD)  
PROPOSED TYPICAL SECTION  
RESURFACING AREA**

STA. 461+36 TO STA. 472+18  
STA. 481+16 TO STA. 486+08

STA. 461+36 TO STA. 464+74  
1' EXIST. HMA SHLD.  
3' EXIST. AGG. SHLD.

STA. 481+16 TO STA. 484+29  
3' EXIST. HMA SHLD.  
3' EXIST. AGG. SHLD.

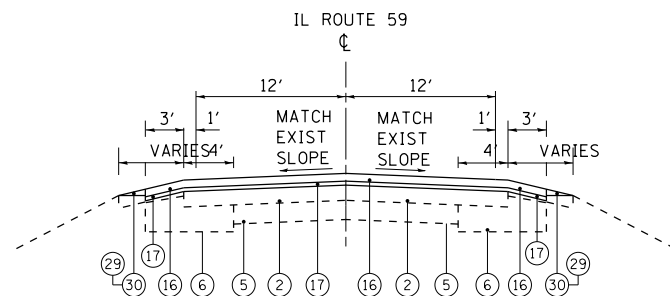


STA. 478+45 TO STA. 484+30  
3' EXIST. HMA SHLD  
3' AGG. SHLD.

STA. 478+45 TO STA. 484+30  
3' EXIST. HMA SHLD  
3' AGG. SHLD.

**IL 59 (FOX LAKE RD)  
PROPOSED TYPICAL SECTION  
RESURFACING AREA**

STA. 451+08 TO STA. 461+36  
COLUMBIA BAY RD. TO STA. 481+16  
STA. 508+42.30 TO STA. 526+88

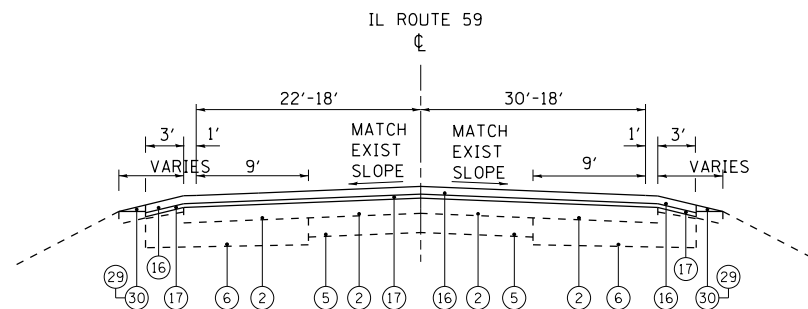

W. DERING LANE @ IL 59  
EXIST C&G AT RADIUS RETURN  
STA. 488+60 TO STA. 491+58.60  
3' EXIST HMA SHLD

**IL 59 (FOX LAKE RD)  
PROPOSED TYPICAL SECTION  
AT DERING LANE  
RESURFACING AREA**

STA. 486+08 TO STA. 491+58.6

W. DERING LANE @ IL 59  
EXIST C&G AT RADIUS RETURN  
STA. 488+60 TO STA. 491+58.60  
3' EXIST HMA SHLD

**NOTE:**

ADDITIONAL SUBBASE AGGREGATE MATERIAL UNDER AND BEHIND CURB AND GUTTER/HMA SHLD. 5 1/2" SHALL NOT BE PAID FOR SEPARATELY BUT WILL BE CONSIDERED AS INCLUDED IN THE COST PER SQUARE YARD OF "AGGREGATE SUBGRADE IMPROVEMENT, 12".

ANY SAW CUTTING REQUIRED TO REMOVE AN ITEM ADJACENT TO AN ITEM TO BE SAVED WILL BE CONSIDERED AS PART OF THE REMOVAL ITEM AND WILL NOT BE PAID FOR SEPARATELY.

"THE CONTRACTOR SHALL MILL FIRST BEFORE PATCHING".


• PROFILE CORRECTION FROM STA 499+00 TO 505+00

FILE NAME =	USER NAME = ldezma	DESIGNED -	REVISED -	<b>STATE OF ILLINOIS DEPARTMENT OF TRANSPORTATION</b>	<b>IL 59 (IL 132 TO W HIGHWOODS DR) EXIST &amp; PROP TYPICAL SECTIONS</b>	F.A.P. RTE. =	SECTION =	COUNTY =	TOTAL SHEETS =	SHEET NO. =	
						104	105N-4	LAKE	113	15	
						<b>CONTRACT NO. 60W06</b>					
						ILLINOIS FED. AID PROJECT					
Default	PLOT DATE = 9/19/2016	DATE -	REVISED -	SCALE:	SHEET OF SHEETS	STA. TO STA.					




**LEGEND**

- ① EXISTING HMA SURFACING, ±2.5"
- ② EXISTING HMA BASE COURSE, ±6"
- ③ EXISTING HMA PAVEMENT, ±11"
- ④ EXISTING HMA BASE CSE WIDENING, ±9"
- ⑤ EXISTING PCC PAVEMENT, ±6"
- ⑥ EXISTING SUB-BASE GRAN. MATERIAL
- ⑦ EXISTING HMA SHOULDER
- ⑧ EXISTING AGGREGATE SHOULDER, ±6"
- ⑨ EXISTING CONC. COMB. C&G TYPE B-6.24
- ⑩ EXISTING CONC. COMB. C&G TYPE B-6.12
- ⑪ PROPOSED PAVEMENT REMOVAL
- ⑫ PROPOSED SHOULDER PAVEMENT REMOVAL
- ⑬ PROPOSED HMA BINDER COURSE, IL-19.0, N70, VARIES (PROFILE CORRECTION BINDER) (USED WHEN THICKNESS IS > 2 1/4")
- ⑭ PROPOSED HMA BASE COURSE, 7" (USED WHEN WIDENING GREATER OR EQUAL TO 6')
- ⑮ PROPOSED HMA SURF. REMOVAL, 2-1/2"
- ⑯ PROPOSED POLY. HMA SURF. CSE MIX "E", N70, 1-3/4"
- ⑰ PROPOSED POLY. LEVELING BINDER (MM), IL-4.75, N50, 3/4"
- ⑱ PROPOSED HMA BASE COURSE WIDENING, 7" (USED WHEN WIDENING LESS THAN 6')
- ⑲ PROPOSED HMA SHOULDER, 5 1/2"
- ⑳ PROPOSED HMA SURF CSE MIX "D", N50 (IL-9.5mm), 3"
- ㉑ PROPOSED HMA SURF. CSE MIX "D", N50, 2" (PETITE LAKE ROAD)
- ㉒ PROPOSED HMA BINDER COURSE, 7.5" (PETITE LAKE ROAD)
- ㉓ PROPOSED HMA SURF CSE MIX "D", N50 (IL-9.5mm), 3"
- ㉔ PROPOSED AGGREGATE SUBGRADE IMPROVEMENT, 12"
- ㉕ PROPOSED CONC. COMB. C&G REM. & REPLACEMENT (LOCATIONS TO BE DETERMINED BY THE ENGINEER)
- ㉖ PROPOSED COMB. C&G TYPE B-6-24
- ㉗ PROPOSED COMB. C&G TYPE M-6.24
- ㉘ PROPOSED AGG. BASE COURSE TYPE B, 6" (SHARED PATH)
- ㉙ PROPOSED AGGREGATE WEDGE SHOULDER, TYPE B
- ㉚ PROPOSED GRADING AND SHAPING SHOULDERS
- ㉛ PROPOSED PIPE UNDERDRAIN, 4"
- ㉜ PROPOSED LANDSCAPED PARKWAY
- ㉝ PROPOSED SWALE/DITCH
- ㉞ PROPOSED GEOTECHNICAL FABRIC FOR GROUND STABILIZATION

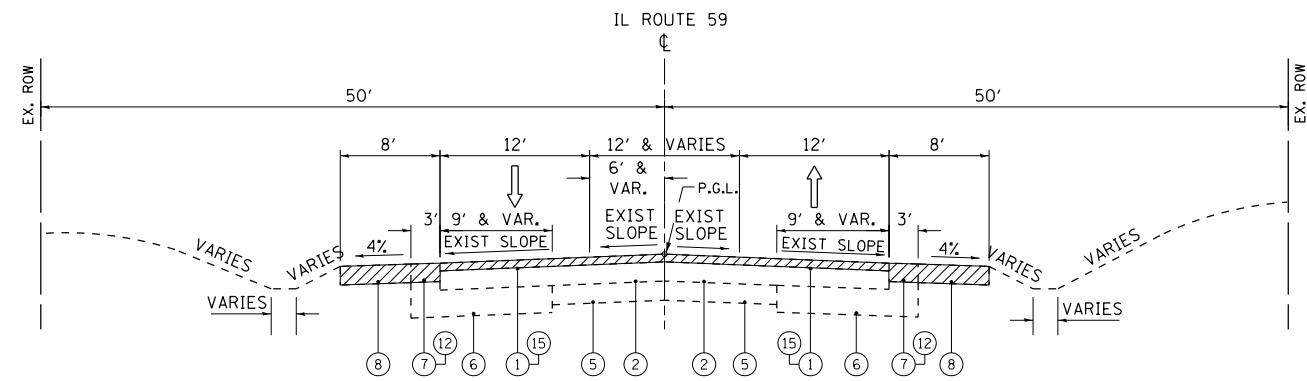

**IL 59 (FOX LAKE RD)  
EXISTING TYPICAL SECTION**  
STA. 491+63 TO 494+42

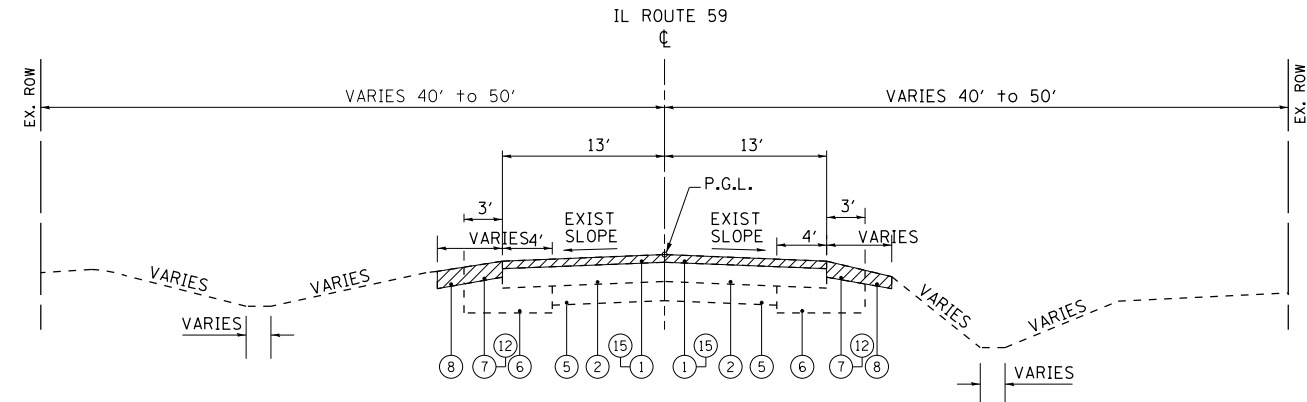

**IL 59 (FOX LAKE RD)  
EXISTING TYPICAL SECTION**  
STA. 494+42 TO 508+47

**NOTE:**

ADDITIONAL SUBBASE AGGREGATE MATERIAL UNDER AND BEHIND CURB AND GUTTER/HMA SHLD. 5 1/2" SHALL NOT BE PAID FOR SEPARATELY BUT WILL BE CONSIDERED AS INCLUDED IN THE COST PER SQUARE YARD OF "AGGREGATE SUBGRADE IMPROVEMENT, 12".

ANY SAW CUTTING REQUIRED TO REMOVE AN ITEM ADJACENT TO AN ITEM TO BE SAVED WILL BE CONSIDERED AS PART OF THE REMOVAL ITEM AND WILL NOT BE PAID FOR SEPARATELY.

"THE CONTRACTOR SHALL MILL FIRST BEFORE PATCHING".

• PROFILE CORRECTION FROM STA 499+00 TO 505+00

HOT-MIX ASPHALT MIXTURE REQUIREMENTS		QUALITY MANAGEMENT PROGRAM (OMP)
MIXTURE TYPE	AIR VOIDS (%) • NDES	
RESURFACING: (IL 59)		
POLY. HMA SURFACE COURSE MIX "E", N70, 1 3/4" (IL-9.5mm)	4% @ 70 GYR.	OCP
POLY. LEVELING BINDER (MM) IL-4.75, N50, 3/4"	3.5% @ 50 GYR.	OCP
WIDENING: (IL 59)		
POLY. HMA SURFACE COURSE MIX "E", N70, 1 3/4" (IL-9.5mm)	4% @ 70 GYR.	OCP
POLY. LEVELING BINDER (MM) (IL-4.75, N50, 3/4"	3.5% @ 50 GYR.	OCP
HMA BASE COURSE WIDENING (HMA BINDER IL-19mm), 7"	4% @ 70 GYR.	OCP (note 1)
HMA BASE COURSE (HMA BINDER IL-19mm), 7"	4% @ 70 GYR.	OCP (note 1)
PROFILE CORRECTION BINDER (HMA BINDER COURSE IL-19.0, N70, THICKNESS > 2 1/4"	4% @ 70 GYR.	OCP (note 1)
PETITE LAKE RD: (RECONSTRUCTION)		
HMA SURFACE COURSE MIX "D", N50, 2" (IL-9.5mm)	4% @ 50 GYR.	OC/QA
HMA BINDER COURSE IL-19, N50, 7/2"	4% @ 50 GYR.	OCP
SHOULDER: (IL 59 WIDENING SECTION)		
POLY. HMA SURFACE COURSE MIX "E", N70, 1 3/4" (IL-9.5mm)	4% @ 70 GYR.	OCP
POLY. LEVELING BINDER (MM) IL-4.75, N50, 3/4"	3.5% @ 50 GYR.	OCP
HMA SHOULDER (HMA BINDER IL-19 mm), 5 1/2"	4% @ 70 GYR.	OCP (note 1)
SHOULDER: (IL 59 RESURFACING SECTION)		
POLY. HMA SURFACE COURSE MIX "E", N70, 1 3/4" (IL-9.5mm)	4% @ 70 GYR.	OCP
POLY. LEVELING BINDER (MM) IL-4.75, N50, 3/4"	3.5% @ 50 GYR.	OCP
IL 59: HOT-MIX ASPHALT PATCHING		
CLASS D PATCHES (HMA BINDER IL-19 mm), 12-1/2"	4% @ 70 GYR.	OC/QA
IL 59 & PETITE LAKE RD: (SHARED PATH)		
HMA SURFACE COURSE MIX "D", N50 (IL 9.5mm), 3"	4% @ 50 GYR.	OC/QA
PETITE LAKE RD: HMA DRIVEWAY (P.E.)		
HMA SURFACE COURSE MIX "D", N50, (IL 9.5mm), 2-1/2"	4% @ 50 GYR.	OC/QA
IL 59: HMA DRIVEWAY (P.E.)		
HMA SURFACE COURSE MIX "D", N50, (IL 9.5mm), 2"	4% @ 50 GYR.	OC/QA
HMA BASE COURSE (IL-19mm), 6"	4% @ 50 GYR.	OC/QA
OMP DESIGNATION QUALITY CONTROL/QUALITY ASSURANCE (OC/QA) QUALITY CONTROL FOR PERFORMANCE (OCP)		

THE UNIT WEIGHT USED TO CALCULATE ALL HMA SURFACE MIXTURE QUANTITIES IS 112 POUND PER SQUARE YARD-INCH


THE "AC TYPE" FOR POLYMERIZED HMA MIXES SHALL BE "SBS / SBR PG 76-22" AND FOR NON-POLYMERIZED HMA THE "AC TYPE" SHALL BE "PG 64-22" UNLESS MODIFIED BY DISTRICT ONE SPECIAL PROVISIONS.

"FOR USE OF RECYCLED MATERIALS SEE DISTRICT ONE SPECIAL PROVISIONS".


QUALITY MANAGEMENT PROGRAM (OMP) IDENTIFIES THE PARTICULAR QUALITY CONTROL SPECIFICATION THAT APPLIES TO THE HMA MIXTURE.

note 1:  
THE DENSITY FOR THIS ITEM WILL BE ASSIGNED 100% PAY FACTOR, BE TESTED RANDOMLY AT THE FREQUENCY REQUIRED IN THE HMA-QUALITY CONTROL FOR PERFORMANCE SPECIAL PROVISION, AND SHALL MEET MINIMUM QC/QA DENSITY REQUIREMENTS IN ACCORDANCE WITH ART. 1030 OF THE STANDARD SPECIFICATIONS



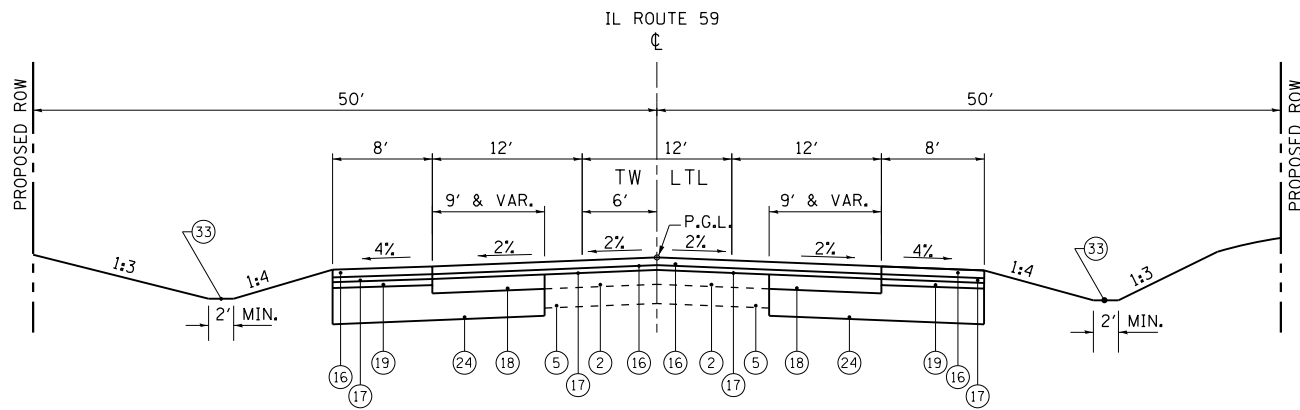

**IL 59 (FOX LAKE RD)  
PROPOSED TYPICAL SECTION**  
STA. 491+58.6 TO 495+20

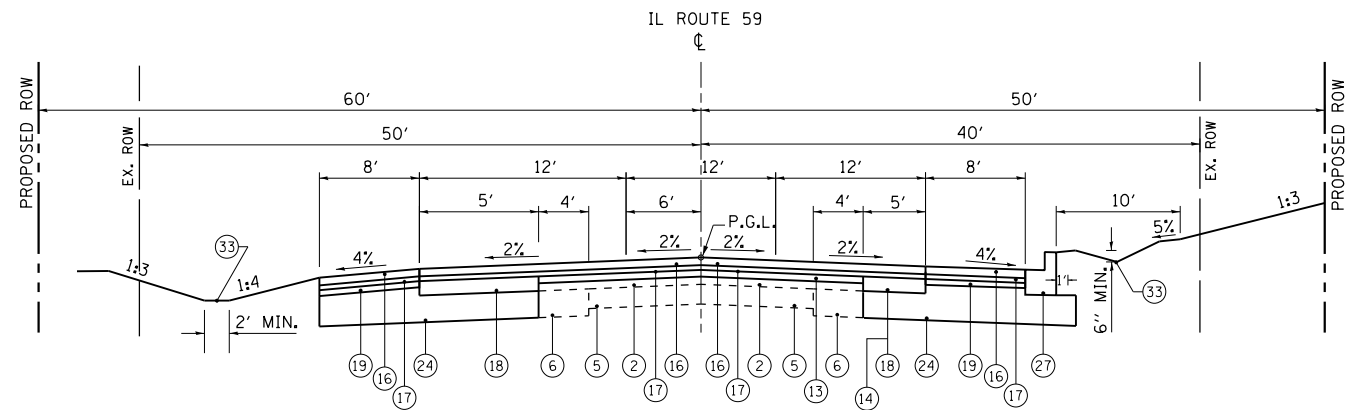

**IL 59 (FOX LAKE RD)  
PROPOSED TYPICAL SECTION**  
STA. 497+85 TO 502+15

**LEGEND**

- ① EXISTING HMA SURFACING, ±2.5"
- ② EXISTING HMA BASE COURSE, ±6"
- ③ EXISTING HMA PAVEMENT, ±11"
- ④ EXISTING HMA BASE CSE WIDENING, ±9"
- ⑤ EXISTING PCC PAVEMENT, ±6"
- ⑥ EXISTING SUB-BASE GRAN. MATERIAL
- ⑦ EXISTING HMA SHOULDER
- ⑧ EXISTING AGGREGATE SHOULDER, ±6"
- ⑨ EXISTING CONC. COMB. C&G TYPE B-6.24
- ⑩ EXISTING CONC. COMB. C&G TYPE B-6.12
- ⑪ PROPOSED PAVEMENT REMOVAL
- ⑫ PROPOSED SHOULDER PAVEMENT REMOVAL
- ⑬ PROPOSED HMA BINDER COURSE, IL-19.0, N70, VARIES (PROFILE CORRECTION BINDER) (USED WHEN THICKNESS IS > 2 1/4")
- ⑭ PROPOSED HMA BASE COURSE, 7" (USED WHEN WIDENING GREATER OR EQUAL TO 6')
- ⑮ PROPOSED HMA SURF. REMOVAL, 2-1/2"
- ⑯ PROPOSED POLY. HMA SURF. CSE MIX "E", N70, 1-3/4"
- ⑰ PROPOSED POLY. LEVELING BINDER (MM), IL-4.75, N50, 3/4"
- ⑱ PROPOSED HMA BASE COURSE WIDENING, 7" (USED WHEN WIDENING LESS THAN 6')
- ⑲ PROPOSED HMA SHOULDER, 5 1/2"
- ⑳ PROPOSED HMA SURF CSE MIX "D", N50 (IL-9.5mm), 3"
- ㉑ PROPOSED HMA SURF. CSE MIX "D", N50, 2" (PETITE LAKE ROAD)
- ㉒ PROPOSED HMA BINDER COURSE, 7.5" (PETITE LAKE ROAD)
- ㉓ PROPOSED HMA SURF CSE MIX "D", N50 (IL-9.5mm), 3"
- ㉔ PROPOSED AGGREGATE SUBGRADE IMPROVEMENT, 12"
- ㉕ PROPOSED CONC. COMB. C&G REM. & REPLACEMENT (LOCATIONS TO BE DETERMINED BY THE ENGINEER)
- ㉖ PROPOSED COMB. C&G TYPE B-6-24
- ㉗ PROPOSED COMB. C&G TYPE M-6-24
- ㉘ PROPOSED AGG. BASE COURSE TYPE B, 6" (SHARED PATH)
- ㉙ PROPOSED AGGREGATE WEDGE SHOULDER, TYPE B
- ㉚ PROPOSED GRADING AND SHAPING SHOULDERS
- ㉛ PROPOSED PIPE UNDERDRAIN, 4"
- ㉜ PROPOSED LANDSCAPED PARKWAY
- ㉝ PROPOSED SWALE/DITCH
- ㉞ PROPOSED GEOTECHNICAL FABRIC FOR GROUND STABILIZATION


**NOTE:**

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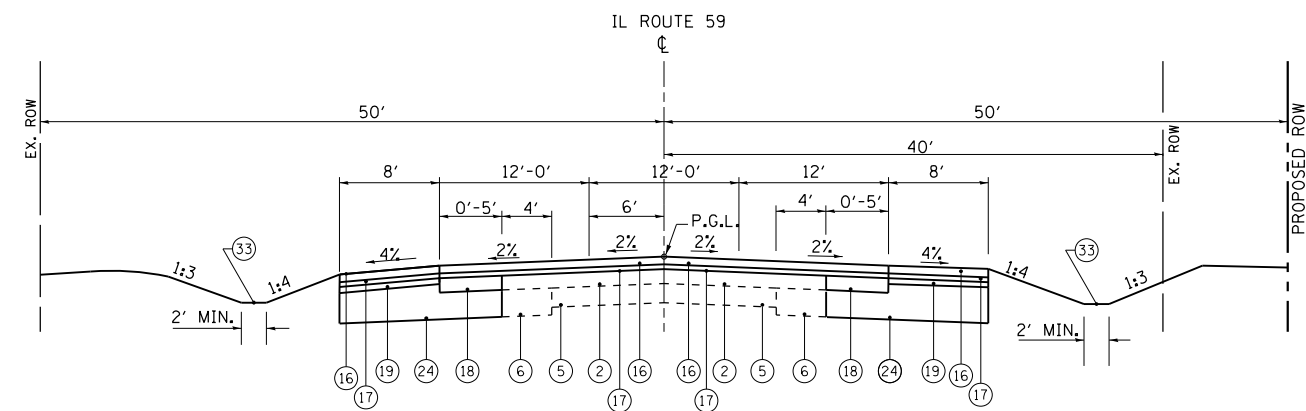
"THE CONTRACTOR SHALL MILL FIRST BEFORE PATCHING".

- PROFILE CORRECTION FROM STA 499+00 TO 505+00




PROPOSED SHARED PATH:  
STA. 500+38.44 TO RAVINE DR.

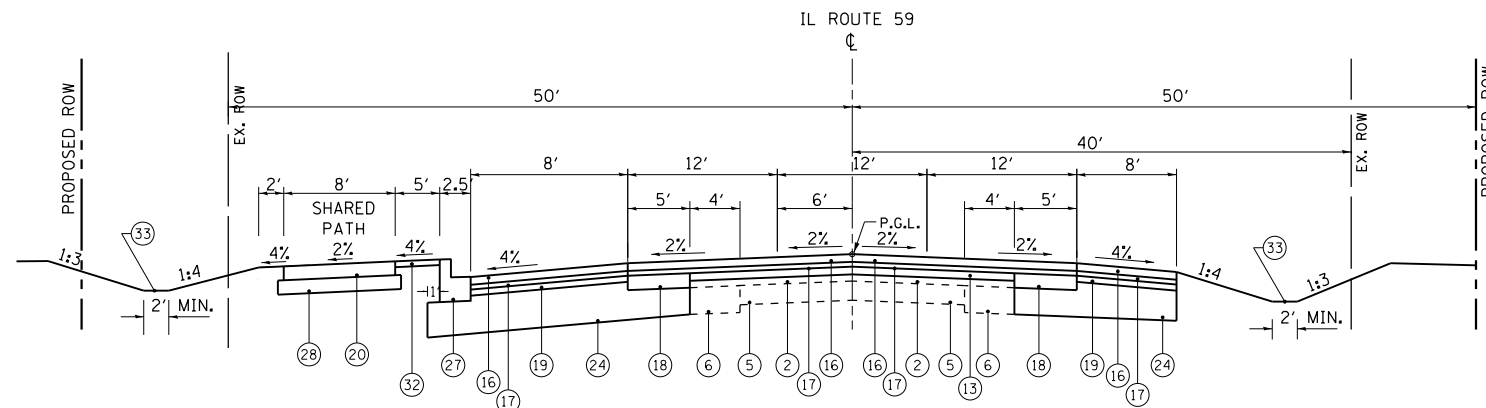**IL 59 (FOX LAKE RD)  
PROPOSED TYPICAL SECTION**  
STA. 495+20 TO 497+85  
STA. 502+15 TO 505+47



**IL 59 (FOX LAKE RD)  
PROPOSED TYPICAL SECTION**  
STA. 505+47 TO 508+42.3


FILE NAME =	USER NAME = ledeznom	DESIGNED -	REVISED -	<b>STATE OF ILLINOIS DEPARTMENT OF TRANSPORTATION</b>	<b>EXISTING &amp; PROPOSED TYPICAL SECTIONS IL. ROUTE 59 AT PETITE LAKE RD.</b>	F.A.P. RTE.	SECTION	COUNTY	TOTAL SHEETS	SHEET NO.	
pw\IL084EBIDINTEG.illinois.gov\PIWIDOT\Documents\IDOT Offices\District 1\Projects\P14540\Drawings\Design\P45409-sh-typical.dgn		CHECKED -	REVISED -			104	105N-4	LAKE	113	17	
Default		DATE -	REVISED -			CONTRACT NO. 60W06					
						ILLINOIS FED. AID PROJECT					

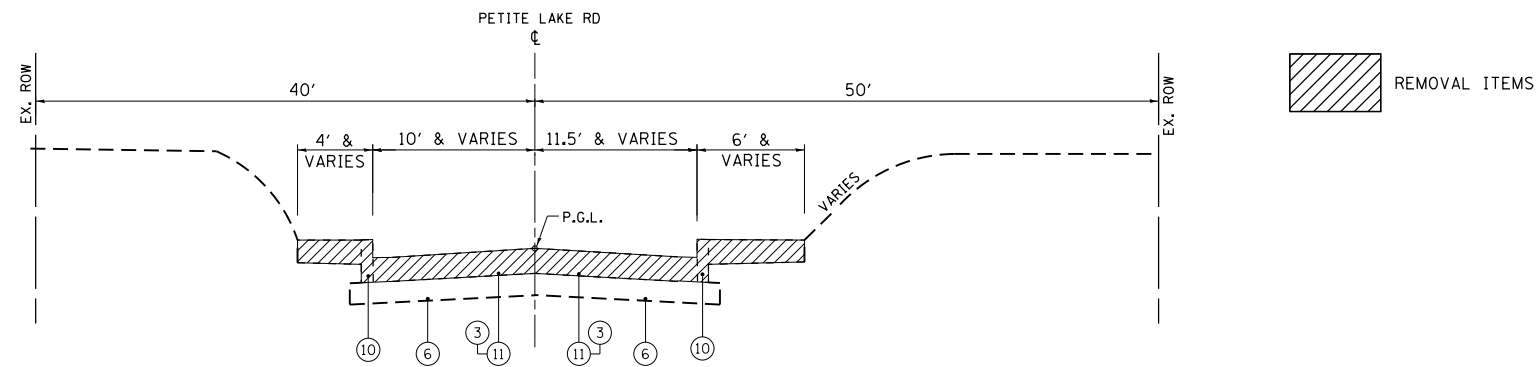

EXIST. C&G, TYPE B-6.12  
(STA. 200+00 - STA. 203+39.37)

EXIST. C&G, TYPE B-6.12  
(STA. 200+00 - STA. 203+39.37)

**PETITE LAKE RD  
EXISTING TYPICAL SECTION**  
STA. 200+00 TO 203+39.37  
(0+00 TO 3+39.37, LCDOT (LAKE COUNTY DOT))

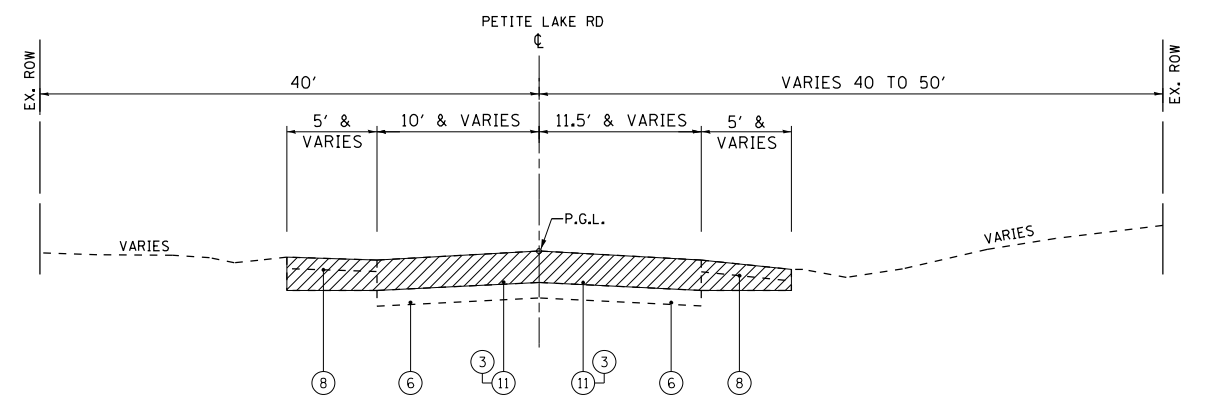

**PETITE LAKE RD  
EXISTING TYPICAL SECTION**  
STA. 203+39.37 TO 208+67  
(3+39.37 TO 8+67, LCDOT)

**LEGEND**

- ① EXISTING HMA SURFACING, ±2.5"
- ② EXISTING HMA BASE COURSE, ±6"
- ③ EXISTING HMA PAVEMENT, ±11"
- ④ EXISTING HMA BASE CSE WIDENING, ±9"
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- ㉝ PROPOSED SWALE/DITCH
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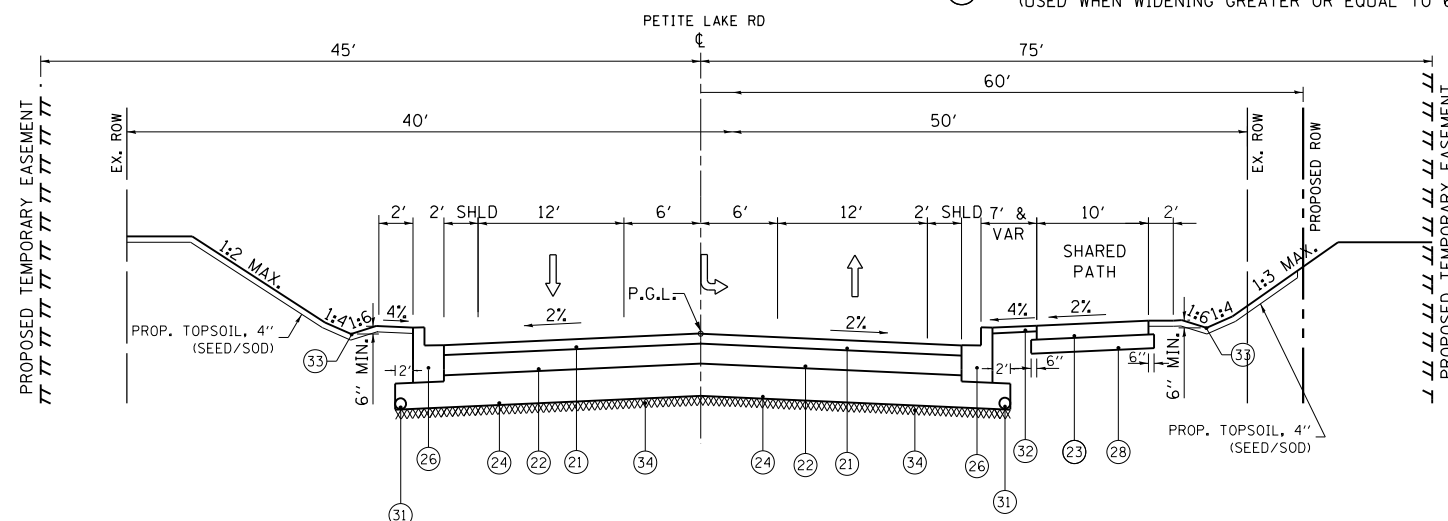
**NOTE:**

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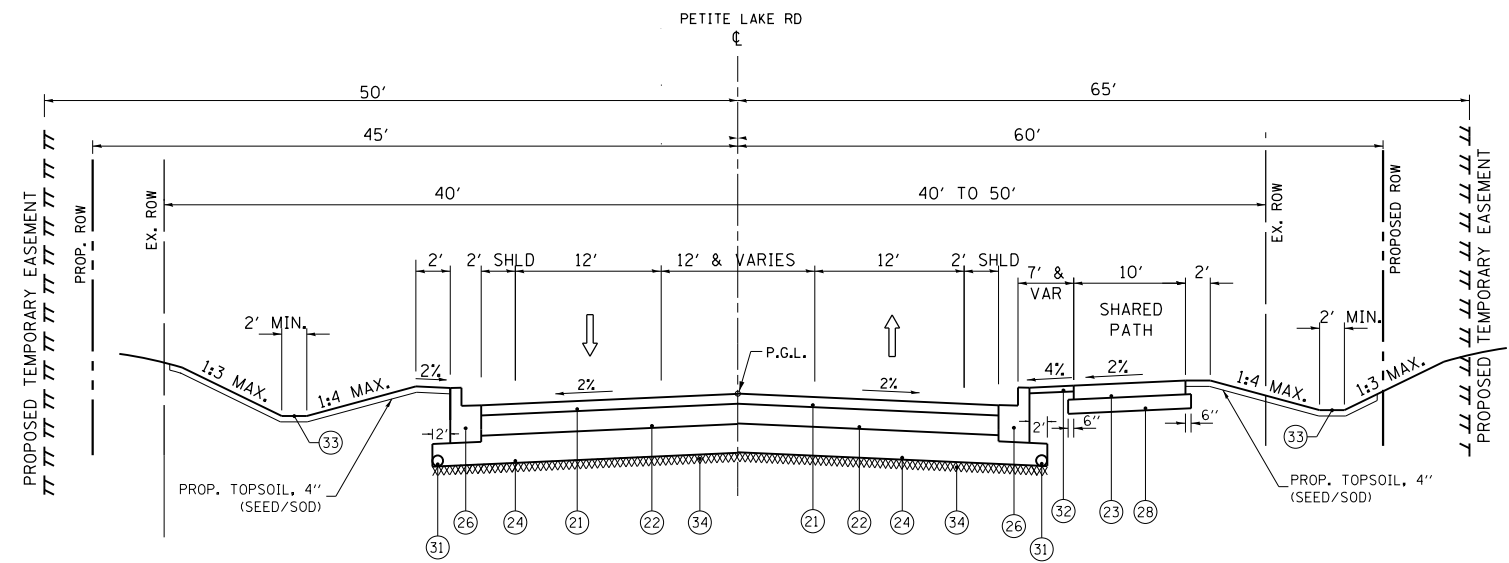
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"THE CONTRACTOR SHALL MILL FIRST BEFORE PATCHING".

- PROFILE CORRECTION FROM STA 499+00 TO 505+00



**PETITE LAKE RD  
PROPOSED TYPICAL SECTION**  
STA. 200+93.5 TO 204+47  
(0+93.5 TO 4+47, LCDOT)




**PETITE LAKE RD  
PROPOSED TYPICAL SECTION**  
STA. 204+47 TO 208+67  
(4+47 TO 8+67, LCDOT)

FILE NAME =	USER NAME = ldezma	DESIGNED -	REVISED -	<b>STATE OF ILLINOIS DEPARTMENT OF TRANSPORTATION</b>	<b>EXISTING &amp; PROPOSED TYPICAL SECTIONS IL. ROUTE 59 AT PETITE LAKE RD.</b>	F.A.P. RTE.	SECTION	COUNTY	TOTAL SHEETS	SHEET NO.	
pw:\IL\084EBID\INTEG\illinois.gov\PI\DOT\Documents\DOT Offices\District 1\Projects\P14540\DATA\Design\P45409-sh-typical.dgn		CHECKED -	REVISED -			104	105N-4	LAKE	113	18	
Default	PLOT SCALE = 100.0000' / 1in.	DATE -	REVISED -			CONTRACT NO. 60W06					
	PLOT DATE = 9/19/2016					ILLINOIS FED. AID PROJECT					


EXIST. CURVE E\_IL59-3  
 PI STA. = 518+54.02  
 $\Delta = 2^{\circ} 25' 03''$  (RT)  
 $D = 0^{\circ} 05' 00''$   
 $R = 68,760.00'$   
 $T = 1,450.90'$   
 $L = 2,901.36'$   
 $E = 15.31'$   
 $e = \text{-----}$   
 $T.R. = \text{-----}$   
 $S.E. \text{ RUN} = \text{-----}$   
 P.C. STA. = 504+03.12  
 P.T. STA. = 533+04.49

IL. 59	PI	STA. 478+15.88	N 2097214.92	E 1041893.59
	PC CURVE 1	STA. 504+03.12	N 2099729.19	E 1042503.73
	PI CURVE 1	STA. 518+54.02	N 2101139.17	E 1042845.89
	PT CURVE 1	STA. 533+04.49	N 2102533.45	E 1043247.22
PETITE LAKE RD.	PI	STA. 200+00	N 2099337.42	E 1042408.66
	PI	STA. 214+86.98	N 2099347.37	E 1043895.61
	PI	STA. 216+43.03	N 2099348.42	E 1044051.65

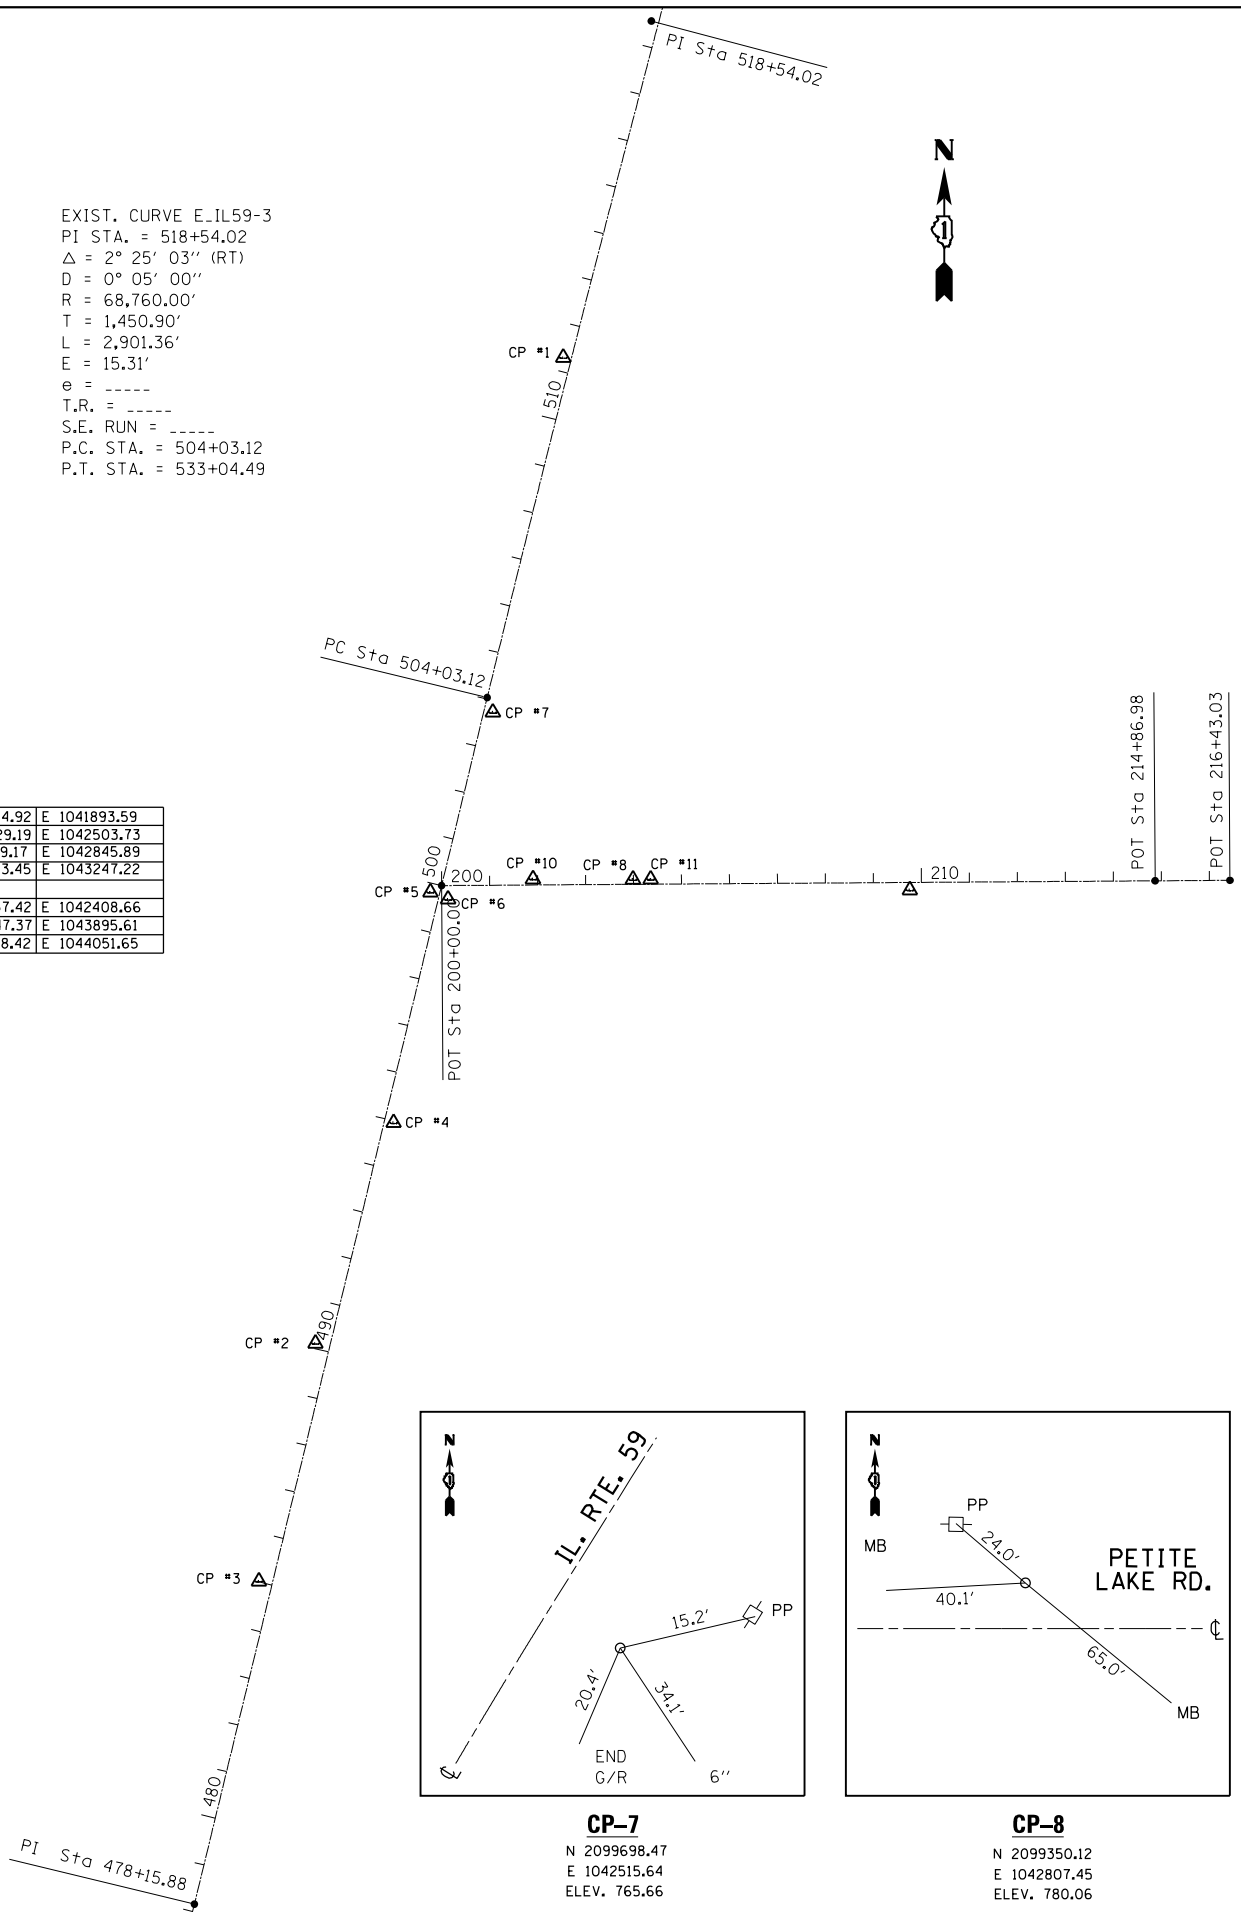


**BENCHMARKS**

BM 1 - SPIKE/SCREW FOUND IN PP EAST SIDE OF RTE. 59 @ RES #38923, ELEV. 777.50  
 BM 2 - SPIKE & YELLOW TOP IN PP EAST SIDE RTE. 59 ACROSS FROM RES # 39122, ELEV. 774.30  
 BM 3 - SPIKE & YELLOW TOP IN PP NORTH SIDE PETITE LAKE RD. @ ENT. TO X-MAS TREE FARM HOUSE, ELEV. 778.61

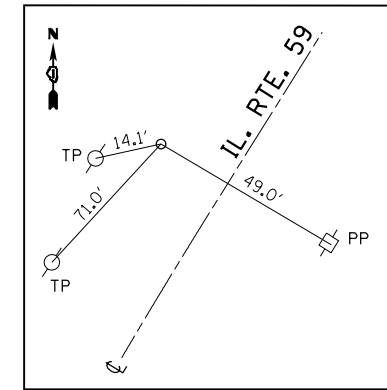


**CP-1**

N 2100437.82  
 E 1042662.36  
 ELEV. 788.76

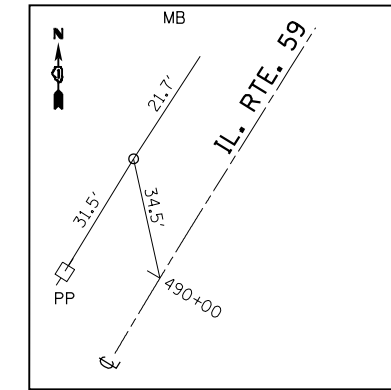


**CP-2**

N 2098383.52  
 E 1042145.65  
 ELEV. 773.48

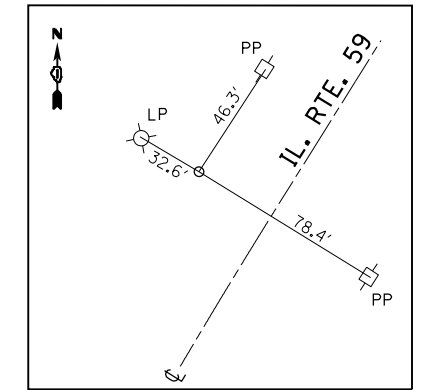


**CP-3**

N 2097887.70  
 E 1042027.87  
 ELEV. 777.00

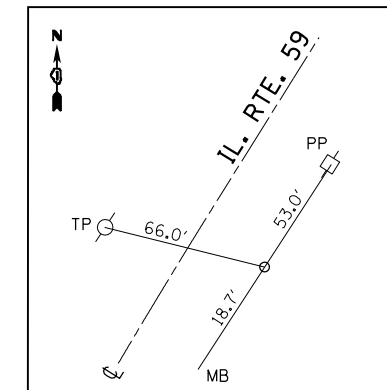


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N 2098843.22  
 E 1042308.48  
 ELEV. 774.63

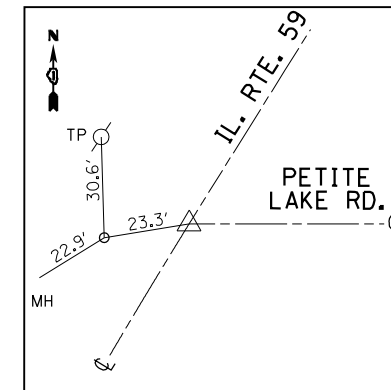


**CP-5**

N 2099323.81  
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 ELEV. 771.68

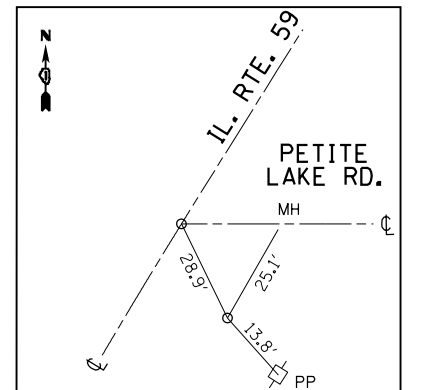


**CP-6**

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 ELEV. 771.93

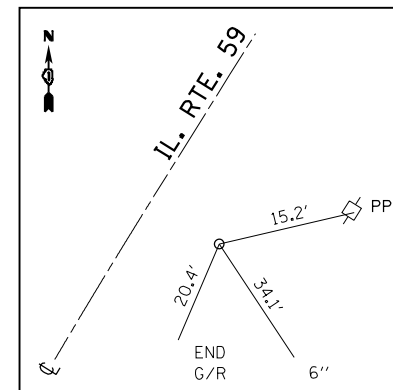


**CP-7**

N 2099698.47  
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 ELEV. 765.66

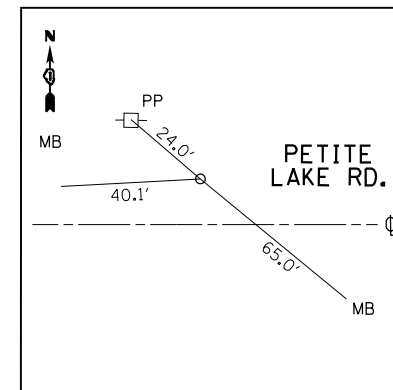


**CP-8**

N 2099350.12  
 E 1042807.45  
 ELEV. 780.06

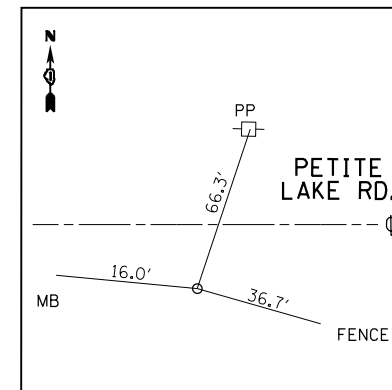


**CP-9**

N 2099327.96  
 E 1043384.69  
 ELEV. 780.59

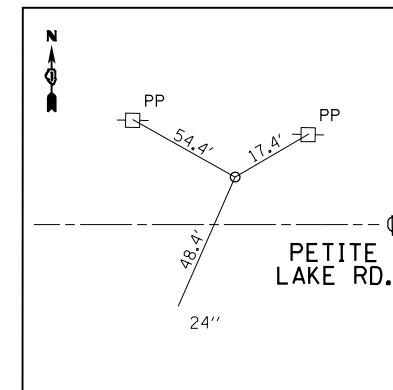

**CP-10**

N 2099350.98  
 E 1042599.06  
 ELEV. 778.27

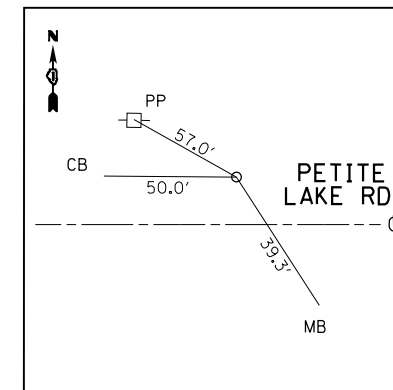

**CP-11**

N 2099350.50  
 E 1042844.40  
 ELEV. 779.52

FILE NAME =	USER NAME = ldezarm	DESIGNED -	REVISED -
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Default	PLOT SCALE = 400.0000' / in.	CHECKED -	REVISED -
	PLOT DATE = 8/19/2016	DATE -	REVISED -

**STATE OF ILLINOIS  
 DEPARTMENT OF TRANSPORTATION**

**ALIGNMENT AND BENCHMARKS  
 IL. ROUTE 59 (FOX LAKE RD.) AT PETITE LAKE ROAD**

SCALE: 1"=200' SHEET OF SHEETS STA. TO STA.

F.A.P. RTE.	SECTION	COUNTY	TOTAL SHEETS	SHEET NO.
104	105N-4	LAKE	113	19
CONTRACT NO. 60W06				
ILLINOIS FED. AID PROJECT				

PART OF THE NORTHWEST QUARTER OF SECTION 31, TOWNSHIP 46 NORTH, RANGE 10 EAST OF THE THIRD PRINCIPAL MERIDIAN, LAKE COUNTY, ILLINOIS.

PARCEL NUMBER	OWNER	TOTAL HOLDINGS ACRES	PART TAKEN ACRES	AREA IN EXISTING R.O.W. ACRES	REMAINDER AREA ACRES	EASEMENT ACRES	AREA SQUARE FEET	EASEMENT PURPOSE	PERMANENT INDEX NUMBER	PROPERTY ACQUIRED BY
1JW0001PE	LAKE VILLA COMMUNITY CONSOLIDATED SCHOOL DISTRICT NUMBER 41	1.072		0.157	1.072	0.056	2418	DRAINAGE	02-31-100-012	
1JW0002	NANCY R. BOLIN, A SINGLE PERSON	1.950	0.150	0.099	1.800				02-31-100-067 02-31-100-068	
1JW0003	BRUCE E. ROSEMANN AND EMILY A. ROSEMANN, HIS WIFE, IN JOINT TENANCY	2.810	0.253	0.167	2.557				02-31-100-009	
1JW0004	GLENDAM. SCOTT, ANDREW A. SCOTT AND NICOLE SCOTT, AS JOINT TENANTS	1.055	0.154	0.102	0.901				02-31-100-032	

LEGEND

SECTION CORNER 9 10 16 15

QUARTER CORNER 16 15 SECTION CORNER

SECTION LINE

QUARTER SECTION LINE

QUARTER, QUARTER SECTION LINE

PLATTED LOT LINES

PROPERTY (DEED) LINE

APPARENT PROPERTY LINE

CENTERLINE

EXISTING RIGHT OF WAY LINE

PROPOSED RIGHT OF WAY LINE

PROPOSED EASEMENT

MEASURED DIMENSION (129.32')

COMPUTED DIMENSION (129.32')

RECORDED DIMENSION

EXISTING BUILDING

IRON PIPE OR ROD FOUND ⊕ PK OR "MAG" NAIL SET

CUT CROSS FOUND OR SET ○ REBAR SET

T1 T2 T3 THESE STAKES REFERENCE FOUND OR SET MONUMENTATION. SET 5/8 INCH IRON ROD FLUSH WITH GROUND TO TIE FOUND IRON STAKE IDENTIFIED BY COLORED PLASTIC CAP BEARING SURVEYORS REGISTRATION NUMBER.

BT1 BT2 BT3 THESE STAKES, IN CULTIVATED AREAS, REFERENCE FOUND OR SET MONUMENTATION. BURIED 5/8 INCH IRON ROD 20 INCHES BELOW GROUND TO TIE FOUND IRON STAKE. IDENTIFIED BY COLORED PLASTIC CAP BEARING SURVEYORS REGISTRATION NUMBER.

STAKING OF PROPOSED RIGHT OF WAY. SET DIVISION OF HIGHWAYS SURVEY MARKER TO MONUMENT THE POSITION SHOWN. IDENTIFIED BY INSCRIPTION DATA AND SURVEYORS REGISTRATION NUMBER.

STAKING OF PROPOSED RIGHT OF WAY IN CULTIVATED AREAS. BURIED 5/8 INCH METAL ROD 20 INCHES BELOW GROUND TO MARK FUTURE SURVEY MARKER POSITION IDENTIFIED BY COLORED PLASTIC CAP BEARING SURVEYORS REGISTRATION NUMBER.

PERMANENT SURVEY MARKER, I.D.O.T. STANDARD 2135 (TO BE SET BY OTHERS).

RIGHT OF WAY STAKING PROPOSED TO BE SET.

STATE OF ILLINOIS )  
) SSS  
COUNTY OF COOK )

THIS IS TO CERTIFY THAT I, WILLIAM J. FLEMING, AN ILLINOIS PROFESSIONAL LAND SURVEYOR, HAVE SURVEYED THE PLAT OF HIGHWAYS SHOWN HEREON IN SECTION 31, TOWNSHIP 46 NORTH, RANGE 10 EAST OF THE THIRD PRINCIPAL MERIDIAN, LAKE COUNTY, ILLINOIS, THAT THE SURVEY IS TRUE AND COMPLETE AS SHOWN TO THE BEST OF MY KNOWLEDGE AND BELIEF, THAT THE PLAT CORRECTLY REPRESENTS SAID SURVEY, THAT ALL MONUMENTS FOUND AND ESTABLISHED ARE OF PERMANENT QUALITY AND OCCUPY THE POSITIONS SHOWN THEREON AND THAT THE MONUMENTS ARE SUFFICIENT TO ENABLE THE SURVEY TO BE RETRACED, MADE FOR THE DEPARTMENT OF TRANSPORTATION, STATE OF ILLINOIS.

DATED AT CHICAGO, ILLINOIS THIS 28TH DAY OF JANUARY, A.D. 2013.


ILLINOIS PROFESSIONAL LAND SURVEYOR 35-3226  
LICENSE EXPIRATION DATE: 11/30/2014

THIS PROFESSIONAL SERVICE CONFORMS TO THE CURRENT ILLINOIS MINIMUM STANDARDS OF PRACTICE FOR A BOUNDARY SURVEY.

GRAPHIC SCALE FEET SCALE: 1" = 50'

BEARINGS AND COORDINATES ARE BASED ON THE ILLINOIS STATE PLANE COORDINATE SYSTEM, NAD83, EAST ZONE, AND THE EXISTING CENTERLINE OF ILLINOIS ROUTE 59 BEARS N 13° 38' 25" E

NORTHWEST CORNER NORTHWEST QUARTER SECTION 31-46-10 POINT OF COMMENCEMENT 1JW0001PE 1JW0002 1JW0003 1JW0004 POINT IS INACCESSIBLE IN A LARGE BODY OF WATER

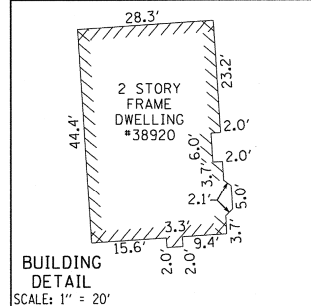

GROUND COORDINATES ON THE CROSS OF PK NAILS SET AT THE INTERSECTION OF THE EXISTING CENTERLINE OF ILLINOIS ROUTE 59 AND THE NORTH LINE OF THE NORTHWEST QUARTER OF SECTION 31-46-10 HAVE A VALUE OF 2,099,377.443 NORTH - 1,042,408.661 EAST AND ARE BASED ON THE ILLINOIS STATE PLANE COORDINATE SYSTEM, NAD '83, EAST ZONE


STATION	OFFSET	NORTH	EAST

PTB 161/017 WORK ORDER 1 GRAEF PROJECT 20123007.01

PLAT OF HIGHWAYS  
STATE OF ILLINOIS  
DEPARTMENT OF TRANSPORTATION  
ILLINOIS ROUTE 59  
SECTION: AT PETITE LAKE ROAD COUNTY: LAKE  
PROJECT JOB NO.: R-91-025-12  
STATION 488+00.00 TO STATION 497+00.00  
SCALE: 1" = 50' SHEET 2 OF 6

BUREAU OF LAND ACQUISITION  
201 WEST CENTER COURT  
SCHAUMBURG, ILLINOIS 60196



REVISION DATE REVISION MADE BY

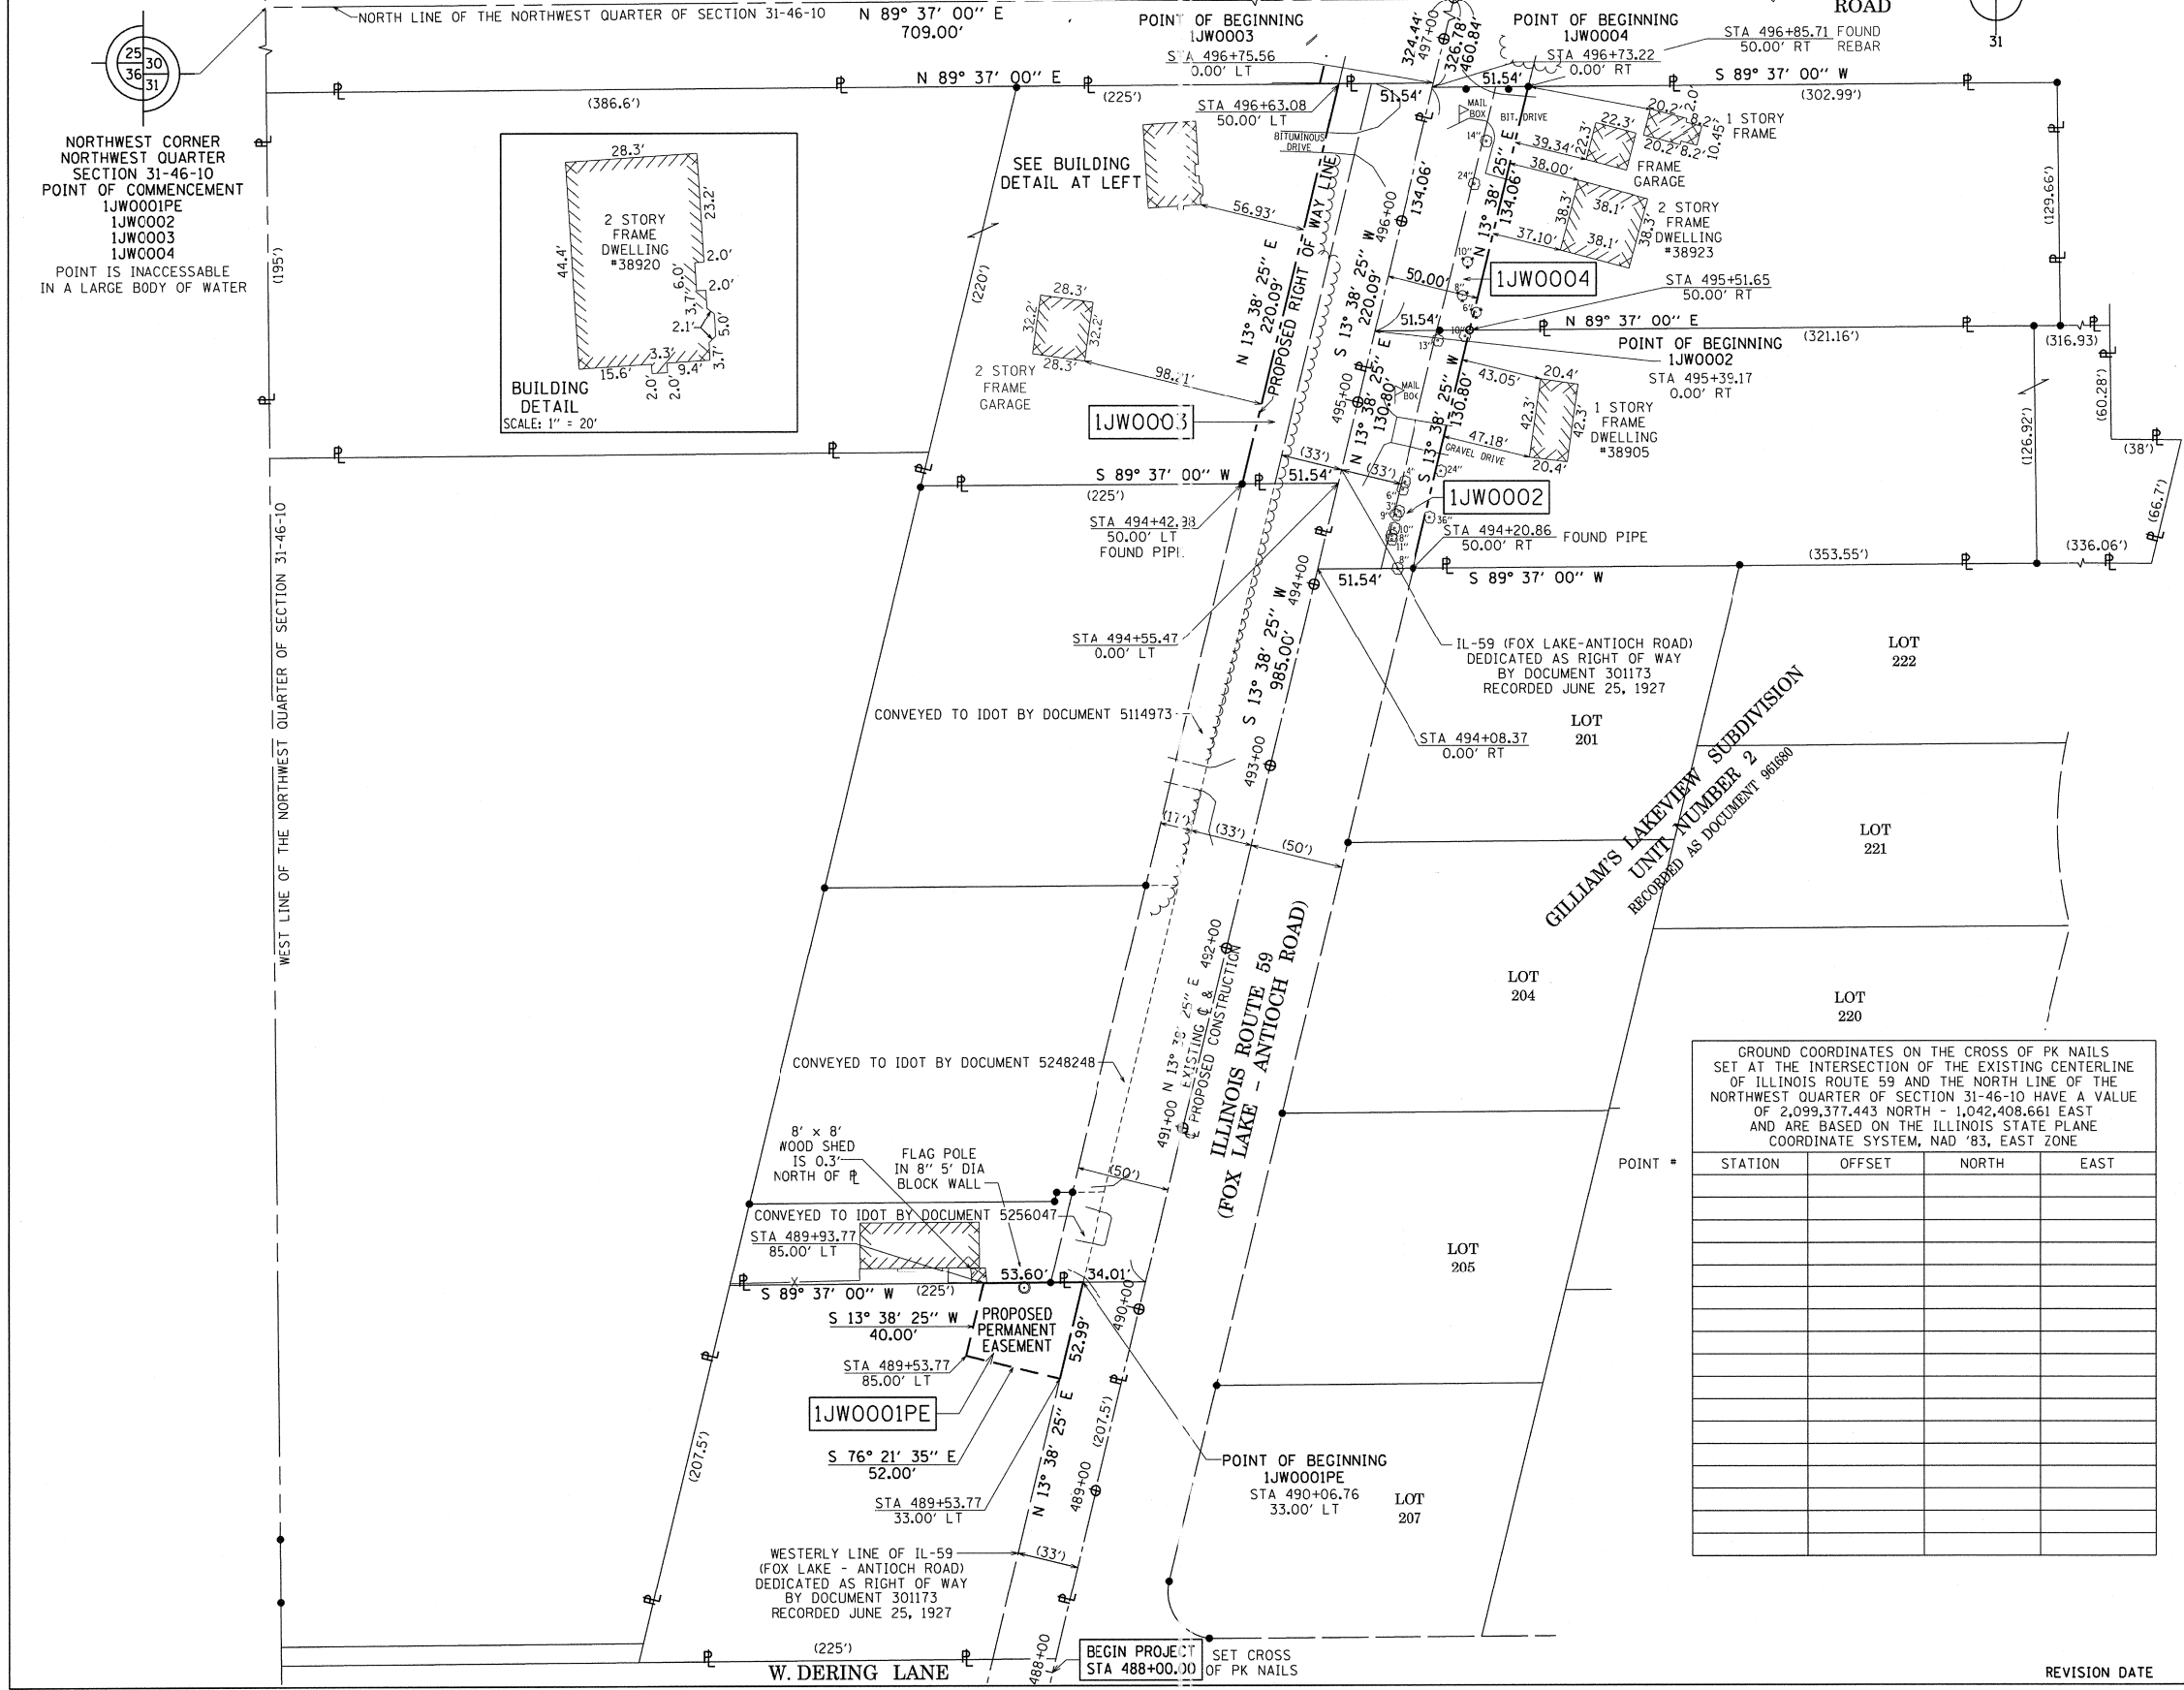

PART OF THE SOUTHWEST QUARTER OF SECTION 30 AND NORTHWEST QUARTER OF SECTION 31, TOWNSHIP 46 NORTH, RANGE 10 EAST OF THE THIRD PRINCIPAL MERIDIAN, LAKE COUNTY, ILLINOIS.

PARCEL NUMBER	OWNER	TOTAL HOLDINGS ACRES	PART TAKEN ACRES	AREA IN EXISTING R.O.W. ACRES	REMAINDER AREA ACRES	EASEMENT AREA		EASEMENT PURPOSE	PERMANENT INDEX NUMBER	PROPERTY ACQUIRED BY
						ACRES	SQUARE FEET			
IJW0005TE	HANS G. LUEDTKE, AS TRUSTEE UNDER A TRUST AGREEMENT DATED THE 23RD DAY OF MAY, 2008, AND DESIGNATED AS TRUST NO. 38956	2.240				0.030	1318	GRADING	02-31-101-002	
IJW0007 IJW0007TE	ULRICH KUEHN AND FRIEDEL KUEHN, HIS WIFE, IN JOINT TENANCY	2.615	0.011		2.604	0.034	1470	GRADING	02-31-101-001	
IJW0008	SHARON F. DAVIS, SHARON DAVIS AND FERN Y. WALASIAK AS JOINT TENANTS; AND MARTIN W. DAVIS; ALL AS TO AN UNDETERMINED PERCENTAGE INTEREST	1.505	0.138	0.076	1.367				02-30-300-016	
IJW0010	JUDY A. MARTIN AKA JUDITH A. MARTIN	0.540	0.034		0.506				02-30-309-014 02-30-309-015 02-30-309-016	
IJW0016	SHARON F. DAVIS, SHARON DAVIS AND FERN Y. WALASIAK AS JOINT TENANTS; AND MARTIN W. DAVIS; ALL AS TO AN UNDETERMINED PERCENTAGE INTEREST	3.849	0.284	0.154	3.565				02-30-300-025	


ILLINOIS ROUTE 59  
EXISTING & PROPOSED  
CONSTRUCTION  
 $\Delta = 02^\circ 25' 03''$   
 $R = 68,760.00'$   
 $L = 2,901.37'$   
 $T = 1450.90'$   
 $E = 15.31'$   
 PC STA 504+03.10  
 N - 2,099,729.170  
 E - 1,042,503.722  
 PI STA 518+54.00  
 N - 2,101,139.150  
 E - 1,042,845.882  
 PT STA 533+04.47  
 N - 2,102,533.443  
 E - 1,043,247.214

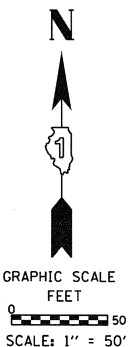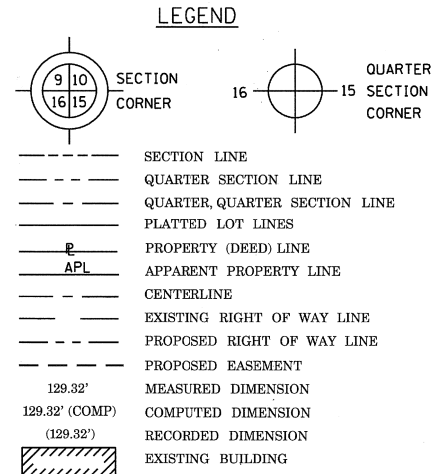

BEARINGS AND COORDINATES ARE BASED ON THE ILLINOIS STATE PLANE COORDINATE SYSTEM, NAD83, EAST ZONE, AND THE EXISTING CENTERLINE OF ILLINOIS ROUTE 59 BEARS N 13° 38' 25\"/>

GROUND COORDINATES ON THE CROSS OF PK NAILS SET AT THE INTERSECTION OF THE EXISTING CENTERLINE OF ILLINOIS ROUTE 59 AND THE NORTH LINE OF THE NORTHWEST QUARTER OF SECTION 31-46-10 HAVE A VALUE OF 2,099,377.443 NORTH - 1,042,408,661 EAST AND ARE BASED ON THE ILLINOIS STATE PLANE COORDINATE SYSTEM, NAD '83, EAST ZONE

STATION	OFFSET	NORTH	EAST

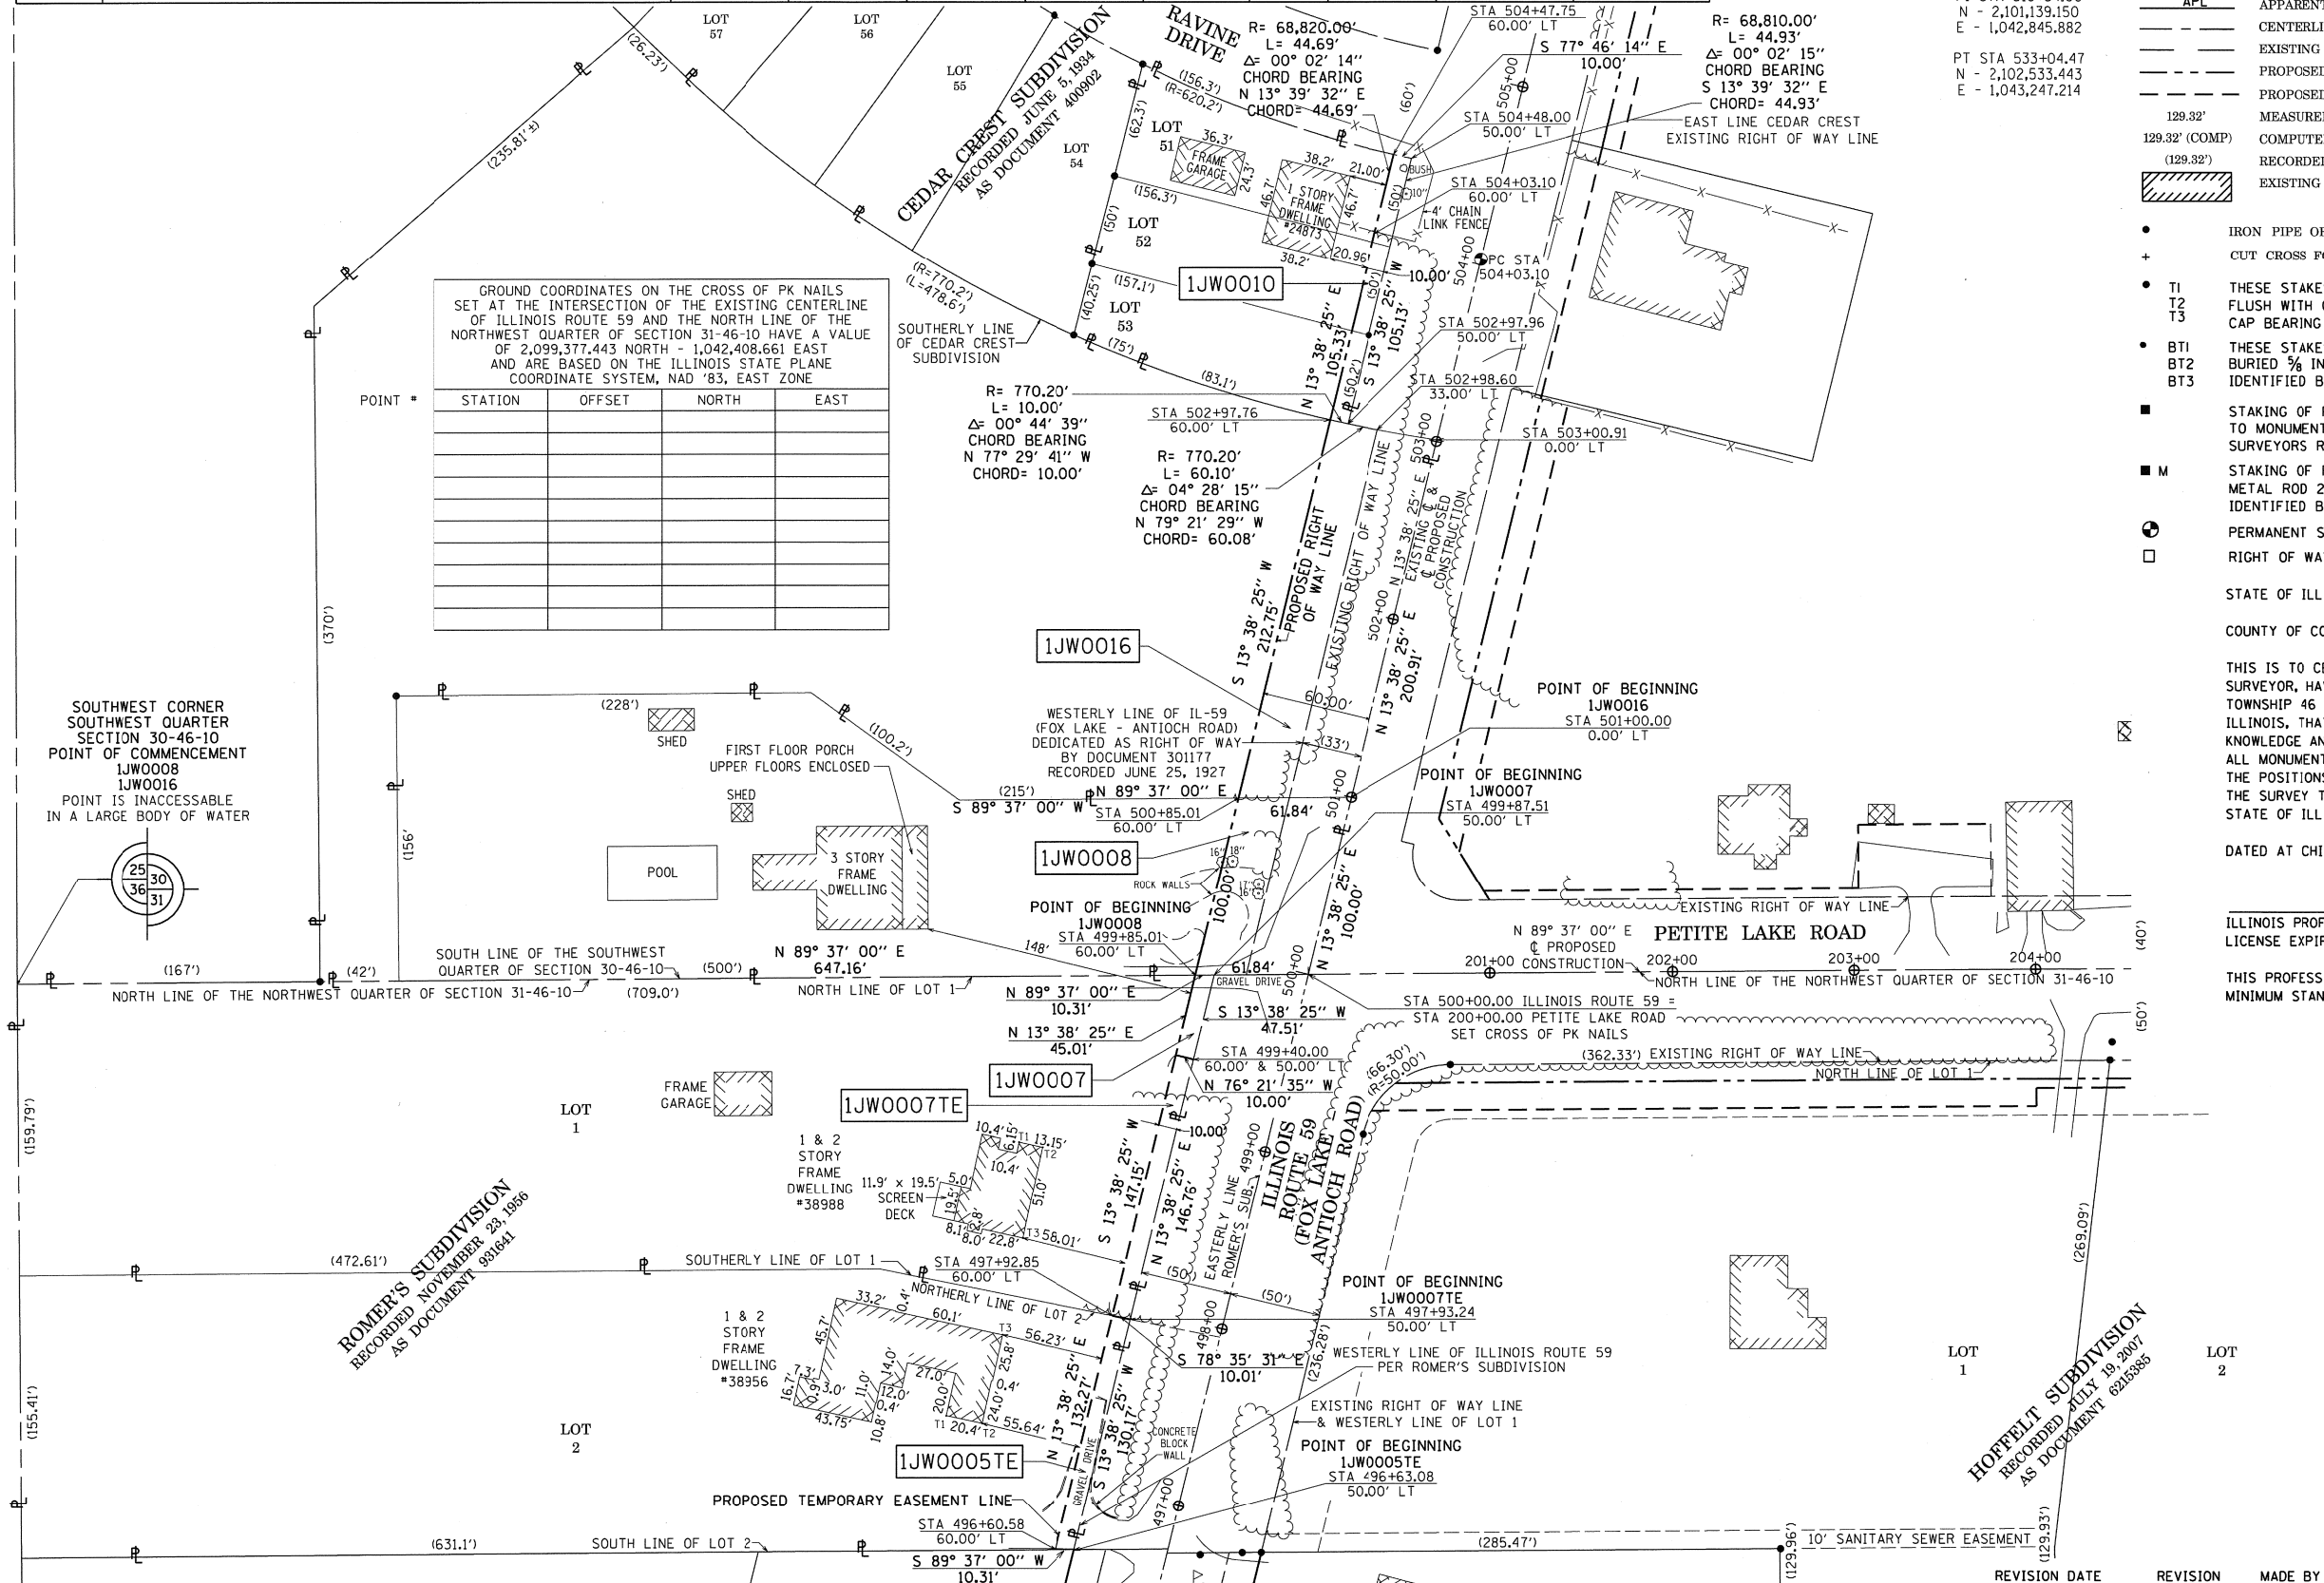

SOUTHWEST CORNER SOUTHWEST QUARTER SECTION 30-46-10 POINT OF COMMENCEMENT IJW0008 IJW0016 POINT IS INACCESSIBLE IN A LARGE BODY OF WATER



STATE OF ILLINOIS )  
 ) SS  
 COUNTY OF COOK )  
 THIS IS TO CERTIFY THAT I, WILLIAM J. FLEMING, AN ILLINOIS PROFESSIONAL LAND SURVEYOR, HAVE SURVEYED THE PLAT OF HIGHWAYS SHOWN HEREON IN SECTIONS 30 & 31, TOWNSHIP 46 NORTH, RANGE 10 EAST OF THE THIRD PRINCIPAL MERIDIAN, LAKE COUNTY, ILLINOIS, THAT THE SURVEY IS TRUE AND COMPLETE AS SHOWN TO THE BEST OF MY KNOWLEDGE AND BELIEF, THAT THE PLAT CORRECTLY REPRESENTS SAID SURVEY, THAT ALL MONUMENTS FOUND AND ESTABLISHED ARE OF PERMANENT QUALITY AND OCCUPY THE POSITIONS SHOWN THEREON AND THAT THE MONUMENTS ARE SUFFICIENT TO ENABLE THE SURVEY TO BE RETRACED, MADE FOR THE DEPARTMENT OF TRANSPORTATION, STATE OF ILLINOIS.  
 DATED AT CHICAGO, ILLINOIS THIS 21ST DAY OF MAY, A.D. 2013.  
 WILLIAM J. FLEMING  
 ILLINOIS PROFESSIONAL LAND SURVEYOR  
 LICENSE EXPIRATION DATE: 11/30/2012  
 THIS PROFESSIONAL SERVICE CONFORMS TO THE CURRENT ILLINOIS MINIMUM STANDARDS OF PRACTICE FOR A BOUNDARY SURVEY.

**Gräef**  
 8501 West Higgins Road  
 Suite 280  
 Chicago, IL 60631-2801  
 773 / 399 0112  
 www.graef-usa.com  
 Illinois Professional Design Corporation 184-000938

PLAT OF HIGHWAYS  
 STATE OF ILLINOIS  
 DEPARTMENT OF TRANSPORTATION  
 ILLINOIS ROUTE 59  
 SECTION: AT PETITE LAKE ROAD COUNTY: LAKE  
 PROJECT JOB NO.: R-91-025-12  
 STATION 497+00.00 TO STATION 505+00.00  
 SCALE: 1" = 50' SHEET 3 OF 6  
 BUREAU OF LAND ACQUISITION  
 201 WEST CENTER COURT MAY 21 2013  
 SCHAUMBURG, ILLINOIS 60196

PART OF THE SOUTHWEST QUARTER OF SECTION 30, TOWNSHIP 46 NORTH, RANGE 10 EAST OF THE THIRD PRINCIPAL MERIDIAN, LAKE COUNTY, ILLINOIS.

PARCEL NUMBER	OWNER	TOTAL HOLDINGS ACRES	PART TAKEN ACRES	AREA IN EXISTING R.O.W. ACRES	REMAINDER AREA ACRES	EASEMENT ACRES	AREA SQUARE FEET	EASEMENT PURPOSE	PERMANENT INDEX NUMBER	PROPERTY ACQUIRED BY
1JW009-A	EDWIN O. SULLIVAN, AS TRUSTEE OF THE EDWIN O. SULLIVAN DECLARATION OF TRUST DATED JANUARY 16, 1995	18.450	0.188	0.067	18.029				02-30-300-011	
1JW009-B			0.094							
1JW009-C			0.139	0.124						
1JW009PE						0.006	250	DRAINAGE		
1JW009TE-A						0.090	3941	GRADING		
1JW009TE-B					0.007	287	GRADING			
1JW009TE-C					0.085	3685	GRADING			
1JW009TE-D					0.037	1616	GRADING			
1JW001PE	COUNTY OF LAKE	0.546			0.546	0.055	2380	GRADING	02-30-300-015	
1JW001TE						0.004	183	GRADING		

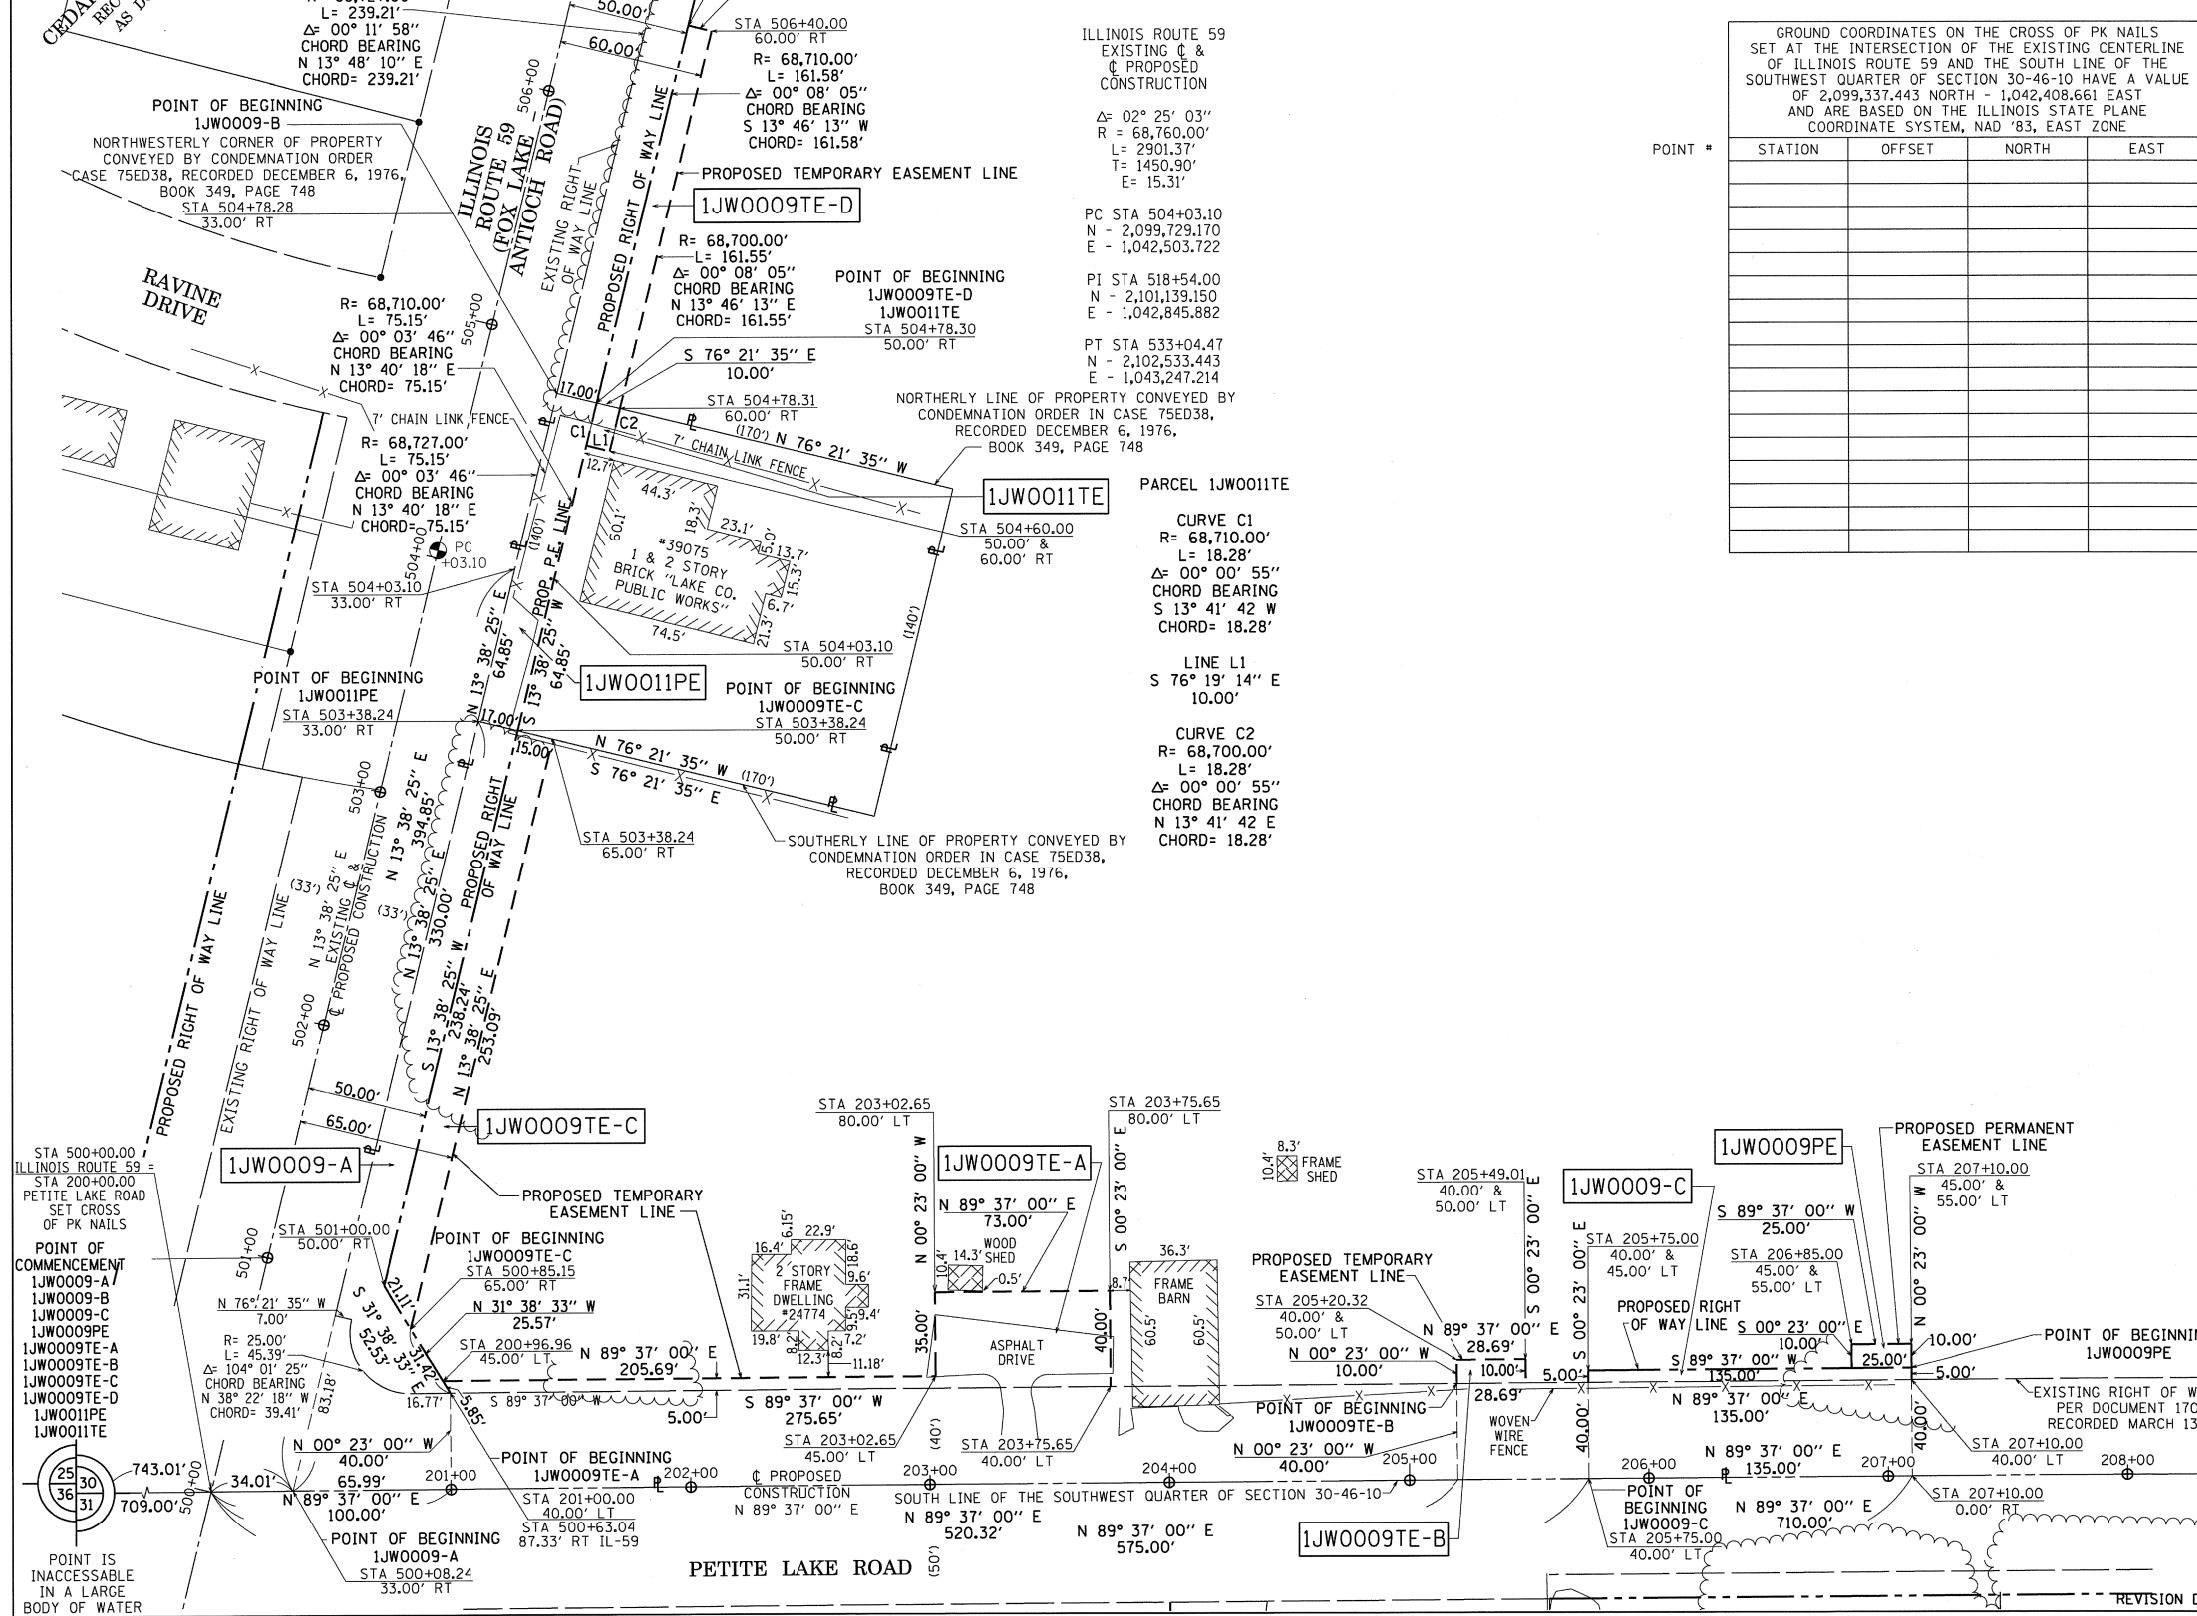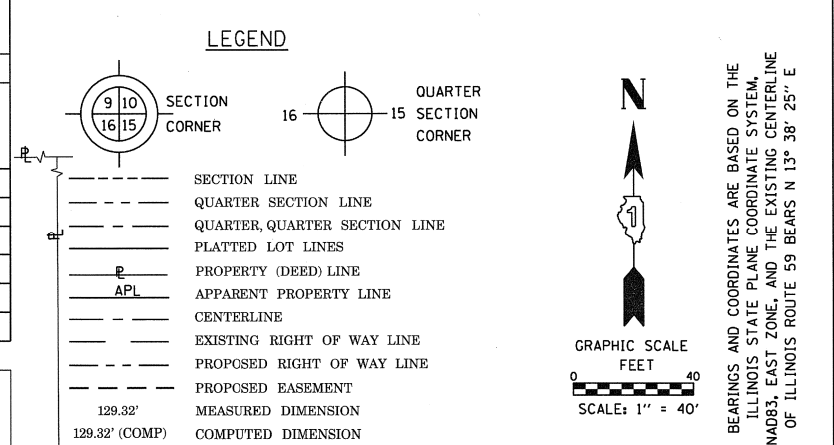

GROUND COORDINATES ON THE CROSS OF PK NAILS SET AT THE INTERSECTION OF THE EXISTING CENTERLINE OF ILLINOIS ROUTE 59 AND THE SOUTH LINE OF THE SOUTHWEST QUARTER OF SECTION 30-46-10 HAVE A VALUE OF 2,099,337.443 NORTH - 1,042,408.661 EAST AND ARE BASED ON THE ILLINOIS STATE PLANE COORDINATE SYSTEM, NAD '83, EAST ZONE

POINT #	STATION	OFFSET	NORTH	EAST

STATE OF ILLINOIS )  
COUNTY OF COOK )

THIS IS TO CERTIFY THAT I, WILLIAM J. FLEMING, AN ILLINOIS PROFESSIONAL LAND SURVEYOR, HAVE SURVEYED THE PLAT OF HIGHWAYS SHOWN HEREON IN SECTION 30, TOWNSHIP 46 NORTH, RANGE 10 EAST OF THE THIRD PRINCIPAL MERIDIAN, LAKE COUNTY, ILLINOIS, THAT THE SURVEY IS TRUE AND COMPLETE AS SHOWN TO THE BEST OF MY KNOWLEDGE AND BELIEF, THAT THE PLAT CORRECTLY REPRESENTS SAID SURVEY, THAT ALL MONUMENTS FOUND AND ESTABLISHED ARE OF PERMANENT QUALITY AND OCCUPY THE POSITIONS SHOWN THEREON AND THAT THE MONUMENTS ARE SUFFICIENT TO ENABLE THE SURVEY TO BE RETRACED, MADE FOR THE DEPARTMENT OF TRANSPORTATION, STATE OF ILLINOIS.

DATED AT CHICAGO, ILLINOIS THIS 21ST DAY OF MAY, A.D. 2013.

ILLINOIS PROFESSIONAL LAND SURVEYOR 35-3226  
LICENSE EXPIRATION DATE: 11/30/2014

THIS PROFESSIONAL SERVICE CONFORMS TO THE CURRENT ILLINOIS MINIMUM STANDARDS OF PRACTICE FOR A BOUNDARY SURVEY.



8501 West Higgins Road  
Suite 280  
Chicago, IL 60631-2801  
773 / 399 0112  
www.graef-usa.com  
Illinois Professional Design Corporation 184-000938

**PLAT OF HIGHWAYS**  
STATE OF ILLINOIS  
DEPARTMENT OF TRANSPORTATION  
ILLINOIS ROUTE 59


SECTION: AT PETITE LAKE COUNTY: LAKE  
PROJECT JOB NO.: R-91-025-12  
STATION 500+00.00 TO STATION 507+00.00  
SCALE: 1" = 40' SHEET 4 OF 6

BUREAU OF LAND ACQUISITION  
201 WEST CENTER COURT  
SCHAUMBURG, ILLINOIS 60196

PTB 161/017  
WORK ORDER 1  
GRAEF PROJECT  
20123007.01

MAY 21 2013  
PLATS & LEGALS

PART OF THE SOUTHWEST QUARTER OF SECTION 30, TOWNSHIP 46 NORTH, RANGE 10 EAST OF THE THIRD PRINCIPAL MERIDIAN, LAKE COUNTY, ILLINOIS.

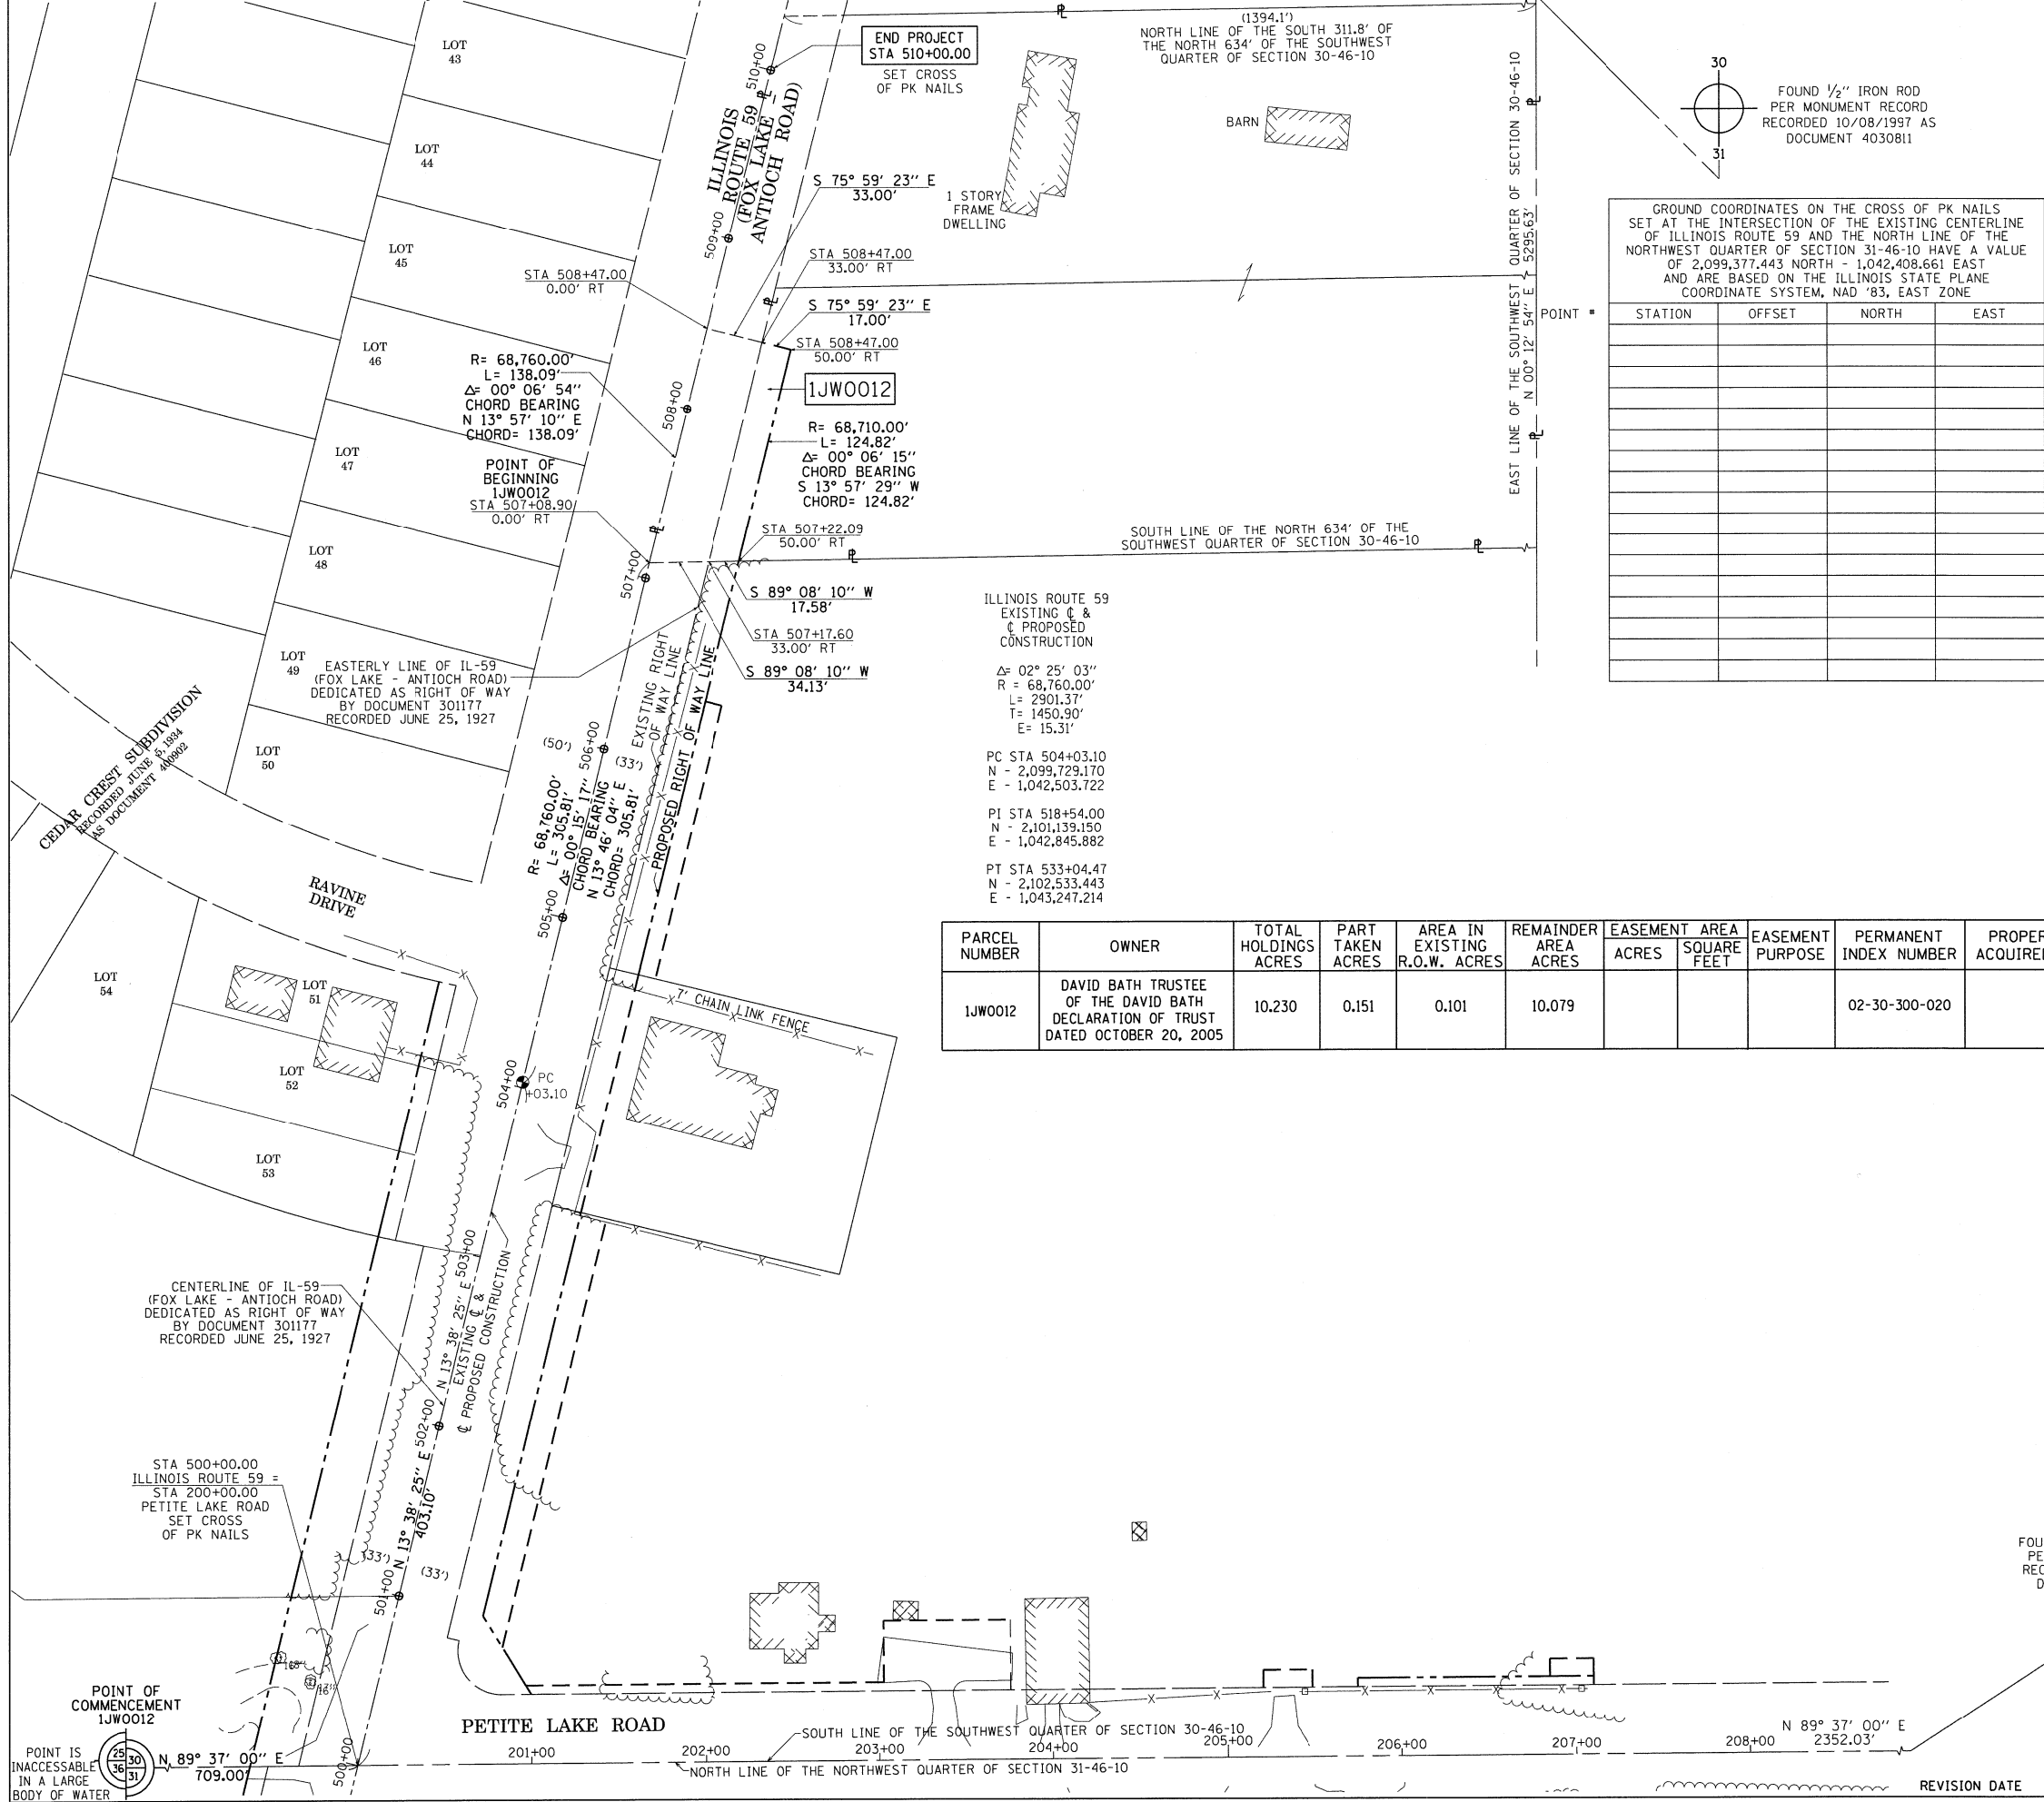

30  
31

FOUND 1/2" IRON ROD  
PER MONUMENT RECORD  
RECORDED 10/08/1997 AS  
DOCUMENT 4030811

### LEGEND

SECTION 30  
SECTION CORNER

SECTION 16  
SECTION CORNER

N

GRAPHIC SCALE  
FEET  
0 50  
SCALE: 1" = 50'

BEARINGS AND COORDINATES ARE BASED ON THE  
ILLINOIS STATE PLANE COORDINATE SYSTEM,  
NAD83, EAST ZONE, AND THE EXISTING CENTERLINE  
OF ILLINOIS ROUTE 59 BEARS N 13° 38' 25" E

SECTION LINE  
QUARTER SECTION LINE  
QUARTER, QUARTER SECTION LINE  
PLATTED LOT LINES  
PROPERTY (DEED) LINE  
APPARENT PROPERTY LINE  
CENTERLINE  
EXISTING RIGHT OF WAY LINE  
PROPOSED RIGHT OF WAY LINE  
PROPOSED EASEMENT  
MEASURED DIMENSION  
COMPUTED DIMENSION  
RECORDED DIMENSION  
EXISTING BUILDING

● IRON PIPE OR ROD FOUND     ⊕ PK OR "MAG" NAIL SET  
+ CUT CROSS FOUND OR SET     ○ 58" REBAR SET

• T1 THESE STAKES REFERENCE FOUND OR SET MONUMENTATION. SET 3/8" INCH IRON ROD FLUSH WITH GROUND TO TIE FOUND IRON STAKE IDENTIFIED BY COLORED PLASTIC CAP BEARING SURVEYORS REGISTRATION NUMBER.  
• T2  
• T3

• BT1 THESE STAKES, IN CULTIVATED AREAS, REFERENCE FOUND OR SET MONUMENTATION. BURIED 3/8" INCH IRON ROD 20 INCHES BELOW GROUND TO TIE FOUND IRON STAKE. IDENTIFIED BY COLORED PLASTIC CAP BEARING SURVEYORS REGISTRATION NUMBER.  
• BT2  
• BT3

■ STAKING OF PROPOSED RIGHT OF WAY. SET DIVISION OF HIGHWAYS SURVEY MARKER TO MONUMENT THE POSITION SHOWN. IDENTIFIED BY INSCRIPTION DATA AND SURVEYORS REGISTRATION NUMBER.

■ M STAKING OF PROPOSED RIGHT OF WAY IN CULTIVATED AREAS. BURIED 3/8" INCH METAL ROD 20 INCHES BELOW GROUND TO MARK FUTURE SURVEY MARKER POSITION IDENTIFIED BY COLORED PLASTIC CAP BEARING SURVEYORS REGISTRATION NUMBER.

⊗ PERMANENT SURVEY MARKER, I.D.O.T. STANDARD 2135 (TO BE SET BY OTHERS).

□ RIGHT OF WAY STAKING PROPOSED TO BE SET.

STATE OF ILLINOIS )  
                                   )SS  
COUNTY OF COOK     )

GROUND COORDINATES ON THE CROSS OF PK NAILS  
SET AT THE INTERSECTION OF THE EXISTING CENTERLINE  
OF ILLINOIS ROUTE 59 AND THE NORTH LINE OF THE  
NORTHWEST QUARTER OF SECTION 31-46-10 HAVE A VALUE  
OF 2,099,377,443 NORTH - 1,042,408,661 EAST  
AND ARE BASED ON THE ILLINOIS STATE PLANE  
COORDINATE SYSTEM, NAD '83, EAST ZONE

STATION	OFFSET	NORTH	EAST

ILLINOIS ROUTE 59  
EXISTING &  
PROPOSED  
CONSTRUCTION

Δ= 02° 25' 03"  
R = 68,760.00'  
L = 2901.37'  
T = 1450.90'  
E = 15.31'

PC STA 504+03.10  
N - 2,099,729.170  
E - 1,042,503.722

PI STA 518+54.00  
N - 2,101,139.150  
E - 1,042,845.882

PT STA 533+04.47  
N - 2,102,533.443  
E - 1,043,247.214

PARCEL NUMBER	OWNER	TOTAL HOLDINGS ACRES	PART TAKEN ACRES	AREA IN EXISTING R.O.W. ACRES	REMAINDER AREA ACRES	EASEMENT ACRES	EASEMENT AREA SQUARE FEET	EASEMENT PURPOSE	PERMANENT INDEX NUMBER	PROPERTY ACQUIRED BY
IJWT012	DAVID BATH TRUSTEE OF THE DAVID BATH DECLARATION OF TRUST DATED OCTOBER 20, 2005	10.230	0.151	0.101	10.079				02-30-300-020	

THIS IS TO CERTIFY THAT I, WILLIAM J. FLEMING, AN ILLINOIS PROFESSIONAL LAND SURVEYOR, HAVE SURVEYED THE PLAT OF HIGHWAYS SHOWN HEREON IN SECTION 30, TOWNSHIP 46 NORTH, RANGE 10 EAST OF THE THIRD PRINCIPAL MERIDIAN, LAKE COUNTY, ILLINOIS, THAT THE SURVEY IS TRUE AND COMPLETE AS SHOWN TO THE BEST OF MY KNOWLEDGE AND BELIEF, THAT THE PLAT CORRECTLY REPRESENTS SAID SURVEY, THAT ALL MONUMENTS FOUND AND ESTABLISHED ARE OF PERMANENT QUALITY AND OCCUPY THE POSITIONS SHOWN THEREON AND THAT THE MONUMENTS ARE SUFFICIENT TO ENABLE THE SURVEY TO BE RETRACED, MADE FOR THE DEPARTMENT OF TRANSPORTATION, STATE OF ILLINOIS.

DATED AT CHICAGO, ILLINOIS THIS 13TH DAY OF SEPTEMBER, A.D. 2012.


ILLINOIS PROFESSIONAL LAND SURVEYOR 35-3226  
LICENSE EXPIRATION DATE: 11/30/2012

THIS PROFESSIONAL SERVICE CONFORMS TO THE CURRENT ILLINOIS MINIMUM STANDARDS OF PRACTICE FOR A BOUNDARY SURVEY.



POINT IS INACCESSIBLE IN A LARGE BODY OF WATER

FOUND L.C.D.T. STEEL DISK PER MONUMENT RECORD RECORDED 5/16/2005 AS DOCUMENT 5782373

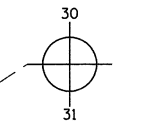

PLAT OF HIGHWAYS  
STATE OF ILLINOIS  
DEPARTMENT OF TRANSPORTATION  
ILLINOIS ROUTE 59

SECTION: AT PETITE LAKE ROAD COUNTY: LAKE  
PROJECT JOB NO.: R-91-025-12  
STATION 506+00.00 TO STATION 510+00.00  
SCALE: 1" = 50' SHEET 5 OF 6

BUREAU OF LAND ACQUISITION  
201 WEST CENTER COURT  
SCHAUMBURG, ILLINOIS 60196

REVISION DATE    REVISION    MADE BY

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Illinois Professional Design Corporation 184-000938

PTB 161/017  
WORK ORDER 1  
GRAEF PROJECT  
20123007.01

PART OF THE NORTHWEST QUARTER OF SECTION 31, TOWNSHIP 46 NORTH, RANGE 10 EAST OF THE THIRD PRINCIPAL MERIDIAN, LAKE COUNTY, ILLINOIS.

PARCEL NUMBER	OWNER	TOTAL HOLDINGS ACRES	PART TAKEN ACRES	AREA IN EXISTING R.O.W. ACRES	REMAINDER AREA ACRES	EASEMENT AREA SQUARE FEET	EASEMENT PURPOSE	PERMANENT INDEX NUMBER	PROPERTY ACQUIRED BY
1JW0006 1JW0006TE	JOSEPH E. HOFFELT AND PEGGY A. HOFFELT, HIS WIFE, AS JOINT TENANTS	3.010	0.088		2.922	0.128	5586	GRADING	02-31-107-001
1JW0013 1JW0013TE	GREGORY BOCKWINKEL	2.021	0.086		1.935	0.007	314	GRADING	02-31-100-035
1JW0014 1JW0014TE	WILLIAM C. REISS AND ANDREA REISS, AS TENANTS BY THE ENTIRETY	2.086	0.055		2.031	0.023	1000	GRADING	02-31-100-042
1JW0015 1JW0015TE	JOSEPH E. HOFFELT AND PEGGY A. HOFFELT, HIS WIFE, AS JOINT TENANTS	1.277	0.027		1.250	0.014	597	GRADING	02-31-107-002

GROUND COORDINATES ON THE CROSS OF PK NAILS SET AT THE INTERSECTION OF THE EXISTING CENTERLINE OF ILLINOIS ROUTE 59 AND THE NORTH LINE OF THE NORTHWEST QUARTER OF SECTION 31-46-10 HAVE A VALUE OF 2,099,377.443 NORTH - 1,042,408.661 EAST AND ARE BASED ON THE ILLINOIS STATE PLANE COORDINATE SYSTEM, NAD '83, EAST ZONE


POINT #	STATION	OFFSET	NORTH	EAST

**LEGEND**

- SECTION CORNER (9 10 / 16 15)
- QUARTER CORNER (16 / 15)
- SECTION LINE
- QUARTER SECTION LINE
- QUARTER, QUARTER SECTION LINE
- PLATTED LOT LINES
- PROPERTY (DEED) LINE
- APPARENT PROPERTY LINE
- CENTERLINE
- EXISTING RIGHT OF WAY LINE
- PROPOSED RIGHT OF WAY LINE
- PROPOSED EASEMENT
- MEASURED DIMENSION (129.32')
- COMPUTED DIMENSION (129.32')
- RECORDED DIMENSION (129.32')
- EXISTING BUILDING
- IRON PIPE OR ROD FOUND
- CUT CROSS FOUND OR SET
- PK OR "MAG" NAIL SET
- 5/8" REBAR SET
- T1, T2, T3: THESE STAKES REFERENCE FOUND OR SET MONUMENTATION. SET 3/8 INCH IRON ROD FLUSH WITH GROUND TO THE FOUND IRON STAKE IDENTIFIED BY COLORED PLASTIC CAP BEARING SURVEYORS REGISTRATION NUMBER.
- BT1, BT2, BT3: THESE STAKES, IN CULTIVATED AREAS, REFERENCE FOUND OR SET MONUMENTATION. BURIED 3/8 INCH IRON ROD 20 INCHES BELOW GROUND TO THE FOUND IRON STAKE. IDENTIFIED BY COLORED PLASTIC CAP BEARING SURVEYORS REGISTRATION NUMBER.
- STAKING OF PROPOSED RIGHT OF WAY. SET DIVISION OF HIGHWAYS SURVEY MARKER TO MONUMENT THE POSITION SHOWN. IDENTIFIED BY INSCRIPTION DATA AND SURVEYORS REGISTRATION NUMBER.
- STAKING OF PROPOSED RIGHT OF WAY IN CULTIVATED AREAS. BURIED 3/8 INCH METAL ROD 20 INCHES BELOW GROUND TO MARK FUTURE SURVEY MARKER POSITION IDENTIFIED BY COLORED PLASTIC CAP BEARING SURVEYORS REGISTRATION NUMBER.
- PERMANENT SURVEY MARKER, I.D.O.T. STANDARD 2135 (TO BE SET BY OTHERS).
- RIGHT OF WAY STAKING PROPOSED TO BE SET.

GRAPHIC SCALE FEET  
SCALE: 1" = 50'

BEARINGS AND COORDINATES ARE BASED ON THE ILLINOIS STATE PLANE COORDINATE SYSTEM, NAD83, EAST ZONE, AND THE EXISTING CENTERLINE OF ILLINOIS ROUTE 59 BEARS N 13° 38' 25" E

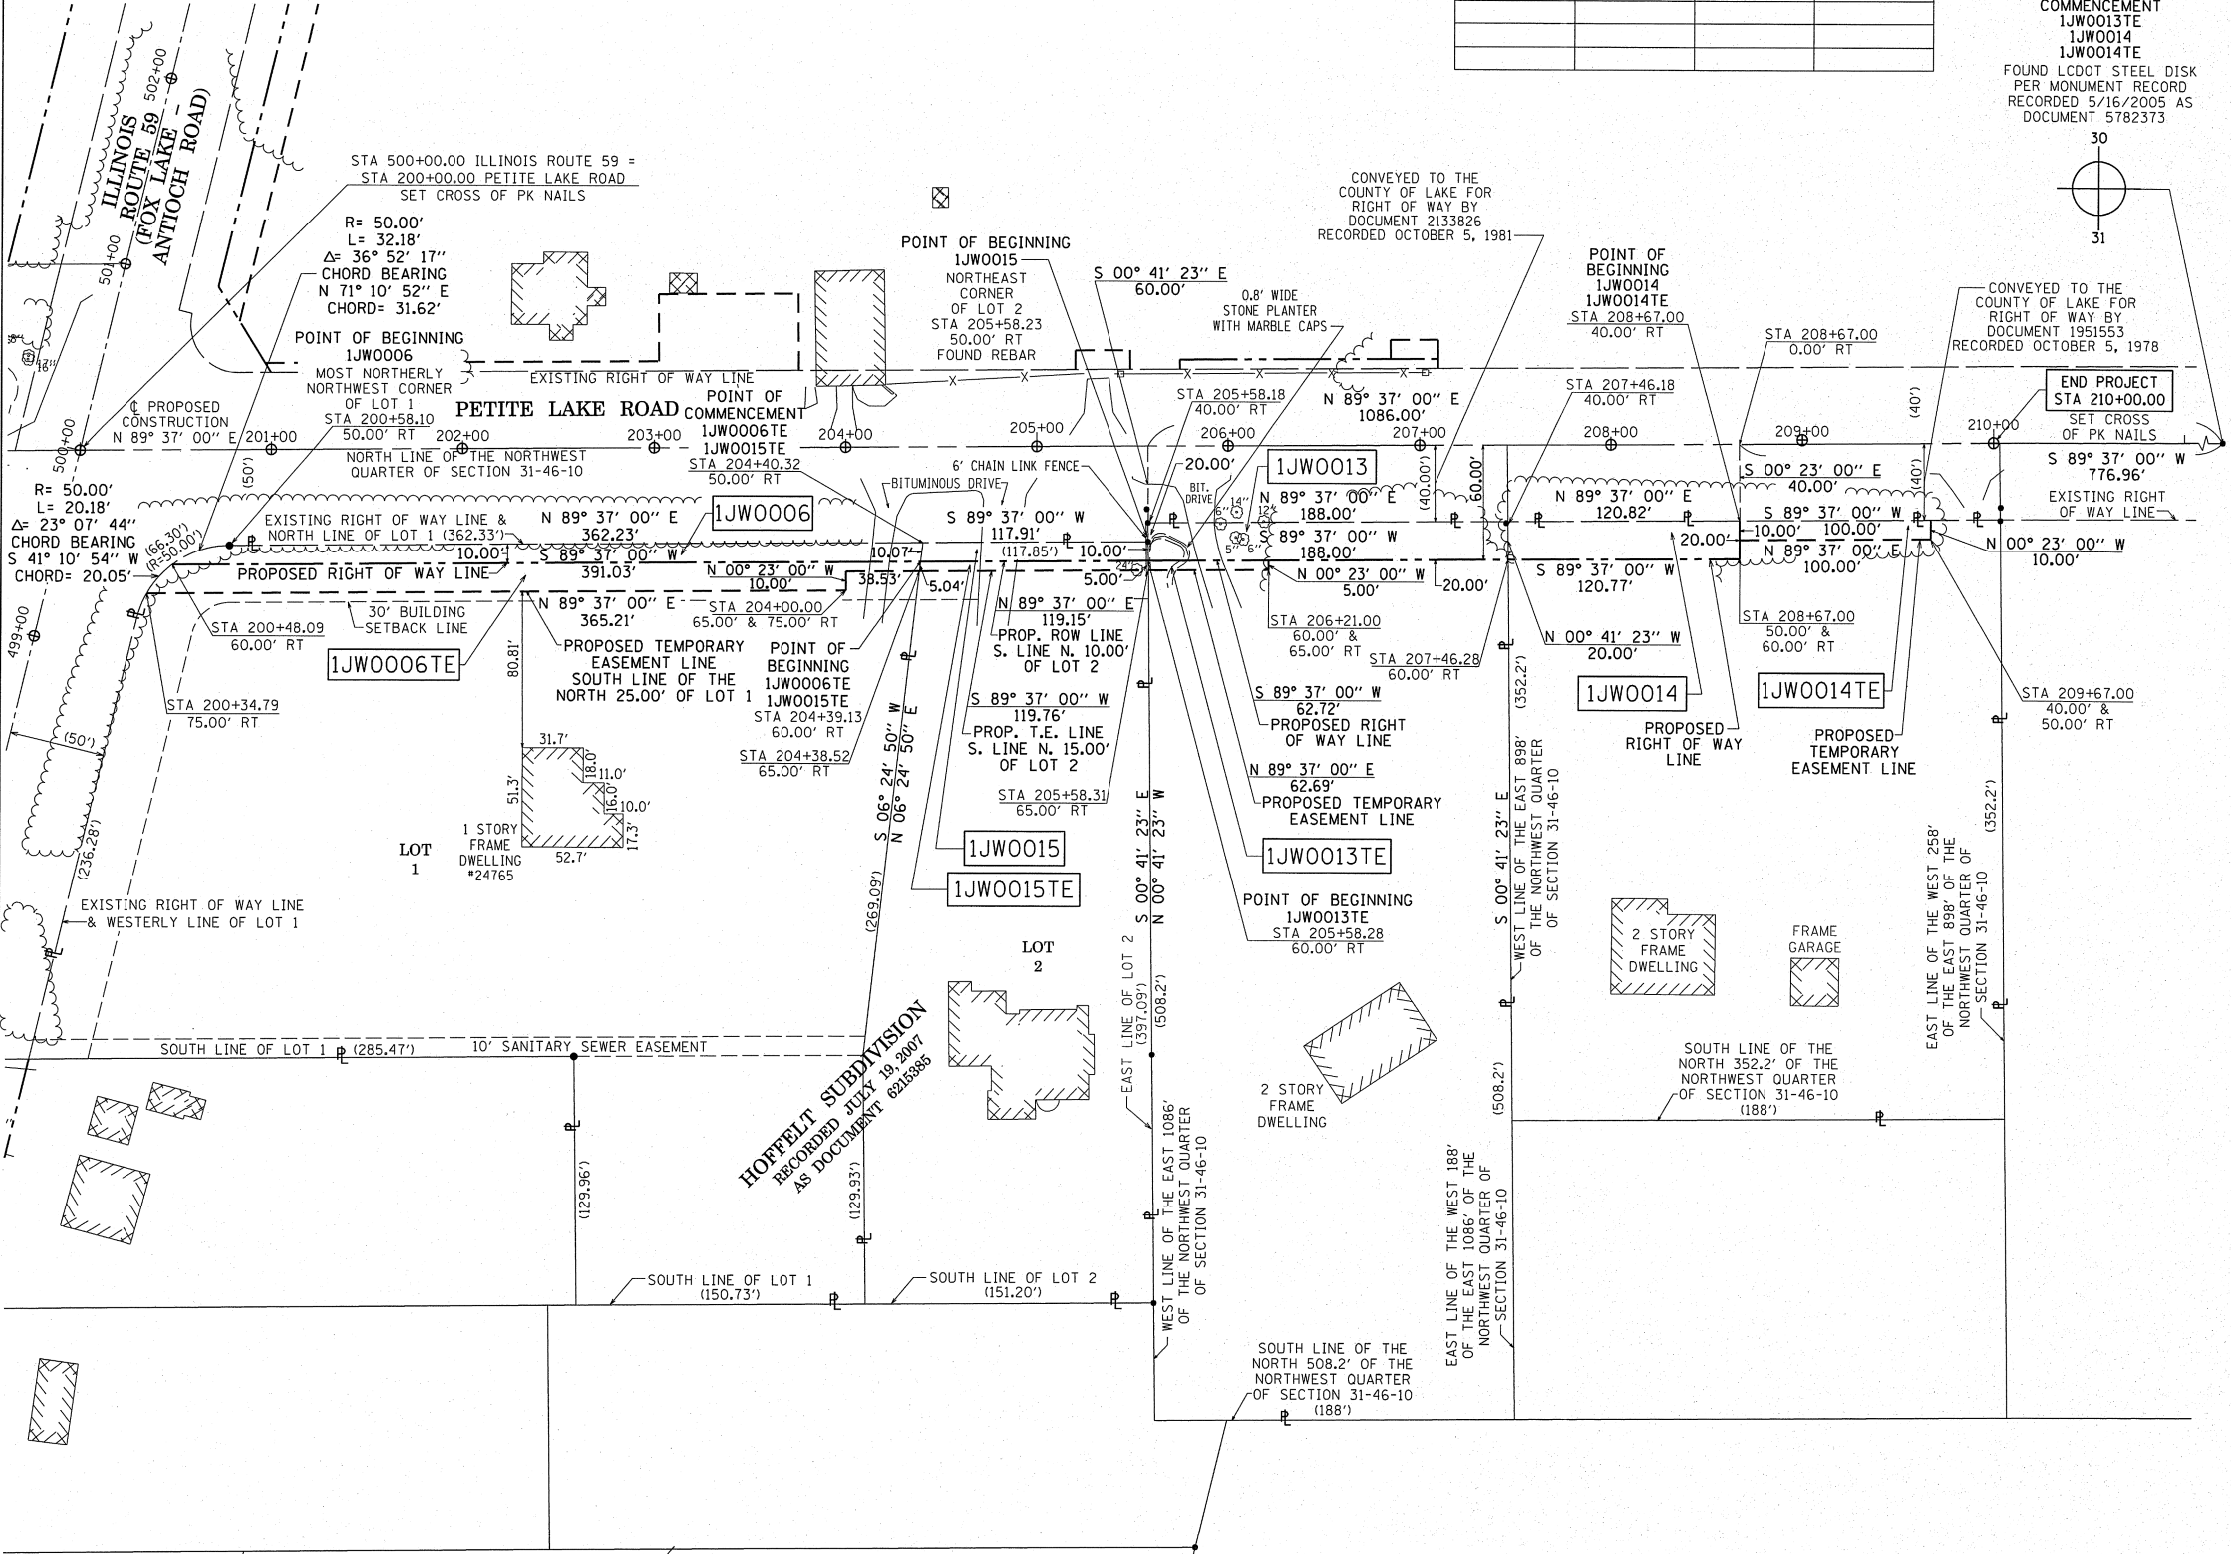

STATE OF ILLINOIS )  
  )SS  
COUNTY OF COOK      )

THIS IS TO CERTIFY THAT I, WILLIAM J. FLEMING, AN ILLINOIS PROFESSIONAL LAND SURVEYOR, HAVE SURVEYED THE PLAT OF HIGHWAYS SHOWN HEREON IN SECTION 31, TOWNSHIP 46 NORTH, RANGE 10 EAST OF THE THIRD PRINCIPAL MERIDIAN, LAKE COUNTY, ILLINOIS, THAT THE SURVEY IS TRUE AND COMPLETE AS SHOWN TO THE BEST OF MY KNOWLEDGE AND BELIEF, THAT THE PLAT CORRECTLY REPRESENTS SAID SURVEY, THAT ALL MONUMENTS FOUND AND ESTABLISHED ARE OF PERMANENT QUALITY AND OCCUPY THE POSITIONS SHOWN THEREON AND THAT THE MONUMENTS ARE SUFFICIENT TO ENABLE THE SURVEY TO BE RETRACED, MADE FOR THE DEPARTMENT OF TRANSPORTATION, STATE OF ILLINOIS.

DATED AT CHICAGO, ILLINOIS THIS 7TH DAY OF NOVEMBER, A.D. 2013.

ILLINOIS PROFESSIONAL LAND SURVEYOR 35-3226  
LICENSE EXPIRATION DATE: 11/30/2014

THIS PROFESSIONAL SERVICE CONFORMS TO THE CURRENT ILLINOIS MINIMUM STANDARDS OF PRACTICE FOR A BOUNDARY SURVEY.



**Gräef** RECEIVED  
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Illinois Professional Design Corporation 184-000938

PTB 161/017  
WORK ORDER 1  
GRAEF PROJECT  
20123007.01

PLAT OF HIGHWAYS  
STATE OF ILLINOIS  
DEPARTMENT OF TRANSPORTATION  
ILLINOIS ROUTE 59

SECTION: AT PETITE LAKE ROAD COUNTY: LAKE  
PROJECT JOB NO.: R-91-025-12  
STATION 200+00.00 TO STATION 210+00.00  
SCALE: 1" = 50' SHEET 6 OF 6

BUREAU OF LAND ACQUISITION  
201 WEST CENTER COURT  
SCHAUMBURG, ILLINOIS 60196





*K. Slaninka*  
signature

10/29/13  
date

license expires 11-30-15

-----A-----A-----A	AERIAL
-----U-----U-----U	UNKNOWN
-----O-----O-----O	OIL
-----CTV-----CTV-----CTV	CABLE TV
-----T-----T-----T	TELEPHONE
-----G-----G-----G	GAS
-----E-----E-----E	ELECTRIC
-----W-----W-----W	WATER
-----FM-----FM-----FM	FORCE MAIN
-----FO-----FO-----FO	FIBER OPTIC
-----S-----S-----S	END OF INFORMATION
-----TBE-----TBE-----TBE	TBE TEST HOLE

UTILITY OWNERS	
AT&T = TELEPHONE	
COM-ED = ELECTRIC	
LAKE COUNTY PUBLIC WORKS = FORCE MAIN	
NICOR = GAS	

Utilities shown on these plans as depicted in the legend have been investigated by Cardno TBE in accordance with SUE Industry Standards. All other information shown has been provided to Cardno TBE by others. Cardno TBE's QL "B" SUE field investigation was performed 10/4/13 through 10/21/13. Changes to utilities after 10/21/13 may have been made and therefore may result in variances from this plan. Consideration should be given to updating this plan if deemed advisable prior to final design and construction.

ALL UTILITIES SHOWN QUALITY LEVEL "B" UNLESS NOTED OTHERWISE.




Utility Quality Level "A" : Visually Verified Test Hole
Utility Quality Level "B" : Designating/non Visually Verified Test Hole
Utility Quality Level "C" : Research with Survey
Utility Quality Level "D" : Records Research

DESIGNED ER	REVISED
DRAWN SRK	REVISED
CHECKED KFS	REVISED
DATE 10/28/13	REVISED

STATE OF ILLINOIS  
DEPARTMENT OF TRANSPORTATION

IL 59 at Petite Lake Road  
Lake Villa, Illinois

TBE Job No. IL09510536 SUE Plan Page: Cover				
F.A. RTE.	SECTION	COUNTY	TOTAL SHEETS	SHEET NO.
	105-N-4	Lake	113	25
Contract No. 60W06				
FED. ROAD DIST. NO. - ILLINOIS 1001 Project No.				

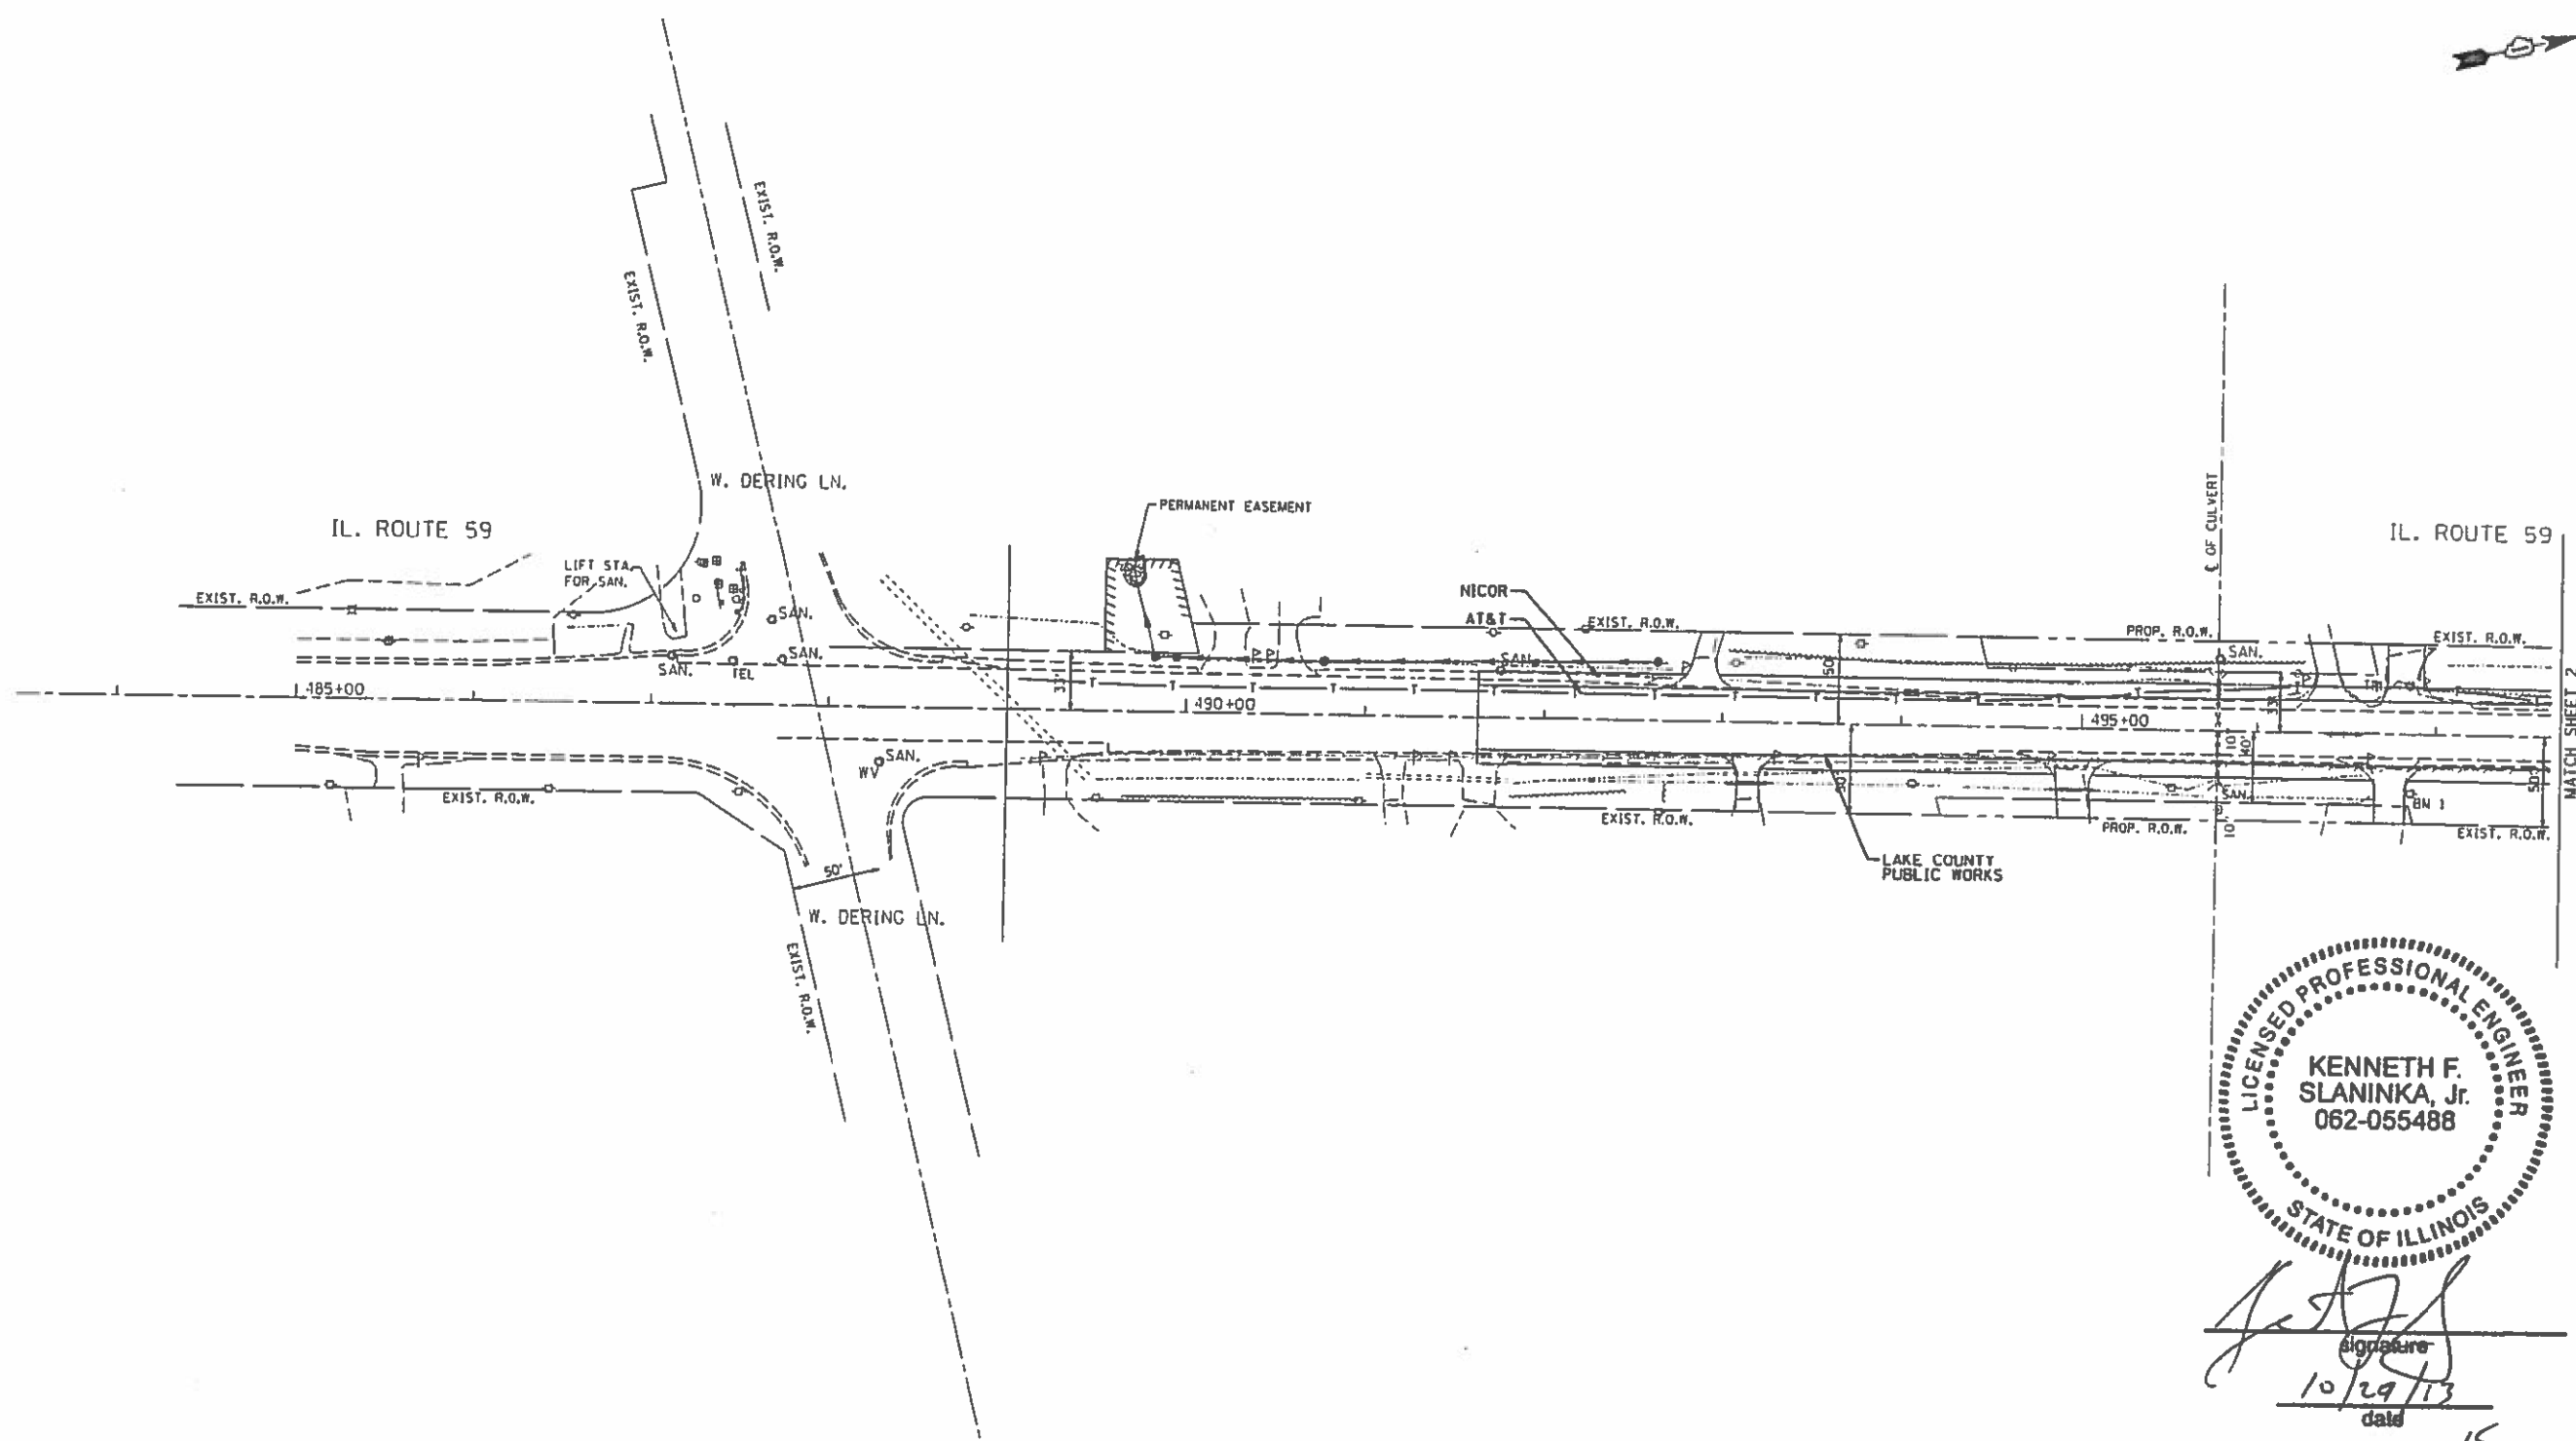


*KFS*  
 Signature  
 10/29/13  
 date  
 license expires 11-30-15

— A — A —	AERIAL UNKNOWN
— O — O —	OIL
— CTV — CTV —	CABLE TV
— T — T —	TELEPHONE
— E — E —	GAS
— W — W —	ELECTRIC
— FM — FM —	WATER
— FO — FO —	FORCE MAIN
	FIBER OPTIC
⊥	END OF INFORMATION
⊙	TBE TEST HOLE

UTILITY OWNERS	
AT&T = TELEPHONE	
COM-ED = ELECTRIC	
LAKE COUNTY PUBLIC WORKS = FORCE MAIN	
NICOR = GAS	

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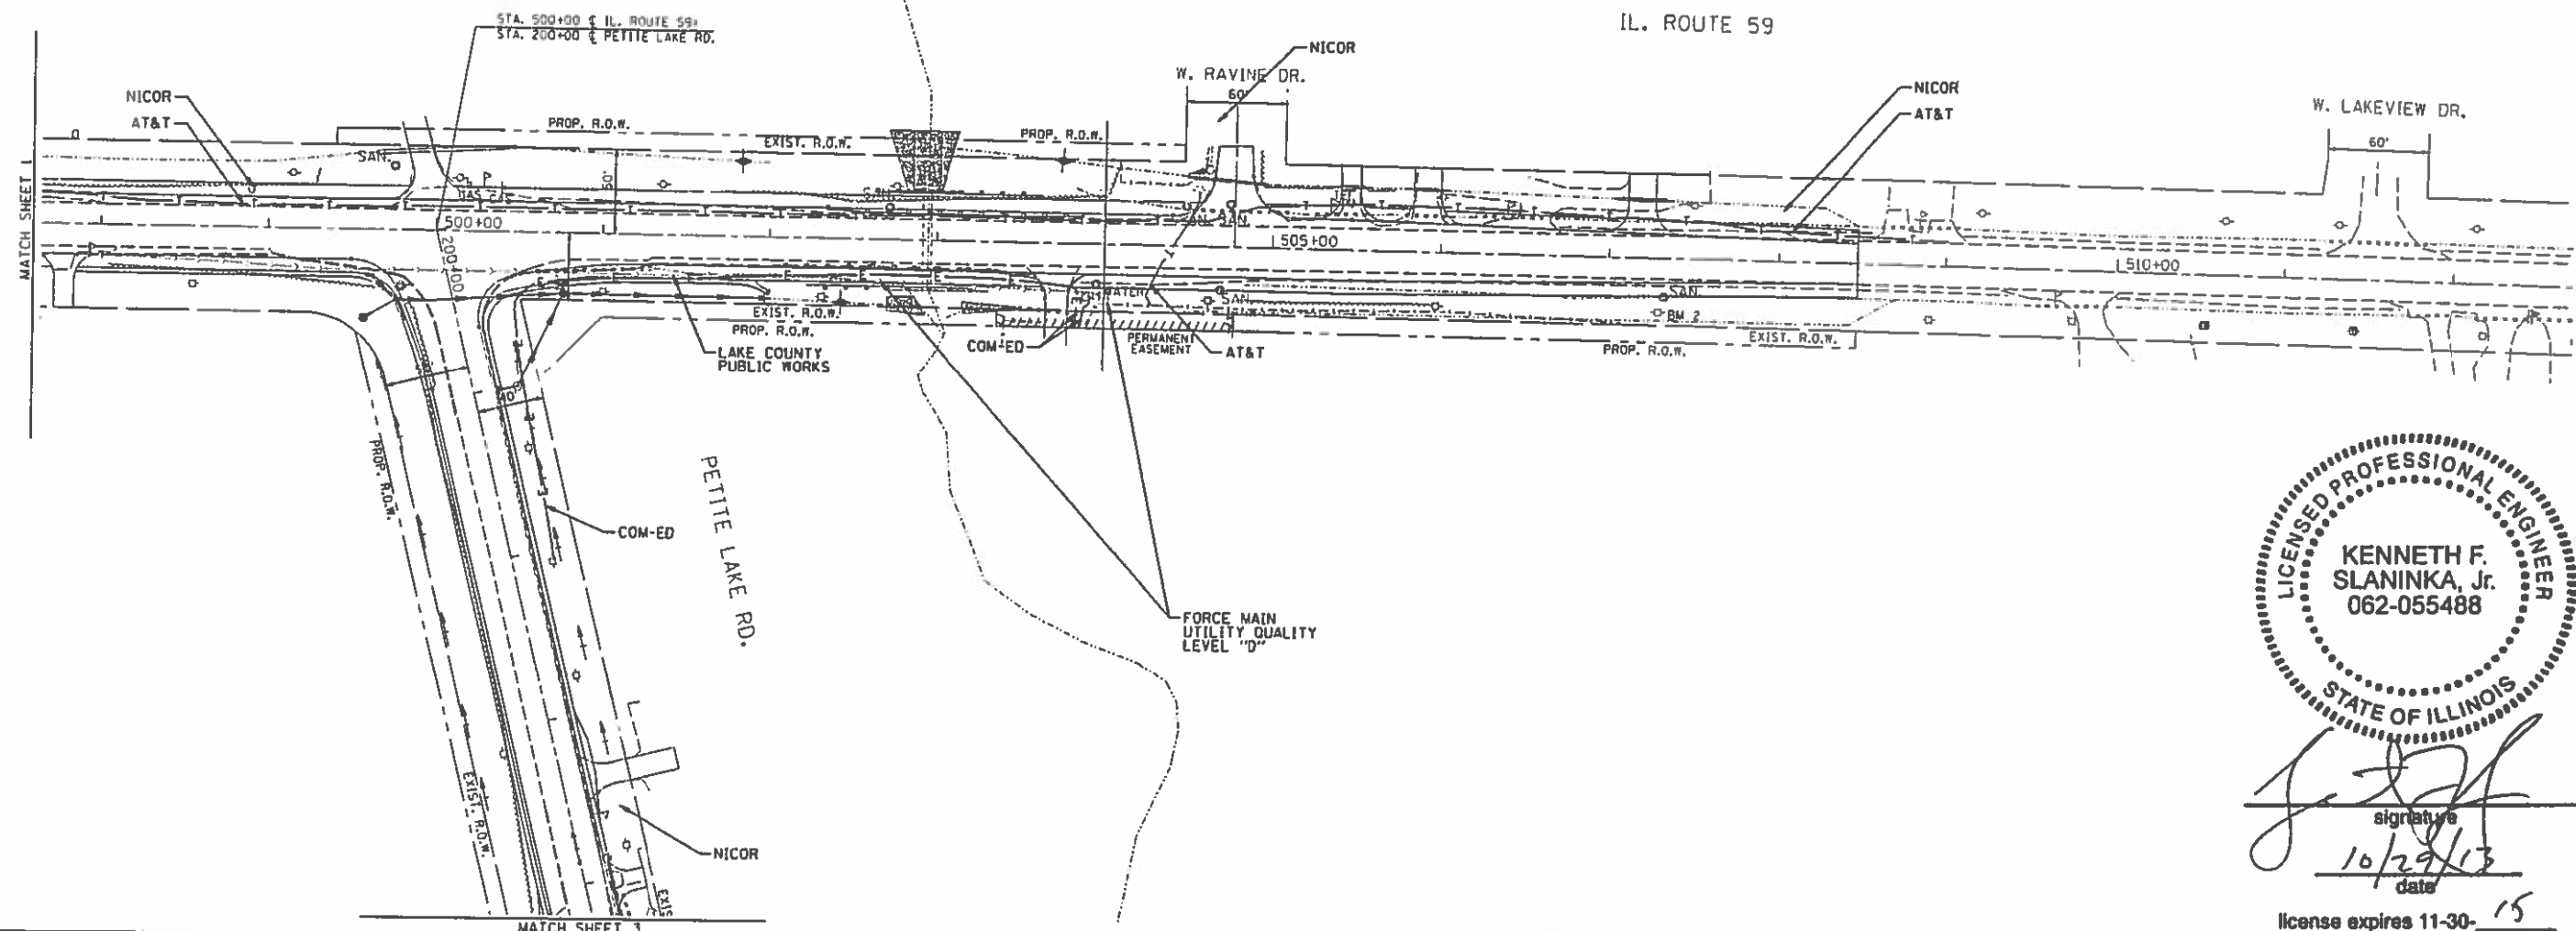
Utility Quality Level "A" : Visually Verified Test Hole  
 Utility Quality Level "B" : Designating/non Visually Verified Test Hole  
 Utility Quality Level "C" : Research with Survey  
 Utility Quality Level "D" : Records Research

DESIGNED	ER	REVISED
DRAWN	SRK	REVISED
CHECKED	KFS	REVISED
DATE	10/28/13	REVISED

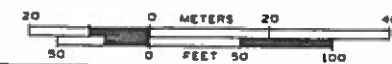STATE OF ILLINOIS  
 DEPARTMENT OF TRANSPORTATION

IL 59 at Petite Lake Road  
 Lake Villa, Illinois

TBE Job No. IL09510536		SUE Plan Page: 1 of 3	
F.A. RTE.	SECTION	COUNTY	TOTAL SHEETS
	105-N-4	Lake	113
			26
Contract No. 60W06			
FED. ROAD DIST. NO. - [ILLINOIS] IDOT Project No.			



*[Signature]*  
 signature  
 10/29/13  
 date  
 license expires 11-30-15

— A — A —	AERIAL UNKNOWN
— O — O —	OIL
— CTV — CTV —	CABLE TV
— T — T —	TELEPHONE
— E — E —	GAS
— W — W —	ELECTRIC
— FM — FM —	WATER
— FO — FO —	FORCE MAIN
— FO — FO —	FIBER OPTIC
— S —	END OF INFORMATION
— T —	TBE TEST HOLE

UTILITY OWNERS	
AT&T = TELEPHONE	
COM-ED = ELECTRIC	
LAKE COUNTY PUBLIC WORKS = FORCE MAIN	
NICOR = GAS	

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 Utility Quality Level "B": Designating/non Visually Verified Test Hole  
 Utility Quality Level "C": Research with Survey  
 Utility Quality Level "D": Records Research


DESIGNED ER	REVISED
DRAWN SRK	REVISED
CHECKED KFS	REVISED
DATE 10/28/13	REVISED


STATE OF ILLINOIS  
 DEPARTMENT OF TRANSPORTATION



IL 59 at Petite Lake Road  
 Lake Villa, Illinois

TBE Job No. IL09510536 SUE Plan Pages 2 of 3				
F.A. RTE.	SECTION	COUNTY	TOTAL SHEETS	SHEET NO.
	105-N-4	LAKE	113	27
FED. ROAD DIST. NO. - ILLINOIS		IDOT Project No.		

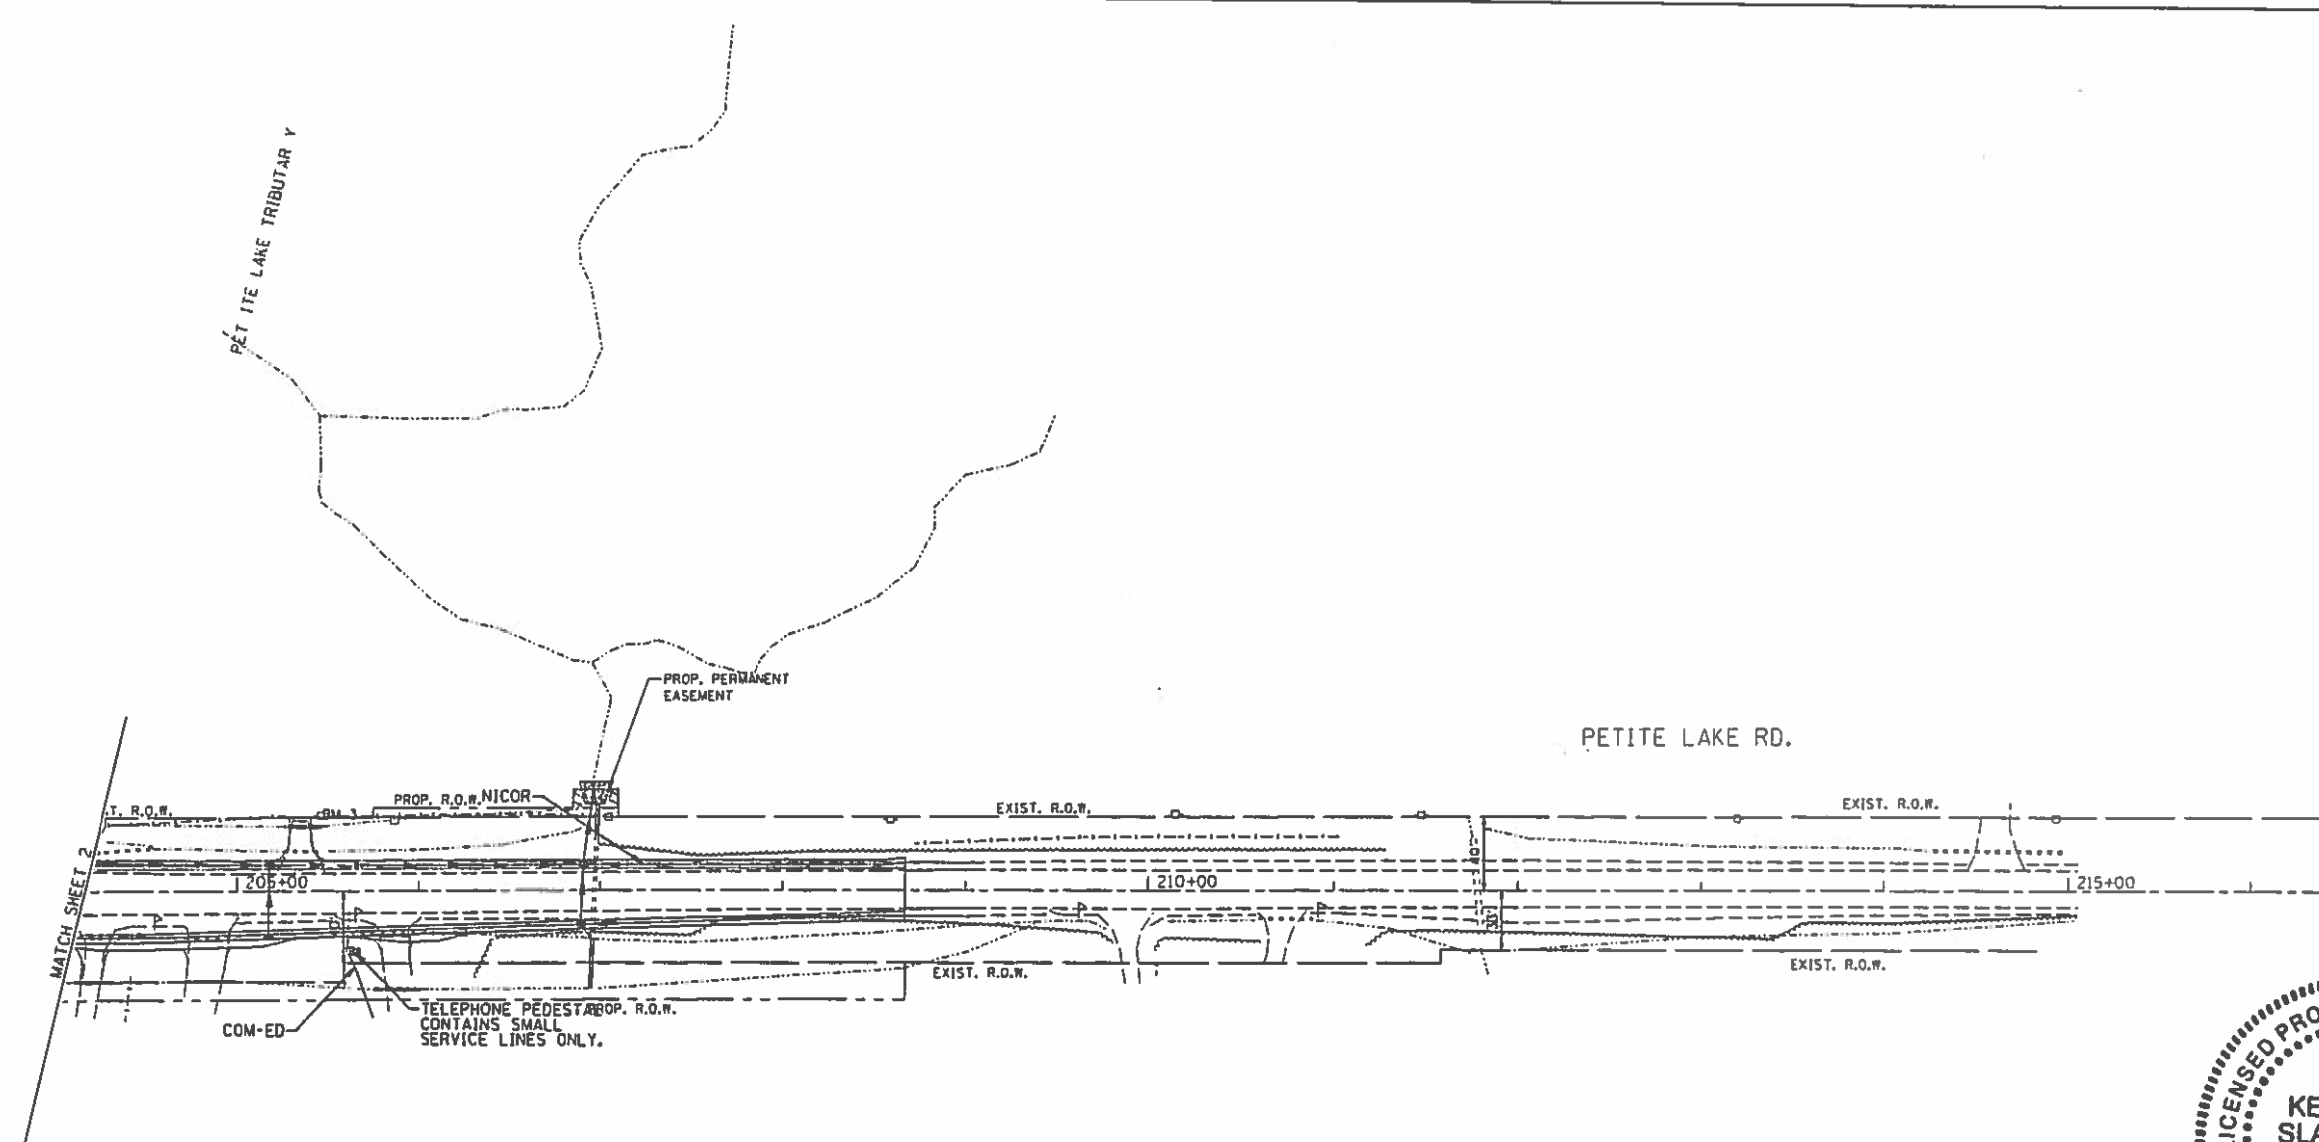

  
 signature  
 10/29/13  
 date  
 license expires 11-30-15

—A—A—	AERIAL UNKNOWN
—O—O—	OIL
—CTV—CTV—	CABLE TV
—T—T—	TELEPHONE
—E—E—	ELECTRIC
—W—W—	WATER
—FM—FM—	FORCE MAIN
—FO—FO—	FIBER OPTIC
⊕	END OF INFORMATION
⊕	TBE TEST HOLE

UTILITY OWNERS	
AT&T	= TELEPHONE
COM-ED	= ELECTRIC
LAKE COUNTY PUBLIC WORKS	= FORCE MAIN
NICOR	= GAS

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 Utility Quality Level "D" : Records Research


DESIGNED	ER	REVISED
DRAWN	SRK	REVISED
CHECKED	KFS	REVISED
DATE	10/28/13	REVISED

STATE OF ILLINOIS  
 DEPARTMENT OF TRANSPORTATION

IL 59 at Petite Lake Road  
 Lake Villa, Illinois

F.A. RTE.	SECTION	COUNTY	TOTAL SHEETS	SHEET NO.
	105-N-4	Lake	113	28
Contract No. 60W06				
FED. ROAD DIST. NO. ILLINOIS 100T Project No.				

TBE Job No. IL09510536  
 SUE Plan Pages 3 of 3

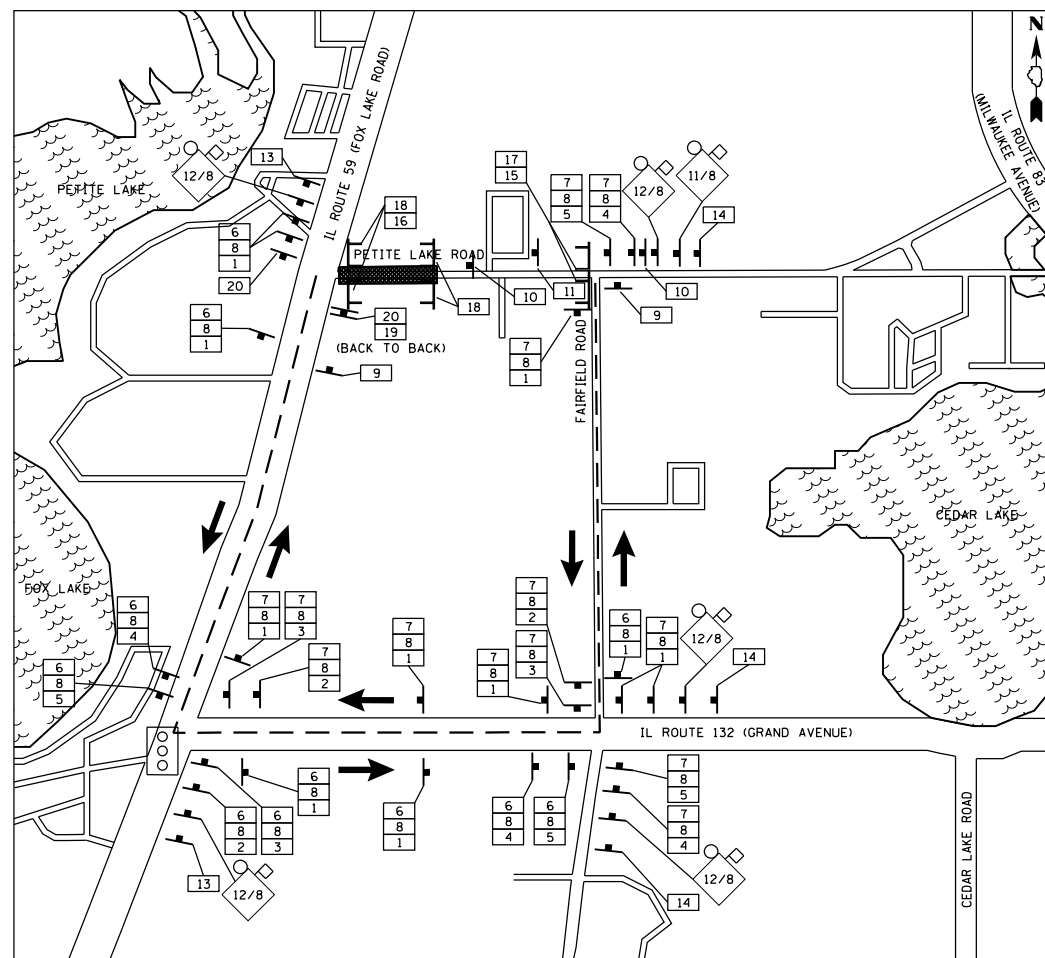

SIGN DESCRIPTION AND QUANTITIES ARE SHOWN ON SHEET #DT3

**SPECIAL DETOUR NOTES:**

1. THE CONTRACTOR SHALL PAY PARTICULAR ATTENTION TO THE DETOUR GENERAL NOTES. SEE SHEET 31 FOR THE DETOUR GENERAL NOTES.
2. SEE SHEET 32 FOR INFORMATION ON THE DESIGN AND LOCATION OF THE DETOUR INFORMATION SIGNS.
3. A MINIMUM OF FOUR (4) TYPE III BARRICADES WILL BE NEEDED FOR THIS DETOUR AND ROAD CLOSURE. SEE DETOUR GENERAL NOTE 9.
4. PRIOR TO AND AT THE CONCLUSION OF THE DETOUR PLAN, THE TRAFFIC CONTROL PLAN SHOWN ON SHEETS 40 TO 41 SHALL BE IN EFFECT.


THE DETOUR SHALL NOT START PRIOR TO JUNE 15, 2017 AND SHALL BE REMOVED PRIOR TO AUGUST 15, 2017. THE DURATION OF THE DETOUR SHALL NOT EXCEED 50 CALENDAR DAYS.

THE LIQUIDATED DAMAGES FOR EXCEEDING THE DURATION SHALL BE \$2,500.00 PER CALENDAR DAY.


**LEGEND**

- 48" X 48" CONSTRUCTION WARNING SIGN WITH AMBER FLASHING LIGHT (NUMBER DENOTES TYPE)
- M4-9 SERIES DETOUR SIGN WITH ROAD NAME & DIRECTION PLATES (NUMBER DENOTES TYPE)
- OTHER DETOUR SIGN (NUMBER DENOTES TYPE)
- CONSTRUCTION WORK ZONE
- DETOUR ROUTE DIRECTION
- SIGN POST
- SIGNALIZED INTERSECTION
- TYPE III BARRICADE
- DETOUR ROUTE


**TYPICAL INTERSECTION ALONG DETOUR ROUTE**

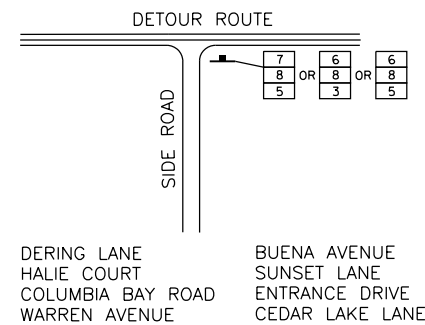

**TYPICAL SIGN ASSEMBLY**

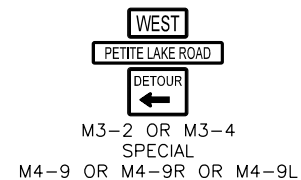

**TYPICAL INTERSECTION AT POINT OF DETOUR**

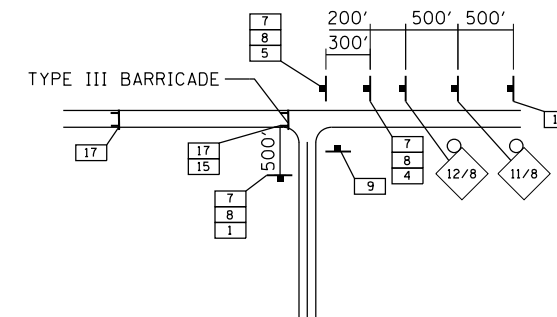


FILE NAME =	USER NAME = ledezmar	DESIGNED -	REVISED -	<b>STATE OF ILLINOIS DEPARTMENT OF TRANSPORTATION</b>	<b>DETOUR PLAN IL. ROUTE 59 AT PETITE LAKE RD</b>			F.A.P. RTE.	SECTION	COUNTY	TOTAL SHEETS	SHEET NO.
pw\ill084EBIDINTEG\illinois.gov\PI\DOT\Documents\IDOT Offices\District 1\Projects\P14540\DRAWING\Design\P145409-shr-cover.dgn	PLOT SCALE = 100.0000' / in.	CHECKED -	REVISED -					104	105N-4	LAKE	113	29
Default	PLOT DATE = 9/13/2016	DATE -	REVISED -		SCALE: 1"=50'			SHEET OF SHEETS STA. TO STA.			CONTRACT NO. 60W06	
ILLINOIS FED. AID PROJECT												

NUMBER OF SIGNS 7



DATES SHOWN ARE FOR EXAMPLE ONLY

NUMBER OF SIGNS \_\_\_\_\_

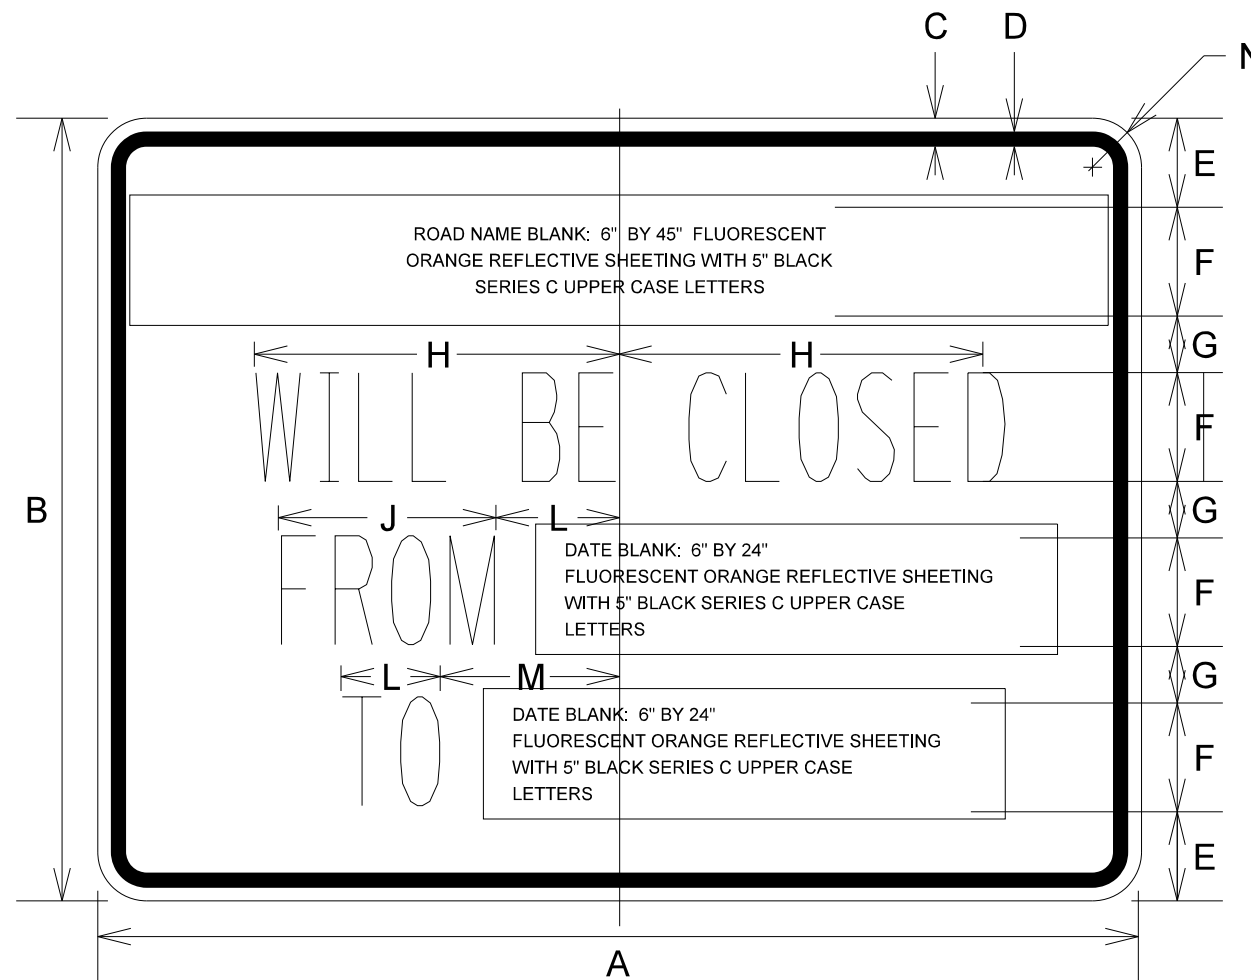

**DIMENSIONS (ENGLISH)**


A	48"
B	36"
C	5/8"
D	7/8"
E	4 1/8"
F	5"
G	2 5/8"
H	9 3/4"
J	12"
K	5 1/2"
L	5 1/2"
M	8 1/2"
N	2 1/4"

NOTE: SIGN SHEETING SHALL BE FLUORESCENT ORANGE WITH 5 INCH (125 mm) BLACK SERIES C LETTERS

**LOCATIONS OF PRE-DETOUR INFORMATION SIGNS BY INTERSECTION**

- W.B. PETITE LAKE ROAD APPROACHING FARIFIELD ROAD
- E.B. PETITE LAKE ROAD APPROACHING FARIFIELD ROAD
- N.B. FARIFIELD ROAD APPROACHING PETITE LAKE ROAD
- N.B. ILLINOIS ROUTE 59 APPROACHING PETITE LAKE ROAD
- S.B. ILLINOIS ROUTE 59 APPROACHING PETITE LAKE ROAD
- W.B. PETITE LAKE ROAD APPROACHING ILLINOIS ROUTE 59
- E.B. PETITE LAKE ROAD, EAST OF ILLINOIS ROUTE 59

SIGN LAYOUT FOR PRE-DETOUR INFORMATION SIGNS AT THE INTERSECTION OF PETITE LAKE ROAD AND FAIRFIELD ROAD. SIGNS AT PETITE LAKE ROAD AND IL ROUTE 59 WILL BE INSTALLED IN A SIMILAR FASHION

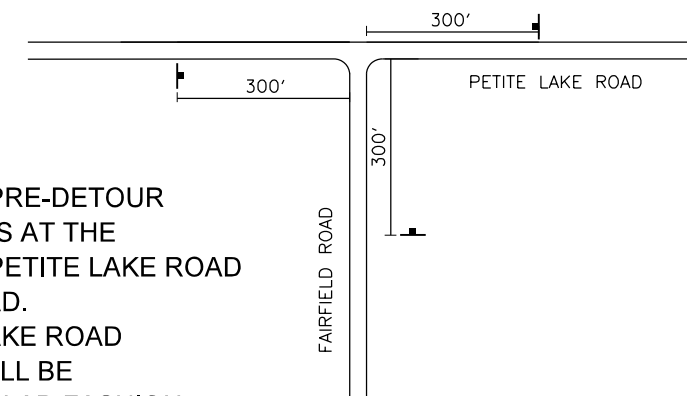

NOTE:  
THESE SIGNS SHALL BE INSTALLED 7-10 CALENDAR DAYS PRIOR TO THE DETOUR AND ROAD CLOSURE. THE SIGNS SHALL BE REMOVED THE DAY THE DETOUR BEGINS.


SCHEDULE OF QUANTITIES

SIGN NO.	SIGN TYPE	QUANTITY
1		13
2		3
3		9
4		4
5		7
6		21
7		15
8		42
9		2
10		1
11		1
12		5
13		2
14		3
15		1
16		2
17		4
18		4
19		1
20		2

DETOUR GENERAL NOTES

- ALL SIGNING SHALL BE IN ACCORDANCE WITH THE APPLICABLE PROVISIONS OF THE STATE OF ILLINOIS "STANDARD SPECIFICATIONS FOR ROAD AND BRIDGE CONSTRUCTION ADOPTED JAN. 1, 2012", " THE QUALITY STANDARD FOR WORK ZONE TRAFFIC CONTROL DEVICES ADOPTED 2010", THE DETAILS IN THESE PLANS, THE LATEST EDITION OF THE STATE OF ILLINOIS "MANUAL OF UNIFORM TRAFFIC CONTROL DEVICES", THE SPECIAL PROVISIONS FOR TRAFFIC CONTROL AND PROTECTION (LC-T-SECTION 700) AND THE L.C.D.O.T. DETOUR PROCEDURES AND GUIDELINES.
- THE ENGINEER SHALL BE NOTIFIED IN WRITING AT LEAST THREE WEEKS PRIOR TO THE DAY THE DETOUR IS TO BE IN EFFECT. THE ENGINEER SHALL DETERMINE THE HOUR OF CLOSURE. THE ENGINEER WILL CONTACT THE APPROPRIATE LOCAL AGENCIES AND INTERESTED PARTIES.
- IF DEEMED NECESSARY BY THE ENGINEER A PRE-CONSTRUCTION MEETING WITH THE CONTRACTOR SHALL BE HELD AT LEAST TWO WEEKS PRIOR TO THE DAY THE DETOUR IS TO BE IN EFFECT.
- THE CONTRACTOR SHALL SUPPLY TO THE ENGINEER THE NAMES AND TELEPHONE NUMBERS OF HIS REPRESENTATIVES ON THE CONSTRUCTION SITE AND HIS REPRESENTATIVE RESPONSIBLE FOR THE DETOUR SIGNING PRIOR TO THE START OF THE WORK. THE LAKE COUNTY DIVISION OF TRANSPORTATION REPRESENTATIVE FOR THIS DETOUR IS:  
  
TOM BENNECKE  
LAKE COUNTY DIVISION OF TRANSPORTATION  
TRAFFIC MANAGEMENT CENTER/TRAFFIC ENGINEERING  
600W. WINCHESTER ROAD  
LIBERTYVILLE, ILLINOIS 60048  
(847) 377-7476
- IF REQUESTED BY THE CONTRACTOR IN WRITING AT LEAST THREE WEEKS PRIOR TO THE DAY THE DETOUR IS TO BE IN EFFECT THE ENGINEER WILL FIELD LOCATE THE POSITIONS OF ANY SIGNS.
- LONGITUDINAL DIMENSIONS SHOWN ON THESE PLANS MAY BE ADJUSTED TO FIT FIELD CONDITIONS, WITH THE APPROVAL OF THE ENGINEER.
- THE ROAD SHALL NOT BE CLOSED UNTIL ALL SIGNING IS ERECTED IN ACCORDANCE WITH THE DETOUR PLAN AND INSPECTED AND APPROVED BY THE ENGINEER.
- THE CONTRACTOR SHALL BE RESPONSIBLE FOR ENSURING THAT ALL BARRICADES, SIGNS, LIGHTS, AND OTHER DEVICES INSTALLED BY HIM ARE IN PLACE AND OPERATING 24 HOURS EACH DAY INCLUDING SUNDAYS AND HOLIDAYS DURING THE TIME THE DETOUR IS IN EFFECT.
- THE TRAFFIC CONTROL SHOWN ON THE DETOUR PLAN IS THE MINIMUM NECESSARY TO ENSURE THIS ROAD CLOSURE. THE CONTRACTOR SHALL MAKE ALL CHANGES IN TRAFFIC CONTROL THAT IS DEEMED NECESSARY BY THE ENGINEER. ADDITIONS AND DELETIONS OF TRAFFIC CONTROL FOR THIS DETOUR SHALL BE CONSIDERED INCIDENTAL TO THE PAY ITEM "TRAFFIC CONTROL AND PROTECTION".
- ALL EXISTING SIGNING THAT IS NOT APPLICABLE WHILE THE DETOUR IS IN EFFECT SHALL BE COMPLETELY COVERED BY THE CONTRACTOR, IN A MANNER APPROVED BY THE ENGINEER.
- ALL DETOUR SIGNING SHALL BE POST MOUNTED IF THE ROAD CLOSURE IS TO EXCEED FOUR (4) CALENDAR DAYS.

- ALL DETOUR SIGNING EXCEPT REGULATORY SIGNS SHALL HAVE BLACK LEGENDS ON FLUORESCENT ORANGE SHEETING AND STANDARD BLACK BORDERS. THE FLUORESCENT ORANGE REFLECTIVE SHEETING SHALL MEET THE REQUIREMENTS OF SECTION 1091 OF THE STANDARD SPECIFICATIONS. ALL DETOUR SIGNING SHALL BE NEW OR LIKE NEW CONDITION. THE ENGINEER SHALL BE THE SOLE JUDGE OF THE CONDITION OF THE SIGNS.
- THE SIZES OF ALL SIGNS NOT SPECIFIED IN THESE PLANS SHALL BE AS REQUIRED BY THE ILLINOIS MANUAL ON UNIFORM TRAFFIC CONTROL DEVICES.
- AS A MINIMUM, ALL AMBER FLASHING LIGHTS THAT ARE REQUIRED FOR THIS DETOUR SHALL MEET THE REQUIREMENTS FOR TYPE A-LOW INTENSITY FLASHING LIGHTS IN ARTICLE 1106.02 OF THE STANDARD SPECIFICATIONS. ALL LIGHTS SHALL OPERATE DURING THE HOURS OF DARKNESS. ONLY LIGHTS THAT HAVE BEEN APPROVED BY THE ILLINOIS DEPARTMENT OF TRANSPORTATION SHALL BE USED.
- ALL BARRICADES SHALL HAVE REFLECTORIZED STRIPING ON BOTH SIDES OF THE BARRICADES.
- THE "ROAD CLOSED" (R11-2), THE "ROAD CLOSED XX MILES AHEAD LOCAL TRAFFIC ONLY" (R11-3) AND THE "ROAD CLOSED TO THRU TRAFFIC" (R11-4) SIGNS SHALL BE MOUNTED ABOVE THE TOP OF THE BARRICADE. ALL TYPE III BARRICADES SHALL HAVE TWO (2) AMBER TYPE A-LOW INTENSITY FLASHING LIGHTS SPACED NEAR THE CENTERLINE OF THE SUPPORTS.
- THE ROAD NAME SIGN SHALL HAVE A BLACK LEGEND ON FLUORESCENT ORANGE REFLECTIVE SHEETING. THE CAPITAL LETTERS SHALL BE 6" WITH 5" LOWER CASE.
- DURING NON-WORKING HOURS AT THE POINT OF ROAD CLOSURE TO ALL TRAFFIC ONLY" (R11-3) AND THE "ROAD CLOSED TO THRU TRAFFIC" (R11-4) BARRICADES FROM EASY MOVEMENT BY VANDALS. THE CHOSEN METHOD SHALL BE APPROVED BY THE ENGINEER.
- CONSTRUCTION EQUIPMENT SHALL NOT BE PARKED IMMEDIATELY BEHIND THE TYPE III BARRICADES DURING NON-WORKING HOURS. IN ANY EVENT ARTICLE 701.04 OF THE STANDARD SPECIFICATIONS SHALL APPLY.
- THE CONTRACTOR SHALL BE RESPONSIBLE FOR MAINTAINING THE VISIBILITY OF ALL DETOUR AND CONSTRUCTION SIGNING, INCLUDING BRUSHING BACK VEGETATION IF DEEMED NECESSARY BY THE ENGINEER PER ARTICLE 201.10
- THE FOLLOWING ILLINOIS DEPARTMENT OF TRANSPORTATION STANDARD IS APPLICABLE FOR THIS WORK:  
  
STANDARD 701006, 701301, 701306, 701326, 701901
- THE ENGINEER SHALL BE NOTIFIED AT LEAST TWO (2) HOURS BEFORE THE ROAD IS TO BE OPENED TO TRAFFIC. THE ENGINEER WILL CONTACT THE APPROPRIATE LOCAL AGENCIES AND INTERESTED PARTIES.

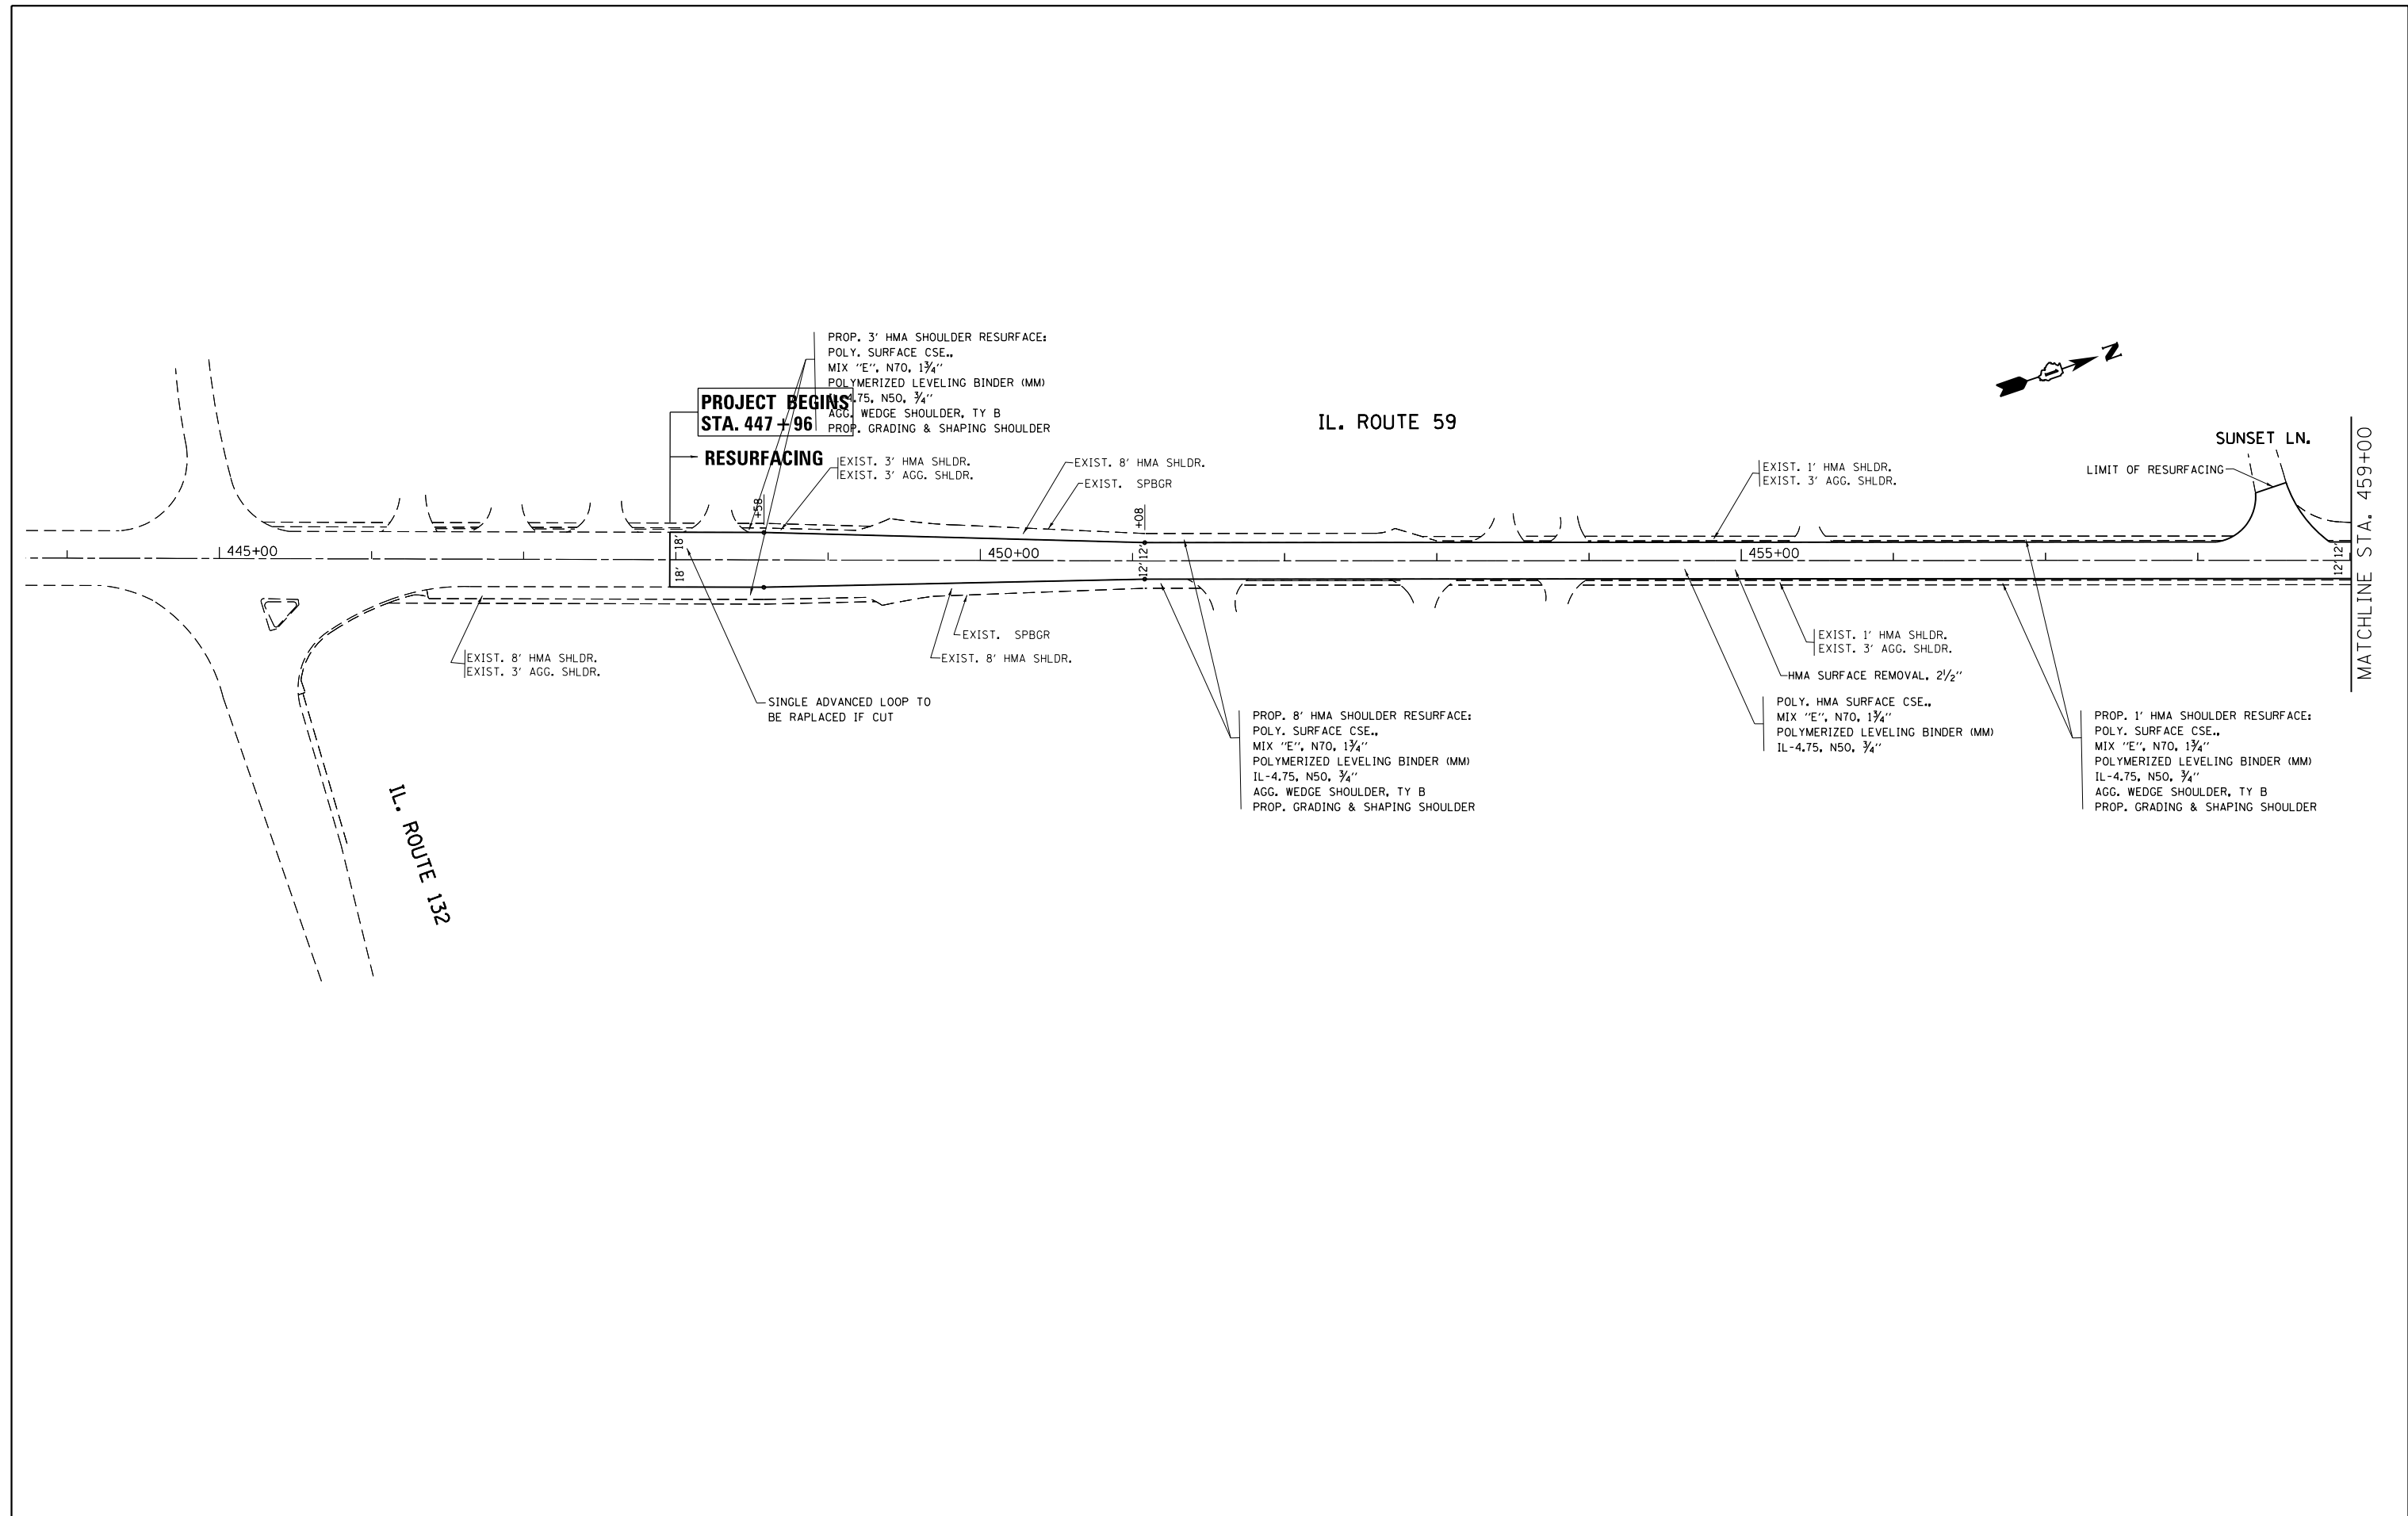

FILE NAME =	USER NAME = ledezmar	DESIGNED -	REVISED -
p:\11\084EBIDINTEG\illinois.gov\PWIDOT\Documents\DOT Offices\District 1\Projects\P145409\Drawings\Design\P145409-shr-cover.dgn		CHECKED -	REVISED -
Default	PLOT DATE = 9/19/2016	DATE -	REVISED -



**STATE OF ILLINOIS  
DEPARTMENT OF TRANSPORTATION**

**EXISTING AND PROPOSED ROADWAY PLAN  
IL. ROUTE 59 AT PETITE LAKE RD**



F.A.P. RTE.	SECTION	COUNTY	TOTAL SHEETS	SHEET NO.
104	105N-4	LAKE	113	32
<b>CONTRACT NO. 60W06</b>				
ILLINOIS FED. AID PROJECT				

SCALE: 1"=50'      SHEET      OF      SHEETS      STA.      TO STA.



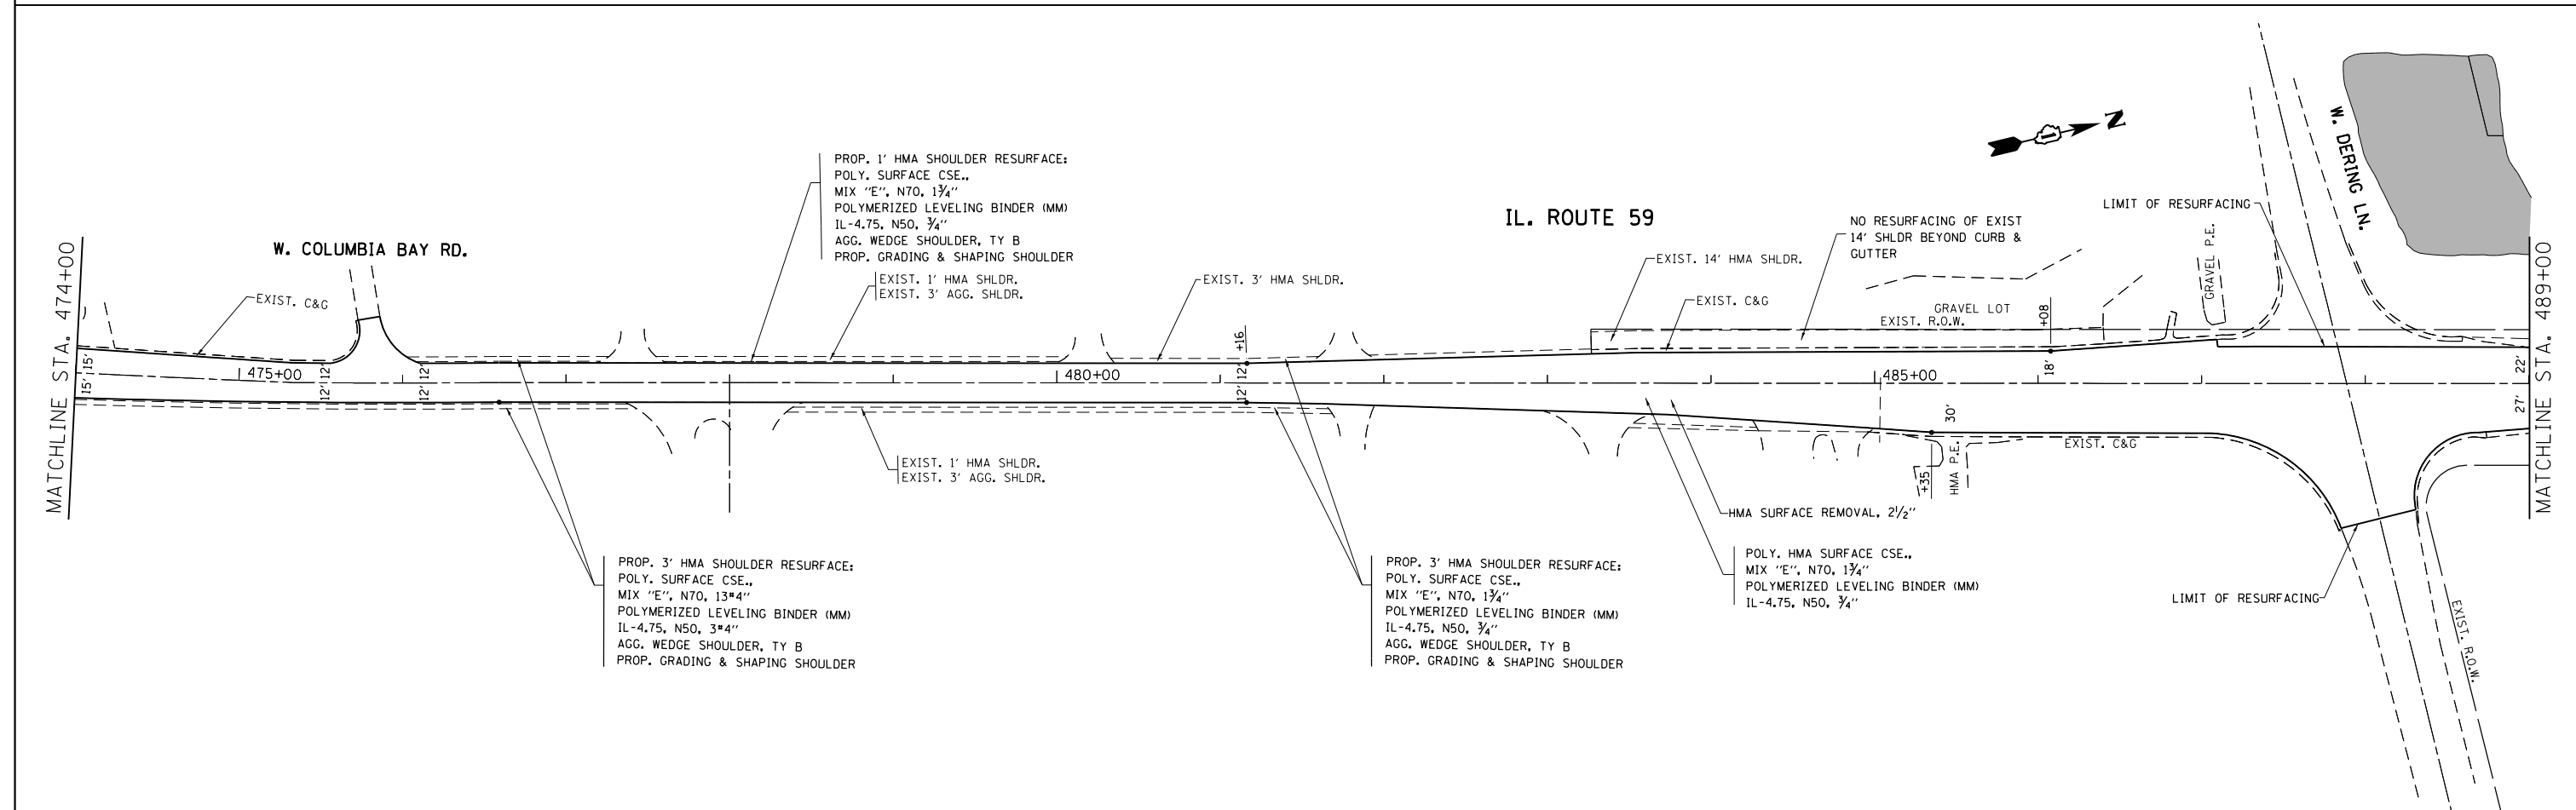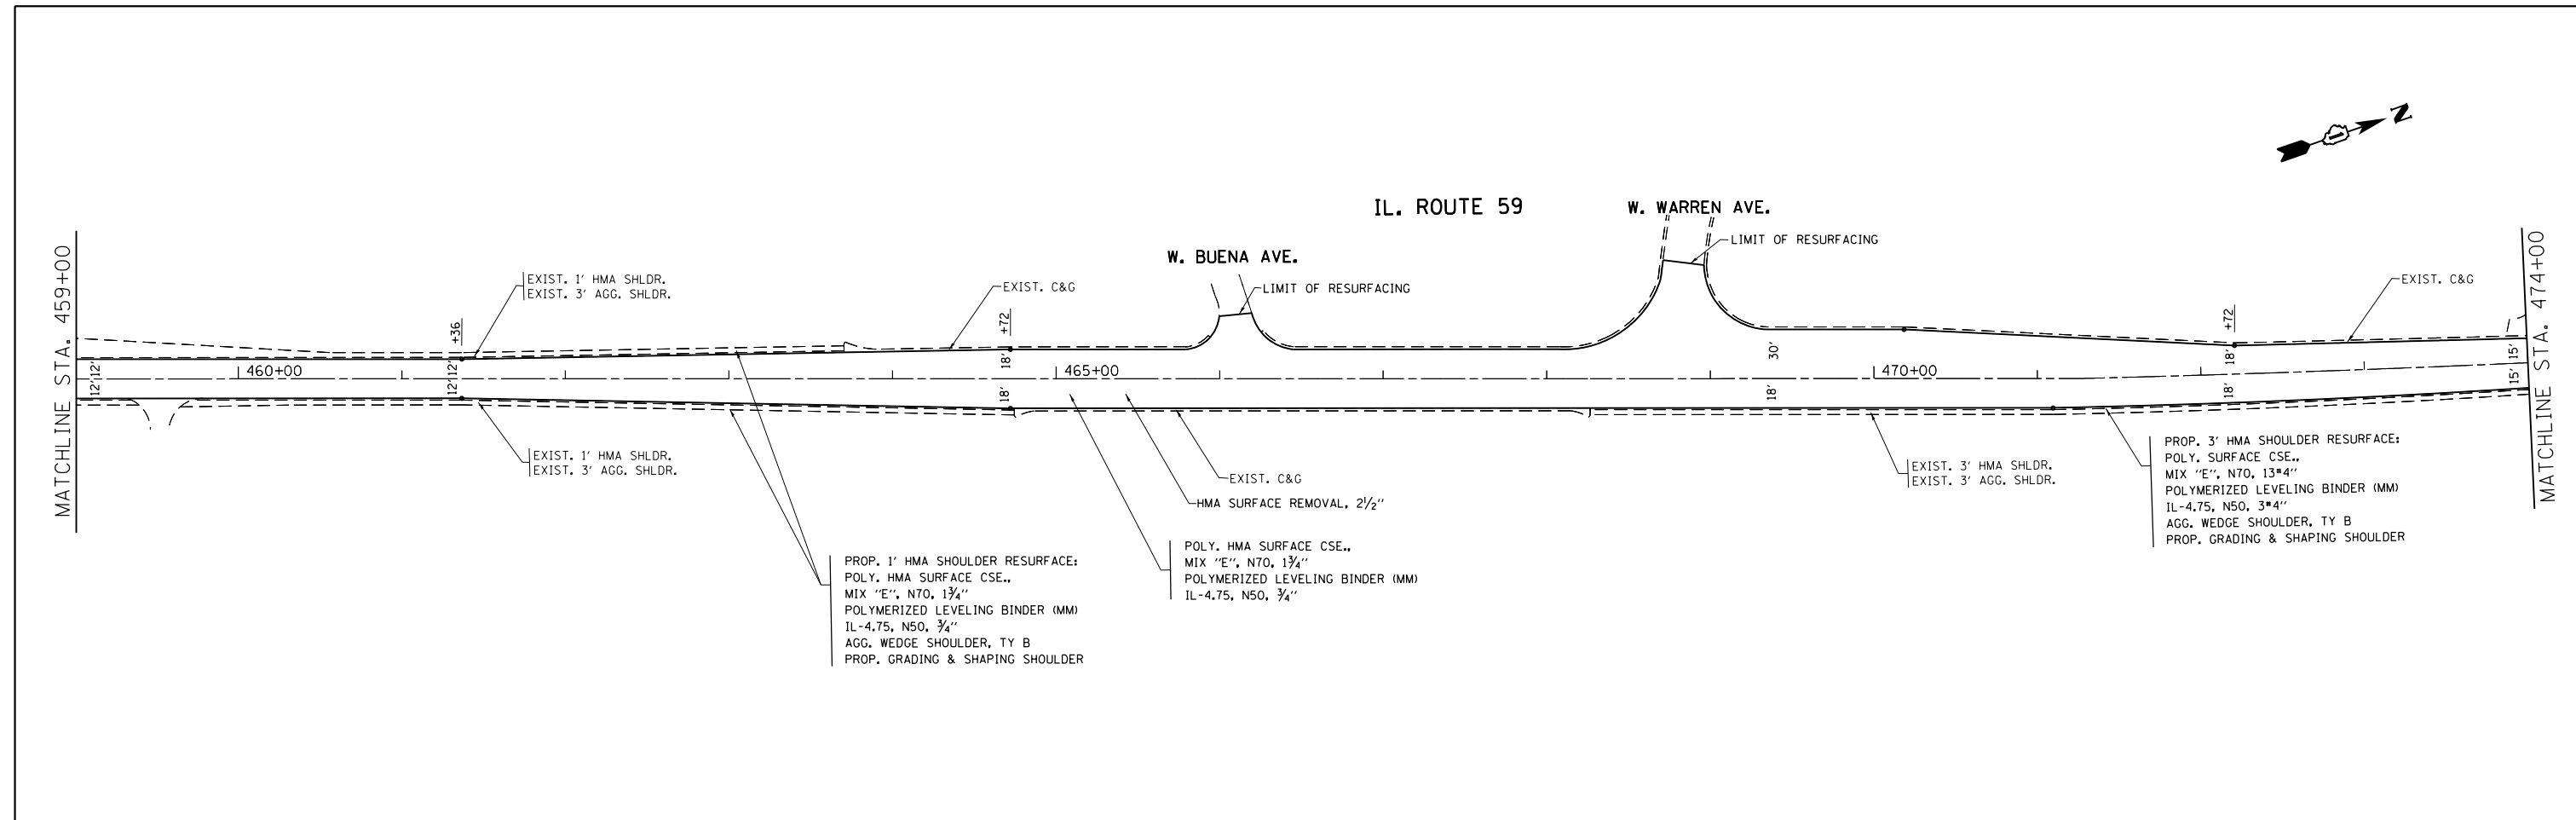

FILE NAME =	USER NAME = ledeznorm	DESIGNED -	REVISED -	<b>STATE OF ILLINOIS DEPARTMENT OF TRANSPORTATION</b>	<b>EXISTING AND PROPOSED ROADWAY PLAN IL. ROUTE 59 AT PETITE LAKE RD</b>			F.A.P. RTE.	SECTION	COUNTY	TOTAL SHEETS	SHEET NO.
pw:\IL084EBIDINTEG.illinois.gov\PIWIDOT\Documents\IDOT Offices\District 1\Projects\P145409\Drawings\Design\P145409-shr-cover.dgn	PLotted SCALE = 100.0000' / in.	CHECKED -	REVISED -					104	105N-4	LAKE	113	33
Default	PLOT DATE = 9/19/2016	DATE -	REVISED -		SCALE: 1"=50'			SHEET OF SHEETS STA. TO STA.			CONTRACT NO. 60W06	
ILLINOIS FED. AID PROJECT												

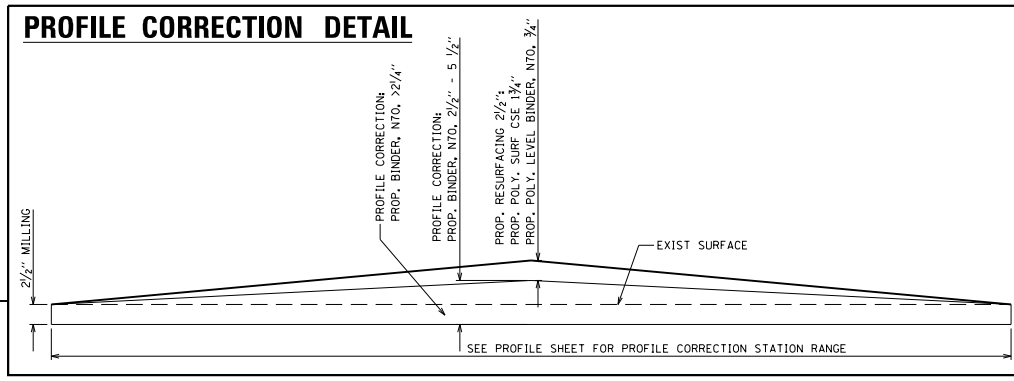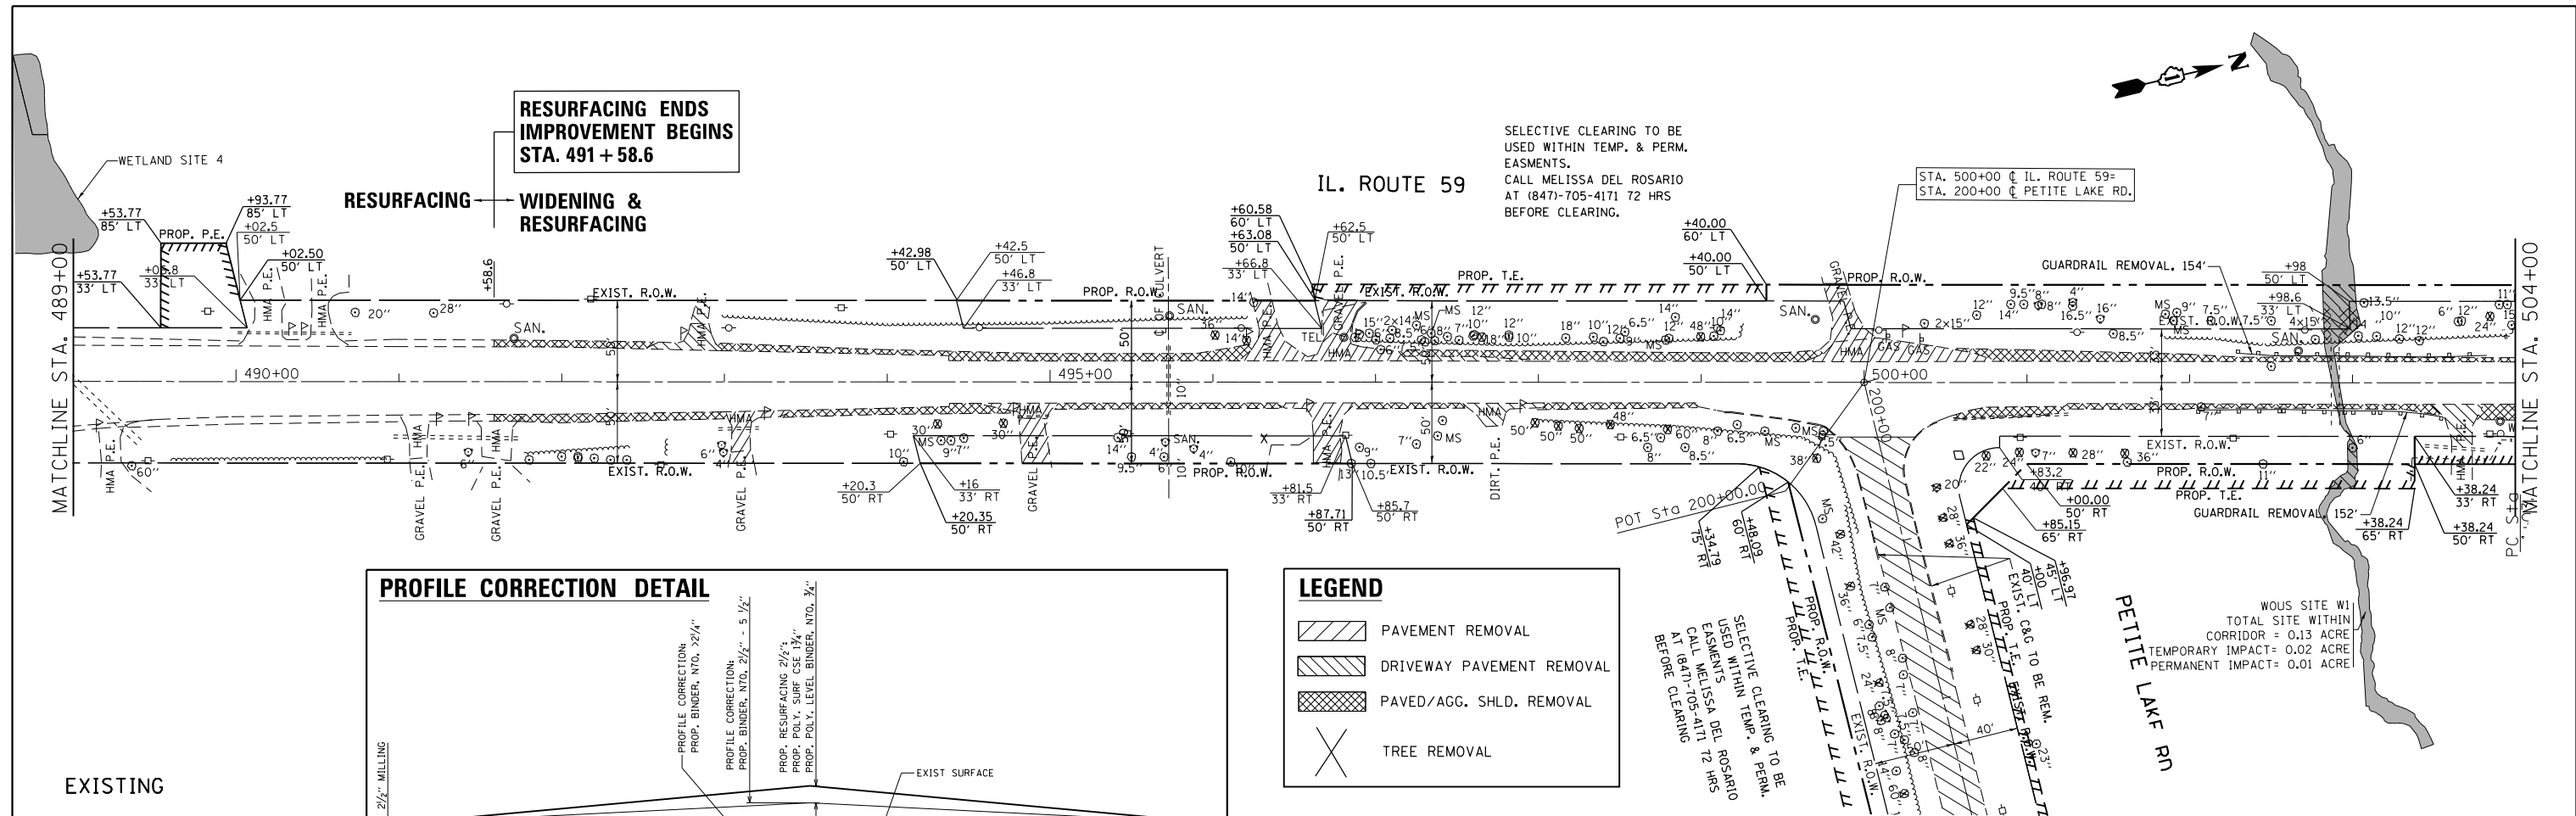


**LEGEND**

- PAVEMENT REMOVAL
- DRIVEWAY PAVEMENT REMOVAL
- PAVED/AGG. SHLD. REMOVAL
- TREE REMOVAL

SELECTIVE CLEARING TO BE USED WITHIN TEMP. & PERM. EASMENTS. CALL MELISSA DEL ROSARIO AT (847)-705-4171 72 HRS BEFORE CLEARING.

STA. 500+00 @ IL. ROUTE 59- STA. 200+00 @ PETITE LAKE RD.

WOUS SITE W/ TOTAL SITE WITHIN CORRIDOR = 0.13 ACRE  
TEMPORARY IMPACT = 0.02 ACRE  
PERMANENT IMPACT = 0.01 ACRE

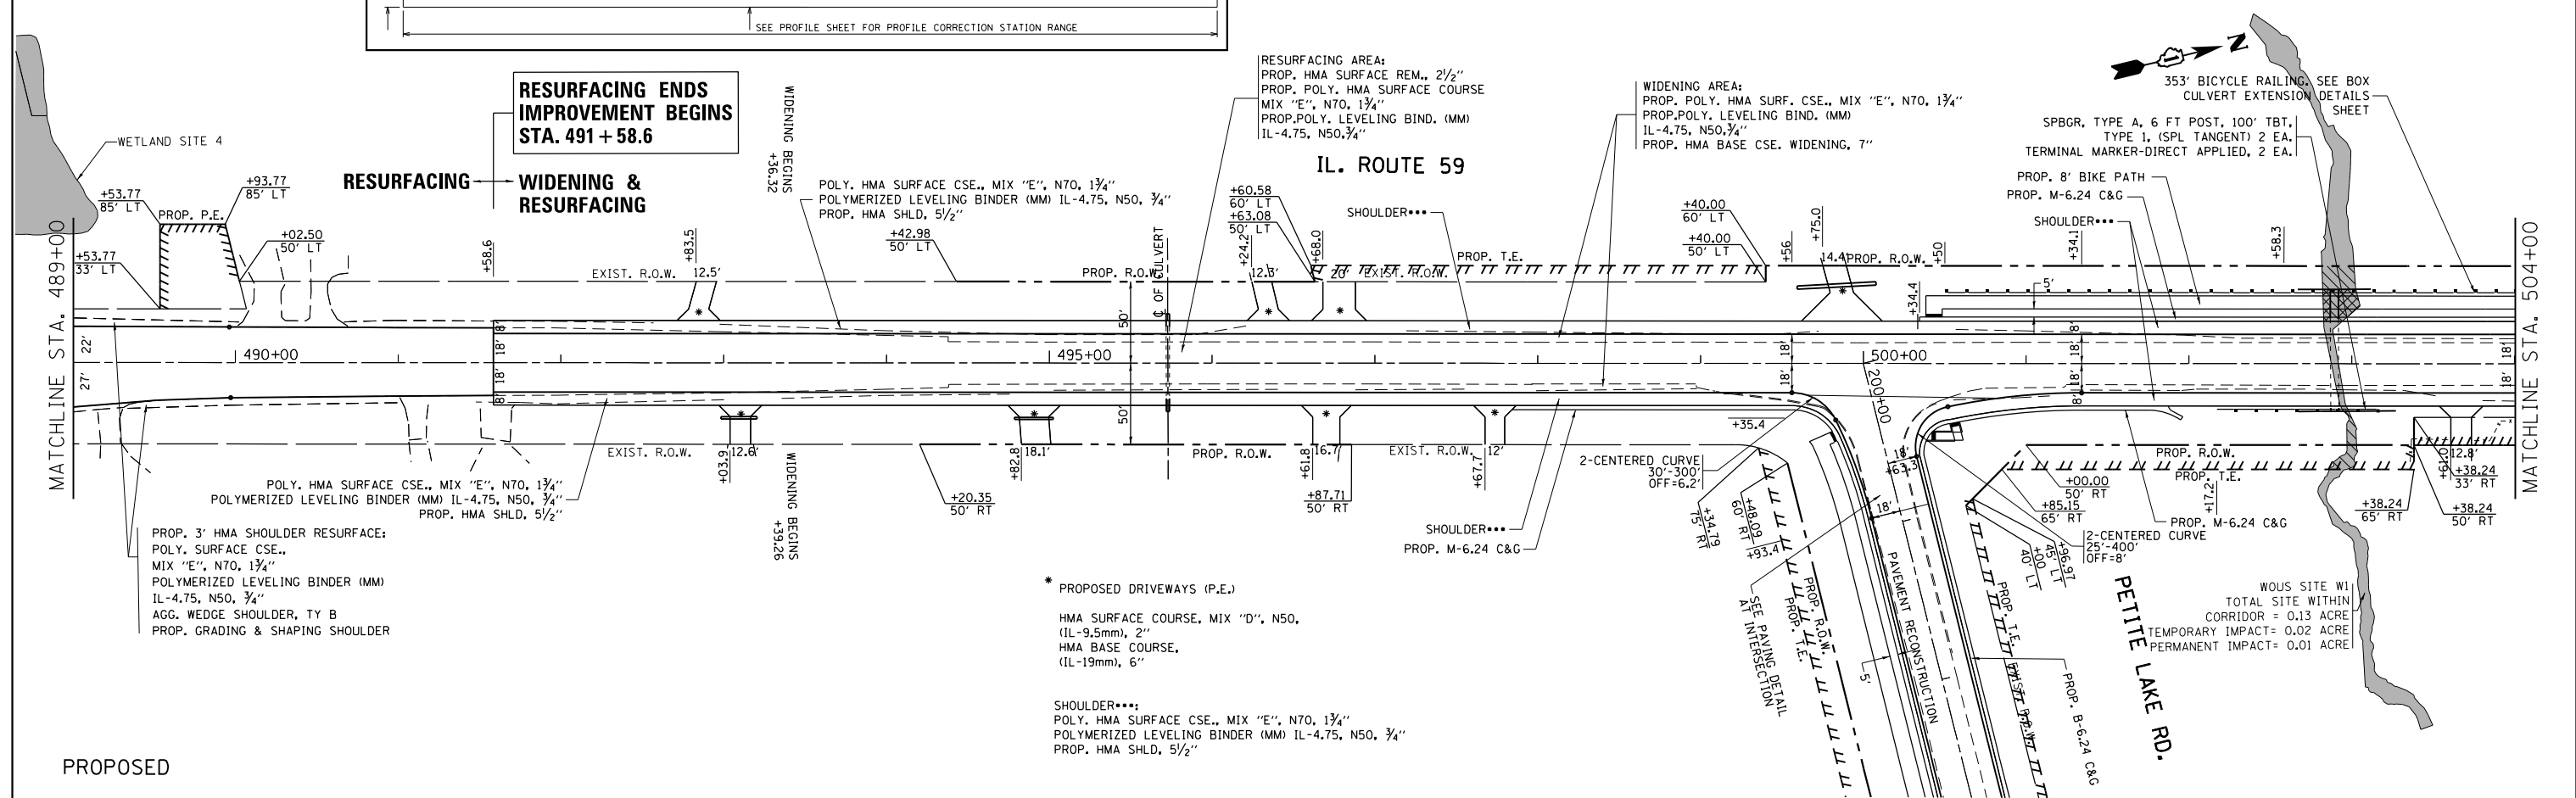

POLY. HMA SURFACE CSE., MIX "E", N70, 1 3/4"  
POLYMERIZED LEVELING BINDER (MM) IL-4.75, N50, 3/4"  
PROP. HMA SHLD., 5 1/2"

PROP. 3' HMA SHOULDER RESURFACE:  
POLY. SURFACE CSE., MIX "E", N70, 1 3/4"  
POLYMERIZED LEVELING BINDER (MM) IL-4.75, N50, 3/4"  
AGG. WEDGE SHOULDER, TY B  
PROP. GRADING & SHAPING SHOULDER

RESURFACING AREA:  
PROP. HMA SURFACE REM., 2 1/2"  
PROP. POLY. HMA SURFACE COURSE MIX "E", N70, 1 3/4"  
PROP. POLY. LEVELING BIND. (MM) IL-4.75, N50, 3/4"  
IL-4.75, N50, 3/4"

WIDENING AREA:  
PROP. POLY. HMA SURF. CSE., MIX "E", N70, 1 3/4"  
PROP. POLY. LEVELING BIND. (MM) IL-4.75, N50, 3/4"  
PROP. HMA BASE CSE. WIDENING, 7"

\* PROPOSED DRIVEWAYS (P.E.)  
HMA SURFACE COURSE, MIX "D", N50, (IL-9.5mm), 2"  
HMA BASE COURSE, (IL-19mm), 6"  
SHOULDER\*\*\*  
POLY. HMA SURFACE CSE., MIX "E", N70, 1 3/4"  
POLYMERIZED LEVELING BINDER (MM) IL-4.75, N50, 3/4"  
PROP. HMA SHLD., 5 1/2"





SPBGR, TYPE A, 6 FT POST, 100' TBT, TYPE 1, (SPL TANGENT) 2 EA.  
TERMINAL MARKER-DIRECT APPLIED, 2 EA.



WOUS SITE W/ TOTAL SITE WITHIN CORRIDOR = 0.13 ACRE  
TEMPORARY IMPACT = 0.02 ACRE  
PERMANENT IMPACT = 0.01 ACRE

FILE NAME =	USER NAME = ldezmarm	DESIGNED -	REVISED -	<b>STATE OF ILLINOIS DEPARTMENT OF TRANSPORTATION</b>	<b>EXISTING AND PROPOSED ROADWAY PLAN IL. ROUTE 59 AT PETITE LAKE RD</b>	F.A.P. RTE.	SECTION	COUNTY	TOTAL SHEETS	SHEET NO.
p:\w\IL084EBIDINTEG\illinois.gov\PIWIDOT\Documents\DOT Offices\District 1\Projects\P145409\Design\P145409-shr-cover.dgn		CHECKED -	REVISED -			104	105N-4	LAKE	113	34
PLOT SCALE = 100.0000' / in.		DATE -	REVISED -			CONTRACT NO. 60W06				
Default						ILLINOIS FED. AID PROJECT				


EXIST. CURVE E\_IL59-3  
 PI STA. = 518+54.02  
 $\Delta = 2^\circ 25' 03''$  (RT)  
 $D = 0^\circ 05' 00''$   
 $R = 68,760.00'$   
 $T = 1,450.90'$   
 $L = 2,901.36'$   
 $E = 15.31'$   
 $e =$  ----  
 $T.R. =$  ----  
 $S.E. RUN =$  ----  
 $P.C. STA. = 504+03.12$   
 $P.T. STA. = 533+04.49$

**LEGEND**

-  PAVEMENT REMOVAL
-  DRIVEWAY PAVEMENT REMOVAL
-  PAVED/AGG. SHLD. REMOVAL
-  TREE REMOVAL

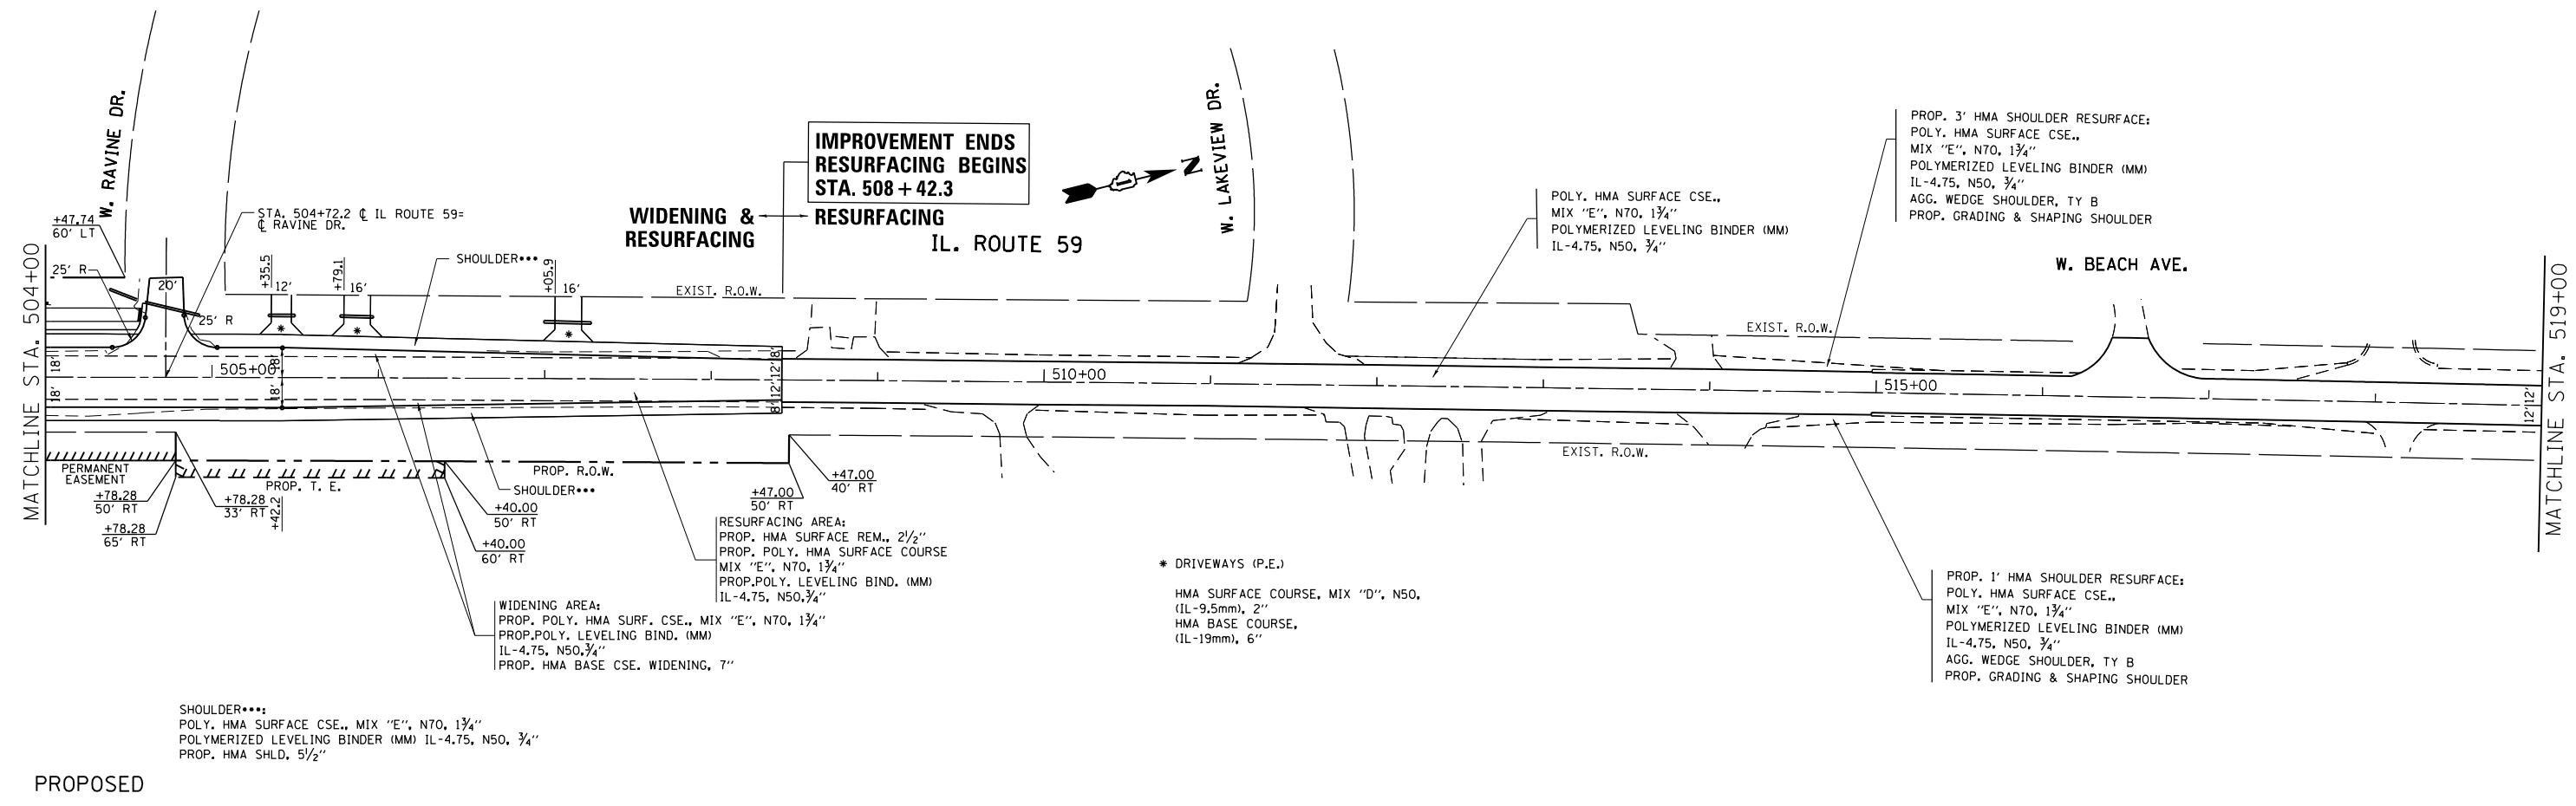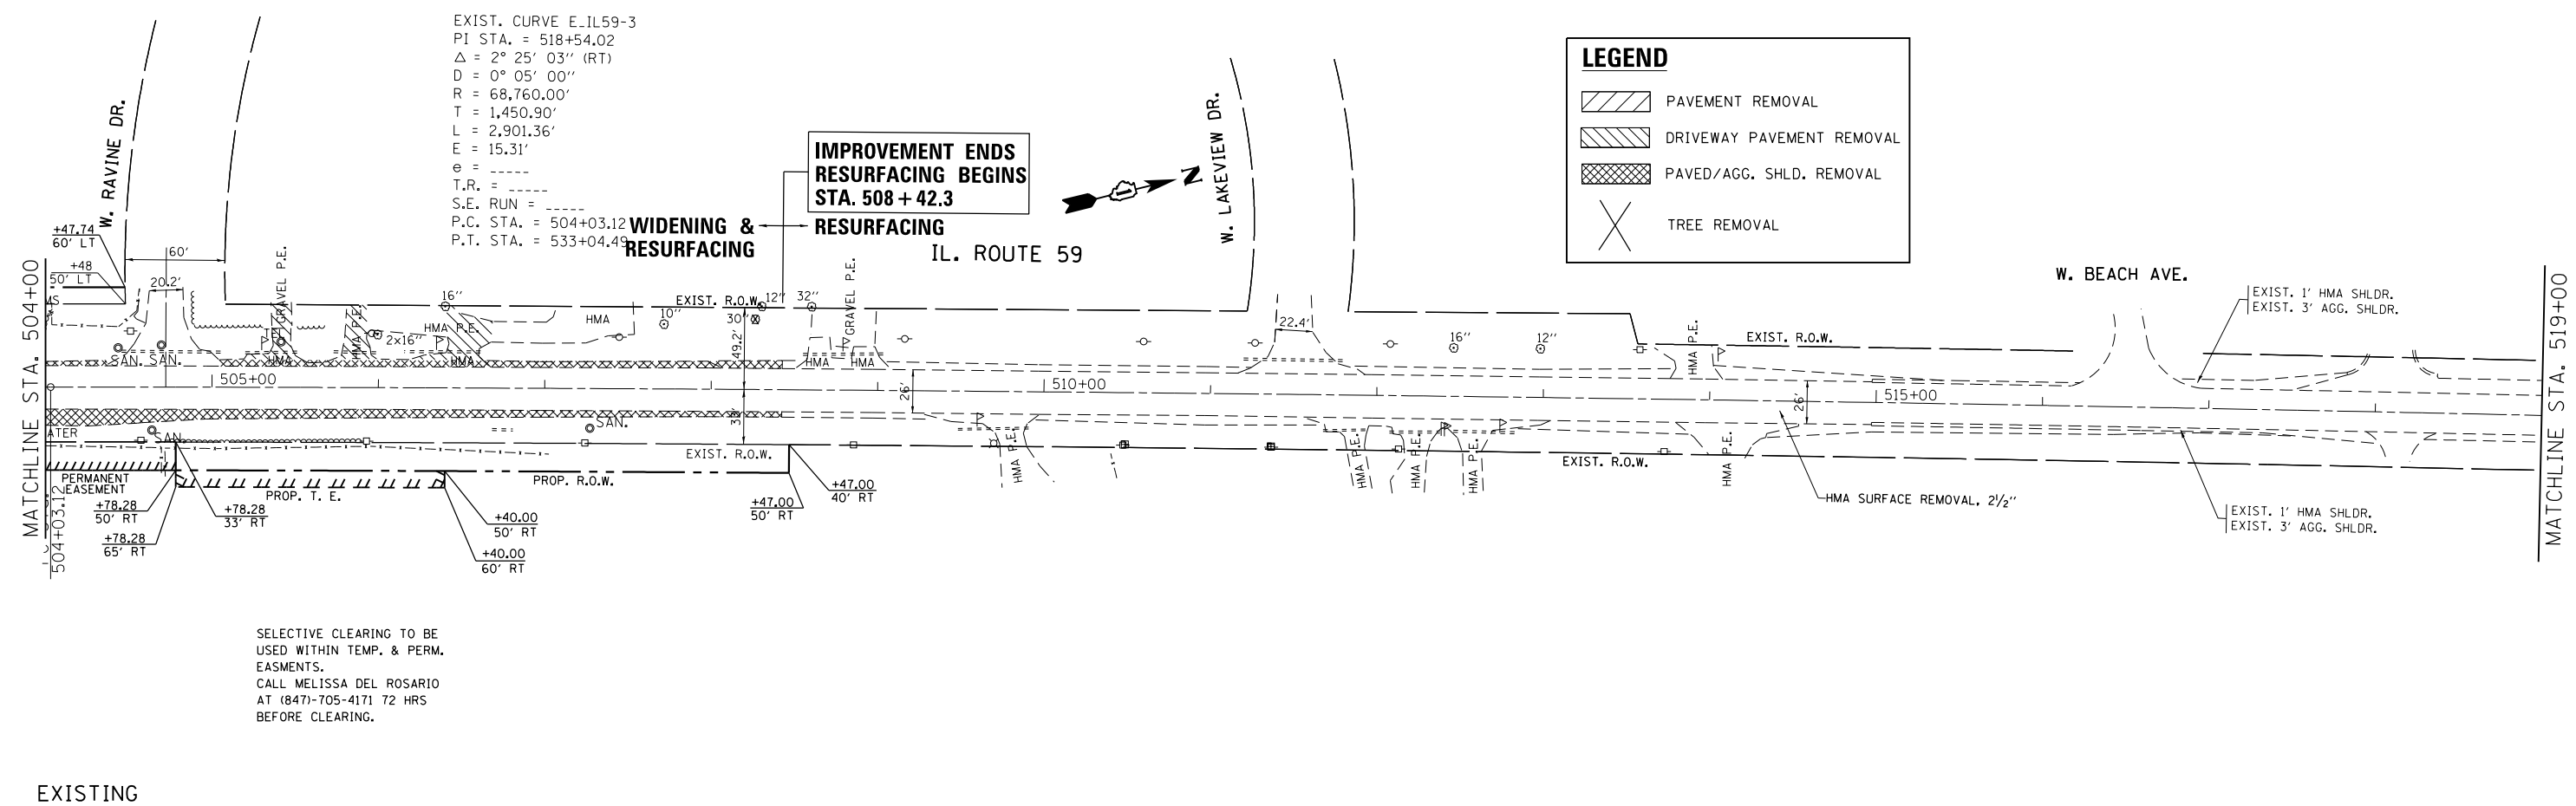

FILE NAME =	USER NAME = ldezmarm	DESIGNED -	REVISED -	<b>STATE OF ILLINOIS DEPARTMENT OF TRANSPORTATION</b>	<b>EXISTING AND PROPOSED ROADWAY PLAN IL. ROUTE 59 AT PETITE LAKE RD</b>			F.A.P. RTE.	SECTION	COUNTY	TOTAL SHEETS	SHEET NO.
pw:\IL\084EBIDINTEG\illinois.gov\PIWIDOT\Documents\DOT Offices\District 1\Projects\P145409\Drawings\Design\P145409-shr-cover.dgn	PLLOT SCALE = 100.0000' / 1" =	CHECKED -	REVISED -					104	105N-4	LAKE	113	35
Default	PLLOT DATE = 9/19/2016	DATE -	REVISED -		SCALE: 1"=50'			SHEET OF SHEETS STA. TO STA.			CONTRACT NO. 60W06	
ILLINOIS FED. AID PROJECT												

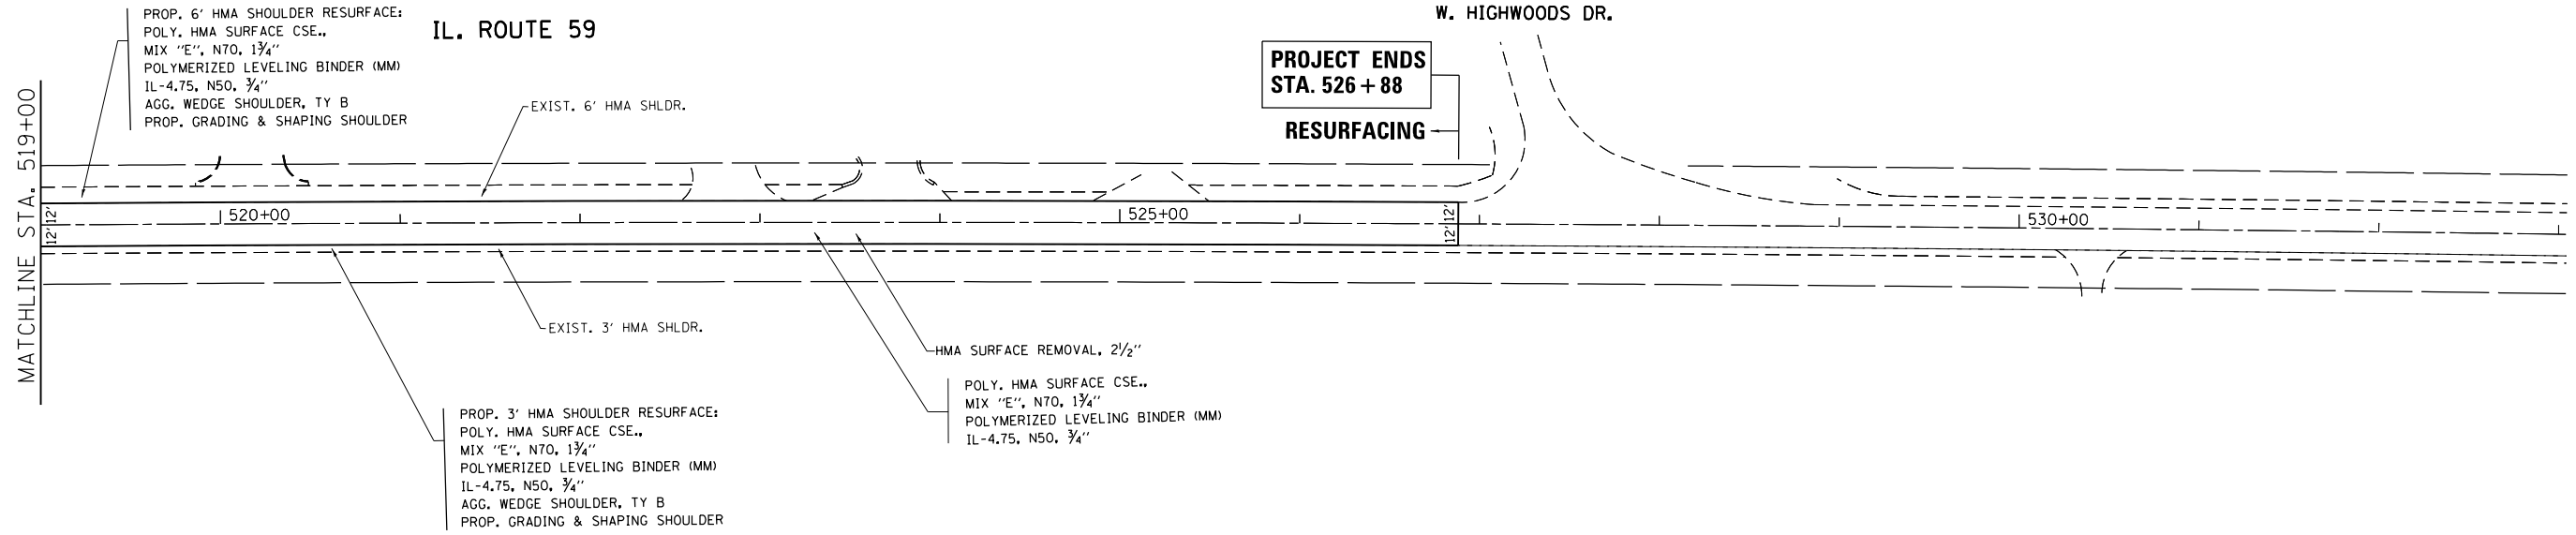

FILE NAME =	USER NAME = ledezmar	DESIGNED -	REVISED -
p:\11\084EBIDINTEG.illinois.gov\PI\DOT\Documents\DOT Offices\District 1\Projects\P145409\Drawings\Design\P145409-shr-cover.dgn		CHECKED -	REVISED -
Default	PLOT DATE = 9/19/2016	DATE -	REVISED -


**STATE OF ILLINOIS  
DEPARTMENT OF TRANSPORTATION**

**EXISTING AND PROPOSED ROADWAY PLAN  
IL. ROUTE 59 AT PETITE LAKE RD**


SCALE: 1"=50'    SHEET    OF    SHEETS    STA.    TO STA.

F.A.P. RTE.	SECTION	COUNTY	TOTAL SHEETS	SHEET NO.
104	105N-4	LAKE	113	36
CONTRACT NO. 60W06			ILLINOIS FED. AID PROJECT	

PLAN	SURVEYED	BY	DATE
	PLOTTED		
	ALIGNED		
	CHECKED		
	FILE NAME		
	NO.		


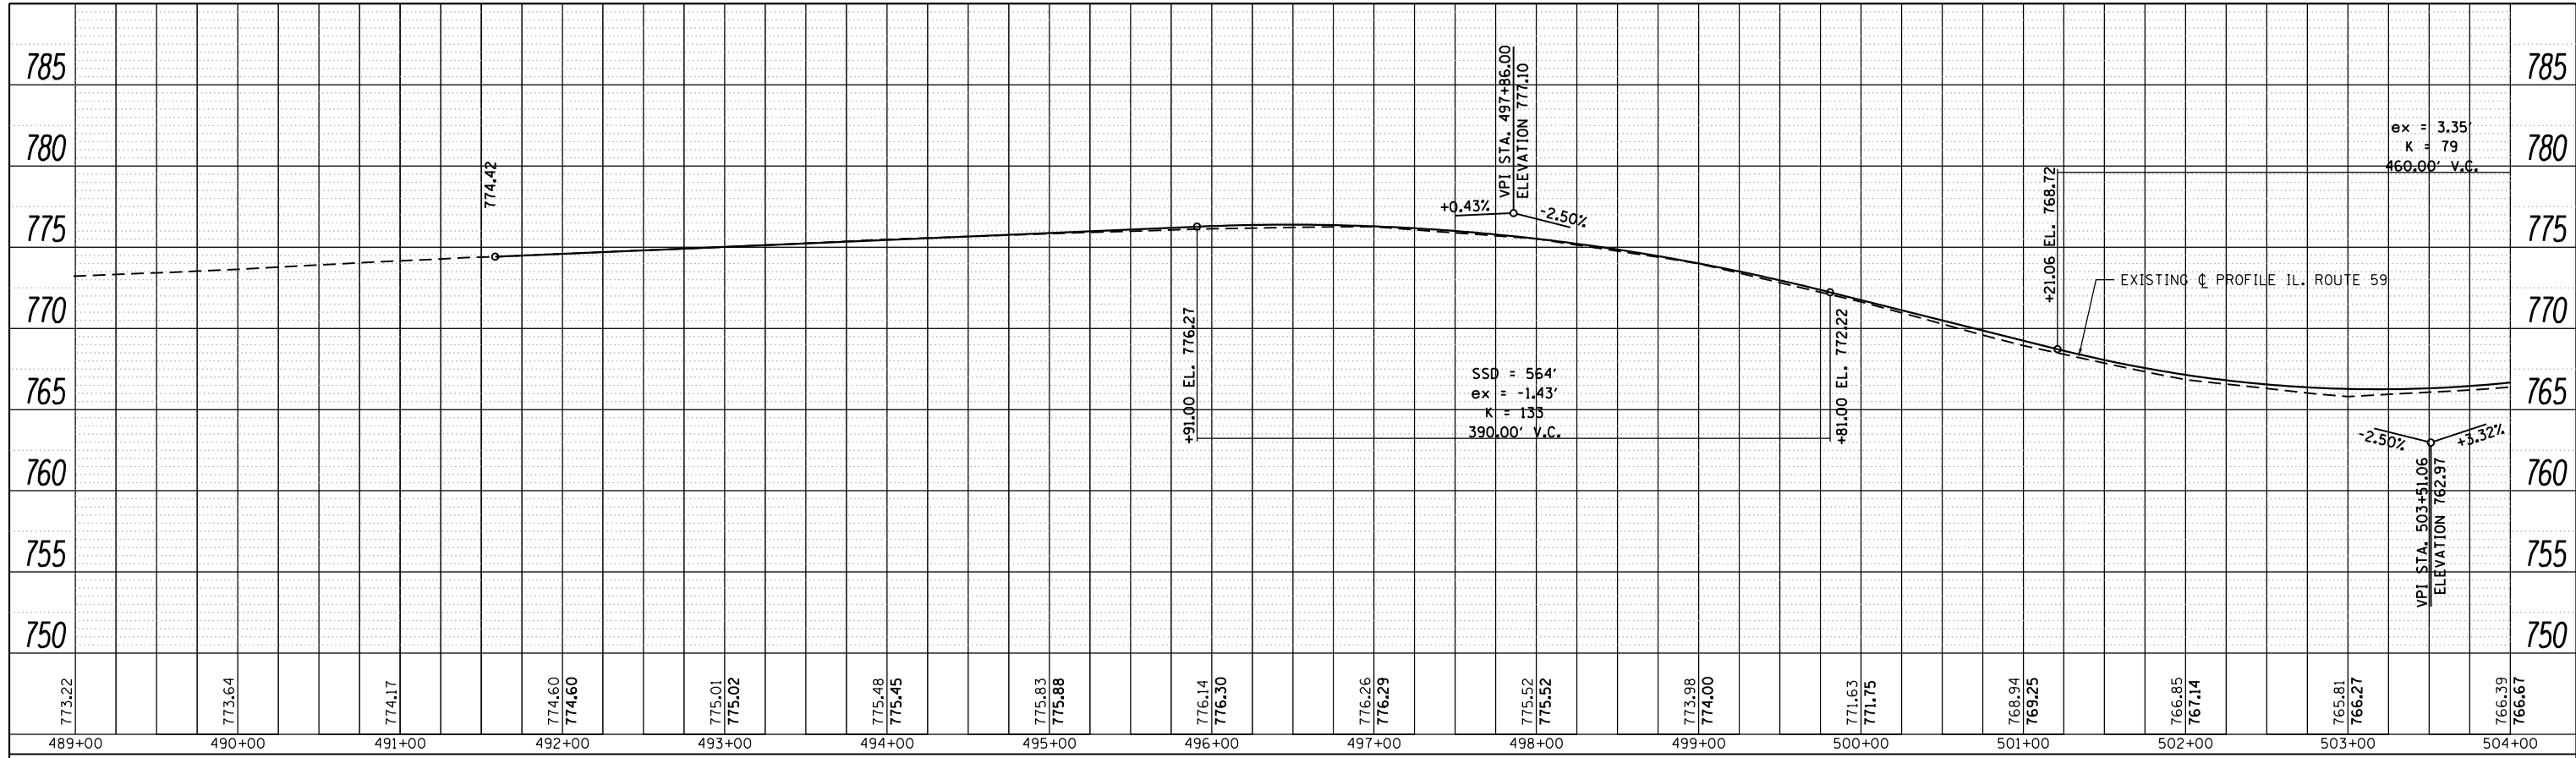


PROFILE	SURVEYED	BY	DATE
	PLOTTED		
	GRADES CHECKED		
	STRUCTURE NOTATIONS CHECKED		
	NO.		

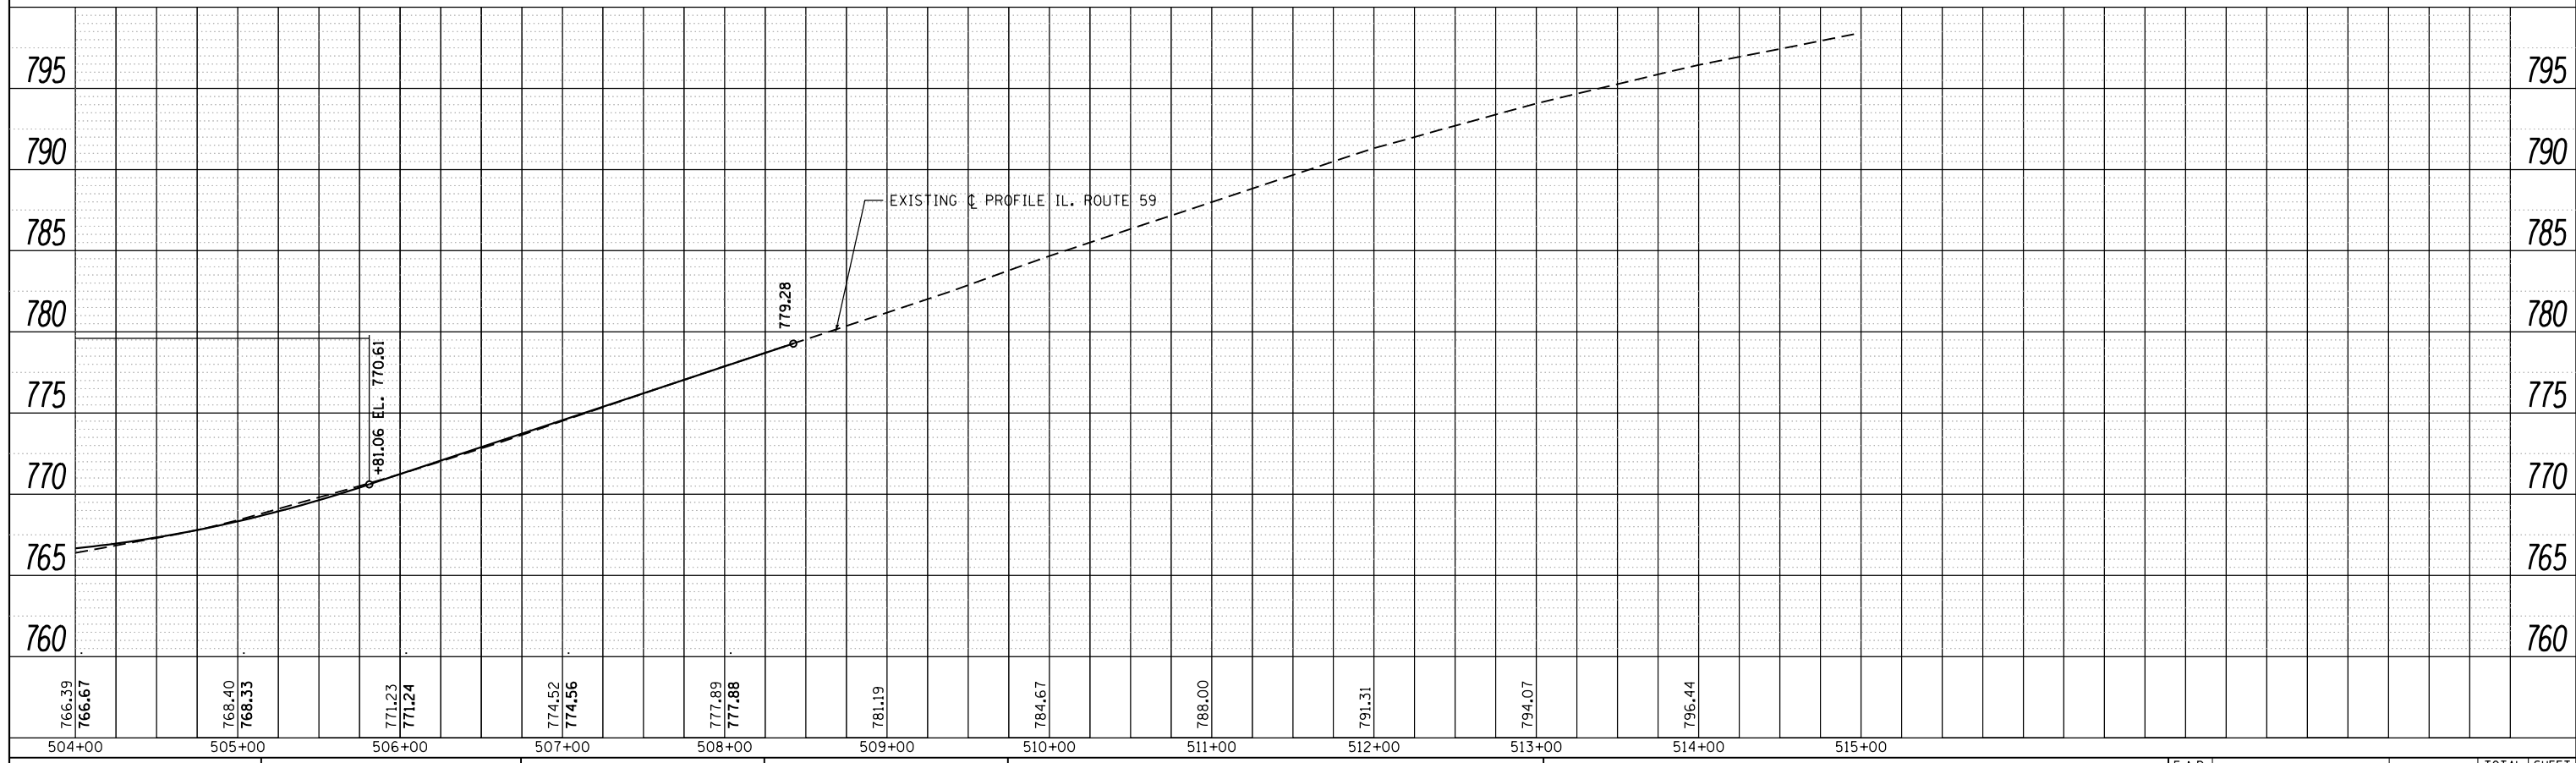

FILE NAME =	USER NAME = ldeznorm	DESIGNED -	REVISED -	<b>STATE OF ILLINOIS</b> <b>DEPARTMENT OF TRANSPORTATION</b>	<b>EXISTING AND PROPOSED ROADWAY PROFILE</b> <b>IL. ROUTE 59 AT PETITE LAKE RD.</b>			F.A.P. RTE.	SECTION	COUNTY	TOTAL SHEETS	SHEET NO.
p:\11084EBIDINTEG.allinois.gov\PIWIDOT\Documents\DOT Offices\District 1\Projects\P145499\DRAWING\Design\P145409-sht-cover.dgn		REVISION	REVISION		104	105N-4	LAKE	113	37			
PLOT SCALE = 100.0000' / in.	CHECKED -	REVISION	REVISION		<b>CONTRACT NO. 60W06</b>							
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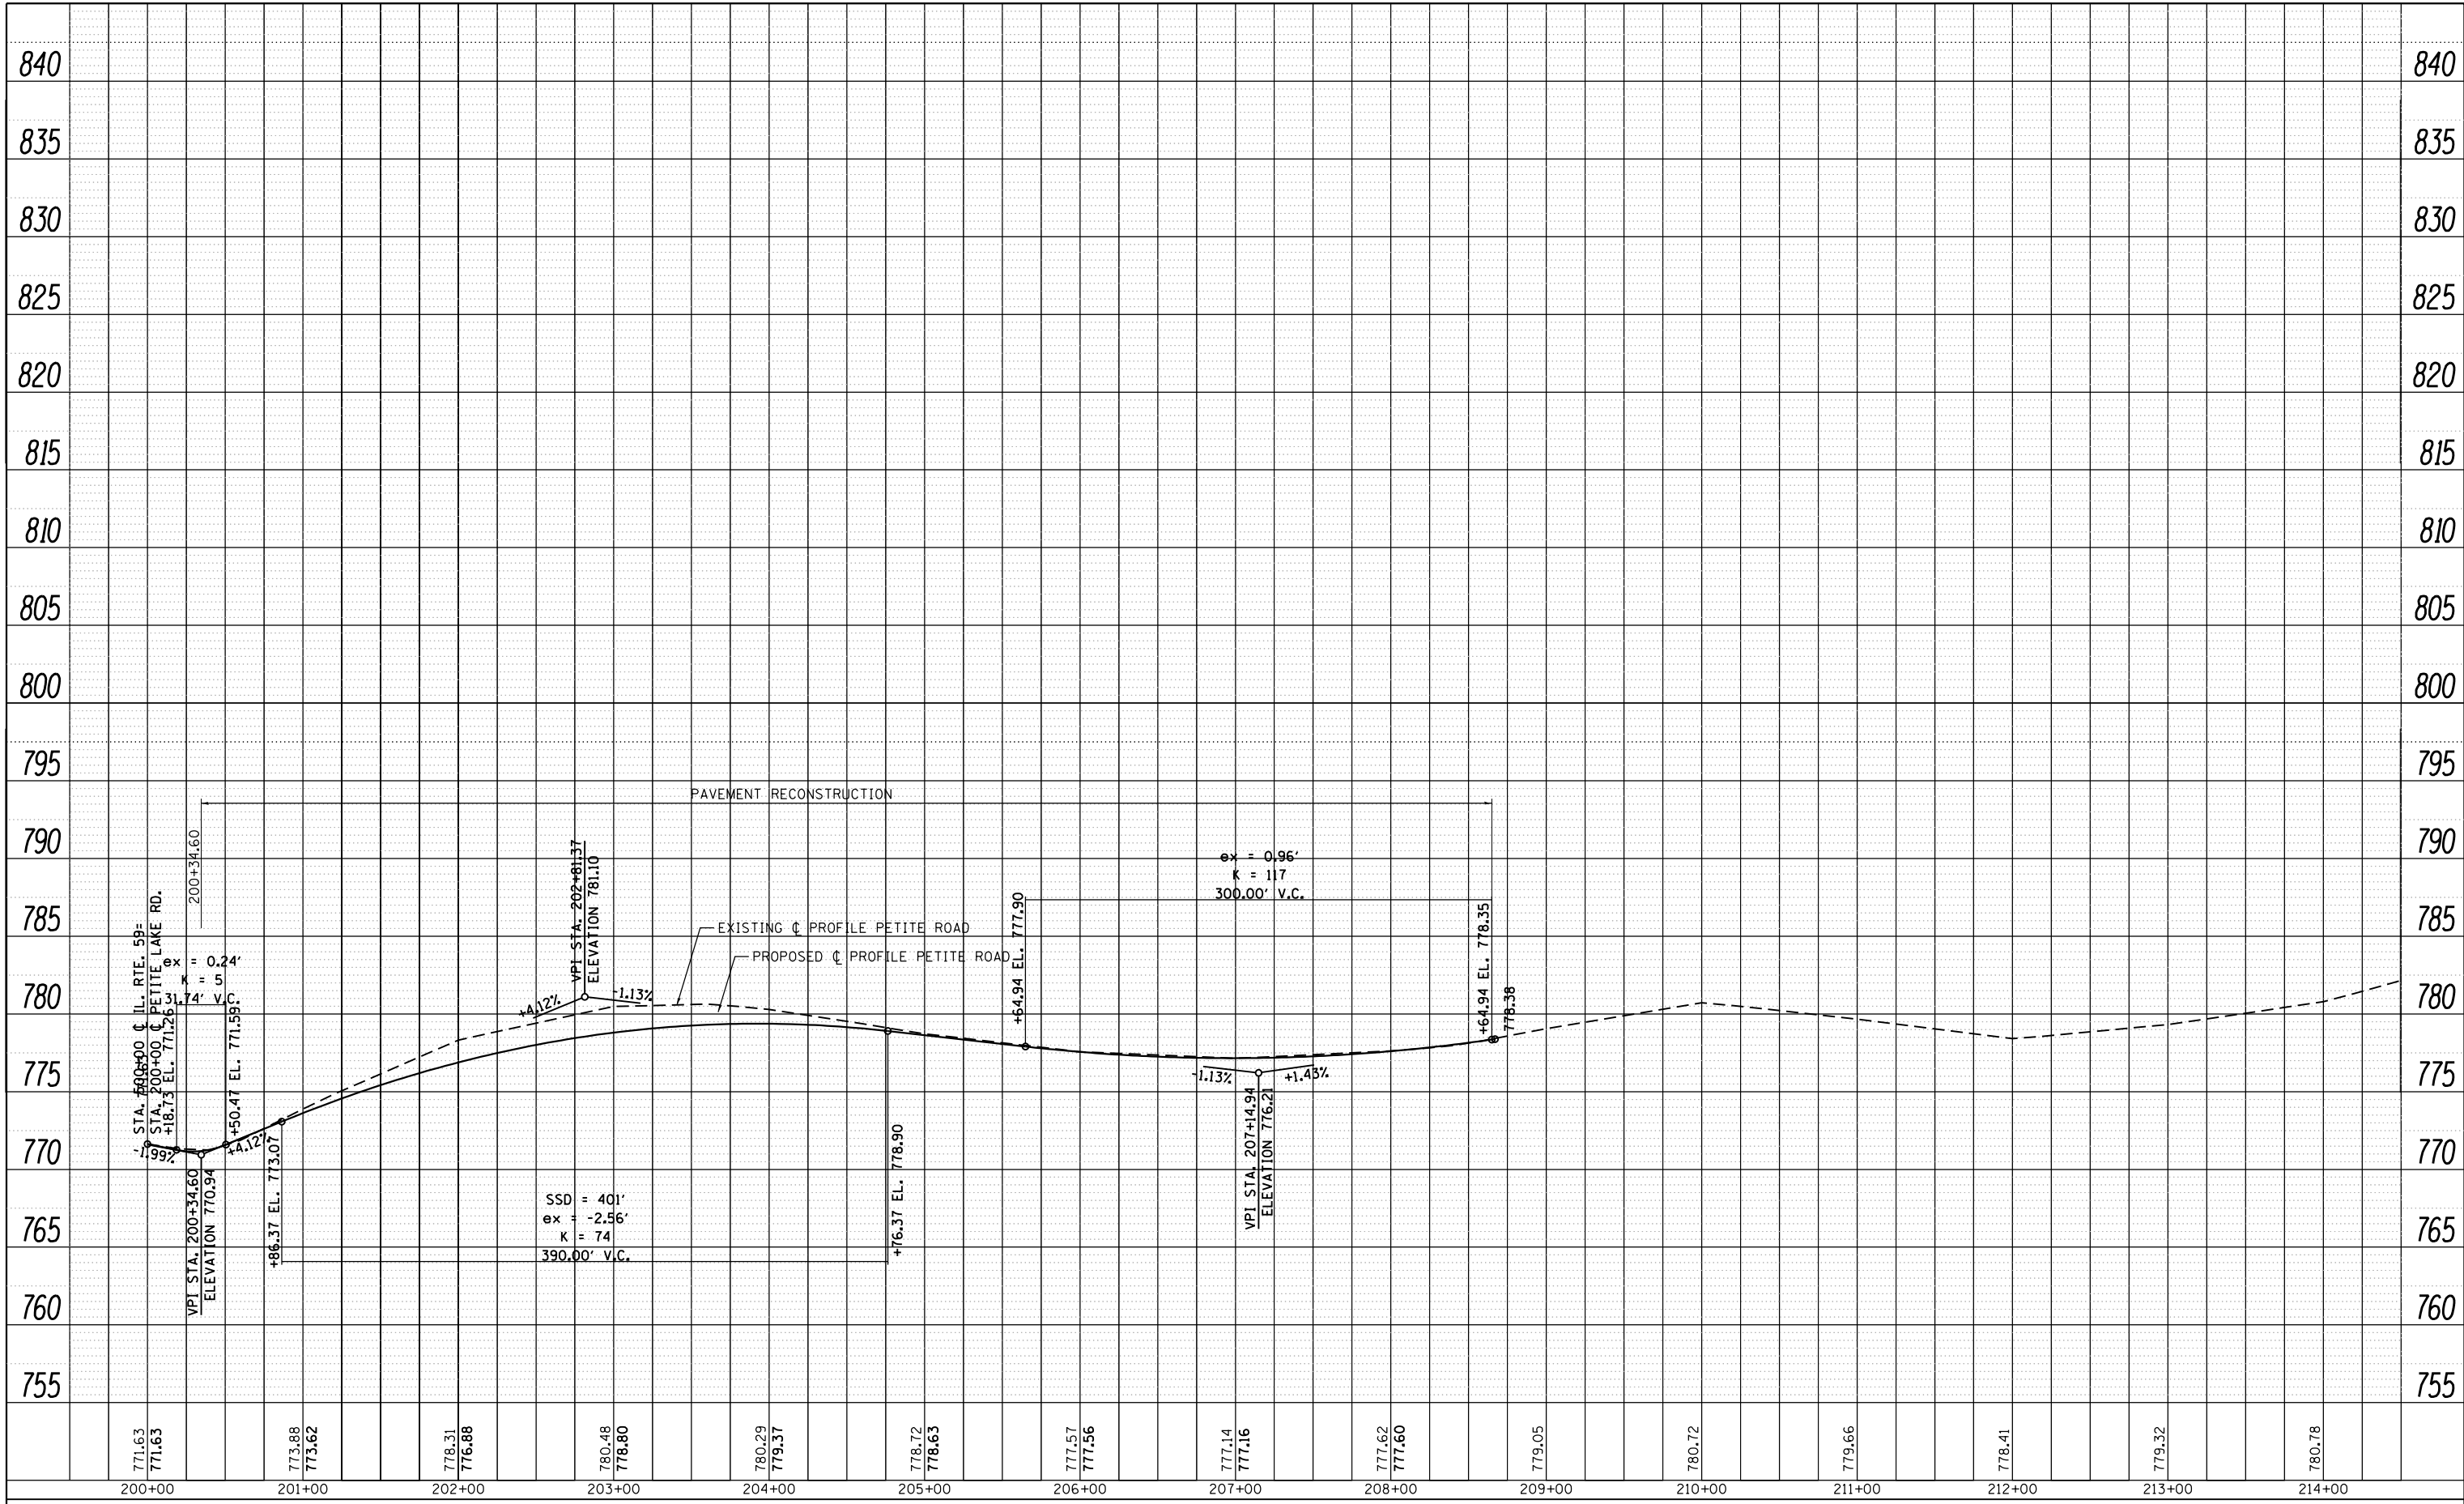
LEGEND	
	PAVEMENT REMOVAL
	DRIVEWAY PAVEMENT REMOVAL
	PAVED/AGG. SHLD. REMOVAL
	TREE REMOVAL

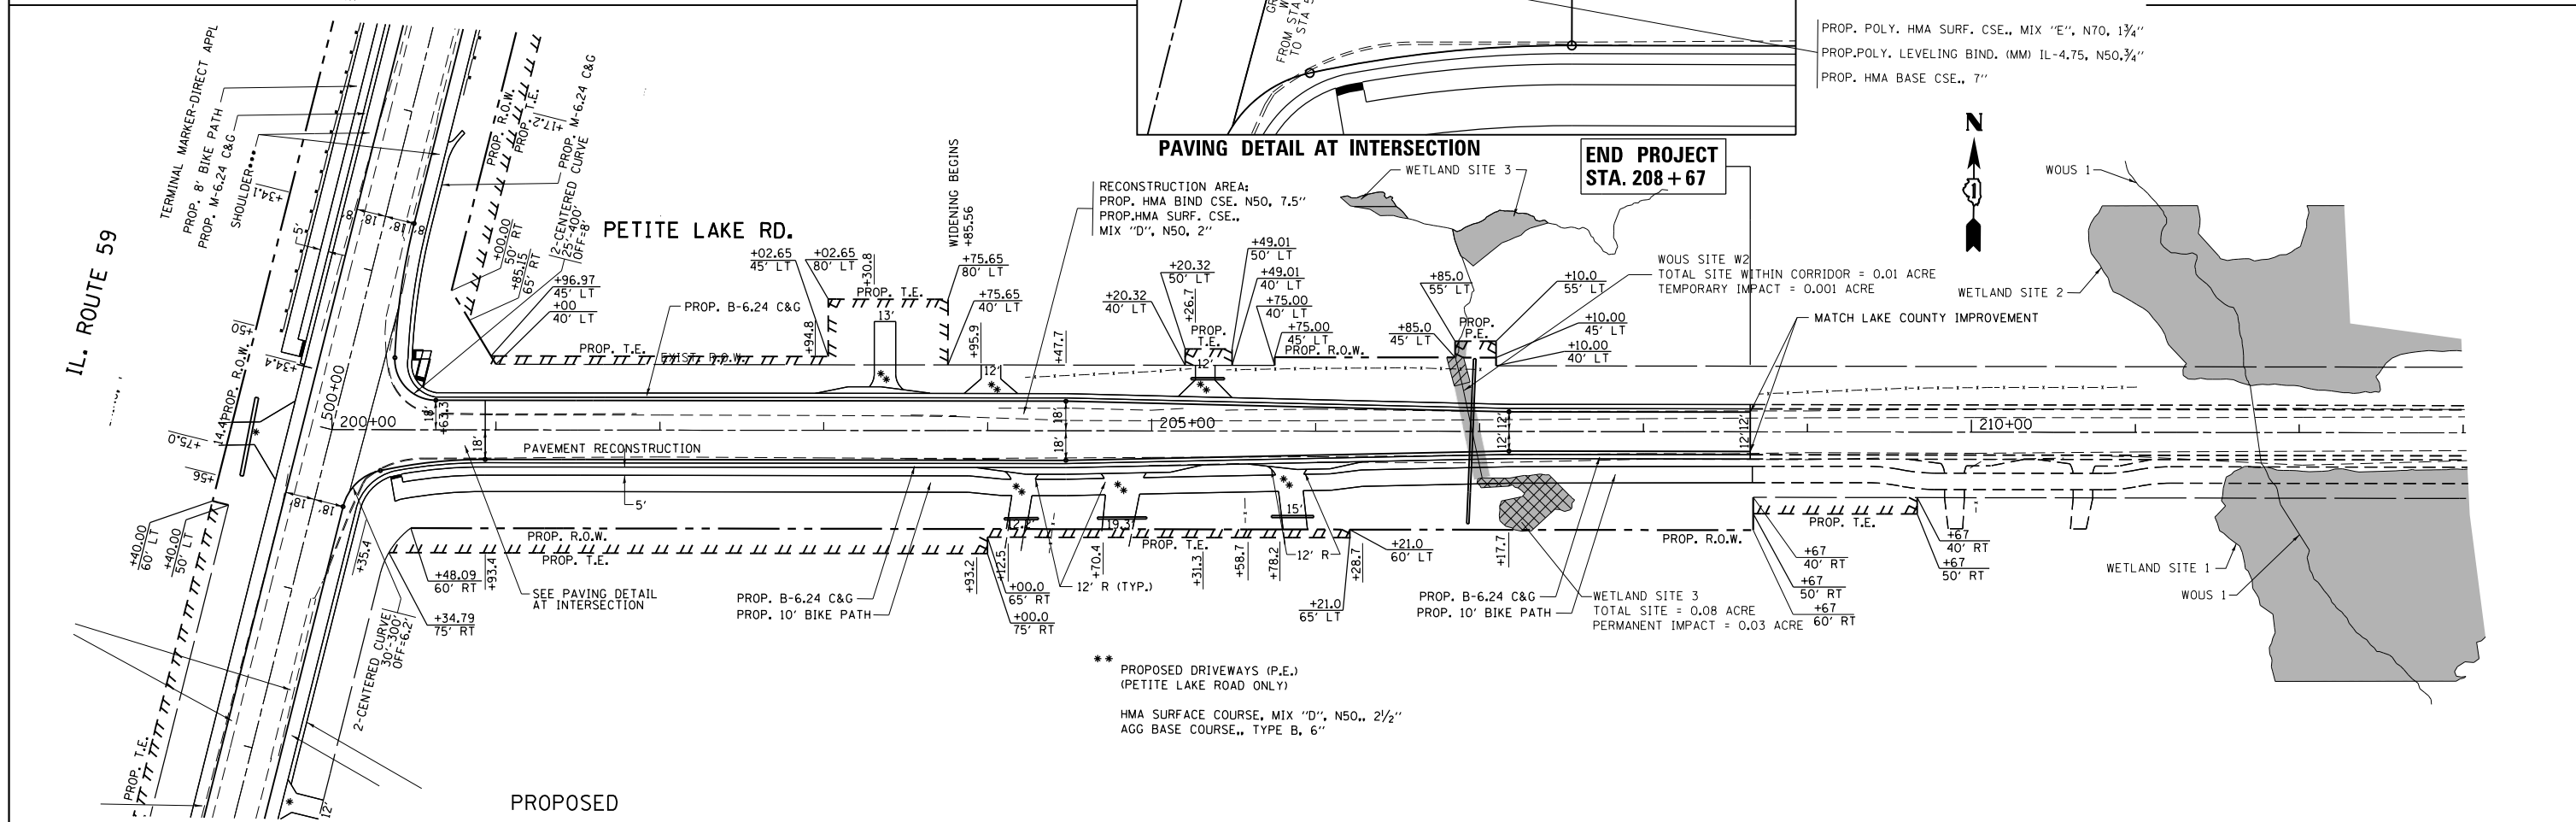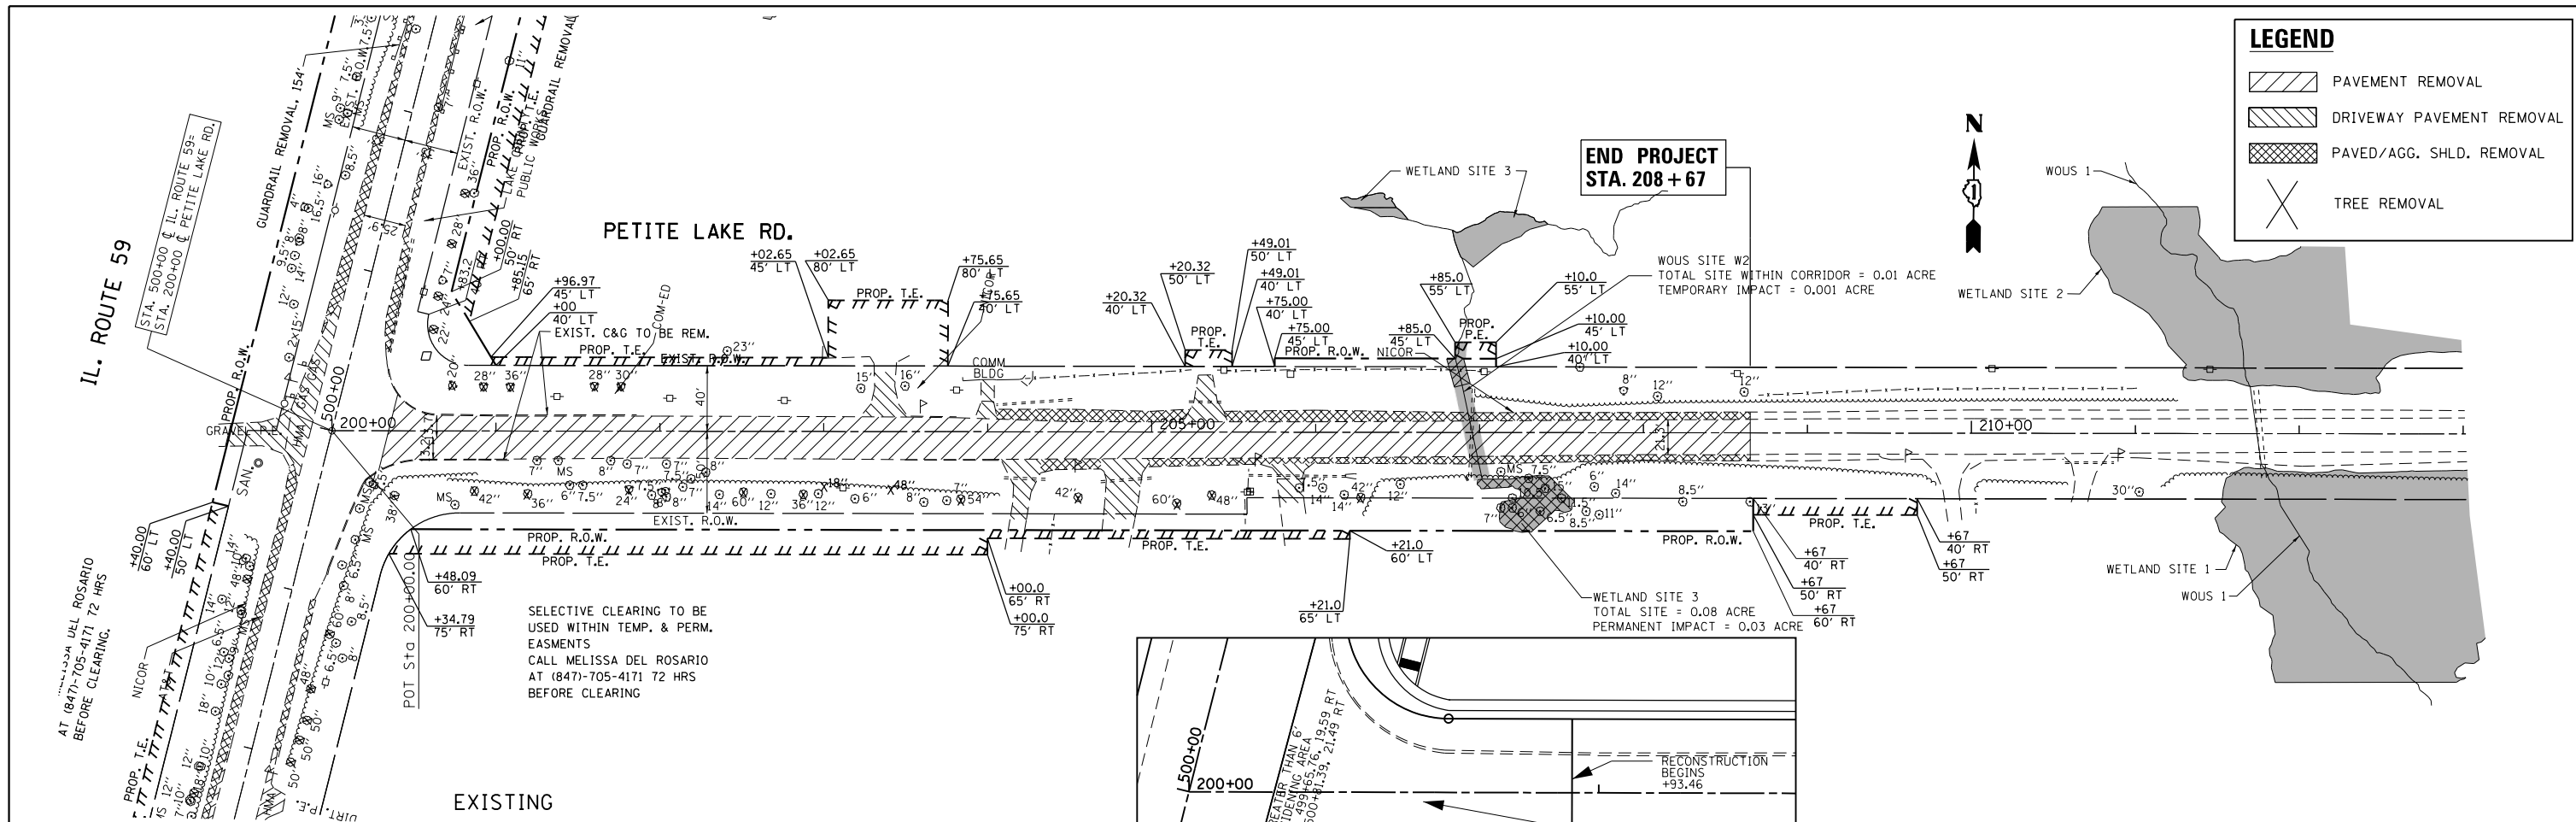

FILE NAME =	USER NAME = ledznm	DESIGNED -	REVISED -	<b>STATE OF ILLINOIS DEPARTMENT OF TRANSPORTATION</b>	<b>EXISTING AND PROPOSED ROADWAY PLAN IL. ROUTE 59 AT PETITE LAKE RD</b>	F.A.P. R.T.E.	SECTION	COUNTY	TOTAL SHEETS	SHEET NO.
pw:\IL\084EBIDINTEG\illinois.gov\PIWIDOT\Documents\DOT Offices\District 1\Projects\P145409\Design\P145409-shd-cover.dgn		CHECKED -	REVISED -			104	105N-4	LAKE	113	38
Default		DATE -	REVISED -			CONTRACT NO. 60W06				
						ILLINOIS FED. AID PROJECT				

PLAN	SURVEYED	DATE
	PLOTTED	
	ALIGNED	
	CHECKED	
	FILED	
NO.	CARD FILE NAME	

PROFILE	SURVEYED	DATE
	PLOTTED	
	GRADES CHECKED	
	STRUCTURE NOTATIONS CHECKED	
NO.	NOT AT THIS OFFICE	



FILE NAME =	USER NAME = ldezmarm	DESIGNED -	REVISED -	<b>STATE OF ILLINOIS</b> <b>DEPARTMENT OF TRANSPORTATION</b>	<b>EXISTING AND PROPOSED ROADWAY PROFILE</b> <b>IL. ROUTE 59 AT PETITE LAKE RD.</b>	F.A.P. RTE.	SECTION	COUNTY	TOTAL SHEETS	SHEET NO.
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Plot Date = 9/19/2016		DATE -	REVISIONS			ILLINOIS FED. AID PROJECT				


LEGEND:

EOS EDGE OF SHOULDER


EOP EDGE OF PAVEMENT

TC TOP OF CURB


TW TOP OF WALK

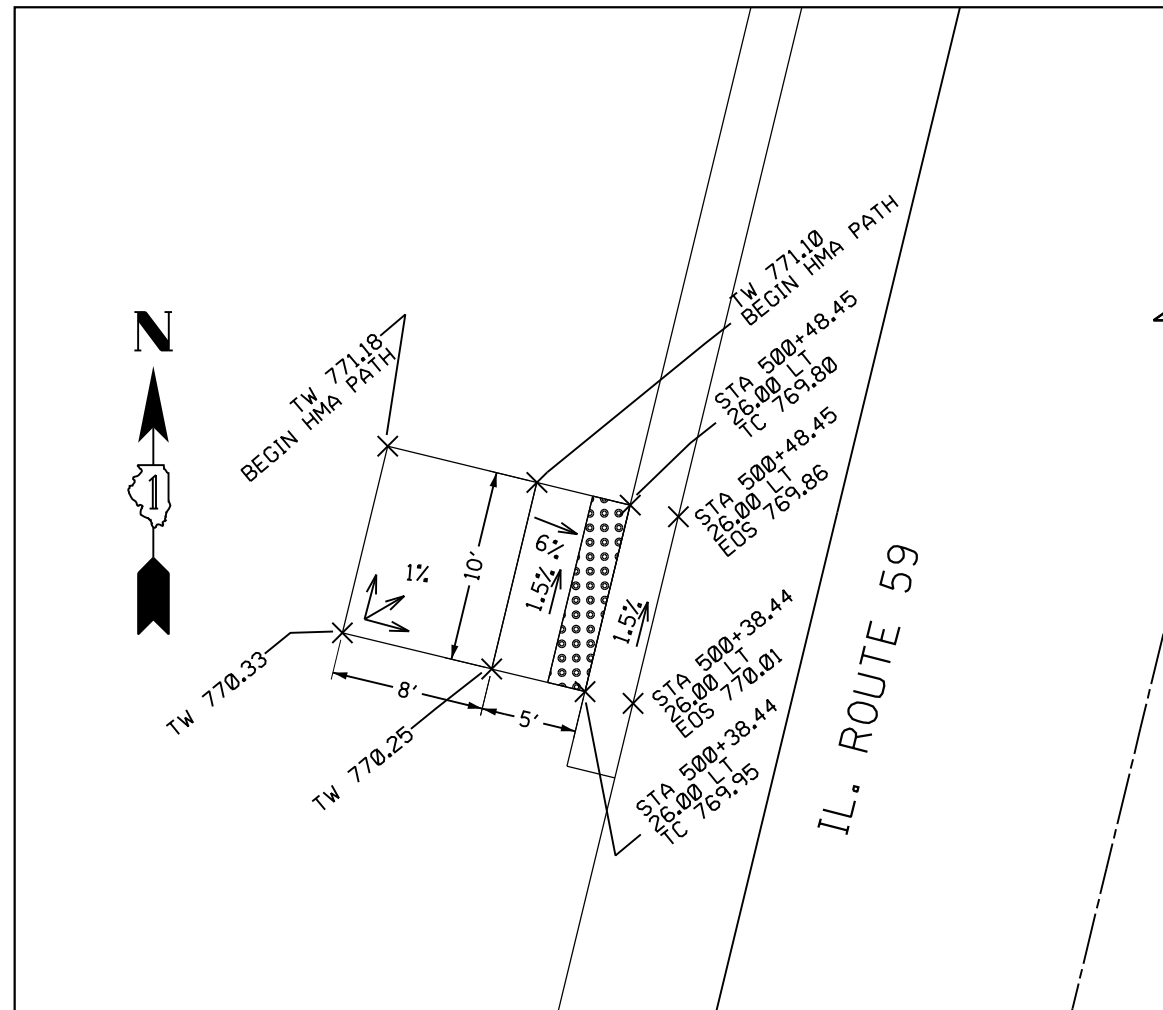


IL-59 AT PETITE LAKE RD  
NW CORNER

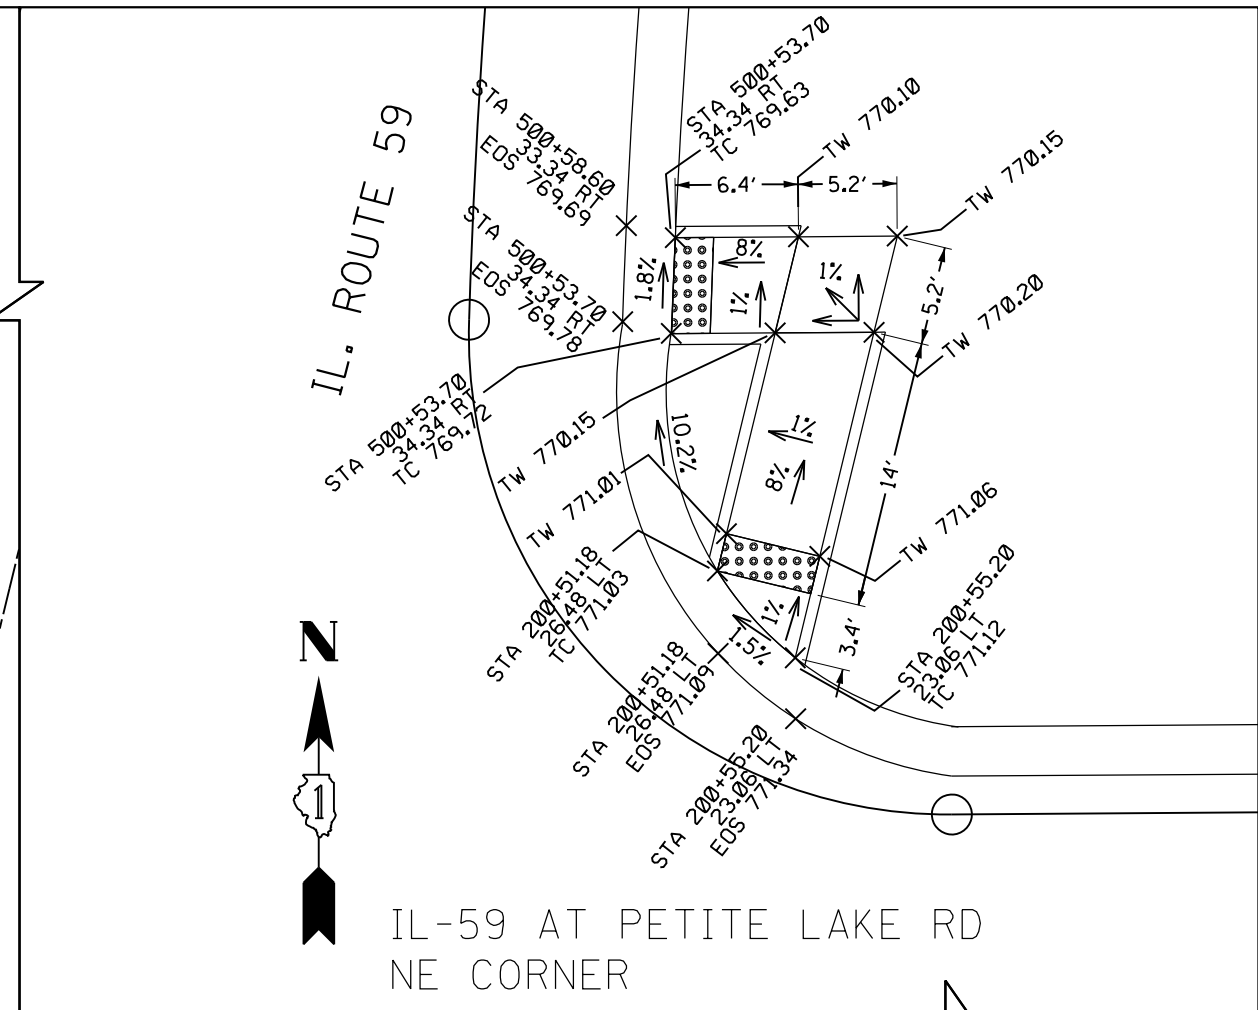

IL-59 AT PETITE LAKE RD  
NE CORNER

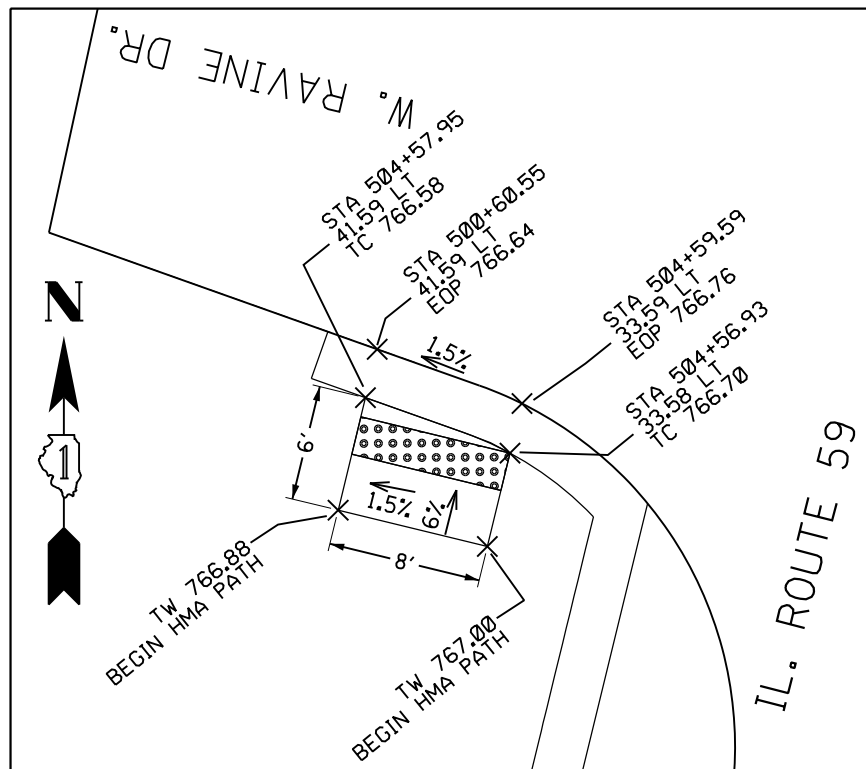

IL-59 AT W. RAVINE DR  
SW CORNER

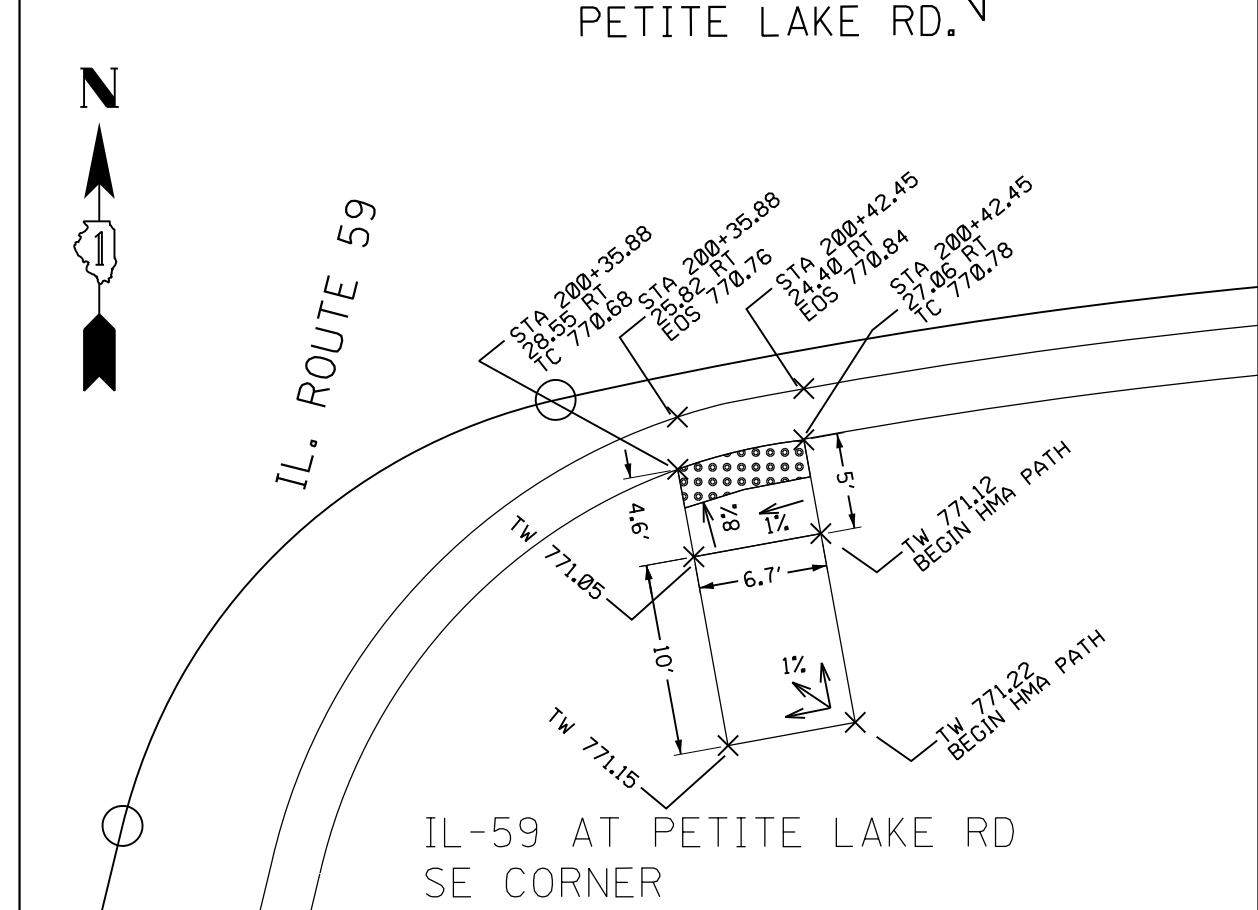


IL-59 AT PETITE LAKE RD  
SE CORNER

INTERSECTION GRADING PLAN  
IL. RTE. 59 (FOX LAKE RD.) AT PETITE LAKE ROAD

1" = 5'




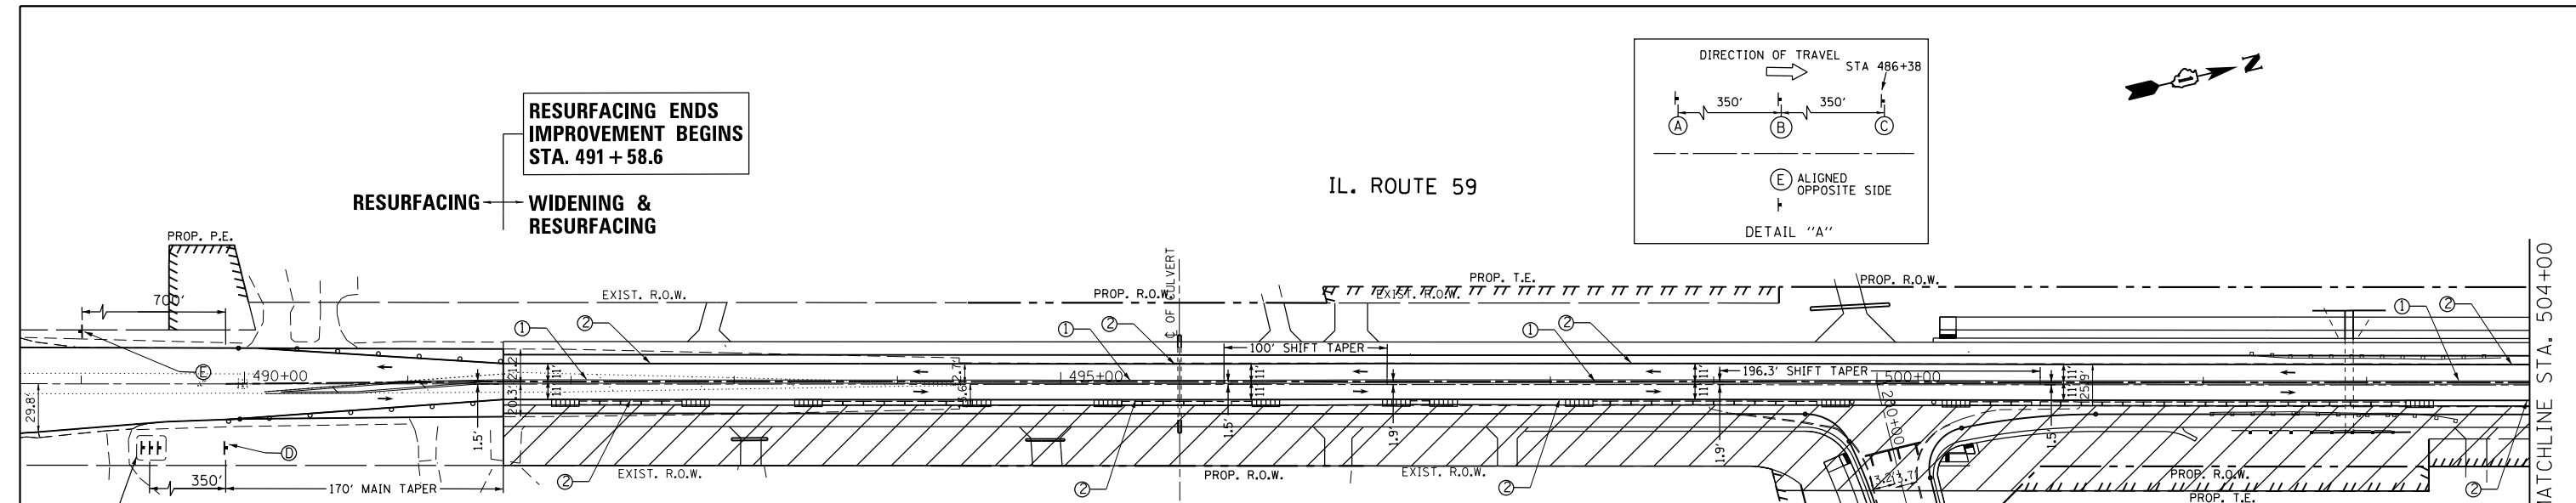

### SIGNS LEGEND


 W20-1103(0)-48 (A)	 R2-1-3648 (B)	 W1-4L(0)-48 (C)	 G20-1103 60" x 36" (E)
 W20-1103(0)-48 (A)	 R2-1-3648 (B)	 W1-4L(0)-48 (C)	 G20-1103 60" x 36" (E)

\* TO BE REMOVED WHEN WORKERS OR FLAGGERS ARE NOT PRESENT FOR AN HOUR OR MORE

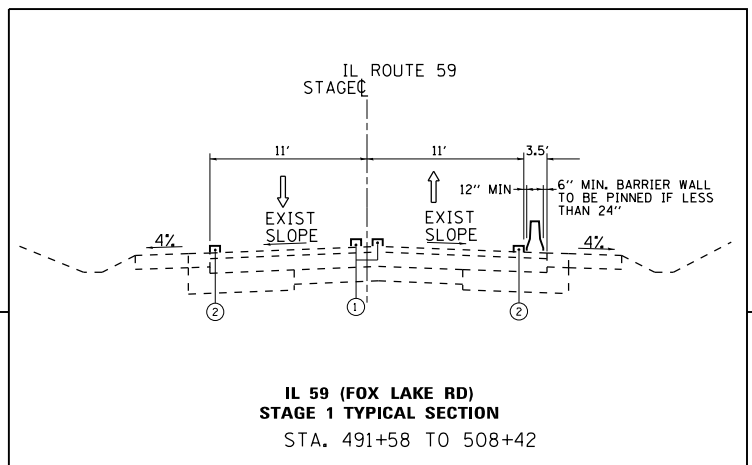




### TEMPORARY MARKINGS LEGEND

①	DOUBLE YELLOW, 4"
②	WHITE EDGE LINE, 4"

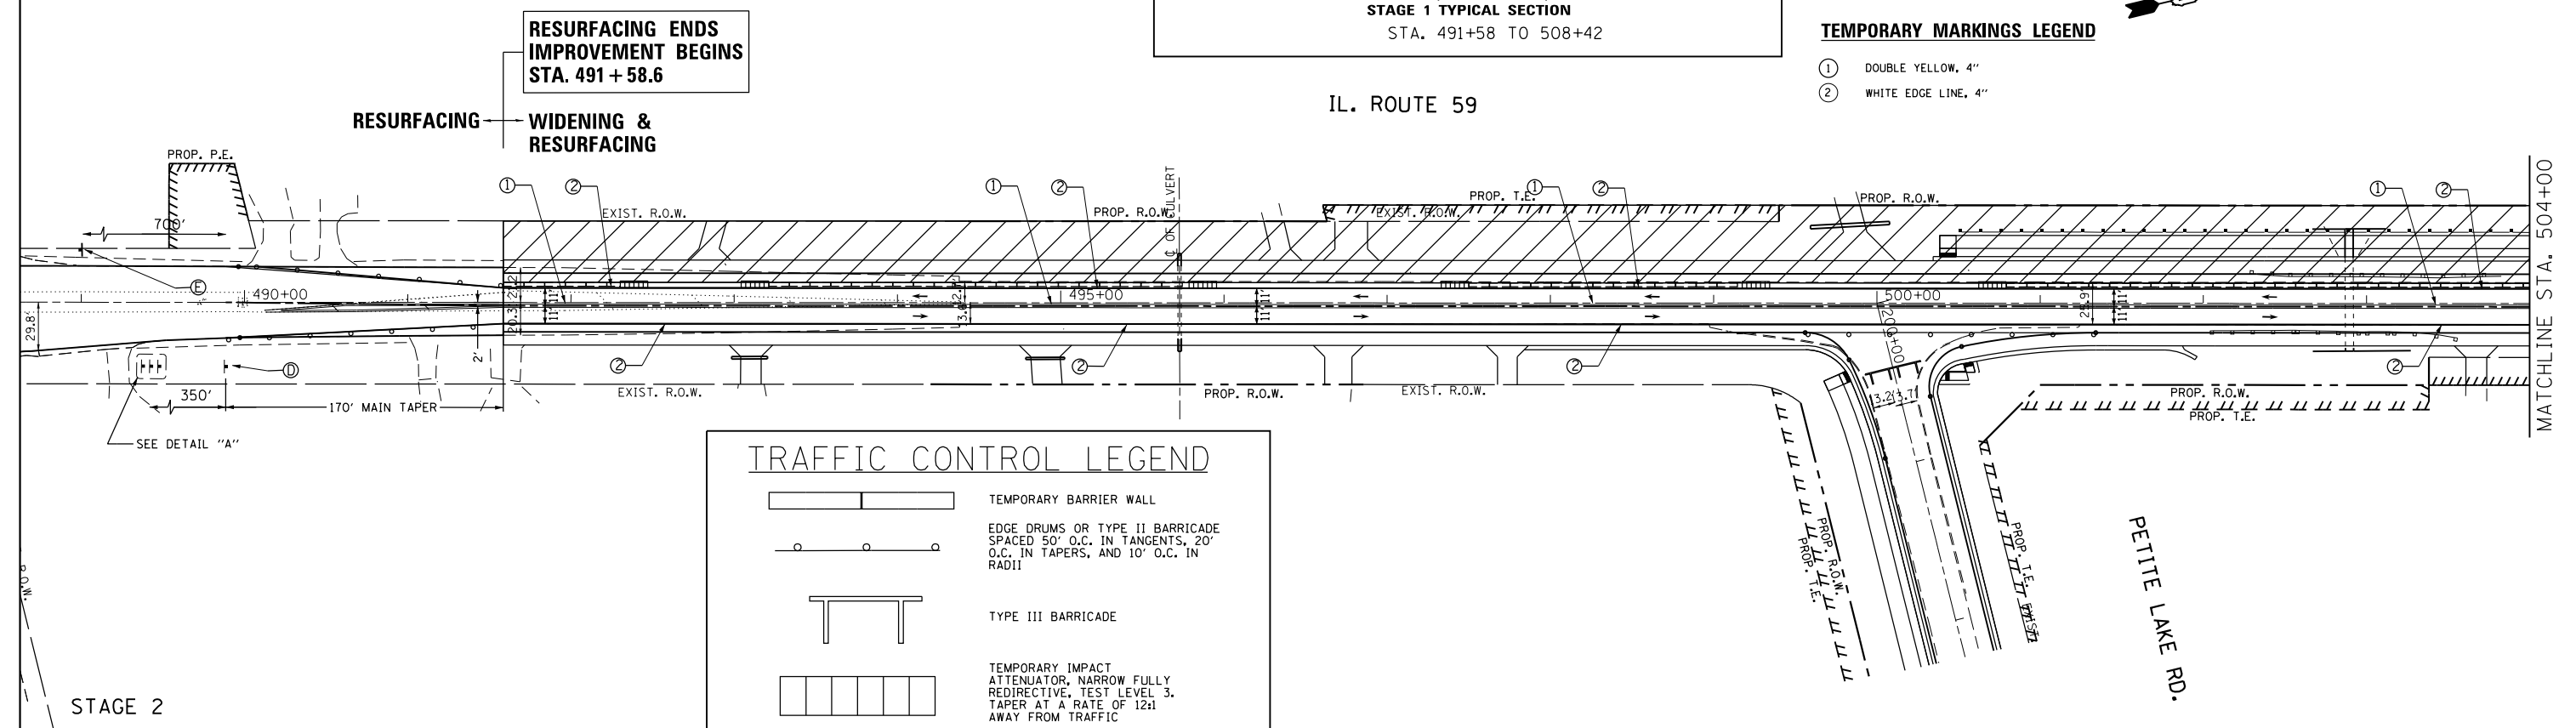

### TRAFFIC CONTROL LEGEND

	TEMPORARY BARRIER WALL
	EDGE DRUMS OR TYPE II BARRICADE SPACED 50' O.C. IN TANGENTS, 20' O.C. IN TAPERS, AND 10' O.C. IN RADII
	TYPE III BARRICADE
	TEMPORARY IMPACT ATTENUATOR, NARROW FULLY REDIRECTIVE, TEST LEVEL 3, TAPER AT A RATE OF 12:1 AWAY FROM TRAFFIC

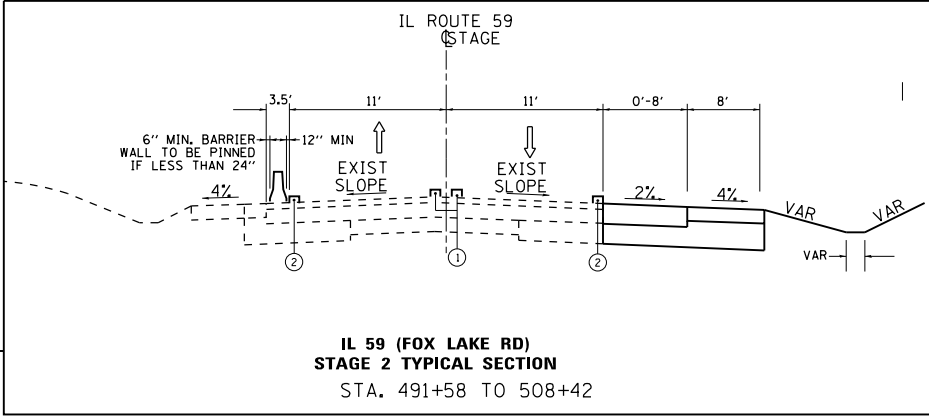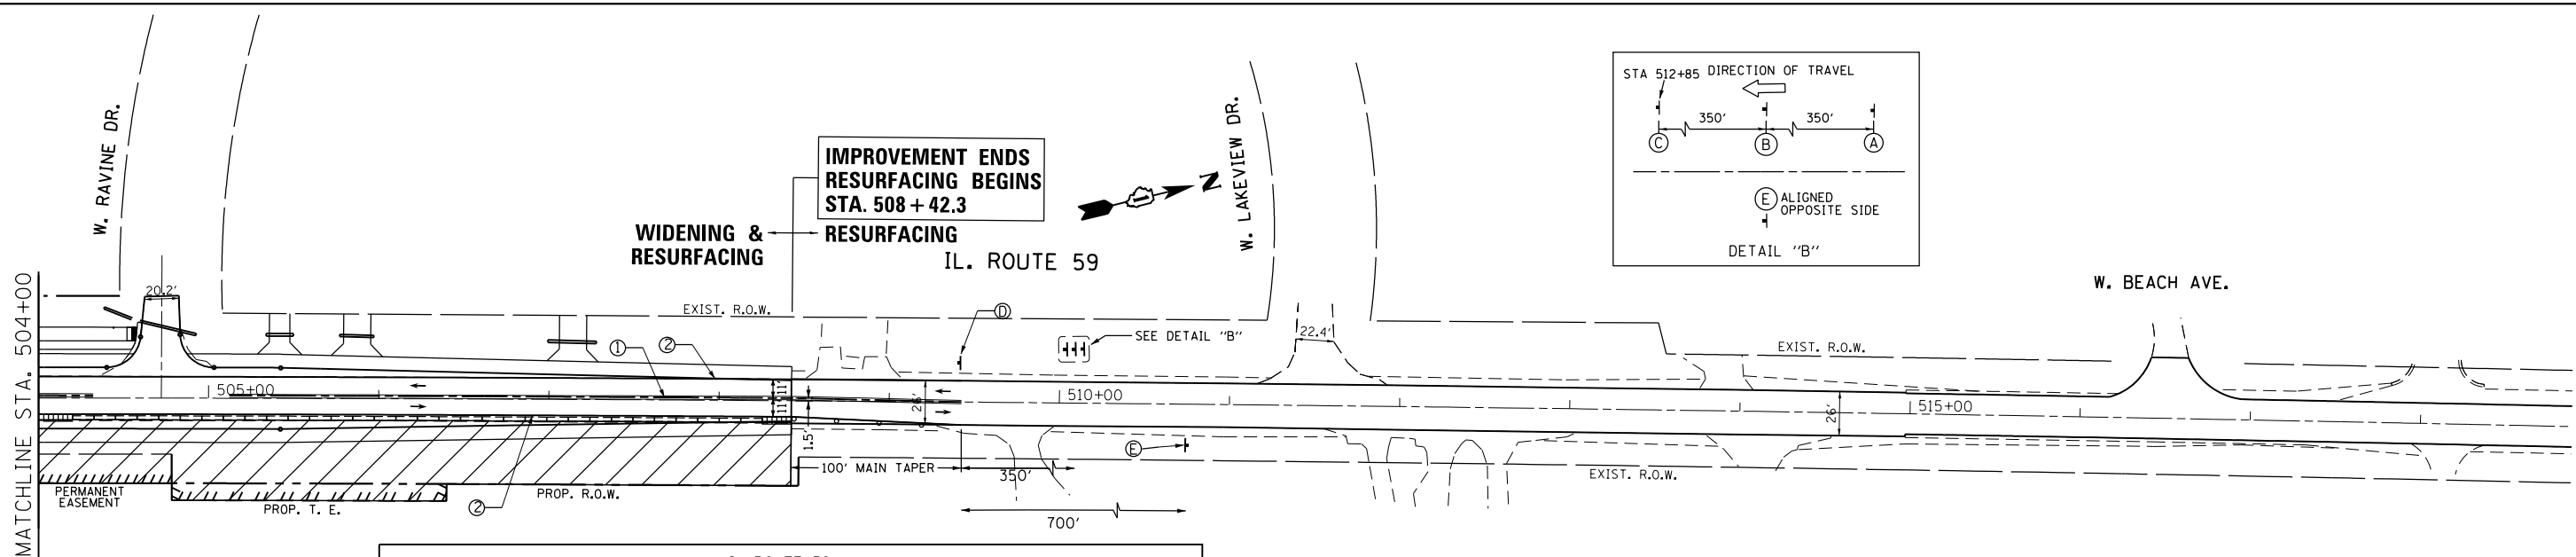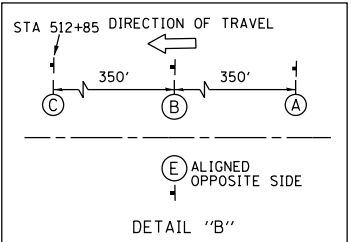


### SIGNS LEGEND

	ROAD CONSTRUCTION AHEAD W20-1103(O)-48 (A)		WORK ZONE SPEED LIMIT 45 R2-1-3648 PHOTO ENFORCED R10-1108p-3618 (US-6 ONLY) R2-1106p-3618 \$375 FINE MINIMUM (B)		W1-4L (O)-48 OR W1-4(O)-48 (C)		W21-1(O)-48 OR W20-7(O)-48 (D)		END WORK ZONE SPEED LIMIT G20-1103 60"x36" (E)
--	---	--	---	--	--------------------------------	--	--------------------------------	--	---

\* TO BE REMOVED WHEN WORKERS OR FLAGGERS ARE NOT PRESENT FOR AN HOUR OR MORE

**TEMPORARY MARKINGS LEGEND**

- ① DOUBLE YELLOW, 4"
- ② WHITE EDGE LINE, 4"

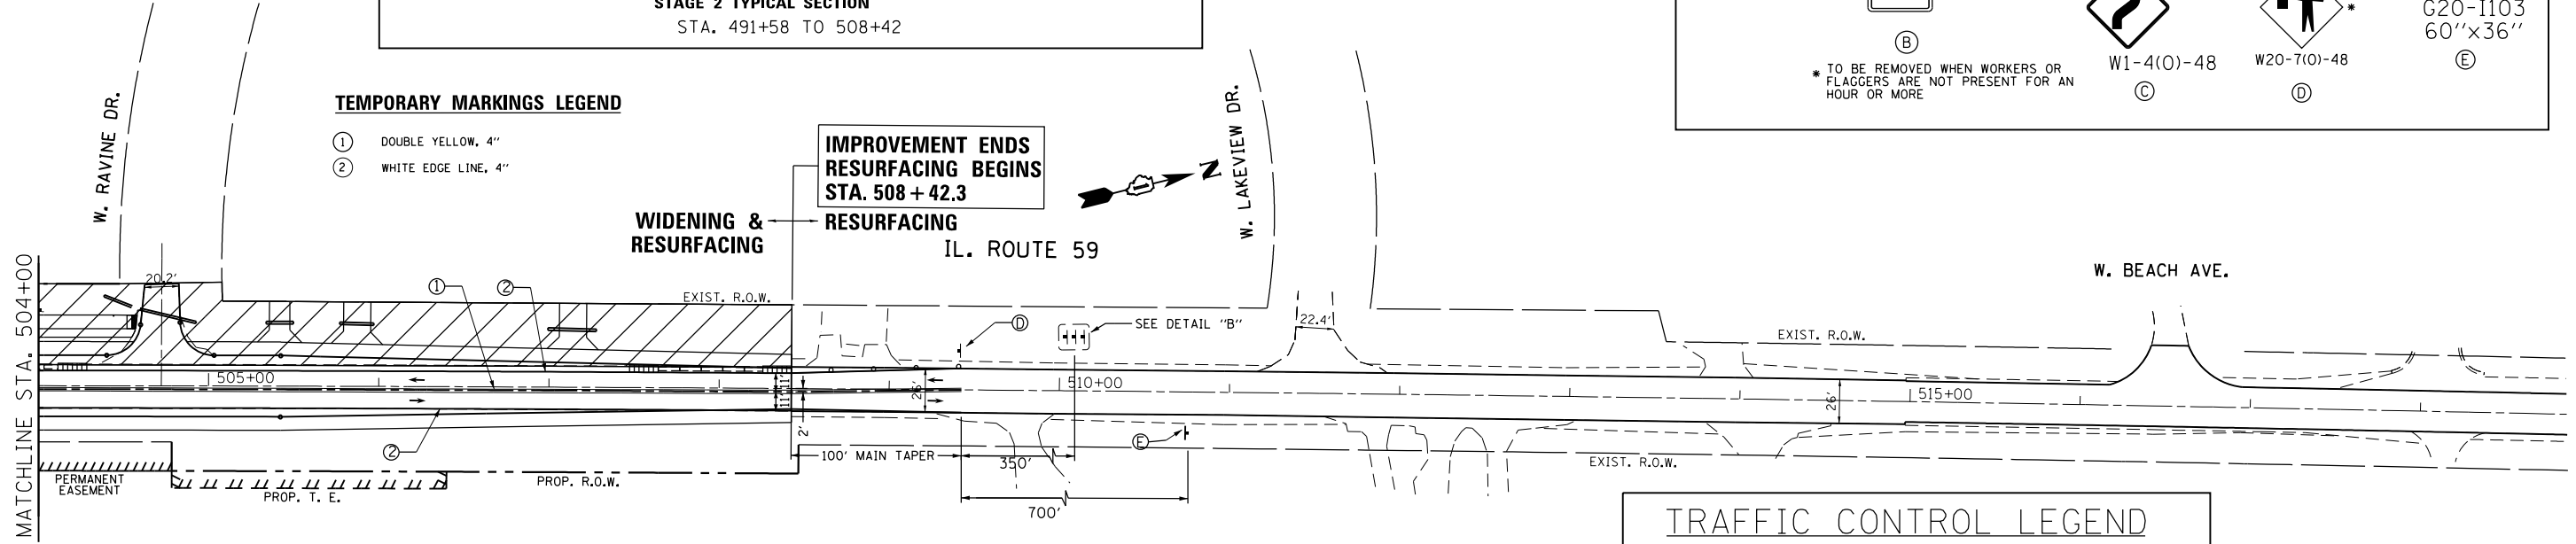

### TRAFFIC CONTROL LEGEND

	TEMPORARY BARRIER WALL
	EDGE DRUMS OR TYPE II BARRICADE SPACED 50' O.C. IN TANGENTS, 20' O.C. IN TAPERS, AND 10' O.C. IN RADIUS
	TYPE III BARRICADE
	TEMPORARY IMPACT ATTENUATOR, NARROW FULLY REDIRECTIVE, TEST LEVEL 3, TAPER AT A RATE OF 12:1 AWAY FROM TRAFFIC

FILE NAME =	USER NAME = ldezma	DESIGNED -	REVISED -
pw:\IL\084EBIDINTEG\illinois.gov\PWIDOT\Documents\DOT Offices\District 1\Projects\P14540\Drawings\Design\P145409-shr-cover.dgn		CHECKED -	REVISED -
Default	PLOT DATE = 9/19/2016	DATE -	REVISED -

STATE OF ILLINOIS  
 DEPARTMENT OF TRANSPORTATION

**SUGGESTED STAGING PLAN**  
 IL. ROUTE 59 AT PETITE LAKE RD


SCALE: 1"=50'	SHEET	OF	SHEETS	STA.	TO	STA.
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F.A.P. RTE.	SECTION	COUNTY	TOTAL SHEETS	SHEET NO.
104	105N-4	LAKE	113	42
CONTRACT NO. 60W06				
ILLINOIS FED. AID PROJECT				

EROSION CONTROL GENERAL NOTES


1. TEMPORARY EROSION CONTROL SEEDING TO BE PROVIDED AT ALL ERODIBLE BARE EARTH AREAS.
2. THE CONTRACTOR SHALL PROVIDE AND MAINTAIN INLET PROTECTION AT ALL DRAINAGE STRUCTURES AND AT OTHER LOCATIONS DIRECTED BY THE ENGINEER OR SHOWN ON THE PLANS. INLET PROTECTION SHALL BE PLACED IMMEDIATELY AFTER THE AREA HAS BEEN DISTURBED.
3. ALL EROSION CONTROL MEASURES SHALL BE IN ACCORDANCE WITH THE REQUIREMENTS OF THE STANDARD SPECIFICATIONS AND OF THE APPLICABLE STATE STANDARDS FOR THE ENTIRE DURATION OF THE CONTRACT OR UNTIL SUCH TIME AS DIRECTED BY THE ENGINEER.
4. PERIMETER EROSION CONTROL BARRIER SHALL BE PLACED 12 INCHES FROM THE R.O.W. OR EASEMENT OR AS DIRECTED BY THE ENGINEER.
5. AT ANY AREA WHERE THERE IS NO PROPOSED GRADING THE EXISTING GROUND COVER SHALL REMAIN.
6. DURING CONSTRUCTION AND WHEN ERODIBLE SOILS ARE EXPOSED, ALL DRAINAGE STRUCTURES NOT PROTECTED WITH INLET OR PIPE PROTECTION SHALL BE KEPT SEALED TO PREVENT ACCESS FROM EROSION. THIS WORK SHALL BE CONSTRUCTED AS PART OF THE COST OF VARIOUS DRAINAGE STRUCTURES.
7. THE CONTRACTOR WILL ASSUME RESPONSIBILITY FOR MAINTENANCE OF ALL SOIL EROSION CONTROL DURING CONSTRUCTION.
8. THE CONTRACTOR SHALL CHECK ALL ESC MEASURES WEEKLY AND AFTER EACH RAINFALL, 0.5 INCHES OR GREATER IN A 24 HOUR PERIOD, OR EQUIVALENT SNOWFALL. ADDITIONALLY DURING WINTER MONTHS, ALL MEASURES SHOULD BE CHECKED BY THE CONTRACTOR AFTER EACH SIGNIFICANT SNOWMELT
9. THE CONTRACTOR SHALL CHECK ALL ESC MEASURES WEEKLY AND AFTER EACH RAINFALL, 0.5 INCHES OR GREATER IN A 24 HOUR PERIOD, OR EQUIVALENT SNOWFALL. ADDITIONALLY DURING WINTER MONTHS, ALL MEASURES SHOULD BE CHECKED BY THE CONTRACTOR AFTER EACH SIGNIFICANT SNOWMELT
10. THE CONTRACTOR SHOULD PROVIDE TO THE RE A PLAN TO ENSURE THAT A STABILIZED FLOW LINE WILL BE PROVIDED DURING STORM SEWER CONSTRUCTION. THE USE OF A STABILIZED FLOW LINE BETWEEN INSTALLED STORM SEWER AND OPEN DISTURBANCE WILL REDUCE THE POTENTIAL FOR THE OFFSITE DISCHARGE OF SEDIMENT-BEARING WATERS, ESPECIALLY WHEN RAIN IS FORECASTED, SO THAT FLOW WILL NOT ERODE. LACK OF APPROVED PLAN OR FAILURE TO COMPLY WILL RESULT IN AN ESC DEFICIENCY DEDUCTION.
11. ANY LOOSE MATERIAL DEPOSITED IN THE FLOW LINE OF DRAINAGE STRUCTURES, WHICH OBSTRUCTS THE NATURAL FLOW OF WATER, SHALL BE REMOVED AT THE CLOSE OF EACH WORKING DAY. PRIOR TO ACCEPTANCE OF THE IMPROVEMENT, ALL DRAINAGE STRUCTURES SHALL BE FREE OF DIRT AND DEBRIS. THIS WORK WILL NOT BE PAID FOR SEPARATELY BUT SHALL BE CONSIDERED AS INCIDENTAL.
12. TEMPORARY OR PERMANENT STABILIZATION SHALL BE INITIATED IMMEDIATELY UPON COMPLETION OF DISTURBANCE OR IF THE WORK AREA IS TO BE LEFT UNDISTURBED FOR 14 DAYS OR MORE
13. UNDER NO CIRCUMSTANCES SHALL THE CONTRACTOR PROLONG FINAL GRADING AND SHAPING SO THAT THE ENTIRE PROJECT CAN BE PERMANENTLY SEEDED AT ONE TIME.
14. EROSION CONTROL ITEMS ARE CONSIDERED TO BE A HIGH PRIORITY ON THIS CONTRACT. THE CONTRACTOR IS RESPONSIBLE FOR INSTALLATION OF ANY ADDITIONAL EROSION CONTROL MEASURES NECESSARY TO PREVENT EROSION AND SEDIMENTATION AS DETERMINED BY THE RE.
15. THIS PROJECT REQUIRES A US ARMY CORPS OF ENGINEERS (USACE) 404 PERMIT THAT WILL BE SECURED BY THE DEPARTMENT. ALL CONDITIONS OF THE 404 PERMIT, FOUND IN THE SPECIAL PROVISIONS, MUST BE FOLLOWED. AS A CONDITION OF THIS PERMIT, THE CONTRACTOR WILL NEED TO SUBMIT AN IN-STREAM WORK PLAN (INCLUDING WORK WITHIN WETLANDS) TO THE DEPARTMENT FOR APPROVAL. GUIDELINES ON ACCEPTABLE IN-STREAM WORK TECHNIQUES (INCLUDING WORK WITHIN WETLANDS) CAN BE FOUND ON THE USACE WEBSITE. THE USACE DEFINES AND DETERMINES IN-STREAM WORK. THE COST OF ALL MATERIALS AND LABOR NECESSARY TO COMPLY WITH THE ABOVE PROVISIONS TO PREPARE AND IMPLEMENT AN IN-STREAM WORK PLAN (INCLUDING WORK WITHIN WETLANDS) WILL NOT BE PAID FOR SEPARATELY, BUT SHALL BE CONSIDERED AS INCLUDED IN THE UNIT BID PRICES OF THE CONTRACT AND NO ADDITIONAL COMPENSATION WILL BE ALLOWED.
16. "WETLANDS NO INTRUSION" SIGNAGE SHOULD ALSO BE PROVIDED AT THE BOUNDARY OF ALL UN-IMPACTED WETLANDS AND/OR WOUS. THE CONTRACTOR CAN BORROW THE SIGNS FROM THE BUREAU OF MAINTENANCE. INCLUDE TEMPORARY FENCING AND WETLAND SIGNAGE WITHIN THE EROSION AND SEDIMENT CONTROL STRATEGY.

FILE NAME =	USER NAME = ldezmarm	DESIGNED -	REVISED -	<b>STATE OF ILLINOIS DEPARTMENT OF TRANSPORTATION</b>	<b>EROSION CONTROL PLAN IL. ROUTE 59 AT PETITE LAKE RD</b>			F.A.P. RTE.	SECTION	COUNTY	TOTAL SHEETS	SHEET NO.
p:\11\084EBID\INTEG.illinois.gov\PI\DOT\Documents\DOT Offices\District 1\Projects\P145409\Drawings\Design\P145409-shr-cover.dgn		REVISED -	REVISED -		104	105N-4	LAKE	113	43			
Default	PLOT SCALE = 100.0000' / 1in.	CHECKED -	REVISED -		CONTRACT NO. 60W06			ILLINOIS FED. AID PROJECT				
	PLOT DATE = 8/19/2016	DATE -	REVISED -		SCALE: 1"=50'	SHEET	OF	SHEETS	STA.	TO	STA.	

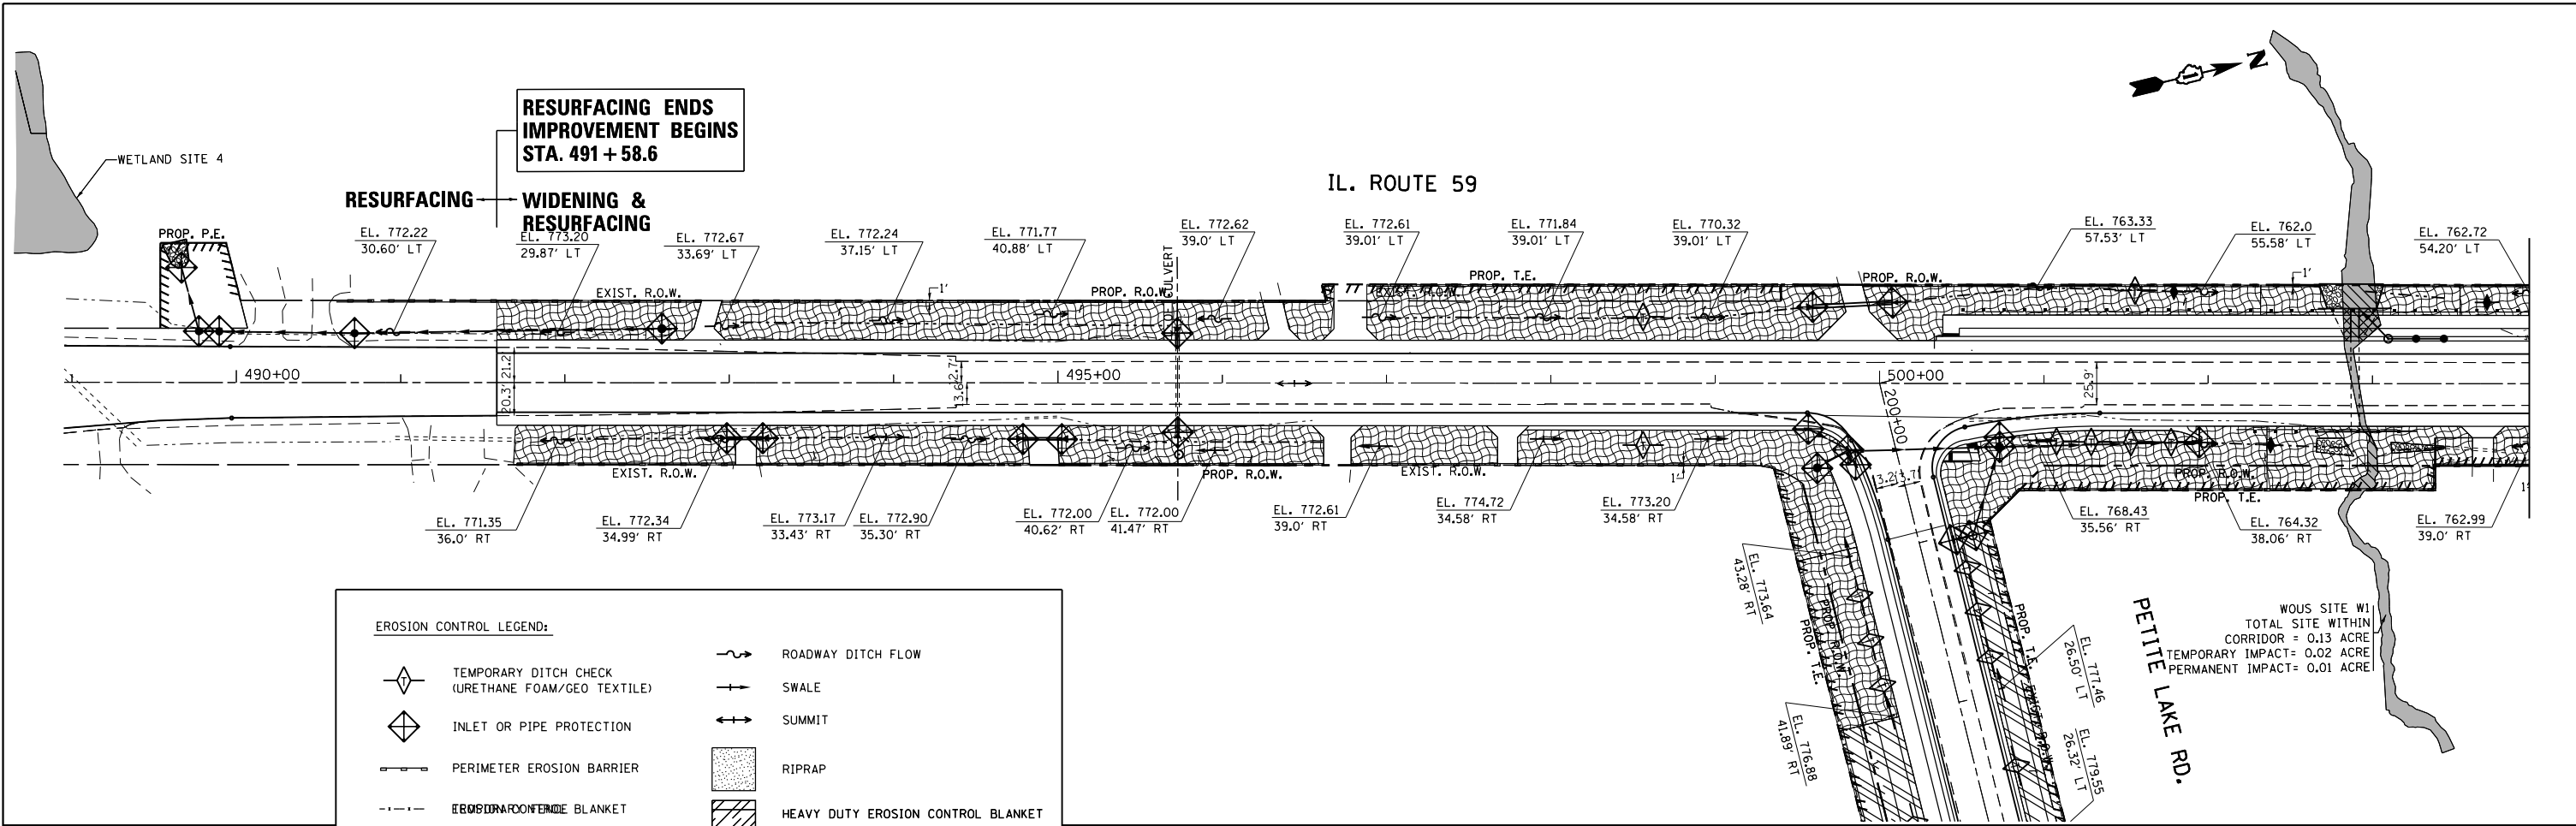


**EROSION CONTROL LEGEND:**

	TEMPORARY DITCH CHECK (URETHANE FOAM/GEO TEXTILE)		ROADWAY DITCH FLOW
	INLET OR PIPE PROTECTION		SWALE
	PERIMETER EROSION BARRIER		SUMMIT
	EROSION CONTROL BLANKET		RIPRAP
	EROSION CONTROL BLANKET		HEAVY DUTY EROSION CONTROL BLANKET

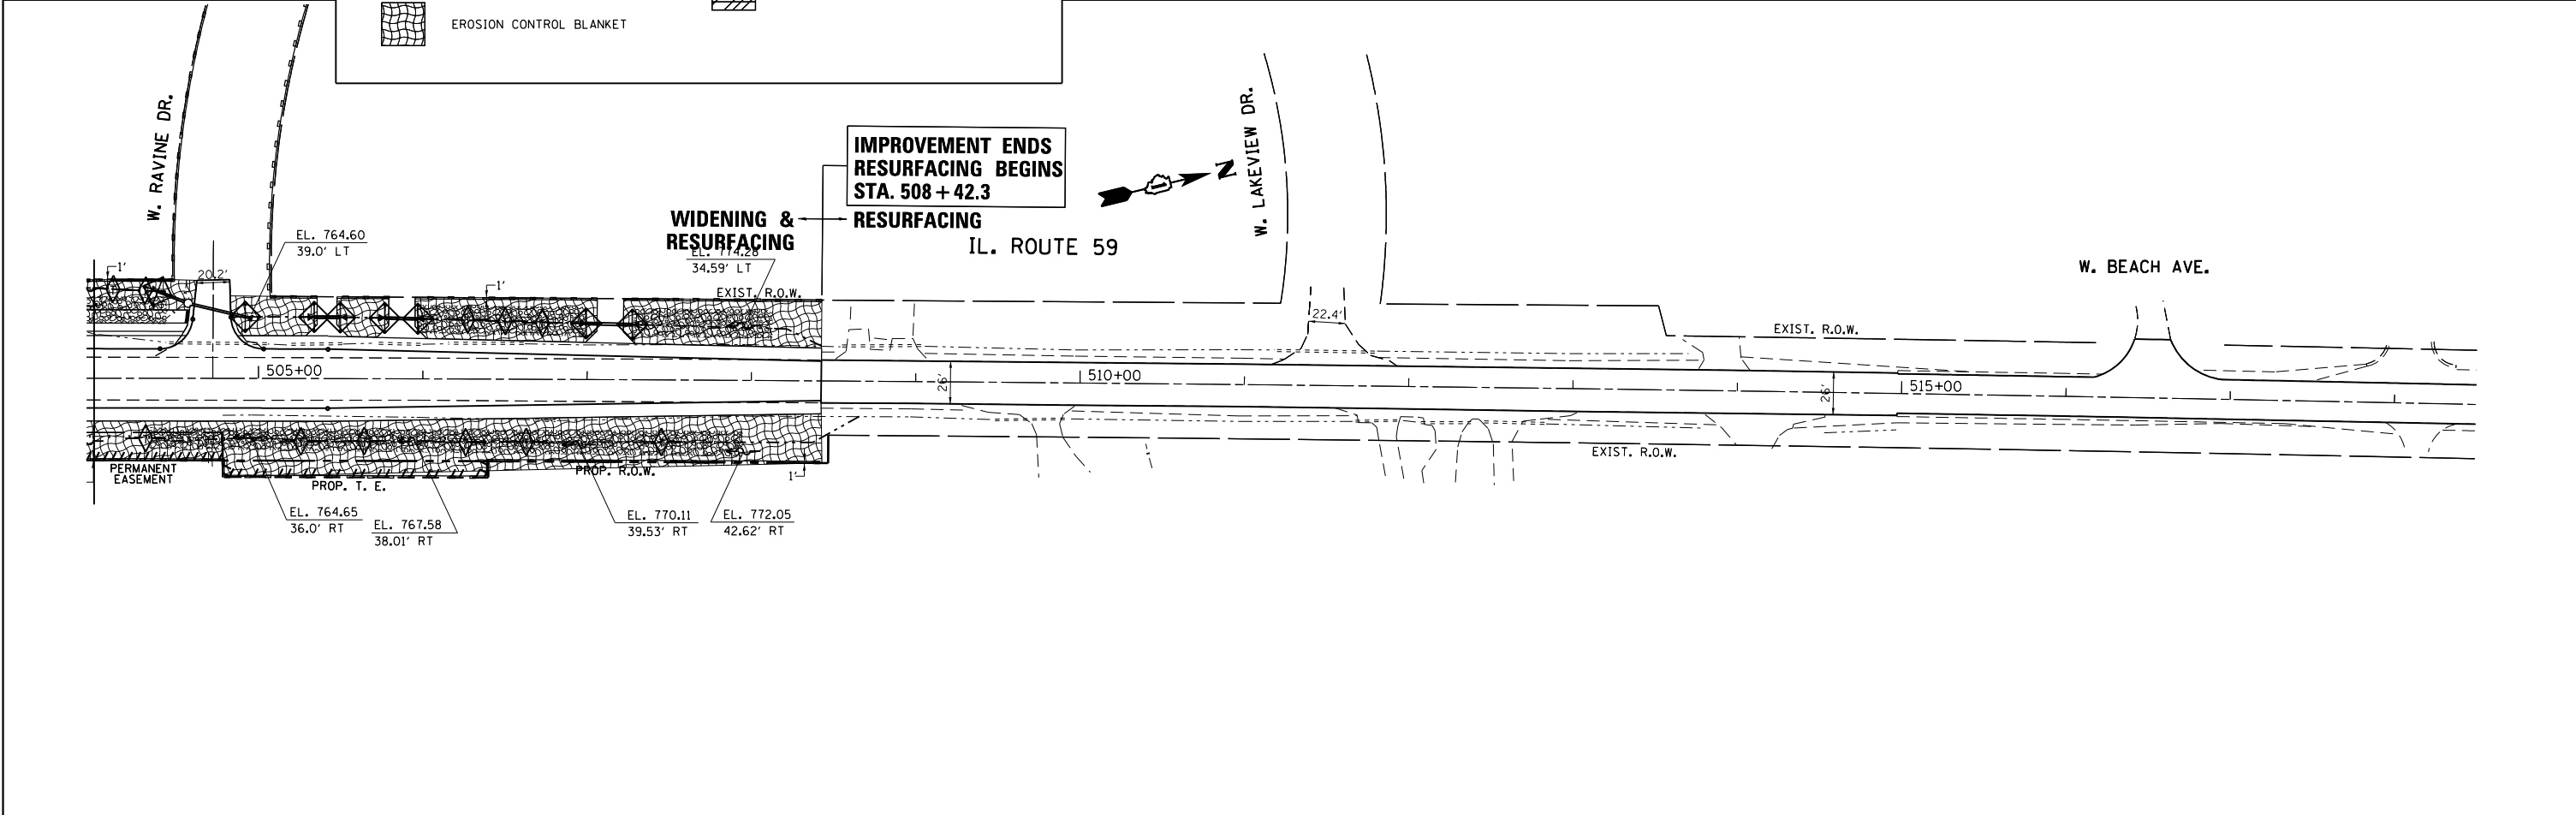

FILE NAME =	USER NAME = ldezarm	DESIGNED -	REVISED -	<b>STATE OF ILLINOIS DEPARTMENT OF TRANSPORTATION</b>	<b>EROSION CONTROL PLAN IL. ROUTE 59 AT PETITE LAKE RD</b>			F.A.P. RTE.	SECTION	COUNTY	TOTAL SHEETS	SHEET NO.
pw\ill084EBIDINTEG\illinois.gov\PIWIDOT\Documents\DOT Offices\District 1\Projects\P145409\Drawings\Design\P145409-shr-cover.dgn		CHECKED -	REVISED -		104	105N-4	LAKE	113	44			
Default		DATE -	REVISED -		SCALE: 1"=50'			CONTRACT NO. 60W06				
					SHEET OF SHEETS STA. TO STA.			ILLINOIS FED. AID PROJECT				

IL. ROUTE 59

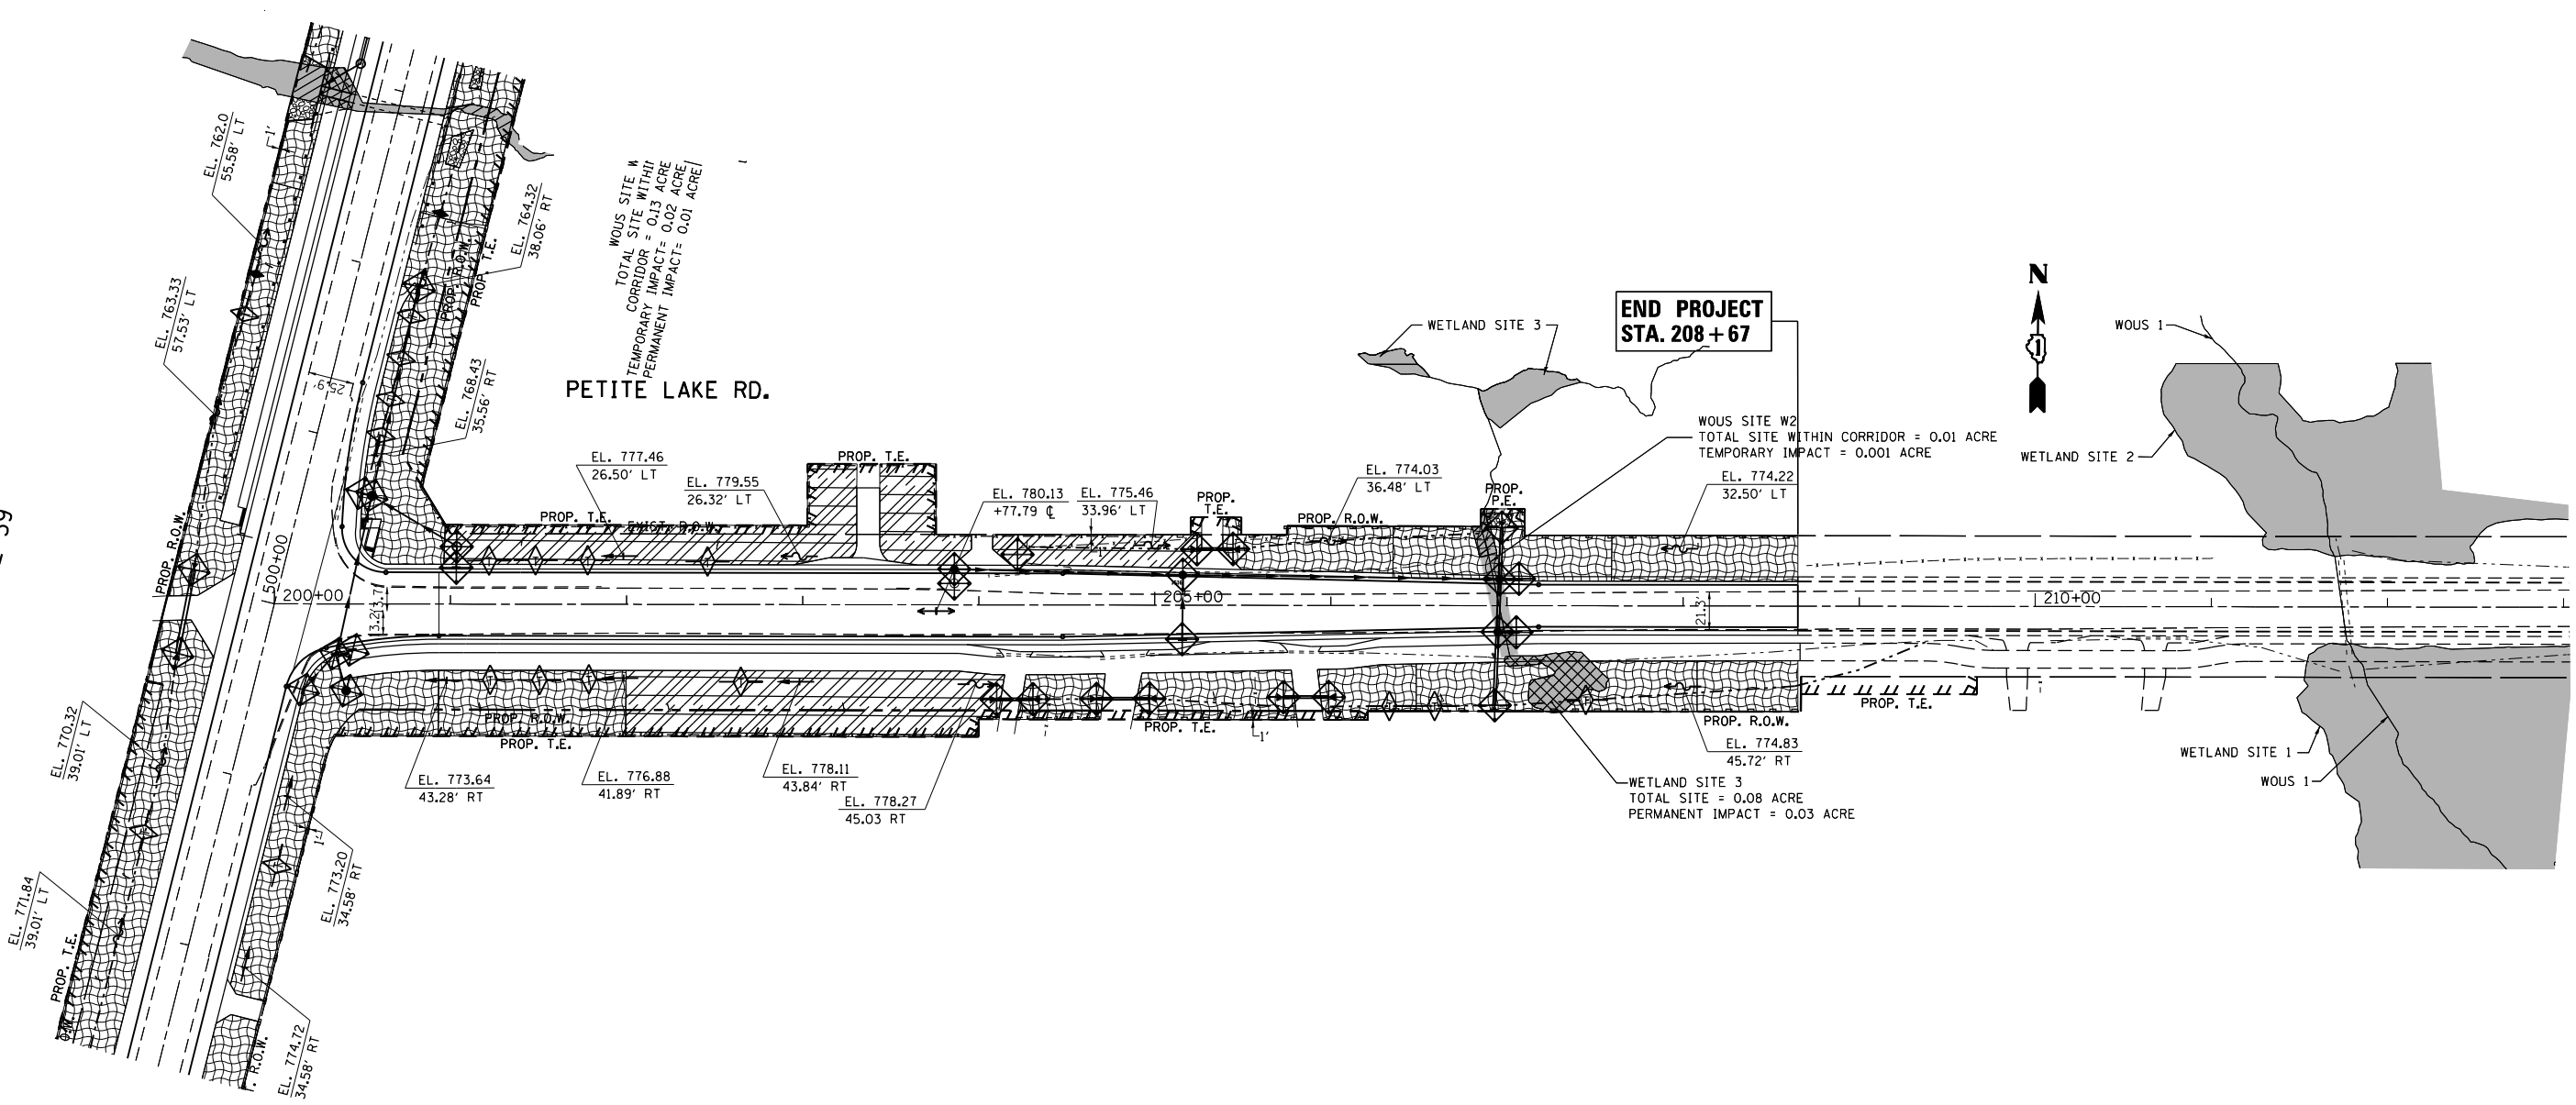

WOUS SITE W  
TOTAL SITE WITHIN  
CORRIDOR = 0.13 ACRE  
TEMPORARY IMPACT = 0.02 ACRE  
PERMANENT IMPACT = 0.01 ACRE

END PROJECT  
STA. 208 + 67

WOUS SITE W2  
TOTAL SITE WITHIN CORRIDOR = 0.01 ACRE  
TEMPORARY IMPACT = 0.001 ACRE

WETLAND SITE 3  
TOTAL SITE = 0.08 ACRE  
PERMANENT IMPACT = 0.03 ACRE



EROSION CONTROL LEGEND:

- TEMPORARY DITCH CHECK (URETHANE FOAM/GEO TEXTILE)
- INLET OR PIPE PROTECTION
- PERIMETER EROSION BARRIER
- TEMPORARY FENCE
- EROSION CONTROL BLANKET
- ROADWAY DITCH FLOW
- SWALE
- SUMMIT
- RIPRAP
- HEAVY DUTY EROSION CONTROL BLANKET



FILE NAME =	USER NAME = ledezmar	DESIGNED -	REVISED -
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Default	PLOT DATE = 8/19/2016	DATE -	REVISED -

STATE OF ILLINOIS  
DEPARTMENT OF TRANSPORTATION


EROSION CONTROL PLAN  
IL. ROUTE 59 AT PETITE LAKE RD

SCALE: 1"=50' SHEET OF SHEETS STA. TO STA.

F.A.P. RTE.	SECTION	COUNTY	TOTAL SHEETS	SHEET NO.
104	105N-4	LAKE	113	45
CONTRACT NO. 60W06				
ILLINOIS FED. AID PROJECT				

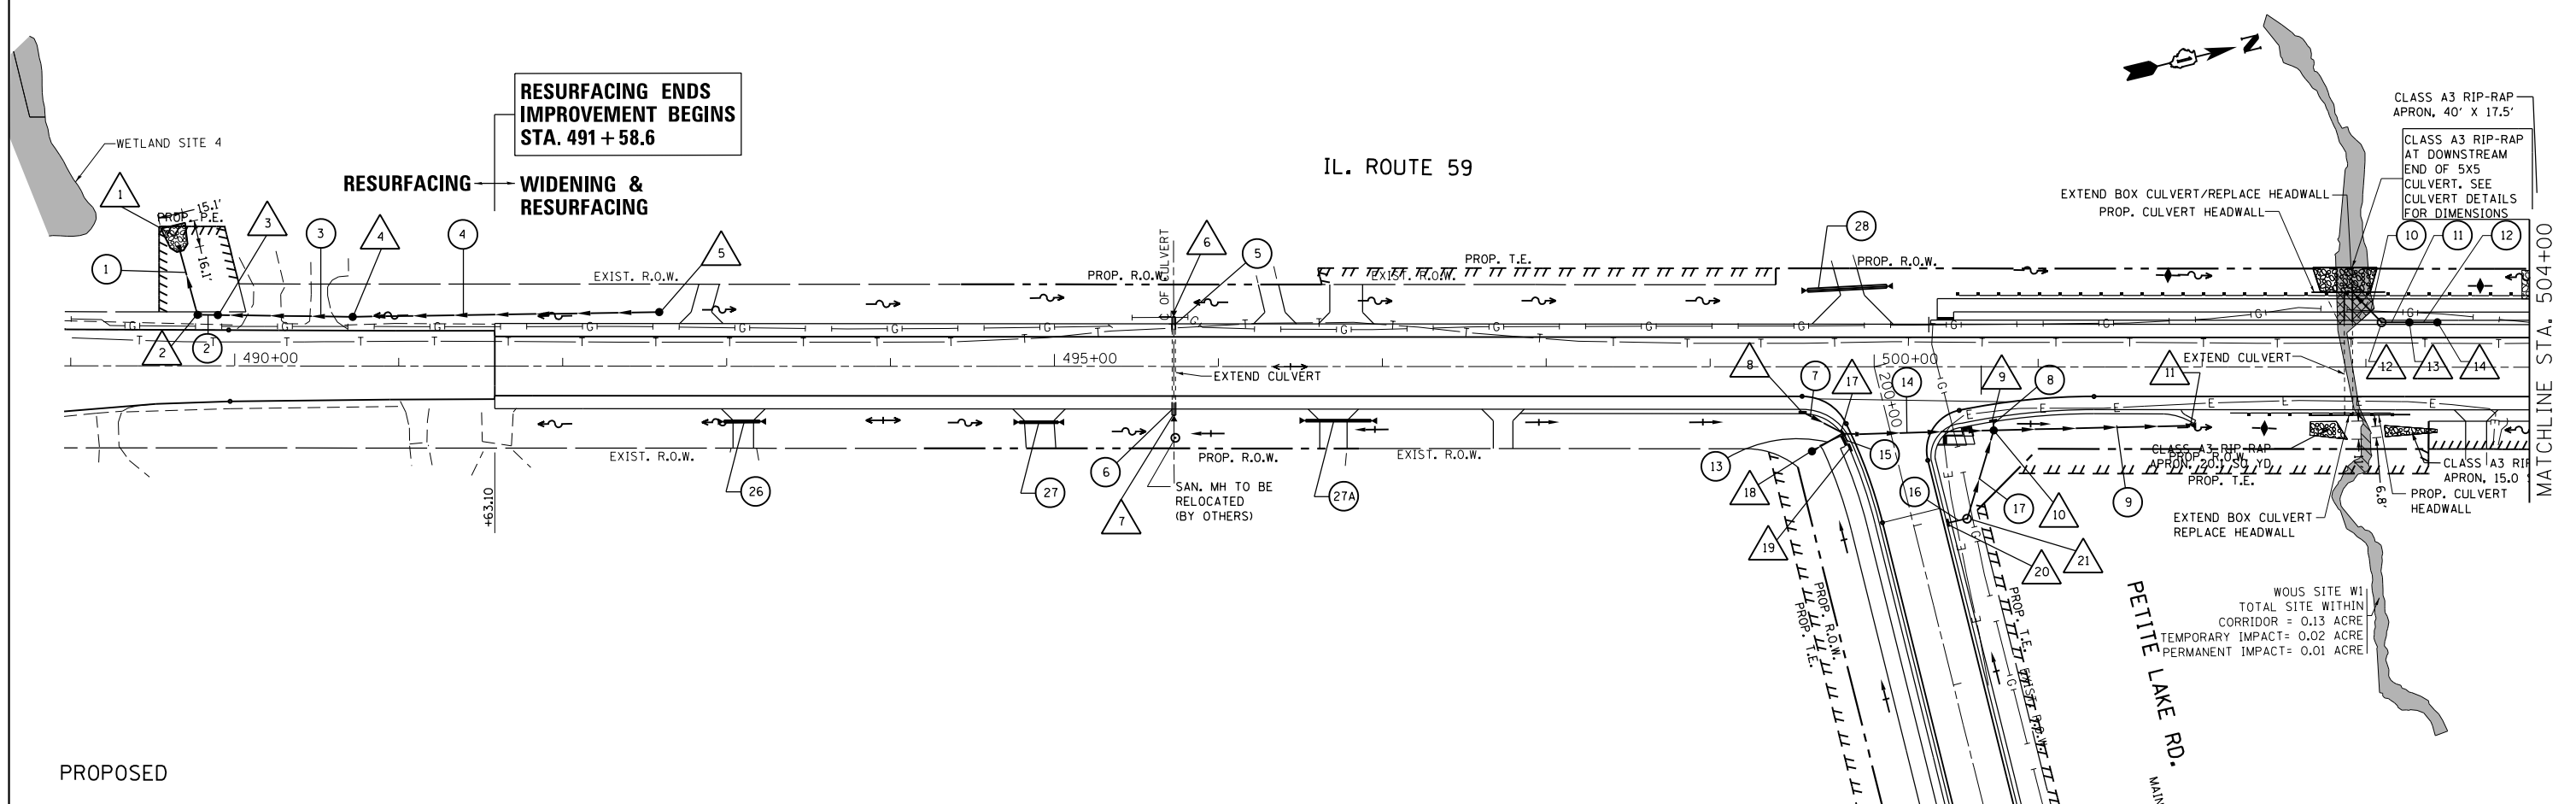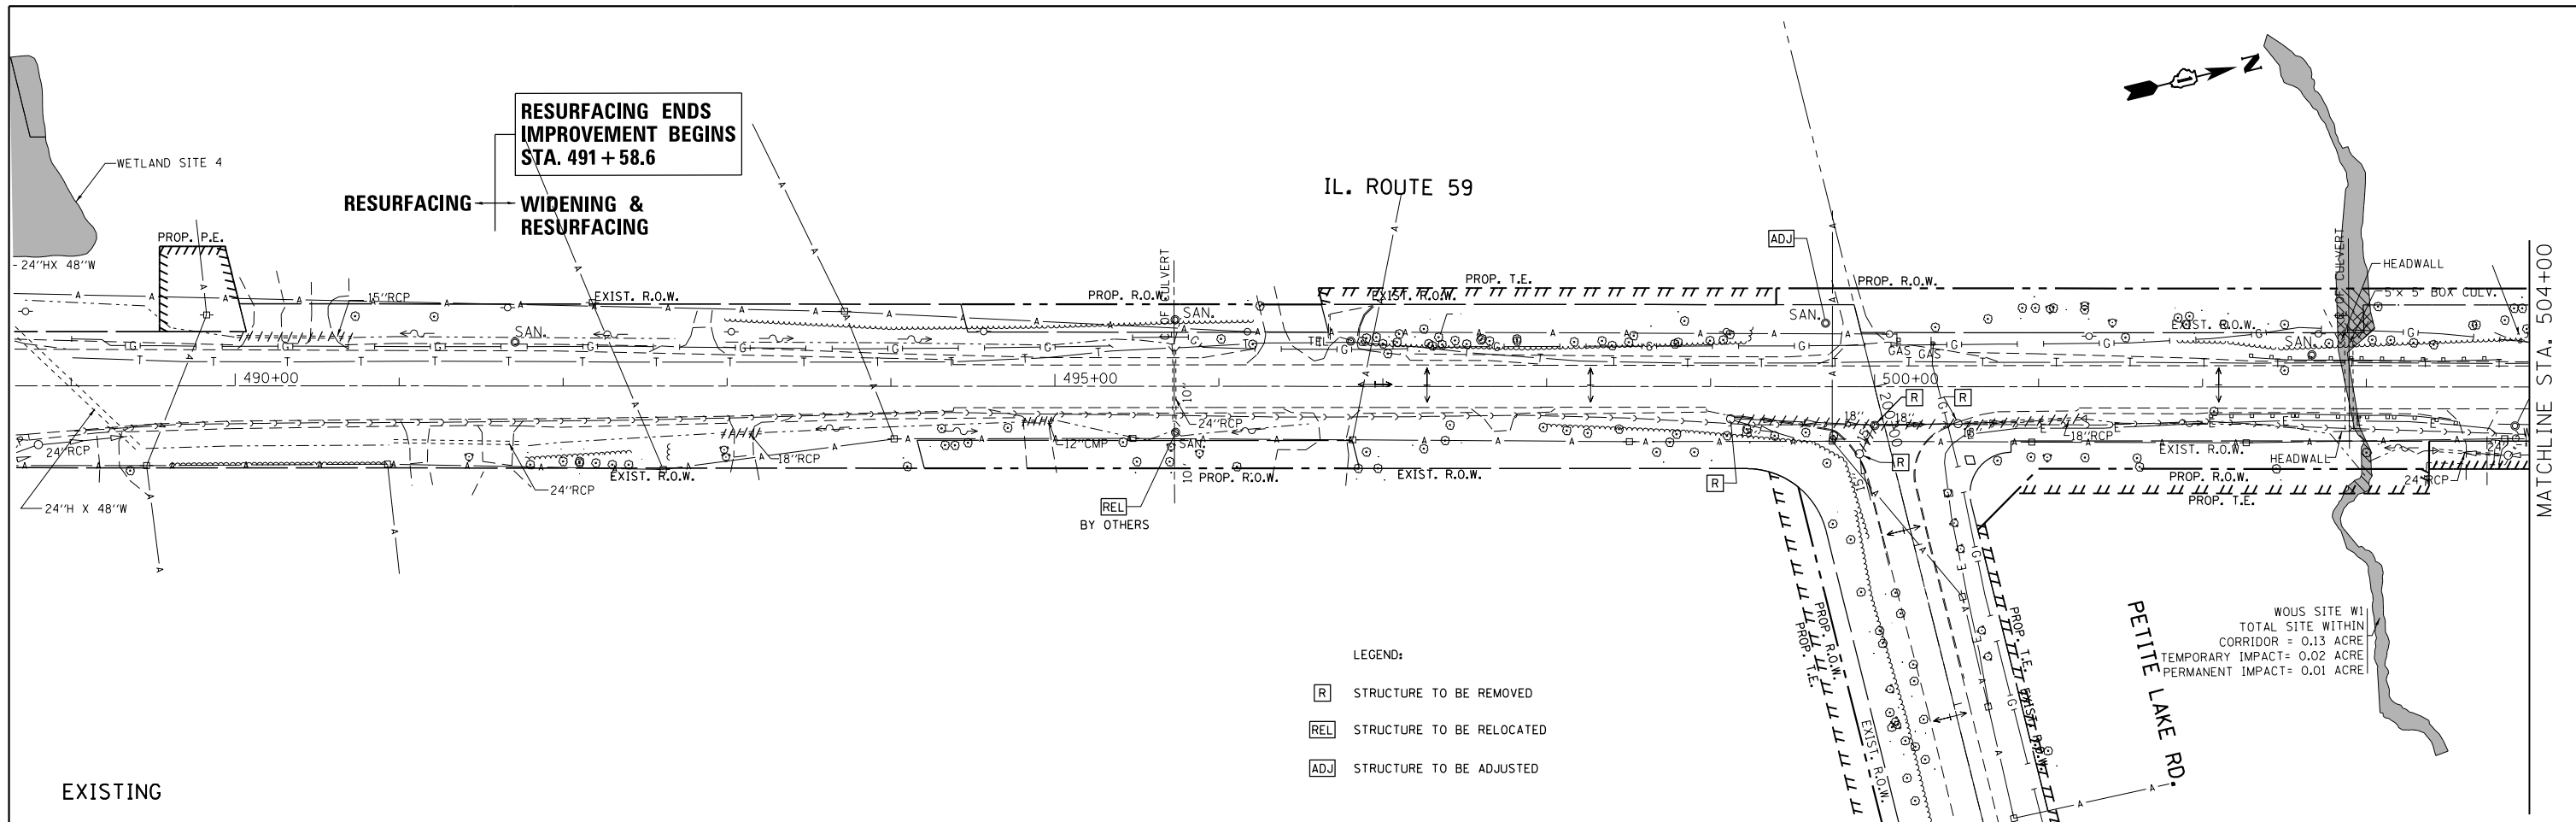

FILE NAME =	USER NAME = ldezma	DESIGNED -	REVISED -	<b>STATE OF ILLINOIS DEPARTMENT OF TRANSPORTATION</b>	<b>DRAINAGE AND UTILITIES PLAN IL. ROUTE 59 AT PETITE LAKE RD</b>			F.A.P. RTE.	SECTION	COUNTY	TOTAL SHEETS	SHEET NO.
pw:\IL\084EBID\INTEG\illinois.gov\PWIDOT\Documents\DOT Offices\District 1\Projects\P145409\Drawings\Design\P145409-shr-cover.dgn		CHECKED -	REVISED -		104	105N-4	LAKE	113	46			
Default		DATE -	REVISED -		SCALE: 1"=50'			SHEET OF SHEETS STA. TO STA.		CONTRACT NO. 60W06		
					ILLINOIS FED. AID PROJECT							

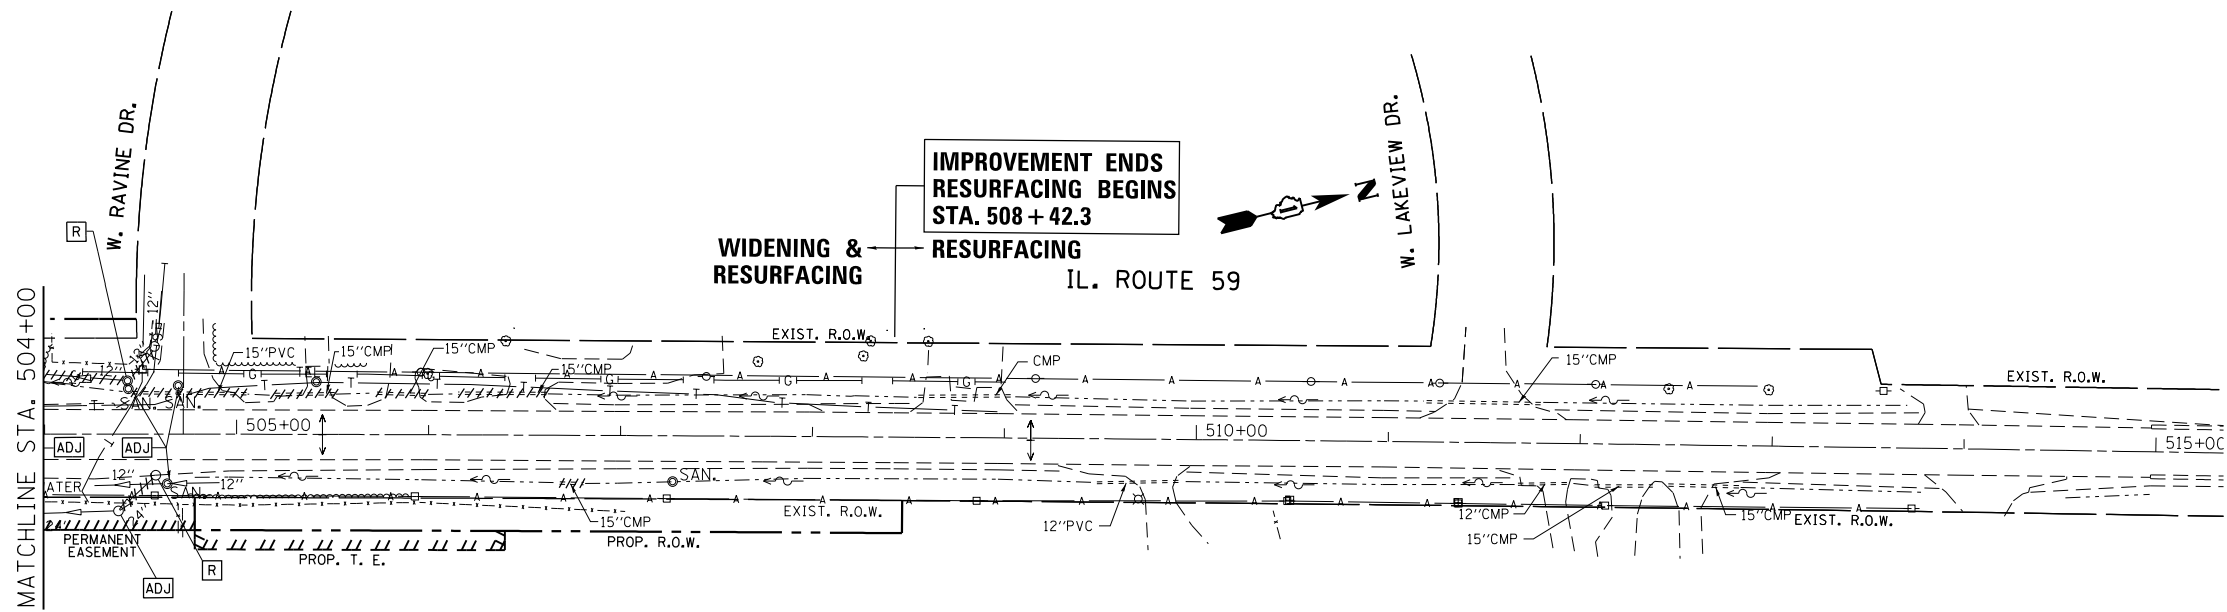


EXISTING SANITARY STRUCTURES  
TO BE ADJUSTED BY OTHERS:

- STA. 503+90.66, 23.67 FT. (RT.)  
T.G. 765.99
- STA. 504+43.62, 23.65 FT. (LT.)  
T.G. 766.07
- STA. 504+63.93, 25.82 FT. (RT.)  
T.G. 767.28

LEGEND:

- [R] STRUCTURE TO BE REMOVED
- [REL] STRUCTURE TO BE RELOCATED
- [ADJ] STRUCTURE TO BE ADJUSTED

EXISTING

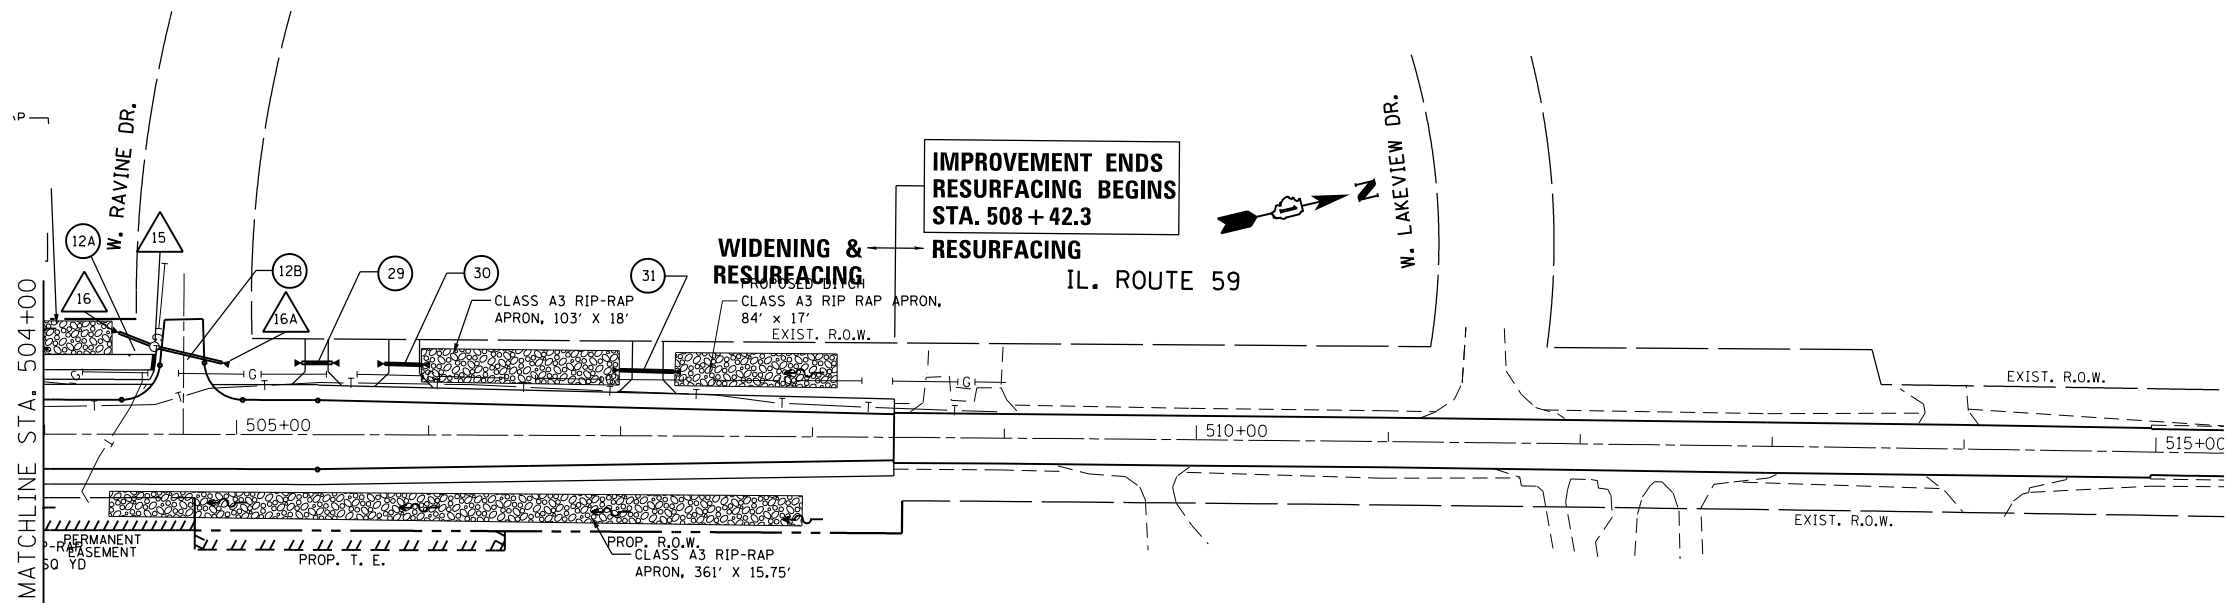

PROPOSED

FILE NAME =	USER NAME = ldezma	DESIGNED -	REVISED -
pw:\IL084EBIDINTEG\illinois.gov\PIWIDOT\Documents\IDOT Offices\District 1\Projects\P145409\Drawings\Design\P145409-shr-cover.dgn		REVISED -	REVISED -
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	PLOT DATE = 8/19/2016	DATE -	REVISED -


STATE OF ILLINOIS  
DEPARTMENT OF TRANSPORTATION

DRAINAGE AND UTILITIES PLAN  
IL. ROUTE 59 AT PETITE LAKE RD


SCALE: 1"=50' SHEET OF SHEETS STA. TO STA.

F.A.P. RTE.	SECTION	COUNTY	TOTAL SHEETS	SHEET NO.
104	105N-4	LAKE	113	47
CONTRACT NO. 60W06				
ILLINOIS FED. AID PROJECT				

PLAN	SURVEYED	DATE
	PLOTTED	
	ALIGNED	
	CHECKED	
	BY	
	NO. BOOK	
	NO.	

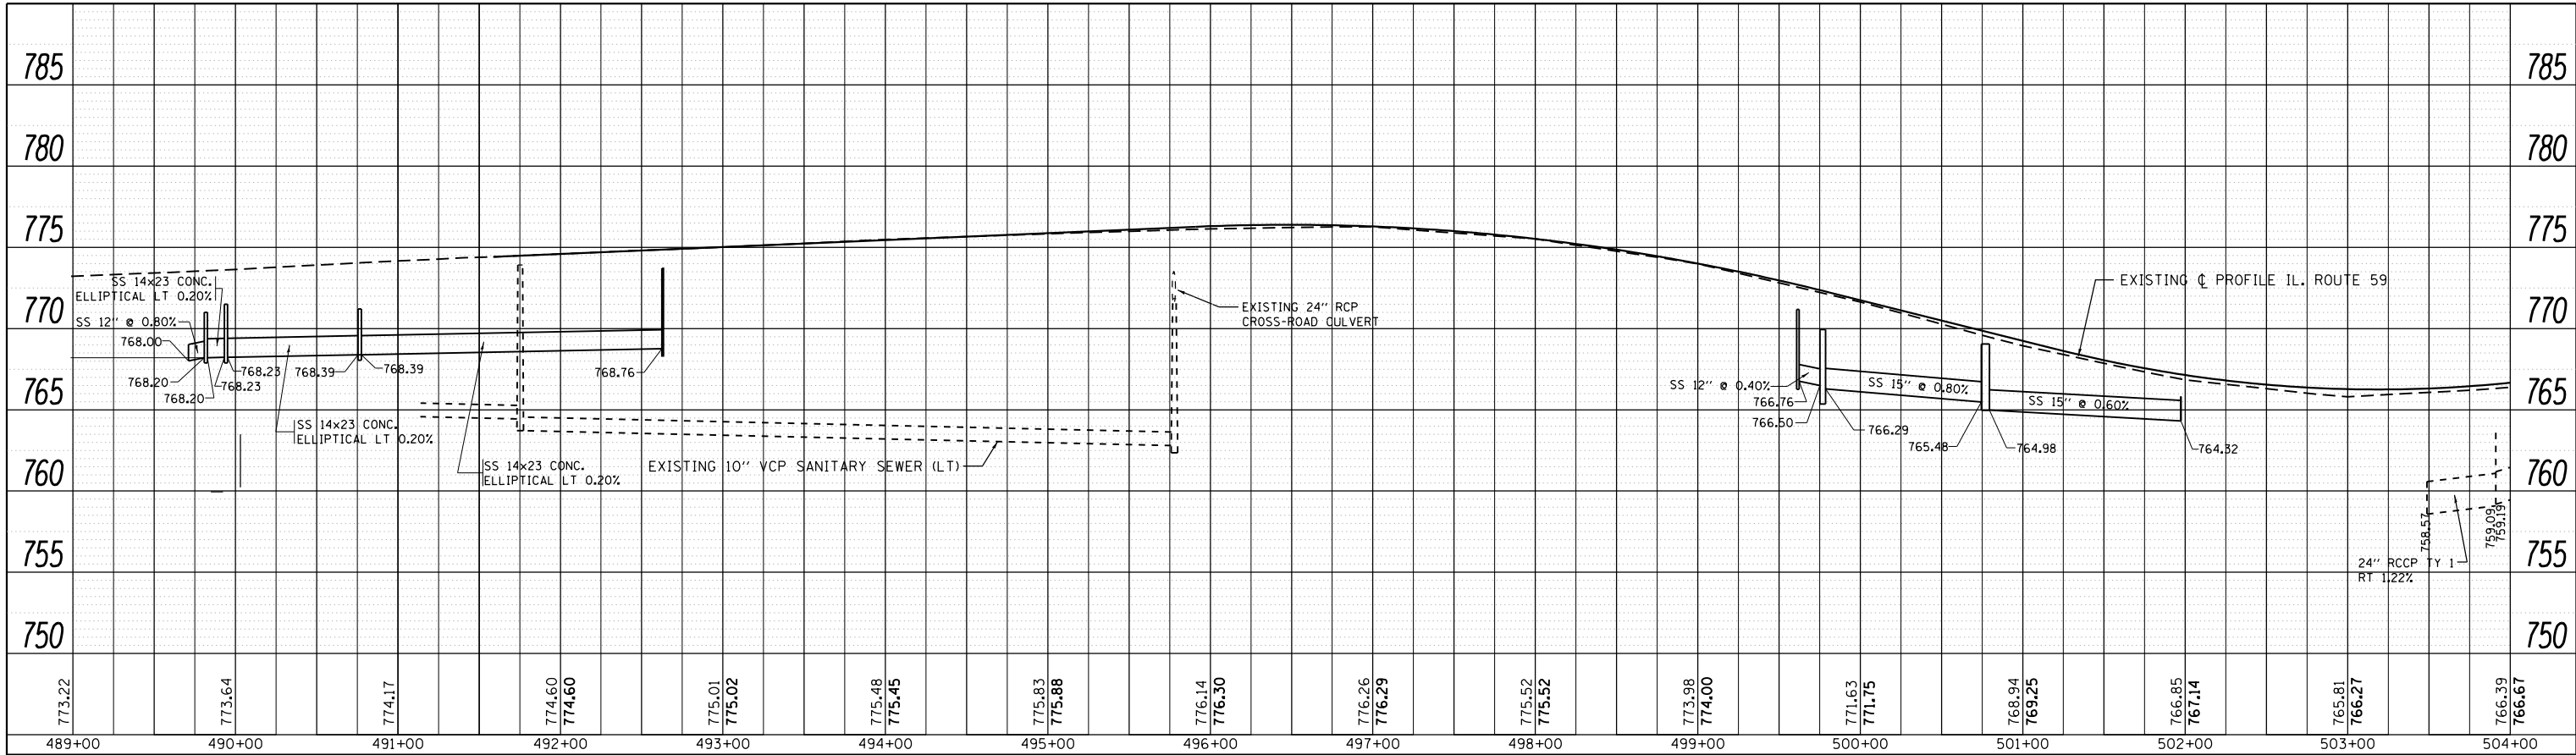

PROFILE	SURVEYED	DATE
	PLOTTED	
	GRADES CHECKED	
	STRUCTURE NOT AT THIS OFFICE	
	NO.	

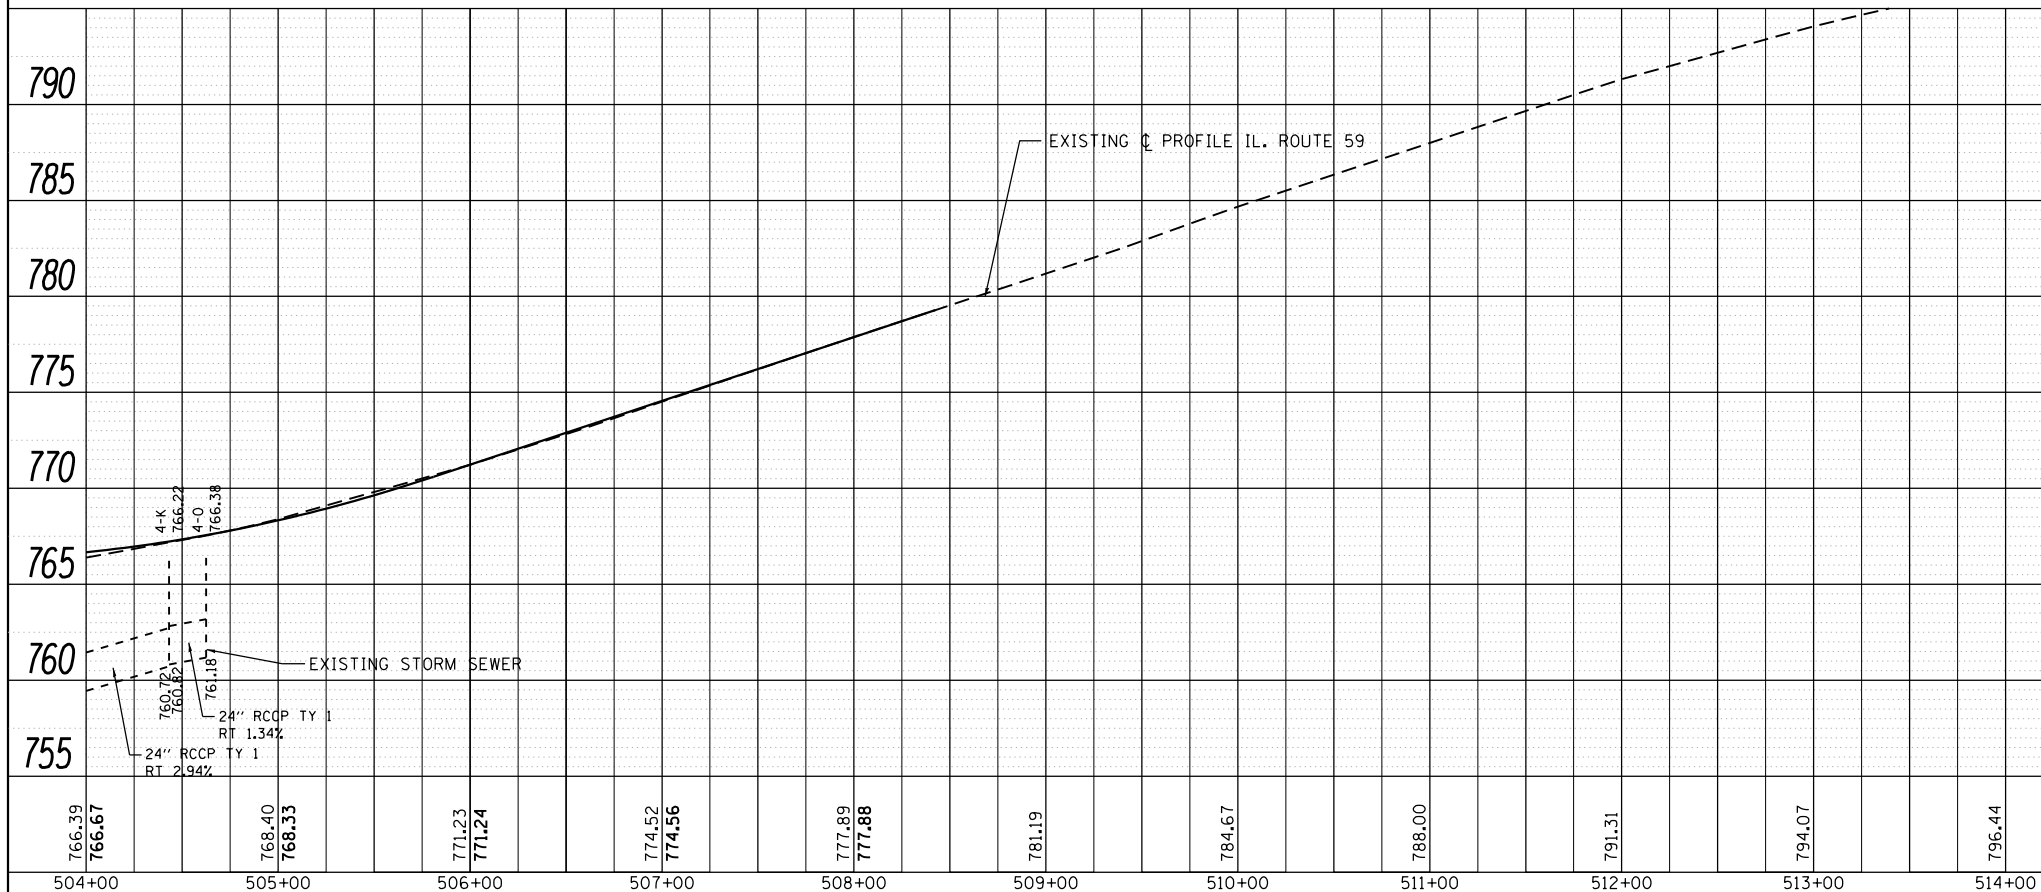

**WATERWAY INFORMATION TABLE (Exhibit 1-03.1a)**

Route: IL Route 59 @ Petite Lake Road  
 Waterway: Unnamed Tributary Creek  
 Section: SIS  
 County: Lake

Outlet #4  
 Existing S.N. 049-0504  
 Proposed S.N. 049-0504  
 Prepared By: SIS Date: Sep-14  
 Checked By: DH Date: Sep-14

Drainage Area = 0.996 sq mi		Existing Overtopping Elevation = 765.86		at Sta. 503+20			
		Proposed Overtopping Elevation = 766.29		at Sta. 503+20			
Flood	Frequency Year	Existing Discharge (cfs)	Proposed Discharge (cfs)	Waterway Opening (sq. ft.)	Head (ft.)	Headwater Elev. (ft)	
				Existing	Proposed	Existing	Proposed
	2	69	70	5.23	5.23	755.44	755.55
	10	123	124	7.49	7.49	755.89	756.00
	50	229	230	9.29	9.29	756.25	756.36
	100	259	261	9.94	9.94	756.38	756.49
	500	330	331	11.15	11.15	756.52	756.63
MAX. CALC.							

DATUM: NAVD83  
 Surveyed Normal Water Level: 755.1 ft  
 ALL - TIME H.W.E. & DATE: No Data Available, No FIS DATA available for this stream.



10 YEAR VELOCITY THROUGH EXISTING CULVERT = 20.4 ft/s  
 10 YEAR VELOCITY THROUGH PROPOSED CULVERT = 20.6 ft/s  
 2-yr flow rate = 69 ft<sup>3</sup>/s

EXISTING STRUCTURE		PROPOSED STRUCTURE	
TYPE: Reinforced Concrete Box Culvert		TYPE: Reinforced Concrete Box Culvert	
Cell Dimensions (W x H): 5' x 5'		Cell Dimensions (W x H): 5' x 5'	
# SPANS/CELLS: 1		# SPANS/CELLS: 1	
LENGTH: 55 feet		LENGTH: 59 feet	
SKEW: 0		SKEW: 0	
Low E.O.P.: 765.3		Low E.O.P.: 765.58	
FREEBOARD: 4.64		FREEBOARD: 4.89	
CULVERT INVERTS: 754.39 (L/S), 753.29 (R/S)		CULVERT INVERTS: 754.39 (L/S), 753.27 (R/S)	

NO EMBEDMENT EXISTS      NO EMBEDMENT PROPOSED

NOTE: Proposed structure details are preliminary. Subject to refinement in T&E stage.  
 COMMENT: Waterway openings are based on the natural H.W.E.; The freeboard is calculated from the edge of shoulder at 503+00.  
 The natural H.W.E. is based on the natural conditions (water elevation added to the upstream culvert invert location).  
 The existing head is the difference in water surface elevations between existing and natural conditions.  
 The proposed head is the difference in water surface elevations between proposed and natural conditions.  
 The headwater elevations are the changes in head added to the natural H.W.E.'s  
 Discharge rates from USGS streamstats. Proposed discharge rates reflect increase in flows due to impervious areas.




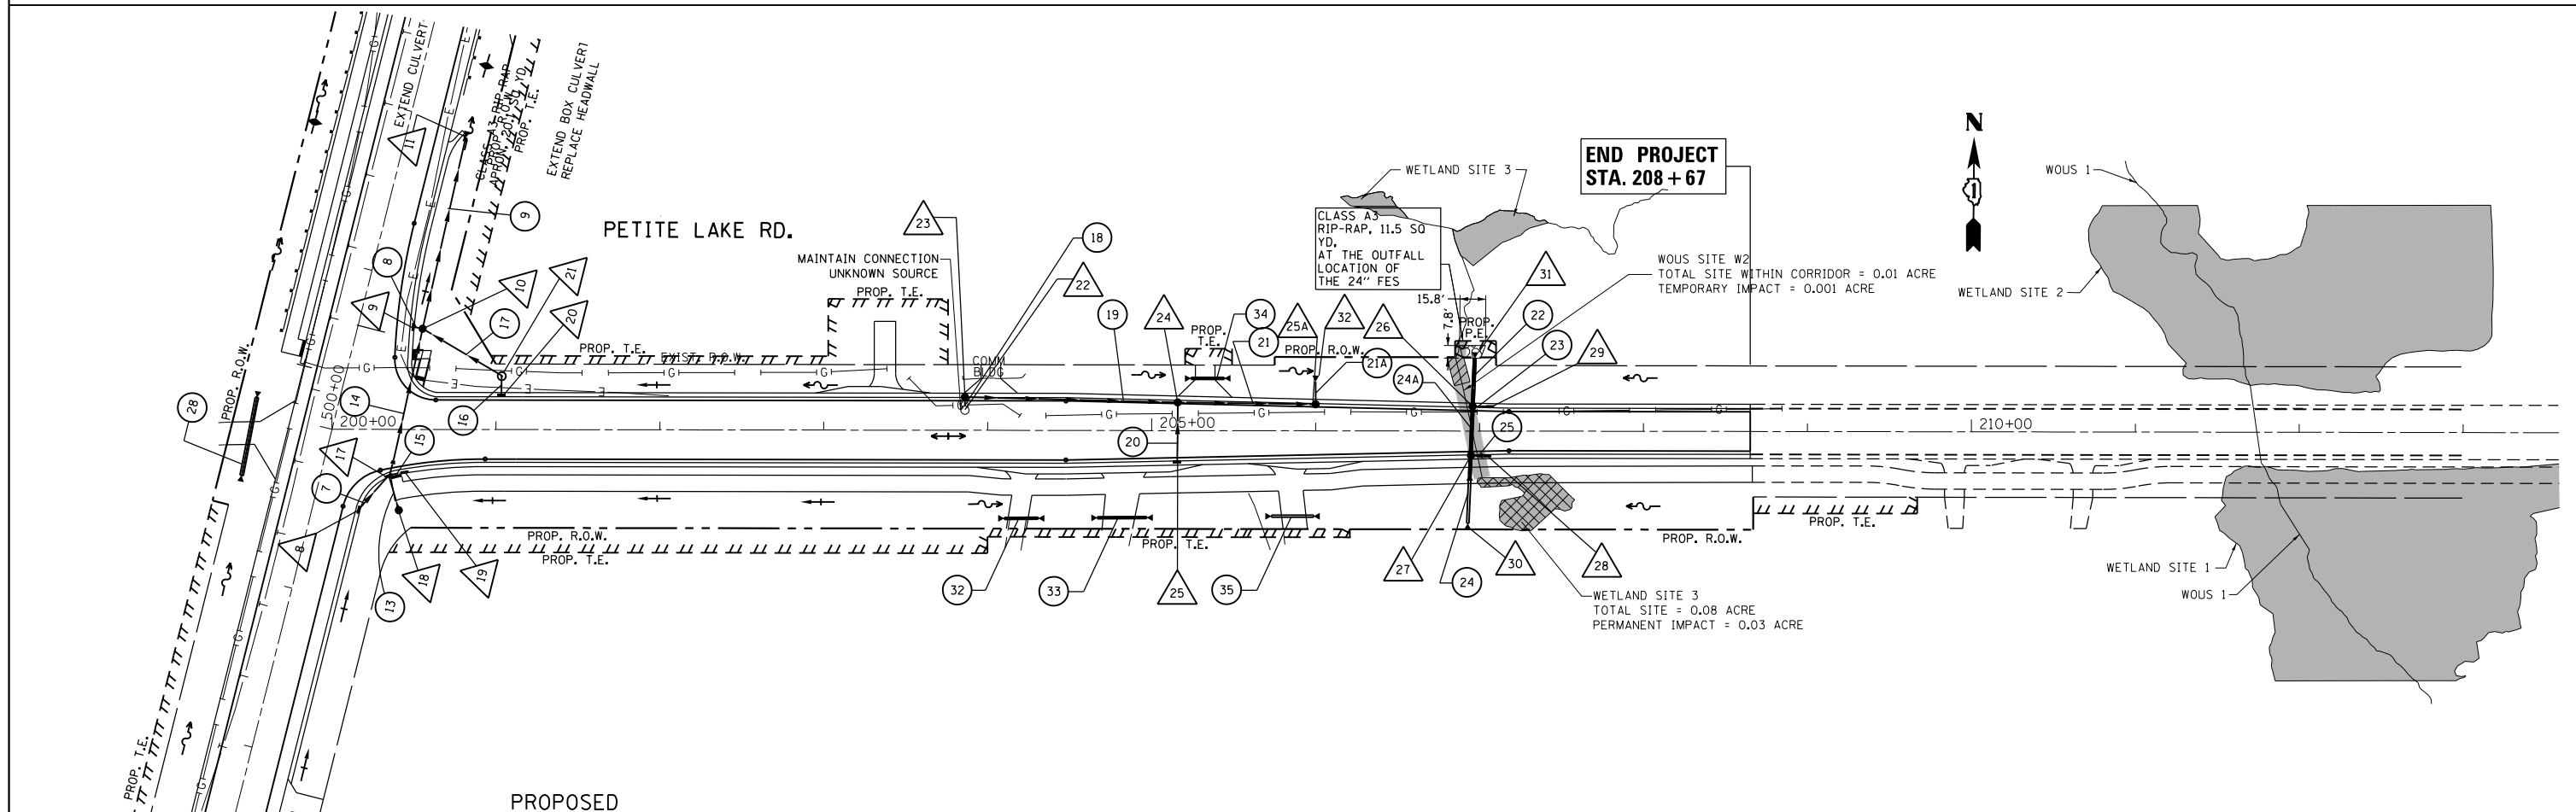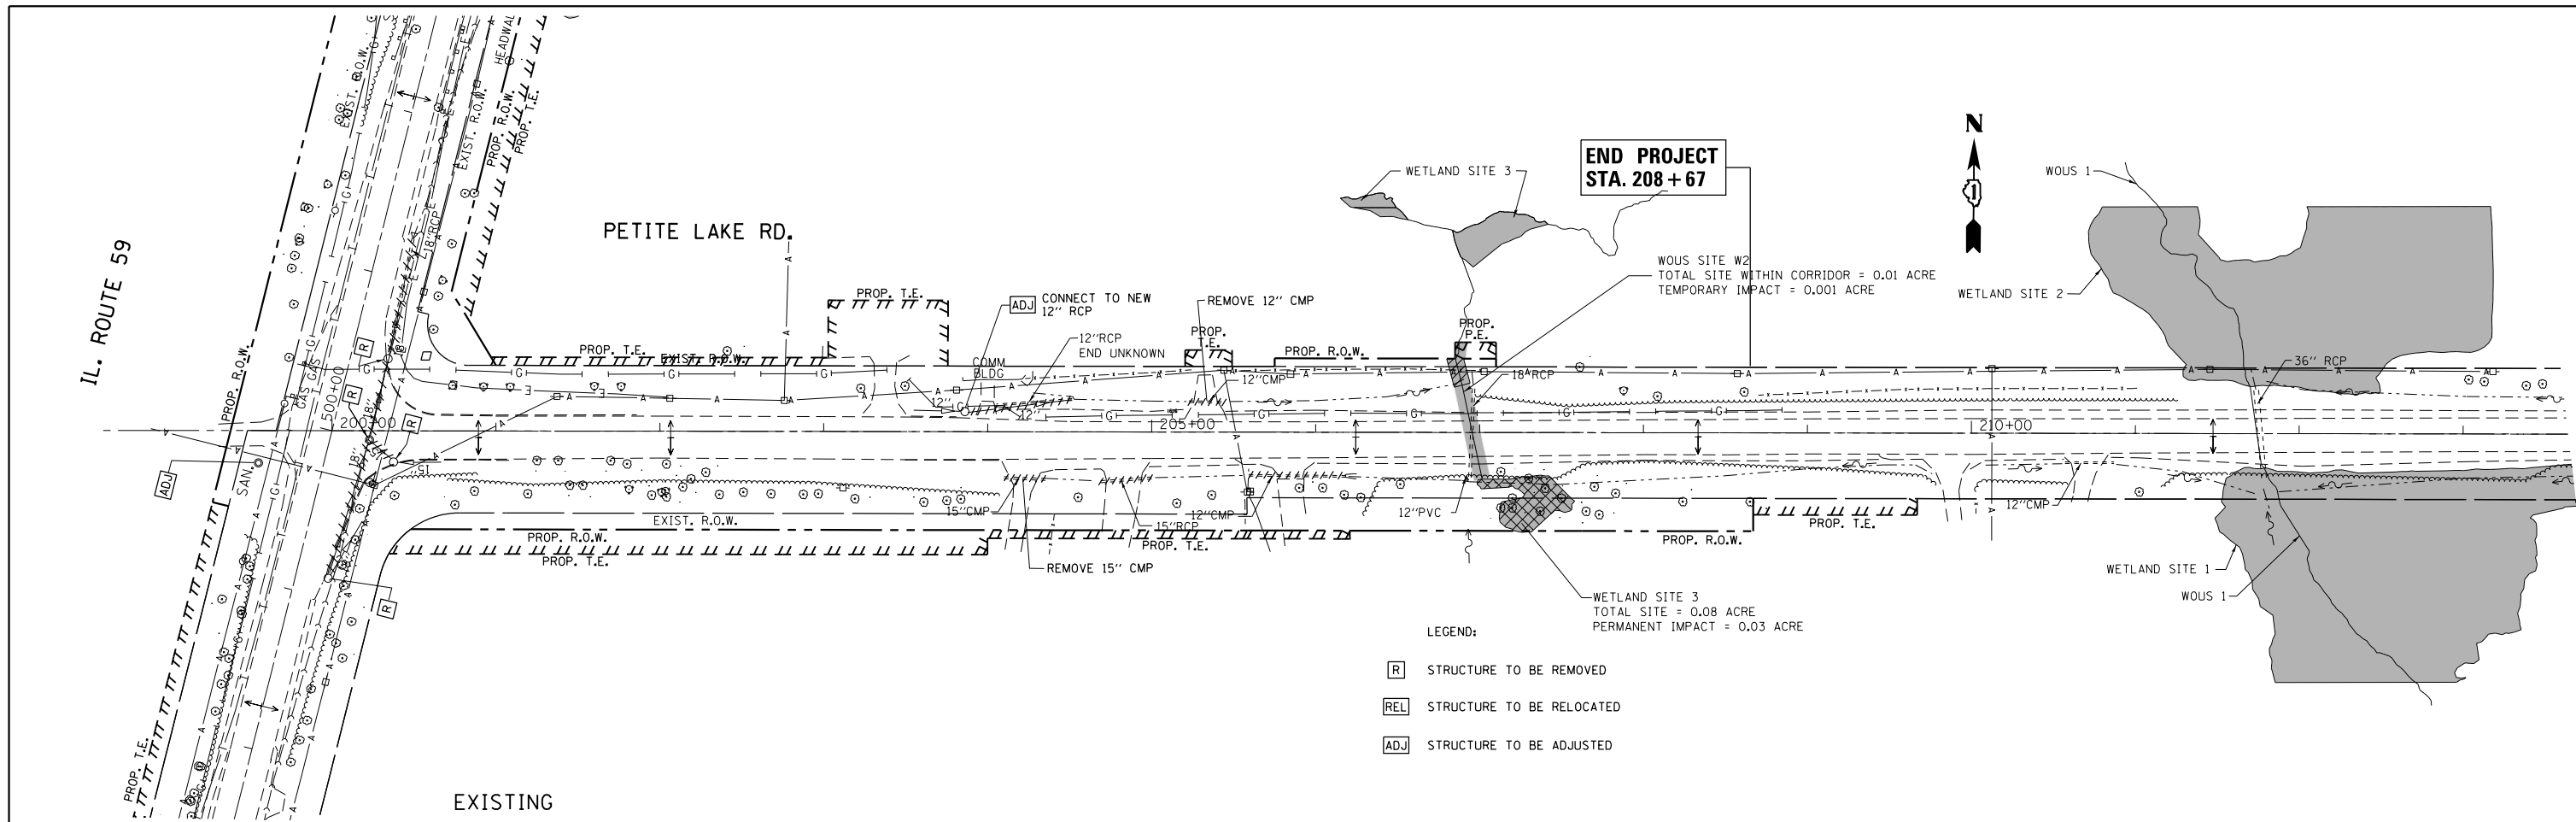

FILE NAME =	USER NAME = ldezmarm	DESIGNED -	REVISED -	<b>STATE OF ILLINOIS DEPARTMENT OF TRANSPORTATION</b>	<b>DRAINAGE AND UTILITIES PLAN IL. ROUTE 59 AT PETITE LAKE RD</b>			F.A.P. RTE.	SECTION	COUNTY	TOTAL SHEETS	SHEET NO.
pw:\IL\084EBID\INTEG.illinois.gov\PIWIDOT\Documents\IDOT Offices\District 1\Projects\P145409\Design\P145409-shr-cover.dgn		CHECKED -	REVISED -					104	105N-4	LAKE	113	49
Default	PLOT SCALE = 100.0000' / in.	DATE -	REVISED -		SCALE: 1"=50'			CONTRACT NO. 60W06				
	PLOT DATE = 9/19/2016				SHEET OF SHEETS STA. TO STA.			ILLINOIS FED. AID PROJECT				

PLAN	SURVEYED	DATE
NOTE BOOK NO.	PLOTTED	BY
	ALIGNMENT CHECKED	
	FIELD FILE NAME	

PROFILE	SURVEYED	DATE
NOTE BOOK NO.	PLOTTED	BY
	GRADES CHECKED	
	STRUCTURE NOT AT THIS CPKID	

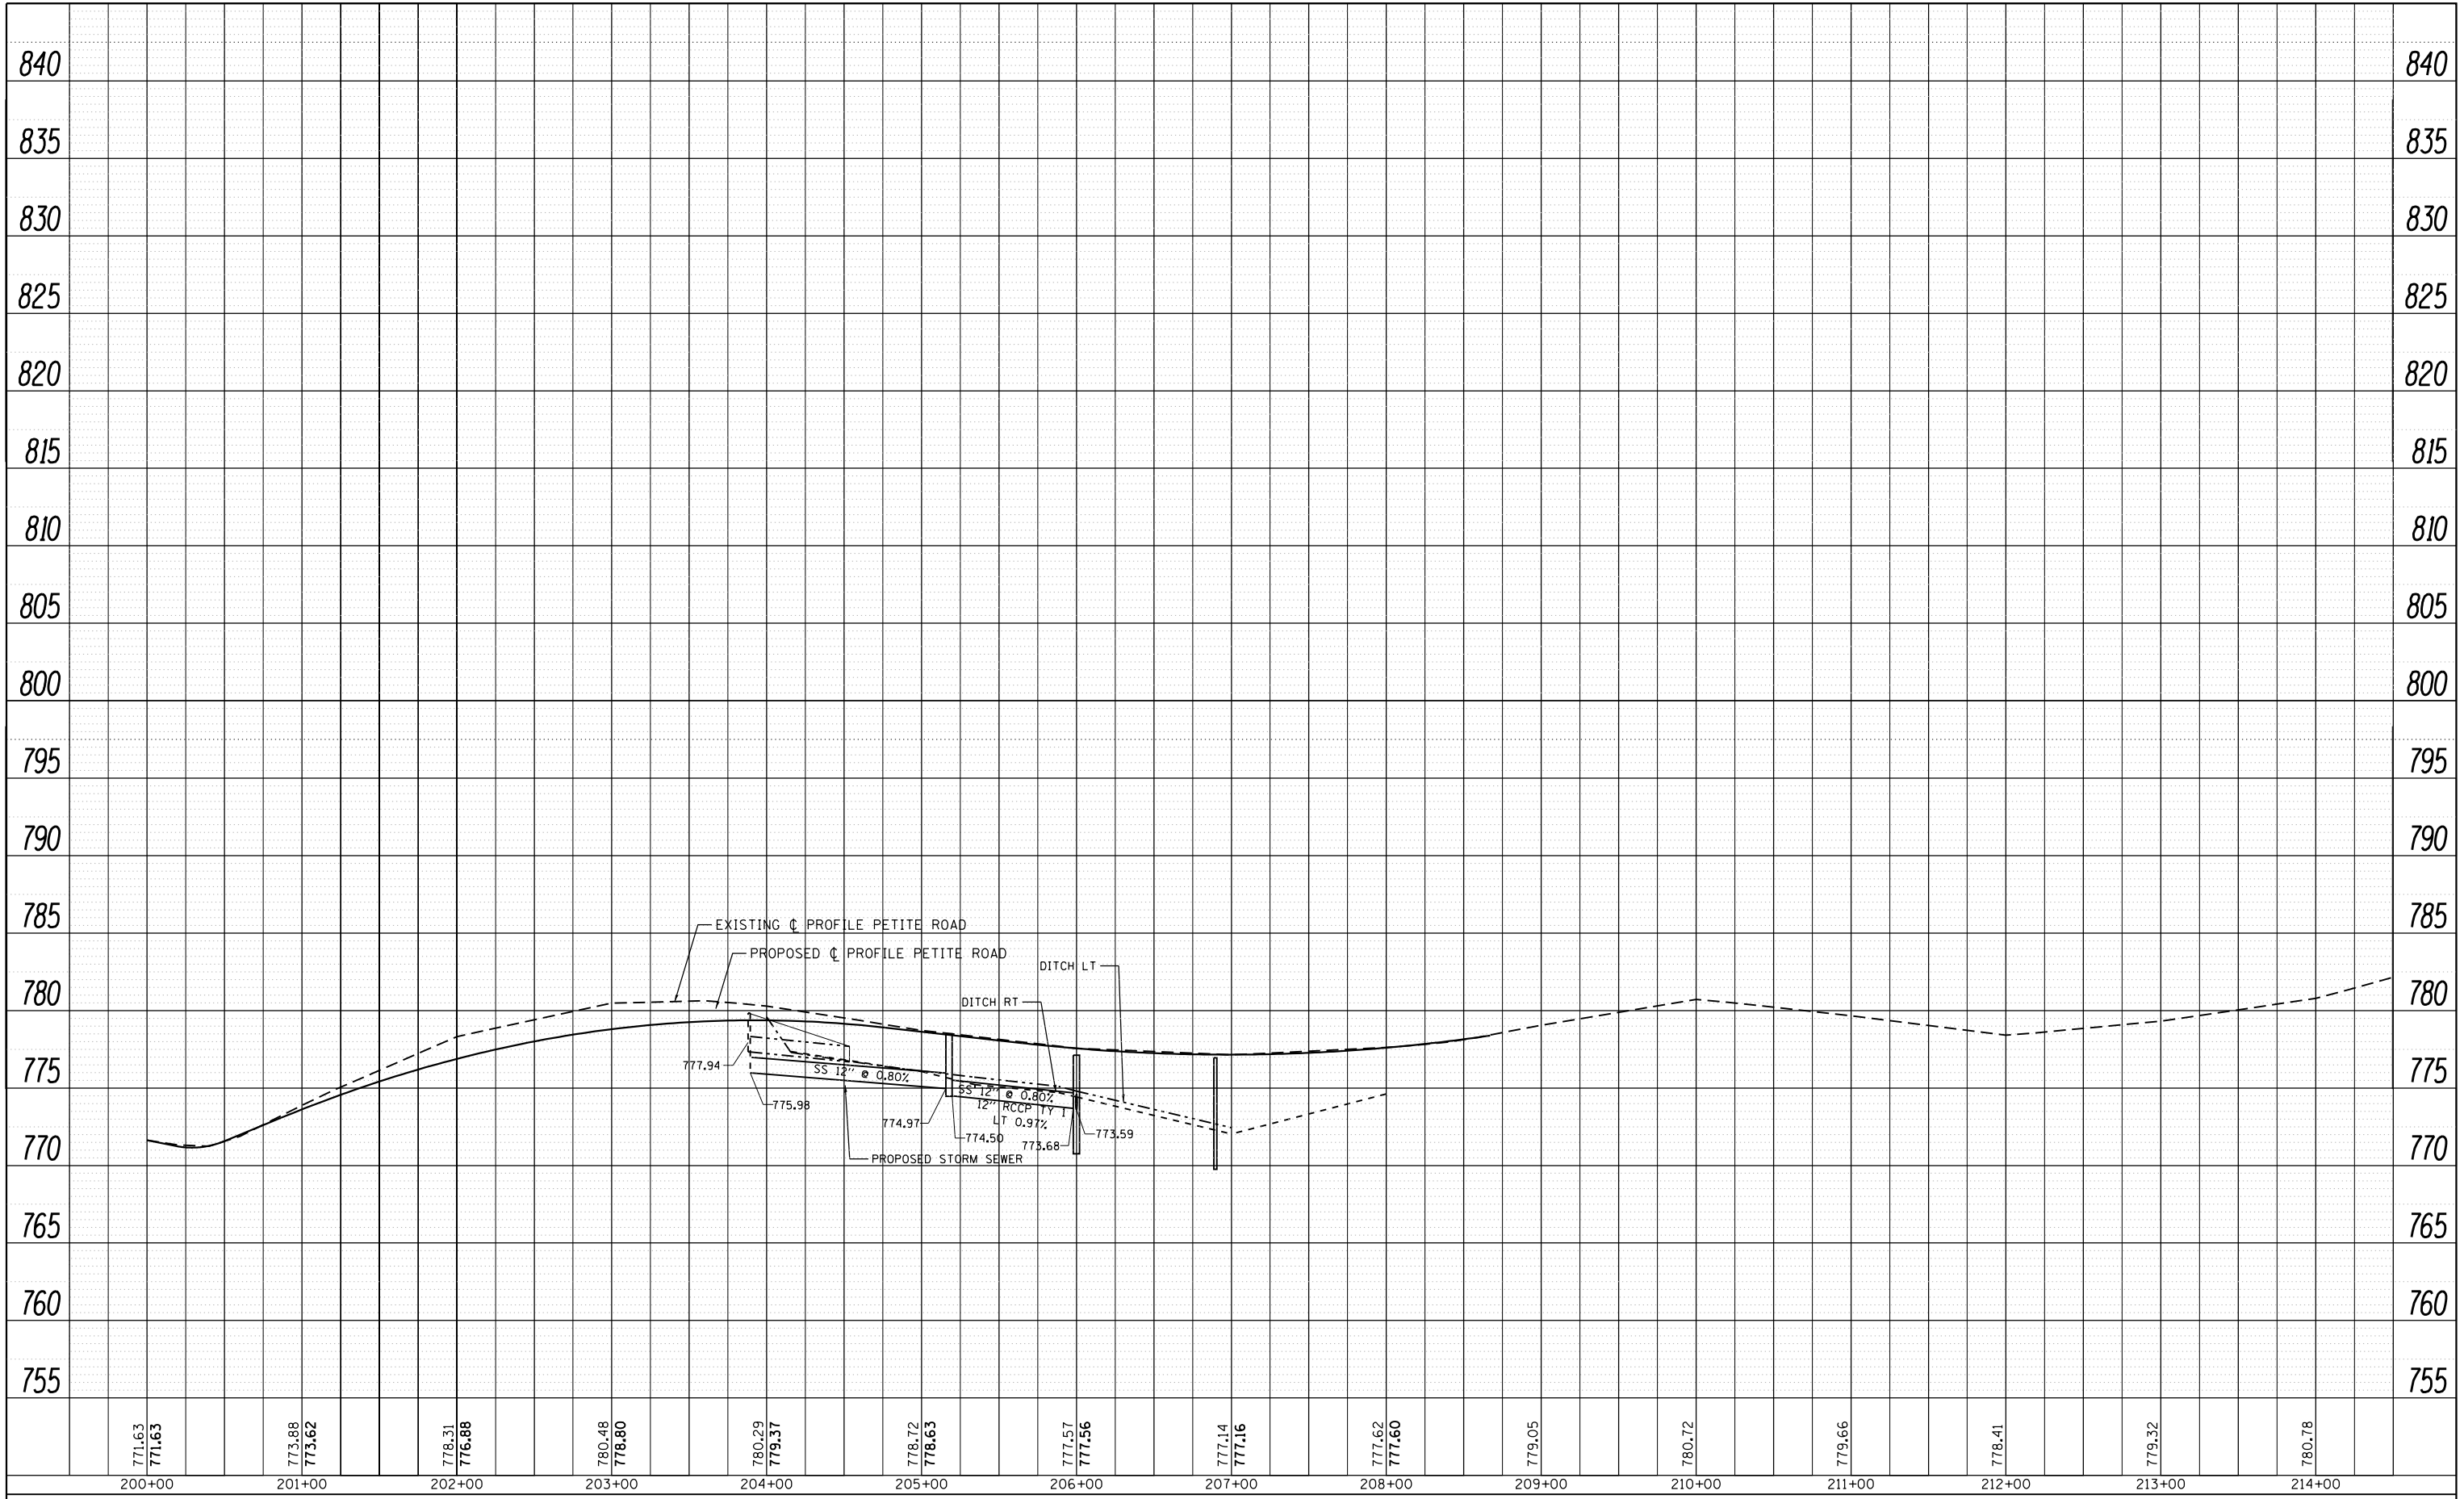

FILE NAME =	USER NAME = ldezmarm	DESIGNED -	REVISED -
p:\1\084EBIDINTEG\Illinois.gov\PIWIDOT\Documents\DOT Offices\District 1\Projects\P14549\Design\14549-sht-cover.dgn		REVISION	REVISION
Default	PLOT SCALE = 100.0000' / in.	CHECKED -	REVISED -
	PLOT DATE = 8/29/2016	DATE -	REVISED -

**STATE OF ILLINOIS  
DEPARTMENT OF TRANSPORTATION**

<b>DRAINAGE PROFILE</b>			
<b>IL. ROUTE 59 AT PETITE LAKE RD.</b>			
SCALE: 1"=50'	SHEET	OF	SHEETS
	STA.		TO STA.

F.A.P. RTE.	SECTION	COUNTY	TOTAL SHEETS	SHEET NO.
104	105N-4	LAKE	113	50
CONTRACT NO. 60W06			ILLINOIS FED. AID PROJECT	

**STRUCTURES:**



PRC FL-END SEC, 12 IN  
STA 489+66.61, 69.98 FT (LT)  
T.G.  
INV. 768.00  
T.B.

FLAT TOP



MH-T-A, 5 FT. DIA. W/ T-8 GRATE  
RESTRICTOR PLATE  
STA. 489+77.24, 31.17 FT. (LT)  
T.G. 770.95  
INV. 768.20 (NE)  
INV. 768.20 (SW)  
T.B.

FLAT TOP



MH, T-A, 5 FT. DIA. W/ T-8 GRATE  
STA. 489+89.63, 31.02 FT. (LT)  
T.G. 771.14  
INV. 768.23 (NE)  
INV. 768.23 (SW)  
T.B.

FLAT TOP



MH, T-A, 5 FT. DIA. W/ T-8 GRATE  
STA. 490+71.93, 30.26 FT. (LT)  
T.G. 772.20  
INV. 768.39 (NE)  
INV. 768.39 (SW)  
T.B.



CB, T-A, 5 FT DIA. W/ T-8 GRATE  
STA. 492+58.90, 32.92 FT (LT)  
T.G. 773.79  
INV. 768.76  
T.B.



CONC-END SEC. 1:4, 24 IN  
STA. 495+71.99, 41.79 FT. (LT)  
T.G.  
INV. 771.42  
T.B.



CONC-END SEC. 1:4, 24 IN  
STA. 495+72.91, 38.04 FT (RT)  
T.G.  
INV. 771.50  
T.B.



CB, T-A, 4 FT. DIA. W/ T-24 F&G  
STA. 499+56.59, 27.00 FT. (RT)  
T.G. 772.13  
INV. 766.76 (NE)  
T.B.



CB, T-C, W/ T-24 F&G  
STA. 500+72.67, 31.84 FT. (RT)  
T.G. 769.15  
INV. 765.62 (SE)  
T.B.

FLAT TOP



MH, T-A, 5 FT. DIA. W/ T-8 GRATE  
STA. 500+73.29, 38.66 FT. (RT)  
T.G. 769.20  
INV. 764.98 (NE)  
INV. 765.60 (NW)  
INV. 765.66 (SE)  
INV. 765.48 (SW)  
T.B.



PRC FL-END SEC. 15 IN  
STA. 501+32.65, 37.88 FT. (RT)  
T.G.  
INV. 764.32  
T.B.



MH, T-A, 4 FT. DIA. W/ T-24 F&G  
STA. 503+08.66, 27.00 FT. (LT)  
T.G. 765.57  
INV. 756.69 (SW)  
INV. 759.86 (NE)  
T.B.



CB, T-A, 4 FT. DIA. W/ T-24 F&G  
STA. 503+18.66, 27.00 FT. (LT)  
T.G. 765.56  
INV. 759.96 (SW)  
INV. 760.46 (NE)  
T.B.




CB, T-A, 4 FT. DIA. W/ T-24 F&G  
STA. 503+28.66, 27.00 FT. (LT)  
T.G. 765.57  
INV. 760.54 (SW)  
T.B.



CB, T-A 4 FT. DIA. W/ T-8 GRATE (EXIST)  
STA. 504+56.98, 45.56 FT. (LT)  
T.G. 765.21 (EXIST)  
INV. 762.11 (NW) EXIST  
INV. 762.61 (NE)  
INV. 761.86 (SW)  
T.B.



PRC FL-END SEC. 15 IN  
STA. 503+47, 50.70 FT (LT)  
T.G.  
INV. 756.06  
T.B.

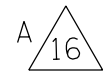

PRC FL-END SEC. 15 IN  
STA. 504+91.49, 40.73 FT (LT)  
T.G.  
INV. 764.22  
T.B.



CB, T-A, 5 FT. DIA. W/ T-24 F&G  
STA. 200+34.81, 27.25 FT. (RT)  
T.G. 770.60  
INV. 766.31 (NE)  
INV. 766.68 (NE)  
INV. 766.47 (SE)  
INV. 766.50 (SW)  
T.B.



CB, T-C, W/ T-8 GRATE  
STA. 200+40.83, 49.27 FT. (RT)  
T.G. 772.06  
INV. 766.56 (NW)  
T.B.

FLAT TOP



CB, T-A, 4 FT. DIA. W/ T-24 F&G  
STA. 200+44.40, 25.00 FT. (RT)  
T.G. 770.87  
INV. 766.74 (NW)  
T.B.



CB, T-C, W/ T-24 F&G  
STA. 201+03.71, 20.98 FT. (LT)  
T.G. 773.48  
INV. 768.10 (N)  
T.B.



MH, T-A, 4 FT. DIA. W/ T-8 GRATE  
STA. 201+03.71, 27.01 FT. (LT)  
T.G. 773.32  
INV. 766.25 (NW)  
INV. 767.44 (S)  
T.B.



CB, T-A, 4 FT. DIA. (EXIST) ADJ  
W/NEW T-1F CL  
STA. 203+86.12, 12.23 FT. (LT)  
T.G. 779.13  
INV. 777.94 (W) EXIST  
INV. 776.19 (N)  
T.B.

FLAT TOP



CB, T-A, 4 FT. DIA. W/ T-24 F&G  
STA. 203+86.12, 20.98 FT. (LT)  
T.G. 778.97  
INV. 775.98 (E)  
INV. 776.15 (S)  
T.B.

FLAT TOP



CB, T-A, 4 FT. DIA. W/ T-24 F&G  
STA. 205+15.69, 19.47 FT. (LT)  
T.G. 778.09  
INV. 774.97 (W)  
INV. 774.50 (E)  
INV. 774.75 (S)  
T.B.

FLAT TOP



CB, T-A, 4 FT. DIA. W/ T-24 F&G  
STA. 206+00, 16.20 FT. (LT)  
T.G. 777.13  
INV. 773.68 (W)  
INV. 773.59 (N)  
T.B.



CB, T-C, W/ T-24 F&G  
STA. 205+15.59, 19.49 FT. (RT)  
T.G. 778.09  
INV. 775.10 (N) EXIST  
T.B.



CB, T-A, 5 FT. DIA. W/ T-24 F&G  
STA. 206+95.86, 15.46 FT. (LT)  
T.G. 776.85  
INV. 770.65 (N) EXIST  
INV. 770.75 (S) EXIST  
INV. 773.31 (E)  
T.B.



CB, T-A, 5 FT. DIA. W/ T-24 F&G  
STA. 206+94.60, 15.51 FT. (RT)  
T.G. 776.87  
INV. 771.34 (N) EXIST  
INV. 771.45 (S) EXIST  
INV. 773.30 (E)  
T.B.



CB, T-C, W/ T-24 F&G  
STA. 207+04.90, 15.31 FT. (RT)  
T.G. 776.86  
INV. 773.40 (W)  
T.B.



CB, T-C, W/ T-24 F&G  
STA. 207+06.36, 15.26 FT. (LT)  
T.G. 776.87  
INV. 773.42 (W)  
T.B.



CONC-END SEC. 1:4, 24 IN  
STA. 206+92.94, 56.30 FT. (RT)  
T.G.  
INV. 772.32  
T.B.




CONC-END SEC. 1:4, 24 IN  
STA. 206+97.44, 44.35 FT. (LT)  
T.G.  
INV. 770.05  
T.B.



PRC FL-END SEC, 12 IN  
STA 206+00, 33.65 FT (LT)  
T.G.  
INV. 773.45  
T.B.

FILE NAME =	USER NAME = ldezmarm	DESIGNED -	REVISED -	<b>STATE OF ILLINOIS DEPARTMENT OF TRANSPORTATION</b>	<b>DRAINAGE TABLES IL. ROUTE 59 AT PETITE LAKE RD</b>			F.A.P. RTE.	SECTION	COUNTY	TOTAL SHEETS	SHEET NO.
pw:\IL\084EBIDINTEG\Illinois.gov\PWIDOT\Documents\DOT Offices\District 1\Projects\P145409\Drawings\Design\P145409-shr-cover.dgn		CHECKED -	REVISED -		104	105N-4	LAKE	113	51			
Default	PLOT SCALE = 100.0000' / 1in.	DATE -	REVISED -		SCALE: 1"=50'			SHEET OF SHEETS STA. TO STA.		CONTRACT NO. 60W06		
	PLOT DATE = 8/29/2016				ILLINOIS FED. AID PROJECT							



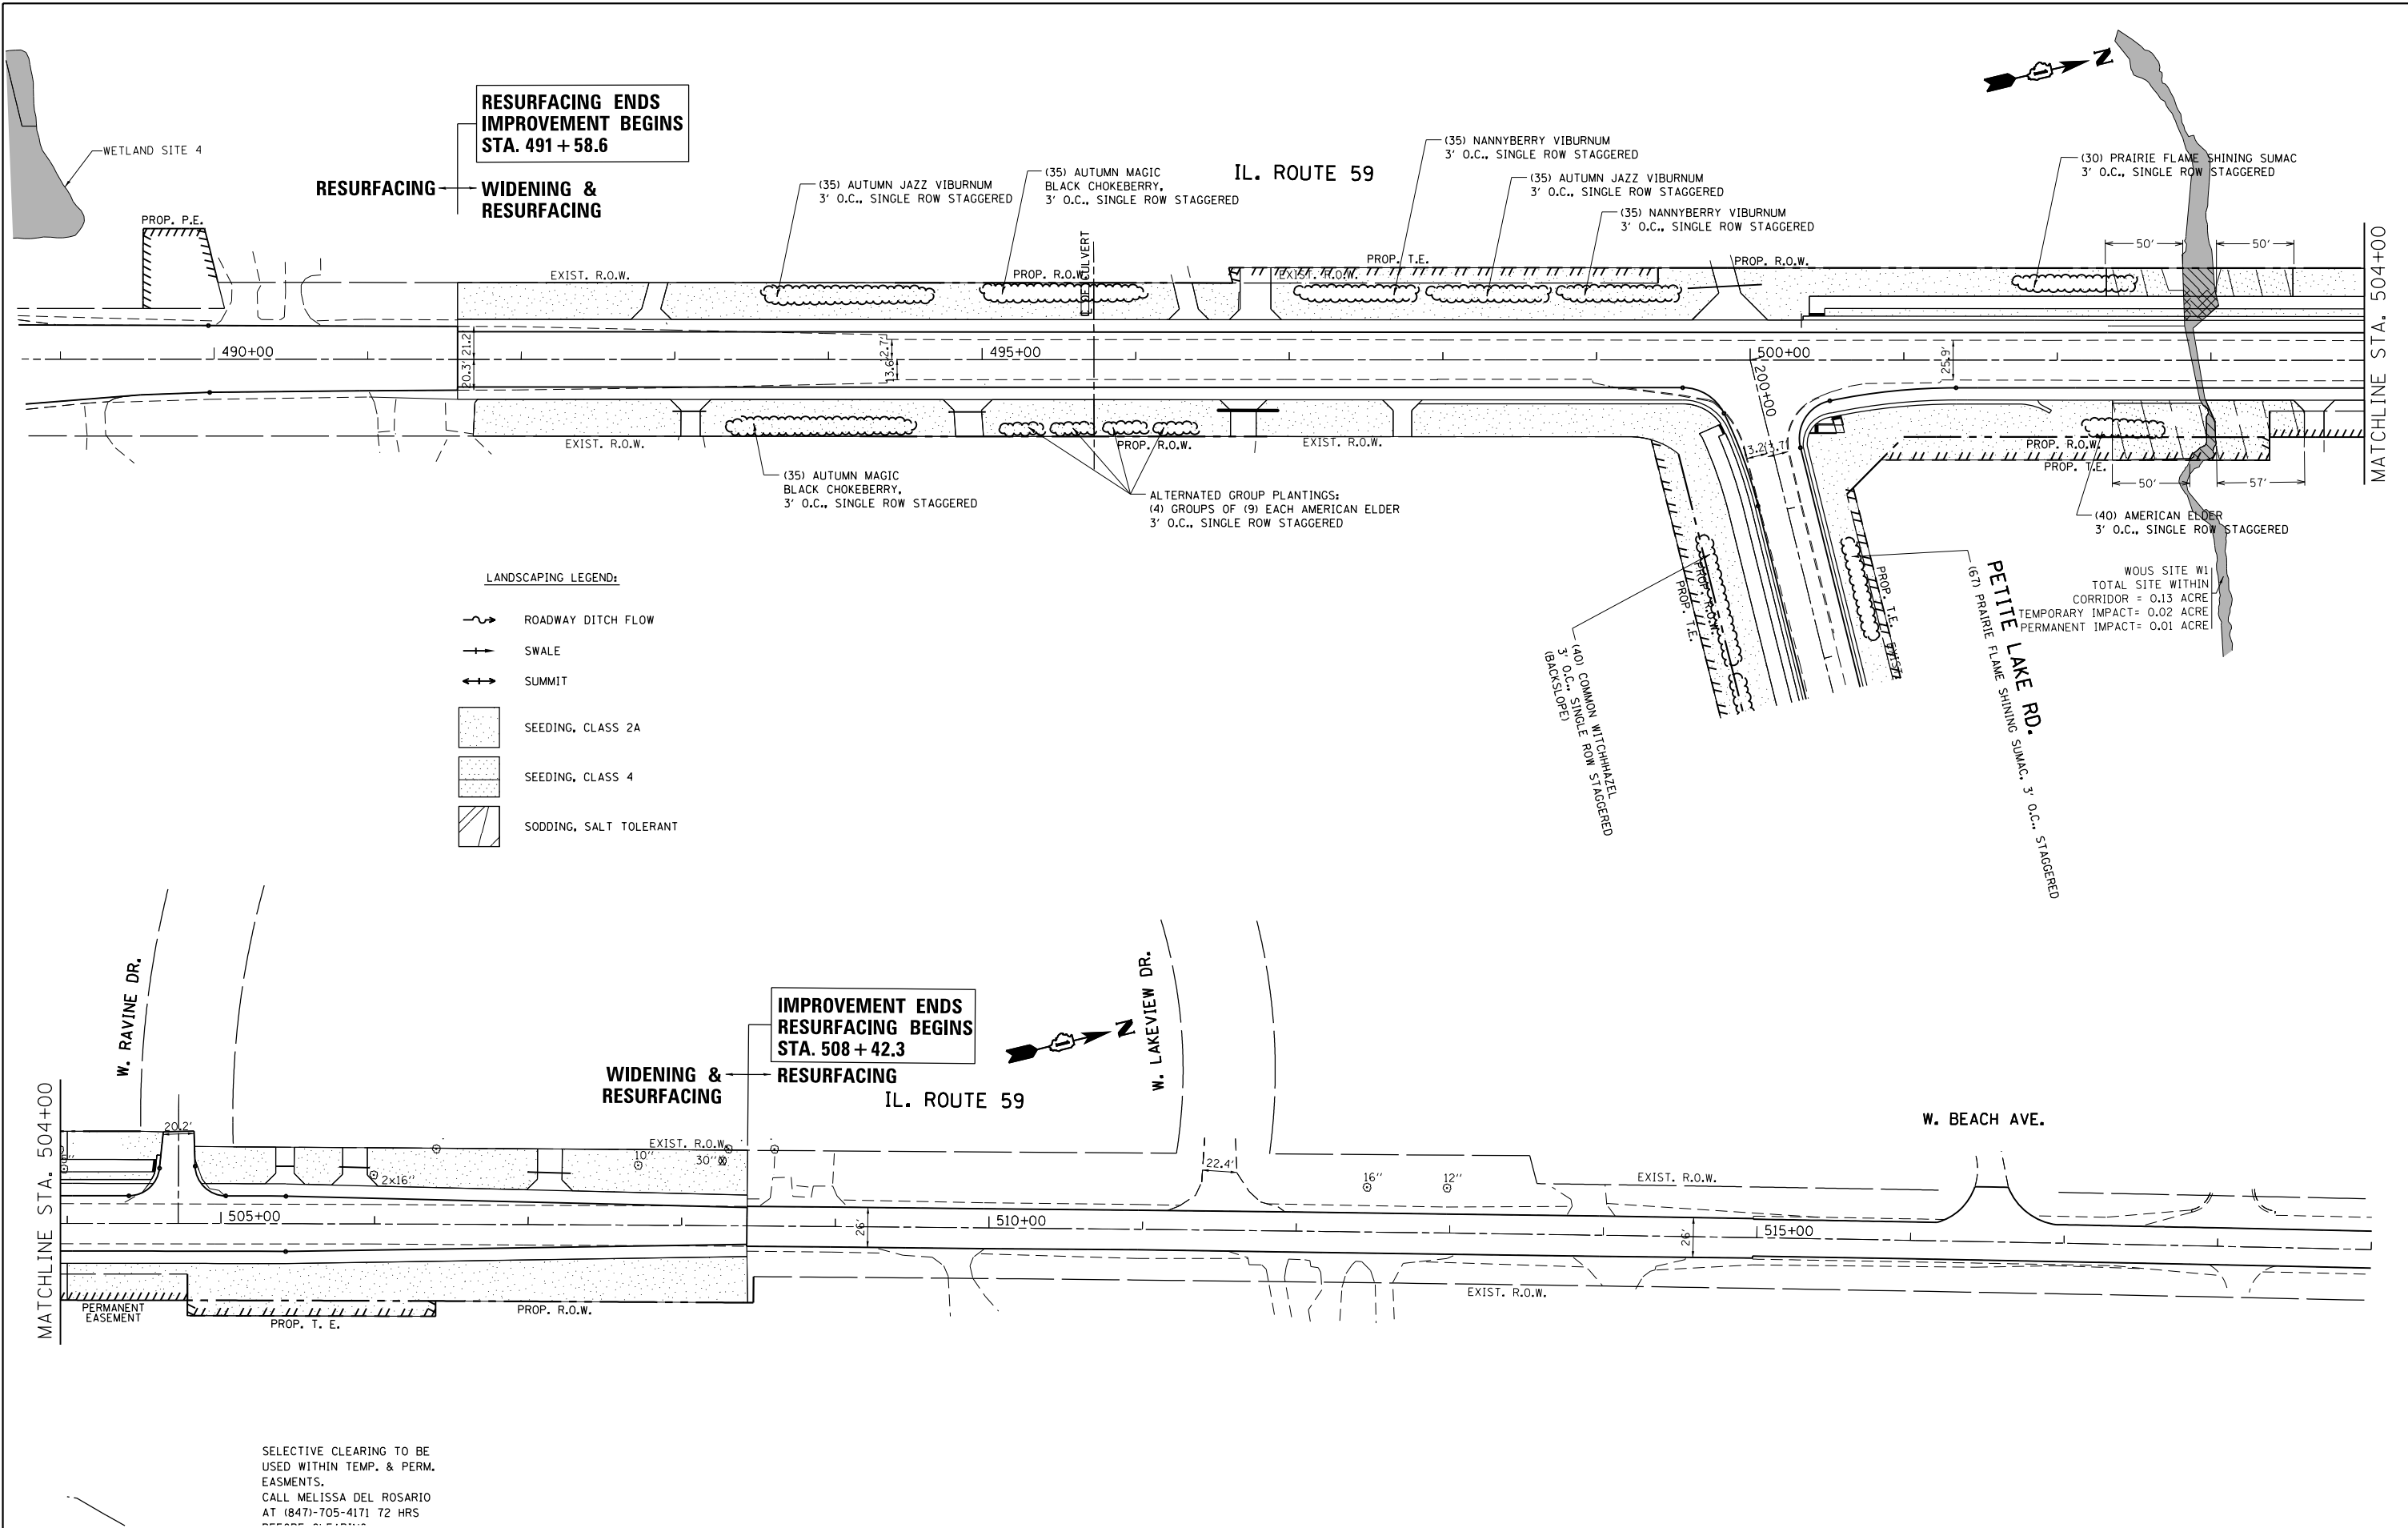


SELECTIVE CLEARING TO BE USED WITHIN TEMP. & PERM. EASEMENTS.  
 CALL MELISSA DEL ROSARIO AT (847)-705-4171 72 HRS

FILE NAME =	USER NAME = ldezmarm	DESIGNED -	REVISED -
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Default	PLOT SCALE = 100.0000' / 1"	CHECKED -	REVISED -
	PLOT DATE = 9/19/2016	DATE -	REVISED -

**STATE OF ILLINOIS  
 DEPARTMENT OF TRANSPORTATION**

<b>PROPOSED LANDSCAPING PLAN</b>			
<b>IL. ROUTE 59 AT PETITE LAKE RD</b>			
SCALE: 1"=50'	SHEET	OF SHEETS	STA. TO STA.

F.A.P. RTE.	SECTION	COUNTY	TOTAL SHEETS	SHEET NO.
104	105N-4	LAKE	113	53
CONTRACT NO. 60W06				
ILLINOIS FED. AID PROJECT				

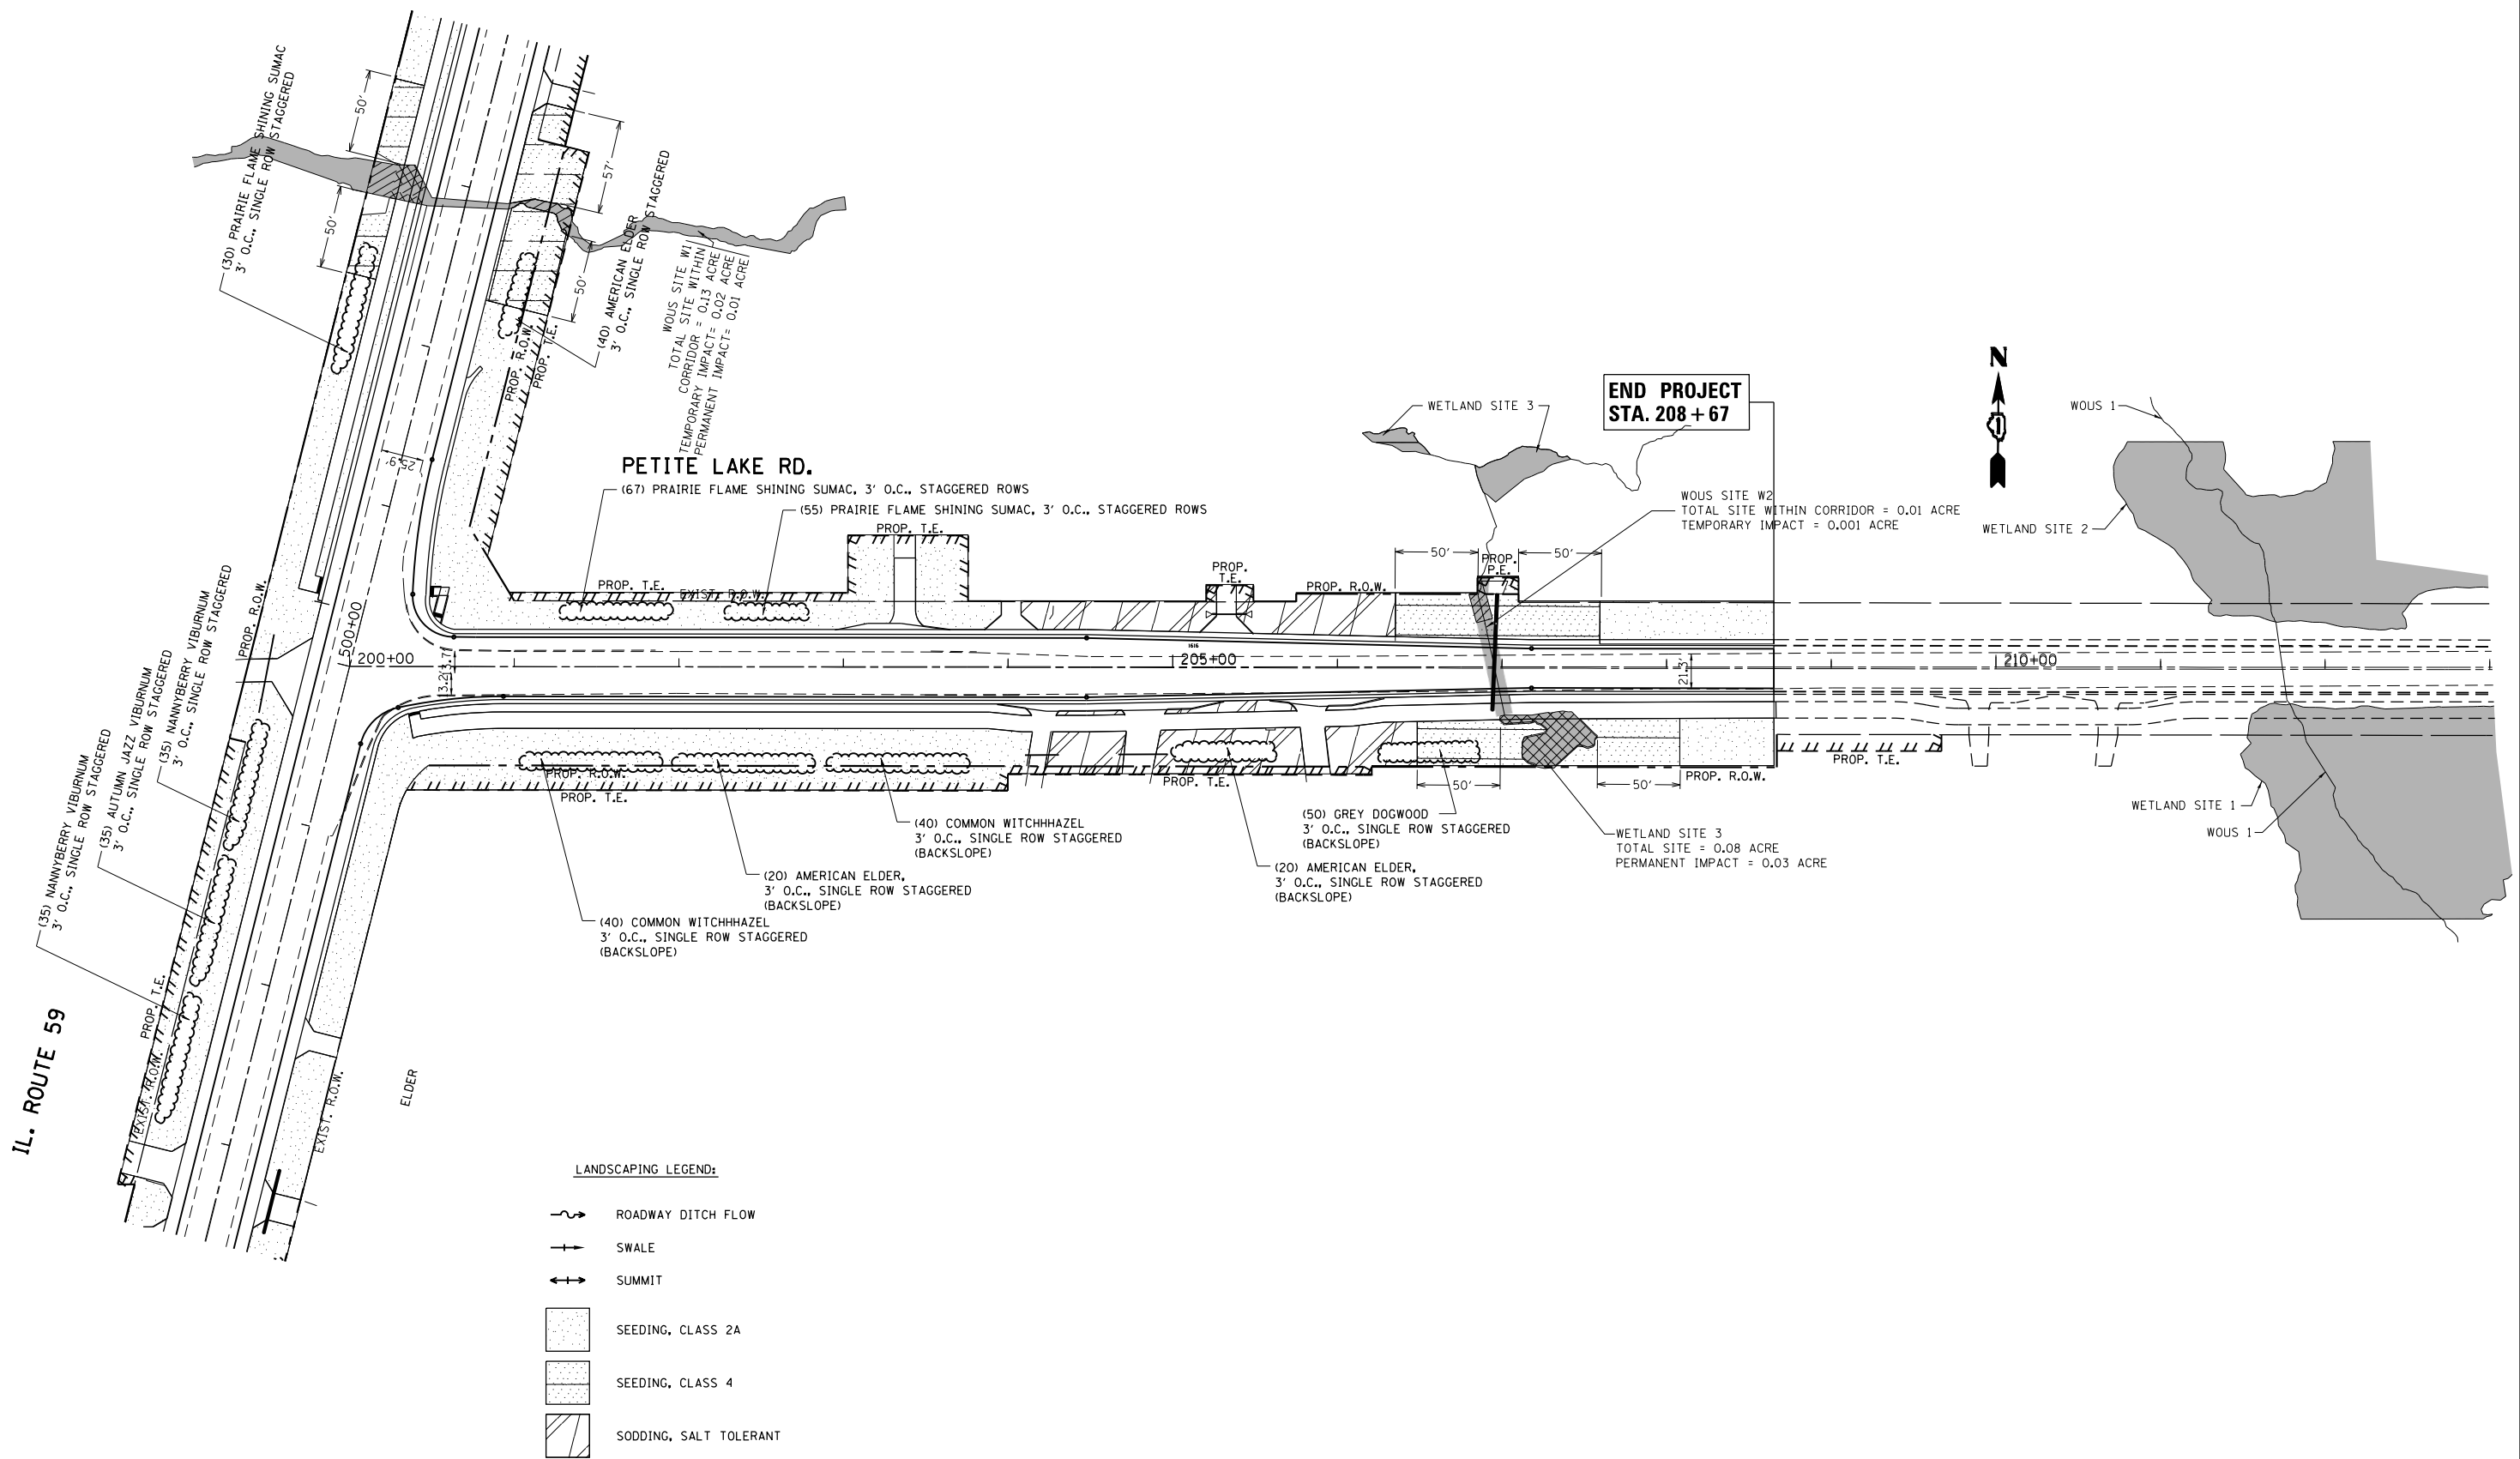

**LANDSCAPING LEGEND:**


	ROADWAY DITCH FLOW
	SWALE
	SUMMIT
	SEEDING, CLASS 2A
	SEEDING, CLASS 4
	SODDING, SALT TOLERANT

FILE NAME =	USER NAME = ldezma	DESIGNED -	REVISED -
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	PLOT DATE = 9/19/2016	DATE -	REVISED -

**STATE OF ILLINOIS  
DEPARTMENT OF TRANSPORTATION**

<b>PROPOSED LANDSCAPING PLAN IL. ROUTE 59 AT PETITE LAKE RD</b>			
SCALE: 1"=50'	SHEET	OF SHEETS	STA. TO STA.

F.A.P. RTE.	SECTION	COUNTY	TOTAL SHEETS	SHEET NO.
104	105N-4	LAKE	113	54
CONTRACT NO. 60W06				
ILLINOIS FED. AID PROJECT				

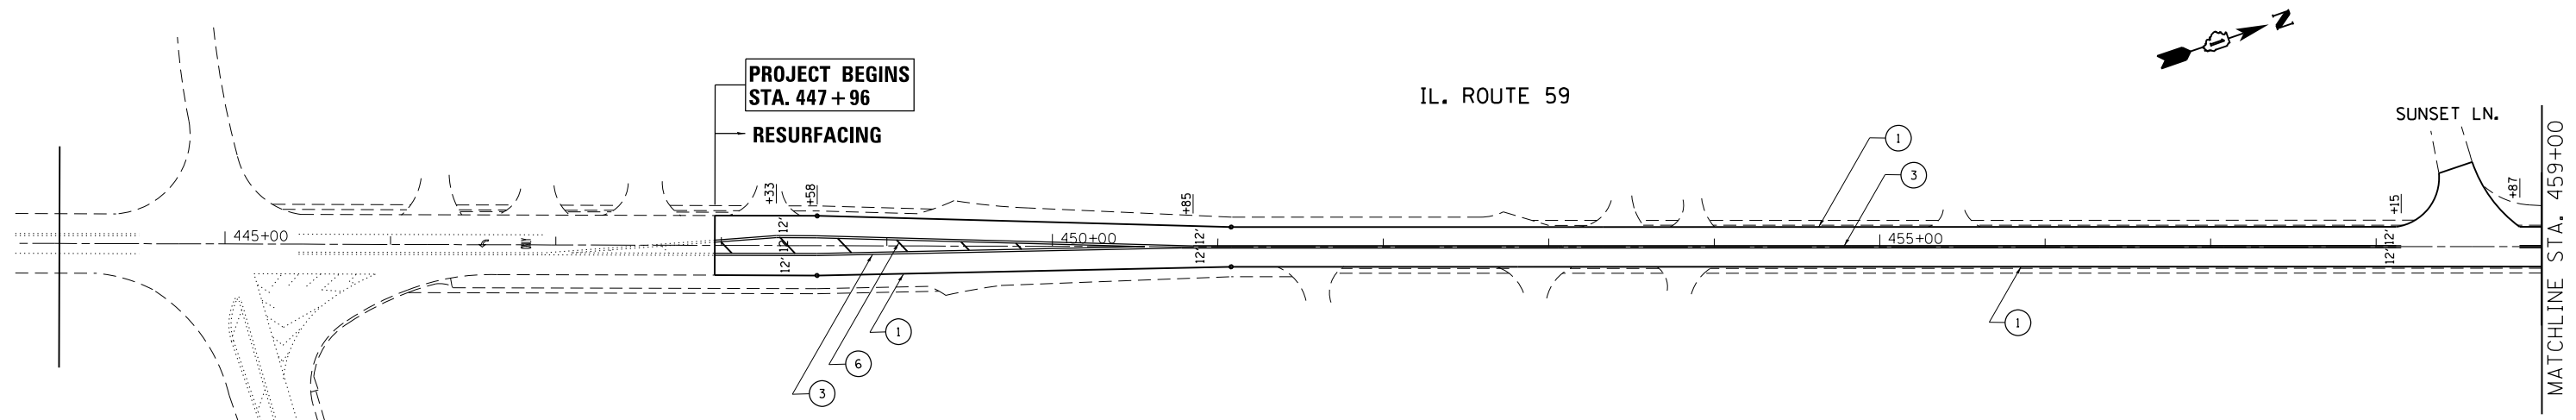

**PAVEMENT MARKING LEGEND**

- ① THERMOPLASTIC PAVEMENT MARKING EDGELINE, 4" SOLID WHITE
- ② THERMOPLASTIC PAVEMENT MARKING 4" YELLOW LINES, 5-1/2" C-C
- ③ THERMOPLASTIC PAVEMENT MARKING MEDIAN EDGELINE, 4" SOLID DOUBLE YELLOW (2 @ 11" C-C)
- ④ THERMOPLASTIC PAVEMENT MARKING TURN LANE LINE, 6" SOLID WHITE
- \* ⑤ THERMOPLASTIC PAVEMENT MARKING CROSSWALK - 12" WIDTH 2" SPACING SOLID WHITE
- ⑥ THERMOPLASTIC PAVEMENT MARKING 12" SOLID YELLOW (RT. 45° DIAGONALS @ 20' C-C)
- ⑦ THERMOPLASTIC PAVEMENT MARKING STOP BAR, 24" SOLID WHITE
- ⑧ THERMOPLASTIC PAVEMENT MARKING TURN ARROWS WHITE (ADDITIONAL PAIRS TO BE PLACED AT 200' TO 300' INTERVALS)
- ⑨ THERMOPLASTIC PAVEMENT MARKING LEFT & RIGHT TURN ONLY LETTERS & SYMBOLS, 8' WHITE
- ⑩ THERMOPLASTIC PAVEMENT MARKING SHOULDER DIAGONALS, 12" SOLID WHITE (RT. 45° DIAGONALS @ 75" C-C)
- ⑪ THERMOPLASTIC PAVEMENT MARKING DOTTED LINE, 6" SOLID WHITE (2' LINE 6' SPACE)
- \* ⑫ THERMOPLASTIC PAVEMENT MARKING EDGE LINE, 5" SOLID WHITE (PETITE LAKE ROAD ONLY)

**PAVEMENT MARKING NOTES (LAKE COUNTY):**

PAVEMENT MARKING SHALL BE THERMOPLASTIC OF THE EXTRUDED TYPE FOR IL 59, AND PETITE LAKE RD. BOTH PAVEMENT MARKINGS WITH THE TYPE AND MATERIAL SHOULD BE PLACE IN ACCORDANCE WITH THE DISTRICT ONE "TYPICAL PAVEMENT MARKING DETAILS".

RAISED REFLECTIVE PAVEMENT MARKERS SHALL BE IN ACCORDANCE WITH THE DISTRICT ONE "TYPICAL APPLICATION RAISED REFLECTIVE PAVEMENT MARKERS DETAILS".

THE RESIDENT ENGINEER SHALL CONTACT WALTER CZARNY, TRAFFIC FIELD ENGINEER AT (847) 715-8419 A MINIMUM OF TWO WEEKS PRIOR TO THE PLACEMENT OF ANY PERMANENT PAVEMENT MARKINGS.

\* REFER TO LAKE COUNTY PAVEMENT MARKING STANDARDS AND DETAILS


FILE NAME =	USER NAME = ledezmar	DESIGNED -	REVISED -	<b>STATE OF ILLINOIS DEPARTMENT OF TRANSPORTATION</b>	<b>PROPOSED PAVEMENT MARKING PLAN IL. ROUTE 59 AT PETITE LAKE RD</b>				F.A.P. RTE.	SECTION	COUNTY	TOTAL SHEETS	SHEET NO.
pw:\IL\084EBIDINTEG.illinois.gov\PWIDOT\Documents\DOT Offices\District 1\Projects\P145409\Drawings\Design\P145409-shr-cover.dgn		CHECKED -	REVISED -		104	105N-4	LAKE	113	55				
Default	PLOT SCALE = 100.0000' / in.	DATE -	REVISED -		CONTRACT NO. 60W06				ILLINOIS FED. AID PROJECT				
	PLOT DATE = 8/19/2016				SCALE: 1"=50'	SHEET OF SHEETS	STA. TO STA.						

MATCHLINE STA. 459+00

MATCHLINE STA. 474+00

IL. ROUTE 59 W. WARREN AVE.

W. BUENA AVE.

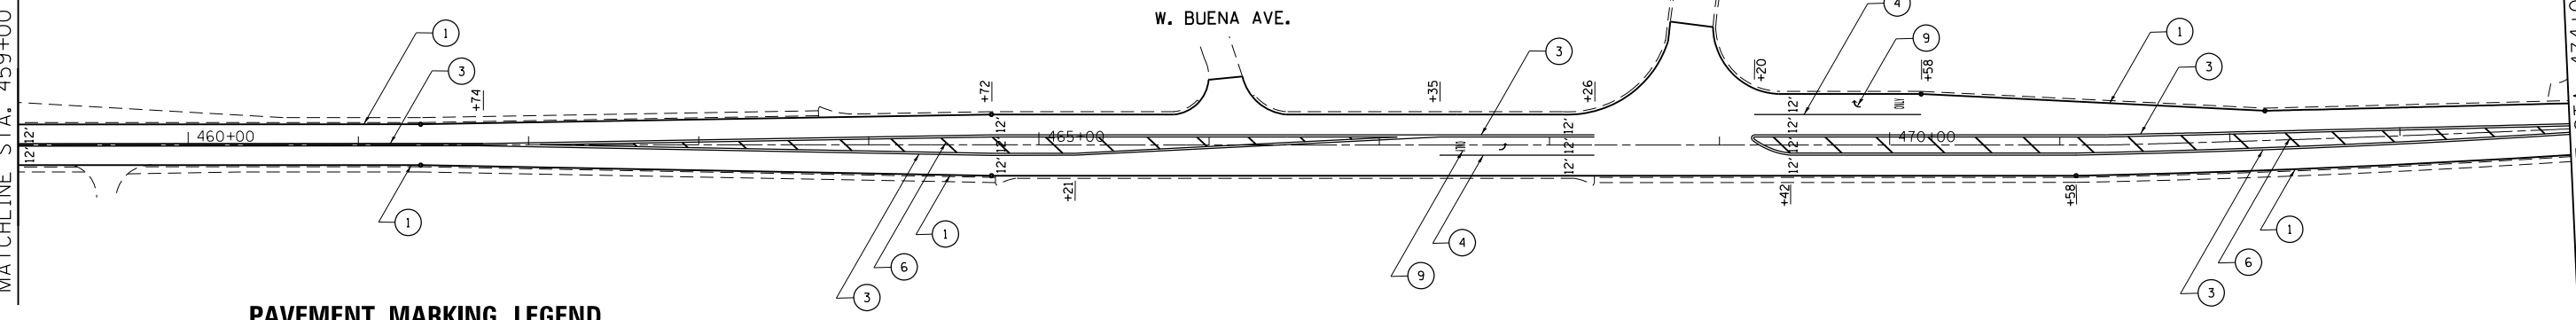

**PAVEMENT MARKING LEGEND**

- ① THERMOPLASTIC PAVEMENT MARKING EDGELINE, 4" SOLID WHITE
- ② THERMOPLASTIC PAVEMENT MARKING 4" YELLOW LINES, 5-1/2" C-C
- ③ THERMOPLASTIC PAVEMENT MARKING MEDIAN EDGELINE, 4" SOLID DOUBLE YELLOW (2 @ 11" C-C)
- ④ THERMOPLASTIC PAVEMENT MARKING TURN LANE LINE, 6" SOLID WHITE
- \* ⑤ THERMOPLASTIC PAVEMENT MARKING CROSSWALK - 12" WIDTH 2" SPACING SOLID WHITE
- ⑥ THERMOPLASTIC PAVEMENT MARKING 12" SOLID YELLOW (RT. 45° DIAGONALS @ 20" C-C)
- ⑦ THERMOPLASTIC PAVEMENT MARKING STOP BAR, 24" SOLID WHITE
- ⑧ THERMOPLASTIC PAVEMENT MARKING TURN ARROWS WHITE (ADDITIONAL PAIRS TO BE PLACED AT 200' TO 300' INTERVALS)
- ⑨ THERMOPLASTIC PAVEMENT MARKING LEFT & RIGHT TURN ONLY LETTERS & SYMBOLS, 8" WHITE
- ⑩ THERMOPLASTIC PAVEMENT MARKING SHOULDER DIAGONALS, 12" SOLID WHITE (RT. 45° DIAGONALS @ 75" C-C)
- ⑪ THERMOPLASTIC PAVEMENT MARKING DOTTED LINE, 6" SOLID WHITE (2' LINE 6' SPACE)
- \* ⑫ THERMOPLASTIC PAVEMENT MARKING EDGE LINE, 5" SOLID WHITE (PETITE LAKE ROAD ONLY)

**PAVEMENT MARKING NOTES (LAKE COUNTY):**

PAVEMENT MARKING SHALL BE THERMOPLASTIC OF THE EXTRUDED TYPE FOR IL 59, AND PETITE LAKE RD. BOTH PAVEMENT MARKINGS WITH THE TYPE AND MATERIAL SHOULD BE PLACE IN ACCORDANCE WITH THE DISTRICT ONE "TYPICAL PAVEMENT MARKING DETAILS".

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THE RESIDENT ENGINEER SHALL CONTACT WALTER CZARNY, TRAFFIC FIELD ENGINEER AT (847) 715-8419 A MINIMUM OF TWO WEEKS PRIOR TO THE PLACEMENT OF ANY PERMANENT PAVEMENT MARKINGS.

\* REFER TO LAKE COUNTY PAVEMENT MARKING STANDARDS AND DETAILS

MATCHLINE STA. 474+00

MATCHLINE STA. 489+00

IL. ROUTE 59

W. COLUMBIA BAY RD.

W. DERLING LN.



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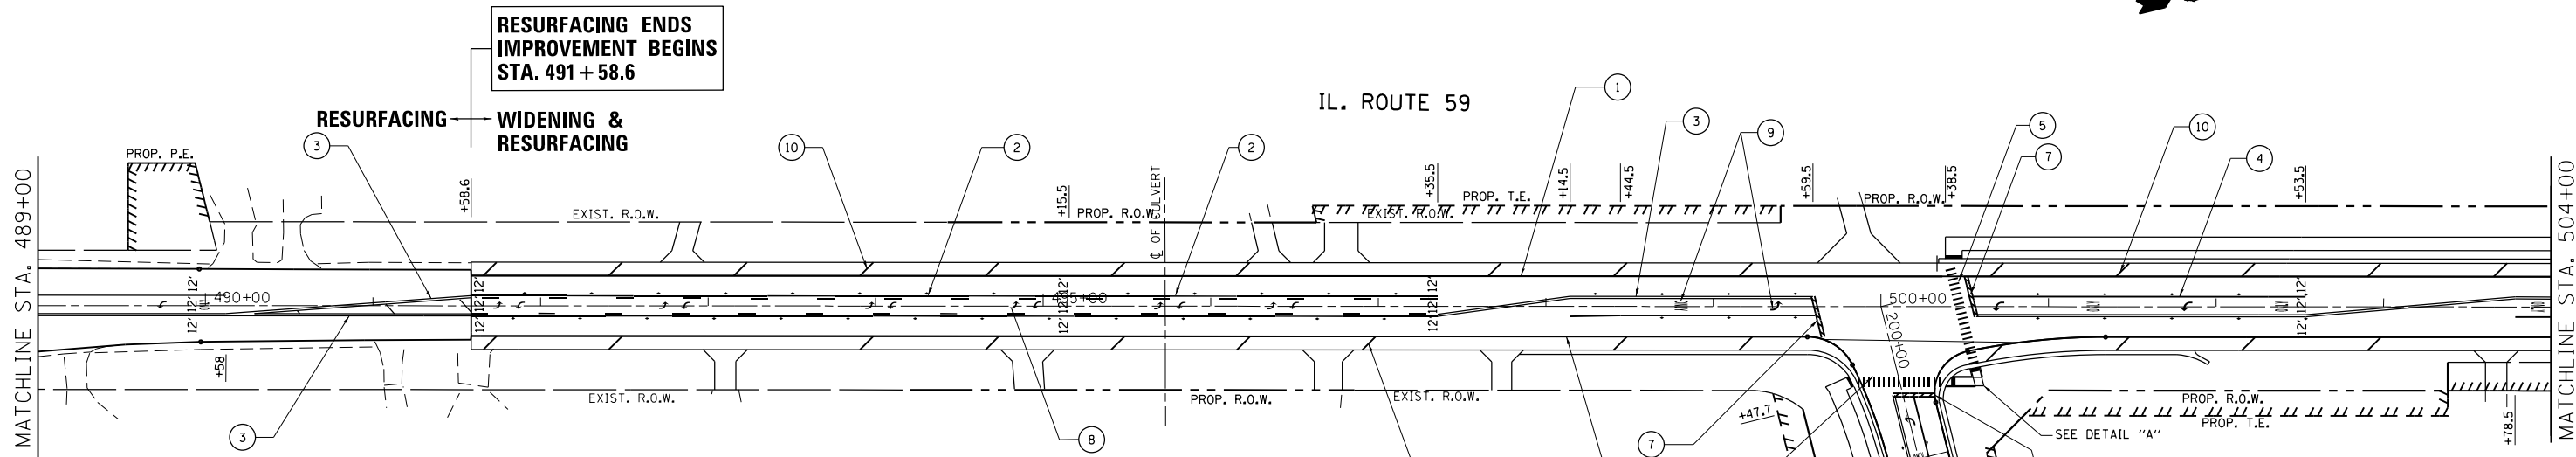
**STATE OF ILLINOIS  
DEPARTMENT OF TRANSPORTATION**

**PROPOSED PAVEMENT MARKING PLAN  
IL. ROUTE 59 AT PETITE LAKE RD**

SCALE: 1"=50' SHEET OF SHEETS STA. TO STA.

F.A.P. RTE.	SECTION	COUNTY	TOTAL SHEETS	SHEET NO.
104	105N-4	LAKE	113	56
CONTRACT NO. 60W06				
ILLINOIS FED. AID PROJECT				





**PAVEMENT MARKING LEGEND**

- ① THERMOPLASTIC PAVEMENT MARKING EDGELINE, 4" SOLID WHITE
- ② THERMOPLASTIC PAVEMENT MARKING 4" YELLOW LINES, 5-1/2" C-C
- ③ THERMOPLASTIC PAVEMENT MARKING MEDIAN EDGELINE, 4" SOLID DOUBLE YELLOW (2 @ 11" C-C)
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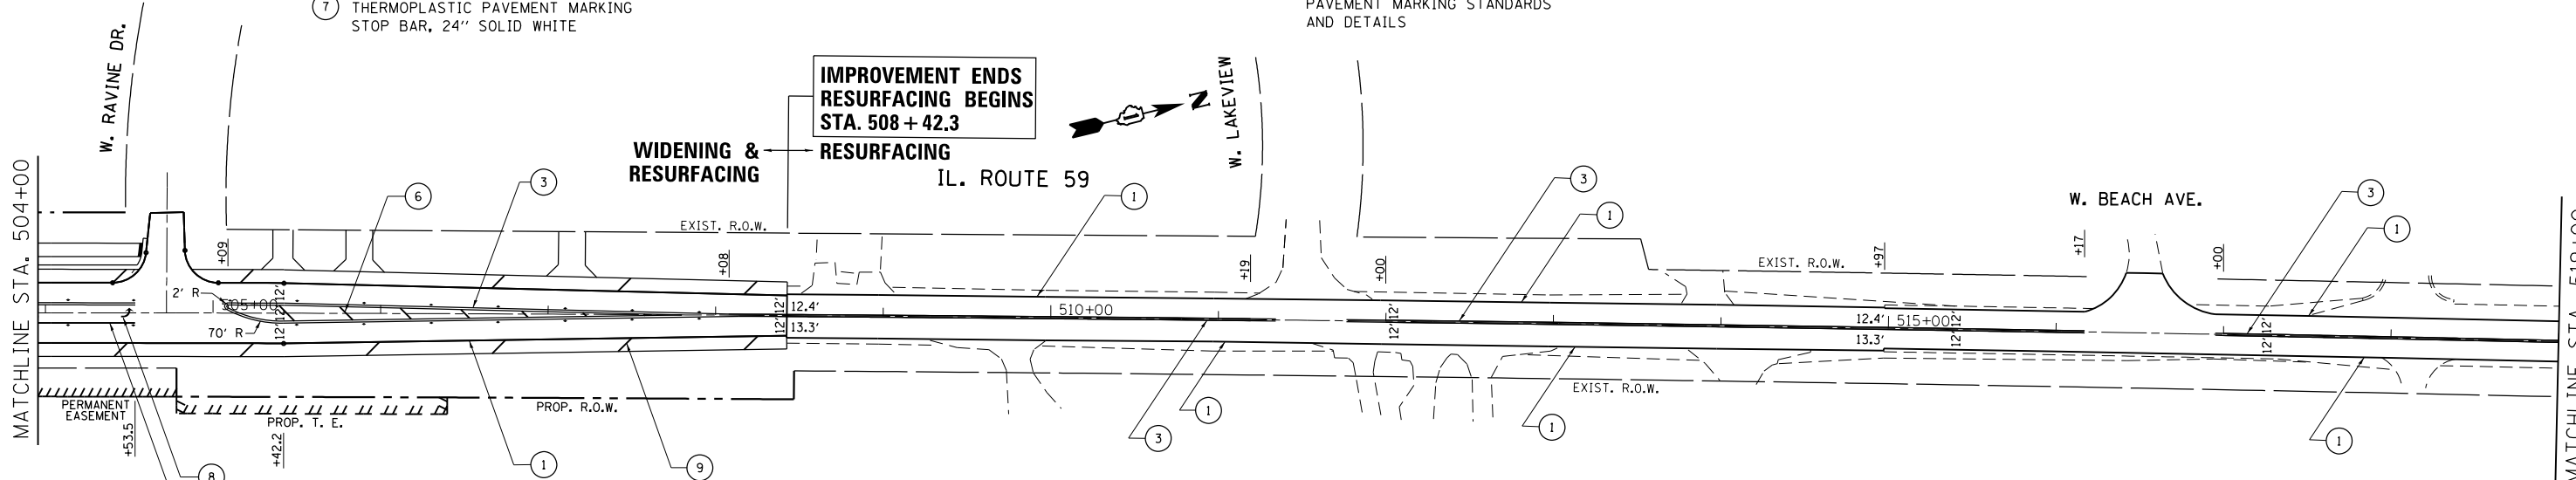
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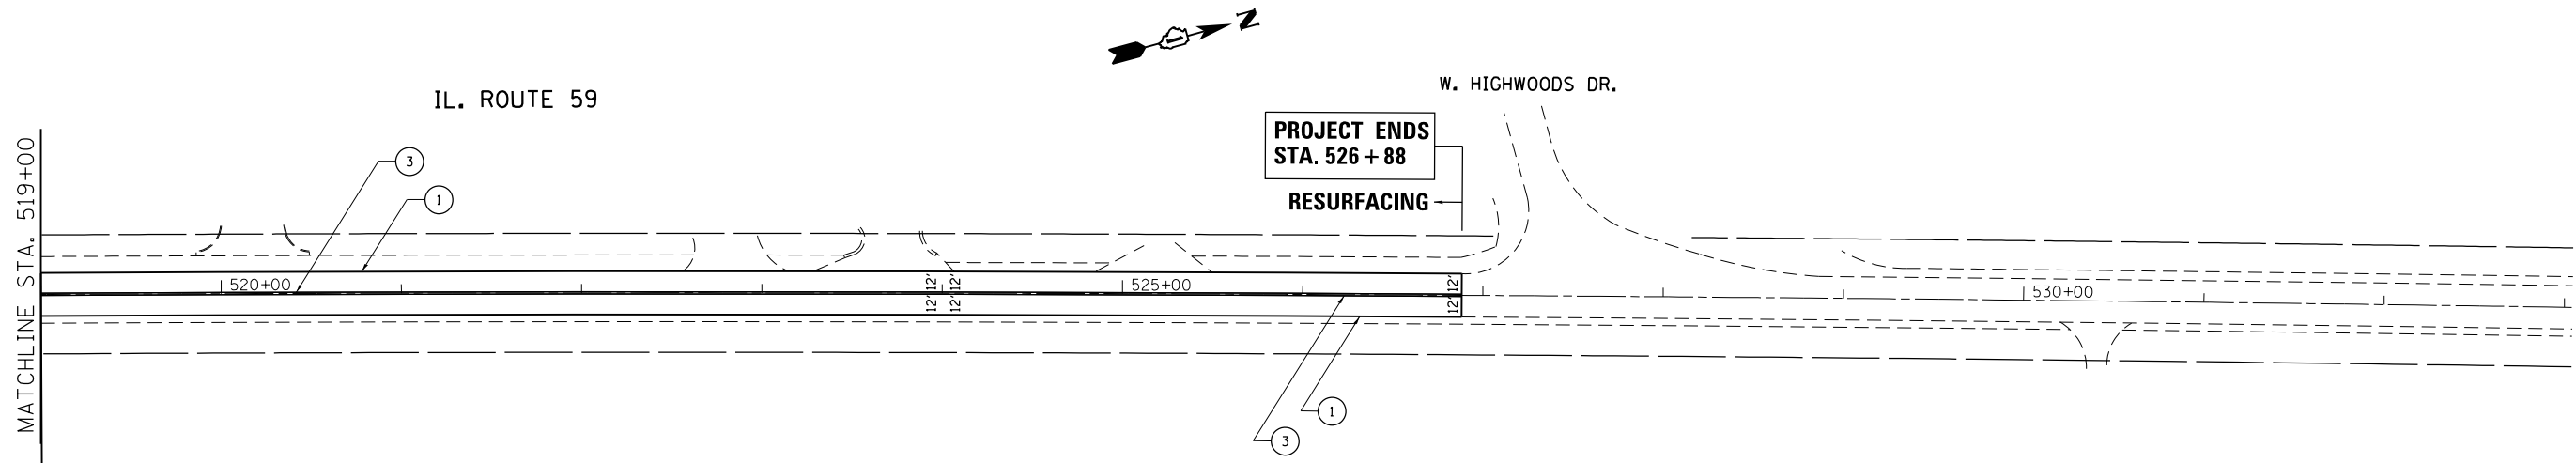
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**STATE OF ILLINOIS  
DEPARTMENT OF TRANSPORTATION**

**PROPOSED PAVEMENT MARKING PLAN  
IL. ROUTE 59 AT PETITE LAKE RD**

SCALE: 1"=50' SHEET OF SHEETS STA. TO STA.

F.A.P. RTE.	SECTION	COUNTY	TOTAL SHEETS	SHEET NO.
104	105N-4	LAKE	113	57
CONTRACT NO. 60W06				
ILLINOIS FED. AID PROJECT				



**PAVEMENT MARKING LEGEND**

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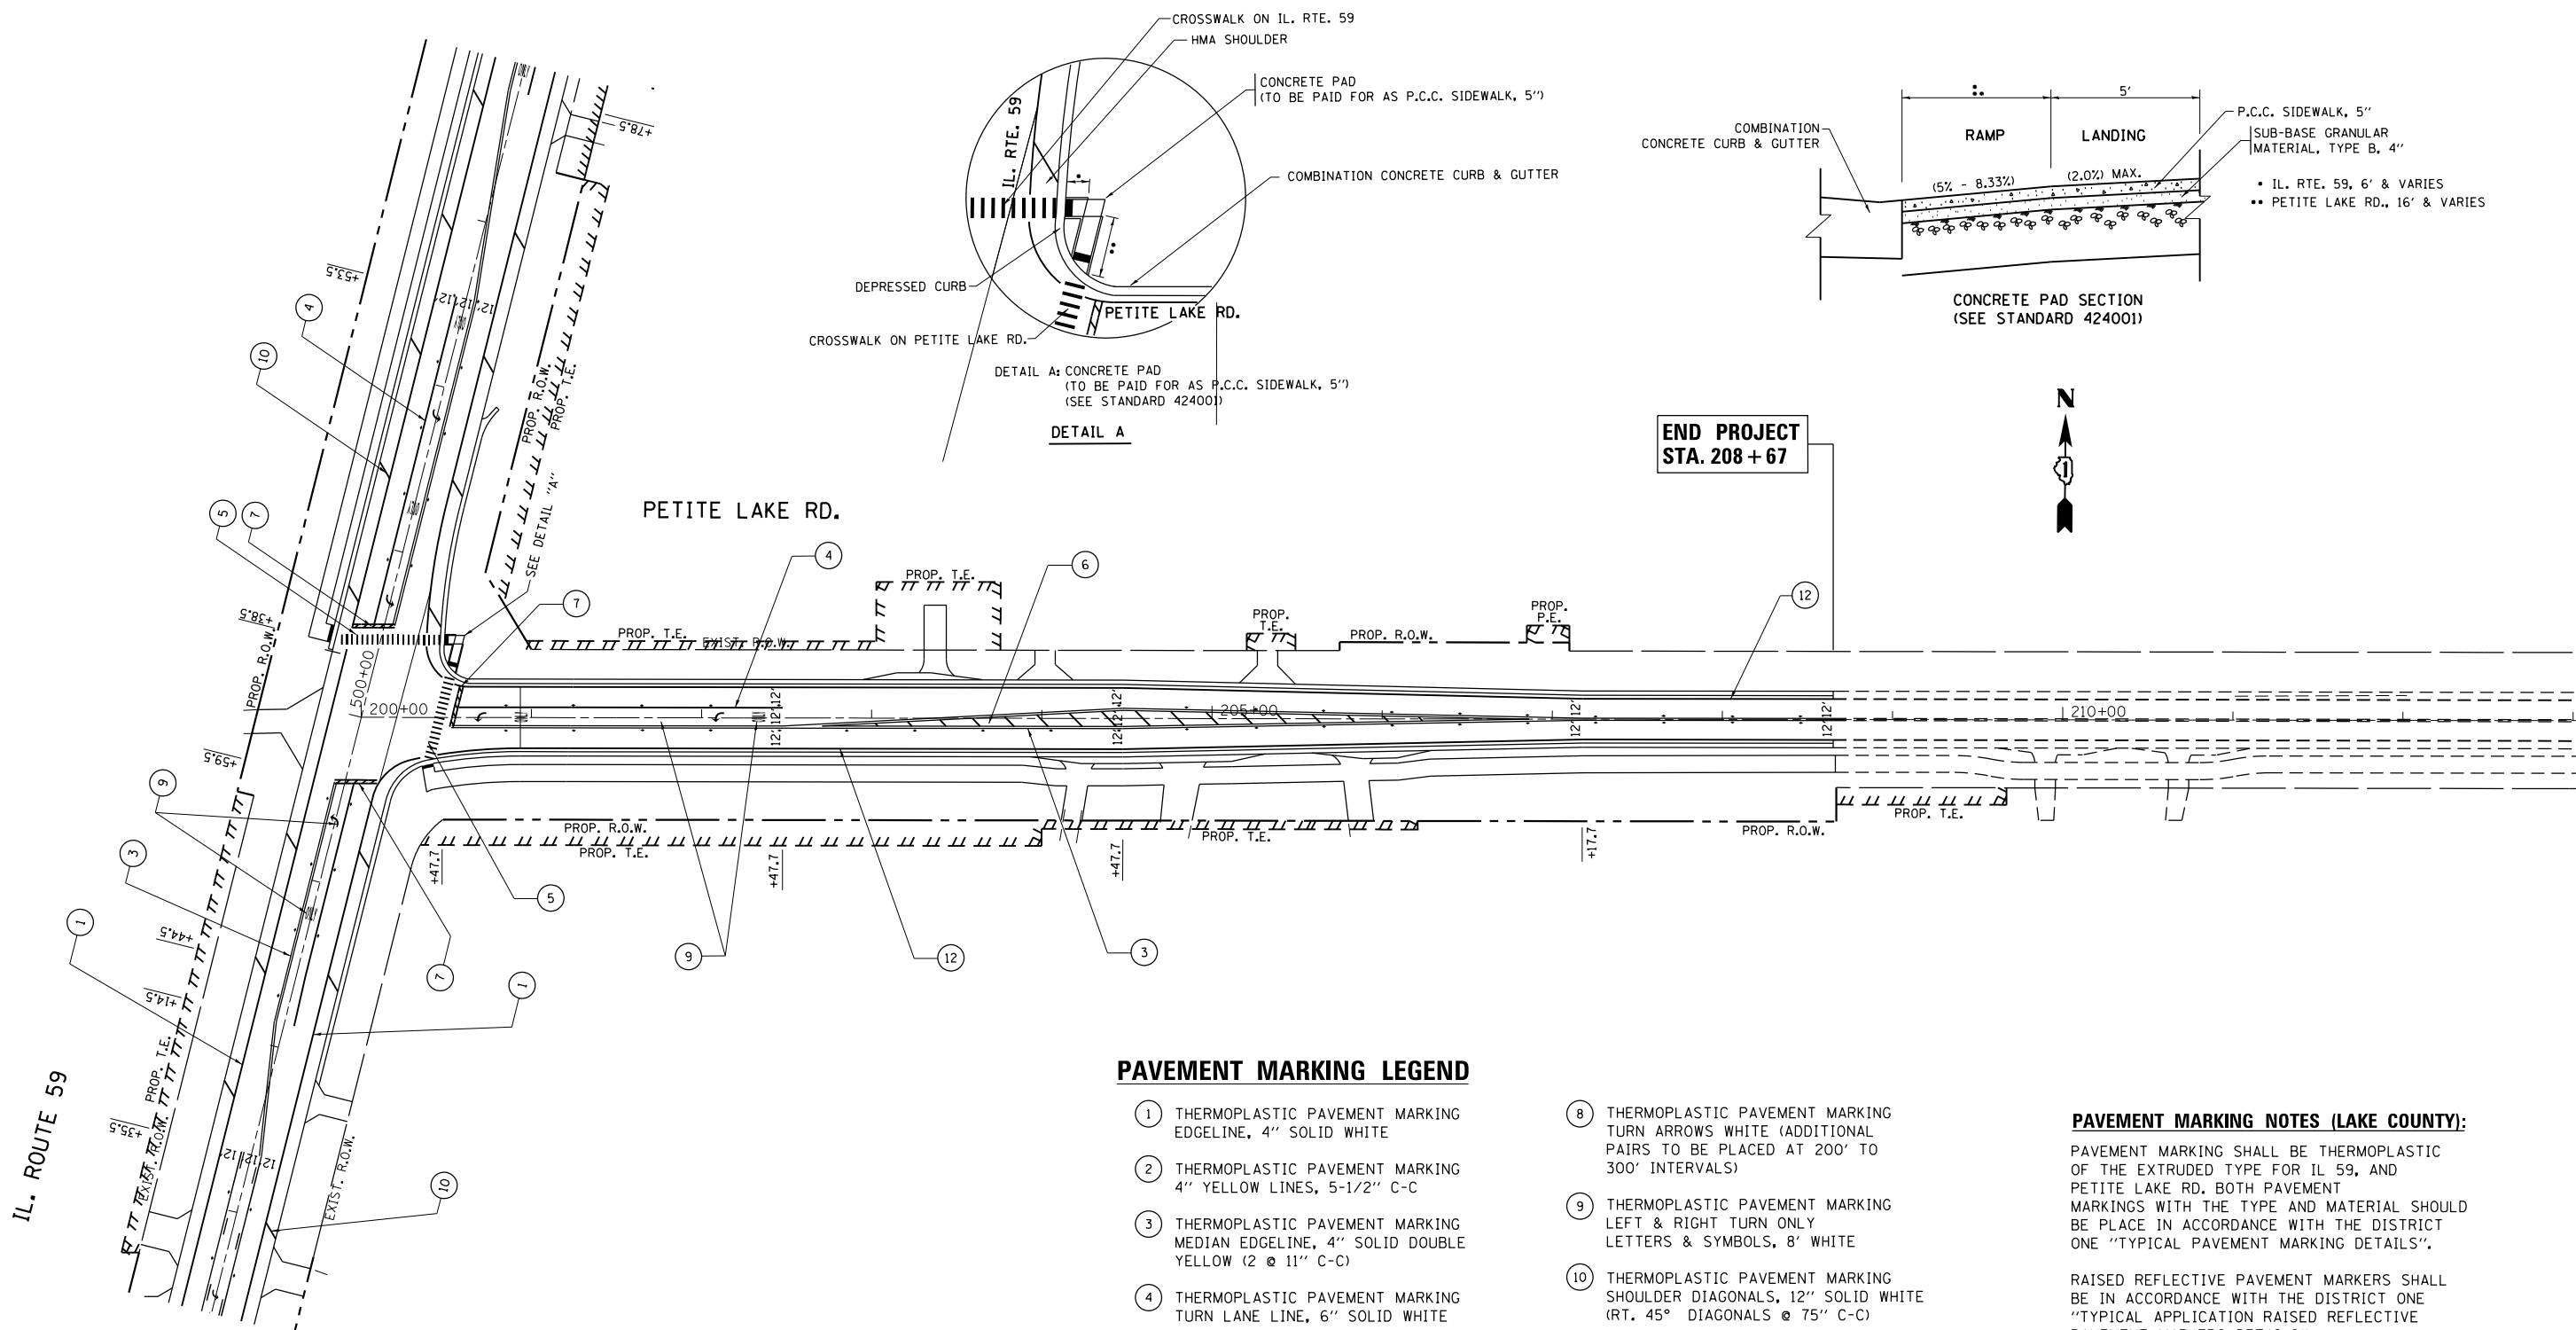
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Default	PLOT DATE = 8/19/2016	DATE -	REVISED -

**STATE OF ILLINOIS  
DEPARTMENT OF TRANSPORTATION**

**PROPOSED PAVEMENT MARKING PLAN  
IL. ROUTE 59 AT PETITE LAKE RD**

SCALE: 1"=50' SHEET OF SHEETS STA. TO STA.

F.A.P. RTE.	SECTION	COUNTY	TOTAL SHEETS	SHEET NO.
104	105N-4	LAKE	113	58
ILLINOIS FED. AID PROJECT			CONTRACT NO. 60W06	



**PAVEMENT MARKING LEGEND**

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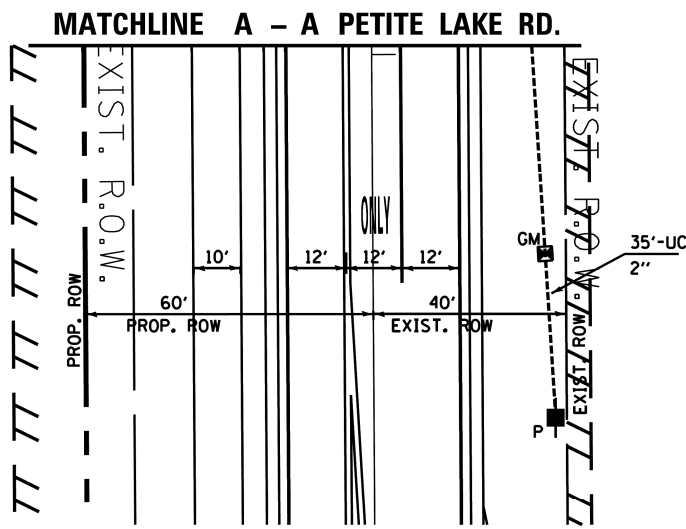
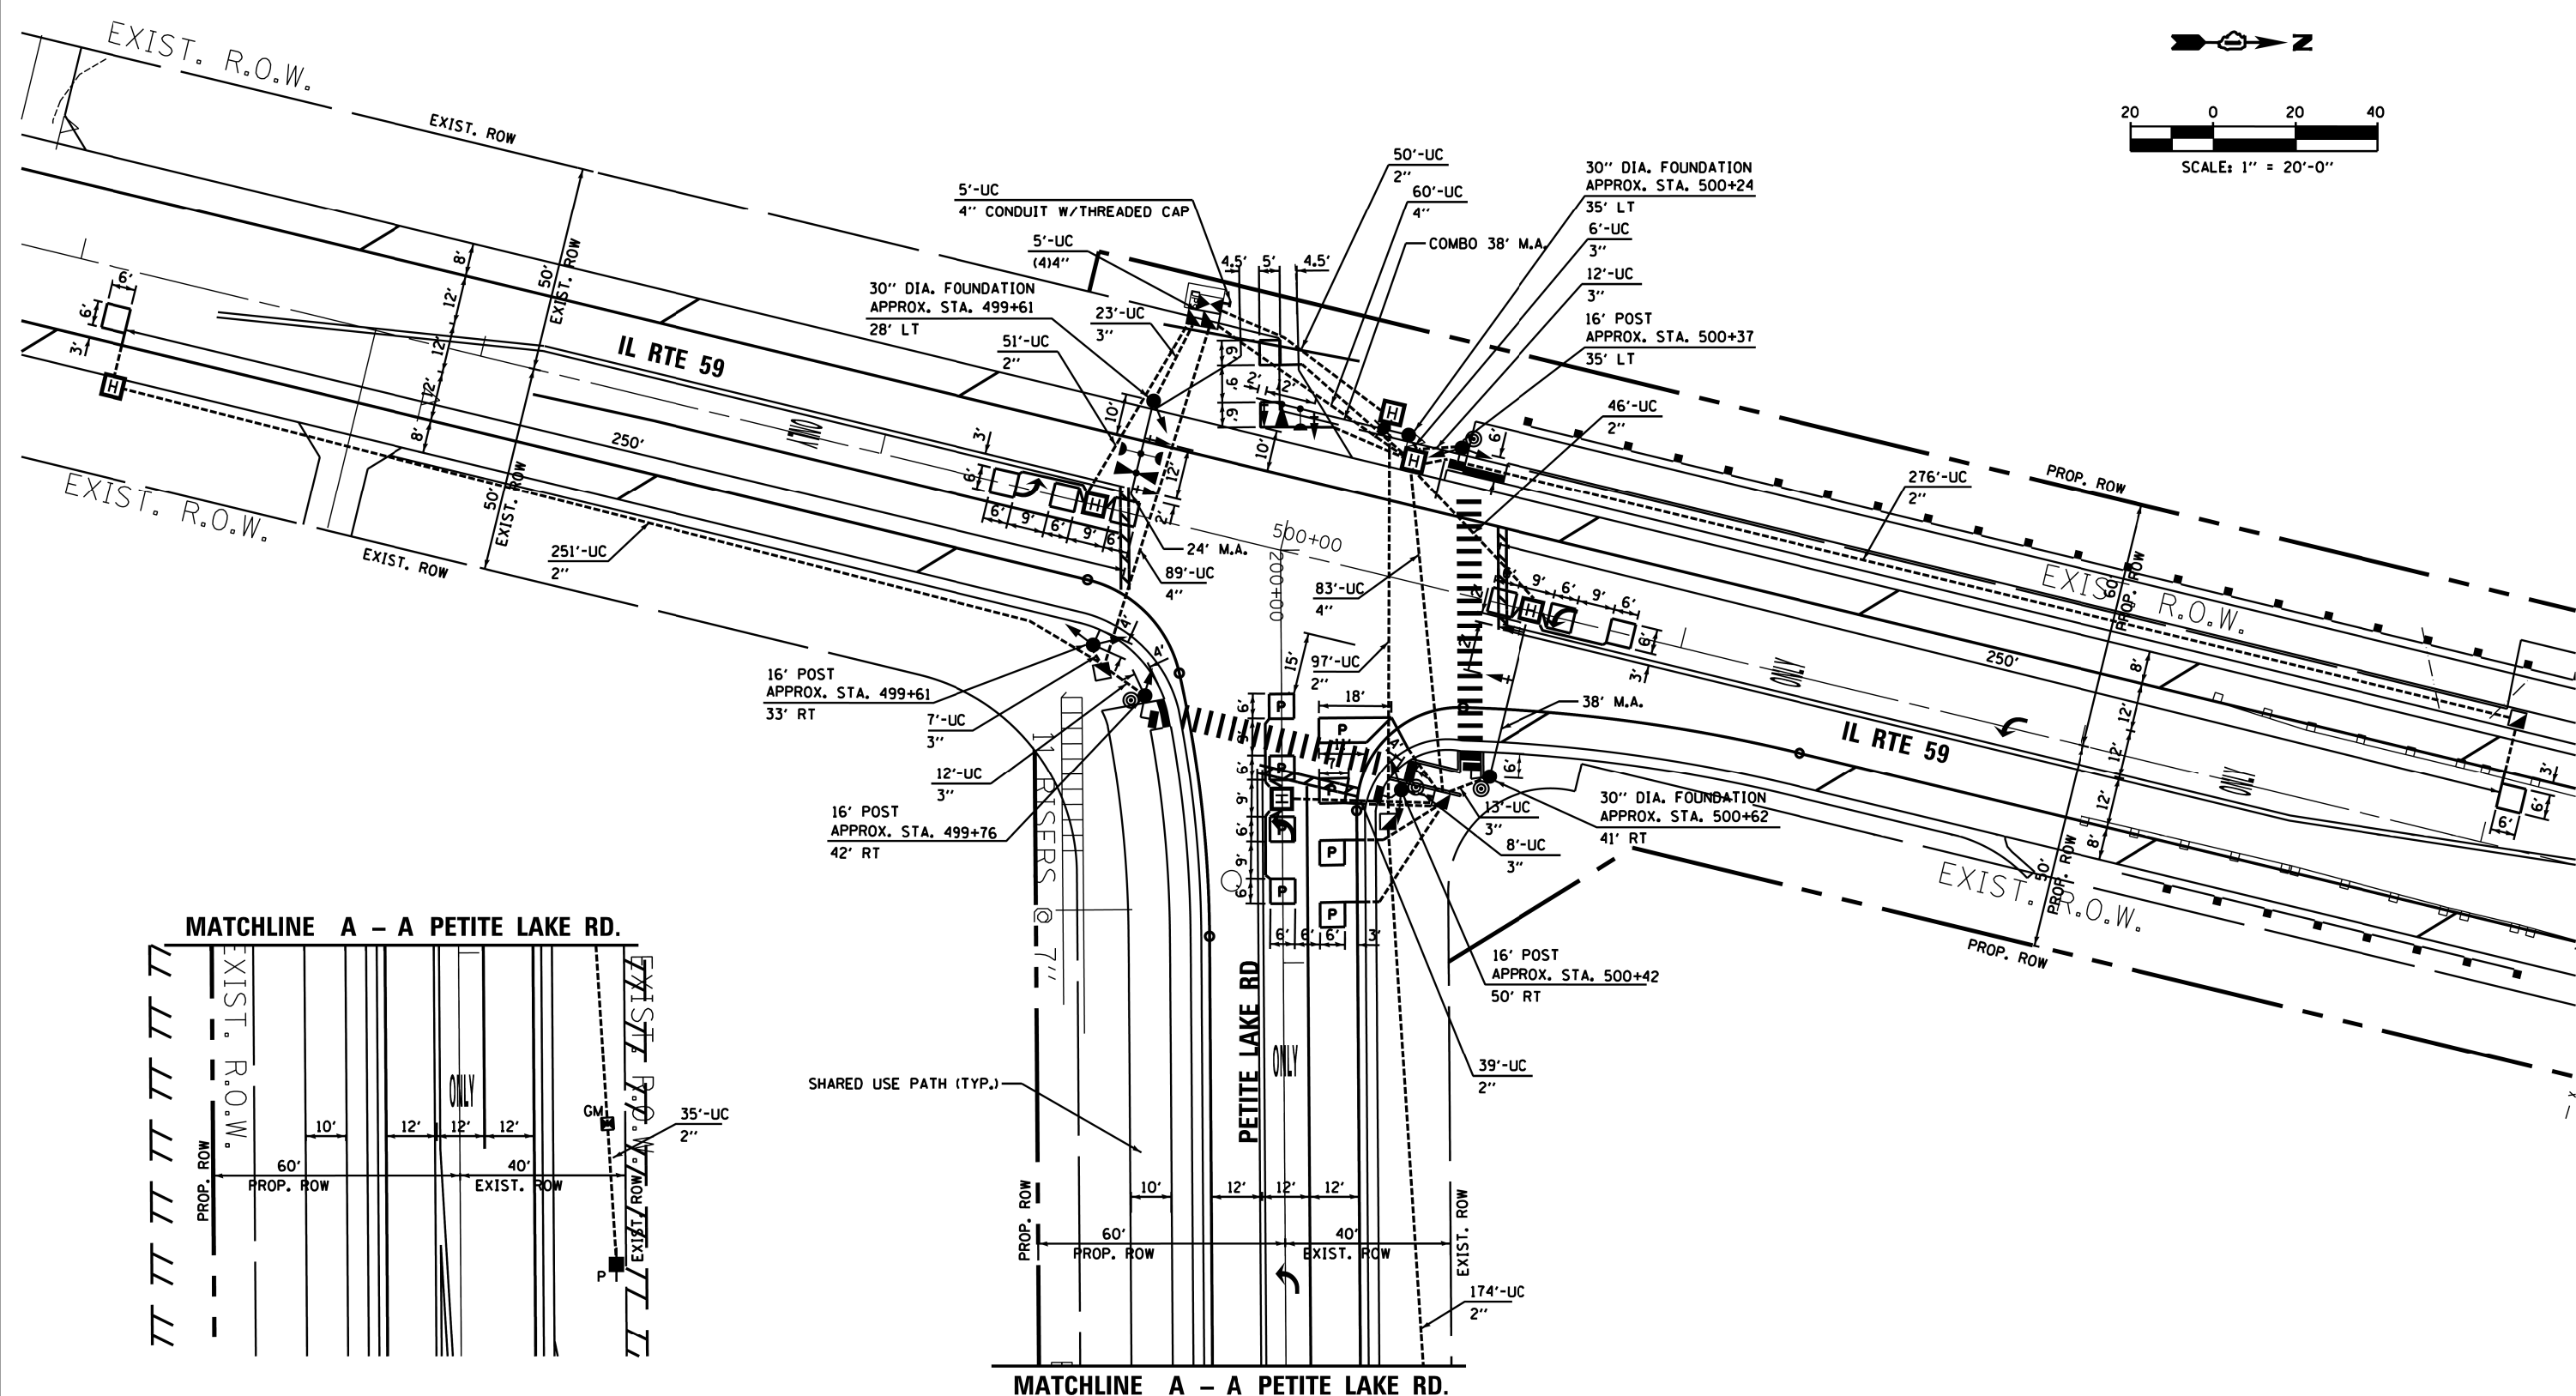
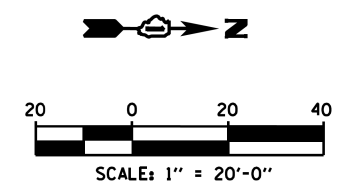
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\* REFER TO LAKE COUNTY PAVEMENT MARKING STANDARDS AND DETAILS

FILE NAME =	USER NAME = ldezmarm	DESIGNED -	REVISED -	<b>STATE OF ILLINOIS DEPARTMENT OF TRANSPORTATION</b>	<b>PROPOSED PAVEMENT MARKING PLAN IL. ROUTE 59 AT PETITE LAKE RD</b>				F.A.P. RTE.	SECTION	COUNTY	TOTAL SHEETS	SHEET NO.
pw\IL084EBIDINTEG.illinois.gov\PIWIDOT\Documents\IDOT Offices\District 1\Projects\P145409\Design\P145409-shr-cover.dgn		CHECKED -	REVISED -		104	105N-4	LAKE	113	59				
Default	PLOT SCALE = 100.0000' / 1in.	DATE -	REVISED -		SCALE: 1"=50'    SHEET    OF    SHEETS    STA.    TO    STA.				CONTRACT NO. 60W06				
	PLOT DATE = 8/19/2016				ILLINOIS FED. AID PROJECT								




**NOTES:**

1. EACH DETECTOR LOOP SHALL HAVE ITS OWN 1" COILABLE NON-METALLIC CONDUIT BETWEEN THE EDGE OF PAVEMENT AND THE ADJACENT HANDHOLE AS SHOWN ON THE PLANS AND AS STATED IN THE TRAFFIC SIGNAL SPECIFICATIONS.


TS 21635

FILE NAME =	USER NAME = curryjo	DESIGNED - DW	REVISED -	<b>STATE OF ILLINOIS DEPARTMENT OF TRANSPORTATION</b>	<b>TRAFFIC SIGNAL MODERNIZATION PLAN ILLINOIS ROUTE 59 AND PETITE LAKE ROAD</b>	F.A.P. RTE.	SECTION	COUNTY	TOTAL SHEETS	SHEET NO.	
S:\WP\Design\JC\Design Let Projects\Consultant\60W06 - IL 59 @ Petite Lake Rd\New Working File\60W06.TS-59-PETITE.dgn	DRAWN	REVISION	REVISION			104	105N-4	LAKE	113	60	
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PLOT DATE = 8/10/2016	DATE -	REVISION	REVISION			ILLINOIS FED. AID PROJECT					
				SCALE: SHEET NO. OF SHEETS STA. TO STA.							


**CONTROLLER SEQUENCE**

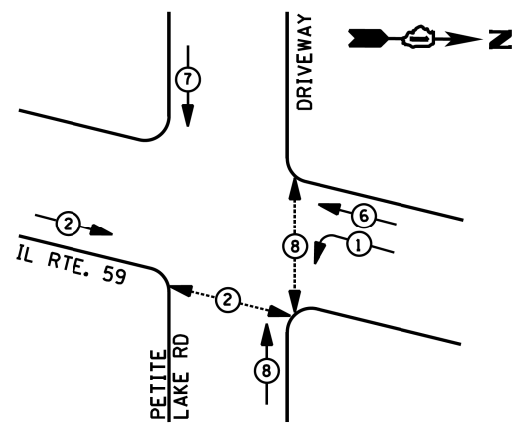

**LEGEND**

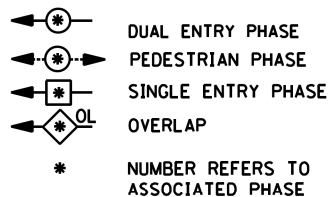


**PHASE DESIGNATION DIAGRAM**

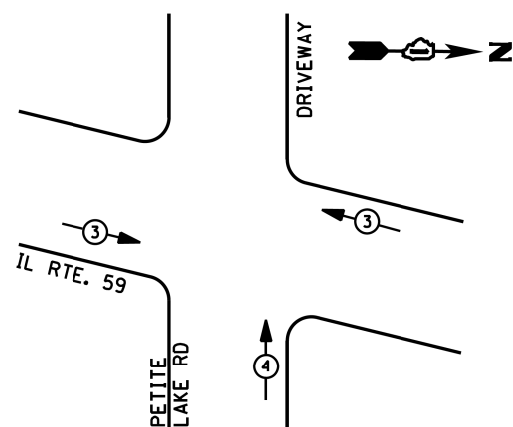

**SCHEDULE OF QUANTITIES**

QUANTITY	UNIT	ITEM
7	SO FT	SIGN PANEL - TYPE 1
21	SO FT	SIGN PANEL - TYPE 2
1	EACH	SERVICE INSTALLATION - GROUND MOUNTED, METERED
1,021	FOOT	UNDERGROUND CONDUIT, GALVANIZED STEEL, 2" DIA.
81	FOOT	UNDERGROUND CONDUIT, GALVANIZED STEEL, 3" DIA.
257	FOOT	UNDERGROUND CONDUIT, GALVANIZED STEEL, 4" DIA.
4	EACH	HANDHOLE
6	EACH	HEAVY-DUTY HANDHOLE
1	EACH	DOUBLE HANDHOLE
1	EACH	FULL-ACTUATED CONTROLLER AND TYPE SUPER P CABINET
653	FOOT	ELECTRIC CABLE IN CONDUIT, SIGNAL NO. 14 2C
932	FOOT	ELECTRIC CABLE IN CONDUIT, SIGNAL NO. 14 3C
1,309	FOOT	ELECTRIC CABLE IN CONDUIT, SIGNAL NO. 14 5C
814	FOOT	ELECTRIC CABLE IN CONDUIT, SIGNAL NO. 14 7C
1,510	FOOT	ELECTRIC CABLE IN CONDUIT, LEAD-IN, NO. 14 1 PAIR
447	FOOT	ELECTRIC CABLE IN CONDUIT, SERVICE, NO. 4 2 C
891	FOOT	ELECTRIC CABLE IN CONDUIT, EQUIPMENT GROUNDING CONDUCTOR, NO. 6 1C
4	EACH	TRAFFIC SIGNAL POST, GALVANIZED STEEL 16 FT.
1	EACH	STEEL MAST ARM ASSEMBLY AND POLE, 24 FT.
1	EACH	STEEL MAST ARM ASSEMBLY AND POLE, 38 FT.
1	EACH	STEEL COMBINATION MAST ARM ASSEMBLY AND POLE, 38 FT.
16	FOOT	CONCRETE FOUNDATION, TYPE A
4	FOOT	CONCRETE FOUNDATION, TYPE C
37	FOOT	CONCRETE FOUNDATION, TYPE E 30-INCH DIAMETER
4	EACH	SIGNAL HEAD, LED, 1-FACE, 3-SECTION, MAST-ARM MOUNTED
3	EACH	SIGNAL HEAD, LED, 1-FACE, 4-SECTION, BRACKET MOUNTED
1	EACH	SIGNAL HEAD, LED, 1-FACE, 4-SECTION, MAST ARM MOUNTED
1	EACH	SIGNAL HEAD, LED, 1-FACE, 5-SECTION, MAST-ARM MOUNTED
4	EACH	SIGNAL HEAD, LED, 1-FACE, 3-SECTION, BRACKET MOUNTED
1	EACH	SIGNAL HEAD, LED, 1-FACE, 5 SECTION, BRACKET MOUNTED
4	EACH	PEDESTRIAN SIGNAL HEAD, LED, 1-FACE, BRACKET MOUNTED WITH COUNTDOWN TIMER
6	EACH	TRAFFIC SIGNAL BACKPLATE, LOUVERED, FORMED PLASTIC
7	EACH	INDUCTIVE LOOP DETECTOR
308	FOOT	DETECTOR LOOP, TYPE I
265	FOOT	PREFORMED DETECTOR LOOP
* 2	EACH	LIGHT DETECTOR
* 1	EACH	LIGHT DETECTOR AMPLIFIER
4	EACH	PEDESTRIAN PUSH-BUTTON
* 251	FOOT	EMERGENCY VEHICLE PRIORITY SYSTEM LINE SENSOR CABLE, NO. 20 3/C
1	EACH	UNINTERRUPTABLE POWER SUPPLY, SPECIAL

\* 100% COST TO THE LAKE VILLA FIRE DISTRICT

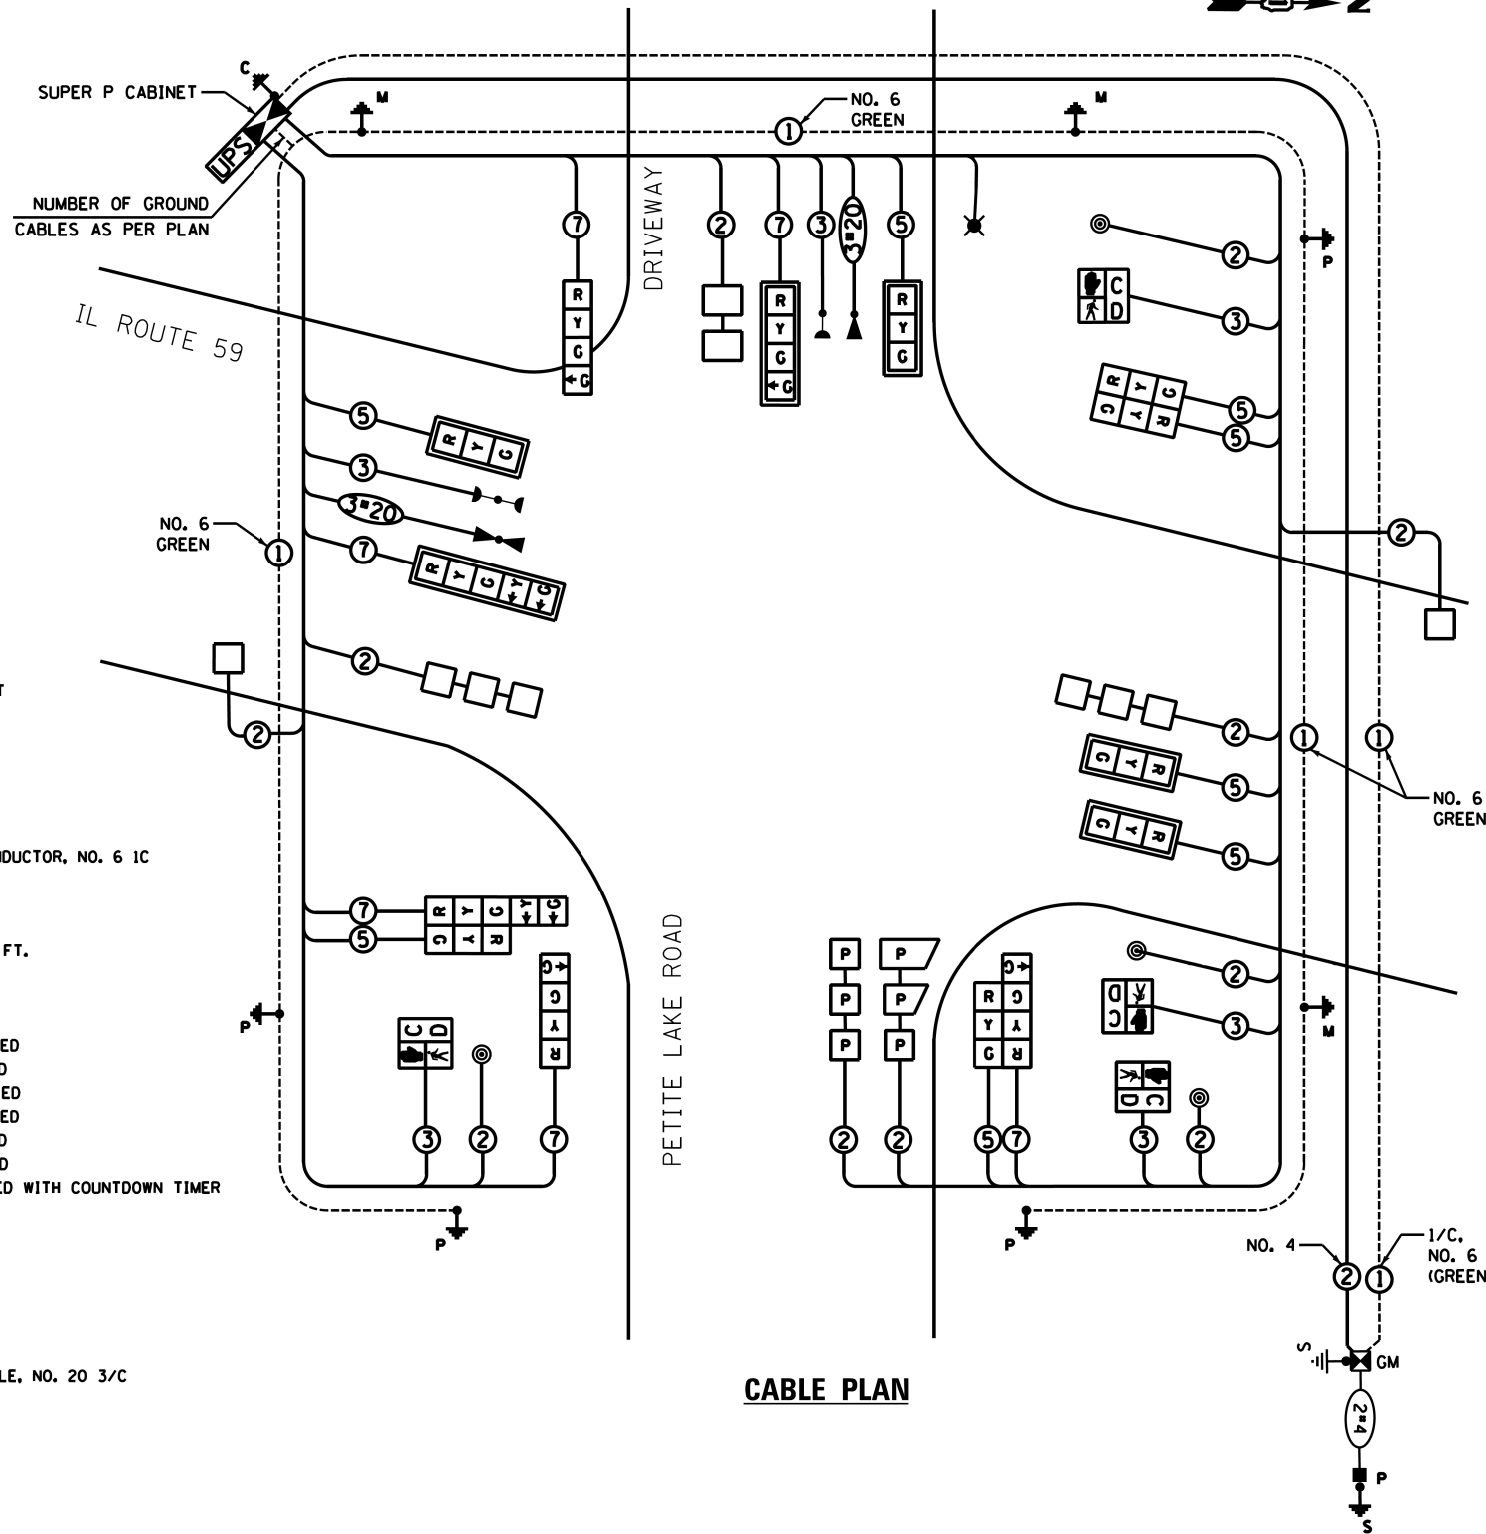

**CABLE PLAN**


I. D. O. T. TRAFFIC SIGNAL INSTALLATION ELECTRICAL SERVICE REQUIREMENTS					
TYPE	NO. LAMPS	WATTAGE		% OPERATIONS	TOTAL WATTAGE
		INCAND.	LED		
SIGNAL (RED)	14		17	0.50	119
(YELLOW)	14		25	0.25	88
(GREEN)	18		15	0.25	68
ARROW	4		12	0.10	5
PED. SIGNAL	4		25	1.00	100
CONTROLLER	1		100	1.00	100
ILLUM. SIGN			25	0.05	--
VIDEO SYSTEM	--		-	1.00	--
FLASHER LED					
TOTAL = 480					

ENERGY COSTS- BILLED TO: IDOT DISTRICT 1  
 201 WEST CENTER COURT  
 SCHAUMBURG, IL 60196-1096

ENERGY SUPPLY - CONTACT TERRI BLECK  
 PHONE 847-816-5239  
 COMMONWEALTH EDISON


TS 21635

PANEL SIGN DESIGN TYPE 1

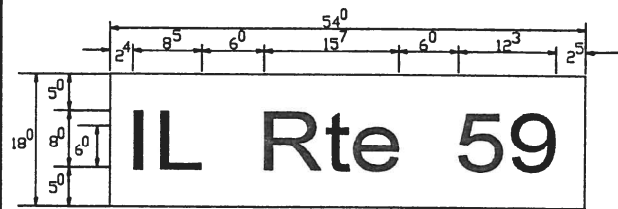


Sq. M. each  
5.75 Sq. Ft. each  
1 Required  
Design Series D

PANEL SIGN DESIGN TYPE 2

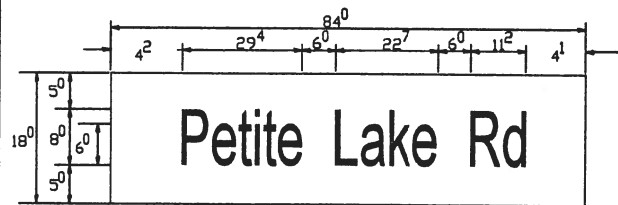


Sq. M. each  
10.5 Sq. Ft. each  
2 Required  
Design Series D


SUPPORTING CHANNELS

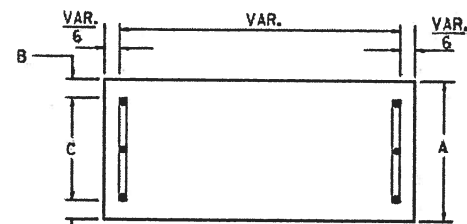


A	B	C
18"	2"	14"

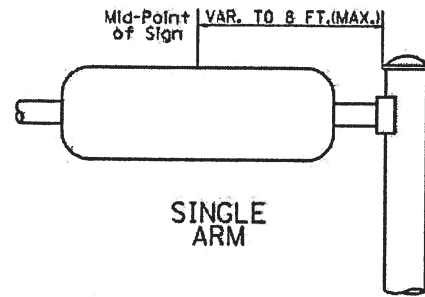

SUPPORTING CHANNELS

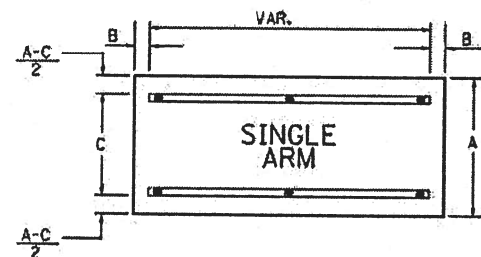

A	B	C
18"	2"	12"
30"	2"	22"

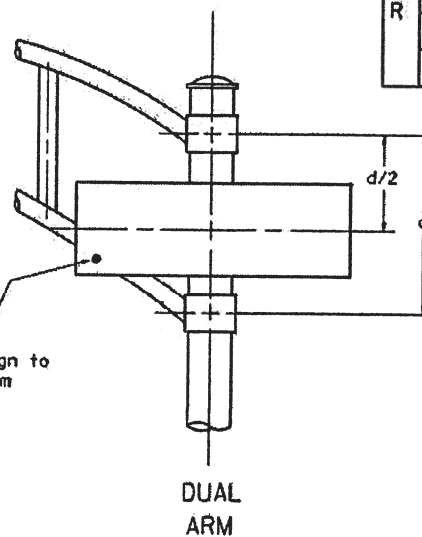

Secure Sign to Mast Arm

DUAL ARM

SIGNFIX ALUMINUM CHANNEL FRAMING SYSTEM shall be used. See Note #5.

Upper Case To Lower Case  
Spacing Chart 8-6 Inch Series "C & D"

		SECOND LETTER															
		acde goq	bhikl mnp ru	f	w	J	s	t	v	y	x	z					
FIRST LETTER	SERIES	C	D	C	D	C	D	C	D	C	D	C	D	C	D	C	D
	A W X	1 <sup>2</sup>	1 <sup>4</sup>	1 <sup>4</sup>	1 <sup>5</sup>	1 <sup>2</sup>	1 <sup>4</sup>	0 <sup>6</sup>	1 <sup>0</sup>	1 <sup>1</sup>	1 <sup>4</sup>	0 <sup>6</sup>	1 <sup>0</sup>	1 <sup>1</sup>	1 <sup>2</sup>	1 <sup>2</sup>	1 <sup>4</sup>
	B	1 <sup>4</sup>	1 <sup>5</sup>	2 <sup>0</sup>	2 <sup>1</sup>	1 <sup>4</sup>	1 <sup>5</sup>	1 <sup>1</sup>	1 <sup>2</sup>	1 <sup>4</sup>	1 <sup>5</sup>	1 <sup>2</sup>	1 <sup>4</sup>	1 <sup>2</sup>	1 <sup>4</sup>	1 <sup>6</sup>	1 <sup>7</sup>
	C E G	1 <sup>4</sup>	1 <sup>5</sup>	2 <sup>0</sup>	2 <sup>1</sup>	1 <sup>2</sup>	1 <sup>4</sup>	0 <sup>6</sup>	1 <sup>0</sup>	1 <sup>2</sup>	1 <sup>4</sup>	1 <sup>2</sup>	1 <sup>4</sup>	1 <sup>4</sup>	1 <sup>5</sup>	1 <sup>4</sup>	1 <sup>5</sup>
	D O O R	1 <sup>4</sup>	1 <sup>5</sup>	2 <sup>0</sup>	2 <sup>1</sup>	1 <sup>4</sup>	1 <sup>5</sup>	0 <sup>6</sup>	1 <sup>0</sup>	1 <sup>2</sup>	1 <sup>4</sup>	1 <sup>2</sup>	1 <sup>4</sup>	1 <sup>4</sup>	1 <sup>5</sup>	1 <sup>4</sup>	1 <sup>5</sup>
	F	0 <sup>5</sup>	0 <sup>6</sup>	1 <sup>4</sup>	1 <sup>5</sup>	0 <sup>6</sup>	1 <sup>0</sup>	0 <sup>5</sup>	0 <sup>6</sup>	0 <sup>6</sup>	1 <sup>0</sup>	0 <sup>6</sup>	1 <sup>0</sup>	0 <sup>6</sup>	1 <sup>0</sup>	1 <sup>1</sup>	1 <sup>2</sup>
	H I M N	2 <sup>0</sup>	2 <sup>1</sup>	2 <sup>2</sup>	2 <sup>4</sup>	2 <sup>0</sup>	2 <sup>1</sup>	1 <sup>4</sup>	1 <sup>5</sup>	1 <sup>6</sup>	1 <sup>7</sup>	1 <sup>6</sup>	1 <sup>7</sup>	1 <sup>6</sup>	2 <sup>0</sup>	2 <sup>1</sup>	2 <sup>0</sup>
	J U	2 <sup>0</sup>	2 <sup>1</sup>	2 <sup>0</sup>	2 <sup>1</sup>	1 <sup>6</sup>	1 <sup>7</sup>	1 <sup>4</sup>	1 <sup>5</sup>	1 <sup>6</sup>	1 <sup>7</sup>	1 <sup>6</sup>	1 <sup>7</sup>	1 <sup>6</sup>	1 <sup>7</sup>	2 <sup>0</sup>	2 <sup>1</sup>
	K L	1 <sup>1</sup>	1 <sup>2</sup>	1 <sup>6</sup>	1 <sup>7</sup>	1 <sup>1</sup>	1 <sup>2</sup>	0 <sup>5</sup>	0 <sup>6</sup>	1 <sup>1</sup>	1 <sup>2</sup>	1 <sup>1</sup>	1 <sup>2</sup>	1 <sup>1</sup>	1 <sup>2</sup>	1 <sup>2</sup>	1 <sup>4</sup>
	P	1 <sup>2</sup>	1 <sup>4</sup>	1 <sup>4</sup>	1 <sup>5</sup>	1 <sup>2</sup>	1 <sup>4</sup>	0 <sup>5</sup>	0 <sup>6</sup>	1 <sup>1</sup>	1 <sup>2</sup>	1 <sup>1</sup>	1 <sup>2</sup>	1 <sup>2</sup>	1 <sup>4</sup>	1 <sup>2</sup>	1 <sup>4</sup>
	S	1 <sup>2</sup>	1 <sup>4</sup>	1 <sup>6</sup>	1 <sup>7</sup>	1 <sup>2</sup>	1 <sup>4</sup>	0 <sup>6</sup>	1 <sup>0</sup>	1 <sup>2</sup>	1 <sup>4</sup>	1 <sup>2</sup>	1 <sup>4</sup>	1 <sup>2</sup>	1 <sup>4</sup>	1 <sup>2</sup>	1 <sup>4</sup>
T	1 <sup>1</sup>	1 <sup>2</sup>	1 <sup>6</sup>	1 <sup>7</sup>	0 <sup>6</sup>	1 <sup>0</sup>	0 <sup>6</sup>	1 <sup>0</sup>	1 <sup>1</sup>	1 <sup>2</sup>	1 <sup>1</sup>	1 <sup>2</sup>	1 <sup>1</sup>	1 <sup>2</sup>	1 <sup>2</sup>	1 <sup>4</sup>	
V	0 <sup>6</sup>	1 <sup>0</sup>	1 <sup>4</sup>	1 <sup>5</sup>	1 <sup>1</sup>	1 <sup>2</sup>	0 <sup>6</sup>	1 <sup>0</sup>	1 <sup>2</sup>	1 <sup>4</sup>	1 <sup>2</sup>	1 <sup>4</sup>	1 <sup>2</sup>	1 <sup>4</sup>	1 <sup>2</sup>	1 <sup>4</sup>	
Y	0 <sup>5</sup>	0 <sup>6</sup>	1 <sup>4</sup>	1 <sup>5</sup>	0 <sup>6</sup>	1 <sup>0</sup>	0 <sup>5</sup>	0 <sup>6</sup>	0 <sup>5</sup>	0 <sup>7</sup>	0 <sup>5</sup>	0 <sup>6</sup>	0 <sup>6</sup>	1 <sup>0</sup>	1 <sup>1</sup>	1 <sup>2</sup>	
Z	1 <sup>6</sup>	1 <sup>7</sup>	2 <sup>2</sup>	2 <sup>4</sup>	1 <sup>6</sup>	1 <sup>7</sup>	1 <sup>2</sup>	1 <sup>4</sup>	1 <sup>6</sup>	1 <sup>7</sup>	1 <sup>6</sup>	1 <sup>7</sup>	1 <sup>6</sup>	1 <sup>7</sup>	2 <sup>0</sup>	2 <sup>1</sup>	

EXAMPLE, 2<sup>3</sup> DENOTES 3" / 8"

Lower Case To Lower Case  
Spacing Chart 6 Inch Series "C & D"

		SECOND LETTER															
		acde goq	bhikl mnp ru	f	w	J	s	t	v	y	x	z					
FIRST LETTER	SERIES	C	D	C	D	C	D	C	D	C	D	C	D	C	D	C	D
	ad h g l j	1 <sup>6</sup>	1 <sup>7</sup>	2 <sup>2</sup>	2 <sup>4</sup>	1 <sup>6</sup>	1 <sup>7</sup>	1 <sup>2</sup>	1 <sup>4</sup>	1 <sup>4</sup>	1 <sup>5</sup>	1 <sup>4</sup>	1 <sup>5</sup>	1 <sup>6</sup>	1 <sup>7</sup>	1 <sup>6</sup>	1 <sup>7</sup>
	l m n q u																
	b f k o p s	1 <sup>2</sup>	1 <sup>4</sup>	1 <sup>6</sup>	1 <sup>7</sup>	1 <sup>1</sup>	1 <sup>2</sup>	0 <sup>5</sup>	0 <sup>6</sup>	1 <sup>1</sup>	1 <sup>2</sup>	1 <sup>1</sup>	1 <sup>2</sup>	1 <sup>2</sup>	1 <sup>4</sup>	1 <sup>2</sup>	1 <sup>4</sup>
	c e	1 <sup>2</sup>	1 <sup>4</sup>	1 <sup>6</sup>	1 <sup>7</sup>	1 <sup>2</sup>	1 <sup>4</sup>	0 <sup>6</sup>	1 <sup>0</sup>	1 <sup>2</sup>	1 <sup>4</sup>	1 <sup>2</sup>	1 <sup>4</sup>	1 <sup>2</sup>	1 <sup>4</sup>	1 <sup>2</sup>	1 <sup>4</sup>
	r	0 <sup>6</sup>	1 <sup>0</sup>	1 <sup>2</sup>	1 <sup>4</sup>	0 <sup>6</sup>	1 <sup>0</sup>	0 <sup>3</sup>	0 <sup>3</sup>	0 <sup>5</sup>	0 <sup>6</sup>	0 <sup>5</sup>	0 <sup>6</sup>	0 <sup>8</sup>	1 <sup>0</sup>	0 <sup>6</sup>	1 <sup>0</sup>
	t z	1 <sup>2</sup>	1 <sup>4</sup>	1 <sup>6</sup>	1 <sup>7</sup>	1 <sup>2</sup>	1 <sup>4</sup>	0 <sup>6</sup>	1 <sup>0</sup>	1 <sup>1</sup>	1 <sup>2</sup>	1 <sup>1</sup>	1 <sup>2</sup>	1 <sup>1</sup>	1 <sup>2</sup>	1 <sup>4</sup>	1 <sup>2</sup>
	v y	1 <sup>1</sup>	1 <sup>2</sup>	1 <sup>4</sup>	1 <sup>5</sup>	1 <sup>1</sup>	1 <sup>2</sup>	0 <sup>5</sup>	0 <sup>6</sup>	0 <sup>6</sup>	1 <sup>0</sup>	0 <sup>6</sup>	1 <sup>0</sup>	1 <sup>1</sup>	1 <sup>2</sup>	1 <sup>1</sup>	1 <sup>2</sup>
	w	1 <sup>1</sup>	1 <sup>2</sup>	1 <sup>4</sup>	1 <sup>5</sup>	1 <sup>1</sup>	1 <sup>2</sup>	0 <sup>5</sup>	0 <sup>6</sup>	1 <sup>1</sup>	1 <sup>2</sup>	1 <sup>1</sup>	1 <sup>2</sup>	1 <sup>1</sup>	1 <sup>2</sup>	1 <sup>2</sup>	1 <sup>4</sup>
	x	1 <sup>2</sup>	1 <sup>4</sup>	1 <sup>6</sup>	1 <sup>7</sup>	1 <sup>1</sup>	1 <sup>2</sup>	0 <sup>5</sup>	0 <sup>6</sup>	1 <sup>1</sup>	1 <sup>2</sup>	1 <sup>1</sup>	1 <sup>2</sup>	1 <sup>1</sup>	1 <sup>2</sup>	1 <sup>2</sup>	1 <sup>4</sup>

Number To Number  
Spacing Chart 8 Inch Series "C & D"

		SECOND NUMBER															
		0	1	2	3	4	5	6	7	8	9						
FIRST NUMBER	SERIES	C	D	C	D	C	D	C	D	C	D	C	D	C	D	C	D
	0 9	1 <sup>6</sup>	1 <sup>7</sup>	1 <sup>6</sup>	1 <sup>7</sup>	1 <sup>4</sup>	1 <sup>5</sup>	1 <sup>2</sup>	1 <sup>4</sup>	1 <sup>4</sup>	1 <sup>5</sup>	1 <sup>4</sup>	1 <sup>5</sup>	1 <sup>6</sup>	1 <sup>7</sup>	1 <sup>2</sup>	1 <sup>4</sup>
	1	2 <sup>0</sup>	2 <sup>1</sup>	2 <sup>0</sup>	2 <sup>1</sup>	2 <sup>0</sup>	2 <sup>1</sup>	1 <sup>6</sup>	1 <sup>7</sup>	1 <sup>4</sup>	1 <sup>5</sup>	2 <sup>0</sup>	2 <sup>1</sup>	2 <sup>0</sup>	2 <sup>1</sup>	1 <sup>4</sup>	1 <sup>5</sup>
	2 3 4	1 <sup>4</sup>	1 <sup>5</sup>	1 <sup>4</sup>	1 <sup>5</sup>	1 <sup>4</sup>	1 <sup>5</sup>	1 <sup>1</sup>	1 <sup>2</sup>	1 <sup>4</sup>	1 <sup>4</sup>	1 <sup>5</sup>	1 <sup>4</sup>	1 <sup>5</sup>	1 <sup>1</sup>	1 <sup>2</sup>	1 <sup>4</sup>
	5	1 <sup>4</sup>	1 <sup>5</sup>	1 <sup>4</sup>	1 <sup>5</sup>	1 <sup>4</sup>	1 <sup>5</sup>	1 <sup>1</sup>	1 <sup>2</sup>	1 <sup>4</sup>	1 <sup>4</sup>	1 <sup>5</sup>	1 <sup>4</sup>	1 <sup>5</sup>	1 <sup>1</sup>	1 <sup>2</sup>	1 <sup>4</sup>
	6	1 <sup>6</sup>	1 <sup>7</sup>	1 <sup>4</sup>	1 <sup>5</sup>	1 <sup>4</sup>	1 <sup>5</sup>	1 <sup>2</sup>	1 <sup>4</sup>	1 <sup>4</sup>	1 <sup>5</sup>	1 <sup>4</sup>	1 <sup>5</sup>	1 <sup>1</sup>	1 <sup>2</sup>	1 <sup>4</sup>	1 <sup>5</sup>
	7	1 <sup>2</sup>	1 <sup>4</sup>	1 <sup>2</sup>	1 <sup>4</sup>	1 <sup>4</sup>	1 <sup>5</sup>	1 <sup>2</sup>	1 <sup>5</sup>	0 <sup>6</sup>	1 <sup>2</sup>	1 <sup>4</sup>	1 <sup>4</sup>	1 <sup>5</sup>	1 <sup>1</sup>	1 <sup>2</sup>	1 <sup>4</sup>
	8	1 <sup>6</sup>	1 <sup>7</sup>	1 <sup>6</sup>	1 <sup>7</sup>	1 <sup>4</sup>	1 <sup>5</sup>	1 <sup>2</sup>	1 <sup>5</sup>	1 <sup>2</sup>	1 <sup>4</sup>	1 <sup>4</sup>	1 <sup>5</sup>	1 <sup>6</sup>	1 <sup>7</sup>	1 <sup>2</sup>	1 <sup>4</sup>

UPPER AND LOWER CASE LETTER WIDTHS

LETTERS	6 INCH UPPER CASE LETTERS				8 INCH UPPER CASE LETTERS				6 INCH LOWER CASE LETTERS			
	SERIES		SERIES		SERIES		SERIES		SERIES		SERIES	
	C	D	C	D	C	D	C	D	C	D	C	D
A	3 <sup>6</sup>	5 <sup>0</sup>	5 <sup>0</sup>	6 <sup>5</sup>	a	3 <sup>5</sup>	4 <sup>2</sup>					
B	3 <sup>2</sup>	4 <sup>0</sup>	4 <sup>3</sup>	5 <sup>3</sup>	b	3 <sup>5</sup>	4 <sup>2</sup>					
C	3 <sup>2</sup>	4 <sup>0</sup>	4 <sup>3</sup>	5 <sup>3</sup>	c	3 <sup>5</sup>	4 <sup>1</sup>					
D	3 <sup>2</sup>	4 <sup>0</sup>	4 <sup>3</sup>	5 <sup>3</sup>	d	3 <sup>5</sup>	4 <sup>2</sup>					
E	3 <sup>0</sup>	3 <sup>5</sup>	4 <sup>0</sup>	4 <sup>7</sup>	e	3 <sup>5</sup>	4 <sup>2</sup>					
F	3 <sup>0</sup>	3 <sup>5</sup>	4 <sup>0</sup>	4 <sup>7</sup>	f	2 <sup>3</sup>	2 <sup>6</sup>					
G	3 <sup>2</sup>	4 <sup>0</sup>	4 <sup>3</sup>	5 <sup>3</sup>	g	3 <sup>5</sup>	4 <sup>2</sup>					
H	3 <sup>2</sup>	4 <sup>0</sup>	4 <sup>3</sup>	5 <sup>3</sup>	h	3 <sup>5</sup>	4 <sup>2</sup>					
I	0 <sup>7</sup>	0 <sup>7</sup>	1 <sup>1</sup>	1 <sup>2</sup>	i	1 <sup>1</sup>	1 <sup>1</sup>					
J	3 <sup>0</sup>	3 <sup>6</sup>	4 <sup>0</sup>	5 <sup>0</sup>	j	2 <sup>0</sup>	2 <sup>2</sup>					
K	3 <sup>2</sup>	4 <sup>1</sup>	4 <sup>3</sup>	5 <sup>4</sup>	k	3 <sup>5</sup>	4 <sup>2</sup>					
L	3 <sup>0</sup>	3 <sup>5</sup>	4 <sup>0</sup>	4 <sup>7</sup>	l	1 <sup>1</sup>	1 <sup>1</sup>					
M	3 <sup>7</sup>	4 <sup>5</sup>	5 <sup>1</sup>	6 <sup>1</sup>	m	6 <sup>0</sup>	7 <sup>0</sup>					
N	3 <sup>2</sup>	4 <sup>0</sup>	4 <sup>3</sup>	5 <sup>3</sup>	n	3 <sup>5</sup>	4 <sup>2</sup>					
O	3 <sup>4</sup>	4 <sup>2</sup>	4 <sup>5</sup>	5 <sup>5</sup>	o	3 <sup>6</sup>	4 <sup>3</sup>					
P	3 <sup>2</sup>	4 <sup>0</sup>	4 <sup>3</sup>	5 <sup>3</sup>	p	3 <sup>5</sup>	4 <sup>2</sup>					
Q	3 <sup>4</sup>	4 <sup>2</sup>	4 <sup>5</sup>	5 <sup>5</sup>	q	3 <sup>5</sup>	4 <sup>2</sup>					
R	3 <sup>2</sup>	4 <sup>0</sup>	4 <sup>3</sup>	5 <sup>3</sup>	r	2 <sup>6</sup>	3 <sup>2</sup>					
S	3 <sup>2</sup>	4 <sup>0</sup>	4 <sup>3</sup>	5 <sup>3</sup>	s	3 <sup>6</sup>	4 <sup>2</sup>					
T	3 <sup>0</sup>	3 <sup>5</sup>	4 <sup>0</sup>	4 <sup>7</sup>	t	2 <sup>7</sup>	3 <sup>2</sup>					
U	3 <sup>2</sup>	4 <sup>0</sup>	4 <sup>3</sup>	5 <sup>3</sup>	u	3 <sup>5</sup>	4 <sup>2</sup>					
V	3 <sup>5</sup>	4 <sup>4</sup>	4 <sup>7</sup>	6 <sup>0</sup>	v	4 <sup>2</sup>	4 <sup>7</sup>					
W	4 <sup>4</sup>	5 <sup>2</sup>	6 <sup>0</sup>	7 <sup>0</sup>	w	5 <sup>5</sup>	6 <sup>4</sup>					
X	3 <sup>4</sup>	4 <sup>0</sup>	4 <sup>5</sup>	5 <sup>3</sup>	x	4 <sup>4</sup>	5 <sup>1</sup>					
Y	3 <sup>6</sup>	5 <sup>0</sup>	5 <sup>0</sup>	6 <sup>6</sup>	y	4 <sup>6</sup>	5 <sup>3</sup>					
Z	3 <sup>2</sup>	4 <sup>0</sup>	4 <sup>3</sup>	5 <sup>3</sup>	z	3 <sup>6</sup>	4 <sup>3</sup>					

NUMBER	6 INCH SERIES		8 INCH SERIES	
	C	D	C	D
1	1 <sup>2</sup>	1 <sup>4</sup>	1 <sup>5</sup>	2 <sup>0</sup>
2	3 <sup>2</sup>	4 <sup>0</sup>	4 <sup>3</sup>	5 <sup>3</sup>
3	3 <sup>2</sup>	4 <sup>0</sup>	4 <sup>3</sup>	5 <sup>3</sup>
4	3 <sup>5</sup>	4 <sup>3</sup>	4 <sup>7</sup>	5 <sup>7</sup>
5	3 <sup>2</sup>	4 <sup>0</sup>	4 <sup>3</sup>	5 <sup>3</sup>
6	3 <sup>2</sup>	4 <sup>0</sup>	4 <sup>3</sup>	5 <sup>3</sup>
7	3 <sup>2</sup>	4 <sup>0</sup>	4 <sup>3</sup>	5 <sup>3</sup>
8	3 <sup>2</sup>	4 <sup>0</sup>	4 <sup>3</sup>	5 <sup>3</sup>
9	3 <sup>2</sup>	4 <sup>0</sup>	4 <sup>3</sup>	5 <sup>3</sup>
0	3 <sup>4</sup>	4 <sup>2</sup>	4 <sup>5</sup>	5 <sup>5</sup>

GENERAL NOTES

- WHERE MAST ARM MOUNTED STREET NAME SIGNS ARE SPECIFIED, THE MAST ARM ASSEMBLY AND POLES SHALL BE DESIGNED TO SUPPORT THE LOADINGS CALLED FOR ON STANDARDS 877001, 877002, 877006, 877011 AND 877012, AS APPLICABLE, PLUS TWO (2) SIGN PANELS 2'-6" x 8'-0" MOUNTED AS SHOWN. THE DESIGN SHALL BE IN ACCORDANCE WITH THE REQUIREMENTS OF THE CURRENT "STANDARD SPECIFICATIONS FOR STRUCTURAL SUPPORTS FOR HIGHWAY SIGNS, LUMINAIRES, AND TRAFFIC SIGNALS" AS PUBLISHED BY THE AMERICAN ASSOCIATION OF STATE HIGHWAY AND TRANSPORTATION OFFICIALS FOR 80 M.P.H. WIND VELOCITY.
- ALL SIGNS SHALL HAVE A WHITE REFLECTORIZED LEGEND AND BORDER ON A GREEN REFLECTORIZED BACKGROUND, TYPE A SHEETING.
- THE SIGN LENGTH SHOULD BE INCREASED IN 6-INCH INCREMENTS, BUT THE OVERALL LENGTH SHOULD NOT EXCEED 8'-0".
- ALL BORDERS SHALL BE 3/4" WIDE AND CORNER RADIUS SHALL BE 2-1/4".
- SIGNFIX ALUMINUM CHANNEL FRAMING SYSTEM SHALL BE USED FOR ALL SIGNS ATTACHED TO SIGNAL POLES AND POSTS. LOCAL SUPPLIERS OF THE SIGNFIX ALUMINUM CHANNEL FRAMING SYSTEM ARE:




\* J.O. HERBERT CO. MIDLOTHIAN, VA. \* WESTERN REMAC INC. WOODRIDGE, IL.

PARTS LISTING

SIGN CHANNEL PART #HPN053 (MED. CHANNEL)  
SIGN SCREWS 1/4" x 14 x 1" H.W.H. #3  
BRACKETS PART #HPN034 (UNIVERSAL)  
CHANNEL CLAMPS WITH STAINLESS STEEL STRAPPING

OTHER BRANDS OF MOUNTING HARDWARE ARE ACCEPTABLE, BASED UPON THE DEPARTMENT'S APPROVAL AND COMPATIBILITY WITH THE CHANNEL/BACKET OF THE ABOVE PRODUCT.

**SIGN PANEL – TYPE 1 OR TYPE 2**

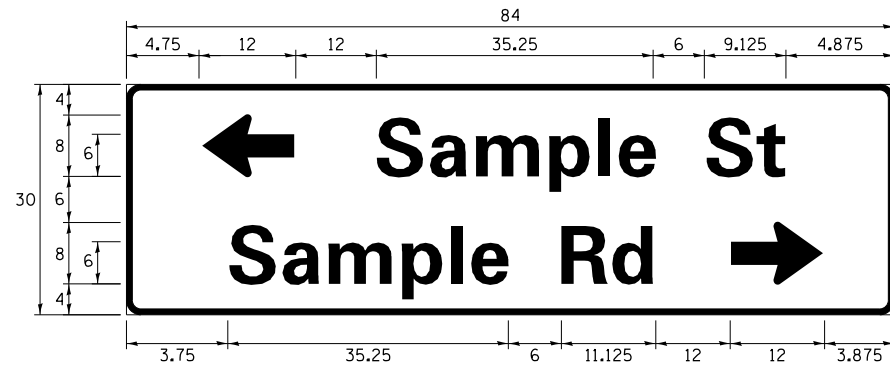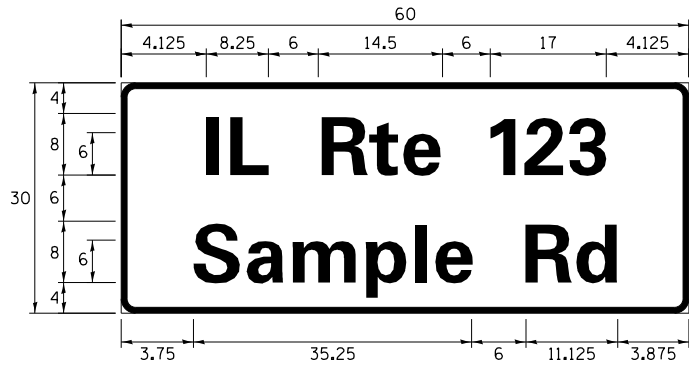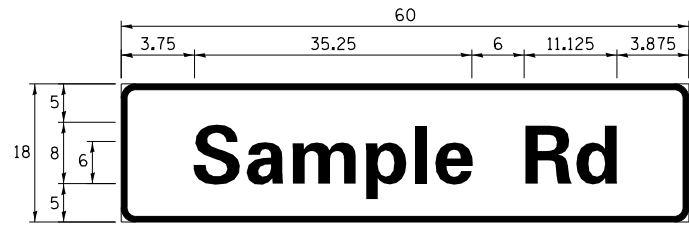

DESIGN SERIES	AREA ( SQ FT)	SIGN PANEL TYPE	SHEETING TYPE	QTY. REQUIRED
D OR C	-	1 OR 2	ZZ	-

ALL DIMENSIONS ARE IN INCHES EXCEPT NOTED OTHERWISE

**COMMON STREET NAME ABBREVIATIONS AND WIDTHS**

NAME	ABBREVIATION	WIDTH ( INCH)	
		SERIES "C"	SERIES "D"
AVENUE	Ave	15.000	18.250
BOULEVARD	Blvd	17.125	20.000
CIRCLE	Cir	11.125	13.000
COURT	Ct	8.250	9.625
DRIVE	Dr	8.625	10.125
HIGHWAY	Hwy	18.375	22.000
ILLINOIS	IL	7.000	8.250
LANE	Ln	9.125	10.750
PARKWAY	Pkwy	23.375	27.375
PLACE	Pl	7.125	7.750
ROAD	Rd	9.625	11.125
ROUTE	Rte	12.625	14.500
STREET	St	8.000	9.125
TERRACE	Ter	12.625	14.625
TRAIL	Tr	7.750	9.125
UNITED STATES	US	10.375	12.250

**GENERAL NOTES**

1. WHERE MAST ARM MOUNTED STREET NAME SIGNS ARE SPECIFIED, THE MAST ARM ASSEMBLY AND POLES SHALL BE DESIGNED TO SUPPORT THE LOADINGS CALLED FOR ON STANDARDS 877001, 877002, 877006, 877011 AND 877012, AS APPLICABLE, PLUS TWO (2) SIGN PANELS 2'-6" x 8'-0" MOUNTED AS SHOWN. THE DESIGN SHALL BE IN ACCORDANCE WITH THE REQUIREMENTS OF THE CURRENT "STANDARD SPECIFICATIONS FOR STRUCTURAL SUPPORTS FOR HIGHWAY SIGNS, LUMINAIRES, AND TRAFFIC SIGNALS" AS PUBLISHED BY THE AMERICAN ASSOCIATION OF STATE HIGHWAY AND TRANSPORTATION OFFICIALS FOR 80 M.P.H. WIND VELOCITY.
2. ALL SIGNS SHALL CONSIST OF A WHITE LEGEND AND BORDER (TYPE ZZ SHEETING) ON A GREEN BACKGROUND (TYPE ZZ SHEETING)
3. THE SIGN LENGTH SHALL BE IN 6-INCH INCREMENTS, BUT THE OVERALL LENGTH SHALL NOT EXCEED 8'-0". ALL BORDERS SHALL BE 3/4" WIDE. CORNER RADIUS SHALL BE 1-7/8". THE SPACING BETWEEN THE WORDS SHOULD BE 6", IF POSSIBLE, BUT MAY BE REDUCED TO 5" WHEN SPACING IS CRITICAL. A MINIMUM OF 2-1/2" SHALL BE INCLUDED BETWEEN THE WORD AND THE RIGHT AND LEFT EDGES OF THE SIGN.
4. A PREFERRED METHOD FOR THE SIGN DESIGN IS TO USE SERIES "D" LETTER ON A ONE-LINE SIGN 18" IN HEIGHT AND A MAXIMUM OF 8'-0" IN WIDTH. IF SERIES "D" DOES NOT FIT ON A 8'-0" SIGN, THEN SERIES "C" SHOULD BE TRIED. IF SERIES "C" DOES NOT FIT ON A 8'-0" SIGN, A 30" HIGH TWO-LINE SIGN CAN BE USED. THE CROSSROAD DESIGNATION AS TO STREET, AVENUE, ETC. SHOULD BE SPELLED OUT ON THE SECOND LINE, IF THE ABBREVIATION CANNOT FIT ON THE FIRST LINE.
5. LED ILLUMINATED STREET NAME SIGNS CAN BE USED IN PLACE OF REGULAR SIGN PANELS BUT ANY SPECIAL WORDING AND SYMBOLOGY MUST BE APPROVED BY THE DEPARTMENT. GENERAL DESIGN REQUIREMENT AS LISTED ABOVE (COLOR, FONT, SIZE, ETC.) MUST BE FOLLOWED.
6. SIGNFIX ALUMINUM CHANNEL FRAMING SYSTEM SHALL BE USED FOR ALL SIGNS ATTACHED TO SIGNAL POLES AND POSTS.

**LOCAL SUPPLIERS:**

- J.O. HERBERT COMPANY, INC  
MIDLOTHIAN, VA
- WESTERN REMAC, INC.  
WOODRIDGE, IL

**PARTS LISTING:**

- SIGN CHANNEL PART \*HPN053 (MED. CHANNEL)  
SIGN SCREWS 1/4" x 14 x 1" H.W.H. #3  
SELF TAPPING WITH NEOPRENE WASHER
- BRACKETS PART \*HPN034 (UNIVERSAL)  
CHANNEL CLAMPS WITH STAINLESS STEEL STRAPPING


OTHER BRANDS OF MOUNTING HARDWARE ARE ACCEPTABLE, BASED UPON THE DEPARTMENT'S APPROVAL AND COMPATIBILITY WITH THE CHANNEL/BRACKET OF THE ABOVE PRODUCT.

**STANDARD ALPHABETS SPACING CHART**


( 8" ) UPPER CASE AND ( 6" ) LOWER CASE

CHARACTER	FHWA SERIES "C"			CHARACTER	FHWA SERIES "D"		
	LEFT SPACING ( INCH)	WIDTH ( INCH)	RIGHT SPACING ( INCH)		LEFT SPACING ( INCH)	WIDTH ( INCH)	RIGHT SPACING ( INCH)
A	0.240	5.122	0.240	A	0.240	6.804	0.240
B	0.880	4.482	0.480	B	0.960	5.446	0.400
C	0.720	4.482	0.720	C	0.800	5.446	0.800
D	0.880	4.482	0.720	D	0.960	5.446	0.800
E	0.880	4.082	0.480	E	0.960	4.962	0.400
F	0.880	4.082	0.240	F	0.960	4.962	0.240
G	0.720	4.482	0.720	G	0.800	5.446	0.800
H	0.880	4.482	0.880	H	0.960	5.446	0.960
I	0.880	1.120	0.880	I	0.960	1.280	0.960
J	0.240	4.082	0.880	J	0.240	5.122	0.960
K	0.880	4.482	0.480	K	0.960	5.604	0.400
L	0.880	4.082	0.240	L	0.960	4.962	0.240
M	0.880	5.284	0.880	M	0.960	6.244	0.960
N	0.880	4.482	0.880	N	0.960	5.446	0.960
O	0.720	4.722	0.720	O	0.800	5.684	0.800
P	0.880	4.482	0.720	P	0.960	5.446	0.240
Q	0.720	4.722	0.720	Q	0.800	5.684	0.800
R	0.880	4.482	0.480	R	0.960	5.446	0.400
S	0.480	4.482	0.480	S	0.400	5.446	0.400
T	0.240	4.082	0.240	T	0.240	4.962	0.240
U	0.880	4.482	0.880	U	0.960	5.446	0.960
V	0.240	4.962	0.240	V	0.240	6.084	0.240
W	0.240	6.084	0.240	W	0.240	7.124	0.240
X	0.240	4.722	0.240	X	0.400	5.446	0.400
Y	0.240	5.122	0.240	Y	0.240	6.884	0.240
Z	0.480	4.482	0.480	Z	0.400	5.446	0.400
a	0.320	3.842	0.640	a	0.400	4.562	0.720
b	0.720	4.082	0.480	b	0.800	4.802	0.480
c	0.480	4.002	0.240	c	0.480	4.722	0.240
d	0.480	4.082	0.720	d	0.480	4.802	0.800
e	0.480	4.082	0.320	e	0.480	4.722	0.320
f	0.320	2.480	0.160	f	0.320	2.882	0.160
g	0.480	4.082	0.720	g	0.480	4.802	0.800
h	0.720	4.082	0.640	h	0.800	4.722	0.720
i	0.720	1.120	0.720	i	0.800	1.280	0.800
j	0.000	2.320	0.720	j	0.000	2.642	0.800
k	0.720	4.322	0.160	k	0.800	5.122	0.160
l	0.720	1.120	0.720	l	0.800	1.280	0.800
m	0.720	6.724	0.640	m	0.800	7.926	0.720
n	0.720	4.082	0.640	n	0.800	4.722	0.720
o	0.480	4.082	0.480	o	0.480	4.882	0.480
p	0.720	4.082	0.480	p	0.800	4.802	0.480
q	0.480	4.082	0.720	q	0.480	4.802	0.800
r	0.720	2.642	0.160	r	0.800	3.042	0.160
s	0.320	3.362	0.240	s	0.320	3.762	0.240
t	0.080	2.882	0.080	t	0.080	3.202	0.080
u	0.640	4.082	0.720	u	0.720	4.722	0.800
v	0.160	4.722	0.160	v	0.160	5.684	0.160
w	0.160	7.524	0.160	w	0.160	9.046	0.160
x	0.000	5.202	0.000	x	0.000	6.244	0.000
y	0.160	4.962	0.160	y	0.160	6.004	0.160
z	0.240	3.362	0.240	z	0.240	4.002	0.240
1	0.720	1.680	0.880	1	0.800	2.000	0.960
2	0.480	4.482	0.480	2	0.800	5.446	0.800
3	0.480	4.482	0.480	3	1.440	5.446	0.800
4	0.240	4.962	0.720	4	0.160	6.004	0.960
5	0.480	4.482	0.480	5	0.800	5.446	0.800
6	0.720	4.482	0.720	6	0.800	5.446	0.800
7	0.240	4.482	0.720	7	0.560	5.446	0.560
8	0.480	4.482	0.480	8	0.800	5.446	0.800
9	0.480	4.482	0.480	9	0.800	5.446	0.800
0	0.720	4.722	0.720	0	0.800	5.684	0.800
-	0.240	2.802	0.240	-	0.240	2.802	0.240

**MOUNTING LOCATION**

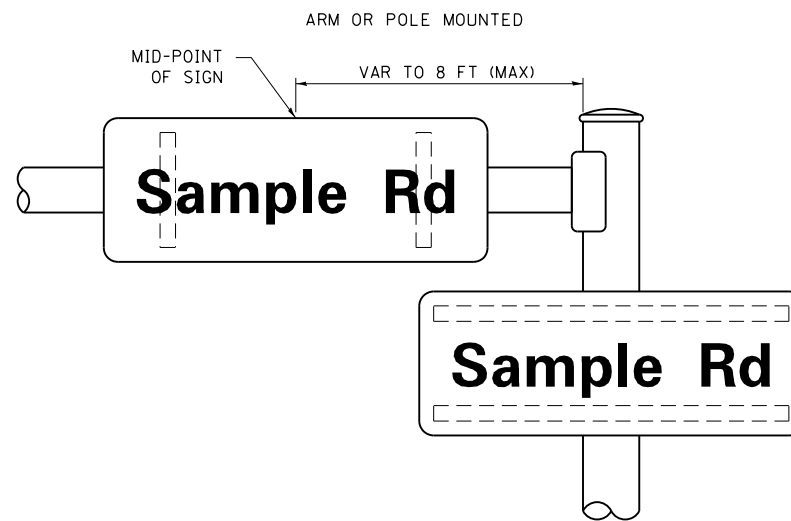

**SUPPORTING CHANNELS**

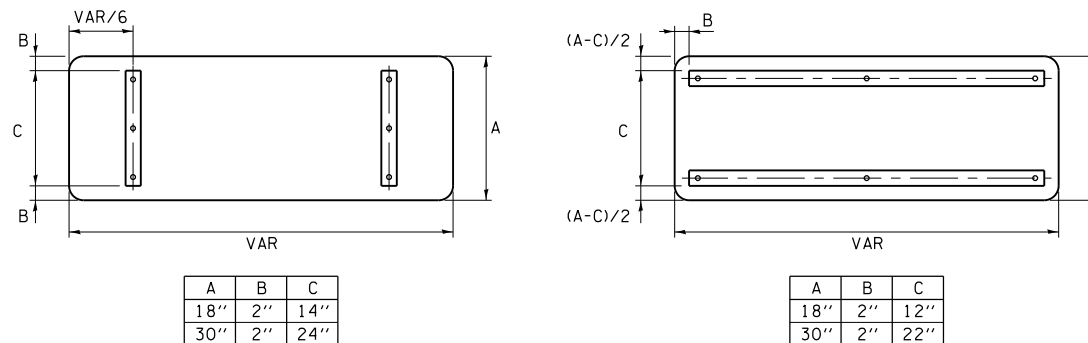

# TRAFFIC SIGNAL LEGEND

ITEM	REMOVAL	EXISTING	PROPOSED	ITEM	REMOVAL	EXISTING	PROPOSED	ITEM	REMOVAL	EXISTING	PROPOSED
CONTROLLER CABINET				EMERGENCY VEHICLE LIGHT DETECTOR				ELECTRIC CABLE IN CONDUIT, TRACER, NO. 14 1/C, UNLESS NOTED OTHERWISE			
RAILROAD CONTROL CABINET				CONFIRMATION BEACON				COAXIAL CABLE			
COMMUNICATIONS CABINET				HANDHOLE				VENDOR CABLE FOR CAMERA			
MASTER CONTROLLER				HEAVY DUTY HANDHOLE				COPPER INTERCONNECT CABLE, NO. 18 3 PAIR TWISTED, SHIELDED			
MASTER MASTER CONTROLLER				DOUBLE HANDHOLE				FIBER OPTIC CABLE NO. 62.5/125, MM12F			
UNINTERRUPTABLE POWER SUPPLY				JUNCTION BOX				FIBER OPTIC CABLE NO. 62.5/125, MM12F SM12F			
SERVICE INSTALLATION, (P) POLE OR (G) GROUND MOUNT				UNDERGROUND CONDUIT, GALVANIZED STEEL (UC)				FIBER OPTIC CABLE NO. 62.5/125, MM12F SM24F			
TELEPHONE CONNECTION (P) POLE OR (G) GROUND MOUNT				TEMPORARY SPAN WIRE, TETHER WIRE, AND CABLE				FIBER OPTIC CABLE NO. 62.5/125, MM12F SM24F			
STEEL MAST ARM ASSEMBLY AND POLE				COMMON TRENCH				GROUND ROD AT (C) CONTROLLER, (H) HANDHOLE, (P) POST, (M) MAST ARM, OR (S) SERVICE			
ALUMINUM MAST ARM ASSEMBLY AND POLE				COILABLE NONMETALLIC CONDUIT (EMPTY)				CONTROLLER CABINET AND FOUNDATION TO BE REMOVED			
STEEL COMBINATION MAST ARM ASSEMBLY AND POLE WITH LUMINAIRE				SYSTEM ITEM		S		STEEL MAST ARM POLE AND FOUNDATION TO BE REMOVED			
STEEL COMBINATION MAST ARM ASSEMBLY AND POLE WITH PTZ CAMERA				INTERSECTION ITEM		I		ALUMINUM MAST ARM POLE AND FOUNDATION TO BE REMOVED			
SIGNAL POST				REMOVE ITEM	R			STEEL COMBINATION MAST ARM ASSEMBLY AND POLE WITH LUMINAIRE AND FOUNDATION TO BE REMOVED			
TEMPORARY WOOD POLE (CLASS 5 OR BETTER) 45 FOOT (13.7m) MINIMUM				RELOCATE ITEM	RL			SIGNAL POST AND FOUNDATION TO BE REMOVED			
GUY WIRE				ABANDON ITEM	A			INTERSECTION & SAMPLING (SYSTEM) DETECTOR			
SIGNAL HEAD				12" (300mm) TRAFFIC SIGNAL SECTION				SAMPLING (SYSTEM) DETECTOR			
SIGNAL HEAD CONSTRUCTION STAGES (NUMBERS INDICATE THE CONSTRUCTION STAGE)				12" (300mm) RED WITH 8" (200mm) YELLOW AND GREEN TRAFFIC SIGNAL FACE				QUEUE DETECTOR			
SIGNAL HEAD WITH BACKPLATE				SIGNAL FACE				PREFORMED QUEUE DETECTOR			
SIGNAL HEAD OPTICALLY PROGRAMMED				SIGNAL FACE WITH BACKPLATE, "P" INDICATES PROGRAMMED HEAD				PREFORMED INTERSECTION AND SAMPLING (SYSTEM) DETECTOR			
FLASHER INSTALLATION (S DENOTES SOLAR POWER)				"RB" INDICATES REFLECTIVE BACKPLATE				PREFORMED SAMPLING (SYSTEM) DETECTOR			
PEDESTRIAN SIGNAL HEAD				12" (300mm) PEDESTRIAN SIGNAL HEAD WALK/DON'T WALK SYMBOL							
PEDESTRIAN PUSHBUTTON DETECTOR				12" (300mm) PEDESTRIAN SIGNAL HEAD INTERNATIONAL SYMBOL, OUTLINED							
ACCESSIBLE PEDESTRIAN PUSHBUTTON DETECTOR				12" (300mm) PEDESTRIAN SIGNAL HEAD INTERNATIONAL SYMBOL, SOLID							
ILLUMINATED SIGN "NO LEFT TURN"				PEDESTRIAN SIGNAL HEAD, INTERNATIONAL SYMBOL, WITH COUNTDOWN TIMER							
ILLUMINATED SIGN "NO RIGHT TURN"				RADIO INTERCONNECT							
DETECTOR LOOP, TYPE I				RADIO REPEATER							
PREFORMED DETECTOR LOOP				DENOTES NUMBER OF CONDUCTORS, ELECTRIC CABLE NO. 14, UNLESS NOTED OTHERWISE, ALL DETECTOR LOOP CABLE TO BE SHIELDED							
MICROWAVE VEHICLE SENSOR				GROUND CABLE IN CONDUIT NO. 6 SOLID COPPER (GREEN)							
VIDEO DETECTION CAMERA											
VIDEO DETECTION ZONE											
PAN, TILT, ZOOM CAMERA											
WIRELESS DETECTOR SENSOR											
WIRELESS ACCESS POINT											


## RAILROAD SYMBOLS

ITEM	REMOVAL	EXISTING	PROPOSED
RAILROAD CONTROL CABINET			
RAILROAD CANTILEVER MAST ARM			
FLASHING SIGNAL			
CROSSING GATE			
CROSSBUCK			






**TRAFFIC SIGNAL MAST ARM AND SIGNAL POST  
MAST ARM MOUNTED SIGNALS IN EXISTING, PROPOSED OR  
FUTURE SIDEWALK/BICYCLE PATH AREA. INTERSECTION SHOWN  
WITH PEDESTRIAN SIGNALS AND PEDESTRIAN PUSHBUTTON DETECTORS.**

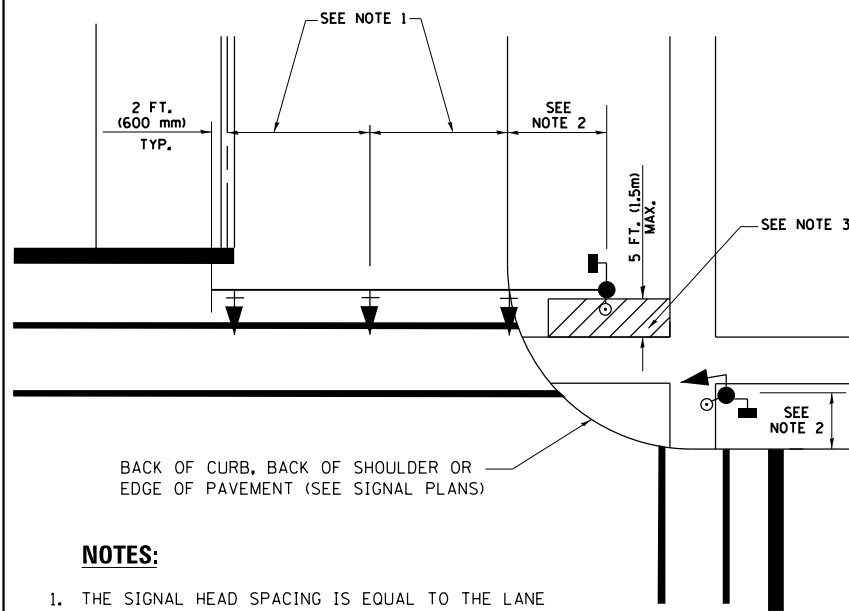

**NOTES:**

1. THE SIGNAL HEAD SPACING IS EQUAL TO THE LANE WIDTH OR AS SHOWN ON THE TRAFFIC SIGNAL PLAN.
2. REFER TO THE TRAFFIC SIGNAL EQUIPMENT OFFSET TABLE.
3. PROVIDE A LEVEL ALL-WEATHER SURFACE (CONCRETE SIDEWALK, ASPHALT BICYCLE PATH SURFACE OR MATCHING MATERIAL TO THE ADJACENT SURFACE) UP TO THE MAST ARM SHAFT OR THE SIGNAL POST.
4. THE FACE OF THE PEDESTRIAN PUSHBUTTON SHALL BE PARALLEL TO THE CROSSWALK TO BE USED.
5. THE LOCATIONS AND INSTALLATION OF PEDESTRIAN SIGNAL HEADS AND PEDESTRIAN PUSHBUTTONS SHALL MEET THE REQUIREMENTS OF THE MUTCD AND INFORMATION FOUND IN THE "AMERICANS WITH DISABILITIES ACT ACCESSIBILITY GUIDELINES FOR BUILDINGS AND FACILITIES."


**PEDESTRIAN SIGNAL POST  
AND  
PEDESTRIAN PUSH BUTTON POST**

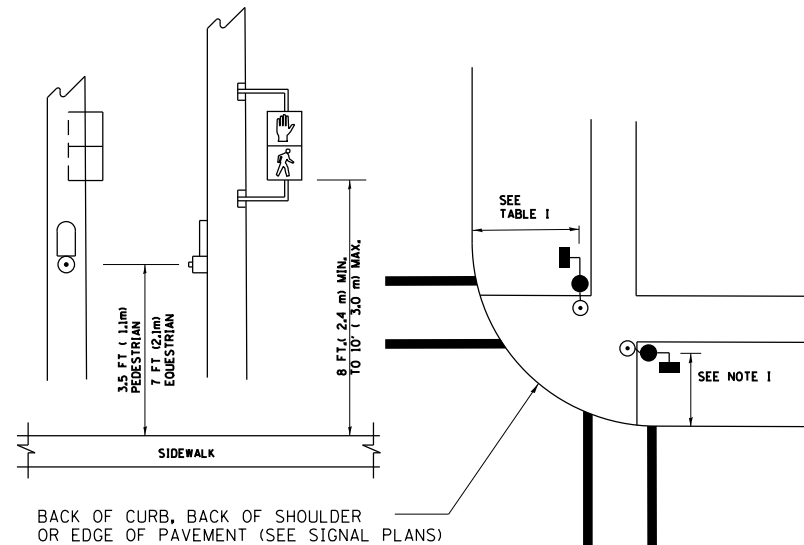

**NOTES:**

1. REFER TO THE TRAFFIC SIGNAL EQUIPMENT OFFSET TABLE.
2. PROVIDE A LEVEL ALL-WEATHER SURFACE (CONCRETE SIDEWALK, ASPHALT BICYCLE PATH SURFACE OR MATCHING MATERIAL TO THE ADJACENT SURFACE) UP TO THE PEDESTRIAN SIGNAL POST OR THE PEDESTRIAN PUSH BUTTON POST.
3. THE FACE OF THE PEDESTRIAN PUSHBUTTON SHALL BE PARALLEL TO THE CROSSWALK TO BE USED.
4. THE LOCATIONS AND INSTALLATION OF PEDESTRIAN SIGNAL HEADS AND PEDESTRIAN PUSHBUTTONS SHALL MEET THE REQUIREMENTS OF THE MUTCD AND INFORMATION FOUND IN THE "AMERICANS WITH DISABILITIES ACT ACCESSIBILITY GUIDELINES FOR BUILDINGS AND FACILITIES."

**RECOMMENDED PUSHBUTTON LOCATIONS**

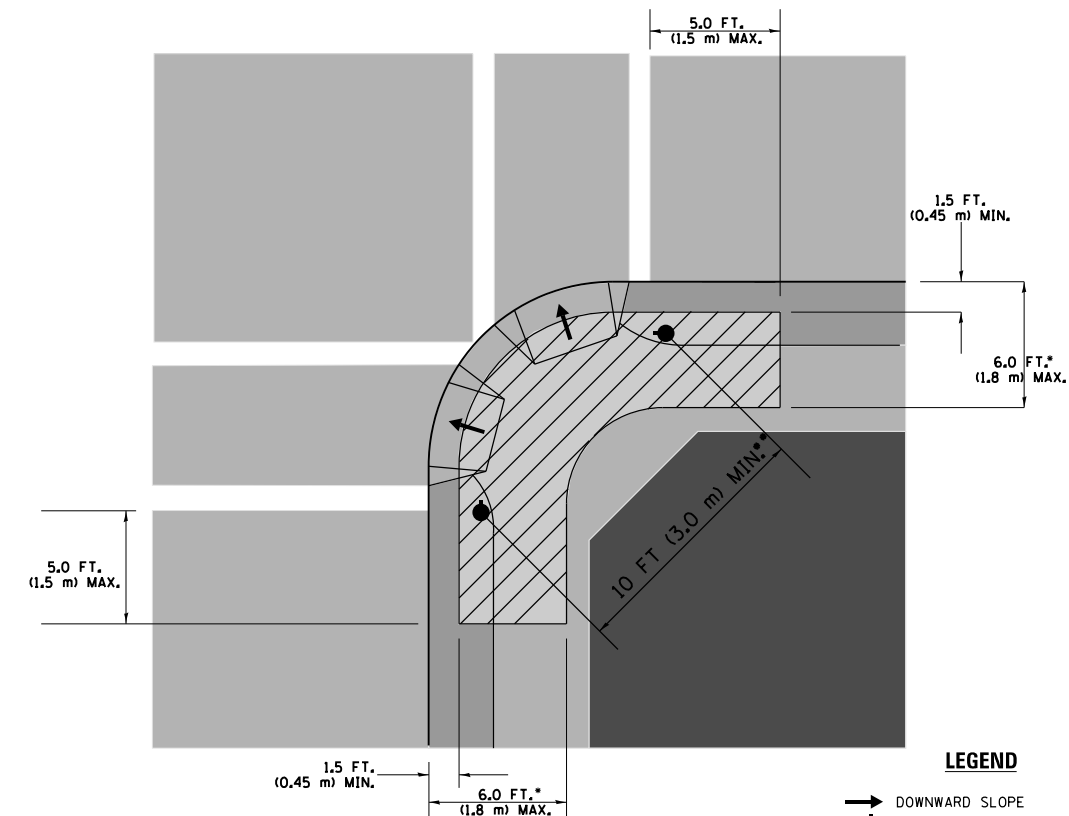

- WHERE THERE ARE CONSTRAINTS THAT MAKE IT IMPRACTICAL TO PLACE THE PEDESTRIAN PUSHBUTTON BETWEEN 1.5 FT (0.45 m) AND 6 FT ( 1.8 m) FROM THE EDGE OF THE CURB, SHOULDER, OR PAVEMENT, IT SHOULD NOT BE FURTHER THAN 10 FT (3 m) FROM THE EDGE OF CURB, SHOULDER, OR PAVEMENT.
- WHERE THERE ARE CONSTRAINTS ON A PARTICULAR CORNER THAT MAKE IT IMPRACTICAL TO PROVIDE THE 10 FT (3 m) SEPERATION BETWEEN THE TWO PEDESTRIAN PUSHBUTTONS, THE PUSHBUTTONS MAY BE PLACED CLOSER TOGETHER OR ON THE SAME POLE.

**NOTES:**


1. PEDESTRIAN SIGNAL HEADS SHALL BE MOUNTED WITH THE BOTTOM OF THE SIGNAL HOUSING INCLUDING BRACKETS NOT LESS THAN 8 FT (2.4 m) OR MORE THAN 10 FT (3 m) ABOVE SIDEWALK LEVEL, AND SHALL BE POSITIONED AND ADJUSTED TO PROVIDE MAXIMUM VISIBILITY AT THE BEGINNING OF THE CONTROLLED CROSSWALK.
2. THE BOTTOM OF THE SIGNAL HOUSING (INCLUDING BRACKETS) OF A VEHICULAR SIGNAL FACE THAT IS NOT LOCATED OVER A HIGHWAY SHALL BE AT LEAST 8 FT (2.4 m) BUT NOT MORE THAN 19 FT (5.8 m) ABOVE THE SIDEWALK OR, IF THERE IS NO SIDEWALK, ABOVE THE PAVEMENT GRADE AT THE CENTER OF THE ROADWAY.
3. THE BOTTOM OF THE SIGNAL HOUSING AND ANY RELATED ATTACHMENTS TO A SIGNAL FACE LOCATED OVER ANY PORTION OF A HIGHWAY SHALL BE ACCORDING TO CURRENT STATE STANDARDS 877001, 877002, 877006, 877011 AND 877012 WITH A MINIMUM OF 16 FT (5.0 m) AND A MAXIMUM OF 18 FT. (5.5 m) FROM THE HIGHEST POINT OF PAVEMENT.
4. THE BOTTOM OF THE TEMPORARY SPAN WIRE MOUNTED SIGNAL HOUSING AND ANY RELATED ATTACHMENTS TO A SIGNAL FACE LOCATED OVER ANY PORTION OF A HIGHWAY SHALL BE ACCORDING TO CURRENT STATE STANDARD 880001 WITH A MINIMUM OF 17 FT (5.18 m) FROM THE HIGHEST POINT OF PAVEMENT.
5. THE TOP OF THE SIGNAL HOUSING OF A SIGNAL FACE LOCATED OVER ANY PORTION OF A HIGHWAY SHALL NOT BE MORE THAN 25.6 FT (7.8 m) ABOVE THE PAVEMENT.

**TRAFFIC SIGNAL EQUIPMENT OFFSET**


TRAFFIC SIGNAL EQUIPMENT	COMBINATION CONCRETE CURB AND GUTTER (MINIMUM DISTANCE FROM BACK OF CURB TO CENTERLINE OF FOUNDATION)	SHOULDER/NON-CURBED AREA (MINIMUM DISTANCE FROM EDGE OF PAVEMENT TO CENTERLINE OF FOUNDATION)
TRAFFIC SIGNAL MAST ARM POLE	6 FT (1.8m)	SHOULDER WIDTH + 2 FT (0.6m), MINIMUM 10 FT (3.0m)
TRAFFIC SIGNAL POST	4 FT (1.2m)	SHOULDER WIDTH + 2 FT (0.6m), MINIMUM 10 FT (3.0m)
PEDESTRIAN SIGNAL POST	4 FT (1.2m)	SHOULDER WIDTH + 2 FT (0.6m), MINIMUM 10 FT (3.0m)
PEDESTRIAN PUSHBUTTON POST	4 FT (1.2m)	SHOULDER WIDTH + 2 FT (0.6m), MINIMUM 10 FT (3.0m)
TEMPORARY WOOD POLE	6 FT (1.8m)	SHOULDER WIDTH + 2 FT (0.6m), MINIMUM 10 FT (3.0m)
CONTROLLER CABINET	6 FT (1.8m) MINIMUM DISTANCE SEE NOTE 2	SHOULDER WIDTH + 6 FT (1.8m), MINIMUM 16 FT (4.9m) SEE NOTE 3.
SERVICE INSTALLATION, GROUND MOUNT	6 FT (1.8m) MINIMUM DISTANCE SEE NOTE 2	SHOULDER WIDTH + 6 FT (1.8m), MINIMUM 16 FT (4.9m) SEE NOTE 3.

**NOTES:**

1. CONTACT THE "AREA TRAFFIC SIGNAL MAINTENANCE AND OPERATIONS ENGINEER" FOR ASSISTANCE IN LOCATING THE TRAFFIC SIGNAL EQUIPMENT WHEN THERE ARE CONFLICTS WITH DITCHES OR THE MINIMUM OFFSET DISTANCES CANNOT BE MET.
2. MINIMUM DISTANCE FROM THE BACK OF CURB TO THE ROADWAY SIDE OF THE FOUNDATION.
3. MINIMUM DISTANCE FROM THE EDGE OF PAVEMENT TO THE ROADWAY SIDE OF THE FOUNDATION.
4. ANY CHANGES TO THE OFFSETS OF THE FOUNDATIONS, FROM THE MINIMUM DISTANCES LISTED IN THE "TRAFFIC SIGNAL EQUIPMENT OFFSET" CHART AND THE TRAFFIC SIGNAL INSTALLATION PLAN, COULD EFFECT THE PLACEMENT OF THE SIGNAL HEADS, PEDESTRIAN SIGNAL HEADS AND THE PEDESTRIAN PUSHBUTTONS. THE SIGNAL HEAD PLACEMENT ON THE MAST ARMS SHALL REMAIN AS PER THE TRAFFIC SIGNAL INSTALLATION PLAN AND THE "TRAFFIC SIGNAL MAST ARM AND SIGNAL POST" DETAIL ABOVE. THE PROPOSED MAST ARM LENGTHS MAY NEED TO BE REVISED TO MEET THE ABOVE REQUIREMENTS. THE PEDESTRIAN SIGNAL HEADS AND PEDESTRIAN PUSHBUTTONS MUST MEET THE REQUIREMENTS UNDER THE DETAILS ON THIS SHEET.


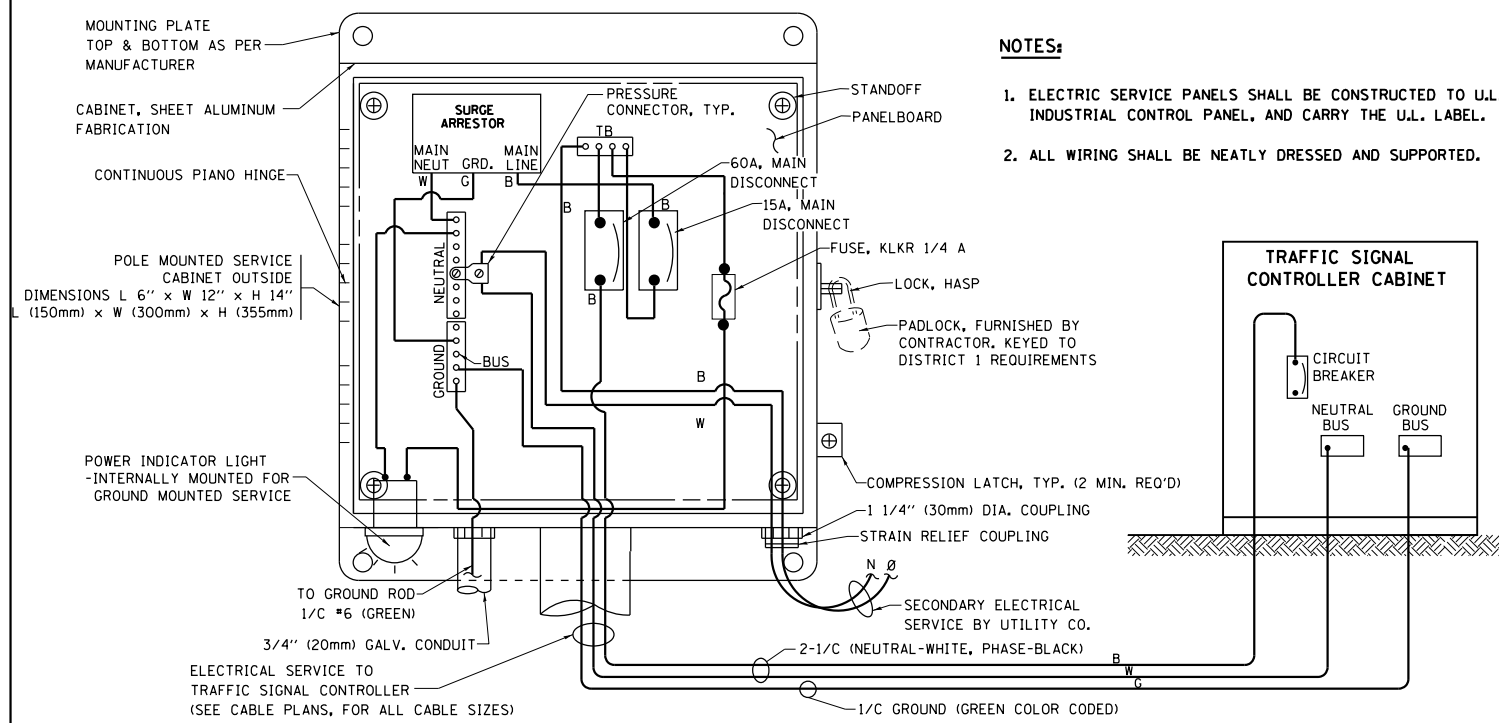


**ELECTRICAL SERVICE - PANEL DIAGRAM (TYPICAL FOR POLE AND GROUND MOUNTED SERVICE)  
SERVICE INSTALLATION POLE MOUNT (SHOWN)  
(NOT TO SCALE)**




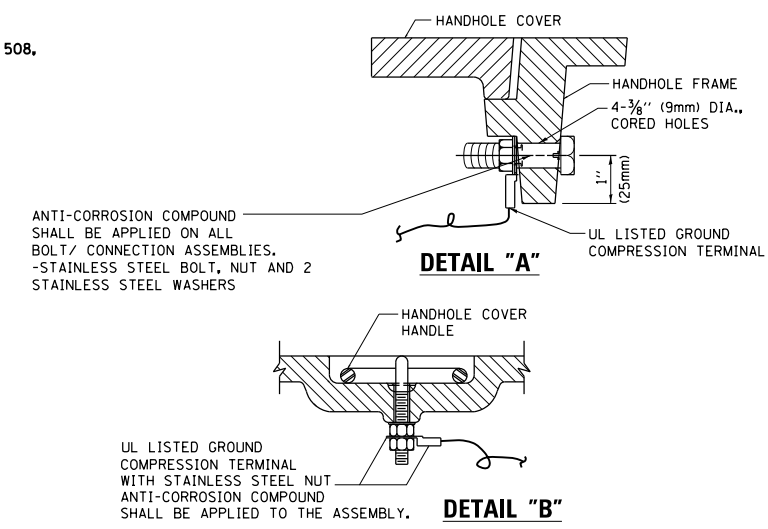



**NOTES:**  
**GROUNDING SYSTEM**

- THE GROUNDING SYSTEM SHALL CONSIST OF AN INSULATED CONDUCTOR TYPE XLP, NO. 6 A.W.G., STRANDED COPPER TO BE INSTALLED IN RACEWAYS. THE GROUNDING CABLE SHALL BE INSTALLED IN A CONTINUOUS MANNER AS SHOWN ON THE CABLE PLAN ENCLOSED. ALL GROUNDING CONDUCTORS SHALL BE BONDED TO METAL ENCLOSURE (HANDHOLE, POST, MAST ARM, CONTROLLER, ETC.). GROUND ROD SHALL BE 3/4" DIA. x 10'-0" (20mm x 3.0m) LONG, COPPER CLAD. ONE GROUND ROD SHALL BE INSTALLED AT ALL POST FOUNDATIONS, POLE FOUNDATIONS, CONTROLLER CABINET FOUNDATION AND ELECTRICAL SERVICE INSTALLATION AS INDICATED ON THE CABLE PLAN. IF THERE ARE ANY SPECIAL CONDITIONS SUCH AS SUB-SURFACE CONDITIONS OR INSTALLATION PROBLEMS, THE RESIDENT ENGINEER SHALL BE NOTIFIED OR CONTACT THE BUREAU OF TRAFFIC, ILLINOIS DEPARTMENT OF TRANSPORTATION DISTRICT ONE AT (847) 705-4139.
- THE NEUTRAL CONDUCTOR AND THE GROUND CONDUCTOR SHALL BE CONNECTED IN THE SERVICE INSTALLATION. AT NO OTHER POINT IN THE TRAFFIC SIGNAL SYSTEM SHALL THE NEUTRAL AND GROUND CONDUCTORS BE CONNECTED.
- ALL EQUIPMENT GROUNDING CONDUCTORS SHALL TERMINATE AT THE GROUND BUS IN THE CONTROLLER CABINET.
- THE CONTRACTOR SHALL PROVIDE A GROUND CABLE WITH CONNECTORS BETWEEN THE HANDHOLE COVER AND HANDHOLE FRAME.

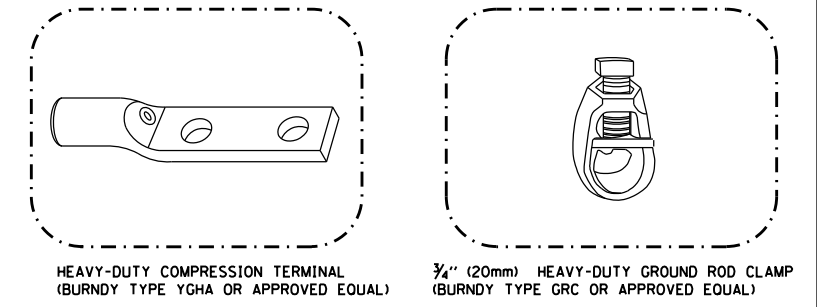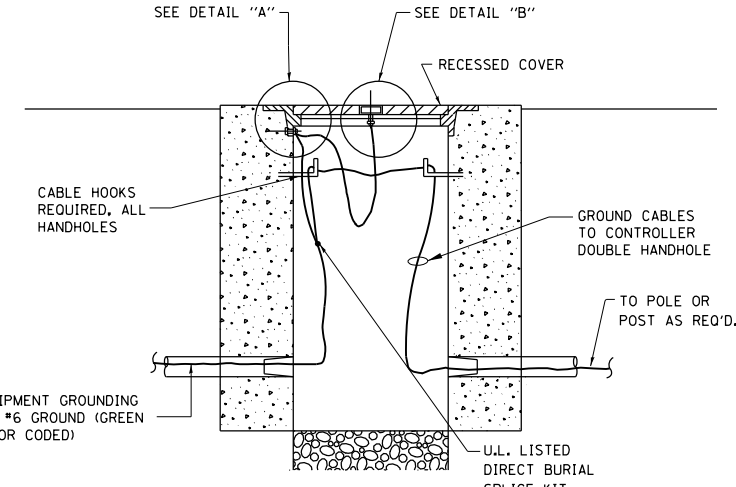


- NOTES:**
- ALL CLAMPS SHALL BE BRONZE OR COPPER, UL APPROVED.
  - GROUND CABLE SHALL BE LOOPED OVER HOOKS IN THE HANDHOLES 6.5' (2.0m) SLACK SHALL BE PROVIDED IN SINGLE HANDHOLES 13' (4.0m) OF SLACK SHALL BE PROVIDED IN DOUBLE HANDHOLES. 5' (1.4m) OF SLACK SHALL BE PROVIDED BETWEEN FRAME AND COVER.

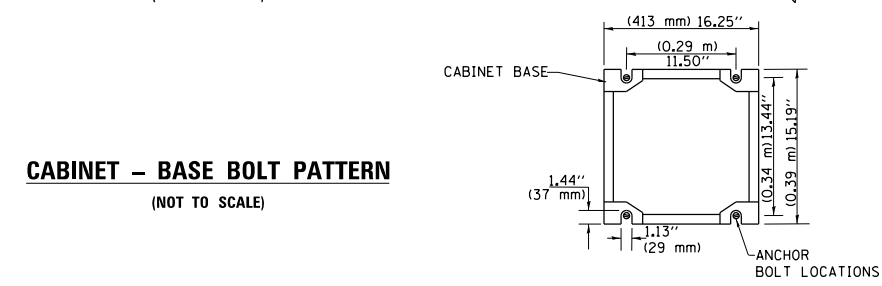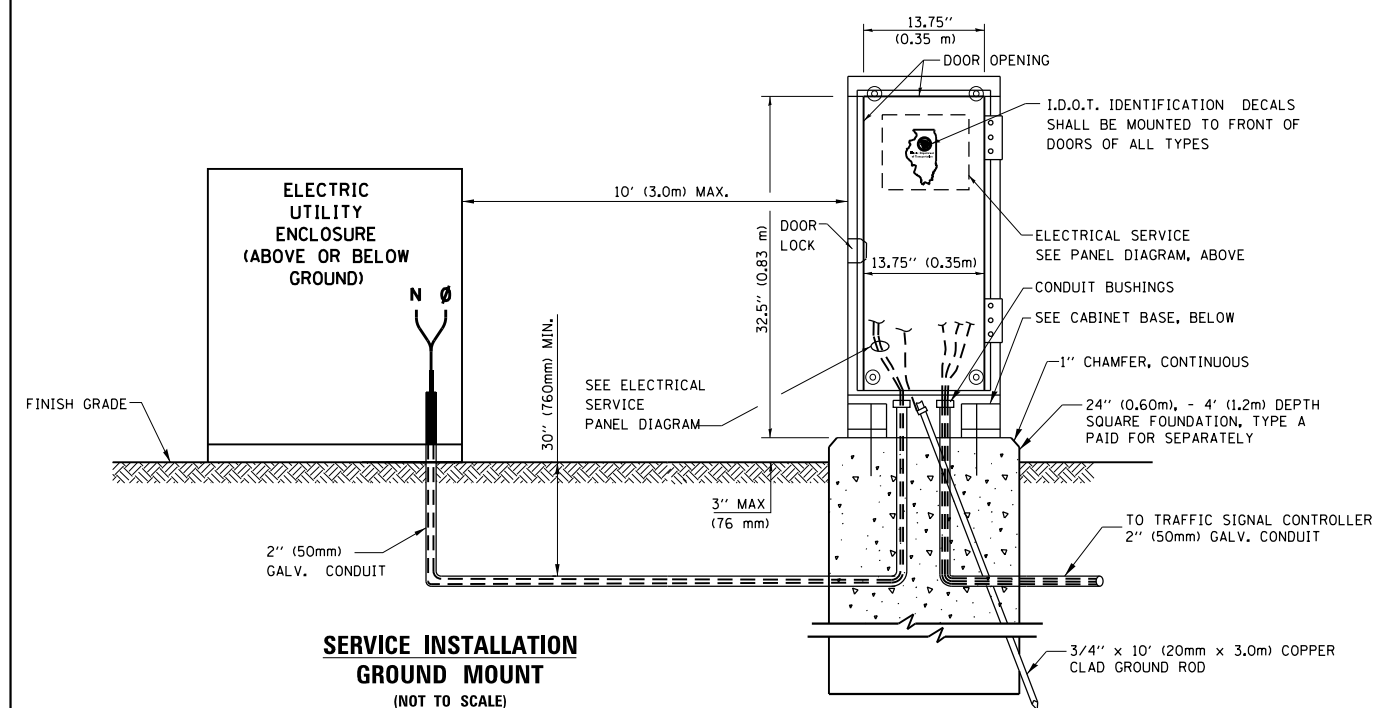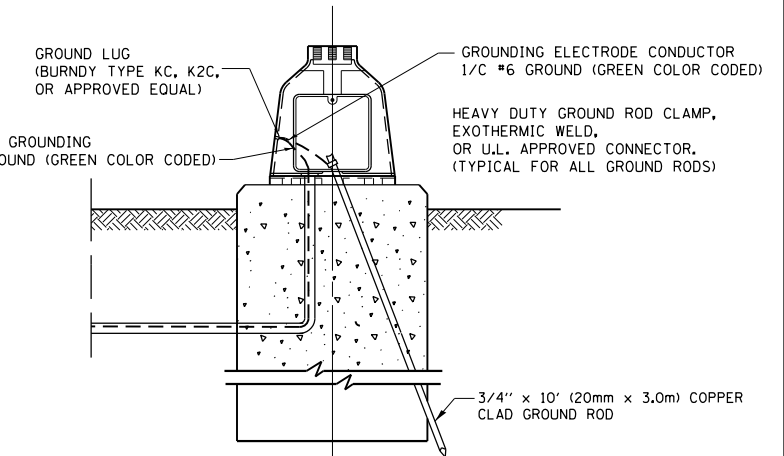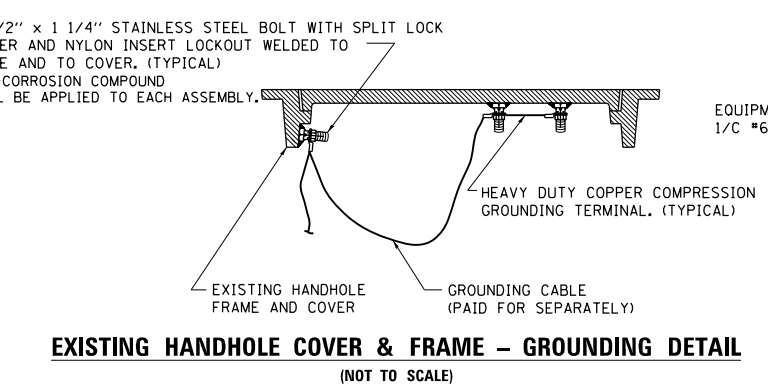


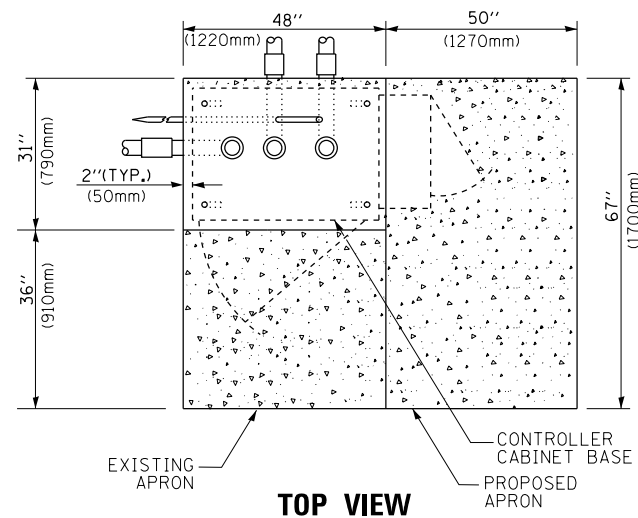

**TOP VIEW**

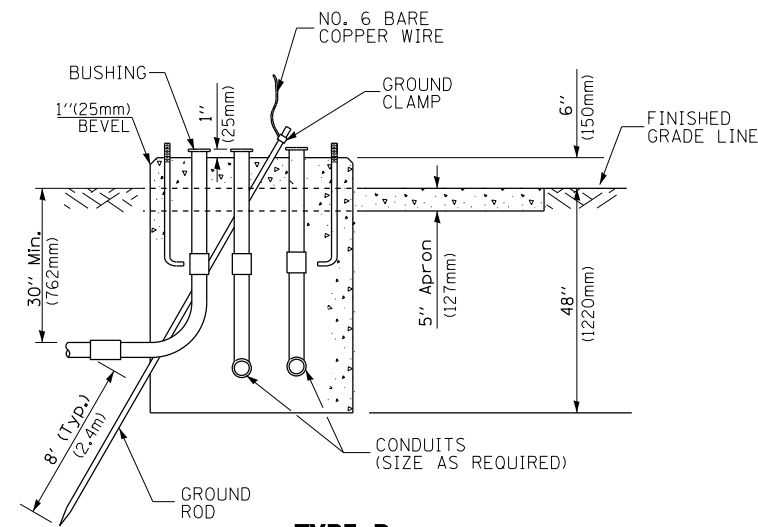


**TYPE D  
FOR GROUND MOUNTED  
CONTROLLER CABINET  
AND UPS BATTERY CABINET**

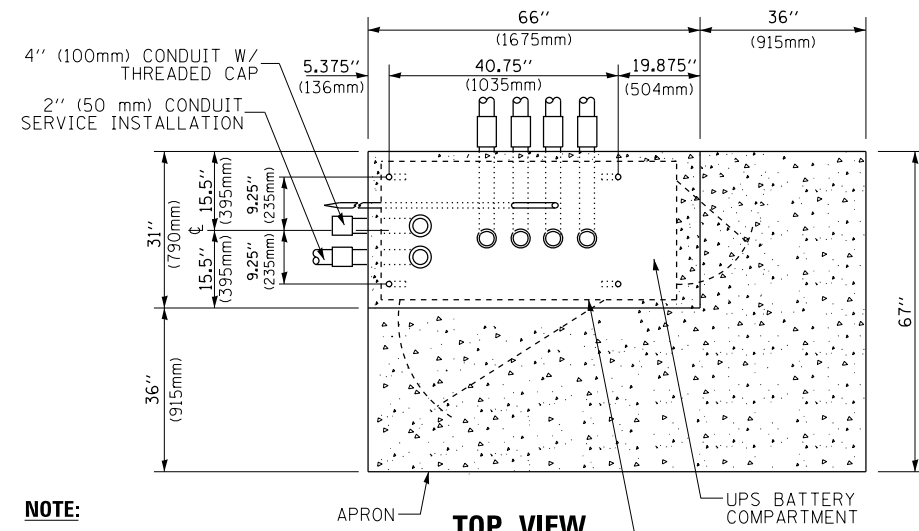


**TOP VIEW**

**NOTE:**

TOP OF FOUNDATION SHALL BE HIGHER THAN TOP OF DOUBLE HANDHOLE

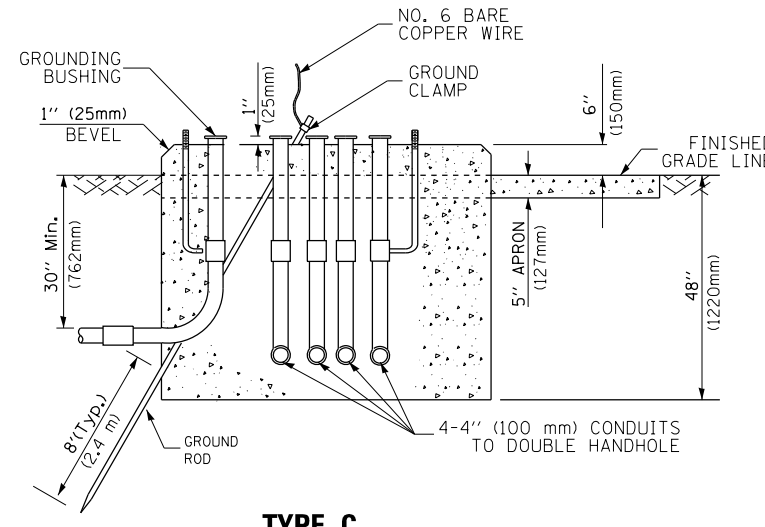

**TYPE C  
FOR GROUND MOUNTED  
SUPER P (TYPE IV) AND SUPER R (TYPE V)  
CONTROLLER CABINETS**

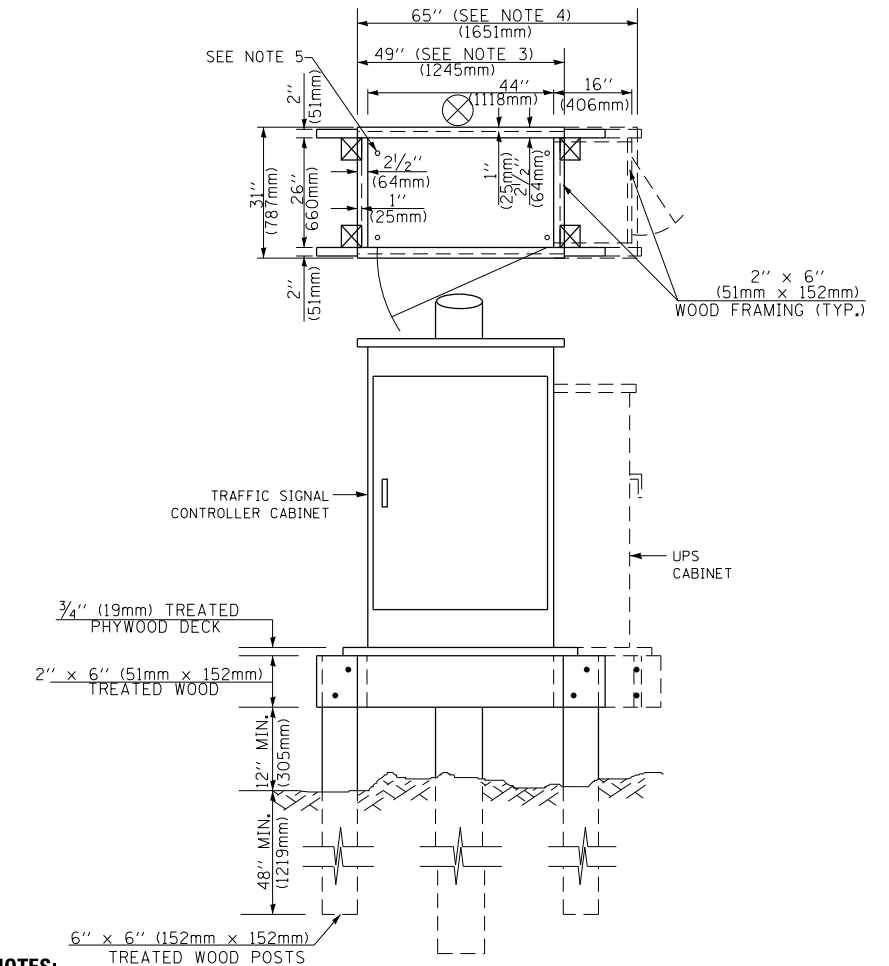

**NOTES:**

1. BASED ON CONTROLLER CABINET TYPE IV WITH BASE DIMENSIONS OF 26" x 44" (660mm x 1118mm). ADJUST PLATFORM SIZE TO FIT CABINET BASE DIMENSIONS BEING SUPPLIED.
2. BASED ON UNINTERRUPTIBLE POWER SUPPLY CABINET WITH BASE DIMENSIONS OF 16" x 25" (406mm x 635mm). ADJUST PLATFORM SIZE TO FIT CABINET BASE DIMENSIONS BEING SUPPLIED.
3. PLATFORM SIZE FOR CONTROLLER CABINET TYPE IV.
4. PLATFORM SIZE FOR CONTROLLER CABINET TYPE IV AND UNINTERRUPTIBLE POWER SUPPLY CABINET.
5. DRILLED HOLES THROUGH THE PLATFORM BASE TO MATCH THE CONTROLLER CABINET BOLT TEMPLATE. FASTEN THE CONTROLLER CABINET TO THE PLATFORM WITH CARRIAGE BOLTS, WASHERS AND NUTS.
6. FASTEN ALL SUPPORT WOOD FRAMING TO THE WOOD POSTS WITH 2 LAG SCREWS FOR EACH CONNECTION.

**TEMPORARY SIGNAL CONTROLLER  
WOOD SUPPORT PLATFORM**

CABLE SLACK LENGTH	FEET	METER
HANDHOLE	6.5	2.0
DOUBLE HANDHOLE	13.0	4.0
SIGNAL POST	2.0	0.6
MAST ARM	2.0	0.6
CONTROLLER CABINET	1.5	0.5
FIBER OPTIC AT CABINET	13.0	4.0
ELECTRIC SERVICE AT (CABINET OR SERVICE LOCATION)	1.5	0.5
GROUND CABLE (SIGNAL POST, MAST ARM, CABINET)	1.5	0.5
GROUND CABLE (BETWEEN FRAME AND COVER)	5.0	1.6

**CABLE SLACK**

VERTICAL CABLE LENGTH	FEET	METER
MAST ARM POLE (MAST ARM MOUNTED SIGNAL HEAD) (L = MAST ARM LENGTH - DISTANCE TO SIGNAL HEAD FROM END OF ARM)	20.0+L	6.0+L
BRACKET MOUNTED (MAST ARM POLE OR SIGNAL POLE)	13.0	4.0
PEDESTRIAN PUSH BUTTON	6.0	2.0
SERVICE INSTALLATION POLE MOUNT TO SERVICE DROP	13.5	4.1
SERVICE INSTALLATION POLE MOUNT TO GROUND	13.5	4.1
SERVICE INSTALLATION GROUND MOUNT	6.0	2.0
FOUNDATION (SIGNAL POST, MAST ARM POLE, CONTROLLER CABINET, SERVICE-GROUND MOUNT)	3.0	1.0

**VERTICAL CABLE LENGTH**

FOUNDATION	DEPTH
TYPE A - Signal Post	4'-0" (1.2m)
TYPE C - CONTROLLER W/ UPS	4'-0" (1.2m)
TYPE D - CONTROLLER	4'-0" (1.2m)
SERVICE INSTALLATION, GROUND MOUNT, TYPE A - SQUARE	4'-0" (1.2m)


**DEPTH OF FOUNDATION**

MAST ARM LENGTH	① FOUNDATION DEPTH	FOUNDATION DIAMETER	SPIRAL DIAMETER	QUANTITY OF REBARS	SIZE OF REBARS
Less than 30' (9.1 m)	10'-0" (3.0 m)	30" (750mm)	24" (600mm)	8	6(19)
Greater than or equal to 30' (9.1 m) and less than 40' (12.2 m)	13'-6" (4.1 m)	30" (750mm)	24" (600mm)	8	6(19)
Greater than or equal to 40' (12.2 m) and less than 50' (15.2 m)	11'-0" (3.4 m)	36" (900mm)	30" (750mm)	12	7(22)
Greater than or equal to 50' (15.2 m) and up to 55' (16.8 m)	13'-0" (4.0 m)	36" (900mm)	30" (750mm)	12	7(22)
Greater than or equal to 55' (16.8 m) and less than 65' (19.8 m)	15'-0" (4.6 m)	36" (900mm)	30" (750mm)	12	7(22)
Greater than or equal to 65' (19.8 m) and up to 75' (22.9 m)	21'-0" (6.4 m)	42" (1060mm)	36" (900mm)	16	8(25)
Greater than or equal to 75' (22.9 m) and up to 85' (25.9 m)	25'-0" (7.6 m)	42" (1060mm)	36" (900mm)	16	8(25)

**NOTES:**

1. These foundation depths are for sites which have cohesive soils (clayey silt, sandy clay, etc.) along the length of the shaft, with an average unconfined compressive strength (qu) > 1.0 tsf (100 kpa). This strength shall be verified by boring data prior to construction or with testing by the Engineer during foundation drilling. The Bureau of Bridges & Structures should be contacted for a revised design if other conditions are encountered.
2. Combination mast arm assemblies under 55 feet (16.8 m) shall use 36" (900 mm) diameter foundations.
3. Combination mast arm assemblies under 56 feet (16.8 m) through 75 feet (22.9 m) shall use 42" (1060 mm) diameter foundations.
4. For mast arm assemblies with dual arms refer to state standard 878001..


**DEPTH OF MAST ARM FOUNDATIONS, TYPE E**

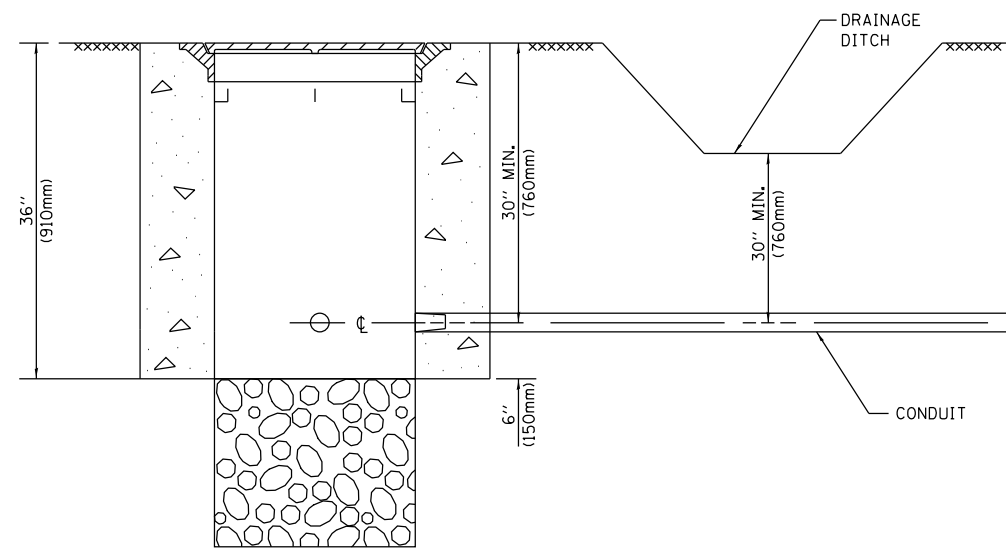


**NOTES:**

1. CONDUIT DEPTH SHALL BE A MINIMUM OF 30" (760mm) BELOW THE BOTTOM OF THE DRAINAGE DITCH OR ANY SLOPING GROUND
2. THE MINIMUM CONDUIT DEPTH APPLIES TO ALL CONDUIT PLACED UNDER ROADWAY PAVEMENT, MULTI-USE PATHS, SIDEWALKS AND SOIL SURFACES.
3. THE MINIMUM CONDUIT DEPTH APPLIES TO ALL HANDHOLES, HEAVY DUTY HANDHOLES AND DOUBLE HANDHOLES.

**HANDHOLE WITH MINIMUM CONDUIT DEPTH**  
(NOT TO SCALE)

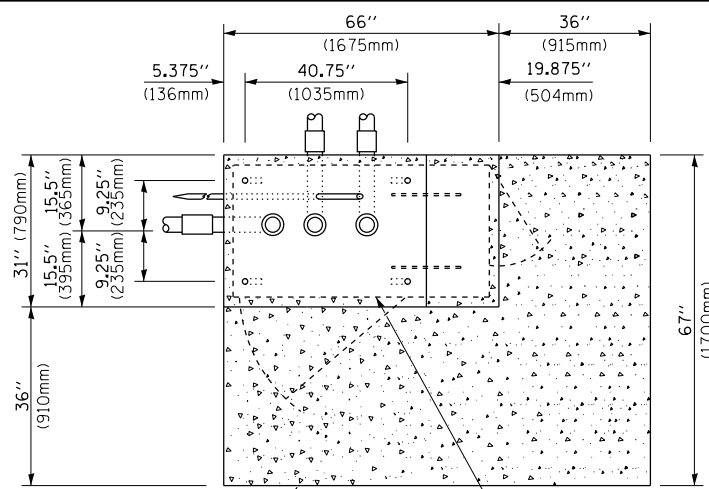

**TOP VIEW**  
(NOT TO SCALE)

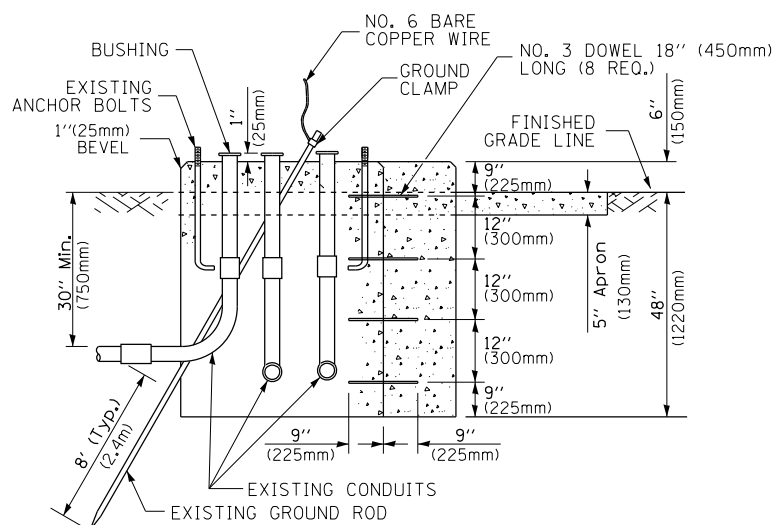


**MODIFY EXISTING TYPE "D" FOUNDATION TO TYPE "C" FOUNDATION**  
(NOT TO SCALE)


ITEM NO.	IDENTIFICATION
1	OUTLET BOX- GALV. 21 CU.IN. (0.000344 CU-M)
2	LAMP HOLDER AND COVER
3	OUTLET BOX COVER
4	RUBBER COVER GASKET
5	REDUCING BUSHING
6	3/4" (19 mm) CLOSE NIPPLE
7	3/4" (19 mm) LOCKNUT
8	3/4" (19 mm) HOLE PLUG
9	SADDLE BRACKET - GALV.
10	6 WATT PAR 38 LED FLOOD LAMP
11	DETECTOR UNIT
12	POST CAP [18 FT. (5.4 m) POST MIN.]

**NOTES:**

1. ALL ELECTRICAL ITEMS, EXCEPT ITEMS #2 AND #11 SHALL BE ALUMINUM OR GALVANIZED
2. ITEM #1- OZ/GEDNEY FSX-1-50 OR EQUIVALENT  
ITEM #2- MULBERRY CON-O-SHADE LAMP SHIELD OR EQUIVALENT  
ITEM #9- "BAND-IT" SADDLE BRACKET OR EQUIVALENT
3. WHEN POST MOUNTING IS SPECIFIED, ITEM #9 SHALL NOT BE REQUIRED. THE DETECTION UNIT SHALL BE MOUNTED DIRECTLY ON TOP OF THE CAP BY DRILLING AND TAPPING A 3/4" (19 mm) HOLE WITH PIPE THREADS. THE POST CAP SHALL EITHER BE SCREWED TO THE TOP OF THE POST OR A MINIMUM OF 3 TIGHTENING SCREWS SHALL BE REQUIRED ON EACH CAP.

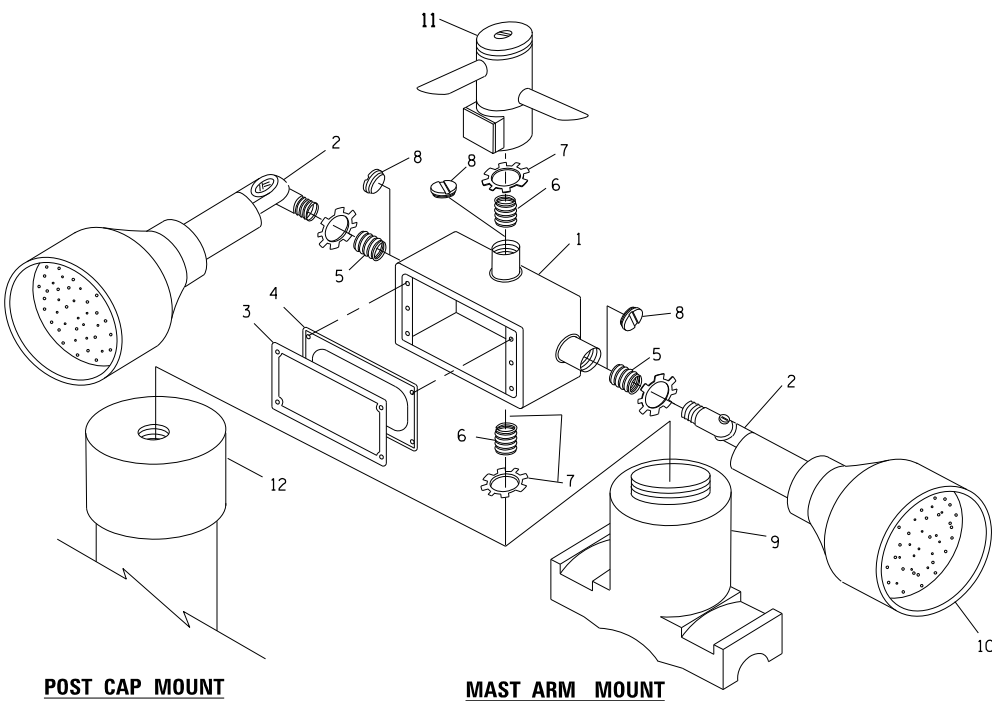

**EMERGENCY VEHICLE DETECTOR WITH CONFIRMATION BEACON MOUNTING DETAIL**

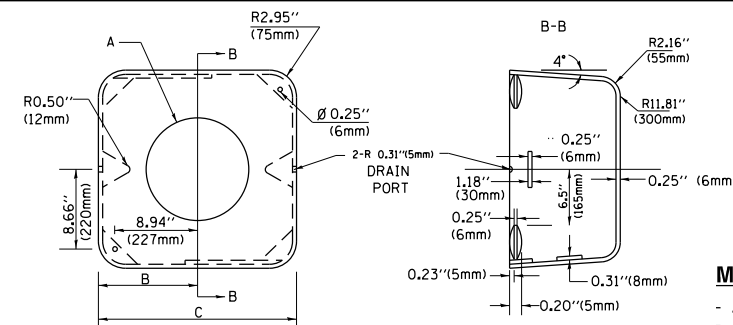

**MATERIAL:**  
- ASTM A36 STEEL  
- ASTM A-123 HOT DIPPED GALVANIZED

A	B	C	HEIGHT	WEIGHT
VARIABLES	9.5" (241mm)	19" (483mm)	7" (178mm) - 12" (300mm)	53 lbs (24kg)
VARIABLES	10.75" (273mm)	21.5" (546mm)	7" (178mm) - 12" (300mm)	68 lbs (31 kg)
VARIABLES	13.0" (330mm)	26" (660mm)	7" (178mm) - 12" (300mm)	81 lbs (37 kg)
VARIABLES	18.5" (470mm)	37" (940mm)	7" (178mm) - 12" (300mm)	126 lbs (57 kg)


**SHROUD**

**NOTES:**


1. DIMENSION "A" IS EQUAL TO THE DIAMETER OF THE MAST ARM POLE AT THE TOP OF THE SHROUD. THE SHROUD SHALL BE TIGHT TO THE MAST ARM POLE.
2. THE SUPPLIER SHALL VERIFY THE ABOVE DIMENSIONS BASED ON MAST ARM REQUIREMENTS.
3. THE HEIGHT OF THE SHROUD SHALL COVER THE ANCHOR BOLTS, NUTS AND MAST ARM POLE BASE.

**NOTE:**

SUPPORT EXISTING CABINET AND CONTROL EQUIPMENT ABOVE FOUNDATION TO KEEP TRAFFIC SIGNAL FUNCTIONING WHILE FOUNDATION MODIFICATION WORK IS PROCEEDING.

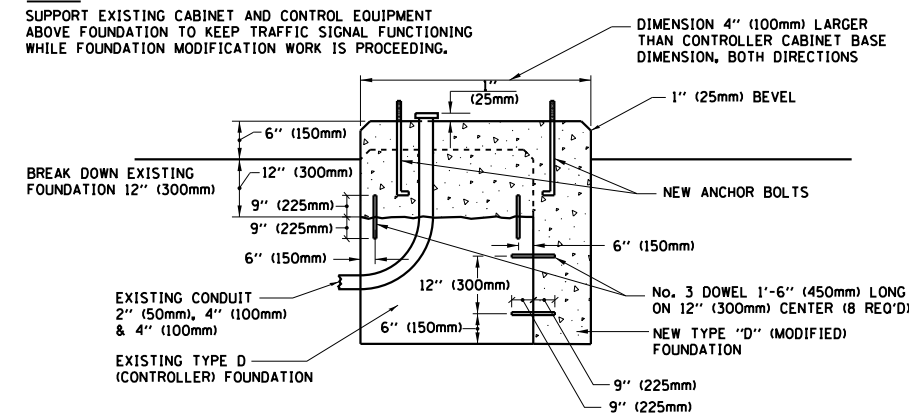

**MODIFY EXISTING TYPE "D" FOUNDATION**

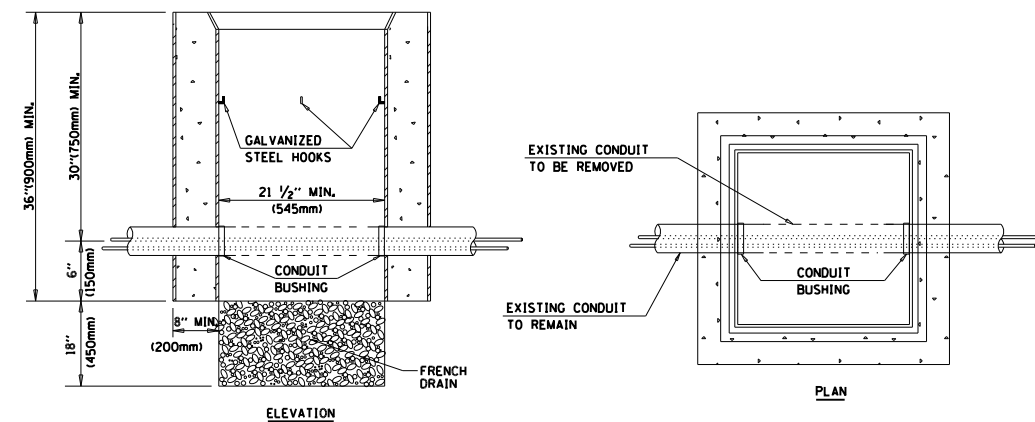

**NOTES:**

1. HANDHOLE CONSTRUCTED PER STATE STANDARD 814001.
2. REMOVAL OF THE EXISTING CONDUIT FROM THE HANDHOLE AND THE INSTALLATION OF THE CONDUIT BUSHINGS SHALL BE INCLUDED WITH THE COST OF THE HANDHOLE.

**HANDHOLE TO INTERCEPT EXISTING CONDUIT**


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	PLOT SCALE = 100.0000' / 1"	DATE - 10-28-09	REVISED -
	PLOT DATE = 8/19/2016		

**STATE OF ILLINOIS**  
**DEPARTMENT OF TRANSPORTATION**

**DISTRICT ONE**  
**STANDARD TRAFFIC SIGNAL DESIGN DETAILS**


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F.A.P. RTE.	SECTION	COUNTY	TOTAL SHEETS	SHEET NO.
104	105N-4	LAKE	113	69
<b>TS-05</b>		<b>CONTRACT NO. 60W06</b>		
FED. ROAD DIST. NO. 1 ILLINOIS FED. AID PROJECT				

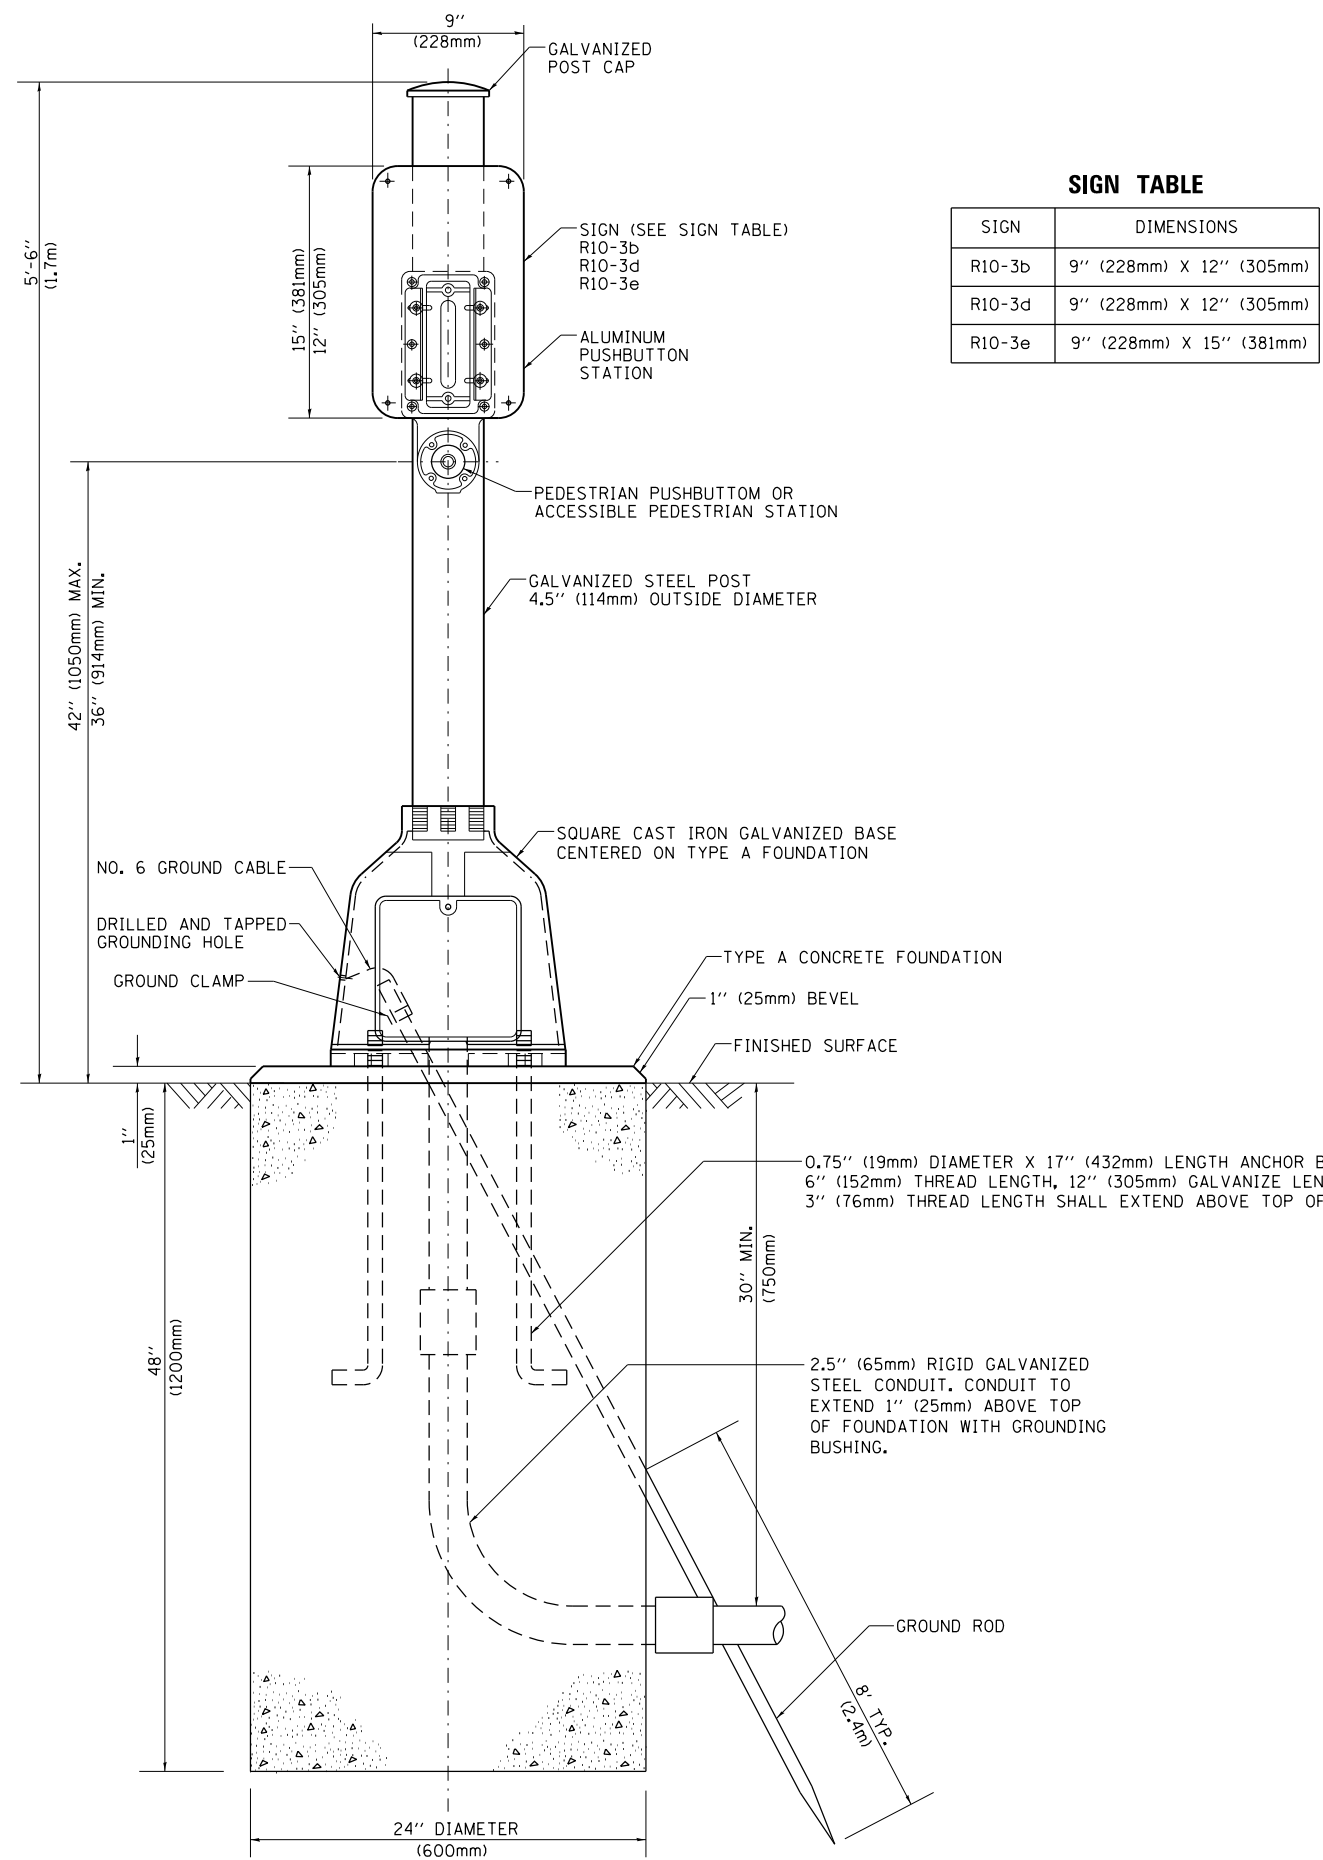

**SIGN TABLE**

SIGN	DIMENSIONS
R10-3b	9" (228mm) X 12" (305mm)
R10-3d	9" (228mm) X 12" (305mm)
R10-3e	9" (228mm) X 15" (381mm)

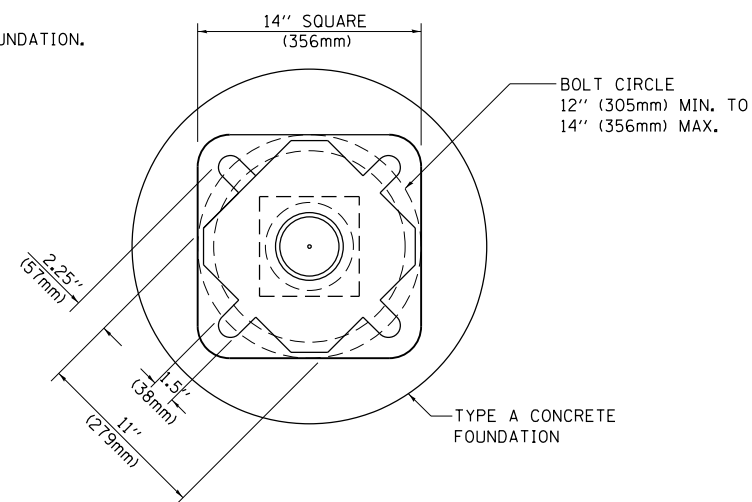

**BOLT PATTERN**

**PEDESTRIAN PUSH BUTTON POST, TYPE A**

FILE NAME =	USER NAME = ledznmrm	DESIGNED - DAG	REVISED - DAG 1-1-14
p:\11\084EBID\INTEG.illinois.gov\PWIDOT\Documents\DOT Offices\District 1\Projects\PI454\Drawings\Design\Std.dgn		CHECKED - DAD	REVISED -
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PLOT DATE = 8/19/2016			


**STATE OF ILLINOIS  
DEPARTMENT OF TRANSPORTATION**

<b>DISTRICT ONE STANDARD TRAFFIC SIGNAL DESIGN DETAILS</b>			
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F.A.P. RTE.	SECTION	COUNTY	TOTAL SHEETS	SHEET NO.
104	105N-4	LAKE	113	70
<b>TS-05</b>			<b>CONTRACT NO. 60W06</b>	
FED. ROAD DIST. NO. 1   ILLINOIS FED. AID PROJECT				


Benchmark: Spike in power pole east side of Rte 59 at 38923 N. IL Rte. 59 Elev. = 777.50

Prop. Culvert Extensions to be completed as part of Pre-Stage Construction. Traffic to be maintained utilizing Day Time Lane Closures. Contractor shall coordinate Day Time Lane Closures with IDOT.

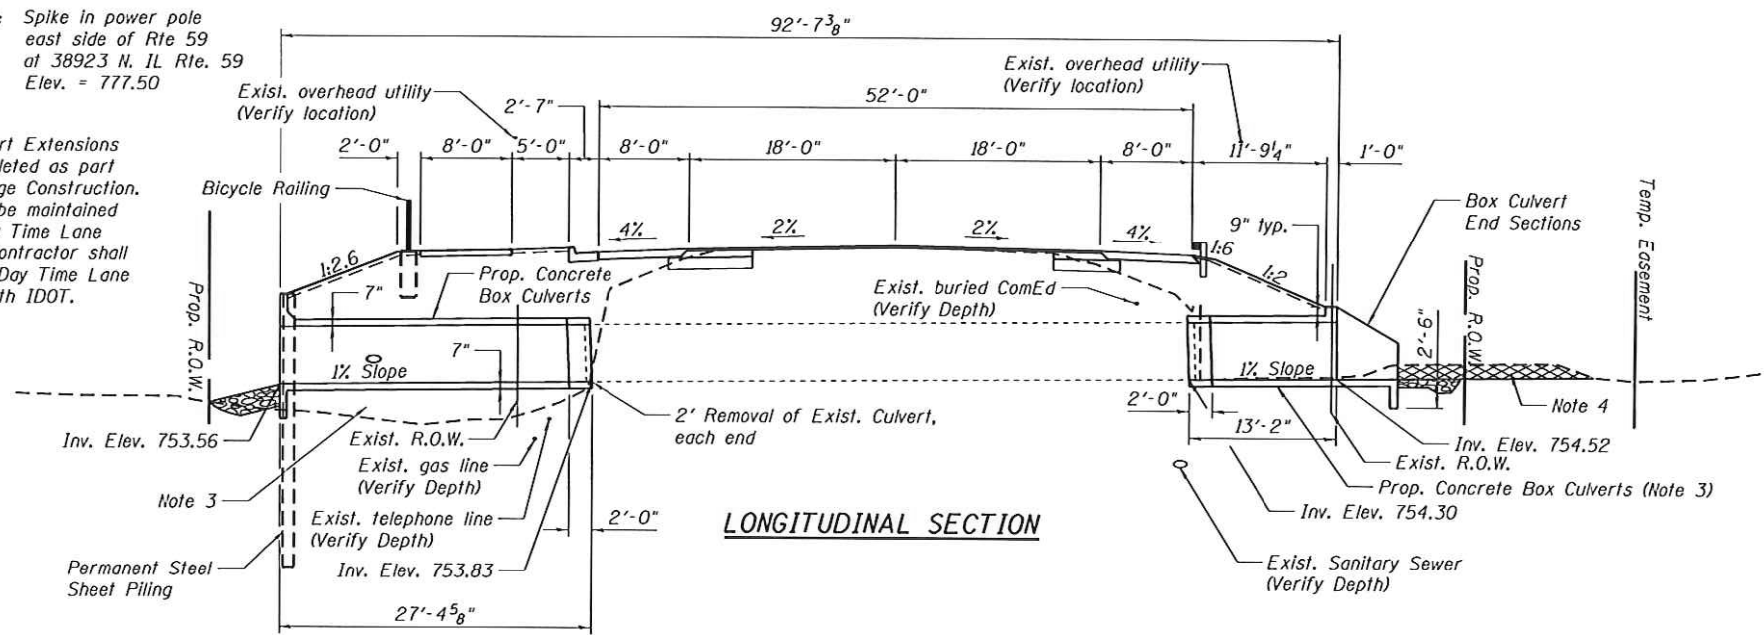

**INDEX OF SHEETS**

1. General Plan and Elevation
2. General Notes
3. Bicycle Railing Details
4. End Section Details
5. Culvert Details
6. Culvert Details

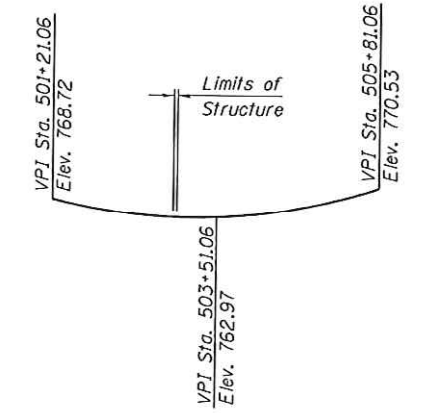

**LOADING HL-93**  
Allow 50#/sq. ft. for future wearing surface.

**DESIGN SPECIFICATIONS**  
2012 AASHTO LRFD Bridge Design Specifications, w/ 2013 Interims



**DESIGN STRESSES**  
FIELD UNITS

$f'_c = 3,500$  psi  
 $f_y = 60,000$  psi (Reinforcement)

**SEISMIC DATA**  
Pending Geotechnical Report

**NOTES**

1. Utility pole where noted on plans appears to have a supporting guide wire only with no overhead Electrical line attached. Contractor to verify if in service.
2. Contractor to verify location of sanitary sewer lines connected to manhole.
3. Contractor shall install additional bedding material as needed to fill in existing low grade and/or to provide a stable base in locations where soft soils are encountered in keeping with the Geotechnical Report, by Testing Service Corporation, dated 9/15/2014. Additional bedding material shall be included in the Unit Price for CONCRETE BOX CULVERTS.
4. Contractor shall excavate local high grade within existing channel bed as needed within the limits of proposed right-of-way and temporary easement to match channel invert with proposed culvert invert at upstream end. This work shall be measured and paid for as Removal and Disposal of Unusable Materials.

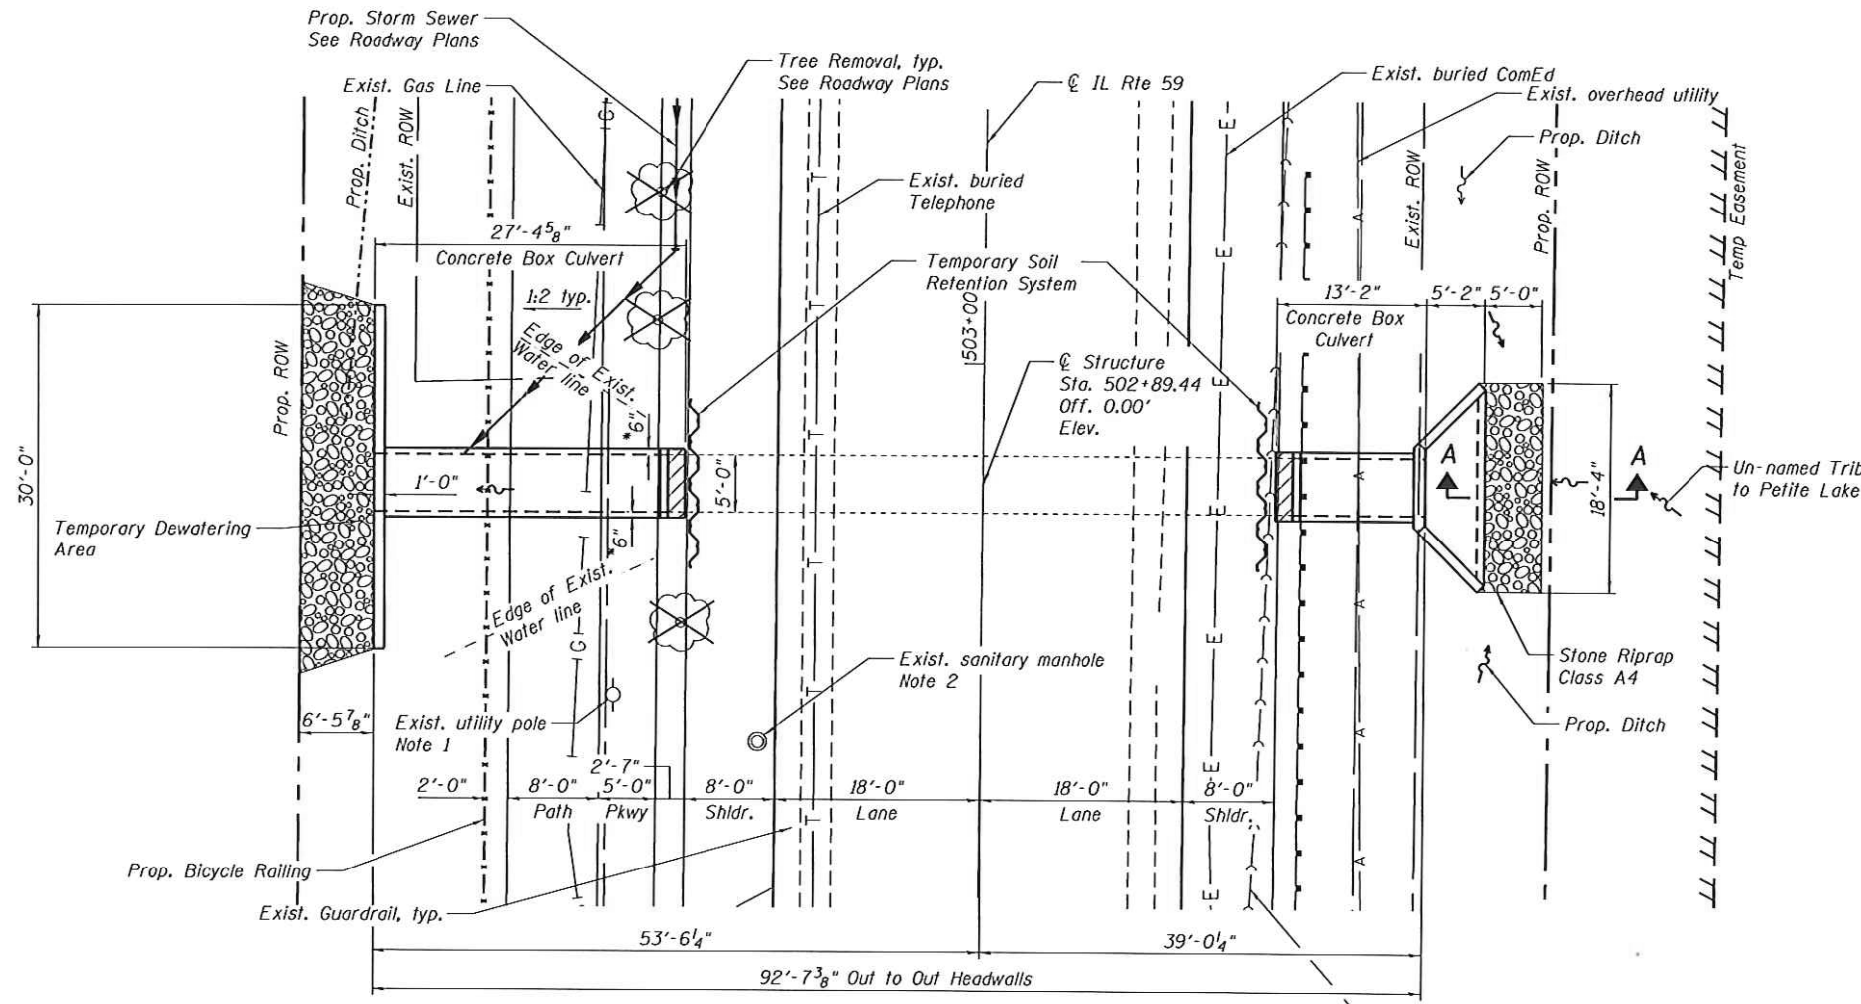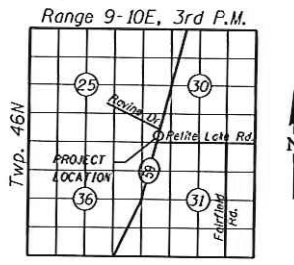

**GENERAL PLAN AND ELEVATION**  
**(F.A.P. 0104) ILLINOIS ROUTE 59**  
**OVER UN-NAMED TRIB. TO PETITE LAKE**  
**SECTION NO. 105N-4**  
**LAKE COUNTY**  
**STATION 502+93.98**

COMPANY NAME: HRGreen.com  
PROJECT CONTACT: HRGreen.com  
CLIENT: HRGreen.com  
DATE PLOTTED: 8/15/2016 4:16:35 PM  
FILE NAME: P165409-01-01-01.dwg  
PLOT DRIVER: il\_dwf.dwg  
PEN TABLE: plotfont.tbl



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PLOT DATE =	DRAWN - WJH	REVISED
	CHECKED - RGD	REVISED


**STATE OF ILLINOIS**  
**DEPARTMENT OF TRANSPORTATION**

SHEET NO. OF SHEETS

F.A.P. RTE.	SECTION	COUNTY	TOTAL SHEETS	SHEET NO.
0104	105N-4	LAKE		
				CONTRACT NO. 12377
ILLINOIS FED. AID PROJECT				

**GENERAL NOTES**


- Concrete Box Culverts 5'x5' shall conform to the requirements of Article 540.05 of the Standard Specifications.  
Fill varies from 6" to 6'-9"
- BOX CULVERT END SECTIONS shall be paid for as noted in Article 540.08, and The Contract Unit Price for BOX CULVERT END SECTIONS shall include all porous granular bedding material, cast in place wingwalls, headwalls, and aprons, cast in place portions between cells, reinforcement, excavation, backfill, and preformed joint filler.
- Contractor shall maintain streamflow in accordance with the Standard Specifications Article 502.
- Reinforcement bars shall conform to the requirements of ASTM A 760 Gr 60. See Special Provisions.
- Reinforcement bars designated (E) shall be epoxy coated
- Diversion and Construction activities shall not be permitted to cause water levels upstream to rise more than 2'-0" above the normal pool elevation.
- Cover from the face of Concrete to Reinforcement bars shall be 3" from surfaces formed against earth and 2" for all other surfaces unless otherwise shown.
- Chloride containing admixtures shall not be used for Class SI concrete.

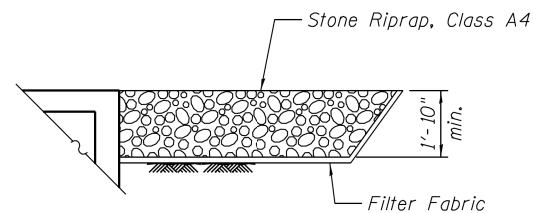

**SECTION A-A**


**TOTAL BILL OF MATERIAL**

ITEM	UNIT	TOTAL
Removal and Disposal of Unsuitable Material	Cu. Yd.	8.0
Porous Granular Embankment	Cu. Yd.	8.0
Stone Riprap, Class A4	Sq. Yd.	28
Filter Fabric	Sq. Yd.	28
Concrete Removal	Cu. Yd.	1.7
Structure Excavation	Cu. Yd.	8.0
Reinforcement Bars, Epoxy Coated	Pound	6,130
Bicycle Railing	Foot	353
Box Culvert End Sections, Culvert 1	Each	1
Expansion Bolts 3/4 Inch	Each	24
Concrete Box Culverts	Cu. Yd.	20.3
Dewatering Structure No. 1	Each	1
Permanent Sheet Piling	Sq. Ft.	595
Temporary Soil Retention System	Sq. Ft.	131

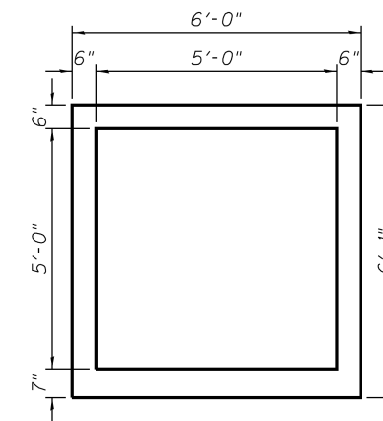

**SECTION THRU C.I.P. BARREL**

Note: Contractor to verify dimensions of existing box culvert in the field.

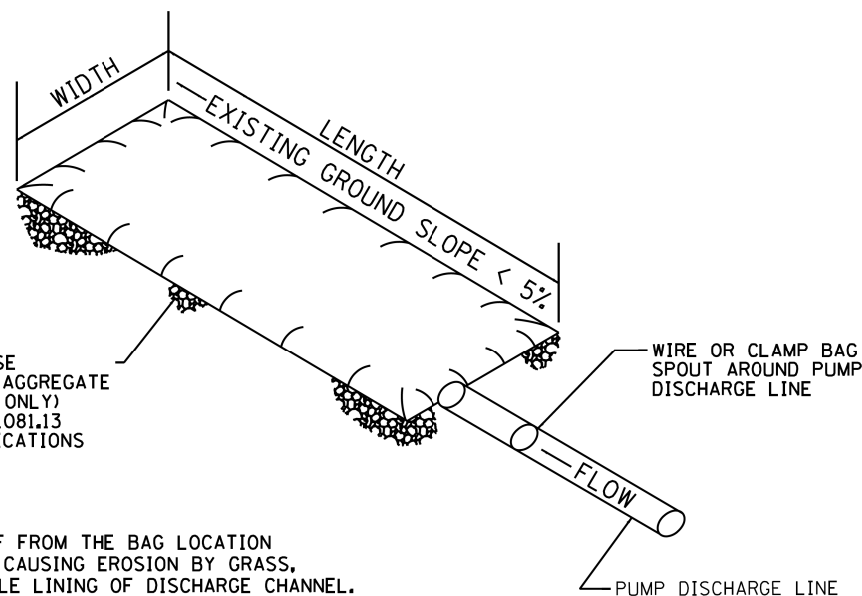

PLACE FILTERBAG ON DENSE MATURE GRASS OR ON AN AGGREGATE BASE (COARSE AGGREGATE ONLY) CONFORMING TO SECTION 1081.13 OF THE STANDARD SPECIFICATIONS

ENSURE THAT RUNOFF FROM THE BAG LOCATION IS PREVENTED FROM CAUSING EROSION BY GRASS, STONE, OR GEOTEXTILE LINING OF DISCHARGE CHANNEL.


REMOVE SILT WHEN BAG IS HALF FULL OR MORE OFTEN IF RECOMMENDED BY THE MAUNFACTURER. DISPOSE OF SILT BY TRANSPORTING THE FILLED BAG TO DISPOSAL AREA. SLIT THE BAG, BLEND SILT INTO EXISTING TOPOGRAPHY, SEED AND MULCH

MAINTAIN EXTRA FILTER BAGS ON SITE. REPLACE DAMAGED BAGS PROMPTLY.

TYPICAL FLOW RATE: 10 GPM x W x L


**FIGURE S1. SEDIMENT FILTER BAG**

NOTE: DEWATERING SYSTEM DETAILS SHALL BE USED IN CONJUNCTION WITH THE PROJECT SPECIAL PROVISIONS.

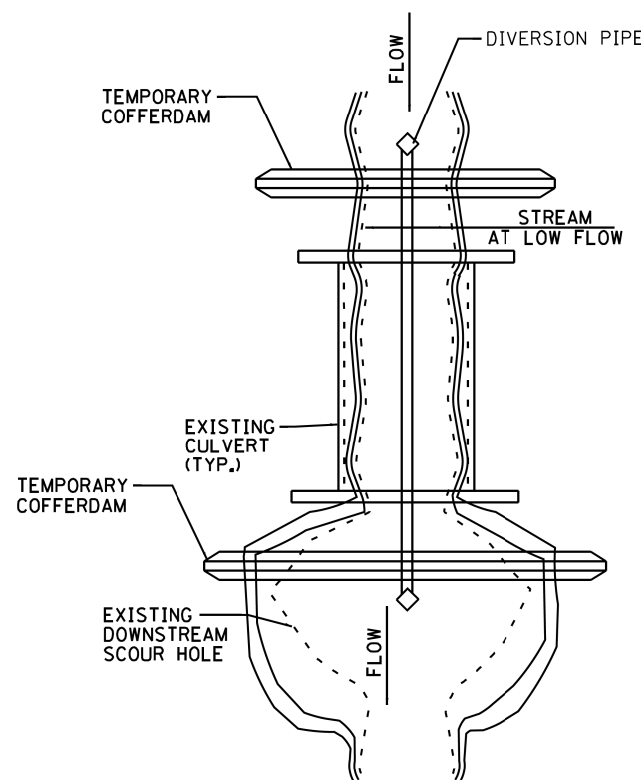

**TEMPORARY COFFERDAM WITH DIVERSION PIPE**

NOTE: FLOW DEPTH < 1'-0" DURING DRY MONTHS AND LOW FLOW CONDITIONS.

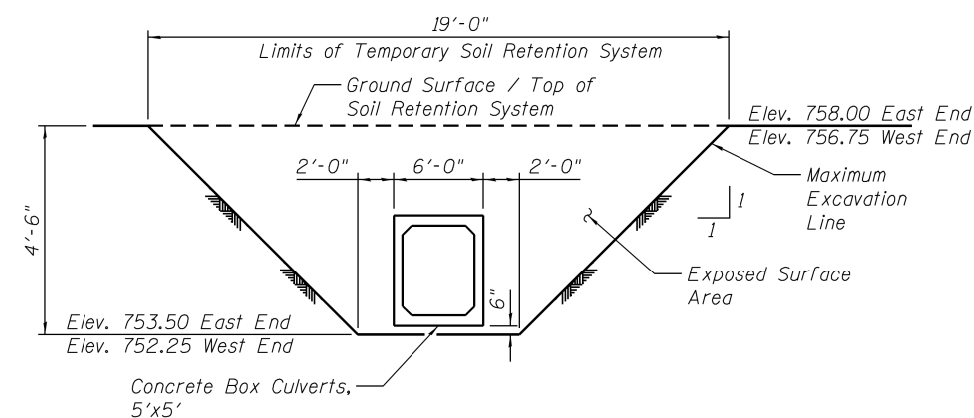

**TEMPORARY SOIL RETENTION SYSTEM DETAIL**

- 2 Locations

COMPANY NAME: HRGreen  
PROJECT CONTACT: HRGreen.com  
CLIENT: HRGreen  
DATE PLOTTED: 8/16/2016 4:00:25 PM  
FILE NAME: P145409-shr-gemmate.dgn  
PLOT DRIVER: JL-pdf\_bw.plt  
PEN TABLE: p10.tbl



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	CHECKED - JMW	REVISED	---
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PLOT DATE =	CHECKED - RGD	REVISED	---

STATE OF ILLINOIS  
DEPARTMENT OF TRANSPORTATION


GENERAL NOTES AND BILL OF MATERIAL  
STRUCTURE NO.

SHEET NO. \_\_\_ OF \_\_\_ SHEETS


F.A.P. RTE.	SECTION	COUNTY	TOTAL SHEETS	SHEET NO.
0104	105N-4	LAKE	113	72
			CONTRACT NO. 12377	

ILLINOIS FED. AID PROJECT




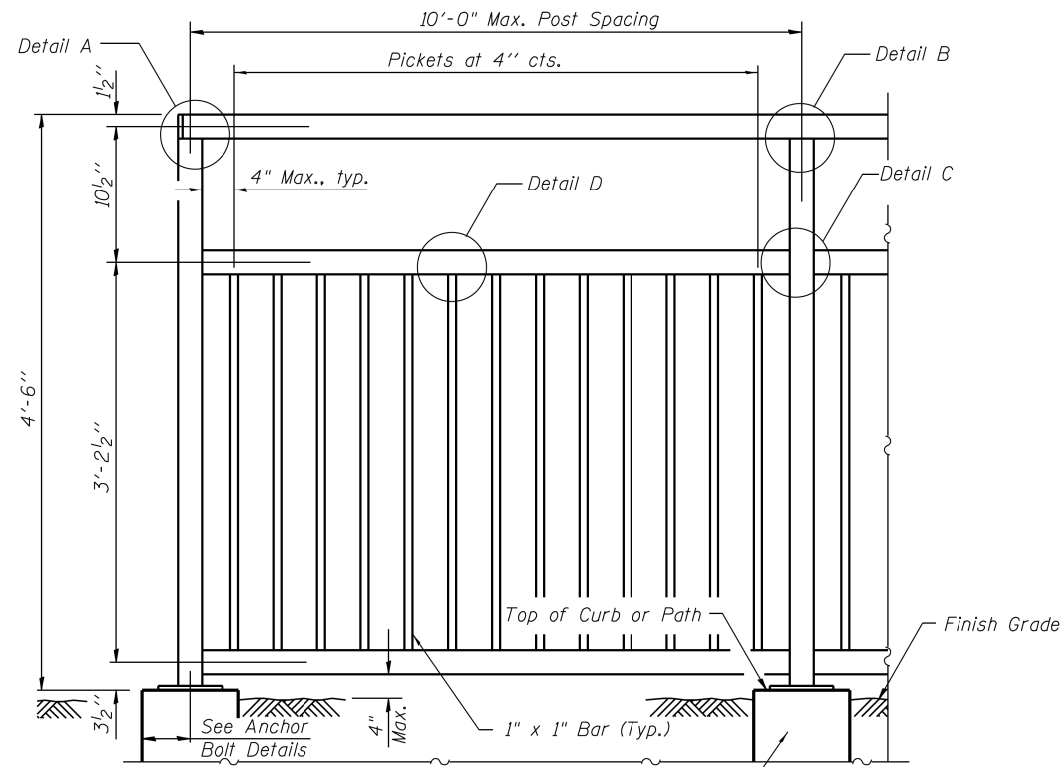


**BICYCLE RAILING**

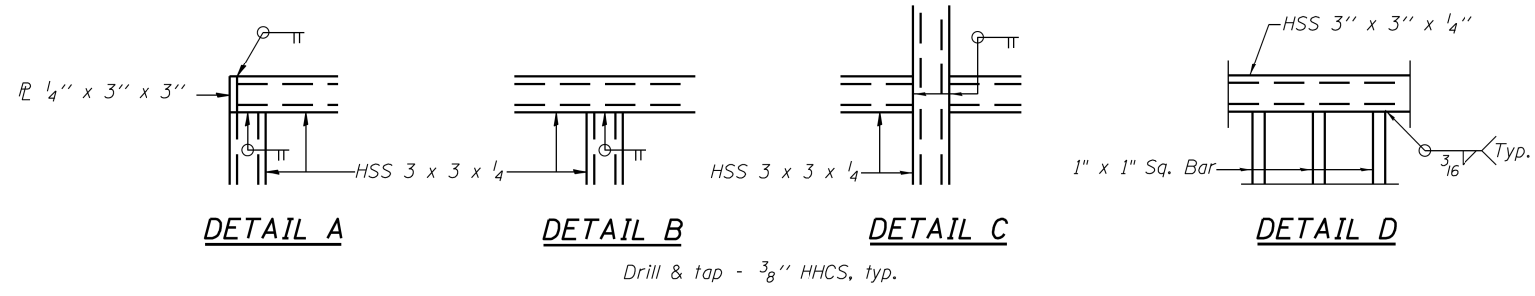

**NOTES**

All post, railing, pickets, splices, and anchor devices shall be powder coated black. The powder coating system to be used shall be approved by the engineer prior to the coating process.

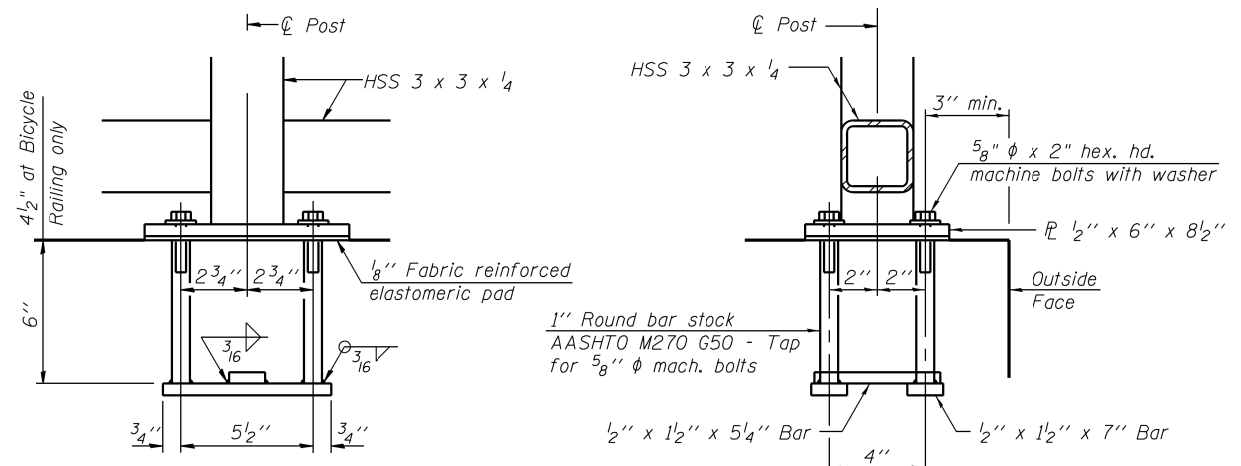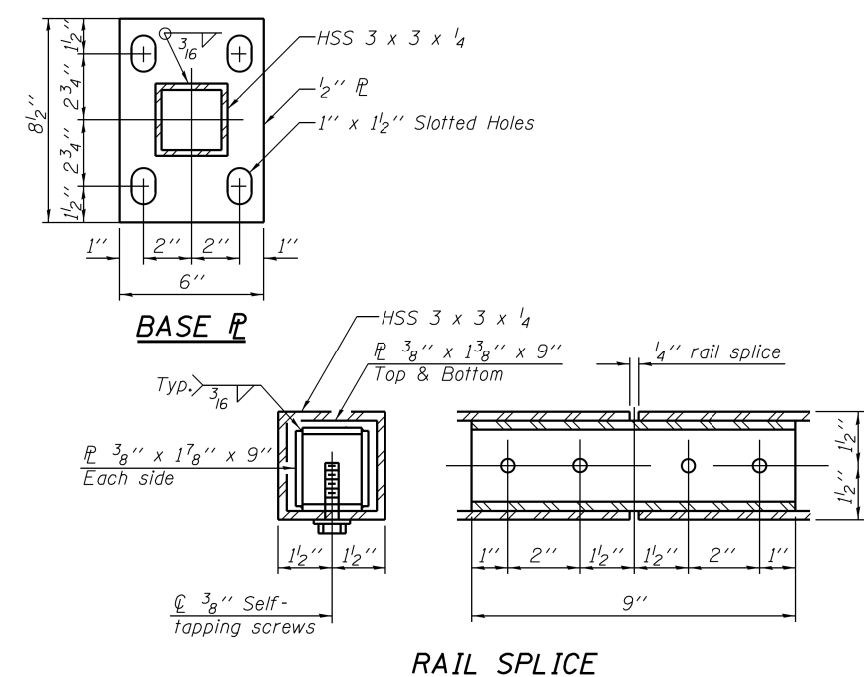

**ANCHOR BOLT DETAILS**

In lieu of the cast-in-place anchor device shown, the Contractor has the option of drilling and setting 5/8" phi anchor rods according to Article 509.06 of the Standard Specifications. Embedment shall be according to the manufacturer's specifications, but no greater than 6".

**BILL OF MATERIAL**

Item	Unit	Quantity
Bicycle Railing	Foot	353

COMPANY NAME: HRGreen  
 PROJECT CONTACT: Sean Connor  
 CLIENT: Illinois Department of Transportation  
 DATE PLOTTED: 6/17/2014 8:25:57 AM  
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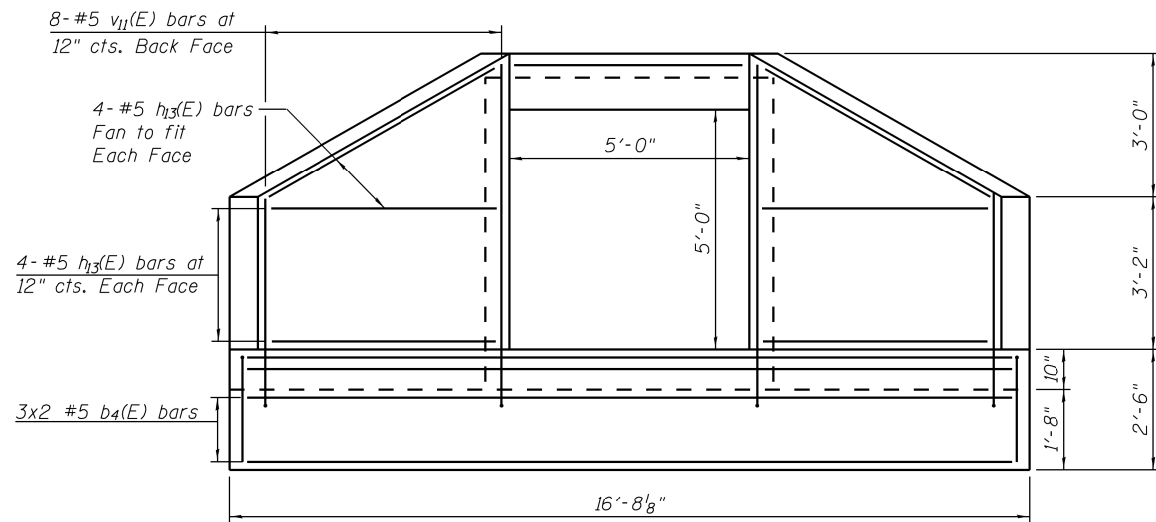
**STATE OF ILLINOIS  
 DEPARTMENT OF TRANSPORTATION**

**BICYCLE RAILING  
 STRUCTURE NO.**


SHEET NO. OF SHEETS

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0104	105N-4	LAKE	113	73
CONTRACT NO. 12377				


ILLINOIS FED. AID PROJECT



**END ELEVATION**

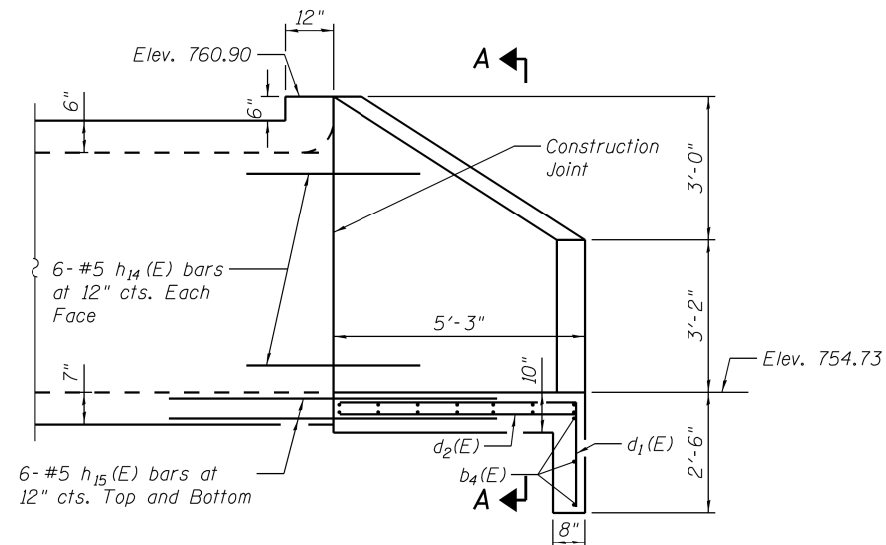

**HALF SIDE ELEVATION**

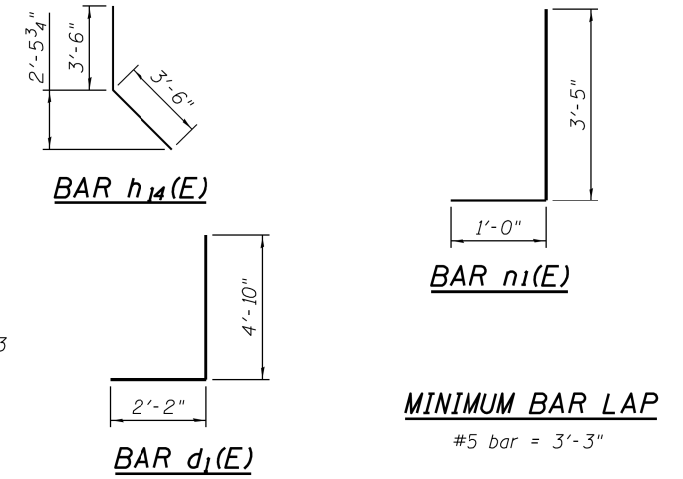


**v11(E) FIELD CUTTING DIAGRAM**


\* Order v11(E) bars full length. Cut as shown and use remainder of bars in opposite wall.

**BILL OF MATERIAL FOR END SECTION**

Bar	No.	Size	Length	Shape
b4(E)	30	#5	9'- 2"	—
d1(E)	16	#4	7'- 0"	└
d2(E)	16	#4	4'- 10"	—
h13(E)	32	#5	7'- 1"	—
h14(E)	24	#5	7'- 0"	—
h15(E)	12	#5	6'- 10"	└
n1(E)	16	#5	4'- 5"	└
v11(E)	8	#5	8'- 6"	—
Box Culvert End Sections, Culvert 1			Each	1
Reinforcement Bars, Epoxy Coated			Pound	1,060

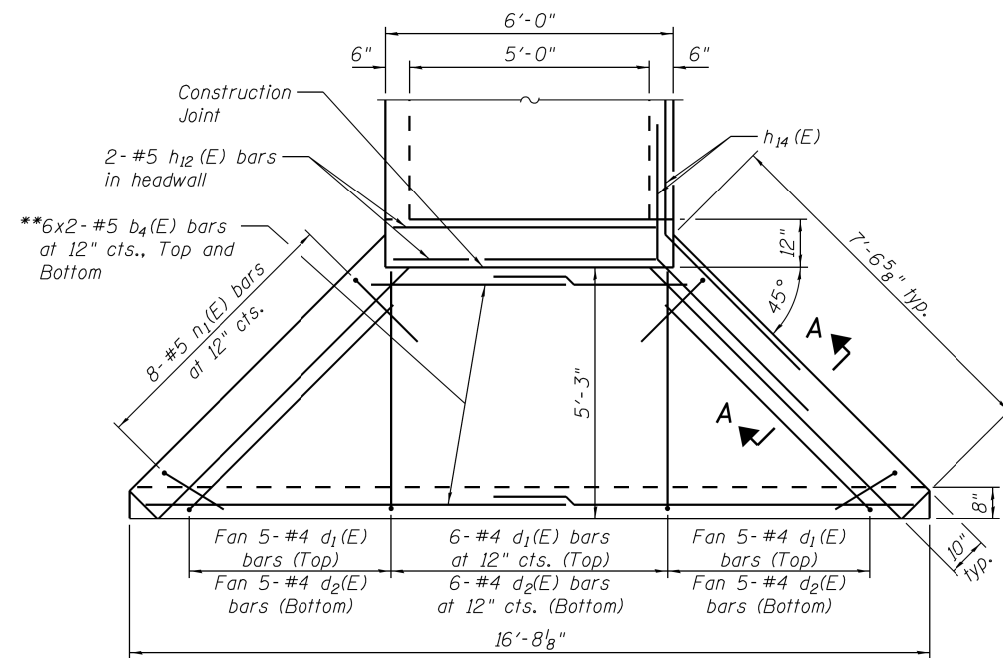

**PLAN**

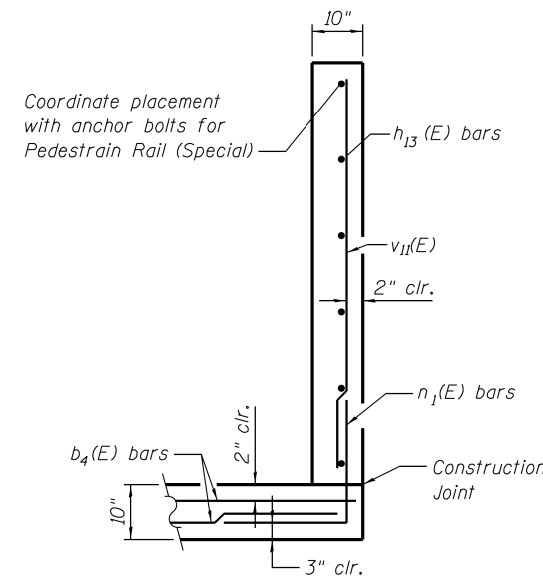

**SECTION A-A**

BOX CULVERT END SECTIONS shall be paid for as noted in Article 540.08, and the Contract Unit Price for BOX CULVERT END SECTIONS shall include all porous granular bedding material, cast in place wingwalls, headwalls, and aprons, cast in place portions between cells, reinforcement, excavation, backfill, and preformed joint filler.

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 PROJECT CONTACT: Sean Connor  
 CLIENT: Illinois Department of Transportation  
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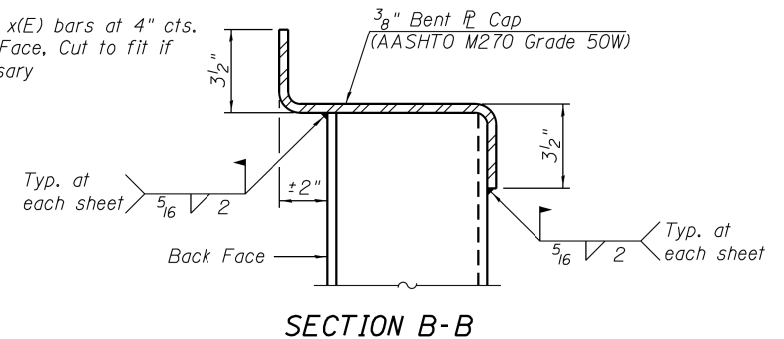
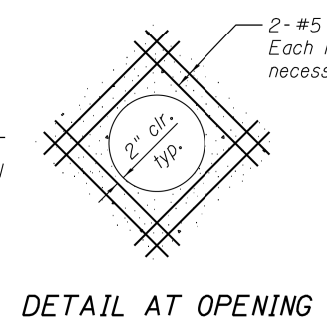
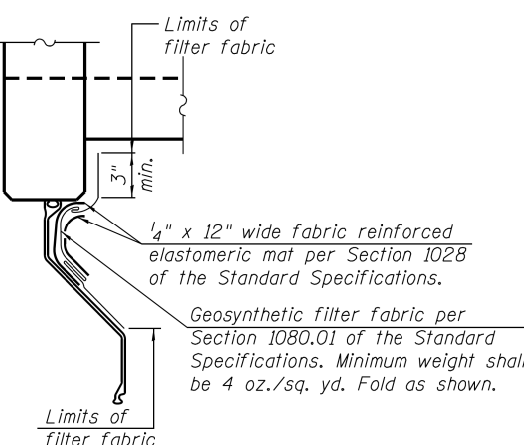
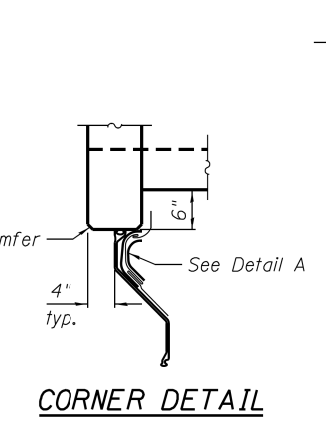
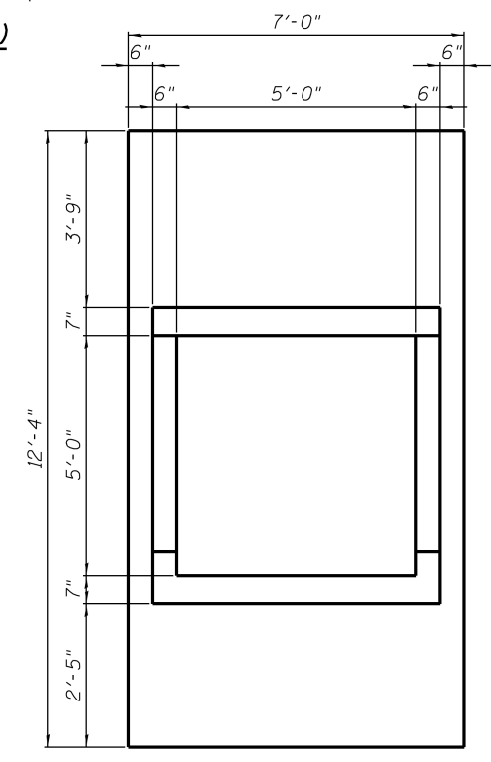
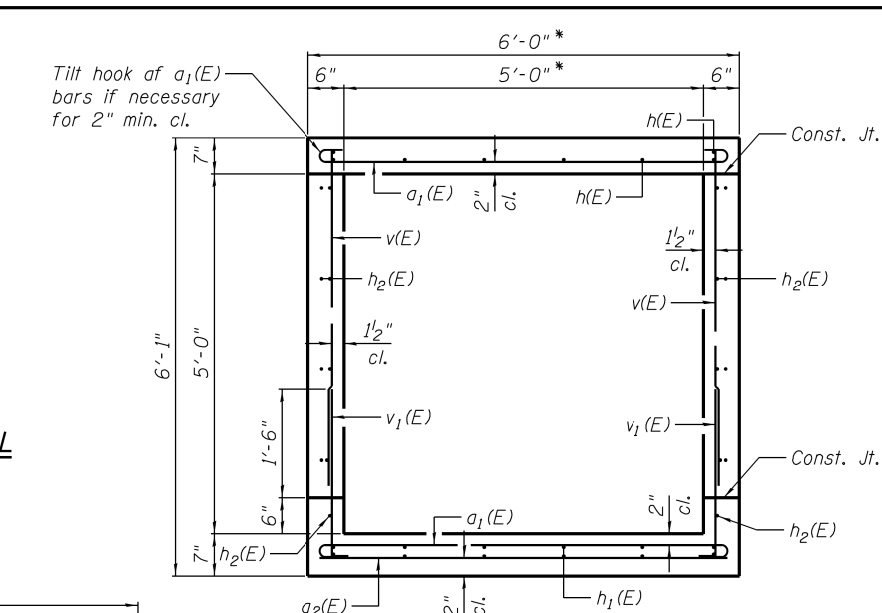
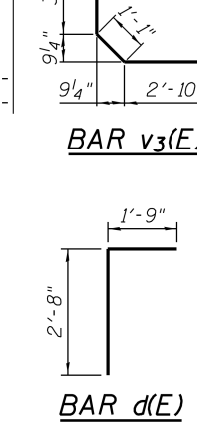
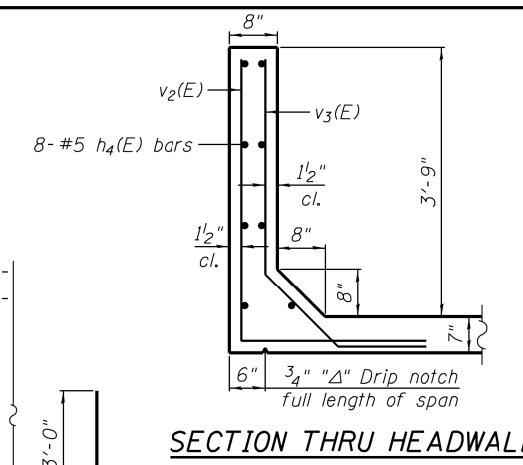
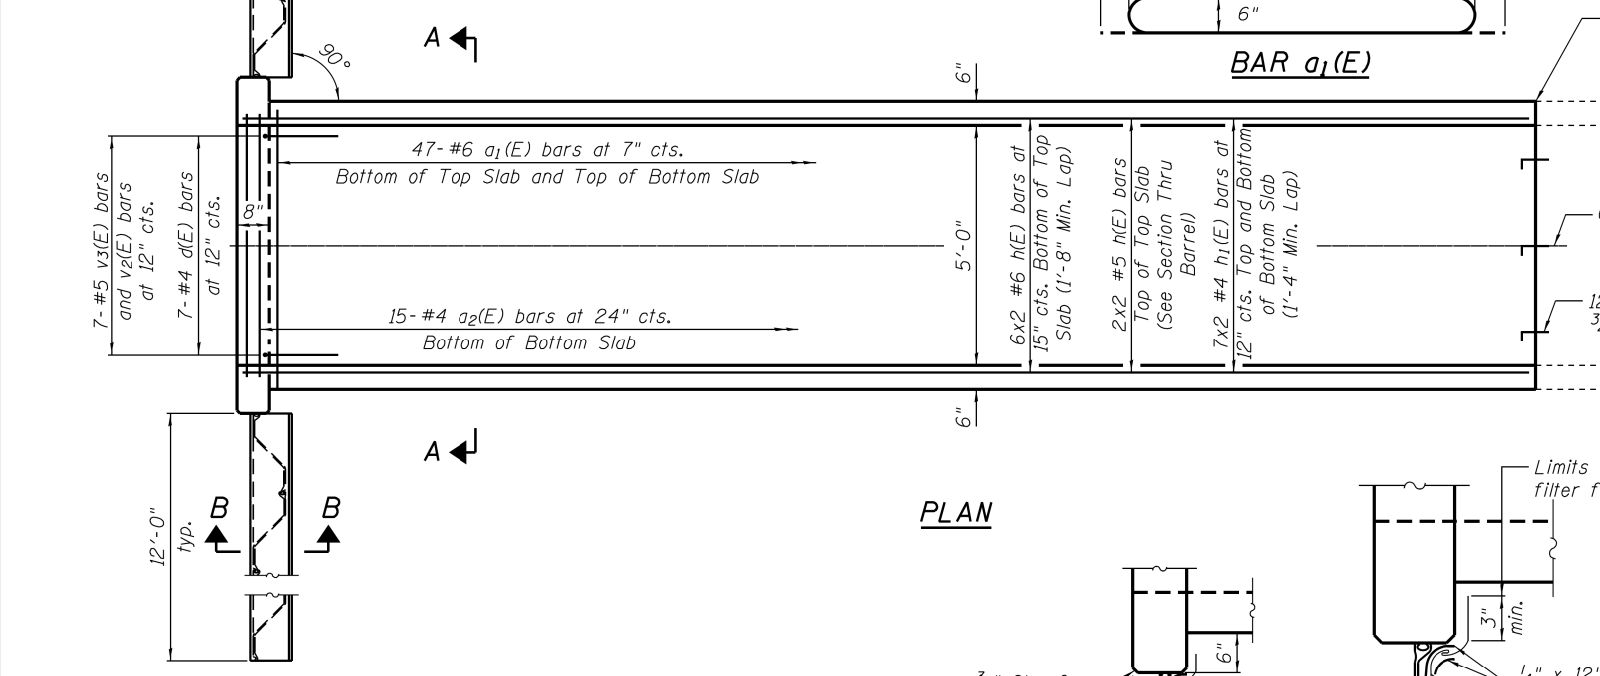
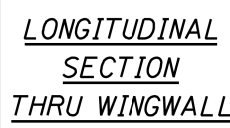
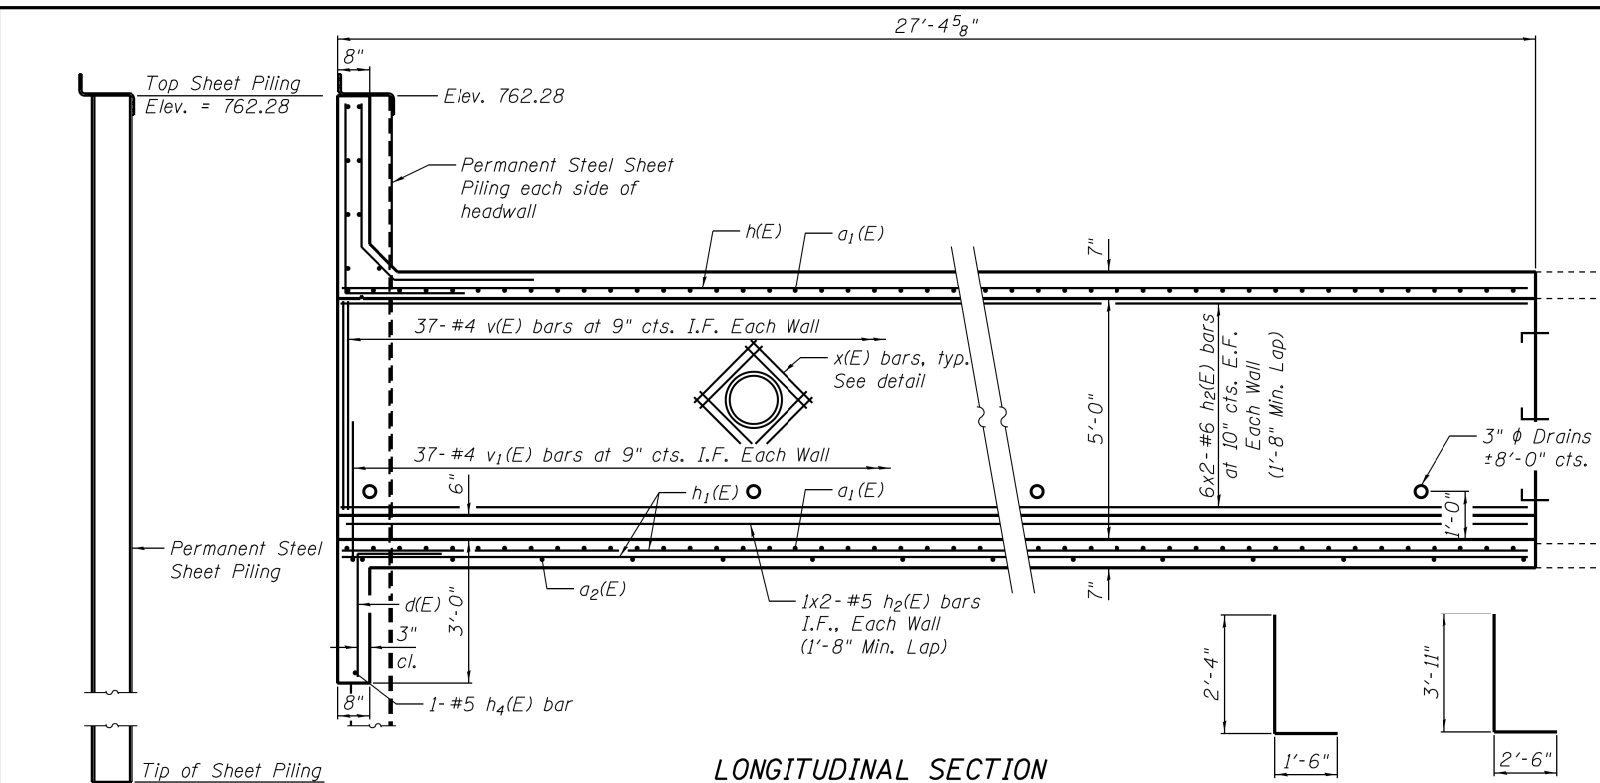
**STATE OF ILLINOIS  
 DEPARTMENT OF TRANSPORTATION**

**END SECTION DETAILS  
 STRUCTURE NO.**

SHEET NO. OF SHEETS

F.A.P. RTE.	SECTION	COUNTY	TOTAL SHEETS	SHEET NO.
0104	105N-4	LAKE	113	74
CONTRACT NO. 12377				

ILLINOIS FED. AID PROJECT



**SECTION THRU BARREL**  
\* Dim. of Existing Culvert opening to be verified in Field (Match Existing)

**BILL OF MATERIAL**

Bar	No.	Size	Length	Shape
a <sub>1</sub> (E)	94	#6	7'-0"	U
a <sub>2</sub> (E)	15	#4	5'-8"	—
d(E)	7	#4	4'-5"	L
h(E)	16	#6	14'-5"	—
h <sub>1</sub> (E)	28	#4	14'-3"	—
h <sub>2</sub> (E)	52	#6	14'-5"	—
h <sub>4</sub> (E)	9	#5	6'-8"	—
v(E)	74	#4	5'-9"	—
v <sub>1</sub> (E)	74	#4	3'-10"	J
v <sub>2</sub> (E)	7	#5	6'-5"	L
v <sub>3</sub> (E)	7	#5	6'-11"	L
x(E)	16	#5	3'-0"	—
Concrete Box Culverts			Cu. Yd.	13.3
Reinforcement Bars, Epoxy Coated			Pound	3,490
Expansion Bolts 3/4 Inch			Each	12

- Notes**
- Bars indicated thus 12 x 4-#5 etc. indicates 12 lines of bars with 4 lengths per line.
  - At the Contractor's option, a longer v<sub>1</sub>(E) bar may be ordered to replace the v(E) bar. No reduction in quantities shall be made for this substitution.
  - The minimum effective section modulus of the permanent steel sheet pile wall shall be 17 in.<sup>3</sup>/ft., and the minimum embedment depth shall be 16'-0".
  - Sheet piling shall not be driven until the concrete strength has attained a minimum flexural strength of 650 psi or a minimum compressive strength of 3500 psi.
  - The cost of furnishing and installing the fabricated steel cap, elastomeric mat, and filter fabric shall be included in the cost of Permanent Steel Sheet Piling.
  - Expansion bolts shall be 3/4" φ hooked bolts. Hooked bolts shall extend a minimum of 9" into new concrete.

COMPANY NAME: HRGreen.com  
PROJECT CONTACT: HRGreen.com  
CLIENT: HRGreen.com  
DATE PLOTTED: 8/16/2016 14:50 PM  
FILE NAME: P145409-shr-Culvert01.dgn  
PLOT DRIVER: JL...pdf\_bw.plt  
PEN TABLE: p10-Hobok.tbl

HRGreen.com  
Professional Design Firm  
#184-001322


USER NAME =	DESIGNED - TOR	REVISED -
	CHECKED - JMW	REVISED -
PLOT SCALE =	DRAWN - WJH	REVISED -
PLOT DATE =	CHECKED - RGD	REVISED -

STATE OF ILLINOIS  
DEPARTMENT OF TRANSPORTATION


CULVERT DETAILS  
STRUCTURE NO.  
SHEET NO. \_\_\_ OF \_\_\_ SHEETS

F.A.P. RTE.	SECTION	COUNTY	TOTAL SHEETS	SHEET NO.
0104	105N-4	LAKE	113	75
CONTRACT NO. 12377				


ILLINOIS FED. AID PROJECT

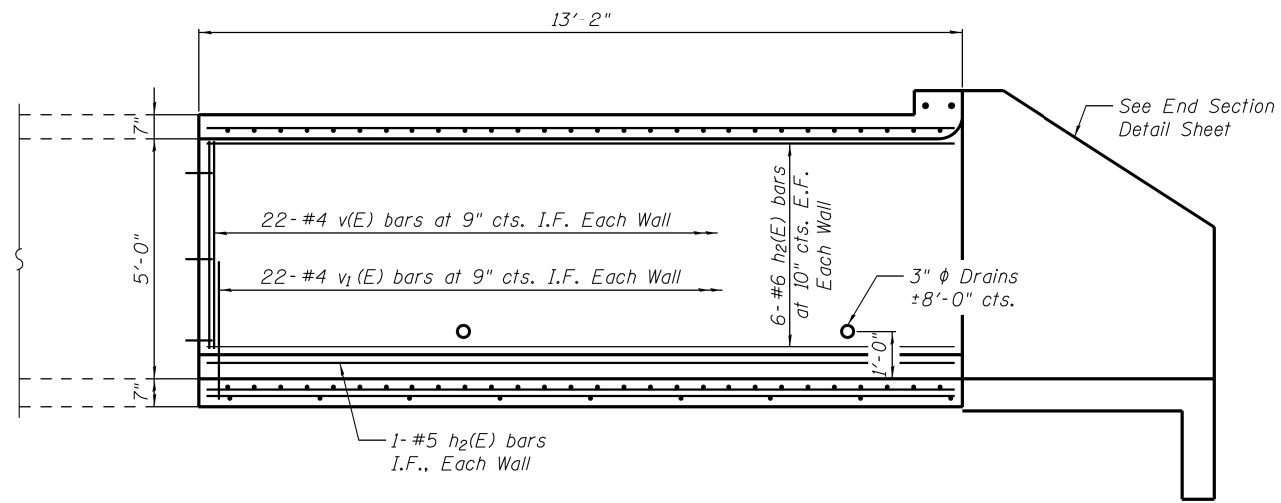

**LONGITUDINAL SECTION**

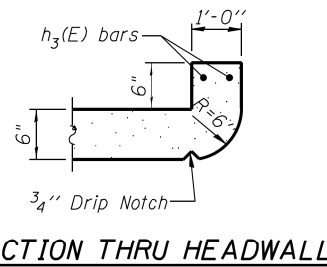


**SECTION THRU HEADWALL**

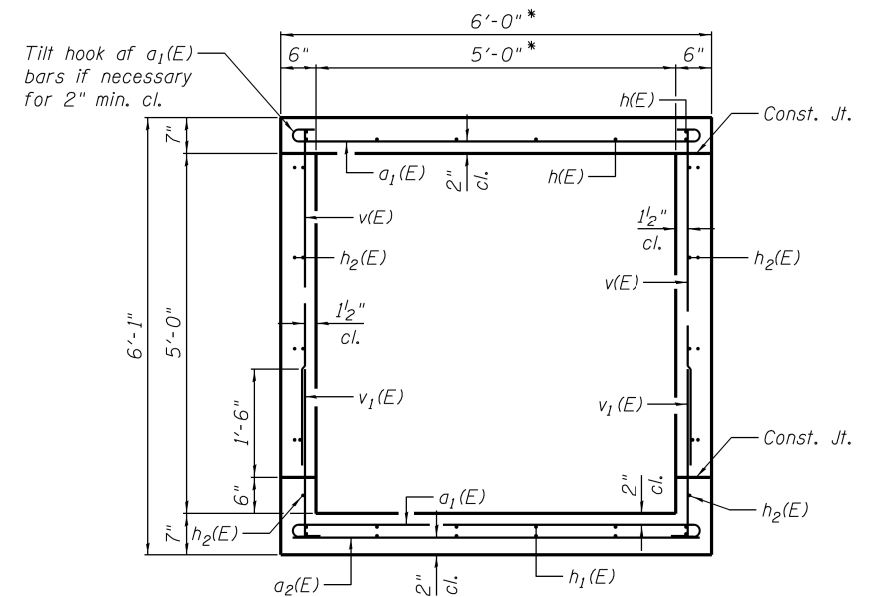


**SECTION THRU BARREL**


\* Dim. of Existing Culvert opening to be verified in Field (Match Existing)

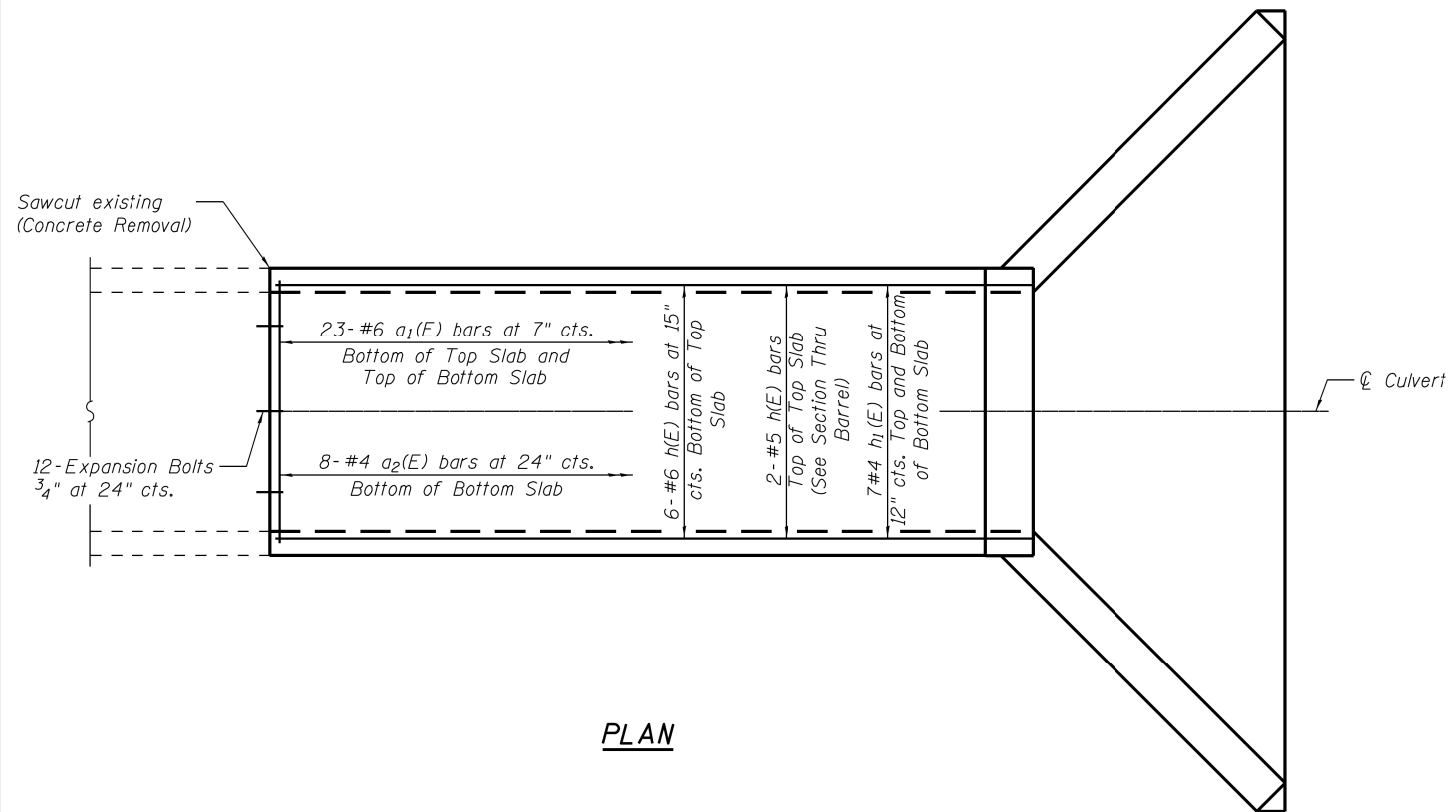

**PLAN**

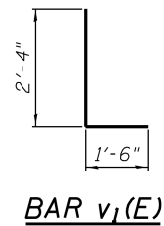

**BAR v1(E)**

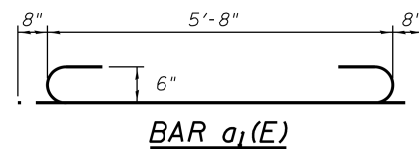

**BAR a1(E)**

**BILL OF MATERIAL**

Bar	No.	Size	Length	Shape
a1(E)	46	#6	7'- 0"	U
a2(E)	8	#4	5'- 8"	—
h(E)	8	#6	12'- 10"	—
h1(E)	14	#4	12'- 10"	—
h2(E)	26	#6	12'- 10"	—
h3(E)	2	#5	5'- 8"	—
v(E)	44	#4	5'- 9"	—
v1(E)	44	#4	3'- 10"	L
Concrete Box Culverts			Cu. Yd.	7.0
Reinforcement Bars, Epoxy Coated			Pound	1,580
Expansion Bolts 3/4 Inch			Each	12

**Notes**

1. Bars indicated thus 12 x 4-#5 etc. indicates 12 lines of bars with 4 lengths per line.
2. At the Contractor's option, a longer v1(E) bar may be ordered to replace the v(E) bar. No reduction in quantities shall be made for this substitution.
3. Expansion bolts shall be 3/4" diameter hooked bolts. Hooked bolts shall extend a minimum of 9" into new concrete.

COMPANY NAME: HRGreen  
 PROJECT CONTACT: Sean Connor  
 CLIENT: Illinois Department of Transportation  
 DATE PLOTTED: 6/17/2014 8:10:01 AM  
 FILE NAME: P145409-shr-Culvert102.dgn  
 PLOT DRIVER: ILDOT-def-no-levels.pltcf  
 PEN TABLE: S1ruct-11x17.tbl




USER NAME =	DESIGNED - TOR	REVISED
	CHECKED - JMW	REVISED
PLOT SCALE =	DRAWN - WJH	REVISED
PLOT DATE =	CHECKED - RGD	REVISED

**STATE OF ILLINOIS  
 DEPARTMENT OF TRANSPORTATION**

**CULVERT DETAILS  
 STRUCTURE NO.**

SHEET NO. OF SHEETS

F.A.P. RTE.	SECTION	COUNTY	TOTAL SHEETS	SHEET NO.
0104	105N-4	LAKE	113	76
CONTRACT NO. 12377			ILLINOIS FED. AID PROJECT	

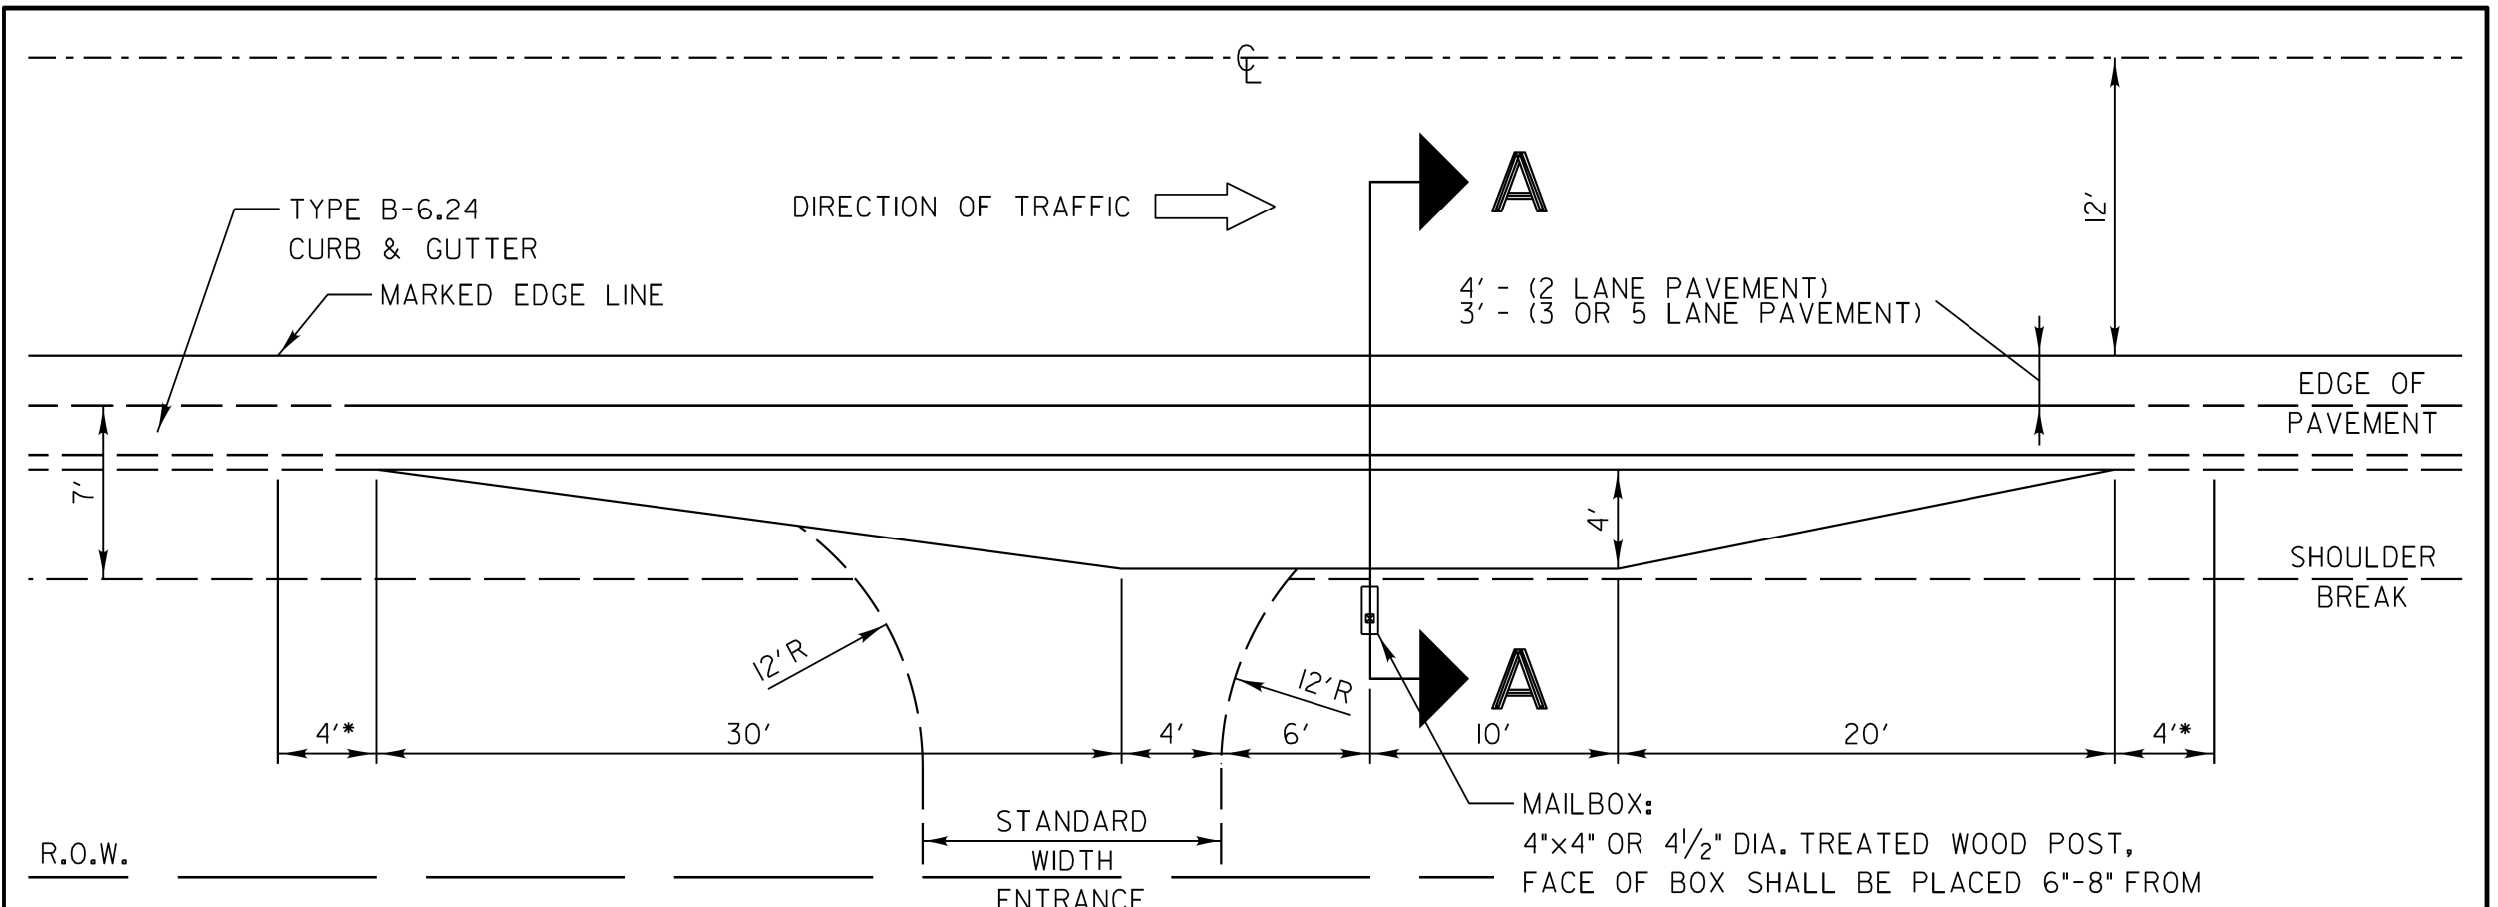


\*CURB TRANSITION EACH END TO BE PAID FOR AT THE CONTRACT UNIT PRICE FOR COMBINATION CONCRETE CURB AND GUTTER, TYPE B-6.24.

MAILBOX:  
4"x4" OR 4 1/2" DIA. TREATED WOOD POST,  
FACE OF BOX SHALL BE PLACED 6"-8" FROM  
THE EDGE OF TURNOUT SURFACE. (SEE A-A)

**DESIGN NOTES:**

1. The Resident Engineer shall contact the local postmaster prior to installing the new mailbox posts for the local mounting height of the mailbox. The standard mounting height is 3 1/2'; however, local post-masters may vary this height.
2. The standard mailbox post is a 4"x4" or a 4 1/2" dia. treated wood post. The standard bury length of the post is 2'. Do not shorten or exceed this bury length.
3. Depending on the location of the shoulder break with respect to the edge of the mailbox turnout the overall post length may vary from 5' 8" to 6' 4" to maintain the 2' bury length and the 3 1/2' mounting height.

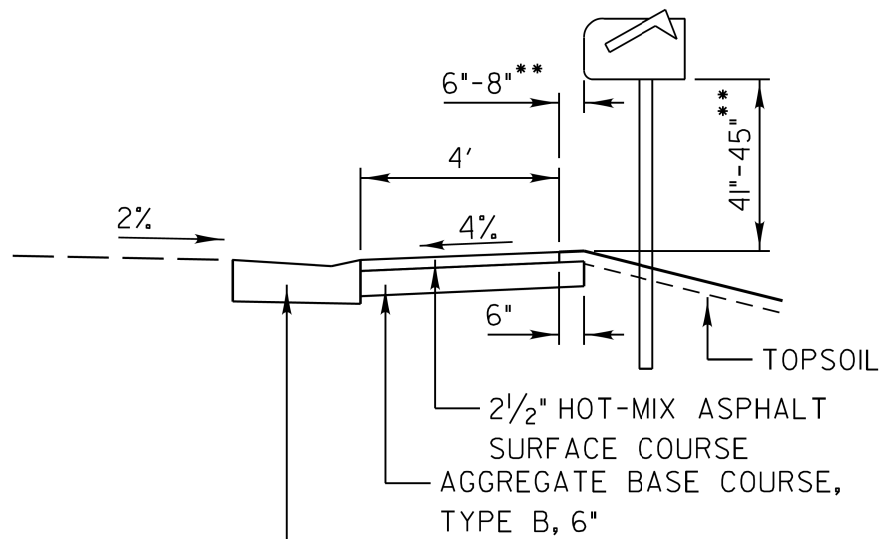

SECTION A-A  
SCALE: 1" = 5'  
TYPE B-6.24 DEPRESSED -  
70 LIN FT

\*\* USPS RESIDENTIAL MAILBOX STANDARD


REVISIONS	DATE
6'-8" BOX OFFSET ADDED	12/22/11
Revised Type A to Type B Aggregate	12/20/12
Revised Curb Transition	1/7/15
Increased Paved Shldr to 3' for 3&5 Lane Pvmt	8/3/2015



APPROVED BY: M. G. ZEMAITIS  
DATE: APRIL 1, 2007


**MAILBOX TURNOUT  
ALONG CURBED ROADS**

LC4121

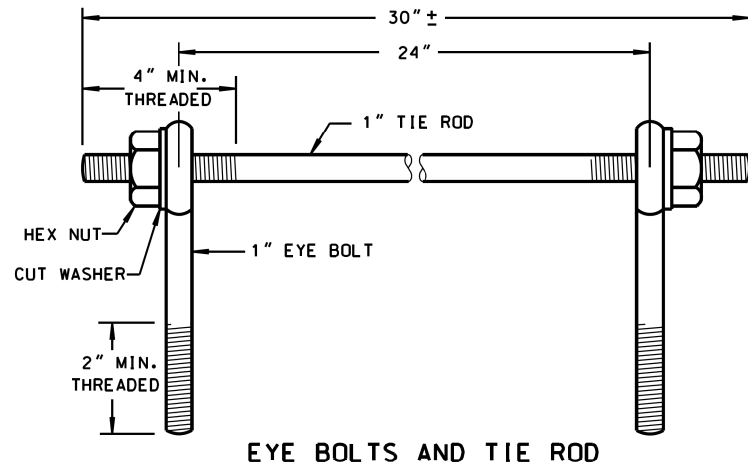

EYE BOLTS AND TIE ROD

EYE BOLT AND TIE ROD ASSEMBLY (ALTERNATE NO. 1)

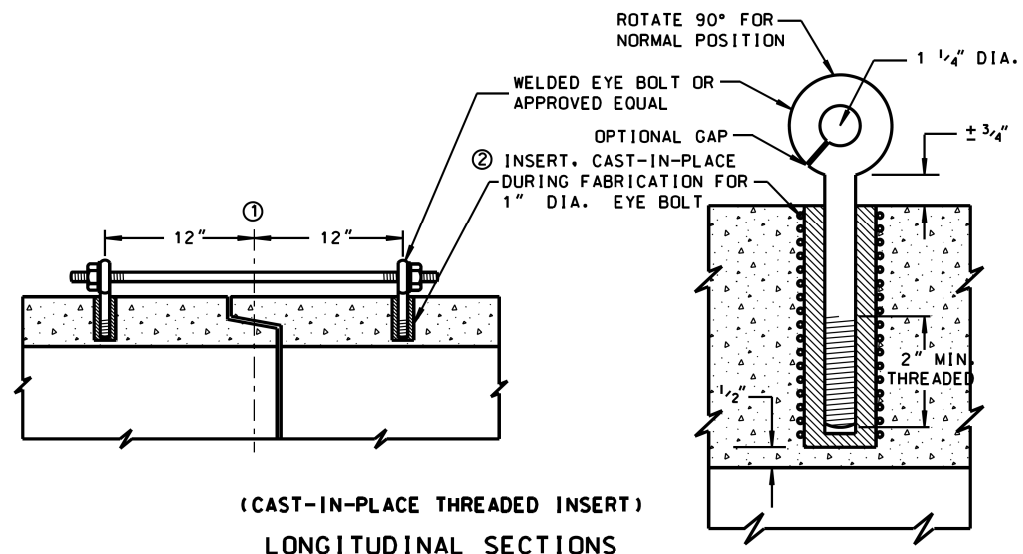

(CAST-IN-PLACE THREADED INSERT)  
LONGITUDINAL SECTIONS

**GENERAL NOTES**

DETAILS OF CONSTRUCTION, MATERIALS AND WORKMANSHIP NOT SHOWN ON THIS DRAWING SHALL CONFORM TO THE PERTINENT REQUIREMENTS OF THE STANDARD SPECIFICATIONS AND APPLICABLE SPECIAL PROVISIONS. JOINT TIES AND HARDWARE SHALL BE GALVANIZED STEEL.


CONCRETE CULVERT PIPE AND SEWER PIPE SHALL BE TIED TOGETHER IN THE MANNER ILLUSTRATED BY THIS DETAIL AT THE LAST THREE JOINTS BEFORE A FLARED END SECTION

THE CONTRACTOR MAY USE EITHER ALTERNATE 1, 2 OR 3 FOR CONCRETE PIPE.


UNLESS OTHERWISE STATED IN THE CONTRACT THE MATERIALS, FABRICATION AND WORK NECESSARY TO TIE CULVERT PIPE AS INDICATED ON THE PLANS AND BY THIS DETAIL WILL BE CONSIDERED INCLUDED IN THE COST OF PIPE CULVERTS OR STORM SEWERS.

DETAILED DRAWINGS FOR PROPOSED ALTERNATE DESIGNS FOR GALVANIZED STEEL JOINT TIES SHALL BE SUBMITTED TO THE ENGINEER FOR APPROVAL.

- ①  $\frac{1}{2}$  OF TONGUE AND GROOVE OR BELL AND SPIGOT JOINTS.
- ② THE INSIDE OF THE THREADED INSERTS SHALL BE CLEAN TO ALLOW THE INSERTION OF THREADED EYE BOLTS.
- ③ HOLES SHALL BE CAST-IN-PLACE OR DRILLED 12" FROM  $\frac{1}{2}$  OF TONGUE AND GROOVE.
- ④ BOLT PROJECTION INSIDE OF PIPE SHALL NOT EXCEED 2".
- ⑤ OPENING TO BE ROD DIAMETER + 1 INCH.
- ⑥ LENGTH ADEQUATE TO EXTEND TO WITHIN 1/2 INCH OF THE INNER SURFACE OF THE PIPE.

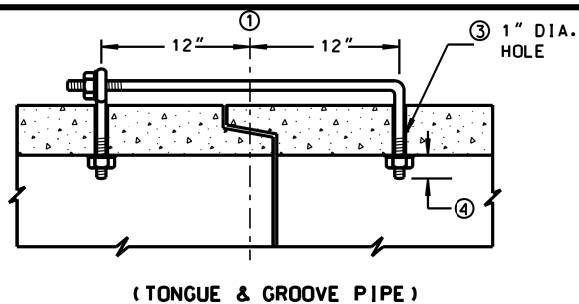


(TONGUE & GROOVE PIPE)

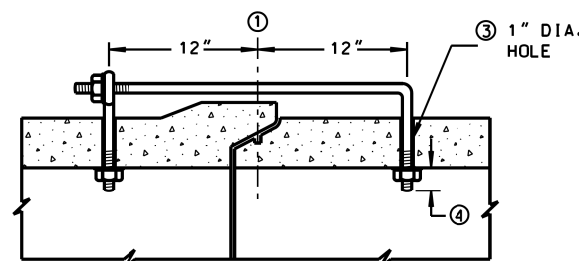

(MODIFIED BELL PIPE)  
LONGITUDINAL SECTION


**EYE BOLT DIMENSION TABLE**

PIPE SIZE	L = LENGTH	
	TONGUE & GROOVE PIPE	MODIFIED BELL PIPE
18" TO 24"	4 1/2"	6 1/4"
30"	5"	7"
36"	5 1/2"	7"
42"	6"	
48"	6 1/2"	
60"	7 1/2"	
66"	8"	

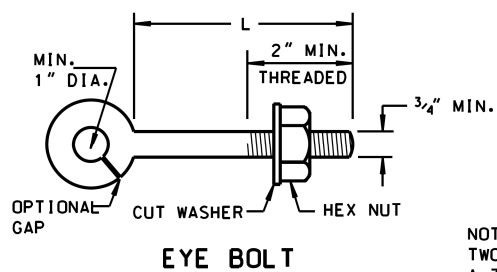

EYE BOLT


NOTE:  
TWO EYE BOLTS MAY BE USED WITH A 30" LONG THREADED ROD IN LIEU OF THE 90° BENT TIE ROD.

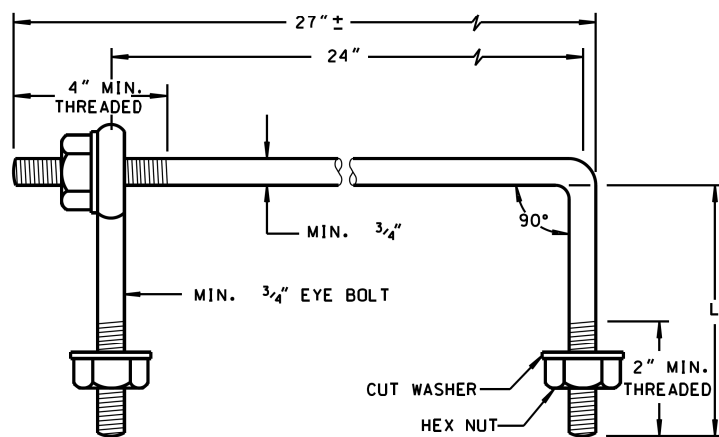


EYE BOLT AND TIE ROD

(JOINT TIES FOR 18" TO 66" DIA. CONCRETE PIPE)

EYE BOLT AND TIE ROD ASSEMBLY (ALTERNATE NO. 2)

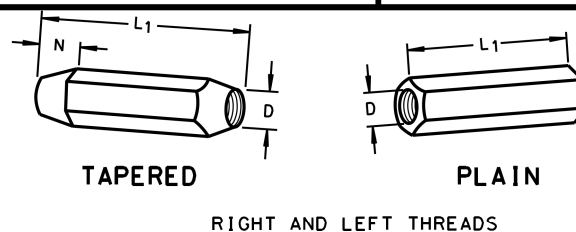

**SLEEVE NUTS**

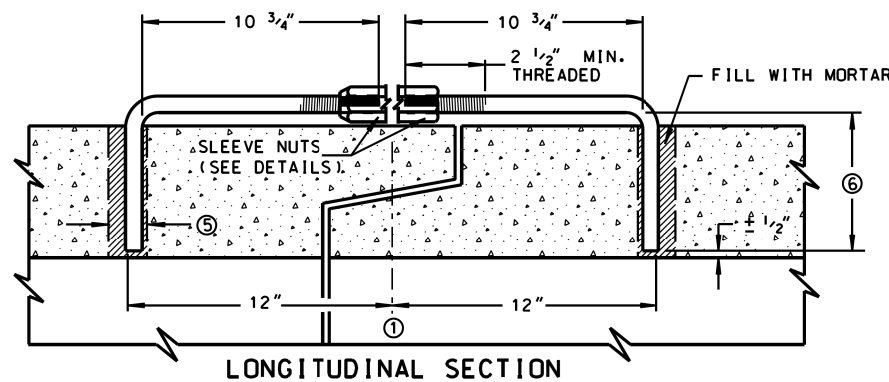

LONGITUDINAL SECTION

(JOINT TIES FOR 12" TO 108" DIA. CONCRETE PIPE)


ADJUSTABLE TIE ROD (ALTERNATE NO. 3)

**ADJUSTABLE TIE ROD TABLE**

PIPE DIAMETER	TIE ROD DIAMETER	D	L1	N
12-60	5/8	5/8	5	1/2
66-84	3/4	3/4	5	1/2
90-108	1	1	7	1 7/16


DIMENSIONS SHOWN ARE IN INCHES

NOT TO SCALE

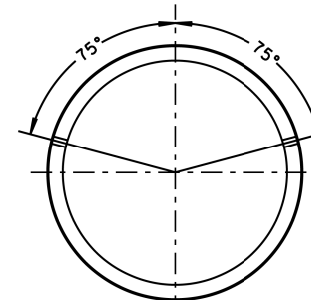

PLACEMENT OF (2) CAST-IN-PLACE INSERTS OR HOLES DURING FABRICATION FOR PIPE SECTIONS REQUIRING TIE RODS

TRANSVERSE SECTION

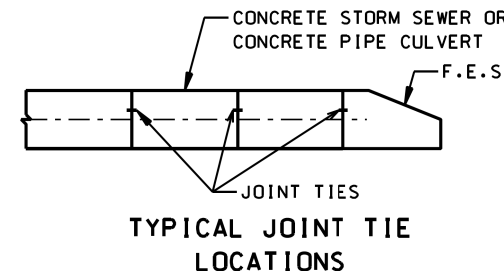

TYPICAL JOINT TIE LOCATIONS

REVISIONS	DATE
ADDED JOINT TIE MAT'L	7/8/11



APPROVED BY: M. ZEMAITIS  
DATE: 04/01/11

**JOINT TIES FOR CONCRETE PIPE**

LC5402

NO.	REVISIONS / REMARKS	DATE	BY	SURVEYOR







**PROJECT NAME**

LAKE COUNTY STANDARDS & DETAILS

ROUTE	SECTION	SECTION NUMBER	SHEET	SHEETS
CH		- - -	XX	XX




TYPICAL MINI-SKIP PAVEMENT MARKINGS

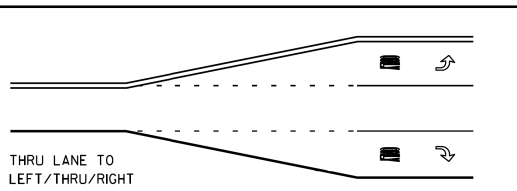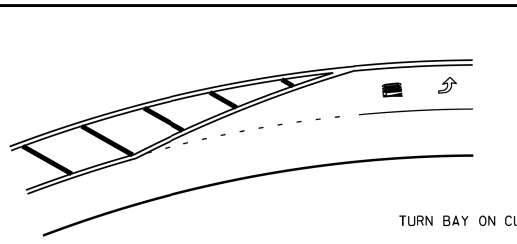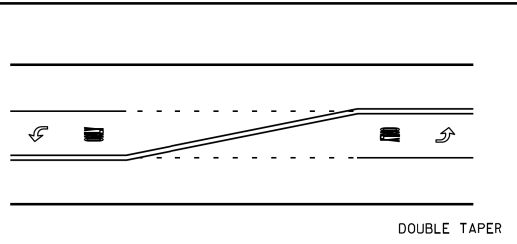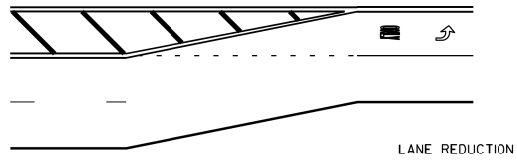


MINI-SKIPS ARE 2 FEET WHITE LINE WITH 6 FEET SPACING, THE MINI-SKIP IS THE SAME WIDTH AS THE PAVEMENT MARKING LINE, IT EXTENDS.

TYPICAL PAVEMENT MARKINGS

EDGE LINE RADII AT SIDE STREETS

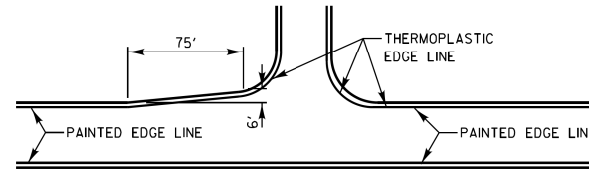
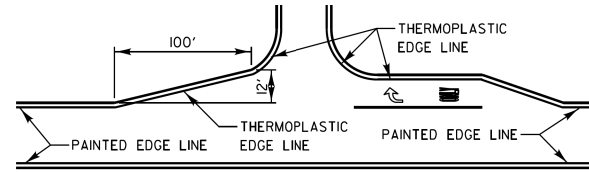
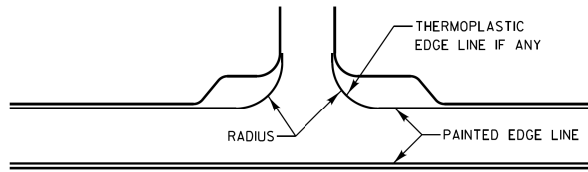


LANE REDUCTION ARROW PLACEMENT

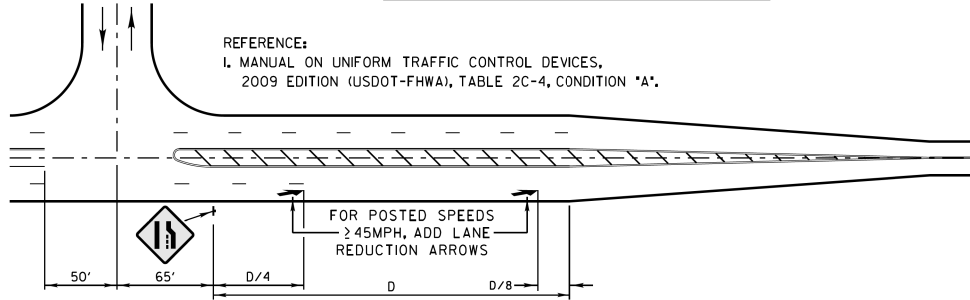

DESIGN SPEED MPH	D (FEET)
<45	N/A
45	775' [1]
50	885' [1]
55	990' [1]

TYPICAL TURN BAY PAVEMENT MARKINGS

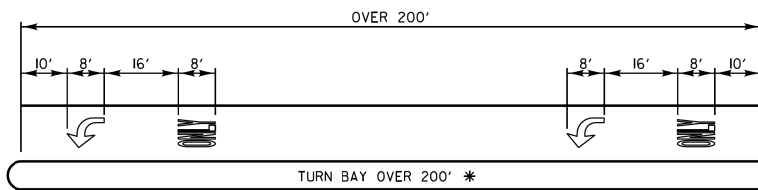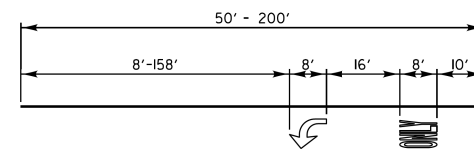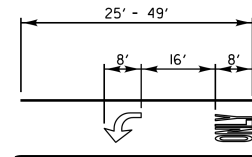


\* AT INTERSECTIONS WITH VIDEO DETECTION, THE ARROW AND ONLY PAVEMENT MARKINGS SHALL BE A MINIMUM OF 30' BEHIND THE STOP BAR.

AREA = 15.6 SQ. FT.

AREA = 20.8 SQ. FT.


FULL SIZE LETTERS (8") AND ARROWS SHALL BE USED. TURN LANES IN EXCESS OF 400' IN LENGTH MAY HAVE AN ADDITIONAL SET OF ARROW W/ "ONLY" INSTALLED MIDWAY BETWEEN THE OTHER TWO SETS OF ARROW W/ "ONLY".

TWO LANE ROAD

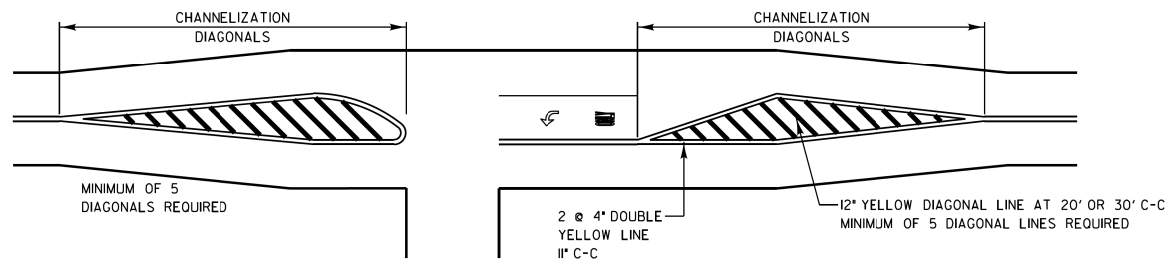


TYPICAL DIAGONAL SPACING


SPEED LIMIT RANGE	DIAGONAL SPACING	
	CONTINUOUS	INTERSECTION CHANNELIZATION
30-45 MPH	75 FT.	20 FT.
OVER 45 MPH	150 FT.	30 FT.

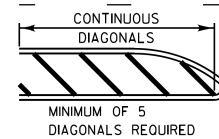


3 OR 5 LANE ROAD

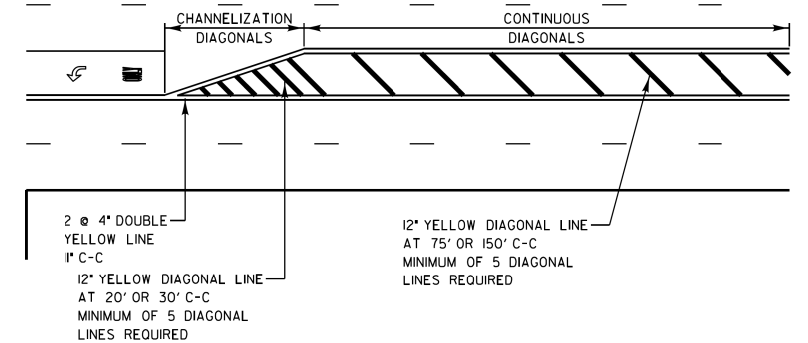

TWO-WAY LEFT TO LEFT TURN BAY

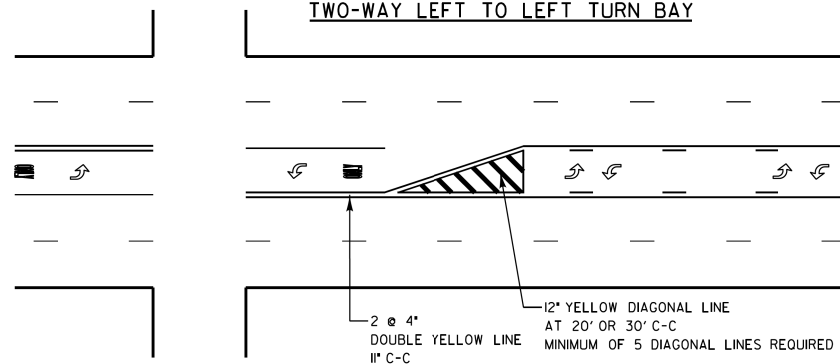

DUAL LEFT TURN ARROWS

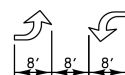

31.2 SQ. FT. MINIMUM OF 2 SETS REQUIRED

A MINIMUM OF TWO PAIRS OF DUAL LEFT TURN ARROWS SHALL BE USED. THE DUAL LEFT TURN ARROWS SHALL BE WHITE IN COLOR. THE INTERVAL BETWEEN SETS OF DUAL LEFT TURN ARROWS SHOULD BE 200' AND 300'.

REVISIONS	DATE
SEPARATED RAILROAD SHEET	06/02/08
ADDED LANE REDUCTION ARROWS	07/1/12
RAISED TO RECESSED MARKERS	12/2/13
REMOVE STATION NUMBERS	5/30/14



APPROVED BY: A. KHAWAJA  
DATE: APRIL 1, 2007

TYPICAL PAVEMENT MARKINGS FOR COUNTY HIGHWAYS

SHEET 1 OF 2

LC7800

REVISIONS / REMARKS				
NO.	DESCRIPTION	DATE	BY	SURVEYOR




PROJECT NAME

LAKE COUNTY STANDARDS & DETAILS

ROUTE	SECTION	SECTION NUMBER	SHEET	SHEETS
CHXX	XXX	XX-XXXXX-XX-XX	XXX	XXX

# TYPICAL PAVEMENT MARKINGS AND RECESSED PAVEMENT MARKERS

## THRU LANE TO TURN LANE CONVERSION

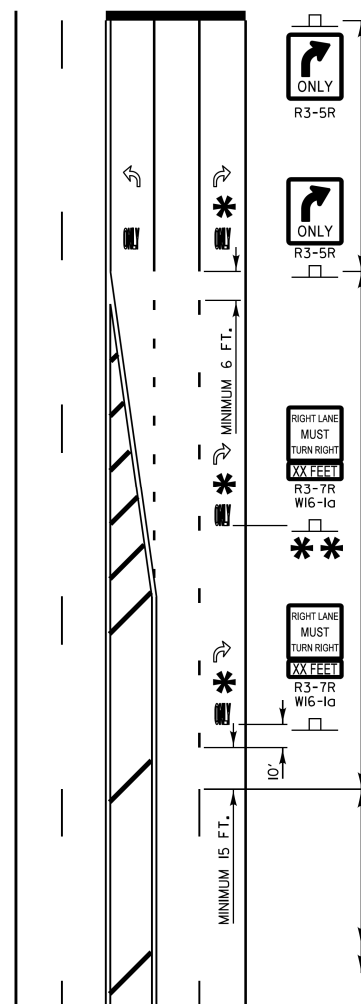

TURN LANE  
6' WHITE LINE  
(ADDITIONAL PAVEMENT MARKINGS AS SHOWN  
ON SHEET ONE OF THE L.C.D.O.T TYPICAL  
PAVEMENT MARKINGS DETAIL SHEETS)

TRANSITION ZONE  
6' WHITE 3'/12' SKIP DASH  
LANE LINE

THRU LANE  
4' WHITE 10'/30' SKIP DASH  
LANE LINE

### MINIMUM TRANSITION ZONE LENGTH


POSTED SPEED	LENGTH
25 M.P.H.	255 FT
30 M.P.H.	330 FT
35 M.P.H.	405 FT
40 M.P.H.	480 FT
45 M.P.H.	555 FT
50 M.P.H.	630 FT
55 M.P.H.	705 FT

### \* LOCATION OF PAV'T MARKINGS

(MEASURED FROM BEGINNING OF TRANSITION ZONE)

POSTED SPEED	LOCATION OF PAV'T MARKINGS
25 M.P.H.	10 FT, 260 FT
30 M.P.H.	10 FT, 170 FT, 340 FT
35 M.P.H.	10 FT, 210 FT, 410 FT
40 M.P.H.	10 FT, 170 FT, 330 FT, 490 FT
45 M.P.H.	10 FT, 190 FT, 370 FT, 560 FT
50 M.P.H.	10 FT, 170 FT, 330 FT, 490 FT, 640 FT
55 M.P.H.	10 FT, 180 FT, 350 FT, 520 FT, 710 FT

\*\* FOR POSTED SPEEDS 40 M.P.H. OR GREATER  
A SECOND R3-7/W16-1a SIGN INSTALLATION  
SHALL BE LOCATED HALFWAY BETWEEN THE  
BEGINNING OF THE TRANSITION ZONE AND THE  
BEGINNING OF THE TURN LANE


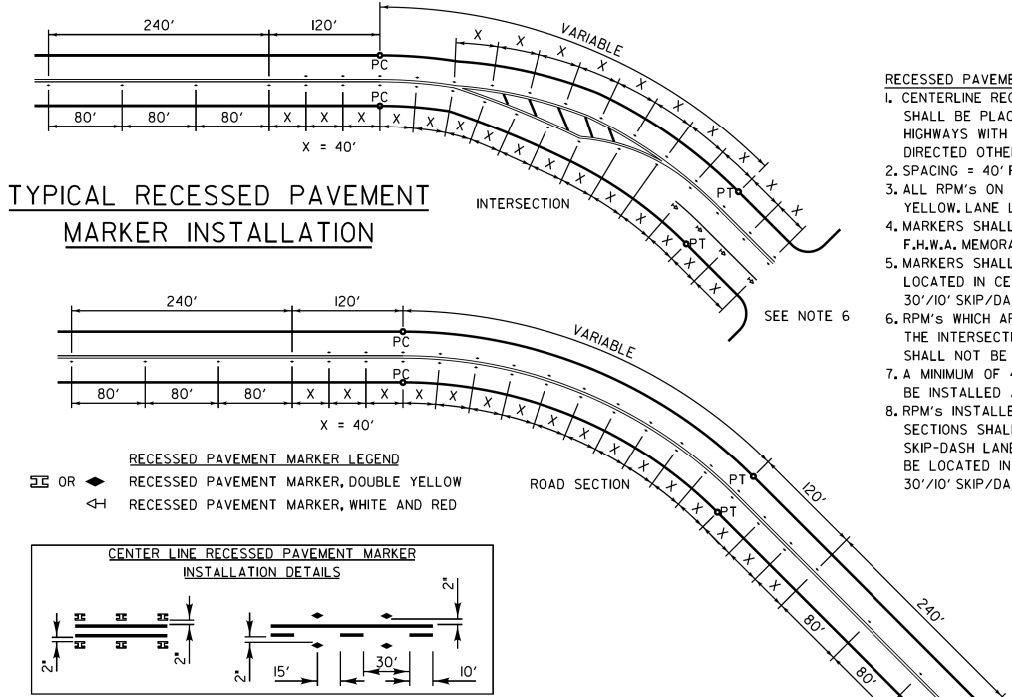


### TYPICAL RECESSED PAVEMENT MARKER INSTALLATION

RECESSED PAVEMENT MARKER LEGEND  


 RECESSED PAVEMENT MARKER, DOUBLE YELLOW  

 RECESSED PAVEMENT MARKER, WHITE AND RED

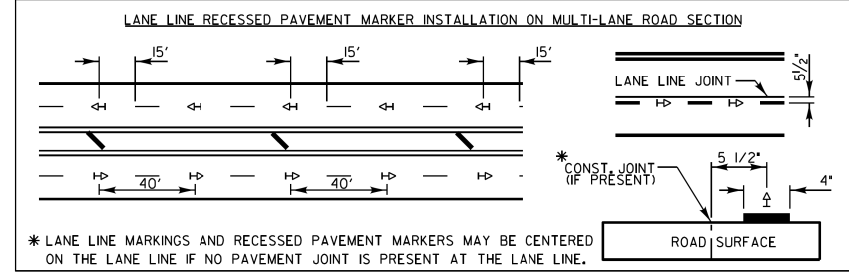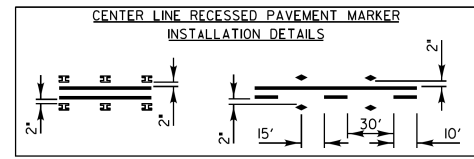


- #### RECESSED PAVEMENT MARKER NOTES:
- CENTERLINE RECESSED PAVEMENT MARKERS (RPM'S) SHALL BE PLACED ON ALL TWO AND THREE LANE HIGHWAYS WITH CURVES OVER 3 1/2 DEGREES, UNLESS DIRECTED OTHERWISE BY THE ENGINEER.
  - SPACING = 40' FOR CENTERLINE MARKERS.
  - ALL RPM'S ON CENTERLINE ARE 2-WAY YELLOW. LANE LINE MARKERS ARE WHITE/RED.
  - MARKERS SHALL BE INSTALLED ACCORDING TO F.H.W.A. MEMORANDUM H10-21.
  - MARKERS SHALL BE FIELD ADJUSTED TO BE LOCATED IN CENTER OF THE 30' GAP OF A 30'/10' SKIP-DASH CENTERLINE.
  - RPM'S WHICH ARE TO BE LOCATED WITHIN THE INTERSECTION OF A CROSS STREET, SHALL NOT BE INSTALLED.
  - A MINIMUM OF 4 WHITE/RED MARKERS SHALL BE INSTALLED ALONG THE TURN LANE LINE.
  - RPM'S INSTALLED ON MULTI-LANE ROAD SECTIONS SHALL BE INSTALLED ON THE WHITE SKIP-DASH LANE LINE ONLY. THESE RPM'S SHALL BE LOCATED IN CENTER OF THE 30' GAP OF A 30'/10' SKIP-DASH LANE LINE.

### CROSSWALKS

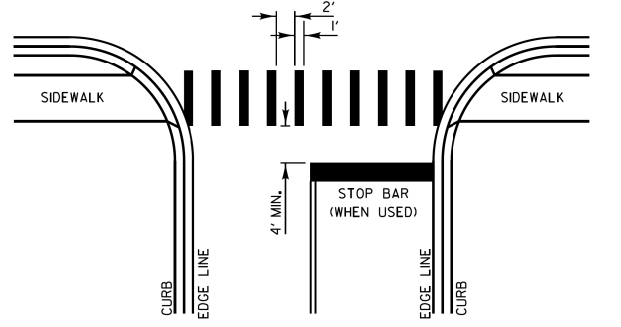



- #### CROSSWALK NOTES:
- WIDTH OF THE CROSSWALK IS GENERALLY 6' EXCEPT AT SCHOOL CROSSINGS AND BICYCLE CROSSINGS, WHICH CAN BE 8'.
  - THE STOP BAR SHOULD BE INSTALLED A MINIMUM OF 4' IN ADVANCE OF THE CROSSWALK.

### CURB MARKING

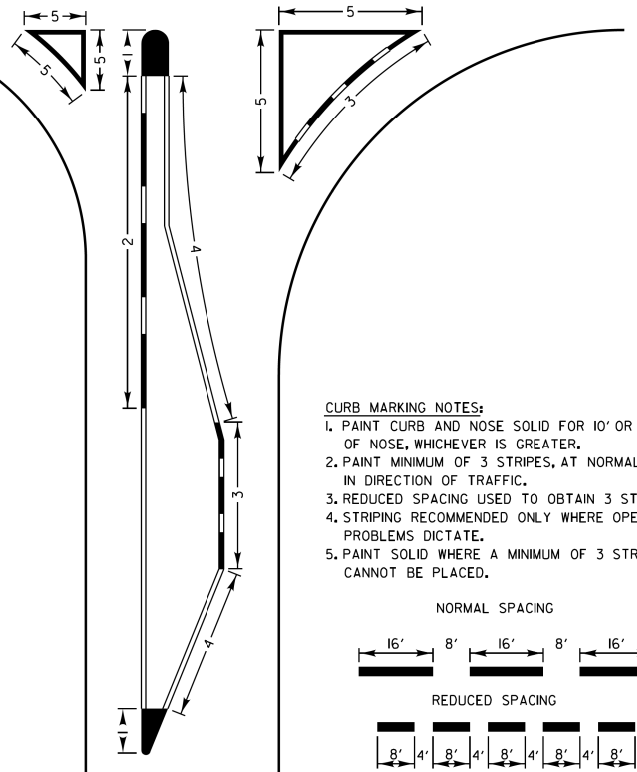

- #### CURB MARKING NOTES:
- PAINT CURB AND NOSE SOLID FOR 10' OR RADIUS OF NOSE, WHICHEVER IS GREATER.
  - PAINT MINIMUM OF 3 STRIPES, AT NORMAL SPACING, IN DIRECTION OF TRAFFIC.
  - REDUCED SPACING USED TO OBTAIN 3 STRIPES MINIMUM.
  - STRIPING RECOMMENDED ONLY WHERE OPERATIONAL PROBLEMS DICTATE.
  - PAINT SOLID WHERE A MINIMUM OF 3 STRIPES CANNOT BE PLACED.

### PAVEMENT CROSS SECTION SHOWING TYPICAL PAVEMENT MARKINGS (2-LANE ROADWAY)

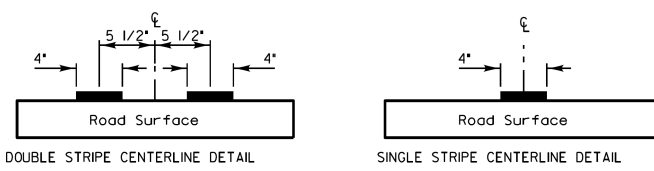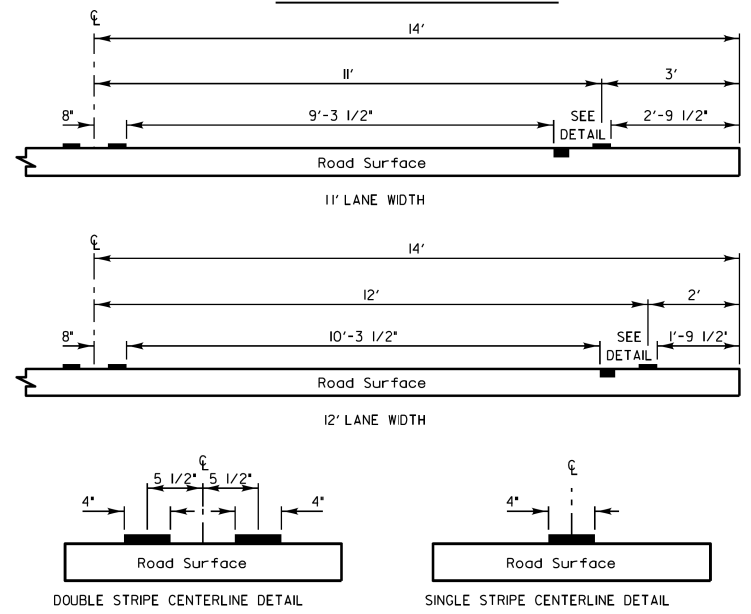

NOTE:  
CENTERLINE MARKINGS ARE 4" LINES AT 11" CENTERS.

PAVEMENT MARKING GUIDELINES				
TYPE OF MARKING	WIDTH OF LINE	PATTERN	COLOR	SPACING / REMARKS
CENTERLINE OF 2 LANE PAVEMENT	4 IN.	SKIP-DASH	YELLOW	10 FT. LINE WITH 30 FT. SPACE
NO PASSING ZONE LINES: FOR ONE DIRECTION FOR BOTH DIRECTIONS	4 IN. 2 @ 4 IN.	SOLID SOLID	YELLOW YELLOW	5 1/2 IN. C-C FROM SKIP-DASH CENTERLINE 11 IN. C-C (OMIT SKIP-DASH CENTERLINE BETWEEN)
CENTERLINE ON MULTI-LANE UNDIVIDED LANE LINES	2 @ 4 IN. 4 IN.	SOLID SKIP-DASH	YELLOW WHITE	11 IN. C-C 10 FT. LINE WITH 30 FT. SPACE
DOTTED LINES (EXTENSIONS OF CENTER, LANE OR TURN LANE MARKINGS)	SAME AS LINE BEING EXTENDED	SKIP-DASH	SAME AS LINE BEING EXTENDED	2 FT. LINE WITH 6 FT. SPACE
EDGE LINES	5 IN. WHITE 4 IN. YELLOW	SOLID	WHITE - RIGHT YELLOW - LEFT	OUTLINE RAISED MEDIANS IN YELLOW
TURN LANE MARKINGS	6 IN. LINE FULL SIZE LETTERS AND SYMBOLS (8 FT.)	SOLID	WHITE	TURN ARROW 15.6 SQ. FT. STRAIGHT ARROW 11.5 SQ. FT. ONLY 20.8 SQ. FT. COMB. ARROW 26.0 SQ. FT.
TWO WAY LEFT TURN MARKING	2 @ 4 IN. EACH DIRECTION 8 FT. LEFT ARROW	SKIP-DASH AND SOLID IN PAIRS	YELLOW WHITE	10 FT. LINE WITH 30 FT. SPACE FOR SKIP-DASH 5 1/2 IN. C-C BETWEEN SKIP-DASH LINE AND SOLID LINE SEE TYPICAL TWO-WAY LEFT TURN MARKING DETAIL
CROSSWALK	12 IN. @ 90°	SOLID	WHITE	12 IN. LONGITUDINAL BAR WITH 24 IN. SPACE 6 FT. TO 12 FT. WIDE SEE TYPICAL CROSSWALK MARKING DETAIL
STOP BARS	24 IN.	SOLID	WHITE	PLACE 4 FT. IN ADVANCE OF AND PARALLEL TO CROSSWALK, IF PRESENT, OTHERWISE PLACE AT DESIRED STOPPING POINT.
PAINTED MEDIANS	2 @ 4 IN. & 8 IN. C-C 12 IN. DIAGONALS @ 45° NO DIAGONALS USED FOR 4 FT. WIDE MEDIAN	SOLID	YELLOW; 2-WAY TRAFFIC WHITE; 1-WAY TRAFFIC	11 IN. C-C FOR THE DOUBLE LINE SEE TYPICAL PAINTED MEDIAN MARKING DETAIL MINIMUM OF 5 DIAGONALS
GORE MARKING AND CHANNELIZING LINES	8 IN. WITH 12 IN. DIAGONALS @ 45°	SOLID	WHITE	DIAGONALS 15 FT. C-C (LESS THAN 30 M.P.H.) 20 FT. C-C (30 TO 45 M.P.H.) 30 FT. C-C (OVER 45 M.P.H.) MINIMUM OF 5 DIAGONALS
R.R. CROSSING	24 IN. TRANSVERSE LINES RR IS 6 FT. LETTER 16 IN. LINE FOR "X"	SOLID	WHITE	SEE I.D.O.T. STD. 780001 50 FT. AREA OF "R" = 3.6 SQ. FT. / "R" "X" = 54.0 SQ. FT.
SHOULDER DIAGONALS	12 IN. @ 45°	SOLID	WHITE - RIGHT YELLOW - LEFT	50 FT. C-C (LESS THAN 30 M.P.H.) 75 FT. C-C (30 TO 45 M.P.H.) 150 FT. C-C (OVER 45 M.P.H.) MINIMUM OF 5 DIAGONALS

FOR FURTHER DETAILS ON PAVEMENT MARKING REFER TO PART III 'MARKINGS' IN THE 'ILLINOIS MANUAL ON UNIFORM TRAFFIC CONTROL DEVICES', THE 'STANDARD SPECIFICATIONS FOR ROAD AND BRIDGE CONSTRUCTION', AND THE LATEST I.D.O.T. HIGHWAY STANDARD 780001.

REVISIONS	DATE	APPROVED BY: A. KHAWAJA DATE: APRIL 1, 2007
SEPARATED RAILROAD SHEET	06/02/08	
REVISED RPM DETAILS	07/11/12	
RAISED TO RECESSED MARKERS	12/2/13	
REMOVE STATION NUMBERS	5/30/14	



## TYPICAL PAVEMENT MARKINGS FOR COUNTY HIGHWAYS


SHEET 2 OF 2

NO.	REVISIONS / REMARKS	DATE	BY	SURVEYOR	DESIGNER/LIAISON	PLOTTED BY	PROJECT NAME	ROUTE	SECTION	SECTION NUMBER	SHEET	SHEETS
						hdrcmc	LAKE COUNTY STANDARDS & DETAILS	CHXX	XXX	XX-XXXXX-XX-XX	XXX	XXX




LC7800





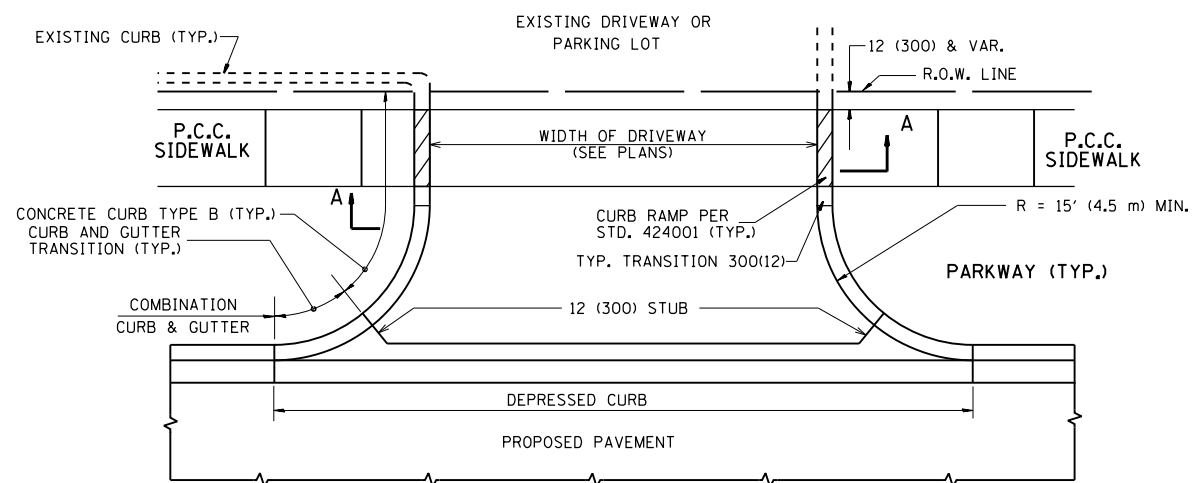


WITH CONCRETE CURB, TYPE B

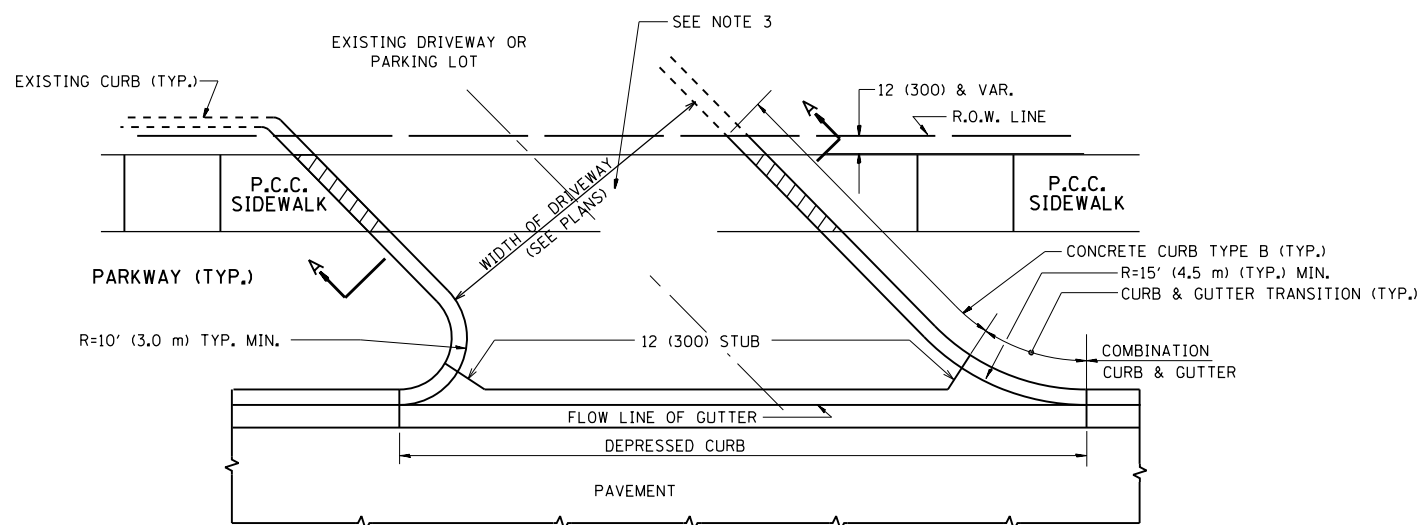


WITH CONCRETE CURB, TYPE B

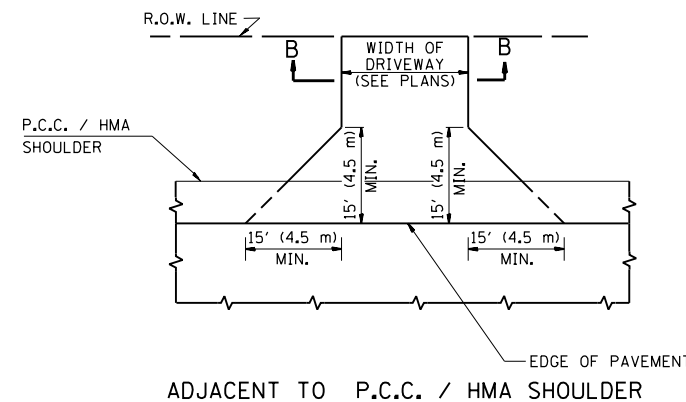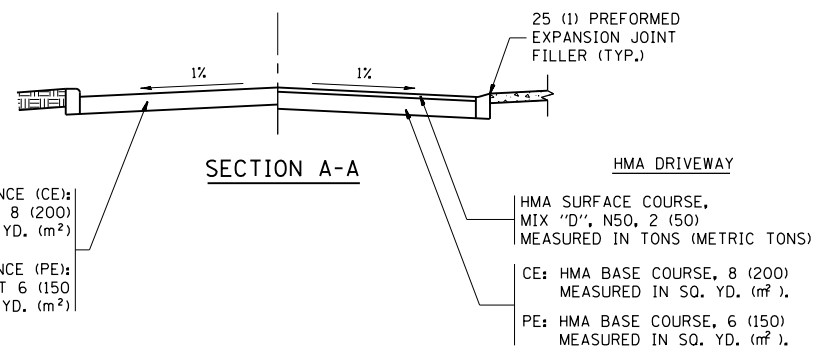

ADJACENT TO P.C.C. / HMA SHOULDER

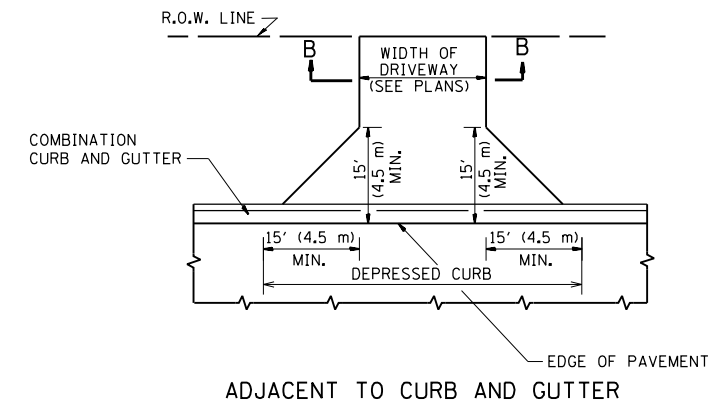

ADJACENT TO CURB AND GUTTER

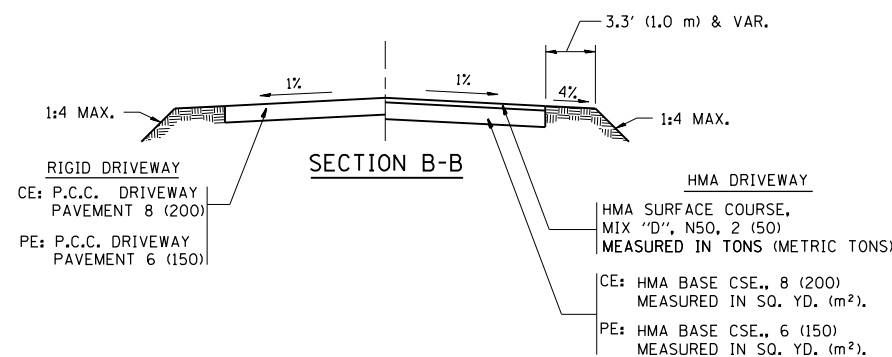

SECTION B-B

**GENERAL NOTES:**

DRIVEWAY SLOPES, LOCATIONS, & GEOMETRIC LAYOUT SHALL BE IN ACCORDANCE WITH THE LATEST EDITION OF THE "HANDBOOK FOR POLICY ON PERMITS FOR ACCESS DRIVEWAYS TO STATE HIGHWAYS". FOR FURTHER LAYOUT REQUIREMENTS, REFER TO ILLUSTRATIONS IN THE PERMIT HANDBOOK. DRIVEWAYS SHALL BE REPLACED IN KIND, UNLESS OTHERWISE NOTED ON THE PLANS.

COMMERCIAL DRIVEWAYS SHALL BE CONSTRUCTED WITH CONCRETE CURB, TYPE B RETURNS EXCEPT WHEN THE SIDEWALK EDGE IS 4 FEET (1.2 METERS) OR LESS FROM THE BACK OF CURB, CONSTRUCT A FLARE DRIVEWAY WITHOUT CURB.

THE RESIDENT ENGINEER SHALL CONTACT THE TRAFFIC PERMIT OFFICE AT 847/ 705-4131 FOR ANY QUESTIONS ON DRIVEWAYS SHOWN IN THE PLANS; SPECIFICALLY IN REFERENCE TO ADDITIONAL AND/OR RELOCATION/REMOVAL OF A DRIVEWAY.

COMBINATION CONCRETE CURB & GUTTER SHALL BE MEASURED STRAIGHT ACROSS THE DRIVEWAY. NO ADDITIONAL COMPENSATION WILL BE ALLOWED FOR THE CURB & GUTTER TRANSITION.

1 (25) PREFORMED EXPANSION JOINT FILLER WILL NOT BE PAID SEPARATELY, BUT SHALL BE CONSIDERED INCLUDED IN THE COST OF THE P.C.C. DRIVEWAY PAVEMENT OR P.C.C. SIDEWALK.


WHEN THE P.C.C. SIDEWALK EXTENDS THROUGH THE DRIVEWAY, THE THICKNESS OF THE SIDEWALK IN THE DRIVEWAY AREA SHALL BE THE SAME AS THE DRIVEWAY THICKNESS. SIDEWALK WILL BE PAID FOR AS P.C.C. SIDEWALK OF THE THICKNESS SPECIFIED. SIDEWALK CROSS SLOPE THRU DRIVEWAY AREA TO BE A MAXIMUM OF 1:50.

FILE NAME =	USER NAME = ldezmar	DESIGNED - R. SHAH	REVISED - P. LaFLUER 04-15-03
pw:\11084EBIDINTEG.illinois.gov\PIWIDOT\Documents\DOT Offices\District 1\Projects\PI4540\Drawings\Design\DistStd.dgn		CHECKED -	REVISED - R. BORO 01-01-07
PLOT SCALE = 100.0000' / 1"		DATE - 11-04-95	REVISED - R. BORO 06-11-08
PLOT DATE = 8/19/2016			REVISED - R. BORO 09-06-11


**STATE OF ILLINOIS  
DEPARTMENT OF TRANSPORTATION**

<b>DRIVEWAY DETAILS - DISTANCE BETWEEN R.O.W. AND FACE OF CURB &amp; EDGE OF SHOULDER ≥ 15' (4.5 m)</b>			
SCALE: NONE	SHEET NO. 1 OF 1 SHEETS	STA.	TO STA.


F.A.P. RTE.	SECTION	COUNTY	TOTAL SHEETS	SHEET NO.
104	105N-4	LAKE	113	81
<b>BD0156-07 (BD-01)</b>			<b>CONTRACT NO. 60W06</b>	
FED. ROAD DIST. NO. 1 ILLINOIS FED. AID PROJECT				

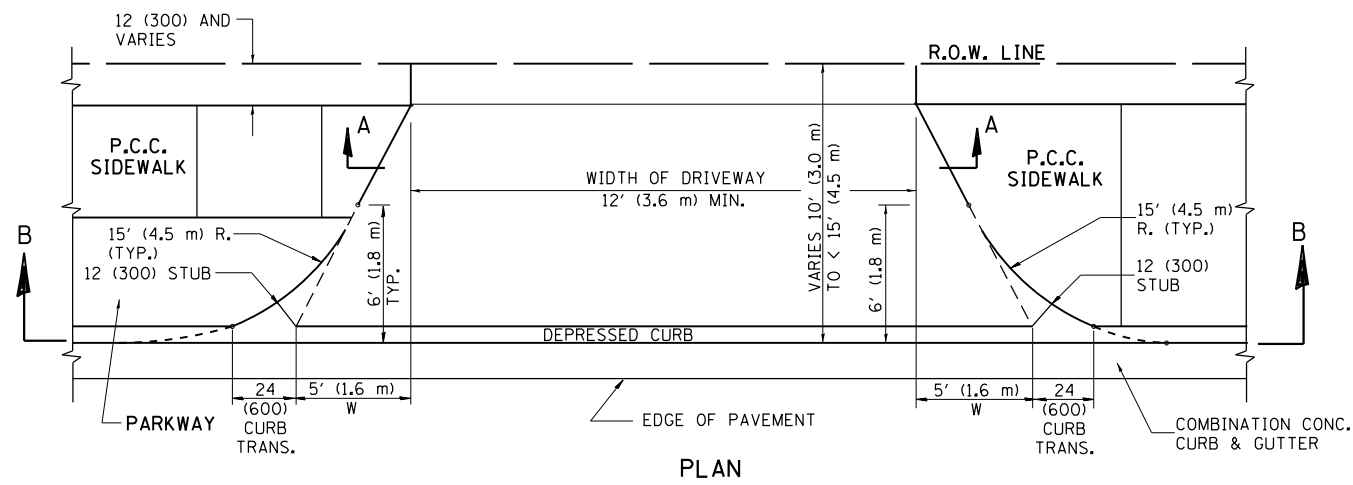


PLAN  
10' (3.0 m) TO < 15' (4.5 m)

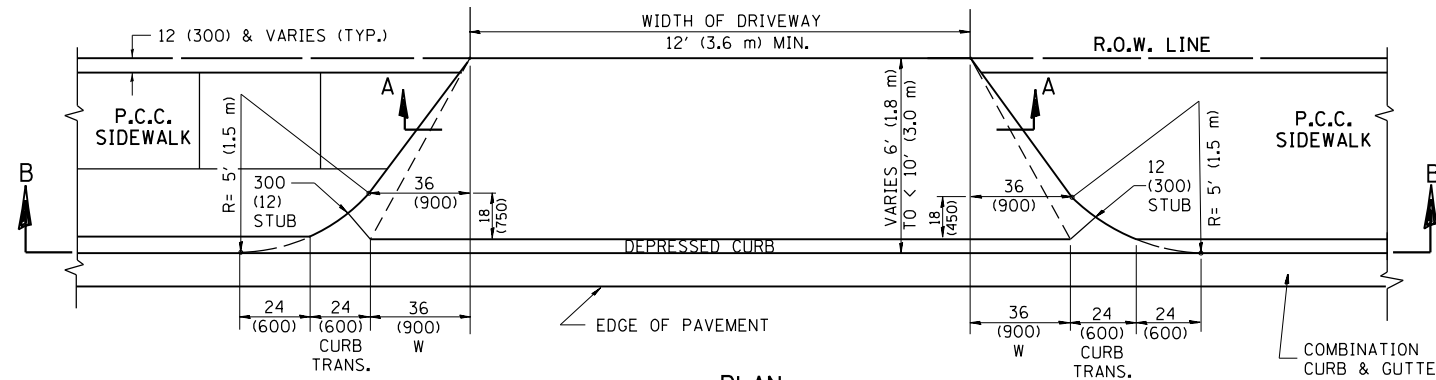


PLAN  
6' (1.8 m) TO < 10' (3.0 m)

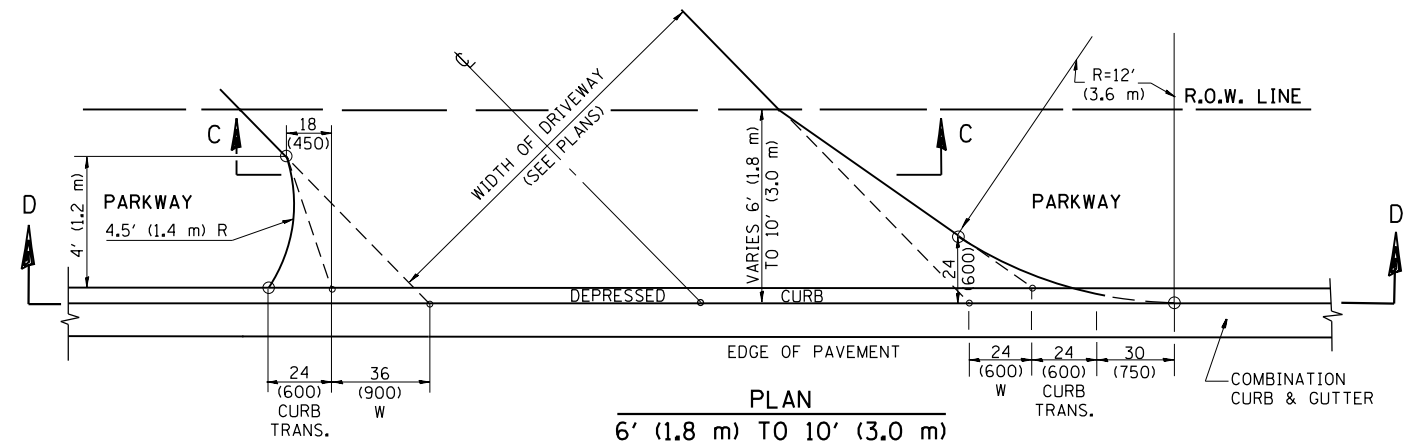


PLAN  
6' (1.8 m) TO 10' (3.0 m)

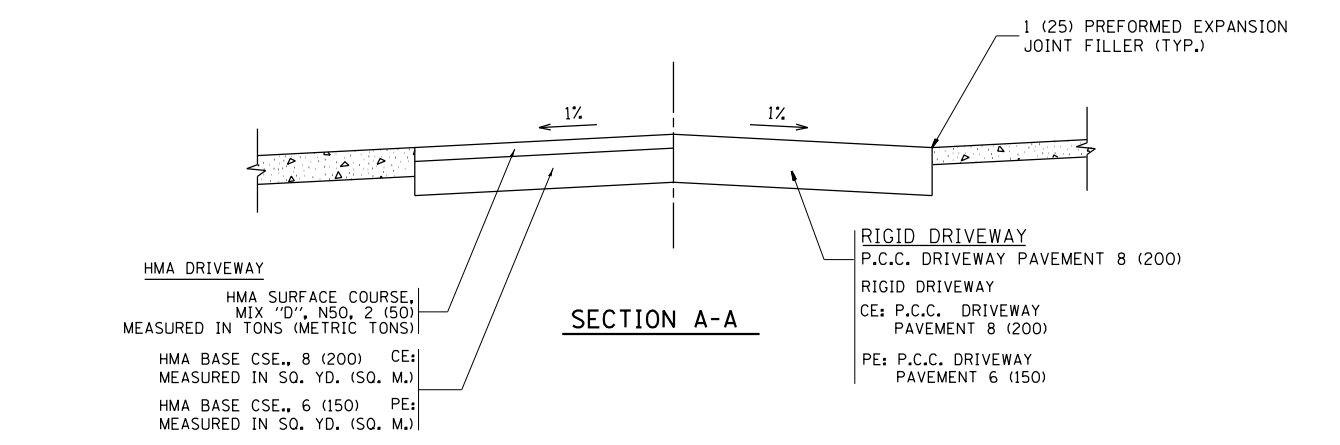


SECTION A-A

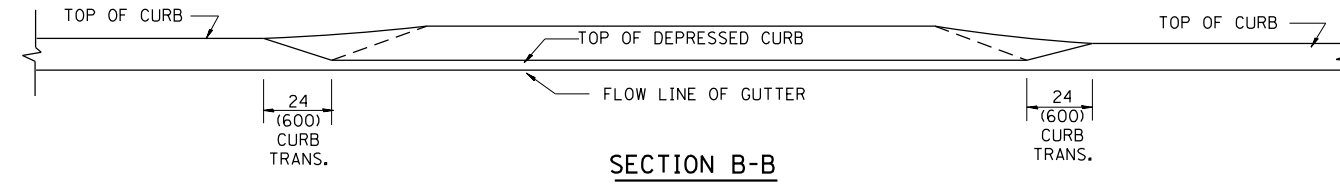

SECTION B-B

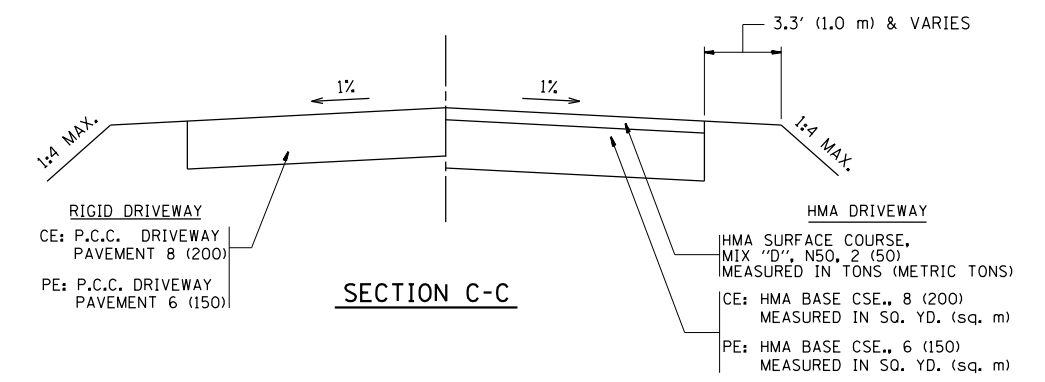

SECTION C-C

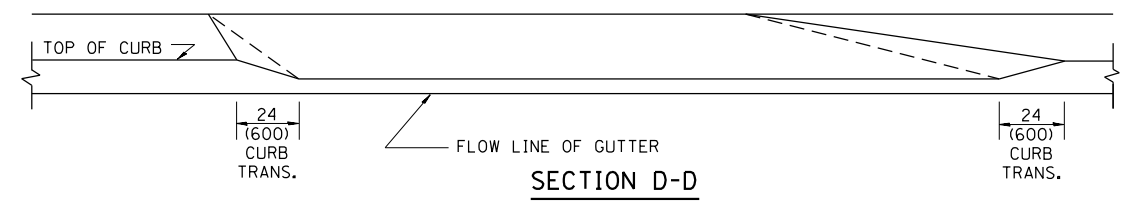

SECTION D-D

GENERAL NOTES

DRIVEWAY SLOPES, LOCATIONS, & GEOMETRIC LAYOUT SHALL BE IN ACCORDANCE WITH THE LATEST EDITION OF THE "HANDBOOK FOR POLICY ON PERMITS FOR ACCESS DRIVEWAYS TO STATE HIGHWAYS". FOR FURTHER LAYOUT REQUIREMENTS, REFER TO ILLUSTRATION 10 IN THE PERMIT HANDBOOK. WHERE SIDEWALKS EXIST, DRIVEWAYS SHALL BE REPLACED WITH RIGID PAVEMENT. WHERE NO SIDEWALKS EXIST, DRIVEWAYS SHALL BE REPLACED IN KIND. SIDEWALK CROSS SLOPE THRU DRIVEWAY AREA TO BE A MAXIMUM OF 1:50.

WHEN THE DISTANCE BETWEEN R.O.W. AND THE BACK OF CURB IS EQUAL TO OR LESS THAN 8' (2.4 m), THE P.C.C. SIDEWALK SHALL EXTEND TO THE BACK OF CURB.

THE RESIDENT ENGINEER SHALL CONTACT THE TRAFFIC PERMIT OFFICE AT 847/ 705-4131 FOR ANY QUESTIONS ON DRIVEWAYS SHOWN IN THE PLANS; SPECIFICALLY IN REFERENCE TO ADDITIONAL AND/OR RELOCATION/REMOVAL OF A DRIVEWAY.

COMBINATION CONCRETE CURB & GUTTER SHALL BE MEASURED STRAIGHT ACROSS THE DRIVEWAY. NO ADDITIONAL COMPENSATION WILL BE ALLOWED FOR THE CURB & GUTTER TRANSITION.

THE 1 (25) PREFORMED EXPANSION JOINT FILLER WILL NOT BE PAID SEPARATELY, BUT SHALL BE CONSIDERED INCLUDED IN THE COST OF THE P.C.C. DRIVEWAY PAVEMENT OR P.C.C. SIDEWALK.

"W" VARIES FROM 36 (900) TO 5' (1.5 m) PROPORTIONAL TO THE LENGTH (L), FROM 6' (1.8 m) TO 10' (3 m).



ALL DIMENSIONS ARE IN INCHES (MILLIMETERS) UNLESS OTHERWISE NOTED.

FILE NAME =	USER NAME = ledznmrm	DESIGNED - R. SHAH	REVISED - M. GOMEZ 04-06-01
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		DATE - 11-06-95	REVISED - R. BORO 01-01-07
			REVISED - R. BORO 01-01-07

STATE OF ILLINOIS  
DEPARTMENT OF TRANSPORTATION







DRIVEWAY DETAILS	
DISTANCE BETWEEN ROW AND FACE OF CURB < 15' (4.5 m)	
SCALE: NONE	SHEET NO. 1 OF 1 SHEETS STA. TO STA.

F.A.P. RTE.	SECTION	COUNTY	TOTAL SHEETS	SHEET NO.
104	105N-4	LAKE	113	82
BD400-02 (BD-02)			CONTRACT NO. 60W06	
FED. ROAD DIST. NO. 1 ILLINOIS FED. AID PROJECT				

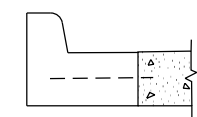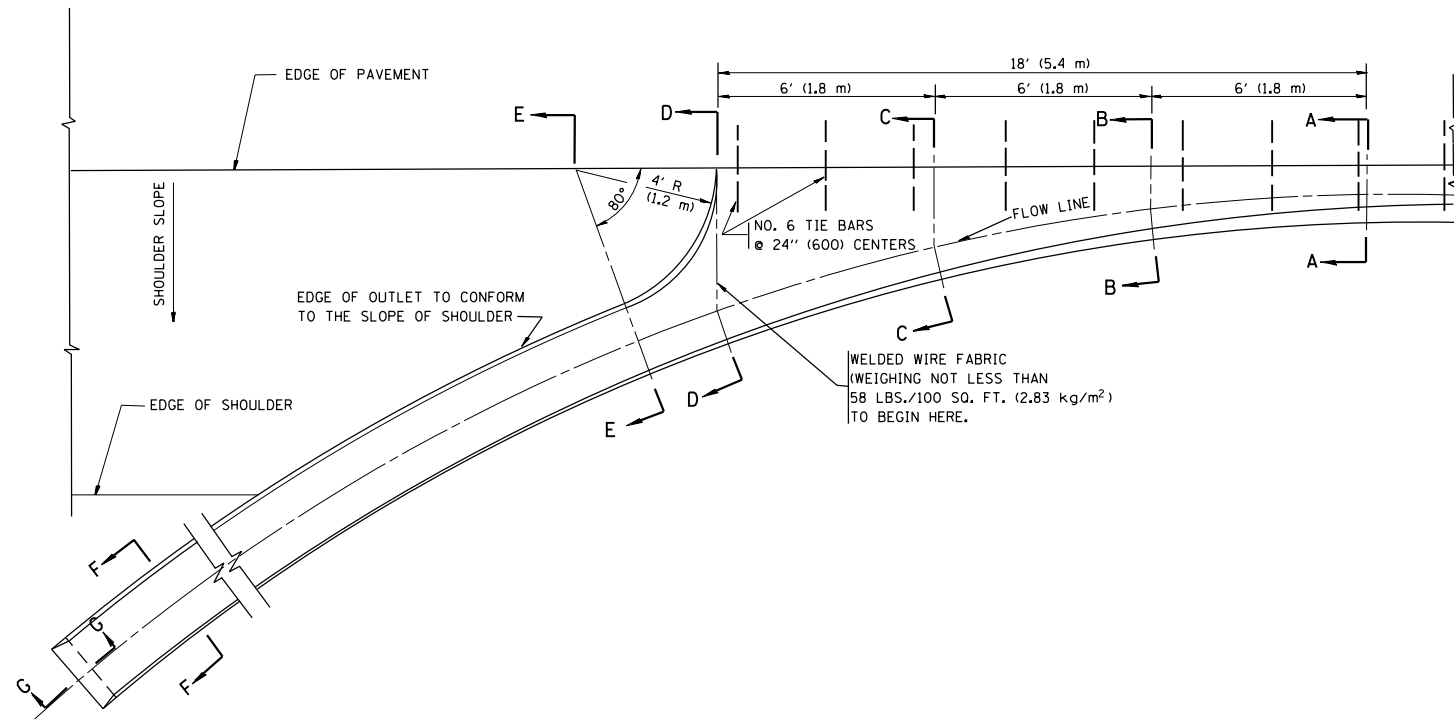

A-A \*

\* DIMENSIONS OF THE CURB & GUTTER AT SECTION A-A ARE SHOWN ON STATE STANDARD 606001. FOR DETAILS OF OUTLET FOR CONCRETE CURB & GUTTER, TYPE B-6.24 (B-15.60) SEE STATE STANDARD 606006.

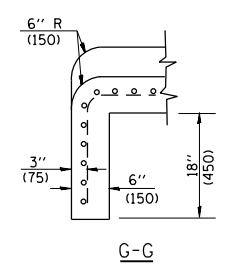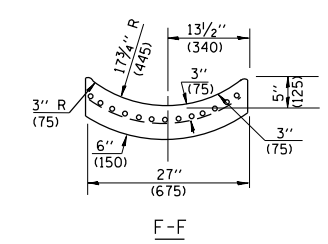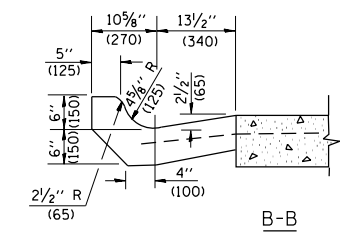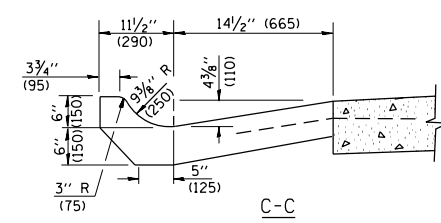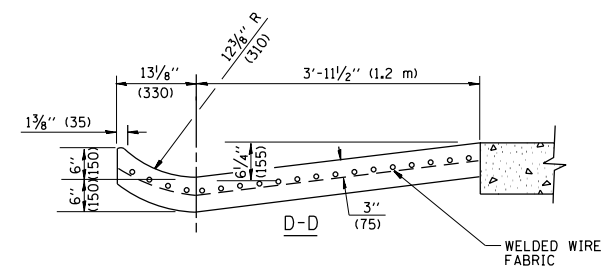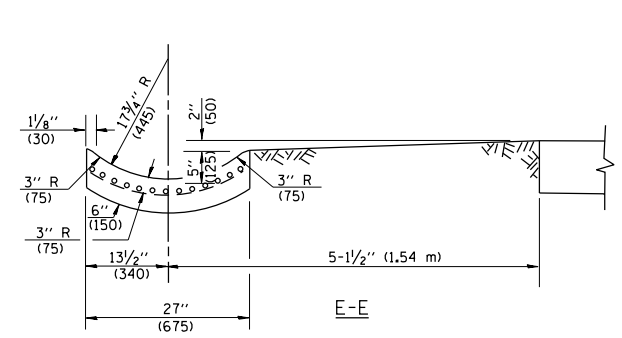

**GENERAL NOTES**

GUTTER OUTLET SHALL BE TIED TO THE PAVEMENT IN ACCORDANCE WITH DETAILS FOR LONGITUDINAL CONSTRUCTION JOINT SHOWN ON STANDARD 420001.

TIE BARS SHALL BE NO. 20 (NO.6) AT 24\"/>


IF THE AVERAGE GRADE OF PAVEMENT FOR THE DISTANCE FROM SECTION A-A TO D-D EXCEEDS 2%, THIS DISTANCE SHALL BE INCREASED 6' (1.8 m) FOR EACH 1% INCREASE IN GRADE.

**QUANTITIES**

FOR SECTION A-A TO E-E AND CURTAIN WALL =  
 1.25 CU. YDS. (0.96 m<sup>3</sup>) CLASS S1 CONCRETE (OUTLET) FOR 9\"/>




ALL DIMENSIONS ARE IN INCHES (MILLIMETERS) UNLESS OTHERWISE SHOWN.

FILE NAME =	USER NAME = ldezma	DESIGNED - M. DE YONG	REVISED - R. SHAH 09-09-94	<b>STATE OF ILLINOIS DEPARTMENT OF TRANSPORTATION</b>	<b>OUTLET FOR CONCRETE CURB AND GUTTER</b>			F.A.P. RTE.	SECTION	COUNTY	TOTAL SHEETS	SHEET NO.
pw:\11084EBIDINTEG.111nois.gov\PIWIDOT\Documents\IDOT Offices\District 1\Projects\P14340\Drawings\Design\DistStd.dgn			REVISED - R. SHAH 10-25-94		104	105N-4	LAKE	83				
PLOT SCALE = 100.0000' / 1\"/>												
PLOT DATE = 8/19/2016	DATE = 08-04-86	REVISED -			SCALE: NONE	SHEET NO. 1 OF 1 SHEETS	STA.	TO STA.	<b>BD600-01 (BD-03) CONTRACT NO. 60W06</b>			
								FED. ROAD DIST. NO. 1 ILLINOIS FED. AID PROJECT				

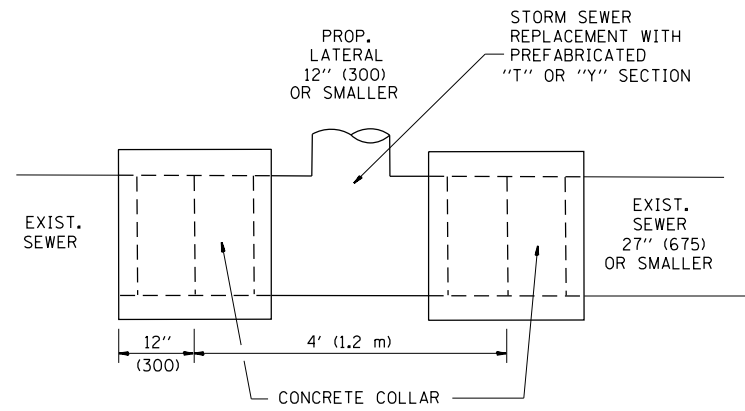

**DETAIL "A"**

LATERAL CONNECTION TO EXISTING SEWER OF 27" (675) OR SMALLER

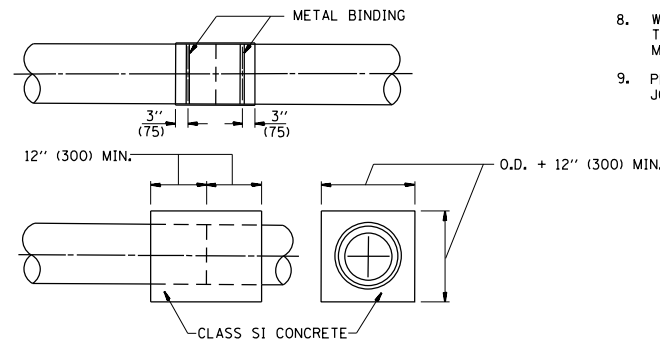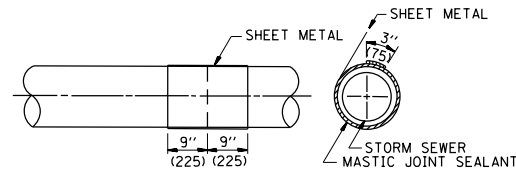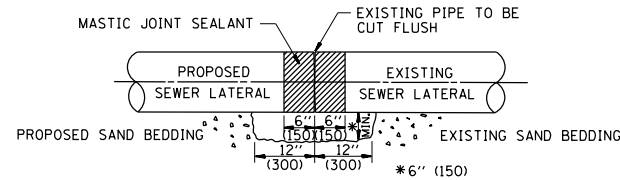


**DETAIL "B"**

CLASS SI CONCRETE COLLAR

**CONSTRUCTION SEQUENCE**

1. CUT THE EXISTING END OF THE PIPE SO AS TO PRESENT A FLUSH BUTT JOINT. BRUSH AND CLEAN ALL PIPES.
2. APPLY THE MASTIC JOINT SEALANT TO THE FIRST 6" (150) OF EACH PIPE.
3. BUTT THE PIPES TOGETHER LEAVING A MINIMUM OF 12" x 6" (300 x 150) DEEP EXCAVATION UNDER AND AROUND EACH PIPE END.
4. CUT A PIECE OF SHEET METAL GAGE NO. 19 1.1 (0.0418) 18" (450) WIDE BY THE OUTSIDE CIRCUMFERENCE OF THE PIPE PLUS 3" (75) LONG.
5. WRAP THE SHEET METAL AROUND THE PIPES, 9" (225) ON EACH SIDE OF THE JOINT, STARTING AT THE TOP OF THE PIPE.
6. LAP THE SHEET METAL AT LEAST 3" (75) AT THE TOP OF THE PIPE AND PLACE THE MASTIC JOINT SEALANT BETWEEN THE LAP.
7. PLACE TWO METAL BANDS AROUND THE SHEET METAL AND TIGHTEN.
8. WIPE OFF ANY EXCESS MASTIC JOINT SEALANT THAT OOOZES OUT FROM BETWEEN THE SHEET METAL AND THE PIPES.
9. PLACE CLASS SI CONCRETE AROUND THE JOINT.

ALL DIMENSIONS ARE IN INCHES (MILLIMETERS) UNLESS OTHERWISE SHOWN.

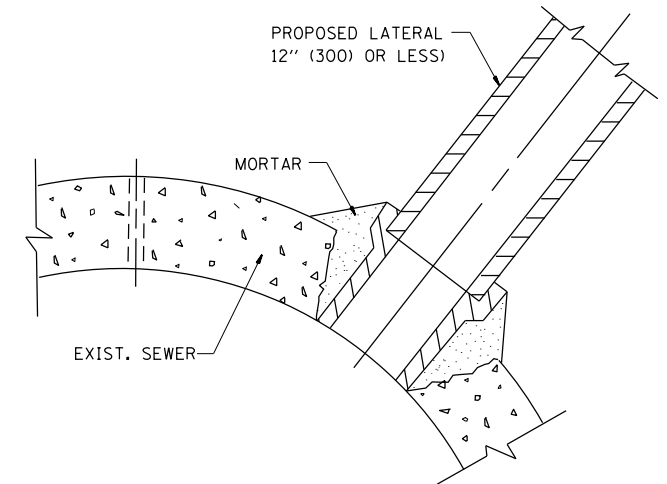

**DETAIL "C"**

PROPOSED LATERAL CONNECTION TO EXISTING SEWER OF 30" (750) OR LARGER

**NOTES**

**MATERIAL**

MATERIAL USED FOR THE TEE OR WYE SECTION SHALL BE COMPATIBLE WITH THE EXISTING STORM SEWER OR THE PROPOSED STORM SEWER.

**CONSTRUCTION METHODS**

- I. THIS WORK SHALL BE CONSTRUCTED IN CONFORMANCE WITH THE APPLICABLE PORTIONS OF SECTION 550 OF THE STANDARD SPECIFICATIONS.
- II. CONNECTION TO AN EXISTING STORM SEWER SHALL BE BY EITHER OF THE FOLLOWING METHODS:
  - A) PROPOSED STORM SEWER CONNECTION TO EXISTING SEWER OF 27" (675) OR SMALLER SEE DETAIL "A" AND "B".
  - B) PROPOSED STORM SEWER CONNECTION TO EXISTING SEWER OF 30" (750) OR LARGER SEE DETAIL "C".

IF THE EXISTING SEWER PIPE IS CRACKED, BROKEN OR OTHERWISE DAMAGED BY THE CONTRACTOR IN MAKING THE CIRCULAR OPENING, THE CONTRACTOR SHALL REPLACE THAT SECTION OF PIPE WITH PIPE EQUAL AND SIMILAR IN ALL RESPECTS TO THE PIPE IN THE EXISTING SEWER, IN A CAREFUL WORKMANLIKE MANNER, WITHOUT EXTRA COMPENSATION.

**GENERAL**

CARE MUST BE TAKEN TO PREVENT DEBRIS FROM ENTERING THE SEWER. ALL DEBRIS WHICH ENTERS THE SEWER MUST BE REMOVED. THE SEWER MUST BE LEFT CLEAN AND UNOBSTRUCTED UPON COMPLETION OF THE CONTRACT.

CARE MUST BE TAKEN TO PREVENT ANY PART OF THE NEW PIPE CONNECTION FROM PROJECTING INTO THE EXISTING SEWER.

**BASIS OF PAYMENT**

TEE OR WYE CONNECTIONS SHALL BE PAID FOR AT THE CONTRACT UNIT PRICE EACH FOR STORM SEWER TEE OR WYE OF THE TYPE AND SIZE SPECIFIED IN THE PLANS. THIS PRICE SHALL INCLUDE ALL EXCAVATION OF THE TRENCH, REMOVAL OF THE EXISTING STORM SEWER, FURNISHING AND INSTALLING THE SPECIFIED TEE OR WYE SECTION, FURNISHING AND INSTALLING THE REQUIRED CONCRETE COLLAR, AND ALL OTHER MATERIAL NECESSARY TO COMPLETE THIS WORK AS SHOWN AND SPECIFIED.

REMOVAL AND REINSTALLATION OF EXISTING STORM SEWER ADJACENT TO THE PROPOSED TEE OR WYE SECTION, FOR THE PURPOSE OF FACILITATING THE INSTALLATION OF THE TEE OR WYE SECTION, WILL NOT BE PAID FOR SEPARATELY BUT SHALL BE INCLUDED IN THE UNIT PRICE BID FOR THE WORK.

TRENCH BACKFILL, EXCAVATION IN ROCK AND REMOVAL AND REPLACEMENT OF UNSUITABLE MATERIAL BELOW PLAN BEDDING GRADE WILL BE PAID FOR SEPARATELY.

CONCRETE COLLAR FOR CONNECTING A PROPOSED STORM SEWER TO AN EXISTING STORM SEWER WILL NOT BE PAID FOR SEPARATELY BUT SHALL BE INCLUDED IN THE COST OF THE PROPOSED STORM SEWER.


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		DATE - 07-25-90	REVISED - R. SHAH 10-25-94
			REVISED - R. SHAH 06-12-96

STATE OF ILLINOIS  
DEPARTMENT OF TRANSPORTATION

DETAIL OF STORM SEWER  
CONNECTION TO EXISTING SEWER

SCALE: NONE SHEET NO. 1 OF 1 SHEETS STA. TO STA.

F.A.P. RTE.	SECTION	COUNTY	TOTAL SHEETS	SHEET NO.
104	105N-4	LAKE	113	84
BD500-01 (BD-7)			CONTRACT NO. 60W06	
FED. ROAD DIST. NO. 1 ILLINOIS FED. AID PROJECT				

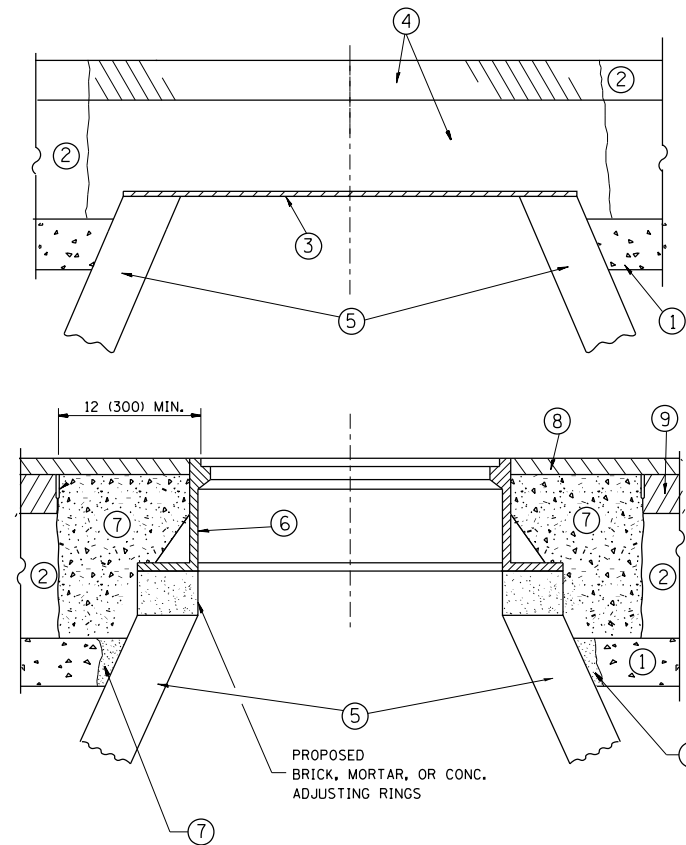

**CONSTRUCTION PROCEDURES**

**STAGE 1 (BEFORE PAVEMENT MILLING)**

- A) REMOVE A MINIMUM OF 12 (300) OF THE PAVEMENT FROM AROUND THE STRUCTURE.
- B) REMOVE THE EXISTING FRAME AND LID FROM THE STRUCTURE.
- C) COVER THE STRUCTURE OPENING WITH A 36 (900) DIAMETER METAL PLATE.
- D) BACKFILL WITH CRUSHED STONE AND A MINIMUM 1/2 (40) THICK HMA SURFACE MIX APPROVED BY THE ENGINEER.

**STAGE 2 (AFTER PAVEMENT MILLING)**

- A) REMOVE THE HMA SURFACE MIX AND CRUSHED STONE.
- B) INSTALL THE FRAME AND LID; ADJUST THE FRAME TO ITS FINAL SURFACE ELEVATION.
- C) THE SURROUNDING SPACE SHALL BE FILLED WITH CLASS PP-1\* CONCRETE TO THE ELEVATION OF THE SURFACE OF THE EXISTING BASE COURSE OR THE BINDER COURSE.

\* UNLESS OTHERWISE SPECIFIED IN THE PLANS.

THE PROCEDURE EXPLAINED ABOVE SHALL CONFORM TO THE APPLICABLE PORTIONS OF SECTIONS 353, 406, 602, AND 603 OF THE STANDARD SPECIFICATIONS EXCEPT THAT "THE CONTRACTOR SHALL ADJUST THE STRUCTURES TO THE FINISHED PAVEMENT ELEVATION NO MORE THAN 5 CALENDAR DAYS PRIOR TO PLACEMENT OF THE FINAL LIFT OF SURFACE UNLESS APPROVED BY THE ENGINEER."

**LEGEND**

- ① SUB-BASE GRANULAR MATERIAL
- ② EXISTING PAVEMENT
- ③ 36 (900) DIAMETER METAL PLATE
- ④ PROPOSED CRUSHED STONE AND HMA SURFACE MIX
- ⑤ EXISTING STRUCTURE
- ⑥ FRAME AND LID (SEE NOTES)
- ⑦ CLASS PP-1\* CONCRETE
- ⑧ PROPOSED HMA SURFACE COURSE
- ⑨ PROPOSED HMA BINDER COURSE

**LOCATION OF STRUCTURES:**

THE CONTRACTOR WILL BE REQUIRED TO KEEP A RECORD OF THE LOCATIONS OF THE BURIED STRUCTURES ACCORDING TO THE STATION AND DISTANCE LEFT OR RIGHT OF THE CENTERLINE OF PAVEMENT. UPON COMPLETION OF THE WORK, THE CONTRACTOR WILL DELIVER THE RECORD TO THE ENGINEER.

**BASIS OF PAYMENT:**

REMOVING FRAMES AND LIDS ON DRAINAGE AND UTILITY STRUCTURES IN THE PAVEMENT PRIOR TO MILLING, AND ADJUSTING TO FINAL GRADE PRIOR TO PLACING THE SURFACE COURSE, WILL BE PAID FOR AT THE CONTRACT UNIT PRICE EACH FOR "FRAMES AND LIDS TO BE ADJUSTED (SPECIAL)."

THIS WORK WILL NOT BE PAID FOR WHEN DRAINAGE AND UTILITY STRUCTURES ARE SPECIFIED FOR PAYMENT AS STRUCTURE RECONSTRUCTION.

NEW FRAMES AND LIDS, WHEN SPECIFIED, WILL BE PAID FOR SEPARATELY.

**NOTES:**

EXISTING BROKEN FRAMES AND LIDS SHALL BE REMOVED AND DISPOSED OF BY THE CONTRACTOR AND SHALL BE REPLACED AS DIRECTED BY THE ENGINEER. REPLACEMENT FRAMES AND LIDS WILL BE PAID FOR IN ACCORDANCE WITH ARTICLE 109.04 OF THE STANDARD SPECIFICATIONS UNLESS A SEPARATE PAY ITEM HAS BEEN PROVIDED.

IF THE EXISTING LIDS ARE OPEN, THE FRAME WILL BE ADJUSTED TO THE ELEVATION OF THE MILLED PAVEMENT SURFACE PRIOR TO THE MILLING OPERATION. THE FRAME WILL NOT BE REMOVED AND COVERED BY THE METAL PLATE.

CITY OF CHICAGO CASTINGS ARE THE PROPERTY OF THE CITY AND THE CONTRACTOR SHALL NOTIFY THE CITY FOR REMOVAL AND DISPOSITION OF THE CASTINGS.

THE METAL PLATE USED TO COVER THE STRUCTURE SHALL REMAIN THE PROPERTY OF THE CONTRACTOR.

WHEN STRUCTURES ARE TO BE ADJUSTED OR RECONSTRUCTED, THE LOWERING AND RAISING OF THE FRAMES AND LIDS WILL NOT BE PAID FOR SEPARATELY BUT WILL BE INCLUDED IN THE COST OF THE CORRESPONDING PAY ITEM.

**DETAILS FOR FRAMES AND LIDS ADJUSTMENT WITH MILLING**

ALL DIMENSIONS ARE IN INCHES (MILLIMETERS) UNLESS OTHERWISE SHOWN






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	PLOT DATE = 8/19/2016	DATE - 10-25-94	REVISED - R. BORO 12-06-11

**STATE OF ILLINOIS  
DEPARTMENT OF TRANSPORTATION**


**DETAILS FOR  
FRAMES AND LIDS ADJUSTMENT WITH MILLING**

SCALE: NONE SHEET NO. 1 OF 1 SHEETS STA. TO STA.


F.A.P. RTE.	SECTION	COUNTY	TOTAL SHEETS	SHEET NO.
104	105N-4	LAKE	113	85
<b>BD600-03 (BD-8)</b>		<b>CONTRACT NO. 60W06</b>		
FED. ROAD DIST. NO. 1 ILLINOIS FED. AID PROJECT				

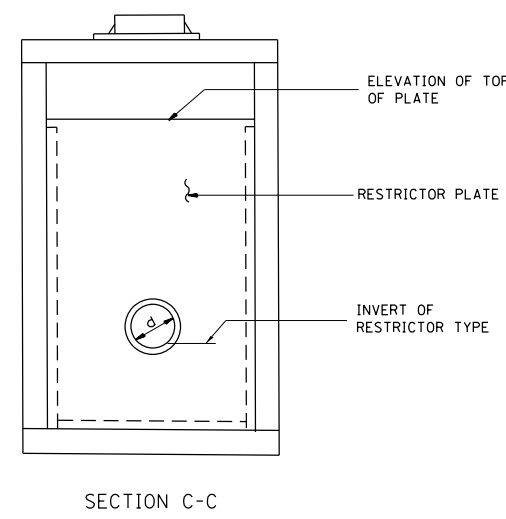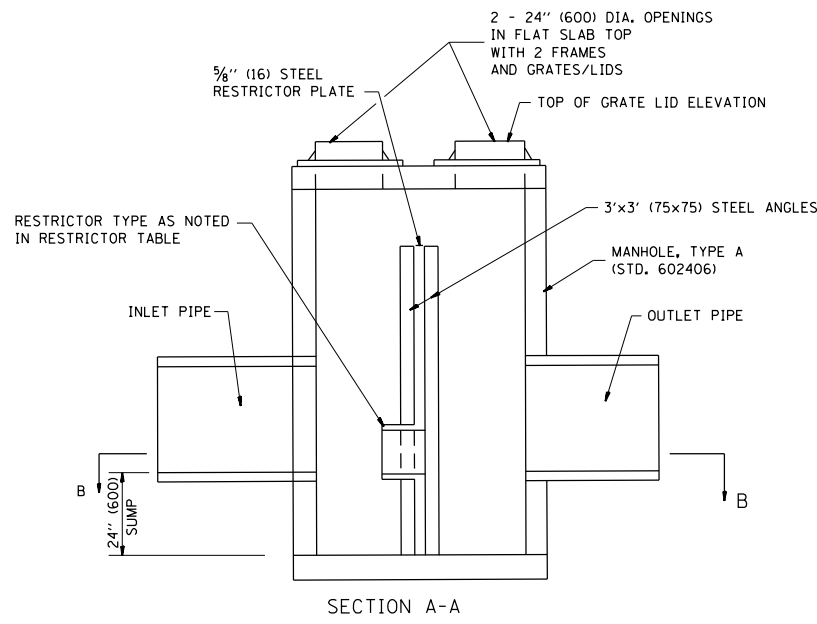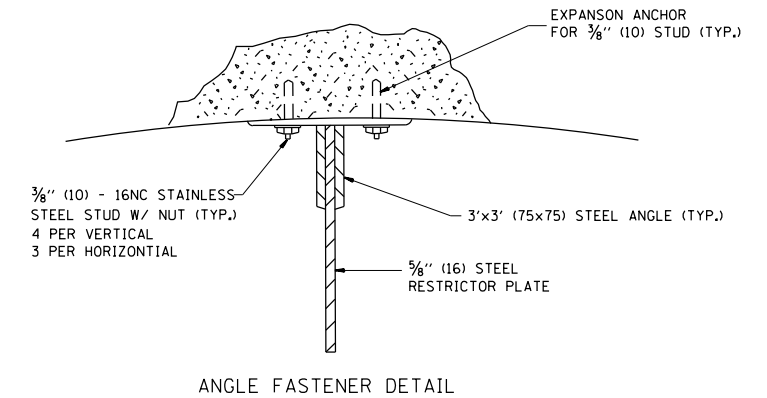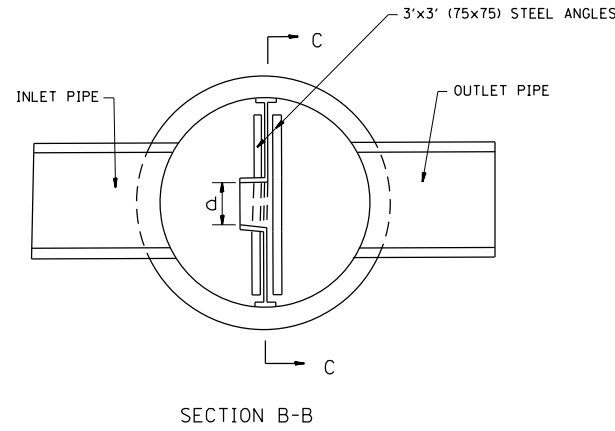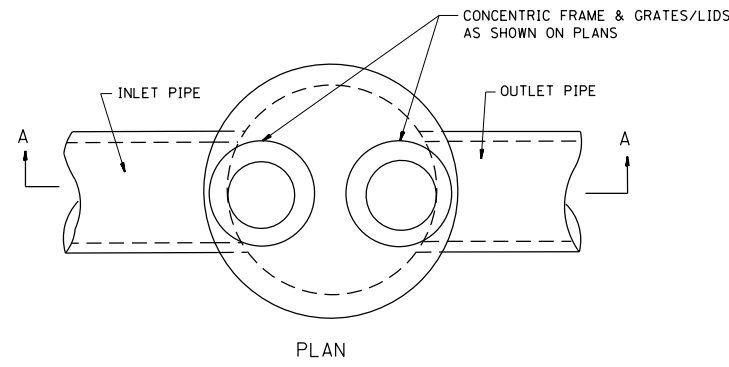

- NOTES:
1. ALL STEEL ANGLES AND PLATES TO BE GALVANIZED AFTER FABRICATION.
  2. ALL RESTRICTOR PLATES, ANGLES AND HARDWARE TO BE INCLUDED IN THE COST OF THE MANHOLE.
  3. BASIS OF PAYMENT: "MANHOLES, TYPE A, 6 FT. (1.8 m)-DIAMETER, TYPE 1 FRAME, CLOSED LID, RESTRICTOR PLATE" EACH

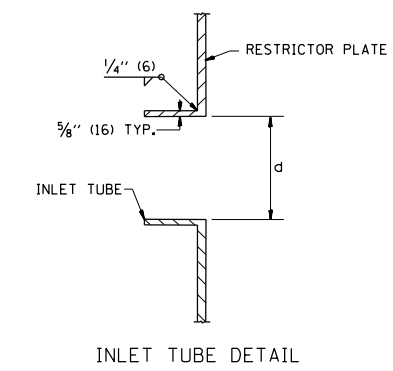

STATION	MANHOLE DIAMETER	FRAME AND GRATE	RESTRICTOR TYPE	INSIDE RESTRICTOR TYPE DIAMETER in. (mm) (d)	INVERT OF RESTRICTOR TYPE	ELEVATION OF TOP OF PLATE OVERFLOW

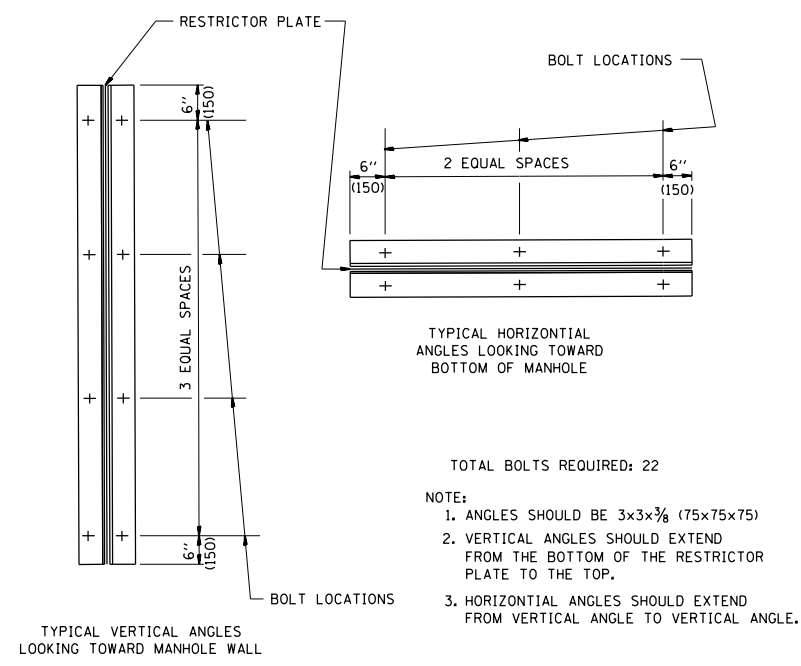


- TOTAL BOLTS REQUIRED: 22
- NOTE:
1. ANGLES SHOULD BE 3x3x3/8 (75x75x75)
  2. VERTICAL ANGLES SHOULD EXTEND FROM THE BOTTOM OF THE RESTRICTOR PLATE TO THE TOP.
  3. HORIZONTAL ANGLES SHOULD EXTEND FROM VERTICAL ANGLE TO VERTICAL ANGLE.

RESTRICTOR TYPE					
1	2	3	4	5	6
RE-ENTRANT TUBE	SHARP EDGED	SQUARE EDGED	RE-ENTRANT TUBE	SQUARE EDGED	ROUNDED
LENGTH: 1/2 TO 1 DIA.		STREAM CLEARS SIDES	LENGTH: 2-1/2 DIA.	LENGTH: 2-1/2 DIA.	
C=.52	C=.61	C=.61	C=.73	C=.82	C=.98

VALUES OF "C" FOR CIRCULAR AND SQUARE ORIFICES

ALL DIMENSIONS ARE IN INCHES (MILLIMETERS) UNLESS OTHERWISE SHOWN.

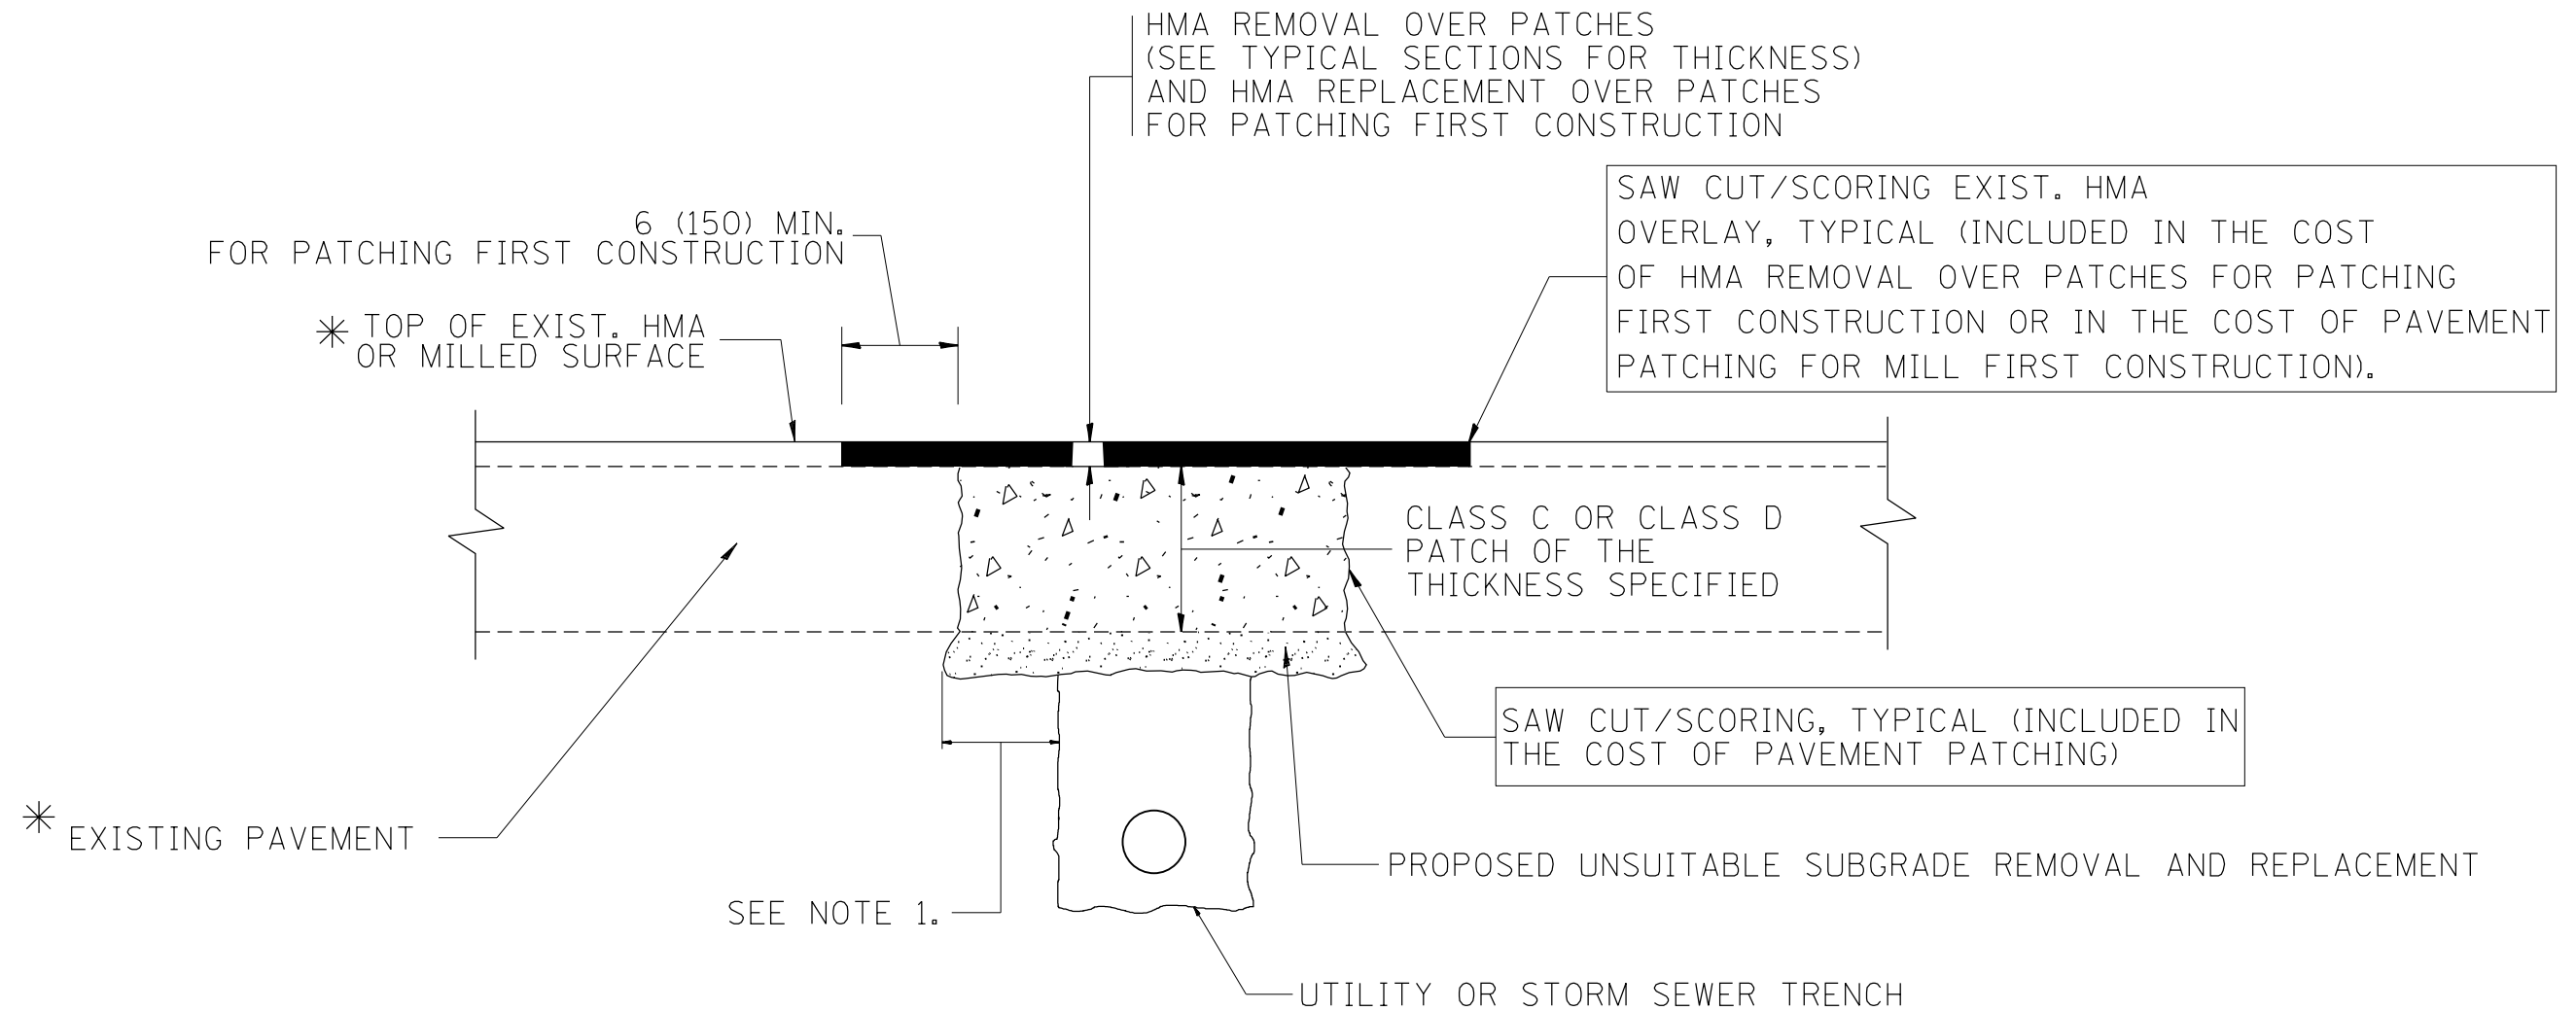

\* SEE TYPICAL SECTIONS FOR THICKNESS AND MATERIALS

**NOTES:**

1. THE WIDTH OF THE FULL DEPTH PATCH OVER A TRENCH SHALL BE 12 (300) WIDER ON EACH SIDE OF THE TRENCH.
2. FOR METHOD OF MEASUREMENT AND BASIS OF PAYMENT, SEE RECURRING SPECIAL PROVISION "PATCHING WITH HOT-MIX ASPHALT OVERLAY REMOVAL".

SEQUENCE OF CONSTRUCTION (PATCHING FIRST)


1. REMOVE THE EXISTING HMA MATERIAL OVER THE AREA TO BE PATCHED.
2. REMOVE AND REPLACE WITH CLASS C OR D PATCH.
3. REPLACE HMA MATERIAL OVER THE AREA TO BE PATCHED.

SEQUENCE OF CONSTRUCTION (MILLING FIRST)

1. MILL HMA FIRST IF THERE IS AT LEAST 4 1/2 INCHES OR MORE OF HMA MATERIAL ON TOP OF THE EXISTING PAVEMENT OR IF THE PAVEMENT IS FULL DEPTH HMA. A MINIMUM OF 2 INCHES OF HMA MATERIAL SHALL BE IN PLACE AFTER MILLING.
2. REMOVE AND REPLACE WITH FULL DEPTH CLASS D PATCHES TO TOP OF MILLED SURFACE.

ALL DIMENSIONS ARE IN INCHES (MILLIMETERS) UNLESS OTHERWISE SHOWN.

FILE NAME =	USER NAME = ldezmar	DESIGNED - R. SHAH	REVISED - A. ABBAS 04-27-98	<b>STATE OF ILLINOIS DEPARTMENT OF TRANSPORTATION</b>	<b>PAVEMENT PATCHING FOR HMA SURFACED PAVEMENT</b>			F.A.P. RTE.	SECTION	COUNTY	TOTAL SHEETS	SHEET NO.
pw\11084EBIDINTEG.illinois.gov\PIWIDOT\Documents\DOT Offices\District 1\Projects\PI4540\Drawings\Design\DistStd.dgn	PLotted SCALE = 100.0000' / 1".	CHECKED -	REVISED - R. BORO 01-01-07					104	105N-4	LAKE	113	87
	PLotted DATE = 8/19/2016	DATE - 10-25-94	REVISED - R. BORO 09-04-07		<b>BD400-04 (BD-22)</b>			<b>CONTRACT NO. 60W06</b>				
			REVISED - K. ENG 10-27-08		SCALE: NONE	SHEET NO. 1 OF 1 SHEETS	STA. TO STA.	FED. ROAD DIST. NO. 1   ILLINOIS   FED. AID PROJECT				

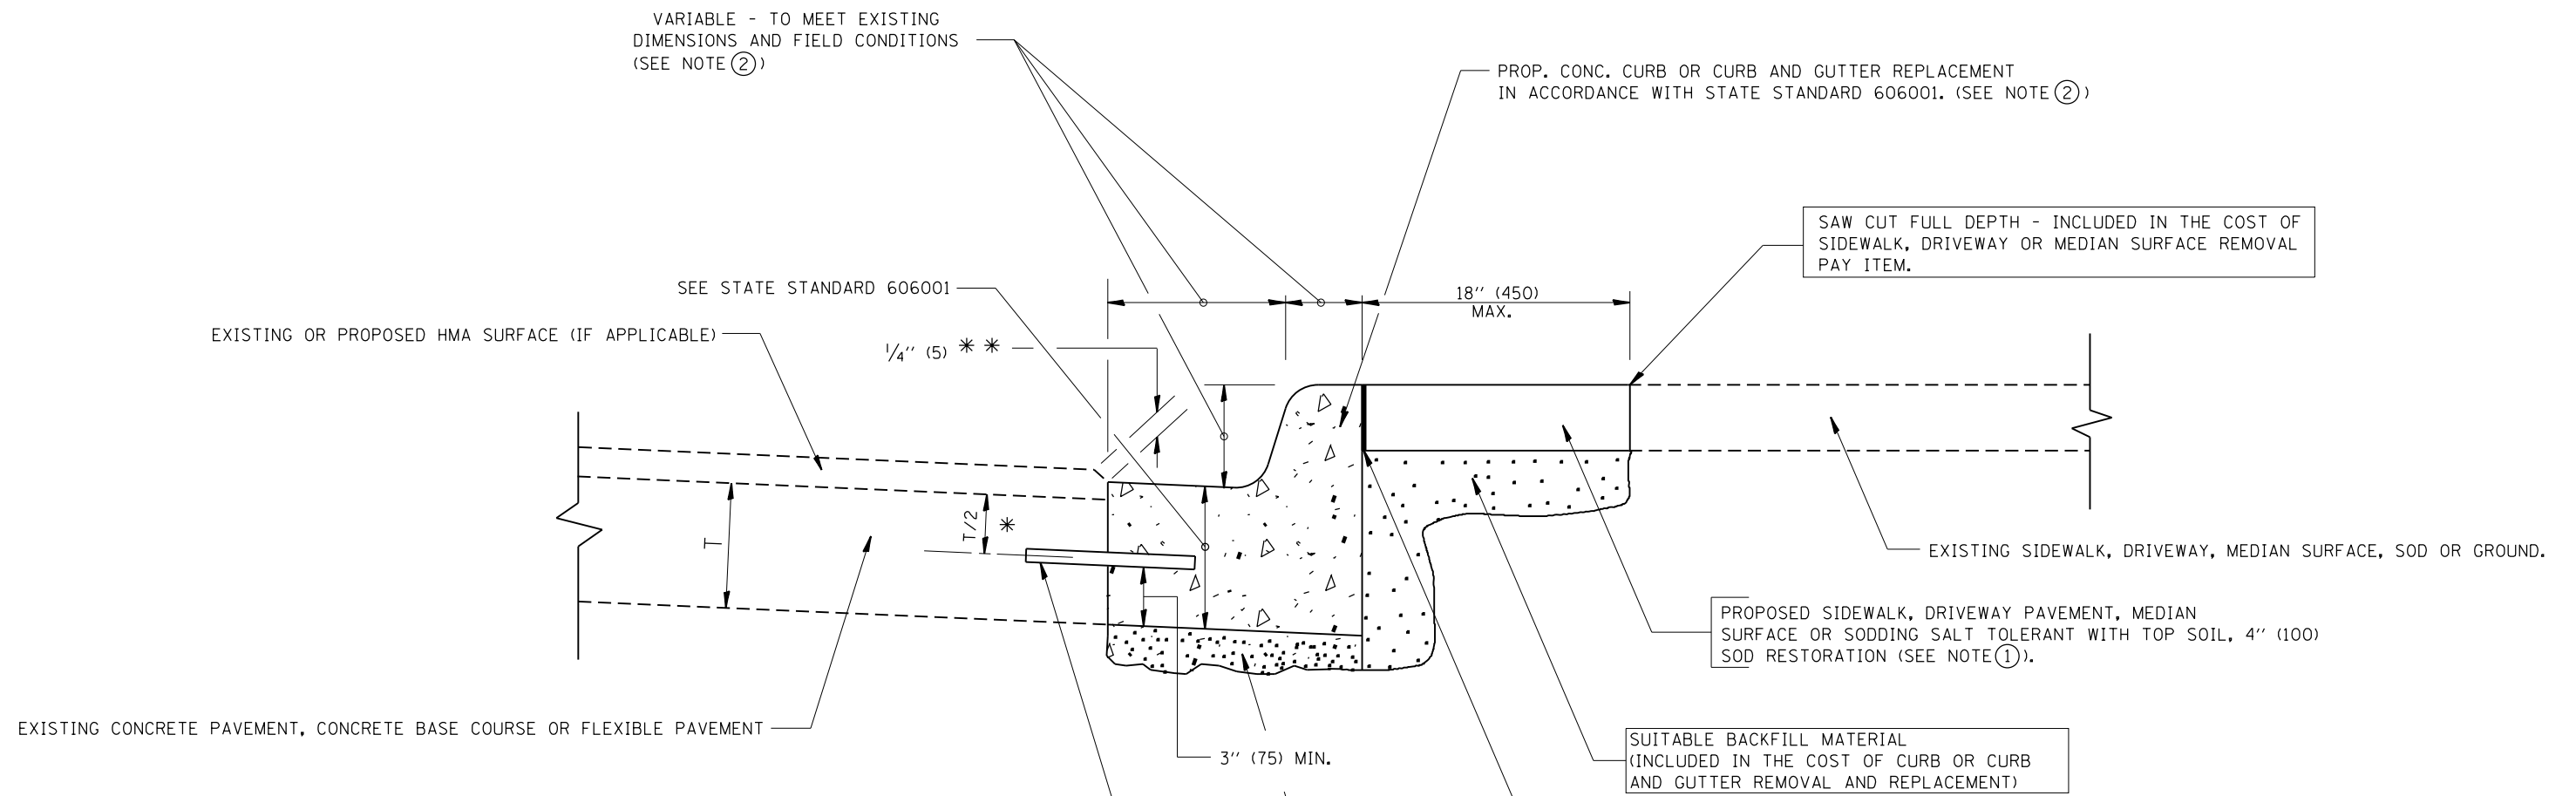

- \* 3" (75) MINIMUM FROM TOP AND BOTTOM OF THE CONCRETE PAVEMENT OR BASE COURSE.
  - \*\* IF THE FINAL SURFACE OF THE PAVEMENT IS CONCRETE, THE GUTTER IS TO BE FLUSH WITH THE PAVEMENT.
- NOTE: ① SIDEWALK, DRIVEWAY PAVEMENT OR MEDIAN SURFACE SHALL BE SIMILAR TO THE MATERIAL BEING REMOVED AND WILL BE PAID FOR SEPARATELY.
- SODDING, SALT TOLERANT AND TOP SOIL, FURNISH AND PLACE 4" WILL BE PAID FOR SEPARATELY.
- ② FERTILIZER FOR THE PLACEMENT OF THE SOD IS NOT REQUIRED
  - ③ CURB OR CURB AND GUTTER REPLACEMENT SHALL MATCH THE SHAPE OF THE EXISTING CURB OR CURB AND GUTTER UNLESS OTHERWISE SPECIFIED.
  - ④ FOR CURB OR CURB AND GUTTER REMOVAL AND REPLACEMENT ADJACENT TO FLEXIBLE PAVEMENT DELETE EPOXY COATED TIE BARS.
  - ⑤ LONGITUDINAL BARS, IF ENCOUNTERED IN THE EXISTING CURB OR CURB AND GUTTER, ARE NOT TO BE REPLACED. CUTTING AND REMOVING LONGITUDINAL BARS SHALL BE INCLUDED IN THE COST OF CURB OR CURB AND GUTTER REMOVAL AND REPLACEMENT.
  - ⑥ THE COST OF HMA SURFACE REMOVAL IN THE EXISTING GUTTER FLAG SHALL BE INCLUDED IN THE COST OF THE CURB AND GUTTER REMOVAL AND REPLACEMENT.
  - ⑦ THE REMOVAL AND REPLACEMENT OF THE EXISTING CURB OR CURB AND GUTTER SHALL BE DONE IN ACCORDANCE WITH THE APPLICABLE PORTIONS OF SECTION 440 AND 606 OF THE STANDARD SPECIFICATIONS.
  - ⑧ THE LOCATIONS OF REMOVAL AND REPLACEMENT OF EXISTING CURB OR CURB AND GUTTER SHALL BE DETERMINED BY THE RESIDENT ENGINEER AT THE TIME OF CONSTRUCTION.

- PROPOSED 3/4" (20) PREFORMED EXPANSION JOINT AT CONCRETE SIDEWALKS, DRIVEWAYS, AND MEDIANS. (INCLUDED IN THE COST OF CURB OR CURB AND GUTTER REMOVAL AND REPLACEMENT.)
- UNSUITABLE SUB-BASE MATERIAL TO BE REMOVED, IF DIRECTED BY THE ENGINEER, SHALL BE REPLACED WITH EITHER SUB-BASE GRANULAR MATERIAL, TYPE B OR ADDITIONAL THICKNESS OF CONCRETE.
- REMOVAL AND REPLACEMENT 4" (100) OR LESS IS INCLUDED IN THE COST OF CURB OR CURB AND GUTTER REMOVAL AND REPLACEMENT.
- REMOVAL AND REPLACEMENT IN EXCESS OF 4" (100) WILL BE PAID FOR IN ACCORDANCE WITH ARTICLE 109.04 OF THE STANDARD SPECIFICATIONS.
- PROPOSED #6 (20) EPOXY COATED TIE BARS 24" (600) LONG AT 24" (600) CENTERS WILL NOT BE PAID FOR SEPARATELY. DELETE EPOXY COATED TIE BARS IF EXISTING TIE BARS ARE USUABLE AS DETERMINED BY THE ENGINEER. (SEE NOTE ③).


**BASIS OF PAYMENT:**  
 THIS WORK WILL BE PAID FOR AT THE CONTRACT UNIT PRICE PER FOOT (METER) FOR "CURB REMOVAL AND REPLACEMENT" OR "COMBINATION CONCRETE CURB AND GUTTER REMOVAL AND REPLACEMENT".

# CURB OR CURB AND GUTTER REMOVAL AND REPLACEMENT


ALL DIMENSIONS ARE IN INCHES (MILLIMETERS) UNLESS OTHERWISE SHOWN.

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			REVISED - A. ABBAS 03-21-97			104	105N-4	LAKE	113	88	
			REVISED - M. GOMEZ 01-22-01			<b>BD600-06 (BD-24)</b>		<b>CONTRACT NO. 60W06</b>			
			REVISED - R. BORO 12-15-09			SCALE: NONE	SHEET NO. 1 OF 1 SHEETS	STA.	TO STA.	FED. ROAD DIST. NO. 1 ILLINOIS FED. AID PROJECT	



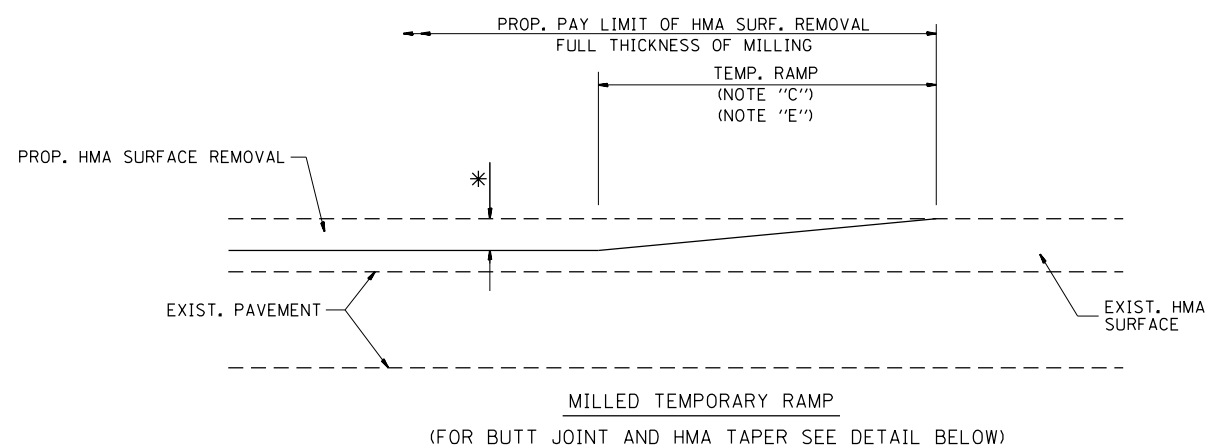


**OPTION 1**

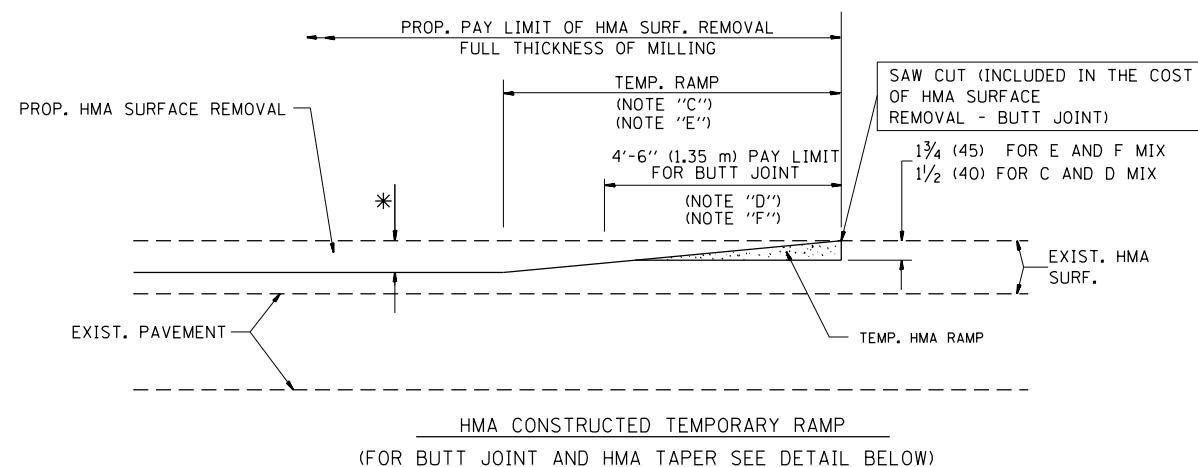


**OPTION 2**

**TYPICAL TEMPORARY RAMP**

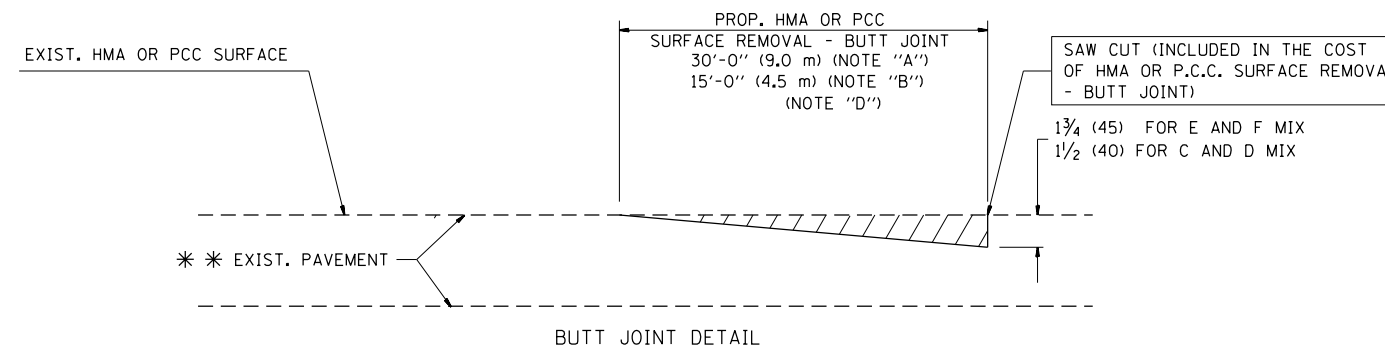

**BUTT JOINT DETAIL**

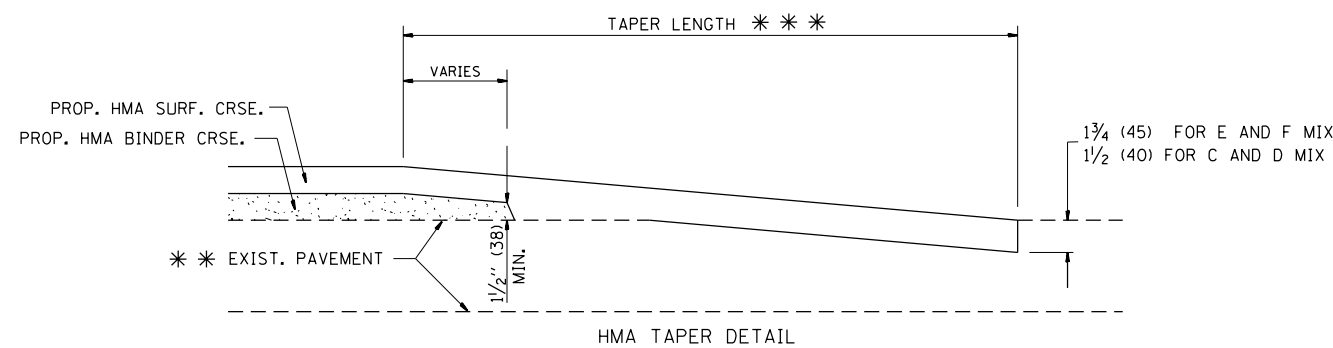

**HMA TAPER DETAIL**

**TYPICAL BUTT JOINT AND HMA TAPER FOR RESURFACING ONLY**

\*\*\* PC CONCRETE, HMA OR HMA RESURFACED PAVEMENT.

**NOTES**

- A: MAINLINE ROADWAYS AND MAJOR SIDE ROADS.
- B: MINOR SIDE ROADS.
- C: THE TEMP. RAMP SHALL BE CONSTRUCTED IMMEDIATELY UPON REMOVAL OF THE EXISTING HMA SURFACE.
- D: THE BUTT JOINT SHALL BE CONSTRUCTED IMMEDIATELY PRIOR TO PLACING THE PROPOSED HMA COURSES.
- E: TAPER THE TEMP. RAMP AT A RATE OF 3'-0" (900 mm) PER 1 INCH (25 mm) OF MILLING THICKNESS.
- F: INSTALLATION AND REMOVAL OF THE 4'-6" (1.35 m) TEMP. RAMP IS INCLUDED IN COST OF HMA SURFACE REMOVAL - BUTT JOINT
- G: SEE ARTICLE 406.08 AND 406.14 OF THE STANDARD SPECIFICATIONS FOR "HMA AND/OR PCC SURFACE REMOVAL, BUTT JOINT".


\* SEE TYPICAL SECTIONS FOR MILLING THICKNESS.

\*\*\* 20'-0" (6.1 m) PER 1 (25) RESURFACING (NOTE "A")  
10'-0" (3.0 m) PER 1 (25) RESURFACING (NOTE "B")

**BASIS OF PAYMENT:**

THE BUTT JOINT WILL BE PAID FOR AT THE CONTRACT UNIT PRICE PER SQUARE YARD (SQUARE METER) FOR "HOT-MIX ASPHALT SURFACE REMOVAL - BUTT JOINT" OR FOR "PORTLAND CEMENT CONCRETE SURFACE REMOVAL - BUTT JOINT".

ALL DIMENSIONS ARE IN INCHES (MILLIMETERS) UNLESS OTHERWISE SHOWN.

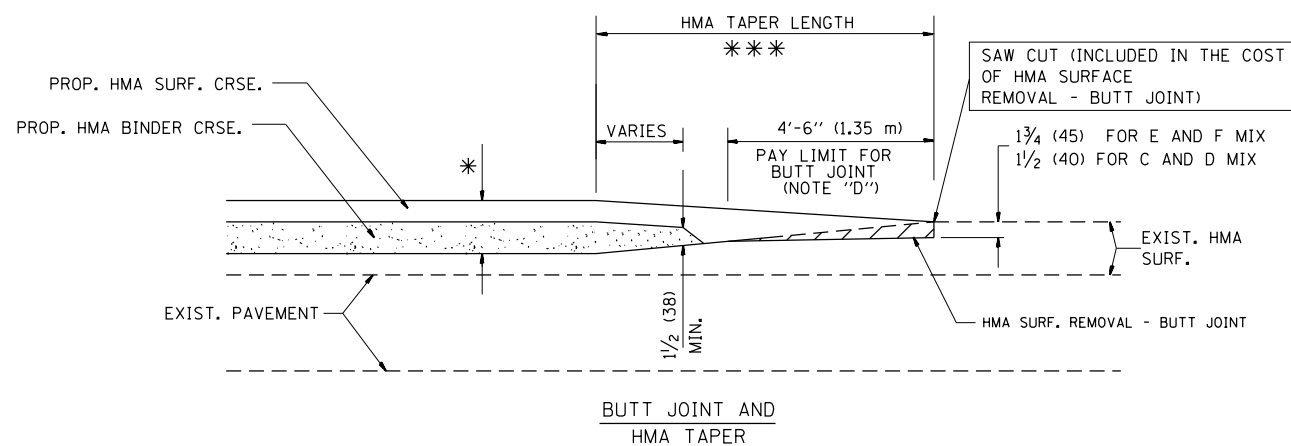

**TYPICAL BUTT JOINT AND HMA TAPER FOR MILLING AND RESURFACING**


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	PLOT DATE = 8/19/2016	DATE - 06-13-90	REVISED - R. BORO 01-01-07

**STATE OF ILLINOIS  
DEPARTMENT OF TRANSPORTATION**

**BUTT JOINT AND  
HMA TAPER DETAILS**

SCALE: NONE SHEET NO. 1 OF 1 SHEETS STA. TO STA.


F.A.P. RTE.	SECTION	COUNTY	TOTAL SHEETS	SHEET NO.
104	105N-4	LAKE	113	89
BD400-05 BD32		CONTRACT NO. 60W06		
FED. ROAD DIST. NO. 1 ILLINOIS FED. AID PROJECT				

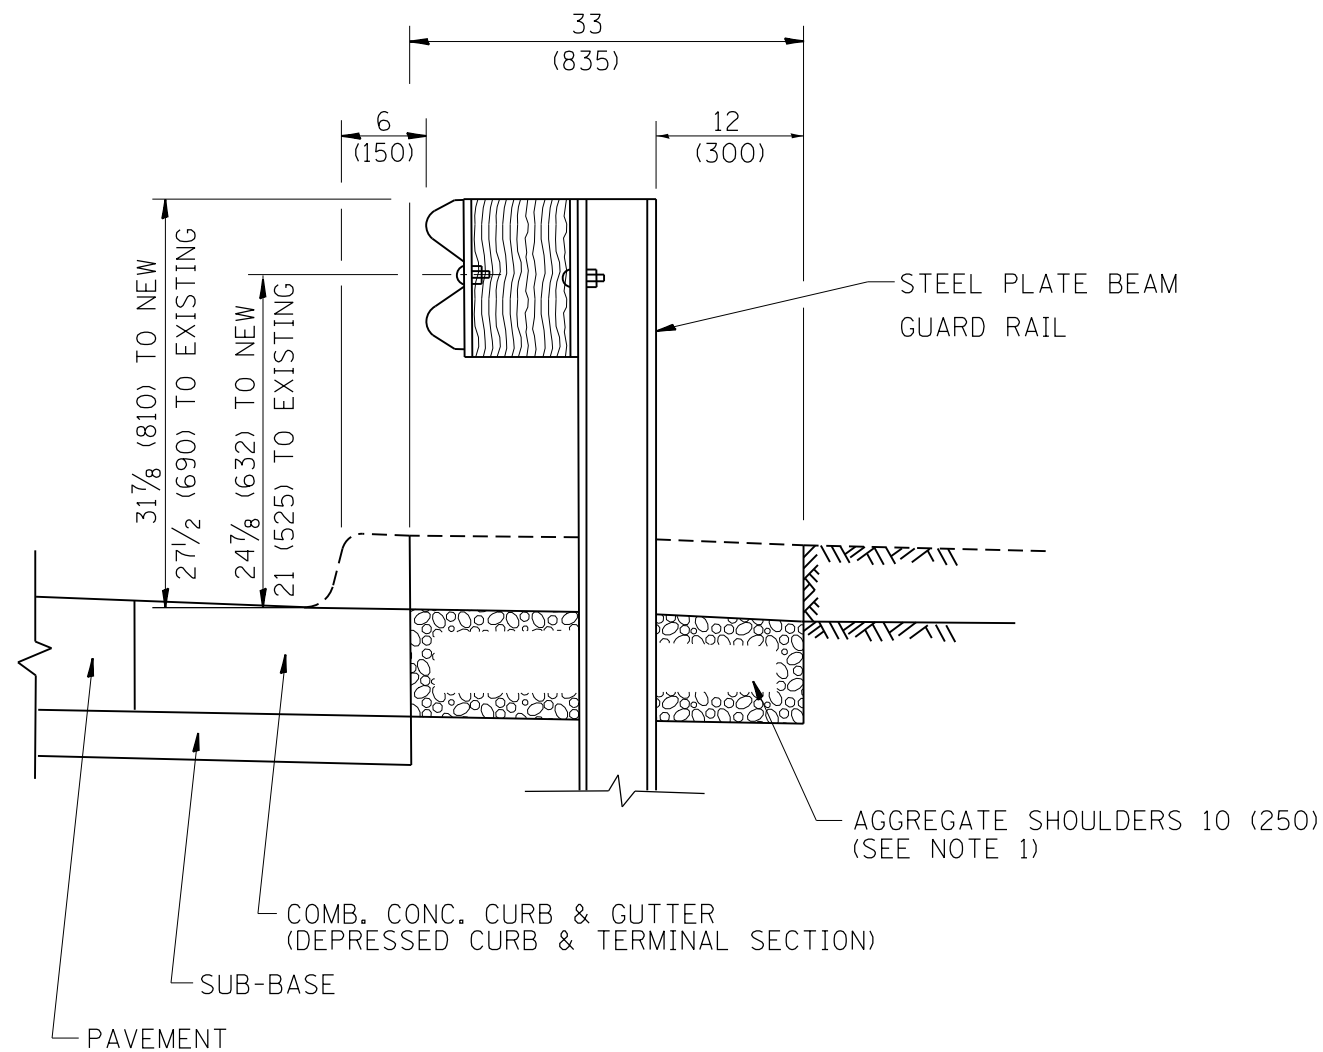

**SECTION A-A**

- NOTES:
1. THE AGGREGATE SHOULDER, 10" OR HMA SHOULDER, 6" (IF REQUIRED) SHALL EXTEND UNDER THE TRAFFIC BARRIER TERMINAL.
  2. "EXISTING" GUARDRAIL REFERS TO CONNECTING TERMINAL SECTION TO GUARD RAILING PRIOR TO THE MIDWEST GUARDRAIL SYSTEM.
  3. THE CONTRACTOR SHALL VERIFY THE TYPE/HEIGHT OF GUARDRAIL IN-PLACE BEFORE ORDERING THE NEW TERMINAL SECTION. COST INCLUDED WITH THE COST OF THE TERMINAL. THE TERMINAL SECTION HEIGHT TO BE PLACED MUST MATCH THE HEIGHT OF THE IN-PLACE GUARDRAIL.

**DETAILS FOR STEEL PLATE BEAM  
GUARD RAIL ADJACENT TO CURB AND GUTTER  
[FOR ROADWAY SPEED 35 MPH (60 kmh) TO 45 MPH (70 kmh)]**

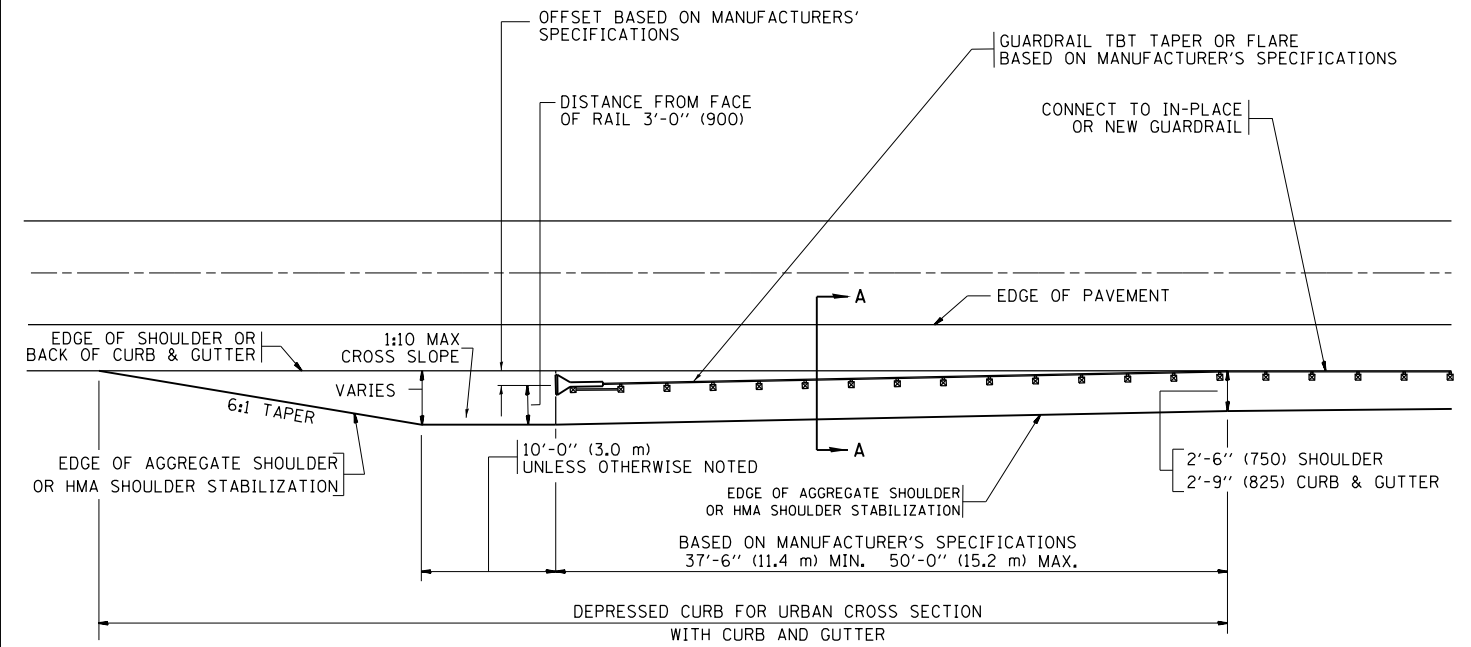

**DEPRESSED CURB AND GUTTER AND  
SHOULDER TREATMENT AT TBT TY. 1 SPL.**

BASIS OF PAYMENT: HMA SHOULDERS 6 (150) (IF REQUIRED) WILL BE PAID FOR AT THE CONTRACT UNIT PRICE PER SQUARE YARD (SQUARE METER) FOR "HOT-MIX ASPHALT SHOULDERS 6" (150 mm)".

STEEL PLATE BEAM GUARD RAIL AND TRAFFIC BARRIER TERMINAL, OF THE TYPE SPECIFIED WILL BE PAID FOR SEPARATELY.

TBT = TRAFFIC BARRIER TERMINAL  
ALL DIMENSIONS ARE IN INCHES (MILLIMETERS) UNLESS OTHERWISE SHOWN.


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		DATE - 09-22-90	REVISED - R. BORO 12-08-2008
			REVISED - R. BORO 09-14-2009

**STATE OF ILLINOIS  
DEPARTMENT OF TRANSPORTATION**

**DETAILS FOR DEPRESSED CURB & GUTTER AND  
SHOULDER TREATMENT AT TBT TY 1 SPL.**

SCALE: NONE SHEET NO. 1 OF 1 SHEETS STA. TO STA.

F.A.P. RTE.	SECTION	COUNTY	TOTAL SHEETS	SHEET NO.
104	105N-4	LAKE	113	90
BD600-10 (BD 34)			CONTRACT NO. 60W06	
FED. ROAD DIST. NO. 1 ILLINOIS FED. AID PROJECT				

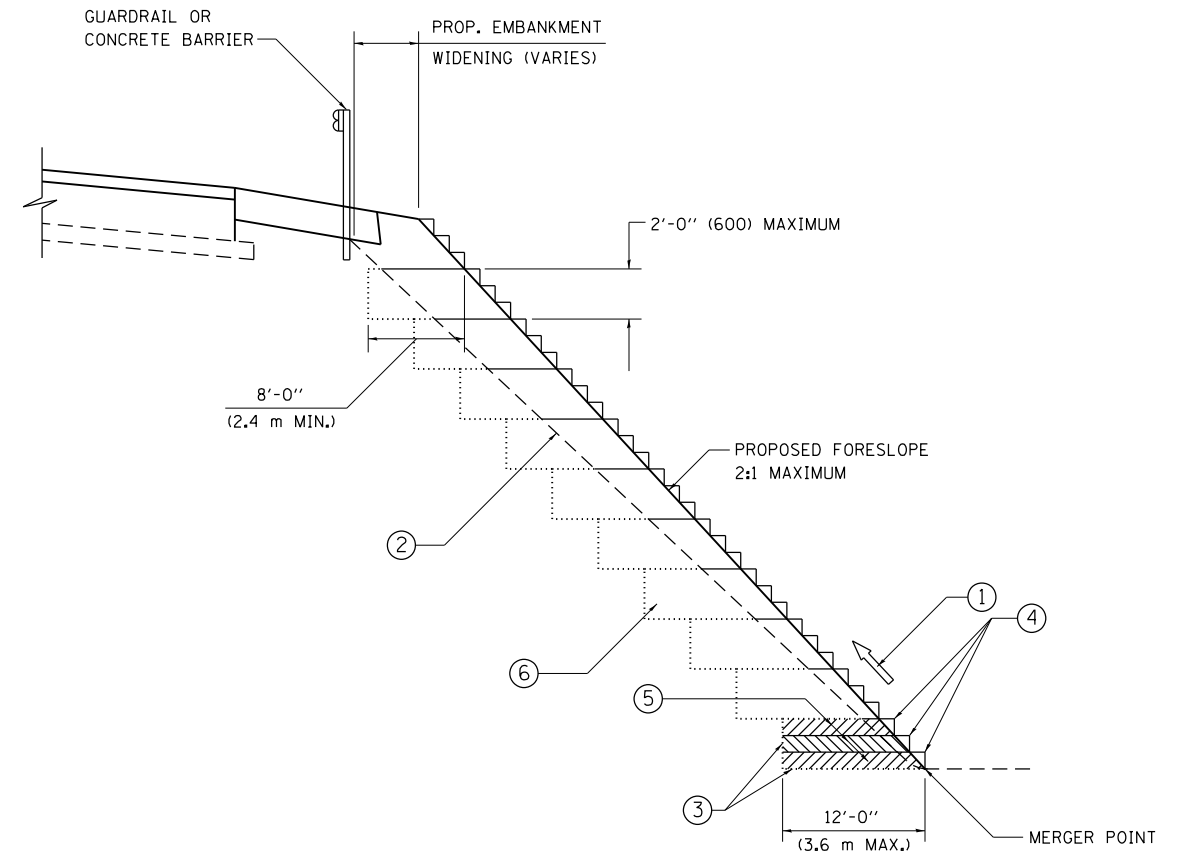

**TYPICAL BENCHING DETAIL  
FOR EMBANKMENT**

**NOTES:**

- ① CONSTRUCT SUCCEEDING BENCH CUTS AND EMBANKMENT PLACEMENT AND COMPACTION FROM BOTTOM TO TOP IN STAIRSTEP FASHION.
- ② EXISTING FORESLOPE PREPARED IN ACCORDANCE WITH ARTICLE 205.03 OF THE STANDARD SPECIFICATIONS.
- ③ BENCH CUT EXISTING SLOPE TYPICAL FOR EACH STEP.
- ④ TRIM TO FINAL SLOPE.
- ⑤ EQUAL 8-INCH (200) LIFTS OF EMBANKMENT COMPACTED IN ACCORDANCE WITH ARTICLE 205.05 OF THE STANDARD SPECIFICATIONS.
- ⑥ EXCAVATION OF BENCH CUTS WITHIN EXISTING EMBANKMENT WILL BE PAID FOR AT THE CONTRACT UNIT PRICE PER CUBIC METER OR CUBIC YARD FOR "EARTH EXCAVATION". THIS PRICE WILL INCLUDE ALL LABOR AND MATERIAL, NO ADDITIONAL COMPENSATION WILL BE ALLOWED.
- ⑦ SLOPES SHALL BE BENCHED ACCORDING TO THIS DETAIL WHEN THE SLOPE IS STEEPER THAN 4:1 AND THE HEIGHT IS GREATER THAN 5' (1.5 m).


ALL DIMENSIONS ARE IN INCHES (MILLIMETERS)  
UNLESS OTHERWISE SHOWN.

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Default	PLOT DATE = 8/19/2016	DATE - 06-16-04	REVISED -

**STATE OF ILLINOIS  
DEPARTMENT OF TRANSPORTATION**

<b>BENCHING DETAIL FOR EMBANKMENT WIDENING</b>			
SCALE:	SHEET	OF SHEETS	STA. TO STA.

F.A.P. RTE.	SECTION	COUNTY	TOTAL SHEETS	SHEET NO.
104	105N-4	LAKE	113	91
<b>BD-51</b>			<b>CONTRACT NO. 60W06</b>	
ILLINOIS FED. AID PROJECT				

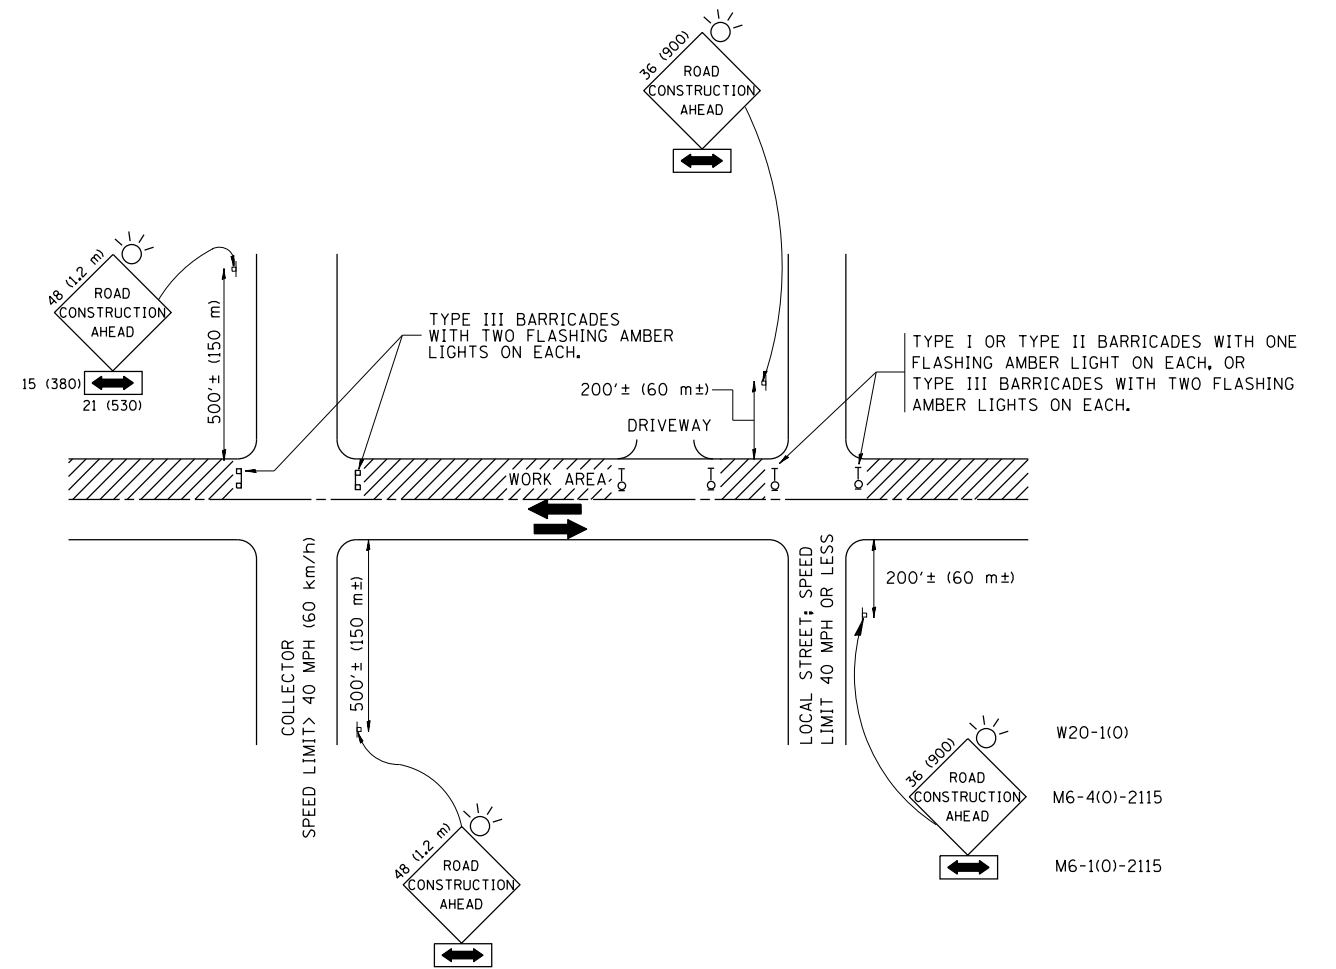

TRAFFIC CONTROL AND PROTECTION FOR SIDE ROADS, INTERSECTIONS, AND DRIVEWAYS

NOTES:

A. FOR NO LANE RESTRICTION ON THE SIDE ROAD OR DRIVEWAYS

1. SIDE ROAD WITH A SPEED LIMIT OF 40 MPH (60 km/h) OR LESS AS SHOWN ON THE DRAWING AND AS DIRECTED BY THE ENGINEER:

a) ONE ROAD CONSTRUCTION AHEAD SIGN 36 x 36 (900x900) WITH A FLASHER AND FLAG MOUNTED ON IT APPROXIMATELY 200' (60 m) IN ADVANCE OF THE MAIN ROUTE.

b) THE CLOSED PORTION OF THE MAIN ROUTE SHALL BE PROTECTED BY BLOCKING WITH TYPE I, TYPE II OR TYPE III BARRICADES, 1/3 OF THE CROSS SECTION OF THE CLOSED PORTION.

2. SIDE ROAD WITH A SPEED LIMIT GREATER THAN 40 MPH (60 km/h) AS SHOWN ON THE DRAWING AND AS DIRECTED BY THE ENGINEER:

a) ONE ROAD CONSTRUCTION AHEAD SIGN 48 x 48 (1.2 m x 1.2 m) WITH A FLASHER MOUNTED ON IT APPROXIMATELY 500' (150 m) IN ADVANCE OF THE MAIN ROUTE.

b) THE CLOSED PORTION OF THE MAIN ROUTE SHALL BE PROTECTED BY BLOCKING WITH TYPE III BARRICADES, 1/2 OF THE CROSS SECTION OF THE CLOSED PORTION.

3. WHEN THE SIDE ROAD LIES BETWEEN THE BEGINNING OF THE MAINLINE SIGNING AND THE WORK ZONE, A SINGLE HEADED ARROW (M6-1) SHALL BE USED IN LIEU OF THE DOUBLE HEADED ARROW (M6-4).

B. FOR A LANE CLOSURE ON A SIDE ROAD OR DRIVEWAY:

USE APPLICABLE PORTIONS OF THE TYPICAL APPLICATION OF TRAFFIC CONTROL DEVICES (STD. 701501, STD. 701606 OR THE APPROPRIATE STANDARD). THE SPACING OF SIGNS AND BARRICADES SHALL BE ADJUSTED FOR FIELD CONDITIONS AS DIRECTED BY THE ENGINEER. THE DIRECTIONAL ARROW SHALL BE COVERED OR REMOVED WHEN NO LONGER CONSISTENT WITH THE SIDE ROAD LANE CLOSURE.

C. ADVANCE WARNING SIGNS ARE TO BE OMITTED ON DRIVEWAY UNLESS OTHERWISE NOTED.

D. THE TRAFFIC CONTROL AND PROTECTION FOR SIDE ROADS, INTERSECTIONS, AND DRIVEWAYS SHALL BE INCIDENTAL TO THE COST OF SPECIFIED TRAFFIC CONTROL STANDARDS OR ITEMS.

All dimensions are in millimeters (inches) unless otherwise shown.


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	PLOT SCALE = 100.0000' / in.	CHECKED -	REVISED - A. HOUSEH 10-15-96
	PLOT DATE = 8/19/2016	DATE - 06-89	REVISED - T. RAMMACH 01-06-00

STATE OF ILLINOIS  
DEPARTMENT OF TRANSPORTATION

TRAFFIC CONTROL AND PROTECTION FOR  
SIDE ROADS, INTERSECTIONS, AND DRIVEWAYS


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F.A.P. RTE.	SECTION	COUNTY	TOTAL SHEETS	SHEET NO.
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TC-10			CONTRACT NO. 60W06	
FED. ROAD DIST. NO. 1 ILLINOIS FED. AID PROJECT				

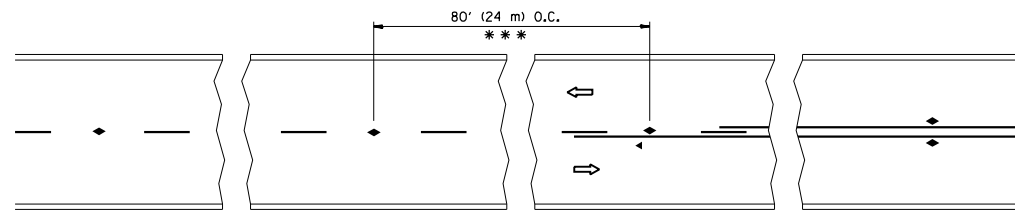


\*\*\* REDUCE TO 40' (12 m) O.C. ON CURVES WITH POSTED OR ADVISORY SPEED 45 M.P.H. (70 km/h) OR LESS.


TWO-LANE/TWO-WAY

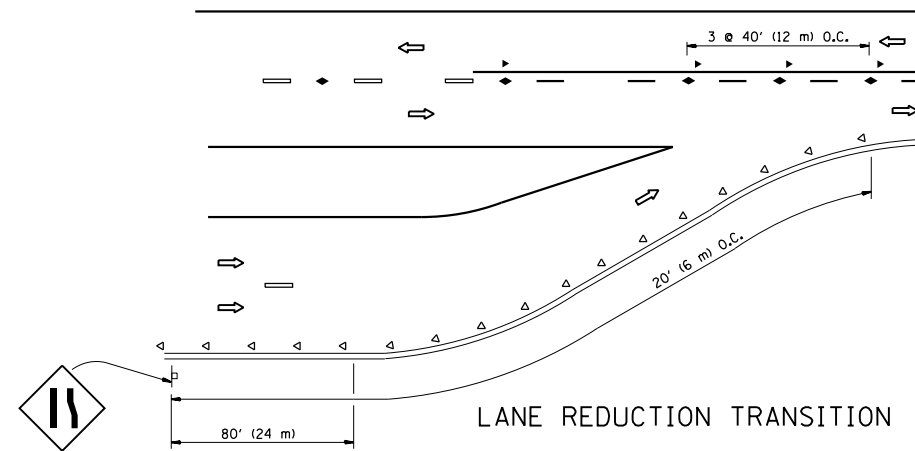


LANE REDUCTION TRANSITION

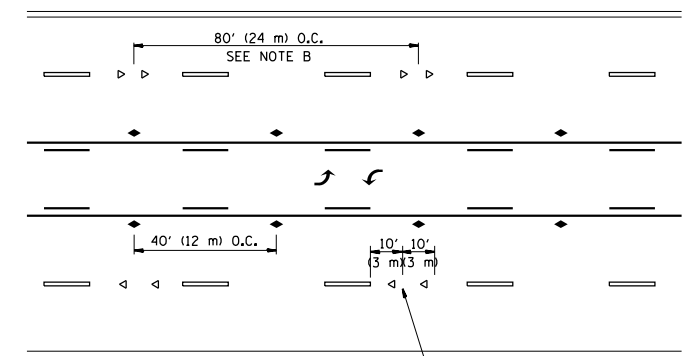

TWO-WAY LEFT TURN

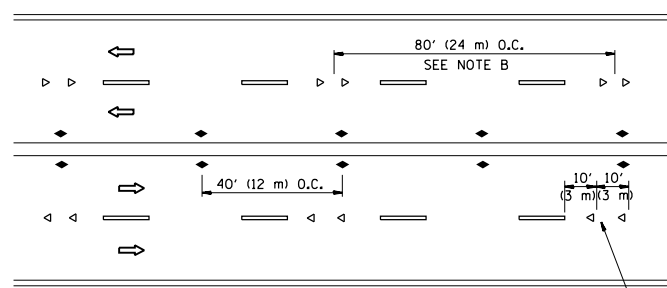

MULTI-LANE/UNDIVIDED

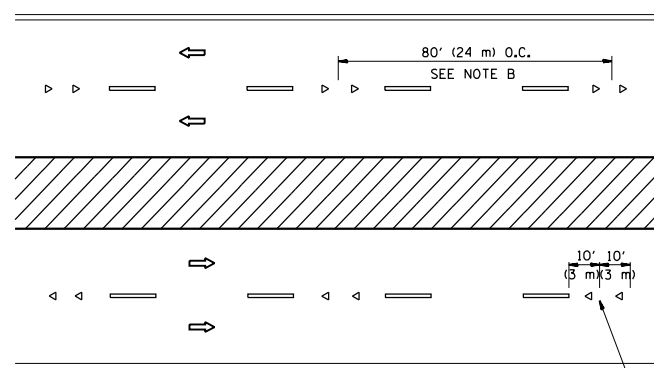

MULTI-LANE/DIVIDED

GENERAL NOTES

1. MARKERS USED WITH DASHED LINES SHALL BE CENTERED IN THE GAP BETWEEN SEGMENTS.
2. MARKERS USED ADJACENT TO SOLID LINES SHALL BE OFFSET 2 TO 3 (50 TO 75) TOWARD TRAFFIC AS SHOWN.
3. MARKERS THROUGH TANGENTS LESS THAN 500' (150 m) IN LENGTH BETWEEN CURVES SHALL BE INSTALLED AT THE LESSER OF THE TWO CURVE SPACINGS.

SYMBOLS


- YELLOW STRIPE
- WHITE STRIPE
- ◀ ONE-WAY AMBER MARKER
- ◁ ONE-WAY CRYSTAL MARKER (W/O)
- ◆ TWO-WAY AMBER MARKER

LANE MARKER NOTES

- A. USE DOUBLE LANE LINE MARKERS SPACED AS SHOWN.
- B. REDUCE TO 40' (12 m) O.C. ON CURVES WHERE ADVISORY SPEEDS ARE 10 M.P.H (20 km/h) LOWER THAN POSTED SPEEDS.

DESIGN NOTES

1. DOUBLE LANE LINE MARKERS SHALL BE USED UNLESS SPECIFIED OTHERWISE.
2. EXCEPT AS SHOWN ON THE LANE REDUCTION TRANSITION AND FREEWAY EXIT RAMP DETAIL, MARKERS ARE NOT TO BE SPECIFIED ON RIGHT EDGE LINES.
3. THE EXACT MARKER LIMITS, SPACING, AND COLOR SHALL BE INCLUDED IN THE PLANS WHEN STANDARD SPECIFICATIONS ARE NOT BEING USED.
4. MARKERS SHOULD NOT BE USED ALONGSIDE CURBS EXCEPT FOR EXTREMELY SHORT SECTIONS OF CURBS WHERE NOT MORE THAN TWO MARKERS WOULD BE INVOLVED.

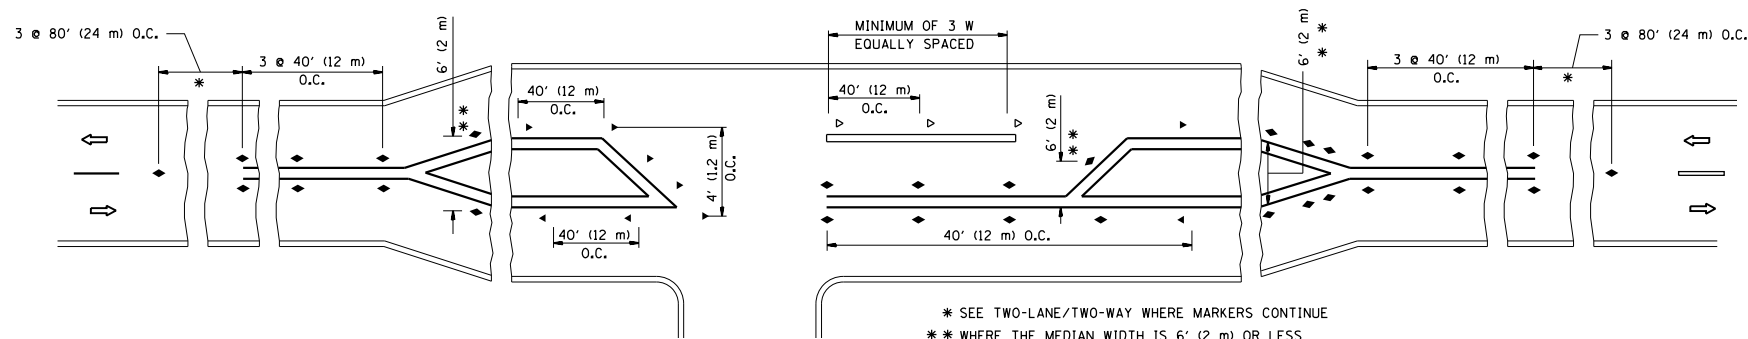

LEFT TURN


All dimensions are in inches (millimeters) unless otherwise shown.

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		DATE -	REVISED - T. RAMMACHER 01-06-00
			REVISED - C. JUCIUS 09-09-09


STATE OF ILLINOIS  
DEPARTMENT OF TRANSPORTATION

TYPICAL APPLICATIONS			
RAISED REFLECTIVE PAVEMENT MARKERS (SNOW-PLOW RESISTANT)			
SCALE: NONE	SHEET NO. 1 OF 1 SHEETS	STA.	TO STA.


F.A.P. RTE.	SECTION	COUNTY	TOTAL SHEETS	SHEET NO.
104	105N-4	LAKE	113	93
TC-11			CONTRACT NO. 60W06	
FED. ROAD DIST. NO. 1 ILLINOIS FED. AID PROJECT				

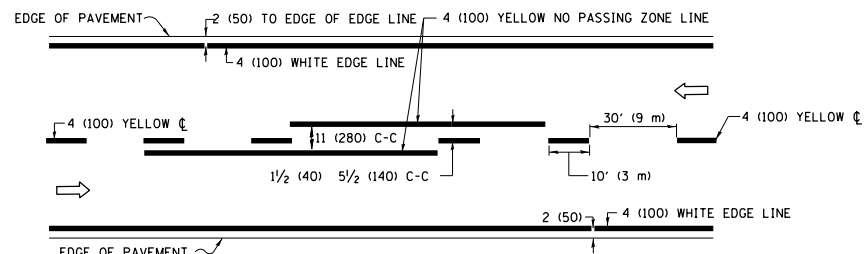

**2-LANE ROADWAY**

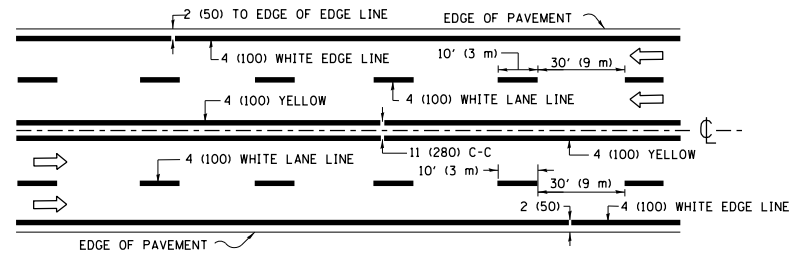


**MULTI-LANE UNDIVIDED**

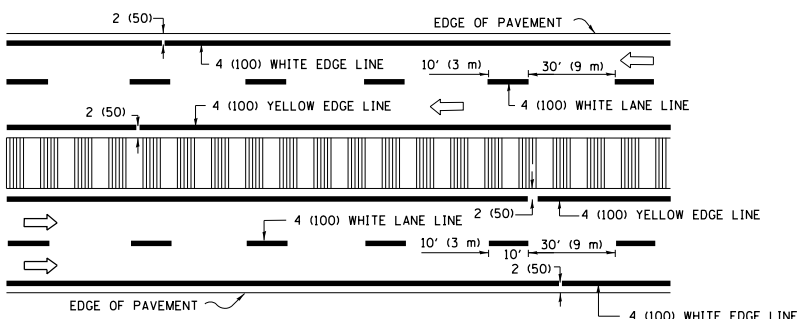


**MULTI-LANE DIVIDED WITH MEDIAN**

**TYPICAL LANE AND EDGE LINE MARKING**

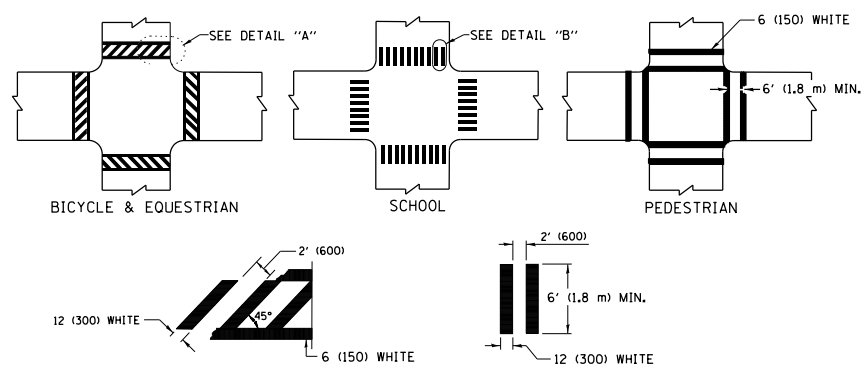


**TYPICAL CROSSWALK MARKING**

\* MARKINGS SHALL BE INSTALLED PARALLEL TO THE CENTERLINE OF THE ROAD WHICH IT CROSSES

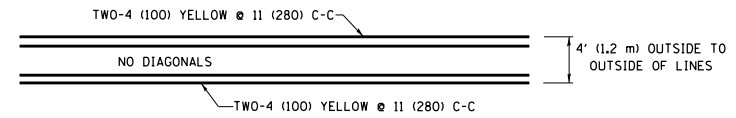


**4' (1.2 m) WIDE MEDIANS ONLY**

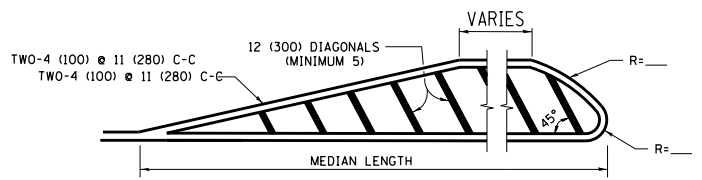


**MEDIANS OVER 4' (1.2 m) WIDE**

DIAGONAL LINE SPACING: 50' (15 m) C-C (LESS THAN 30MPH (50 km/h))  
75' (25 m) C-C 30MPH (50 km/h) TO 45MPH (70 km/h)  
150' (45 m) C-C (MORE THAN 45MPH (70 km/h))

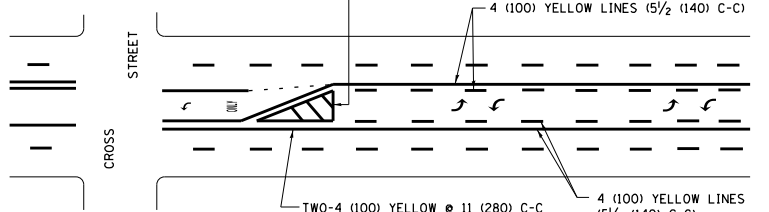


**MEDIAN WITH TWO-WAY LEFT TURN LANE TYPICAL PAINTED MEDIAN MARKING**

A MINIMUM OF TWO PAIRS OF TURN ARROWS SHALL BE USED, WHITE IN COLOR. ADDITIONAL PAIRS SHALL BE PLACED AT 200' (60 m) TO 300' (90 m) INTERVALS.

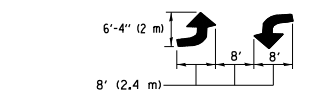


**TYPICAL LEFT (OR RIGHT) TURN LANE TYPICAL TURN LANE MARKING**


FULL SIZE LETTERS 8' (2.4 m) AND ARROWS SHALL BE USED.  
AREA = 15.6 SQ. FT. (1.5 m<sup>2</sup>) ONLY AREA = 20.8 SQ. FT. (1.9 m<sup>2</sup>)  
\* TURN LANES IN EXCESS OF 400' (120 m) IN LENGTH MAY HAVE AN ADDITIONAL SET OF ARROW - "ONLY" INSTALLED MIDWAY BETWEEN THE OTHER TWO SETS OF ARROW - "ONLY".

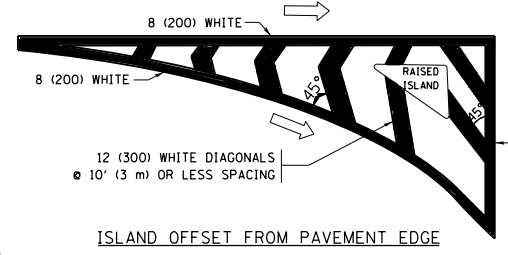


**ISLAND OFFSET FROM PAVEMENT EDGE**

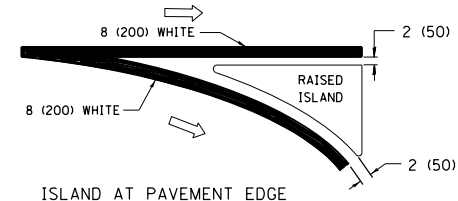

**ISLAND AT PAVEMENT EDGE TYPICAL ISLAND MARKING**

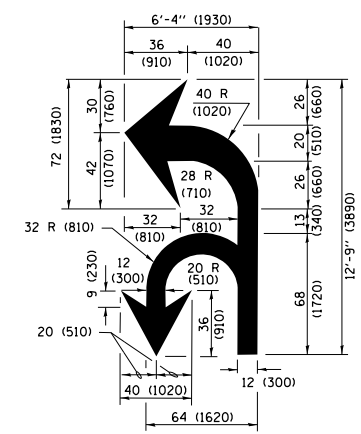

**COMBINATION LEFT AND U-TURN**

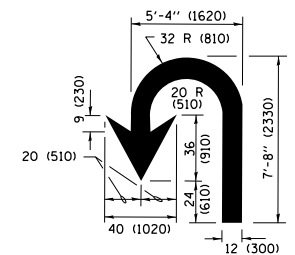

**U-TURN**

**LANE REDUCTION TRANSITION**

\* LANE REDUCTION ARROWS REQUIRED AT SPEEDS OF 45 MPH OR GREATER OR WHEN SPECIFIED IN PLANS.

D(FT)	SPEED LIMIT
345	30
425	35
500	40
580	45
665	50
750	55

TYPE OF MARKING	WIDTH OF LINE	PATTERN	COLOR	SPACING /REMARKS
CENTERLINE ON 2 LANE PAVEMENT	4 (100)	SKIP-DASH	YELLOW	10' (3 m) LINE WITH 30' (9 m) SPACE
CENTERLINE ON MULTI-LANE UNDIVIDED PAVEMENT	2 @ 4 (100)	SOLID	YELLOW	11 (280) C-C
NO PASSING ZONE LINES FOR ONE DIRECTION FOR BOTH DIRECTIONS	4 (100) 2 @ 4 (100)	SOLID SOLID	YELLOW YELLOW	5/2 (140) C-C FROM SKIP-DASH CENTERLINE 11 (280) C-C OMIT SKIP-DASH CENTERLINE BETWEEN
LANE LINES	4 (100) 5 (125) ON FREEWAYS	SKIP-DASH SKIP-DASH	WHITE WHITE	10' (3 m) LINE WITH 30' (9 m) SPACE
DOTTED LINES (EXTENSIONS OF CENTER, LANE OR TURN LANE MARKINGS)	SAME AS LINE BEING EXTENDED	SKIP-DASH	SAME AS LINE BEING EXTENDED	2' (600) LINE WITH 6' (1.8 m) SPACE
EDGE LINES	4 (100)	SOLID	YELLOW-LEFT WHITE-RIGHT	OUTLINE MEDIANS IN YELLOW
TURN LANE MARKINGS	6 (150) LINE; FULL SIZE LETTERS & SYMBOLS (8' (2.4m))	SOLID	WHITE	SEE TYPICAL TURN LANE MARKING DETAIL
TWO WAY LEFT TURN MARKING	2 @ 4 (100) EACH DIRECTION 8' (2.4m) LEFT ARROW	SKIP-DASH AND SOLID IN PAIRS	YELLOW WHITE	10' (3 m) LINE WITH 30' (9 m) SPACE FOR SKIP-DASH; 5/2 (140) C-C BETWEEN SOLID LINE AND SKIP-DASH LINE SEE TYPICAL TWO-WAY LEFT TURN MARKING DETAIL
CROSSWALK LINES (PEDESTRIAN) A. DIAGONALS (BIKE & EQUESTRIAN) B. LONGITUDINAL BARS (SCHOOL)	2 @ 6 (150) 12 (300) @ 45° 12 (300) @ 90°	SOLID SOLID SOLID	WHITE WHITE WHITE	NOT LESS THAN 6' (1.8 m) APART 2' (600) APART 2' (600) APART SEE TYPICAL CROSSWALK MARKING DETAILS.
STOP LINES	24 (600)	SOLID	WHITE	PLACE 4' (1.2 m) IN ADVANCE OF AND PARALLEL TO CROSSWALK, IF PRESENT, OTHERWISE, PLACE AT DESIRED STOPPING POINT, PARALLEL TO CROSSROAD CENTERLINE, WHERE POSSIBLE.
PAINTED MEDIANS	2 @ 4 (100) WITH 12 (300) DIAGONALS @ 45° NO DIAGONALS USED FOR 4' (1.2 m) WIDE MEDIANS	SOLID	YELLOW; TWO WAY TRAFFIC WHITE; ONE WAY TRAFFIC	11 (280) C-C FOR THE DOUBLE LINE SEE TYPICAL PAINTED MEDIAN MARKING.
GORE MARKING AND CHANNELIZING LINES	8 (200) WITH 12 (300) DIAGONALS @ 45°	SOLID	WHITE	DIAGONALS: 15' (4.5 m) C-C (LESS THAN 30MPH (50 km/h)) 20' (6 m) C-C 30MPH (50 km/h) TO 45MPH (70 km/h) 30' (9 m) C-C (OVER 45MPH (70 km/h))
RAILROAD CROSSING	24 (600) TRANSVERSE LINES; "RR" IS 6' (1.8 m) LETTERS; 16 (400) LINE FOR "X"	SOLID	WHITE	SEE STATE STANDARD 780001 AREA OF: "R"=3.6 SQ. FT. (0.33 m <sup>2</sup> ) EACH "X"=54.0 SQ. FT. (5.0 m <sup>2</sup> )
SHOULDER DIAGONALS (REQUIRED FOR SHOULDERS ≥ 8')	12 (300) @ 45°	SOLID	WHITE - RIGHT YELLOW - LEFT	50' (15 m) C-C (LESS THAN 30MPH (50 km/h)) 75' (25 m) C-C (30 MPH (50 km/h) TO 45MPH (70 km/h)) 150' (45 m) C-C (OVER 45MPH (70 km/h))
U TURN ARROW	SEE DETAIL	SOLID	WHITE	16.3 SF
2 ARROW COMBINATION LEFT AND U TURN	SEE DETAIL	SOLID	WHITE	30.4 SF

FOR FURTHER DETAILS ON PAVEMENT MARKING REFER TO STANDARD SPECIFICATIONS FOR ROAD AND BRIDGE CONSTRUCTION AND STATE STANDARD 780001.


All dimensions are in inches (millimeters) unless otherwise shown.

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Default	PLOT SCALE = 100.0000' / in.	DATE - 03-19-90	REVISED - C. JUCIUS 12-21-15
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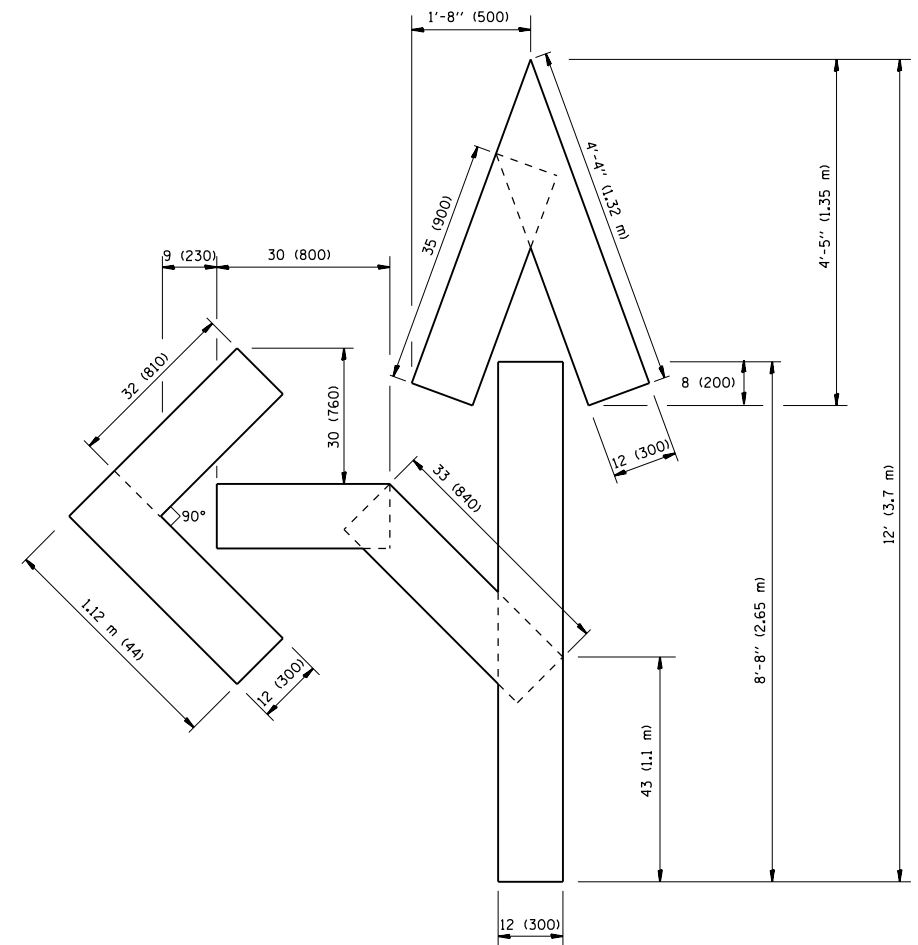
**STATE OF ILLINOIS DEPARTMENT OF TRANSPORTATION**

<b>DISTRICT ONE TYPICAL PAVEMENT MARKINGS</b>			
SCALE: NONE	SHEET 1	OF 1 SHEETS	STA. TO STA.


F.A.P. RTE.	SECTION	COUNTY	TOTAL SHEETS	SHEET NO.
104	105N-4	LAKE	113	94
<b>TC-13</b>		<b>CONTRACT NO. 60W06</b>	ILLINOIS FED. AID PROJECT	

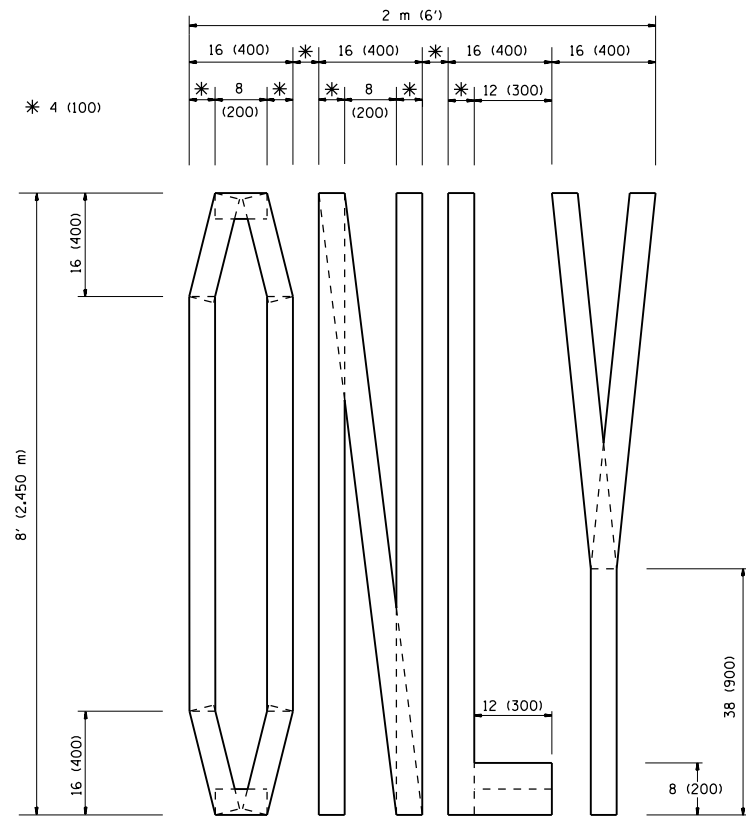

QUANTITY  
 4 (100) LINE = 64.1 ft. (19.7 m)  
 21.1 sq. ft. (1.97 sq. m)



QUANTITY  
 4 (100) LINE = 82.5 ft. (25.3 m)  
 27.5 sq. ft. (2.53 sq. m)

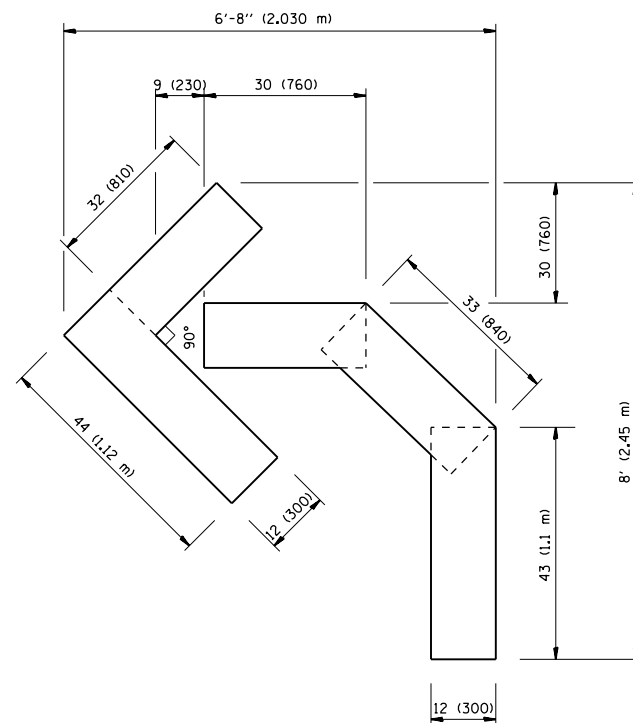

QUANTITY  
 4 (100) LINE = 45.5 ft. (13.9 m)  
 15.2 sq. ft. (1.39 sq. m)

All dimensions are in inches (millimeters) unless otherwise shown.

FILE NAME =	USER NAME = ledznm	DESIGNED -	REVISED -T. RAMMACHER 06-05-96
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		DATE - 09-18-94	REVISED -T. RAMMACHER 03-02-98
			REVISED -E. GOMEZ 08-28-00

STATE OF ILLINOIS  
 DEPARTMENT OF TRANSPORTATION

PAVEMENT MARKING LETTERS AND SYMBOLS  
 FOR TRAFFIC STAGING

SCALE: NONE SHEET NO. 1 OF 1 SHEETS STA. TO STA.

F.A.P. RTE.	SECTION	COUNTY	TOTAL SHEETS	SHEET NO.
104	105N-4	LAKE	113	95
TC-16			CONTRACT NO. 60W06	
FED. ROAD DIST. NO. 1 ILLINOIS FED. AID PROJECT				

**ROUTE MARKERS**

FOR U.S. ROUTES  
M1-40-2424

FOR ILLINOIS ROUTES  
M1-50-2424

R.R., UNMARKED ROUTES  
SPECIAL 24" x 18" VARIABLE  
4" BLACK LETTERS ON WHITE  
REFLECTIVE BACKGROUND

**ARROWS SIGNS**

M5-1L-2115

M5-1R-2115

M6-1-2115

M6-1-2115

M6-3-2115

**CARDINAL DIRECTION & DETOUR SIGNS**


NORTH M3-1-2412

EAST M3-2-2412

SOUTH M3-3-2412

WEST M3-4-2412


DETOUR M4-8-2412

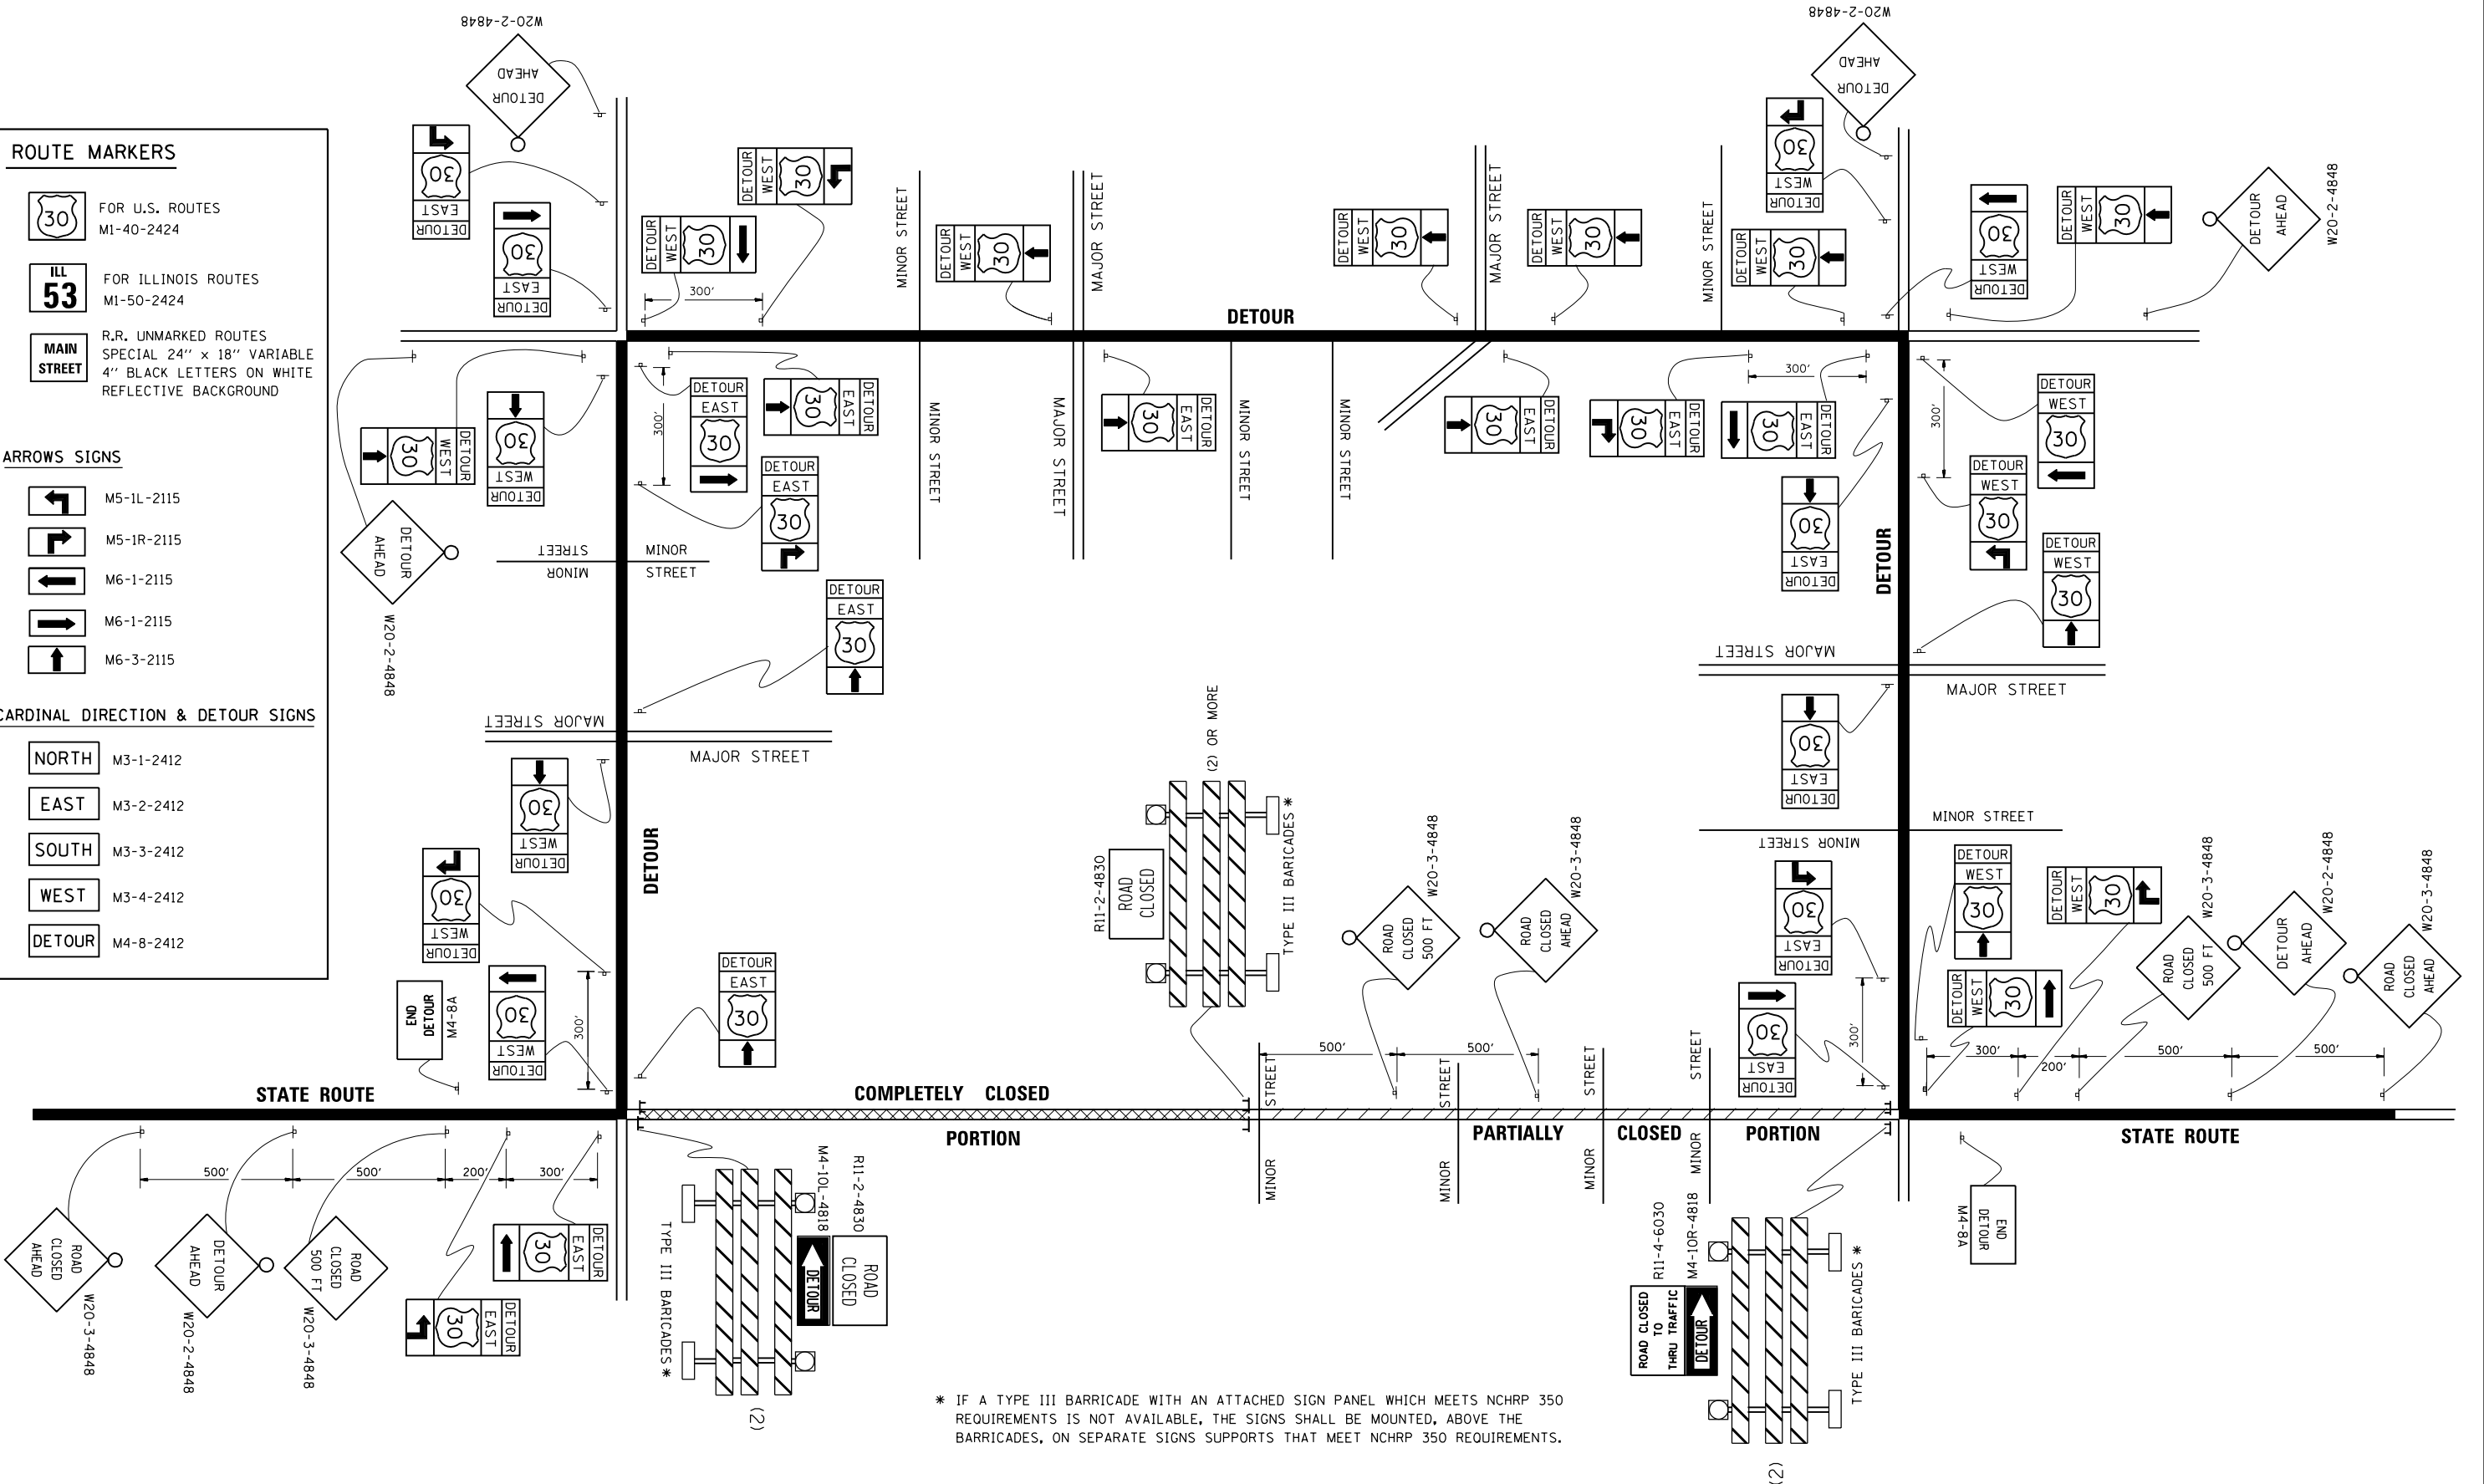

\* IF A TYPE III BARRICADE WITH AN ATTACHED SIGN PANEL WHICH MEETS NCHRP 350 REQUIREMENTS IS NOT AVAILABLE, THE SIGNS SHALL BE MOUNTED, ABOVE THE BARRICADES, ON SEPARATE SIGNS SUPPORTS THAT MEET NCHRP 350 REQUIREMENTS.

FILE NAME =	USER NAME = ledznmrm	DESIGNED -	REVISED - 10-18-02	<b>STATE OF ILLINOIS DEPARTMENT OF TRANSPORTATION</b>	<b>DETOUR SIGNING FOR CLOSING STATE HIGHWAYS</b>			F.A.P. RTE.	SECTION	COUNTY	TOTAL SHEETS	SHEET NO.	
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		DATE -	REVISED -						<b>TC-21</b>		<b>CONTRACT NO. 60W06</b>		
			REVISED -						FED. ROAD DIST. NO. 1 ILLINOIS FED. AID PROJECT				



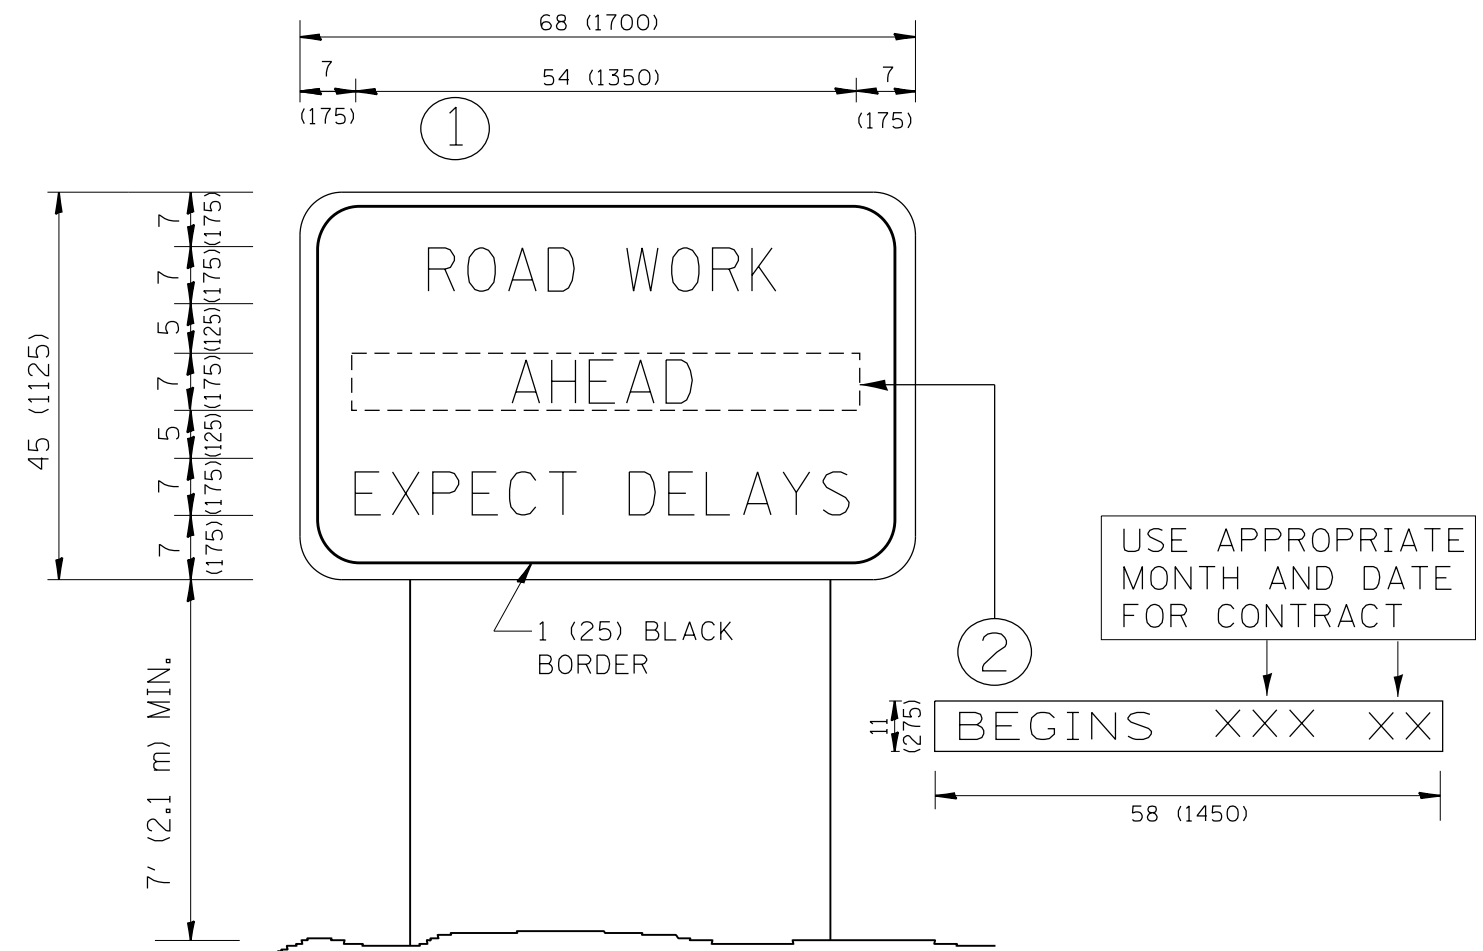

**NOTES:**

1. USE BLACK LETTERING ON ORANGE BACKGROUND.
2. ERECT SIGNS IN ADVANCE OF THE LOCATION FOR THE "ROAD CONSTRUCTION AHEAD" SIGN AT LOCATIONS AS DIRECTED BY THE ENGINEER.
3. ERECT SIGN ① WITH INSTALLED PANEL ② ONE WEEK PRIOR TO THE START OF CONSTRUCTION.
4. REMOVE PANEL ② SOON AFTER THE START OF CONSTRUCTION.
5. SEE SPECIAL PROVISION FOR "TEMPORARY INFORMATION SIGNING" FOR ADDITIONAL INFORMATION.
6. ONE SIGN ASSEMBLY EQUALS 25.70 SQ. FT. (2.3 SQ. M.)
7. SHALL BE PAID FOR AS TEMPORARY INFORMATION SIGNING.

ALL DIMENSIONS ARE IN INCHES (MILLIMETERS) UNLESS OTHERWISE SHOWN.


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		PLOT SCALE = 100.0000' / 1in.	REVISED - T. RAMMACHER 02-02-99
		PLOT DATE = 8/19/2016	REVISED - C. JUCIUS 01-31-07

**STATE OF ILLINOIS  
DEPARTMENT OF TRANSPORTATION**

**ARTERIAL ROAD  
INFORMATION SIGN**

SCALE: NONE SHEET NO. 1 OF 1 SHEETS STA. TO STA.

F.A.P. RTE.	SECTION	COUNTY	TOTAL SHEETS	SHEET NO.
104	105N-4	LAKE	113	97
TC-22			CONTRACT NO. 60W06	
FED. ROAD DIST. NO. 1   ILLINOIS FED. AID PROJECT				

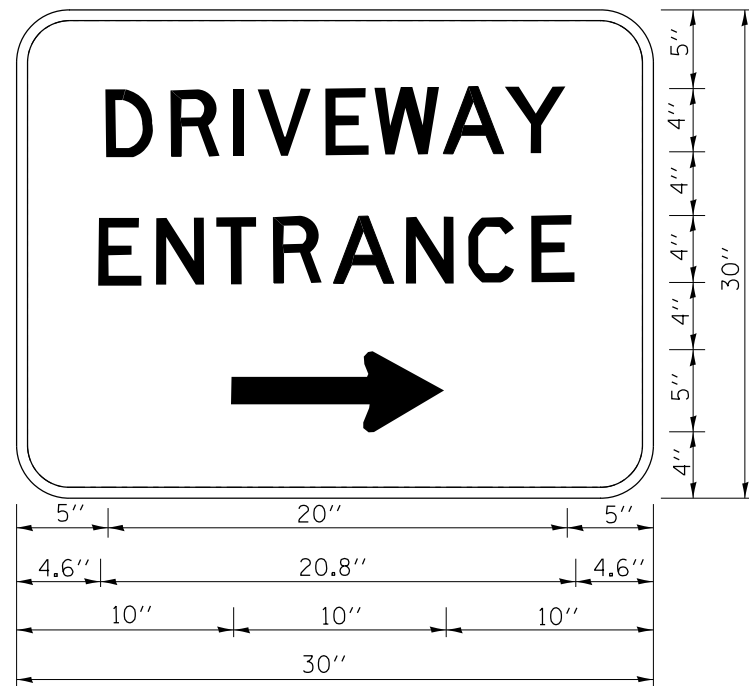

3.0" RADIUS, 0.5" BORDER, WHITE ON GREEN; REFLECTORIZED  
 "DRIVEWAY" D; "ENTRANCE" D; STANDARD ARROW CUSTOM 12.0" x 5.0"

**NOTES:**

1. HALF OF THE SIGNS WILL REQUIRE A LEFT HAND FACING ARROW.
2. TWO SIGNS SHALL BE USED AT EACH COMMERCIAL ENTRANCE  
 PLACED BACK-TO-BACK; ONE WITH A RIGHT HAND ARROW (SHOWN)  
 SHALL BE PLACED ON THE NEAR RIGHT SIDE THE DRIVEWAY  
 AND ONE WITH A LEFT HAND ARROW SHALL BE PLACED ON THE  
 FAR LEFT SIDE OF THE DRIVEWAY.
3. SIGNS TO BE PAID FOR AS ITEM "TEMPORARY INFORMATION SIGNING".


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		DATE -	REVISED -

**STATE OF ILLINOIS  
 DEPARTMENT OF TRANSPORTATION**

**DRIVEWAY ENTRANCE SIGNING**

SCALE: NONE SHEET NO. 1 OF 1 SHEETS STA. TO STA.

F.A.P. RTE.	SECTION	COUNTY	TOTAL SHEETS	SHEET NO.
104	105N-4	LAKE	113	98
<b>TC-26</b>			<b>CONTRACT NO. 60W06</b>	
FED. ROAD DIST. NO. 1 ILLINOIS FED. AID PROJECT				

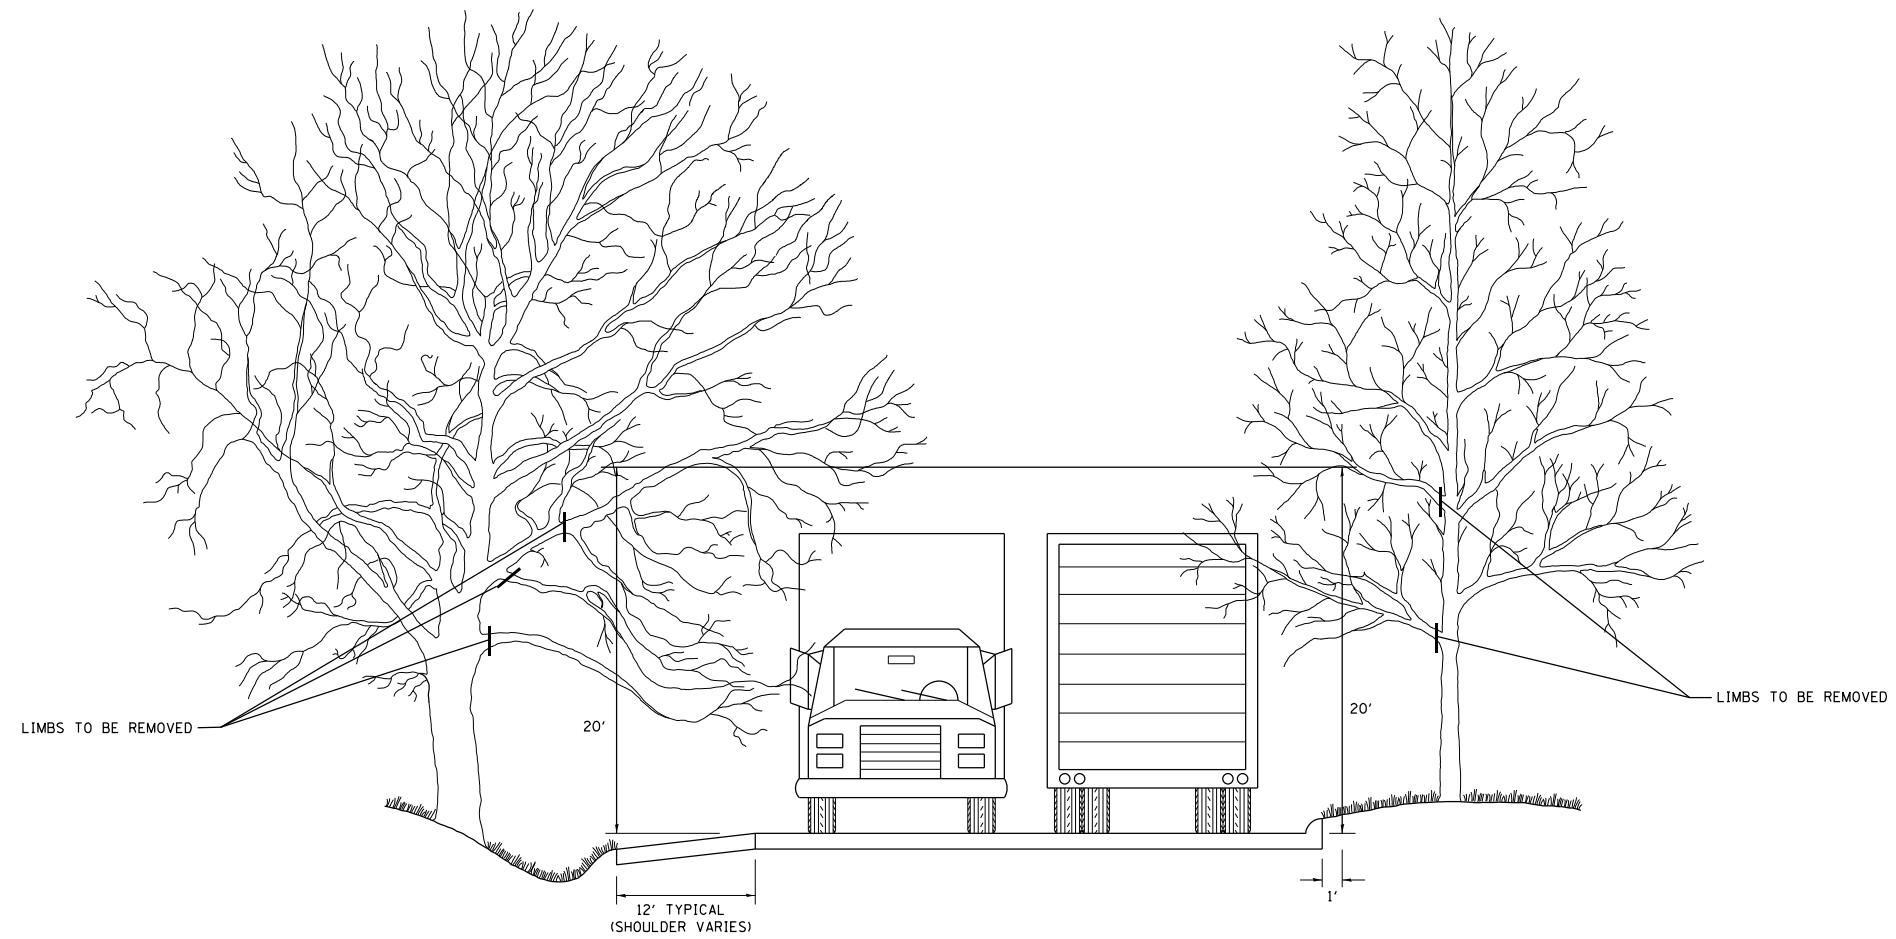

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	PLOT DATE = 8/19/2016		

**STATE OF ILLINOIS  
DEPARTMENT OF TRANSPORTATION**

**PRUNING FOR SAFETY AND  
EQUIPMENT CLEARANCE**


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F.A.P. RTE.	SECTION	COUNTY	TOTAL SHEETS	SHEET NO.
104	105N-4	LAKE	113	99
<b>BM-20</b>			<b>CONTRACT NO. 60W06</b>	
FED. ROAD DIST. NO. 1   ILLINOIS FED. AID PROJECT				



FINAL SURVEY NO.	SURVEYED PLOTTED TEMPLATE AREAS CHECKED	BY	DATE


ORIGINAL SURVEY NO.	SURVEYED PLOTTED TEMPLATE AREAS CHECKED	BY	DATE

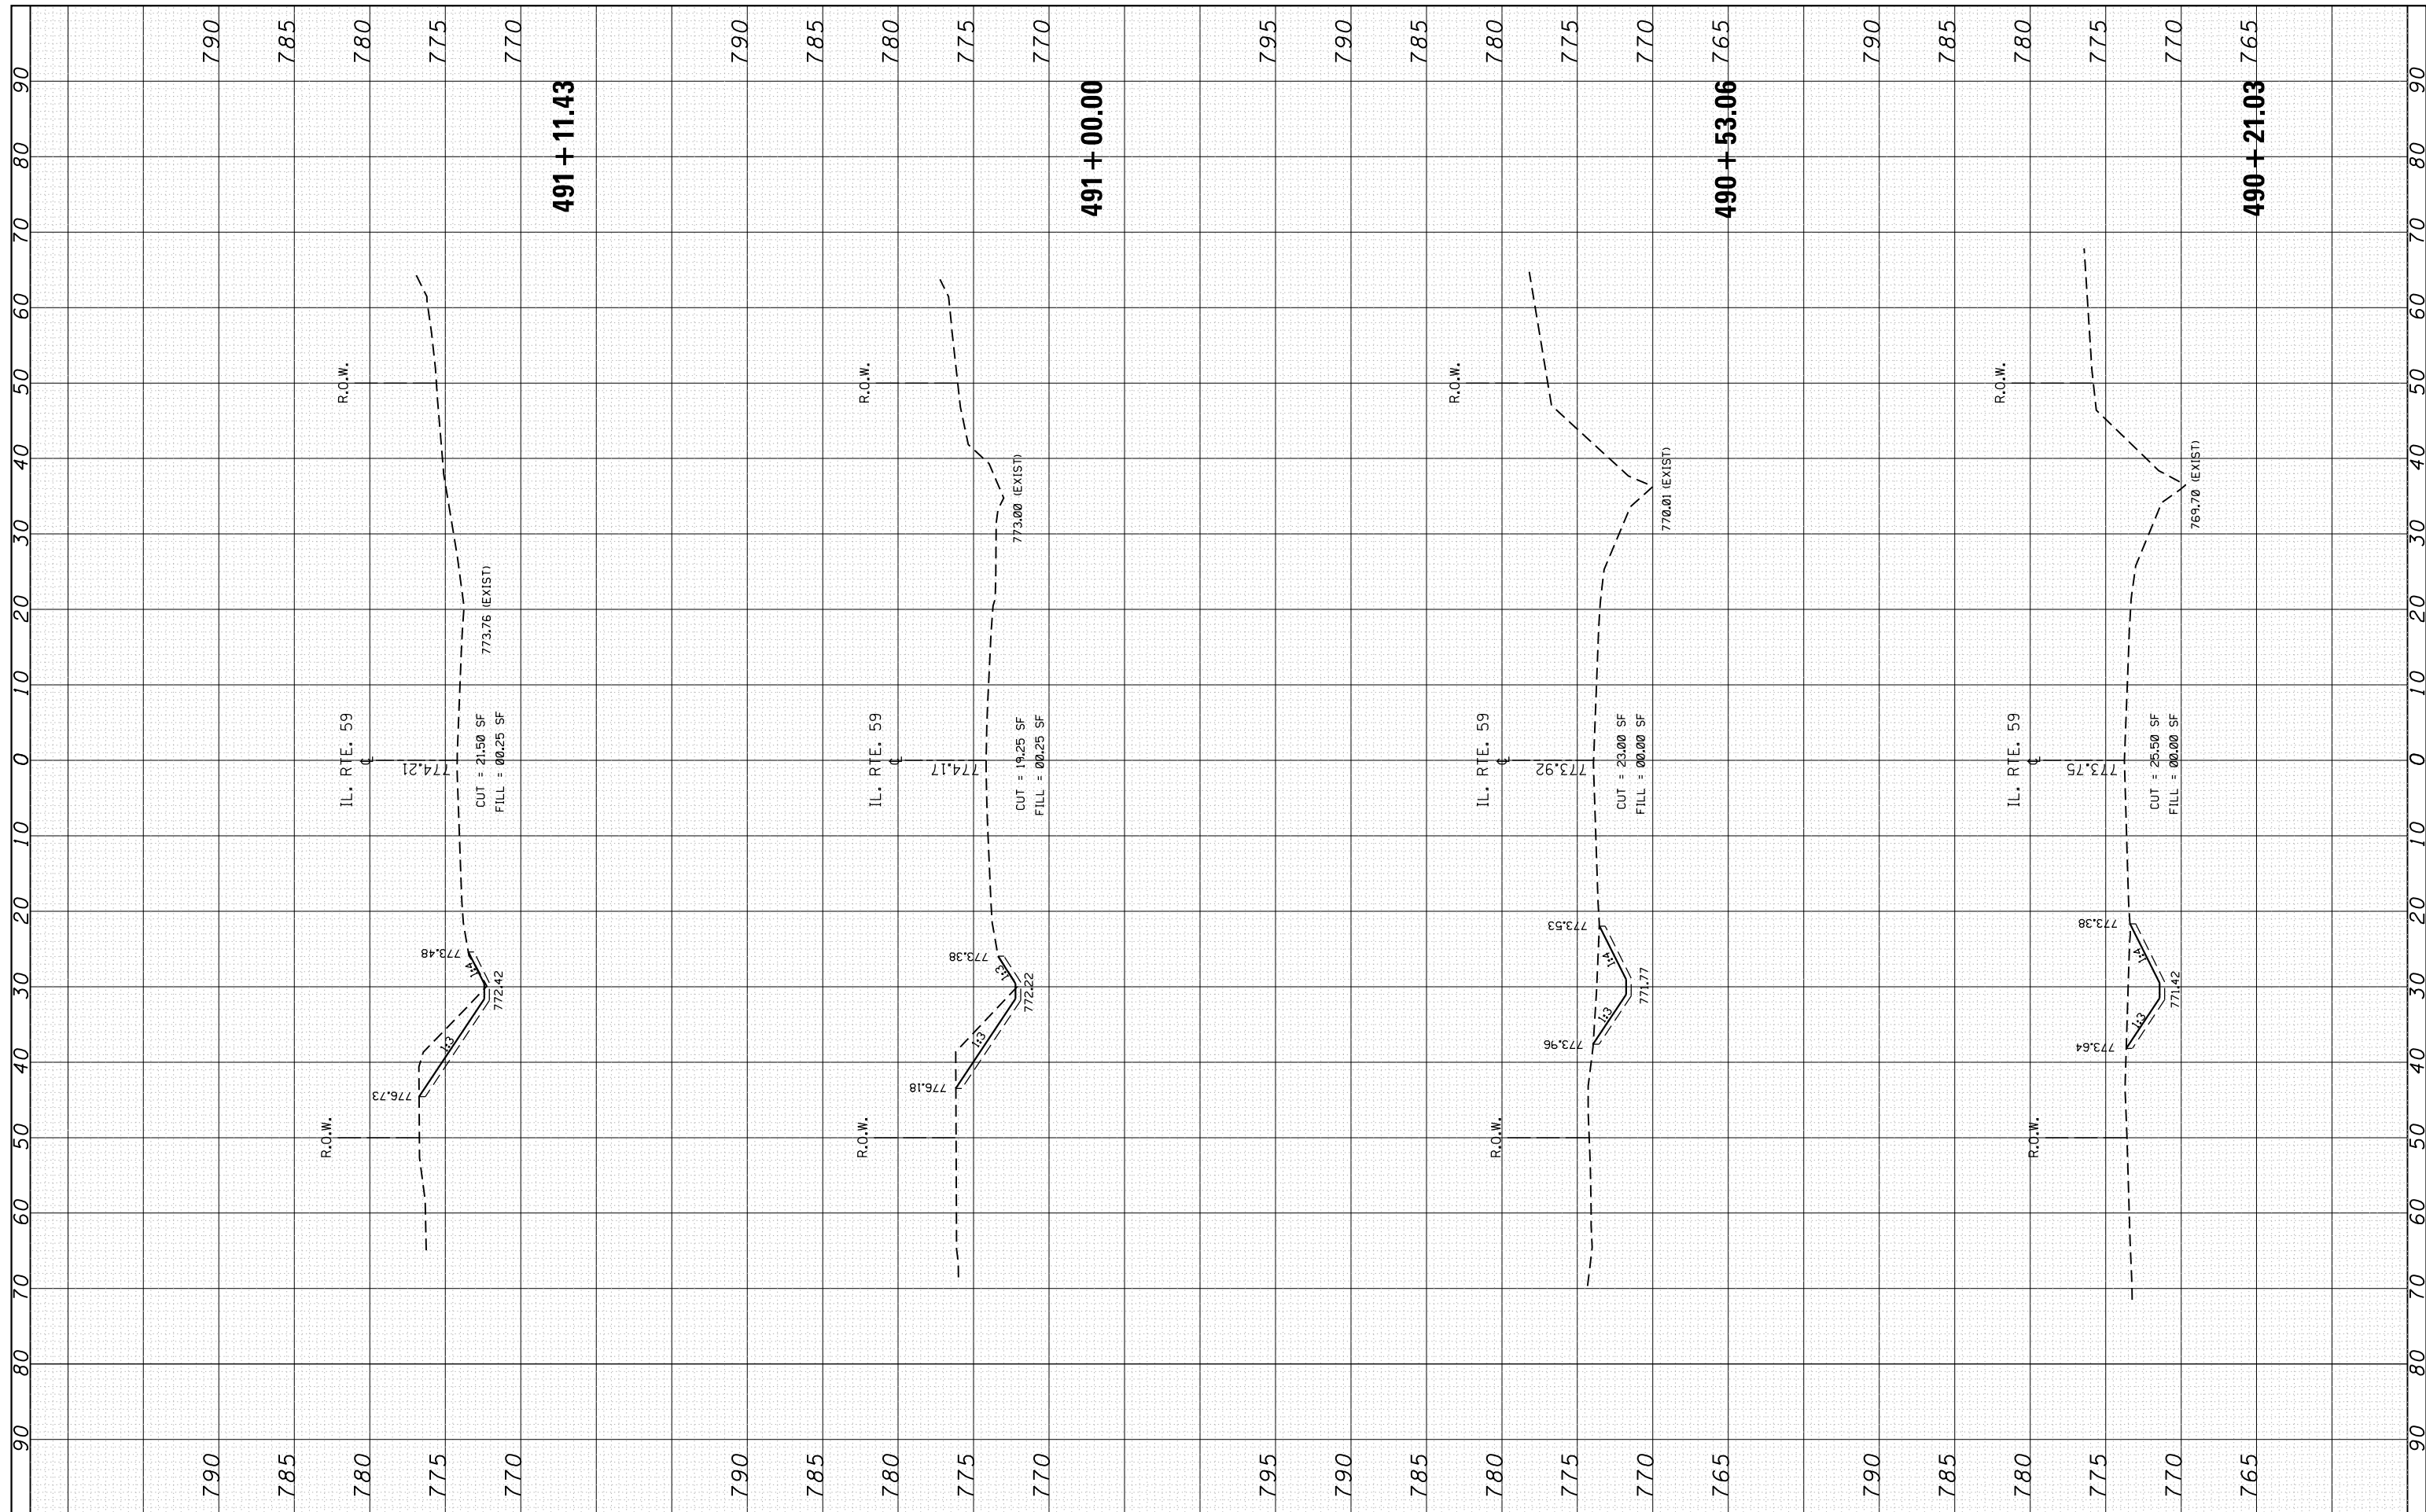

FILE NAME =	USER NAME = ledeznorm	DESIGNED -	REVISÉ -	<b>STATE OF ILLINOIS DEPARTMENT OF TRANSPORTATION</b>	<b>CROSS SECTIONS IL. ROUTE 59 AT PETITE LAKE RD.</b>			F.A.P. RTE. 104	SECTION 105N-4	COUNTY LAKE	TOTAL SHEETS 113	SHEET NO. 101
Default	Plot Scale = 20.0000' / in.	CHECKED -	REVISÉ -		SCALE:	SHEET	OF	SHEETS	STA. 490+21.03	TO STA. 491+11.43	<b>CONTRACT NO. 60W06</b>	
	Plot Date = 8/19/2016	DATE -	REVISÉ -		ILLINOIS FED. AID PROJECT							

NO.	NO.
ORIGINAL SURVEY	FINAL SURVEY
NOTE BOOK	NOTE BOOK
AREAS CHECKED	AREAS CHECKED
DATE	DATE
BY	BY


NO.	NO.
ORIGINAL SURVEY	FINAL SURVEY
NOTE BOOK	NOTE BOOK
AREAS CHECKED	AREAS CHECKED
DATE	DATE
BY	BY

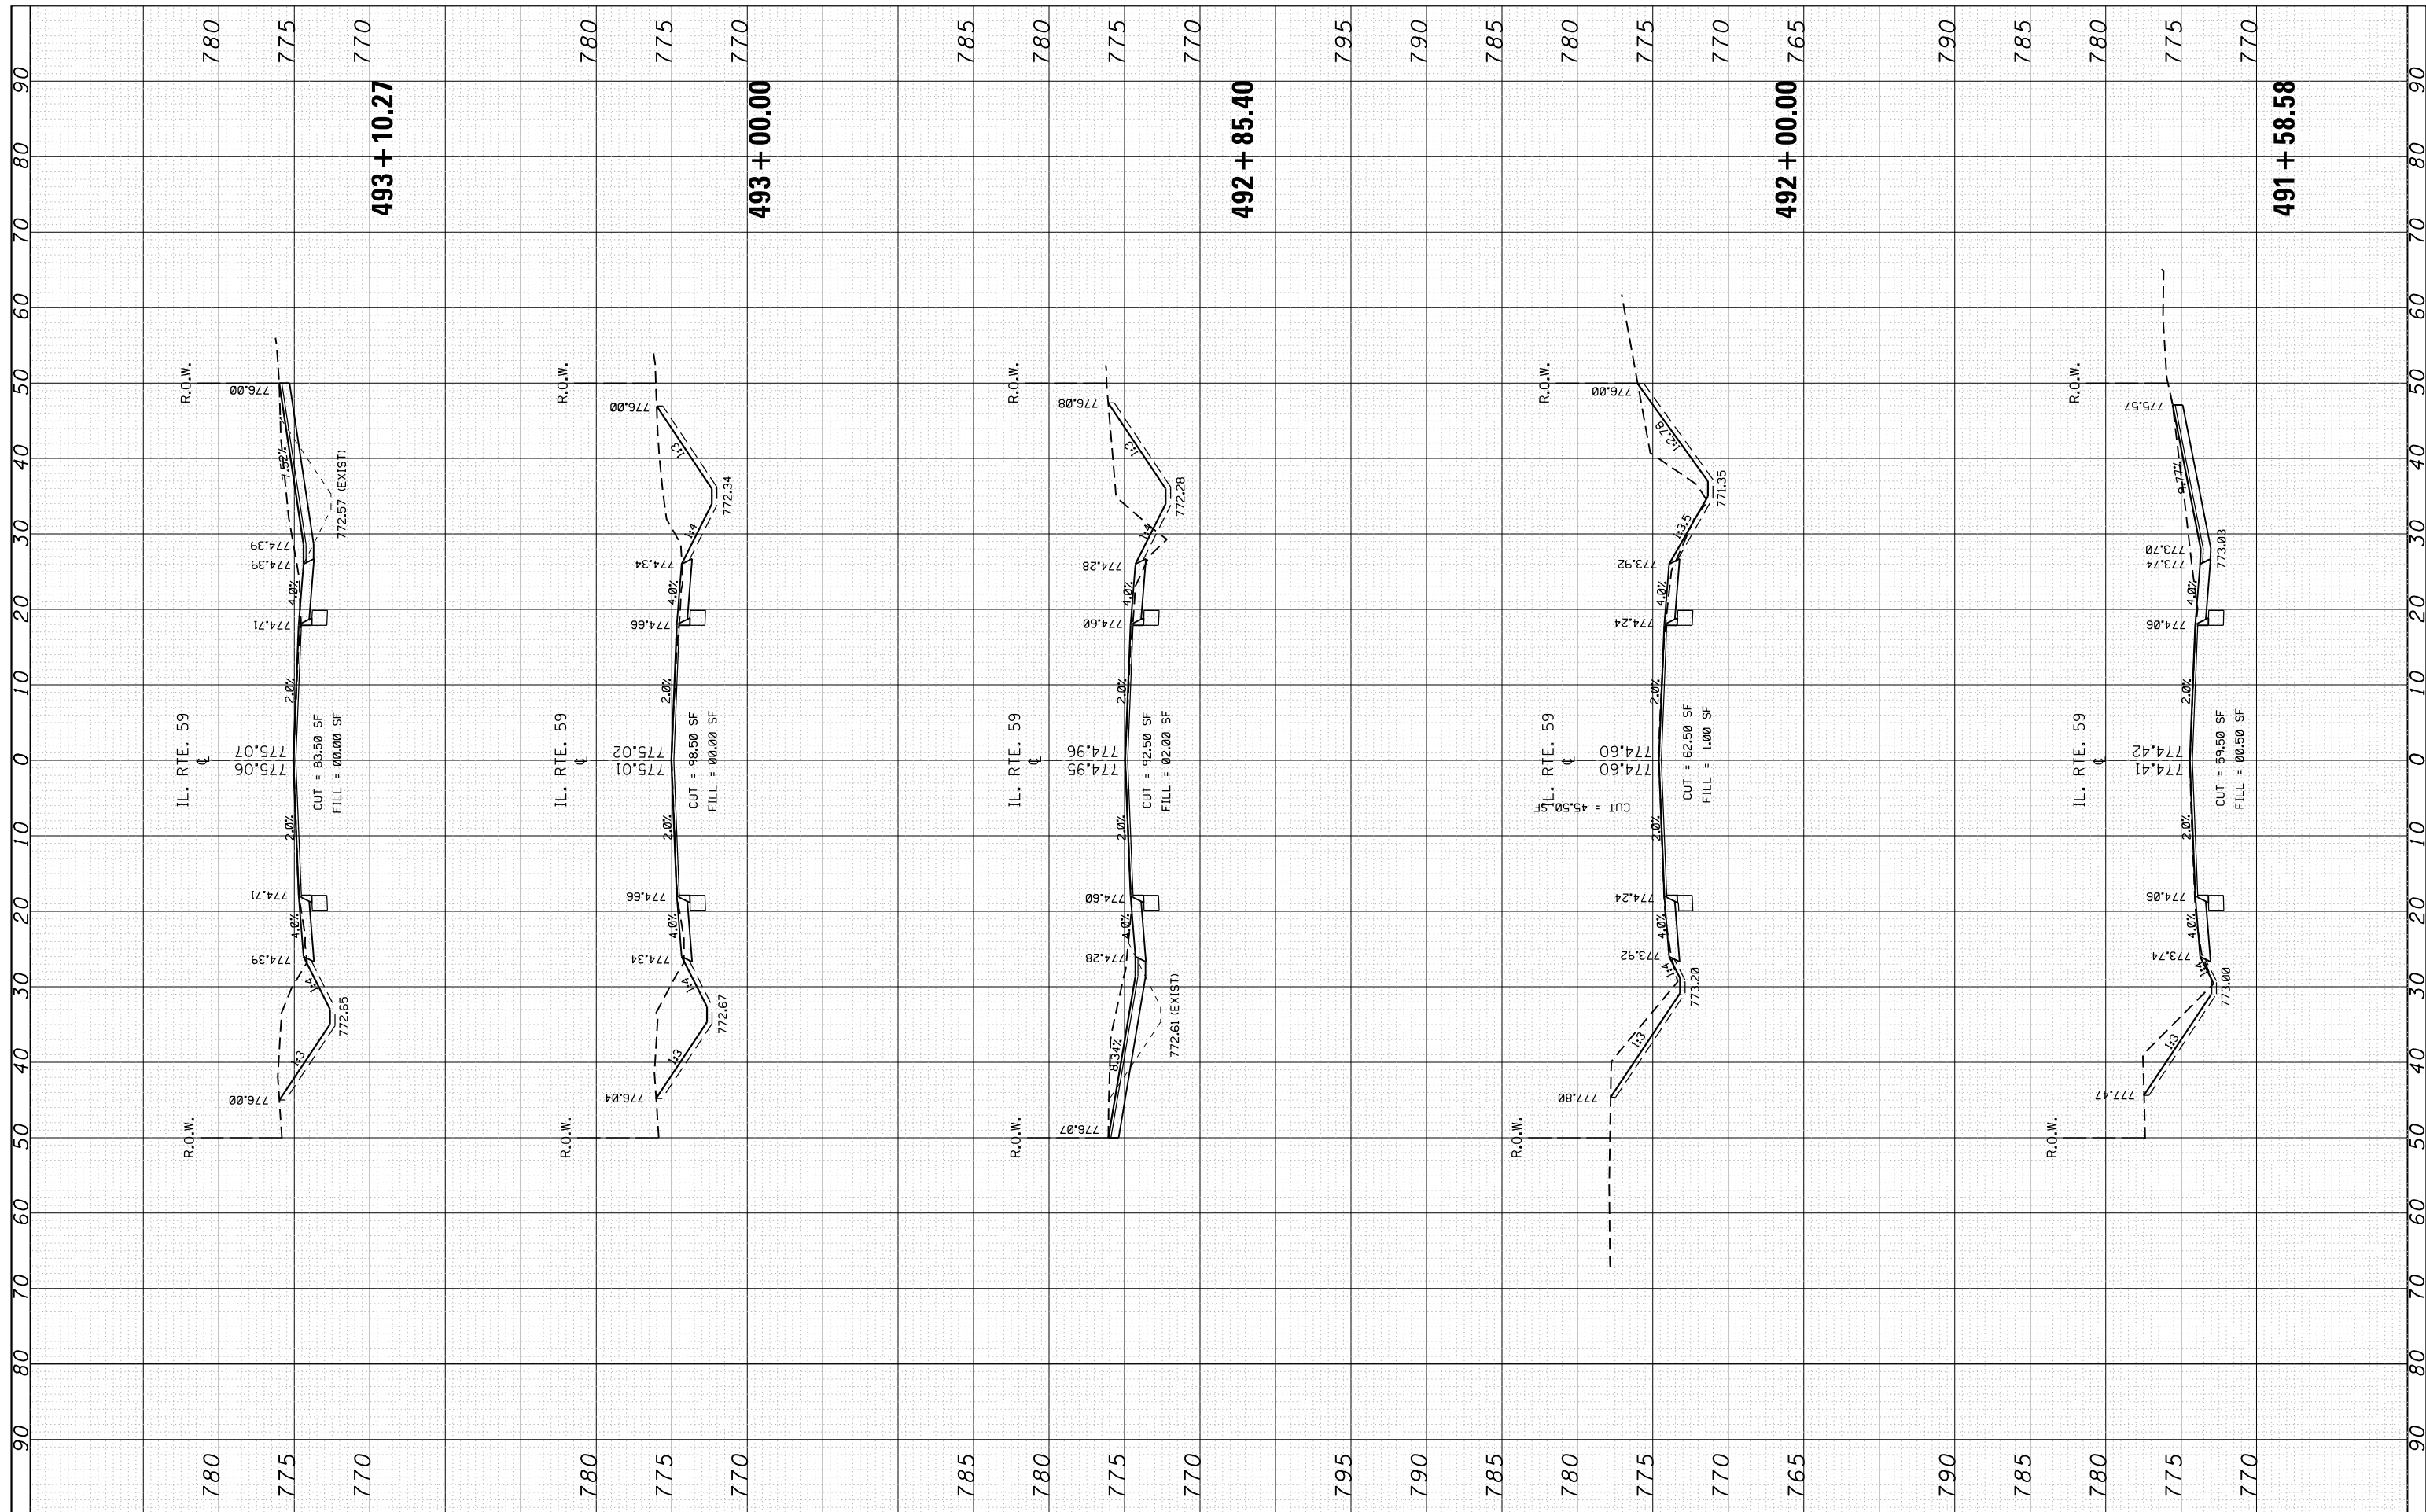

FILE NAME =	USER NAME = ledeznorm	DESIGNED -	REVISED -	<b>STATE OF ILLINOIS</b> <b>DEPARTMENT OF TRANSPORTATION</b>	<b>CROSS SECTIONS</b> <b>IL. ROUTE 59 AT PETITE LAKE RD.</b>			F.A.P. RTE.	SECTION	COUNTY	TOTAL SHEETS	SHEET NO.
Default	DOT Offices\District 1\Projects\P145409\CADD\Drawings\145409-shr-ssht-IL59.dgn	CHECKED -	REVISED -					104	105N-4105N-4	LAKE	113	102
	PLOT SCALE = 20.0000' / in.	DATE -	REVISED -					CONTRACT NO. 60W06				
	PLOT DATE = 8/19/2016							ILLINOIS FED. AID PROJECT				
				SCALE:	SHEET	OF	SHEETS	STA. 491+58.58	TO STA. 493+10.27			

FINAL SURVEY NO.	SURVEYED PLOTTED TEMPLATE AREAS CHECKED	BY	DATE

ORIGINAL SURVEY NO.	SURVEYED PLOTTED TEMPLATE AREAS CHECKED	BY	DATE

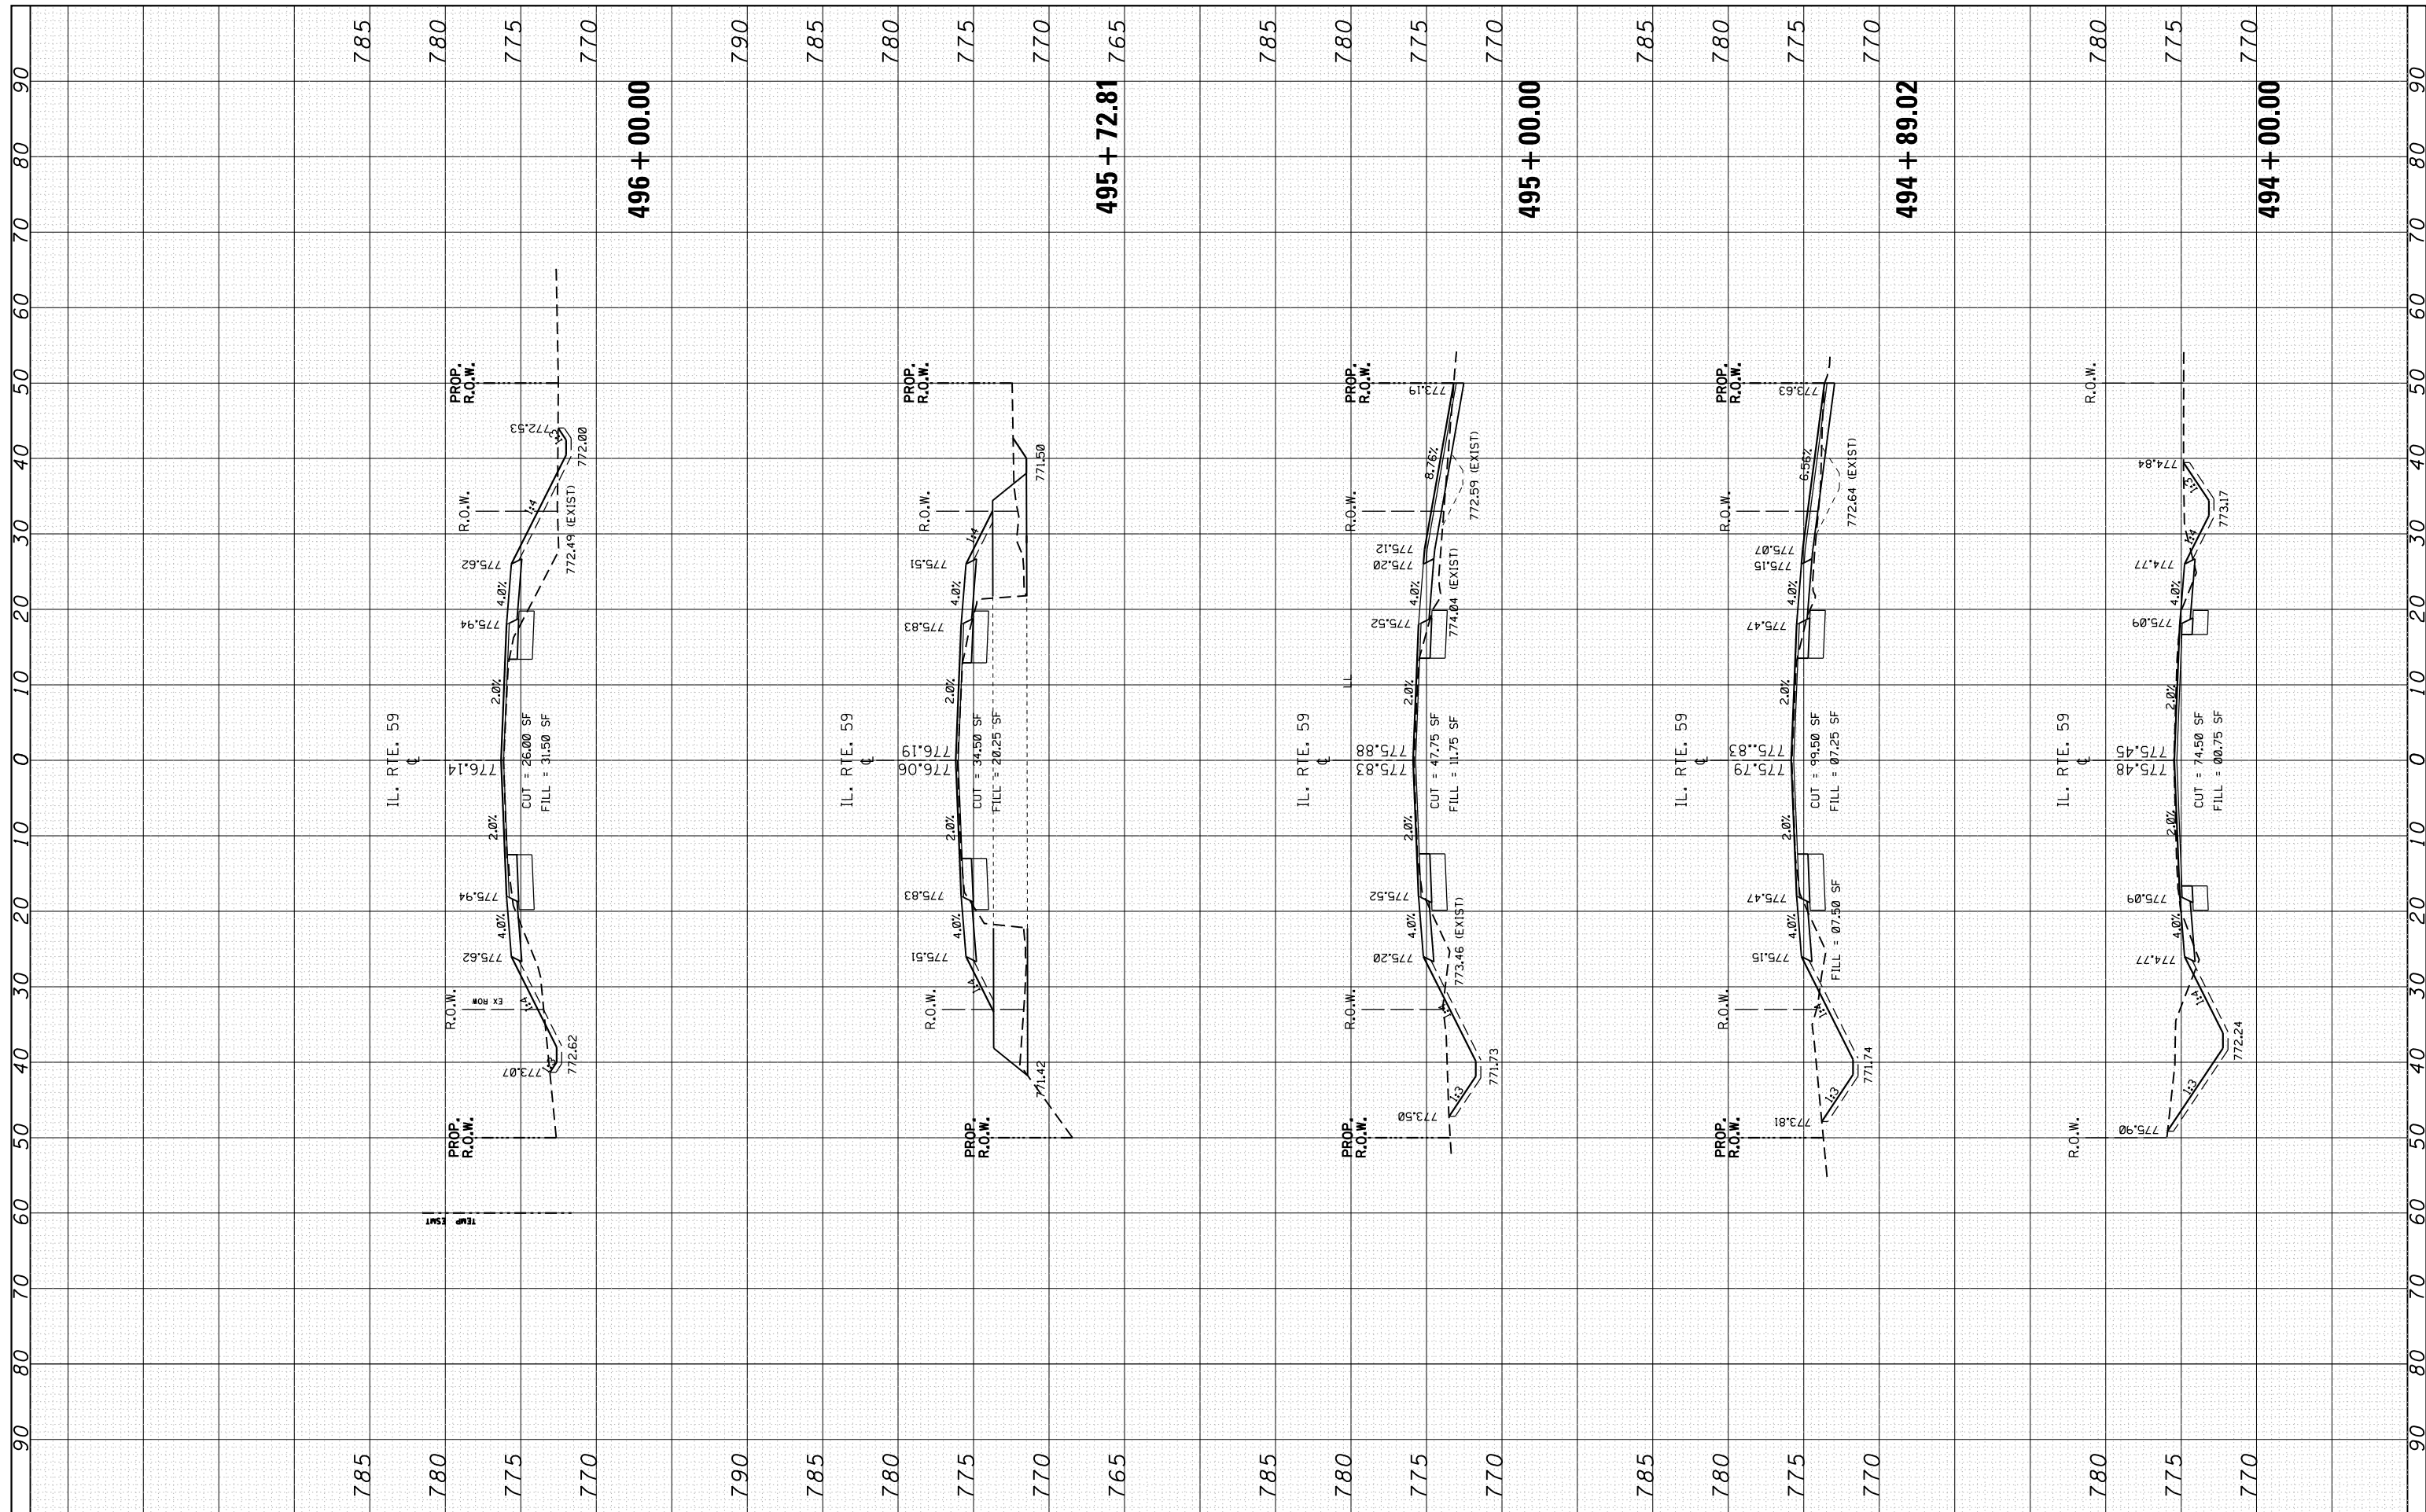

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 PLOT SCALE = 20.0000' / in.  
 PLOT DATE = 8/19/2016

DESIGNED -	REVIS
CHECKED -	REVIS
DATE -	REVIS


**STATE OF ILLINOIS  
DEPARTMENT OF TRANSPORTATION**

**CROSS SECTIONS  
IL. ROUTE 59 AT PETITE LAKE RD.**  
 SCALE: SHEET OF SHEETS STA. 494+00.00 TO STA. 496+00.00

F.A.P. RTE. 104	SECTION 105N-4	COUNTY LAKE	TOTAL SHEETS 113	SHEET NO. 103
CONTRACT NO. 60W06				
ILLINOIS FED. AID PROJECT				

FINAL SURVEY	SURVEYED	BY	DATE
NOTE BOOK	PLOTTED		
NO.	TEMPLATE		
	AREAS CHECKED		

ORIGINAL SURVEY	SURVEYED	BY	DATE
NOTE BOOK	PLOTTED		
NO.	TEMPLATE		
	AREAS CHECKED		

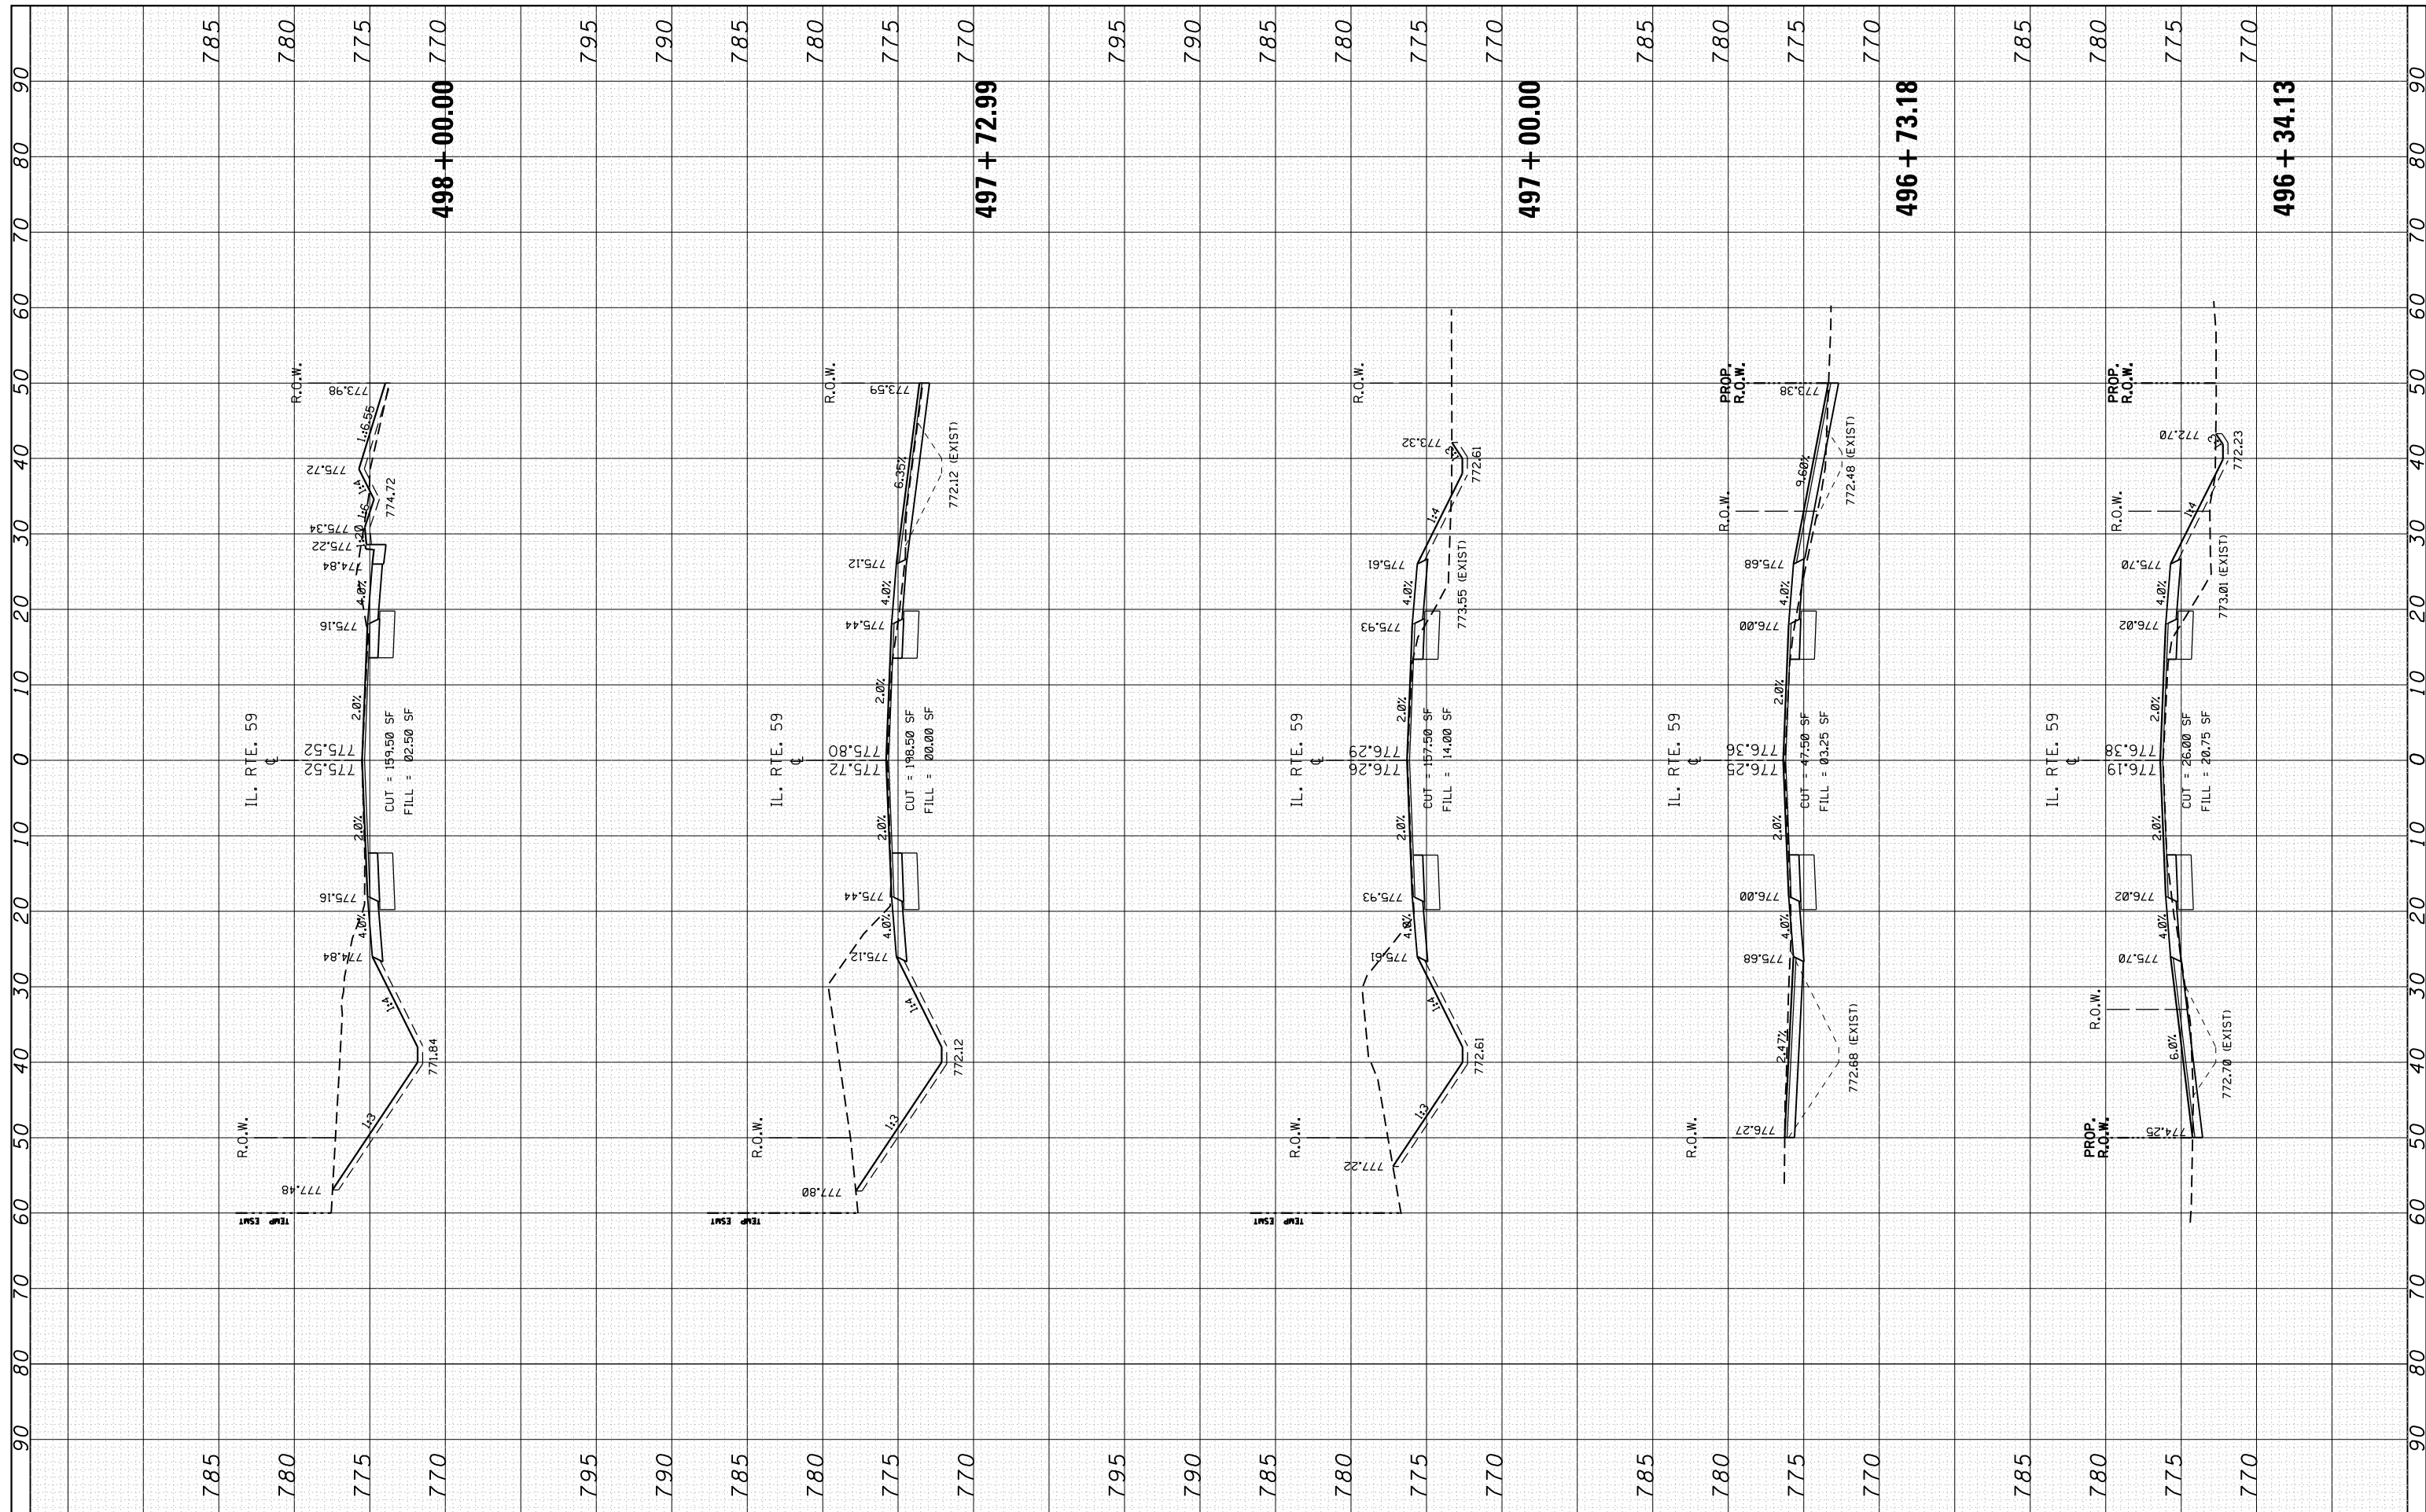


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p:\1\084EBIDINTEG\Illinois.gov\PIDOT\Documents\DOT Offices\District 1\Projects\P145409\CADD\Drawings\145409-sht-xxsht-IL59.dgn		CHECKED -	REVISED -		SCALE:	SHEET	OF	SHEETS	STA. 496+34.13	TO STA. 498+00.00	LAKE	113	104
Default	PLOT SCALE = 20.0000' / in.	DATE -	REVISED -		CONTRACT NO. 60W06								
	PLOT DATE = 8/25/2016		REVISED -		ILLINOIS FED. AID PROJECT								





FINAL SURVEY NO.	SURVEYED PLOTTED	BY	DATE
NOTE BOOK NO.	TEMPLATE AREAS CHECKED		

ORIGINAL SURVEY NO.	SURVEYED PLOTTED	BY	DATE
NOTE BOOK NO.	TEMPLATE AREAS CHECKED		

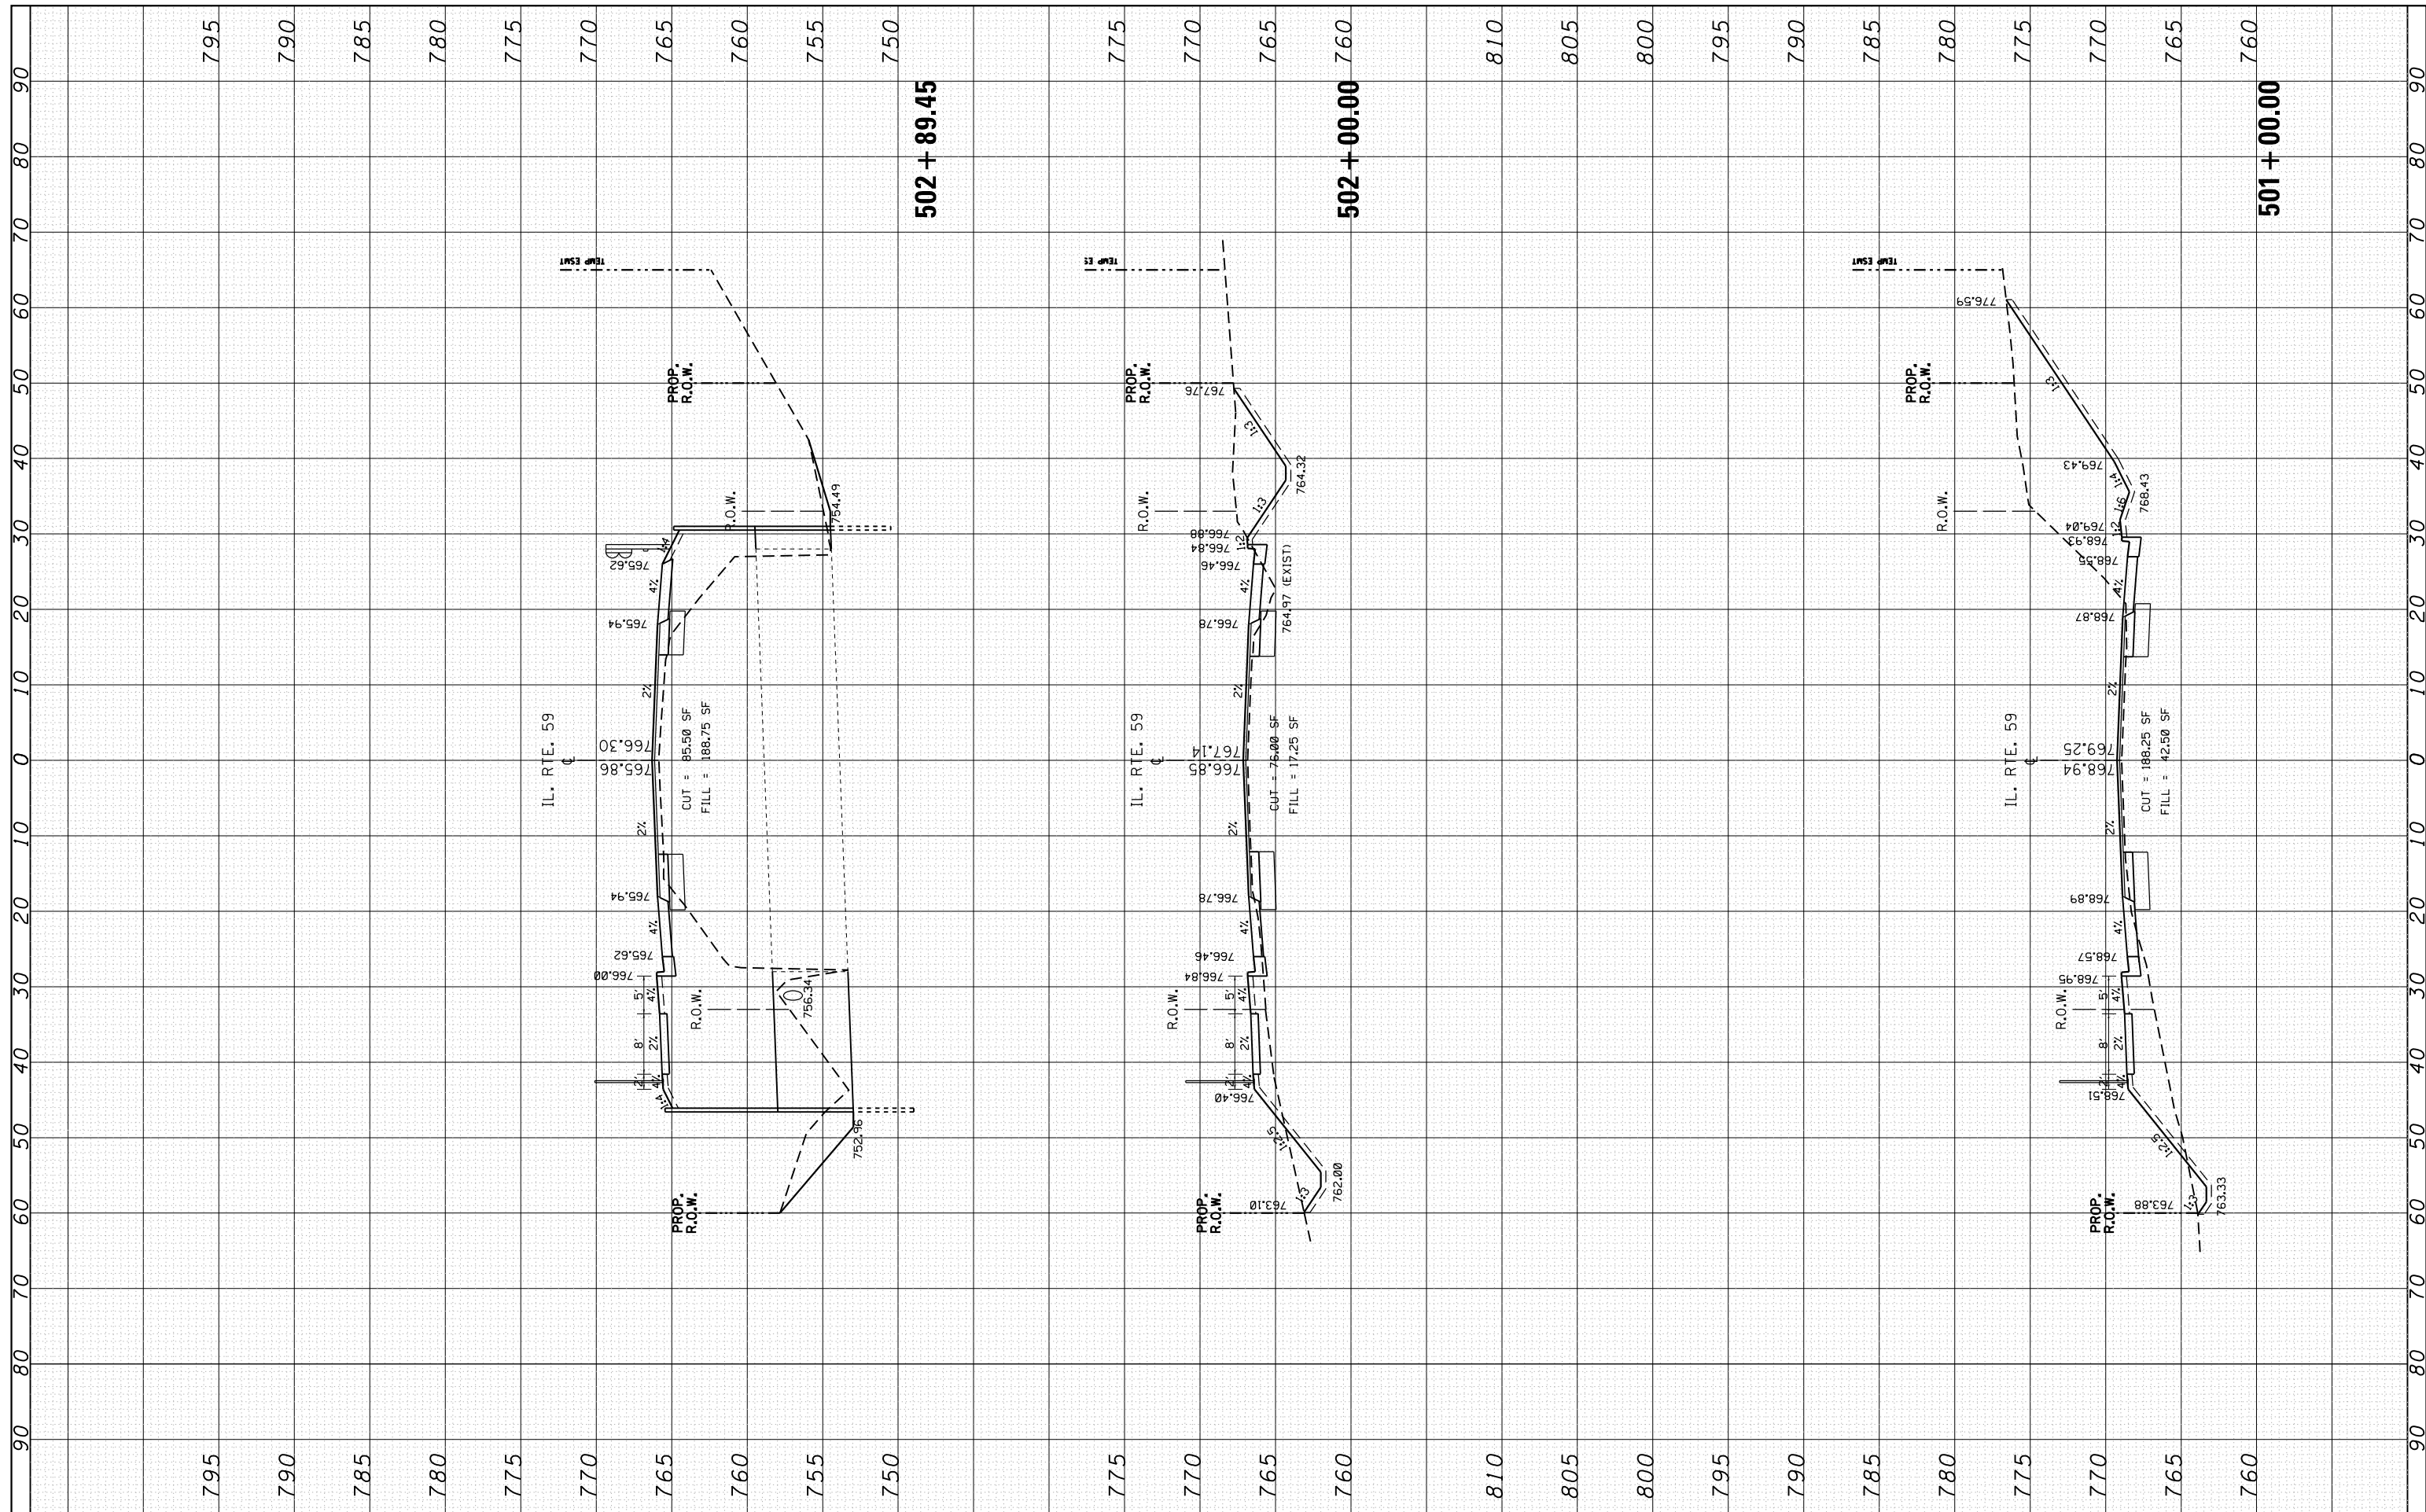

FILE NAME =	USER NAME = ledeznorm	DESIGNED -	REVISED -
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	PLOT SCALE = 20.0000' / in.	CHECKED -	REVISED -
Default	PLOT DATE = 8/19/2016	DATE -	REVISED -

**STATE OF ILLINOIS  
DEPARTMENT OF TRANSPORTATION**


**CROSS SECTIONS  
IL. ROUTE 59 AT PETITE LAKE RD.**

SCALE: SHEET OF SHEETS STA. 501+00.00 TO STA. 502+89.45

F.A.P. RTE.	SECTION	COUNTY	TOTAL SHEETS	SHEET NO.
104	105N-4	LAKE	113	106
CONTRACT NO. 60W06				
ILLINOIS FED. AID PROJECT				

FINAL SURVEY NO.	SURVEYED PLOTTED AREAS CHECKED	BY	DATE

ORIGINAL SURVEY NO.	SURVEYED PLOTTED AREAS CHECKED	BY	DATE

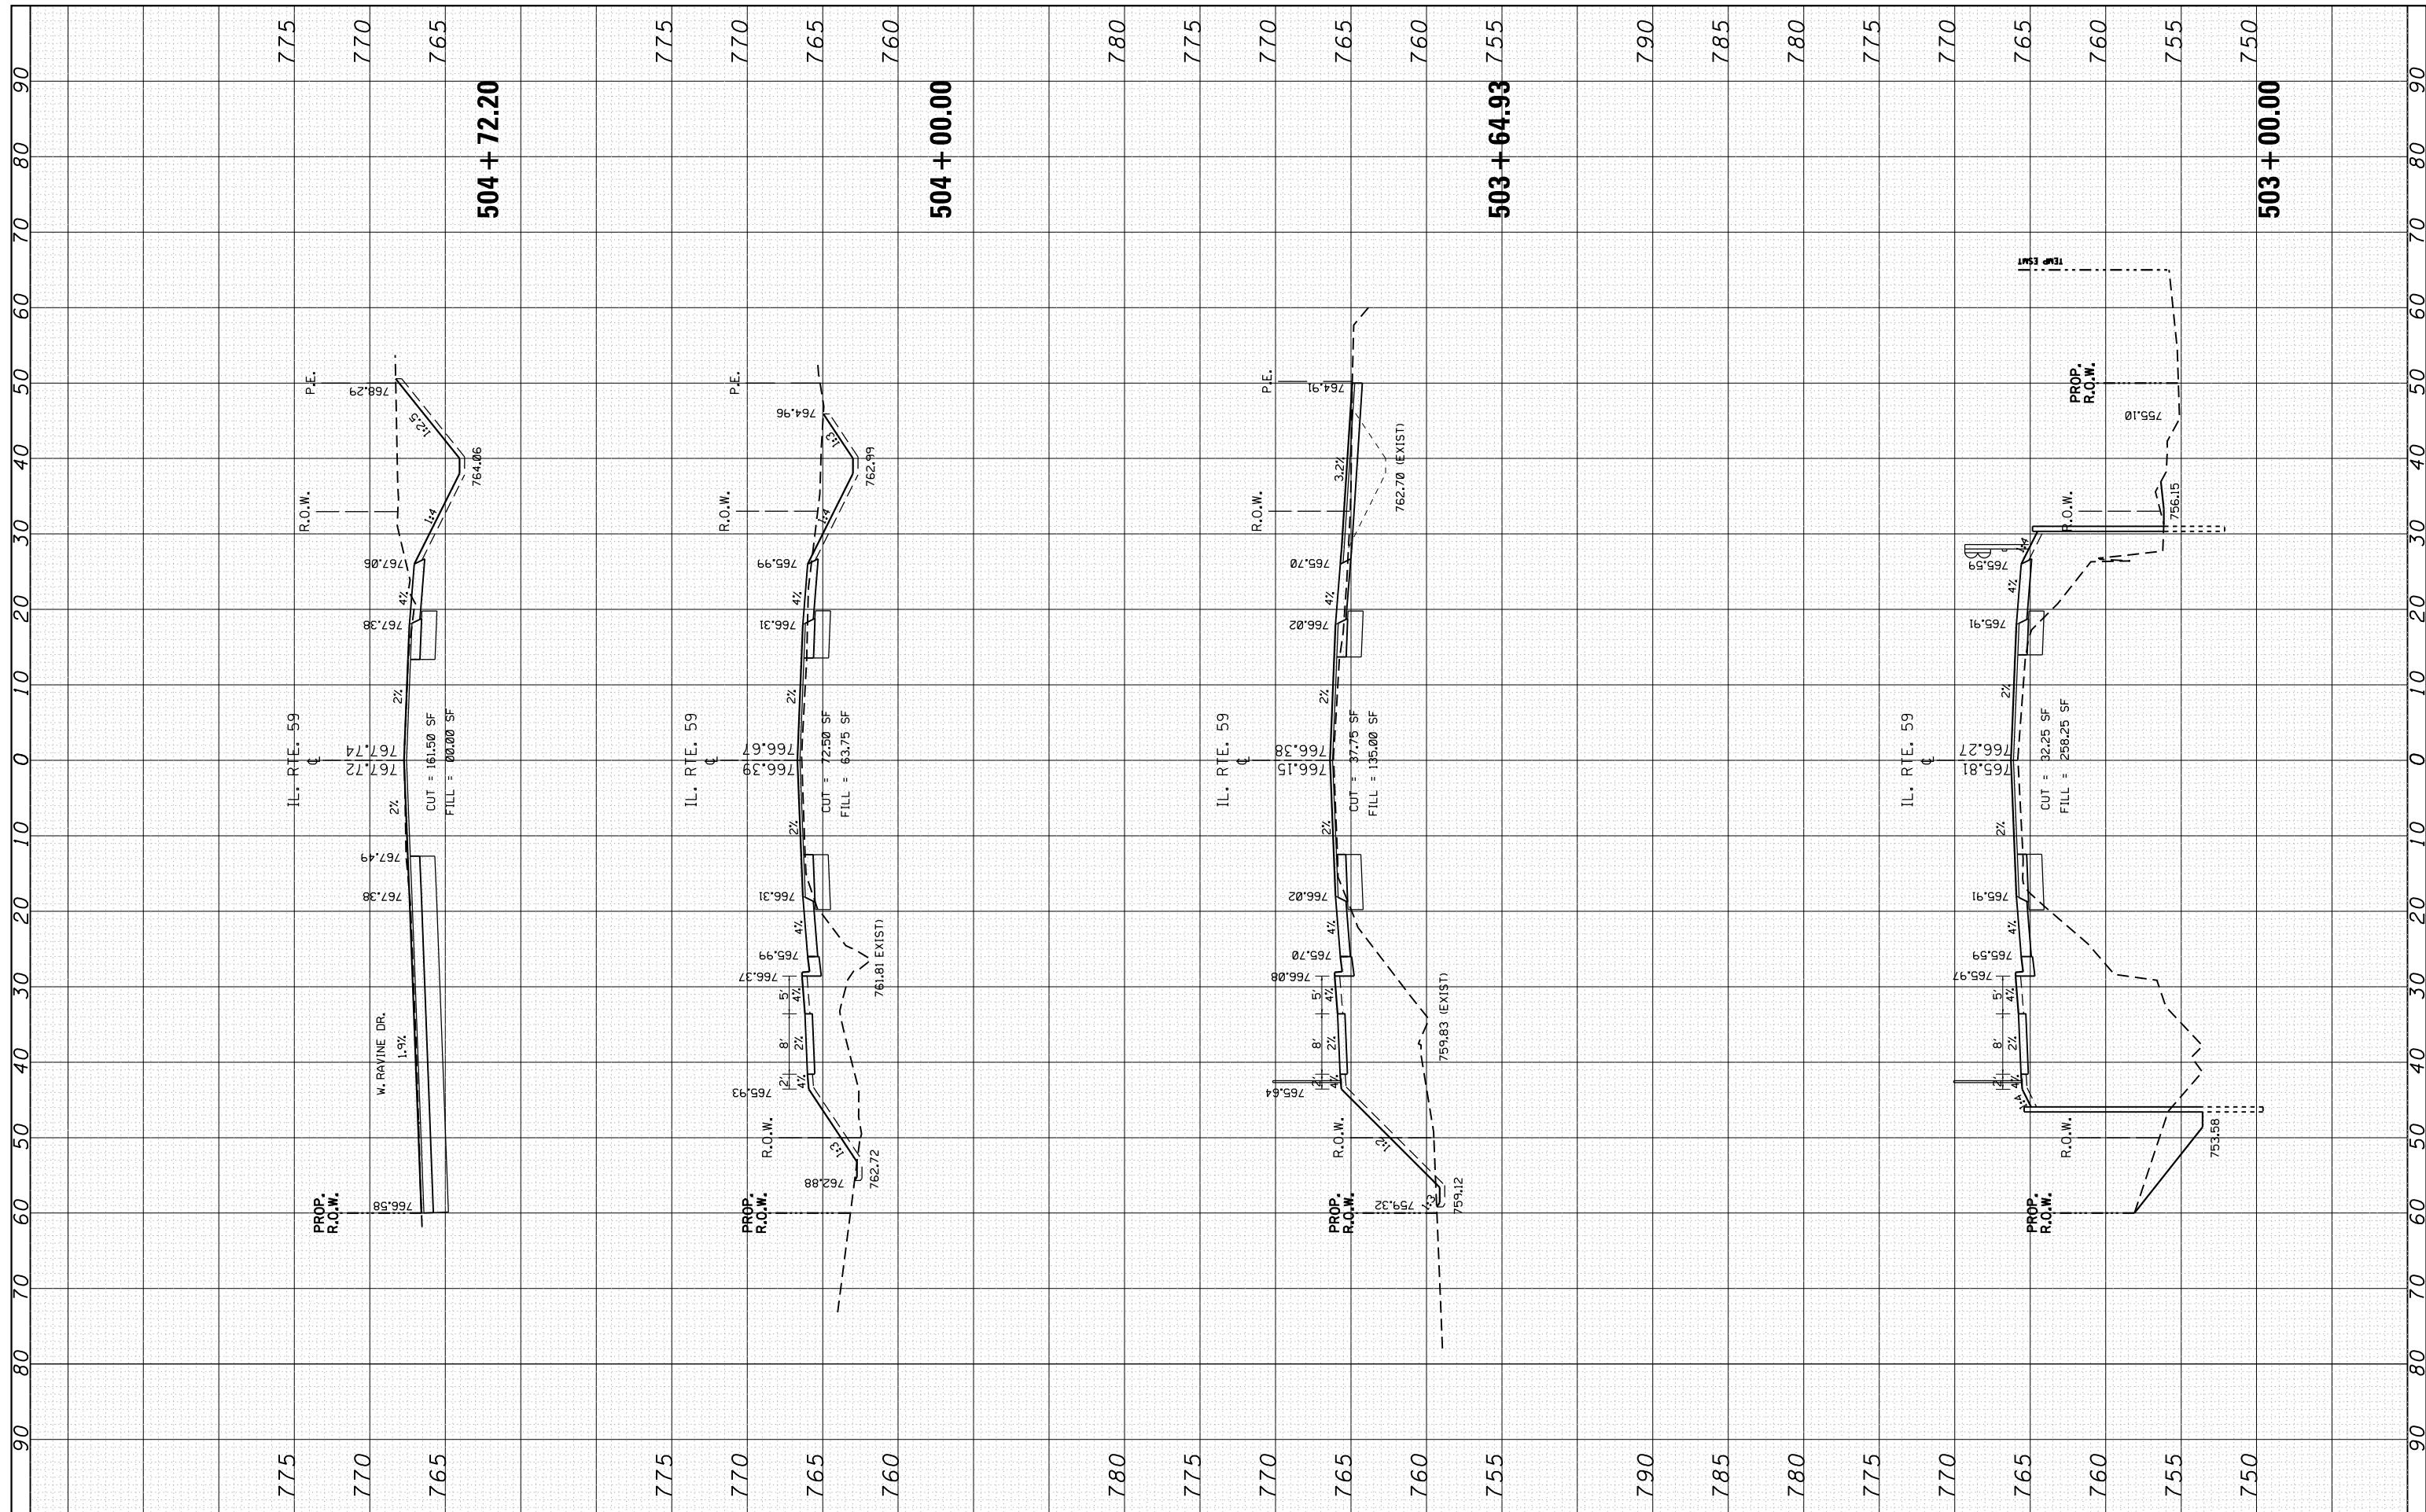


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						104	105N-4	LAKE	113	107	
						CONTRACT NO. 60W06					
						ILLINOIS FED. AID PROJECT					
PLOT SCALE = 20.0000' / in.	CHECKED -			SCALE:	SHEET OF SHEETS	STA. 503+00.00 TO STA. 504+72.20					
PLOT DATE = 8/19/2016	DATE -										



FINAL SURVEY NO.	SURVEYED PLOTTED TEMPLATE AREAS CHECKED	BY	DATE

ORIGINAL SURVEY NO.	SURVEYED PLOTTED TEMPLATE AREAS CHECKED	BY	DATE

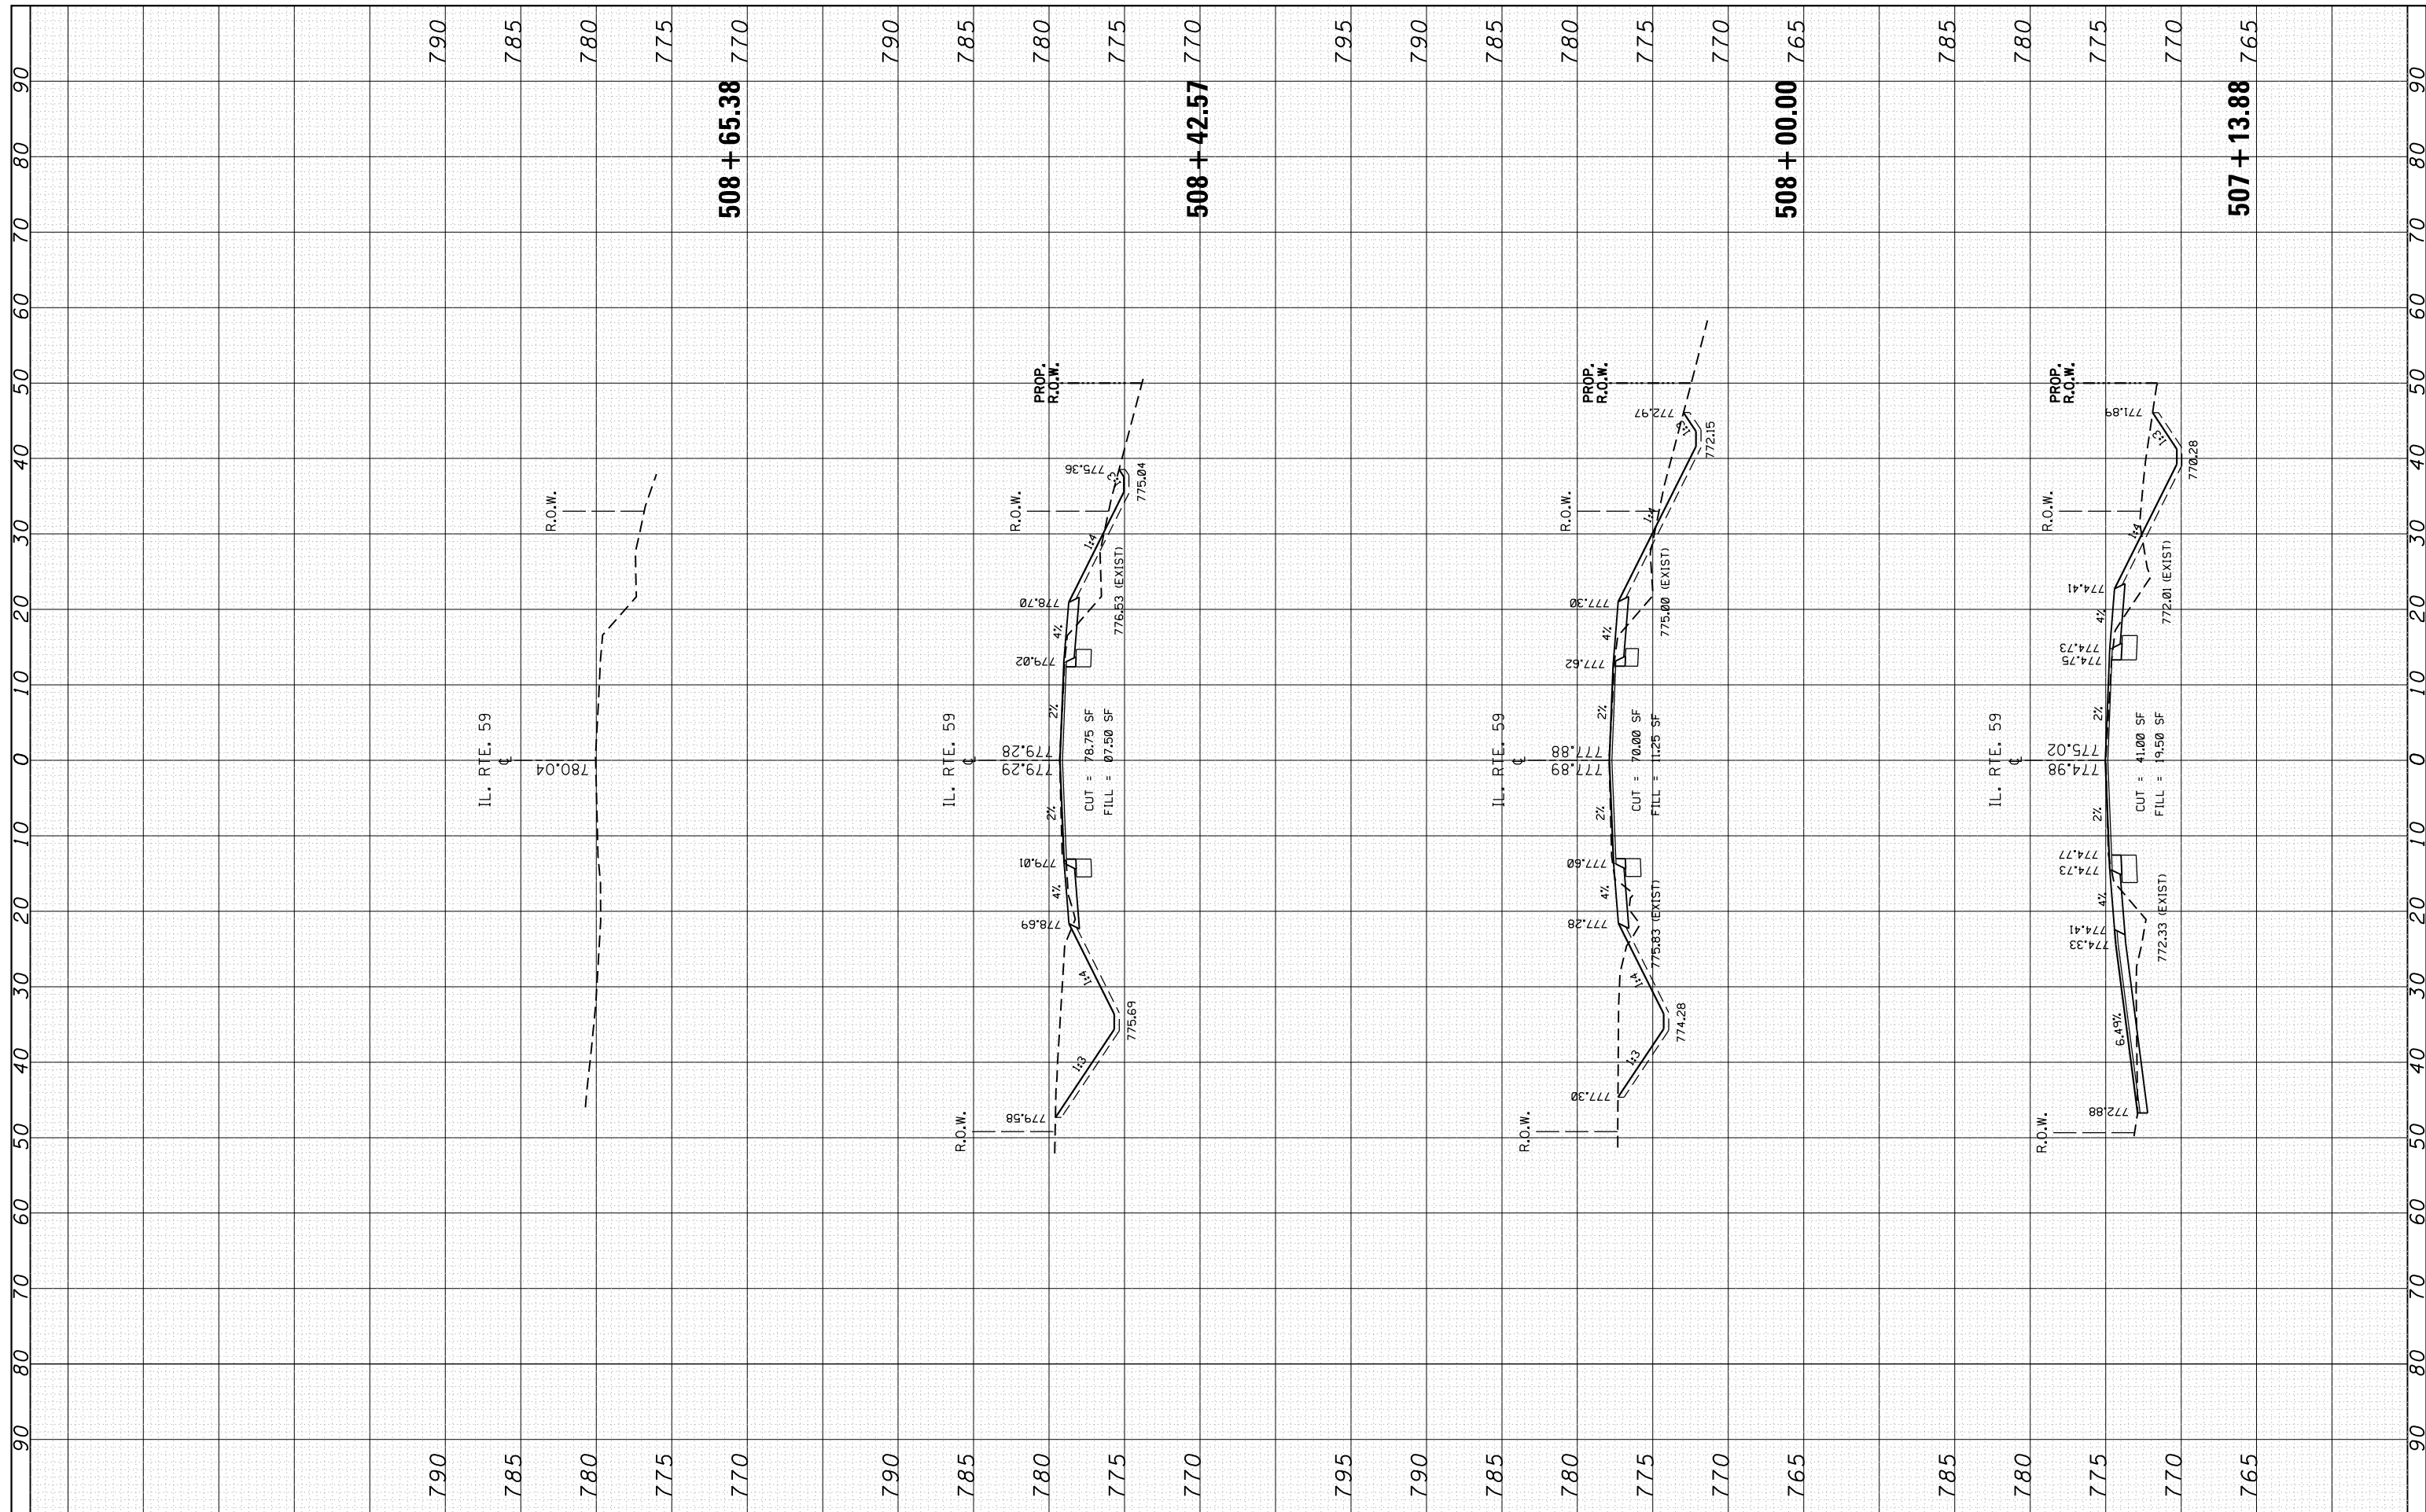


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Default	DOT Offices\District 1\Projects\P145409\CADD\Drawings\P145409-sht-xxsht-IL59.dgn	CHECKED -	REVISED -		SCALE:	SHEET	OF	SHEETS	STA. 507+13.88	TO STA. 508+65.38	CONTRACT NO. 60W06		
	PLOT SCALE = 20.0000' / in.	DATE -	REVISED -		ILLINOIS FED. AID PROJECT								
	PLOT DATE = 8/19/2016												



FINAL SURVEY	SURVEYED	DATE
NOTE BOOK	PLOTTED	
AREAS CHECKED	TEMPLATE	
NO.	AREAS CHECKED	

ORIGINAL SURVEY	SURVEYED	DATE
NOTE BOOK	PLOTTED	
AREAS CHECKED	TEMPLATE	
NO.	AREAS CHECKED	

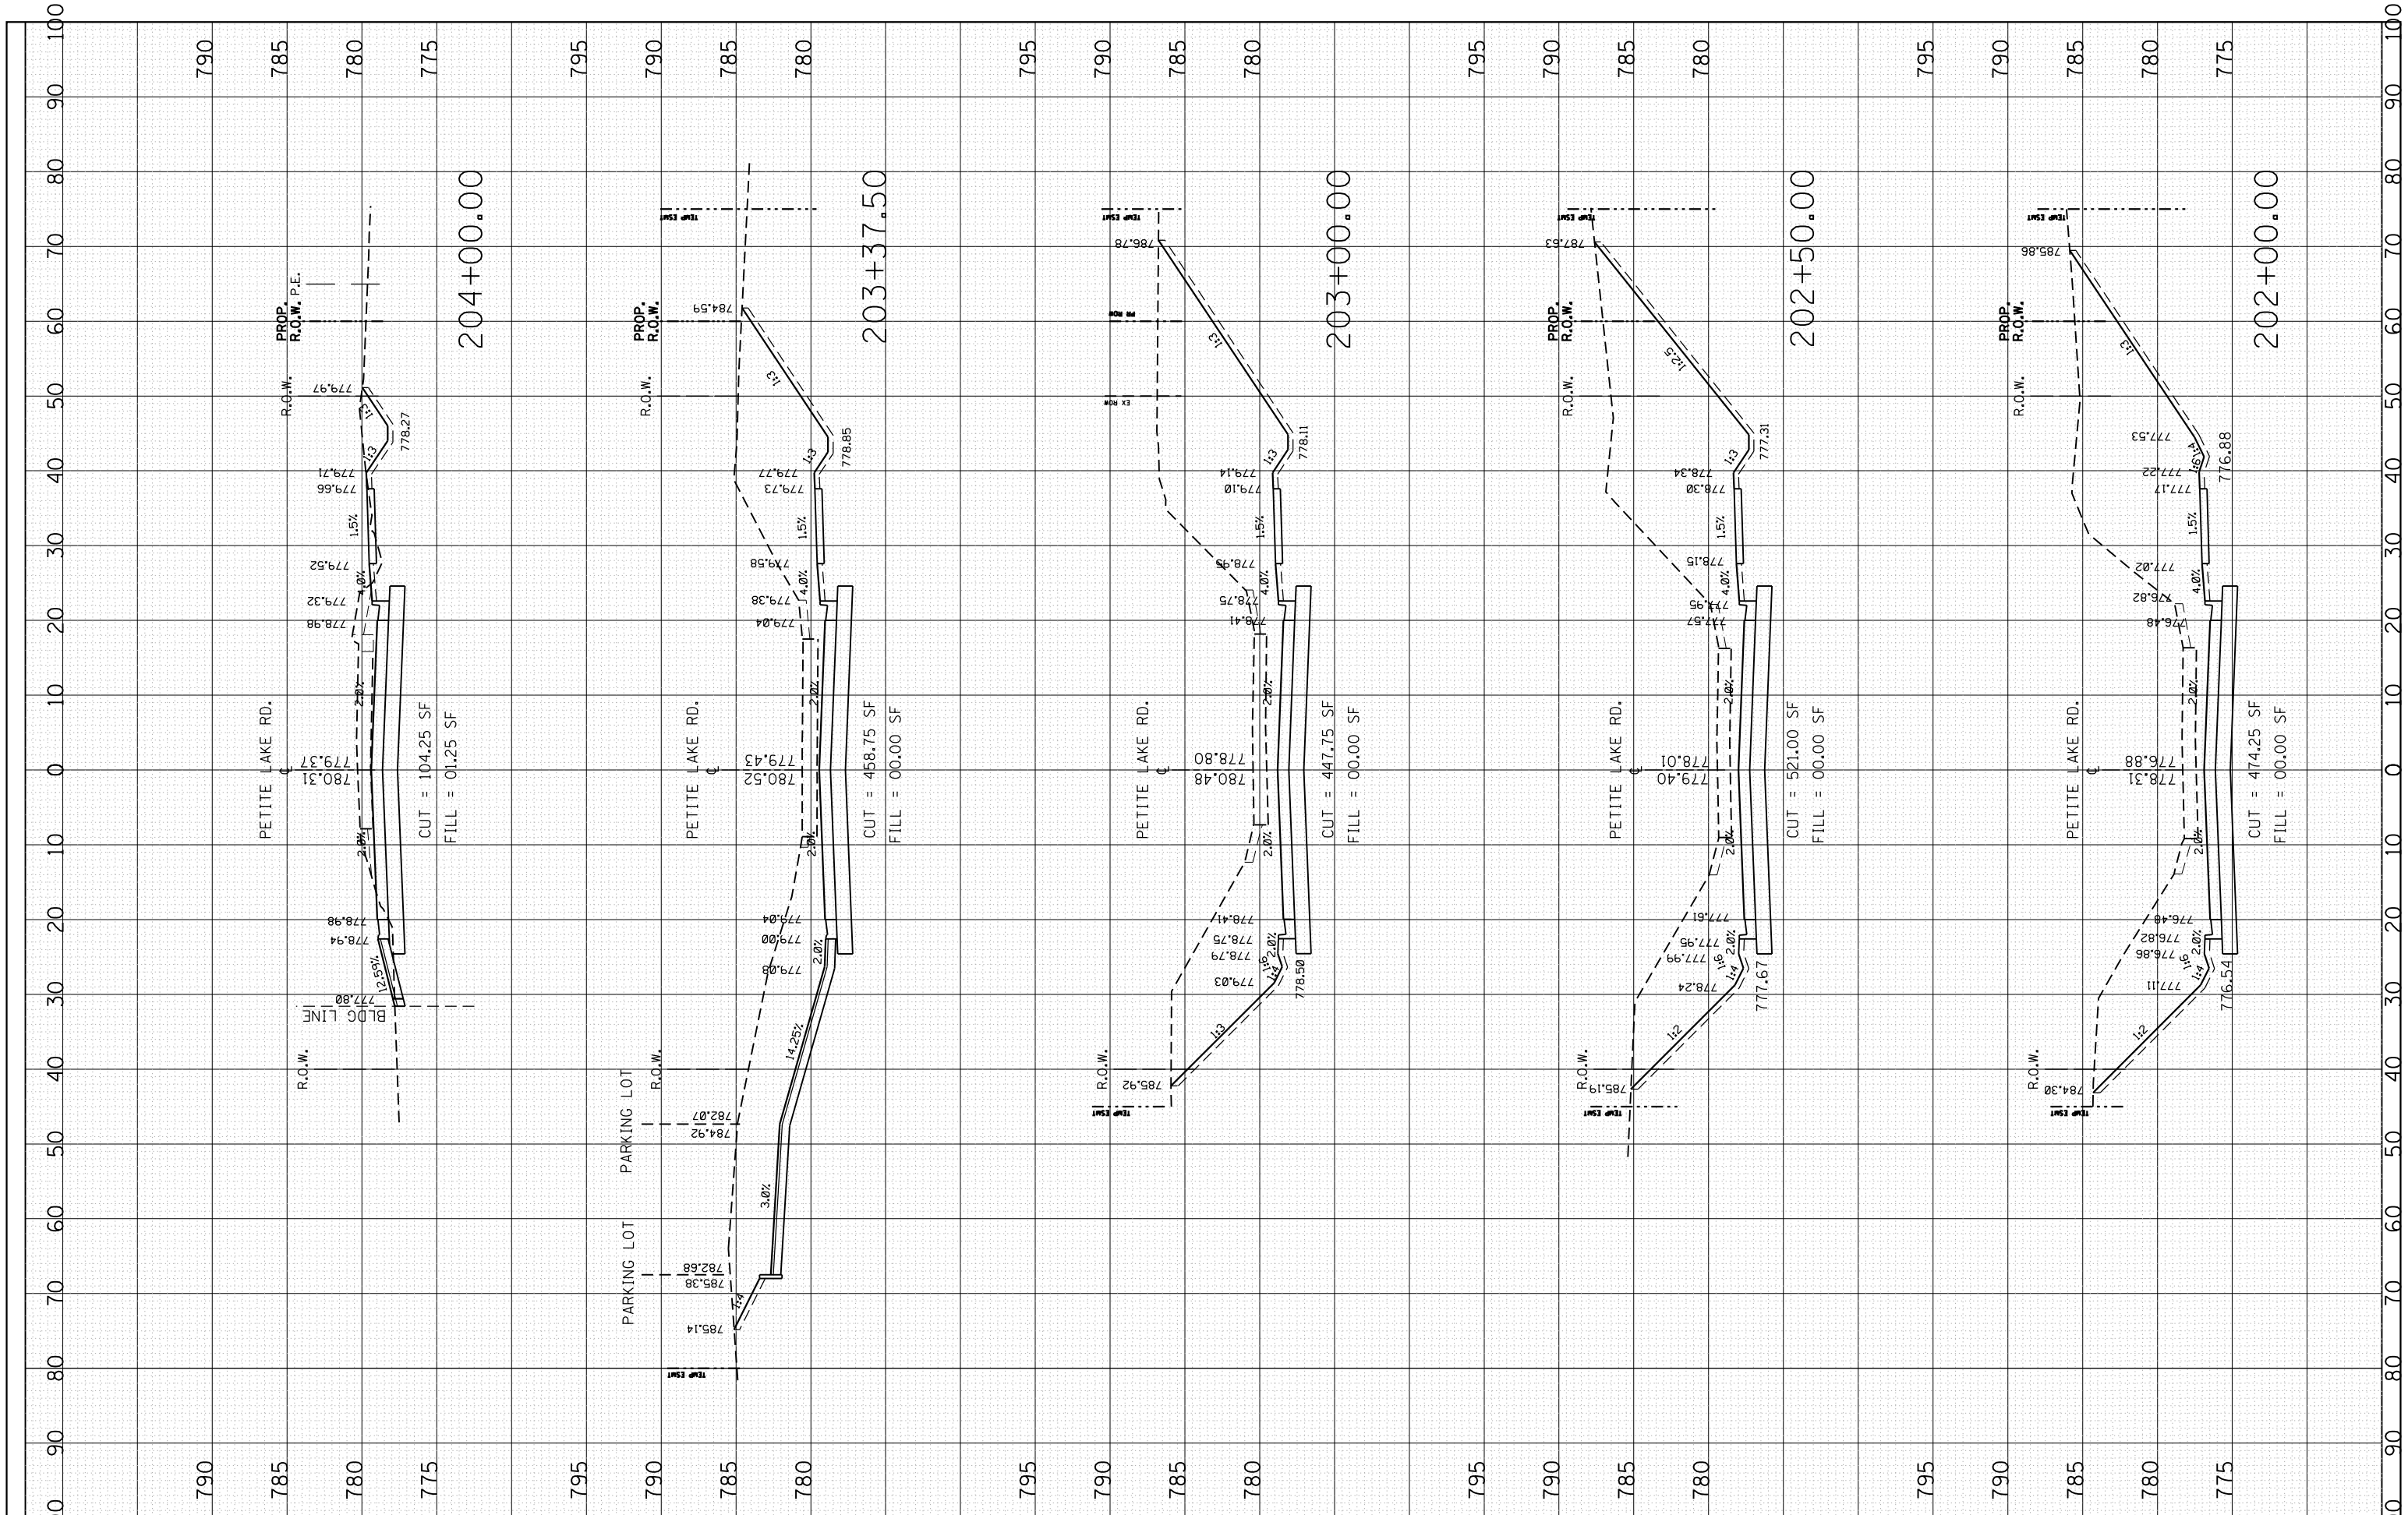

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 PLOT DATE = 9/19/2016

DESIGNED -	REVISOR -
CHECKED -	REVISOR -
DATE -	REVISOR -

**STATE OF ILLINOIS  
DEPARTMENT OF TRANSPORTATION**

**CROSS SECTION  
PETITE LAKE ROAD**

SCALE: SHEET OF SHEETS STA. 202+00.00 TO STA. 204+00.00


F.A.P. RTE.	SECTION	COUNTY	TOTAL SHEETS	SHEET NO.
104	105N-4	LAKE	113	111
CONTRACT NO. 60W06				
ILLINOIS FED. AID PROJECT				





FINAL SURVEY	SURVEYED	BY	DATE
NOTE BOOK	PLOTTED		
AREAS CHECKED	TEMPLATE		
	AREAS		
	CHECKED		

ORIGINAL SURVEY	SURVEYED	BY	DATE
NOTE BOOK	PLOTTED		
AREAS CHECKED	TEMPLATE		
	AREAS		
	CHECKED		

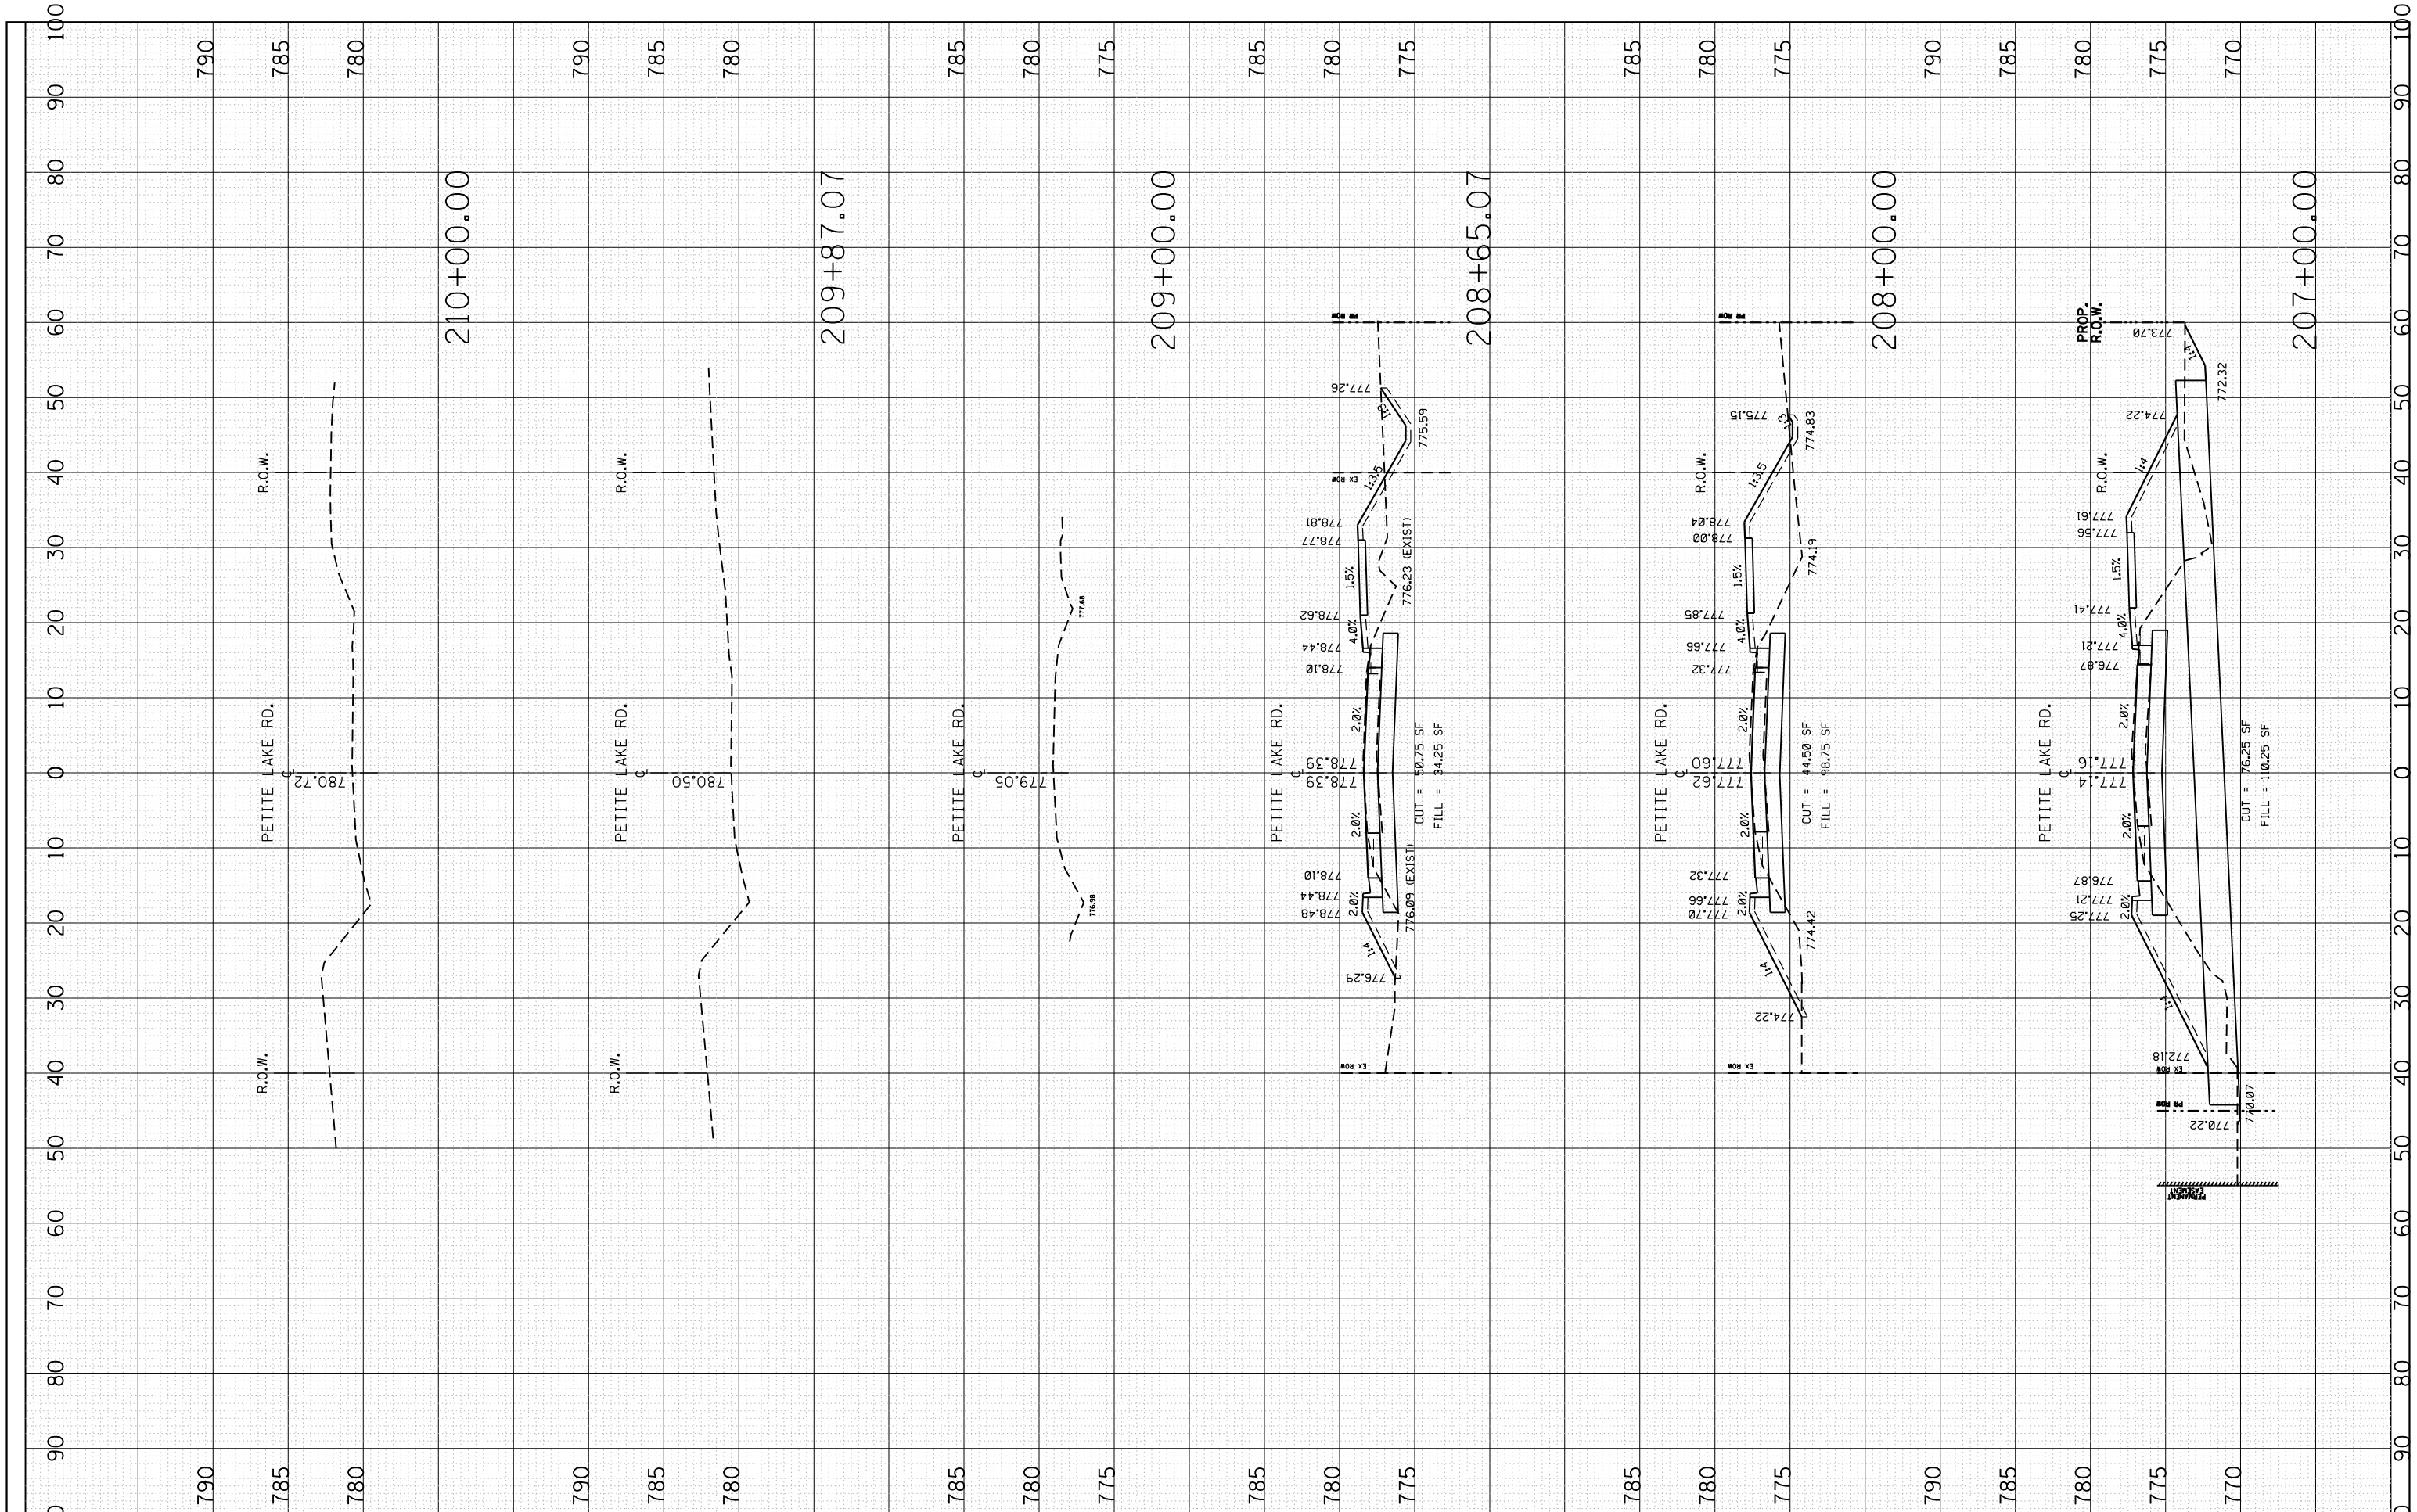

FILE NAME = p:\11084EBIDINTEG\Illinois.gov\PIWIDOT\Documents\DOT Offices\District 1\Projects\P145409\CADD\Drawings\P145409-sht-xssht-Petite.dgn  
 USER NAME = ledeznorm  
 PLOT SCALE = 20.0000' / in.  
 PLOT DATE = 8/19/2016

DESIGNED -  
 CHECKED -  
 DATE -

REVISED -  
 REVISED -  
 REVISED -  
 REVISED -

**STATE OF ILLINOIS  
 DEPARTMENT OF TRANSPORTATION**

CROSS SECTION  
 PETITE LAKE ROAD  
 SCALE: SHEET OF SHEETS STA. 207+00.00 TO STA. 210+00.00

F.A.P. RE.	SECTION	COUNTY	TOTAL SHEETS	SHEET NO.
104	105N-4	LAKE	113	113
CONTRACT NO. 60W06				
ILLINOIS FED. AID PROJECT				