


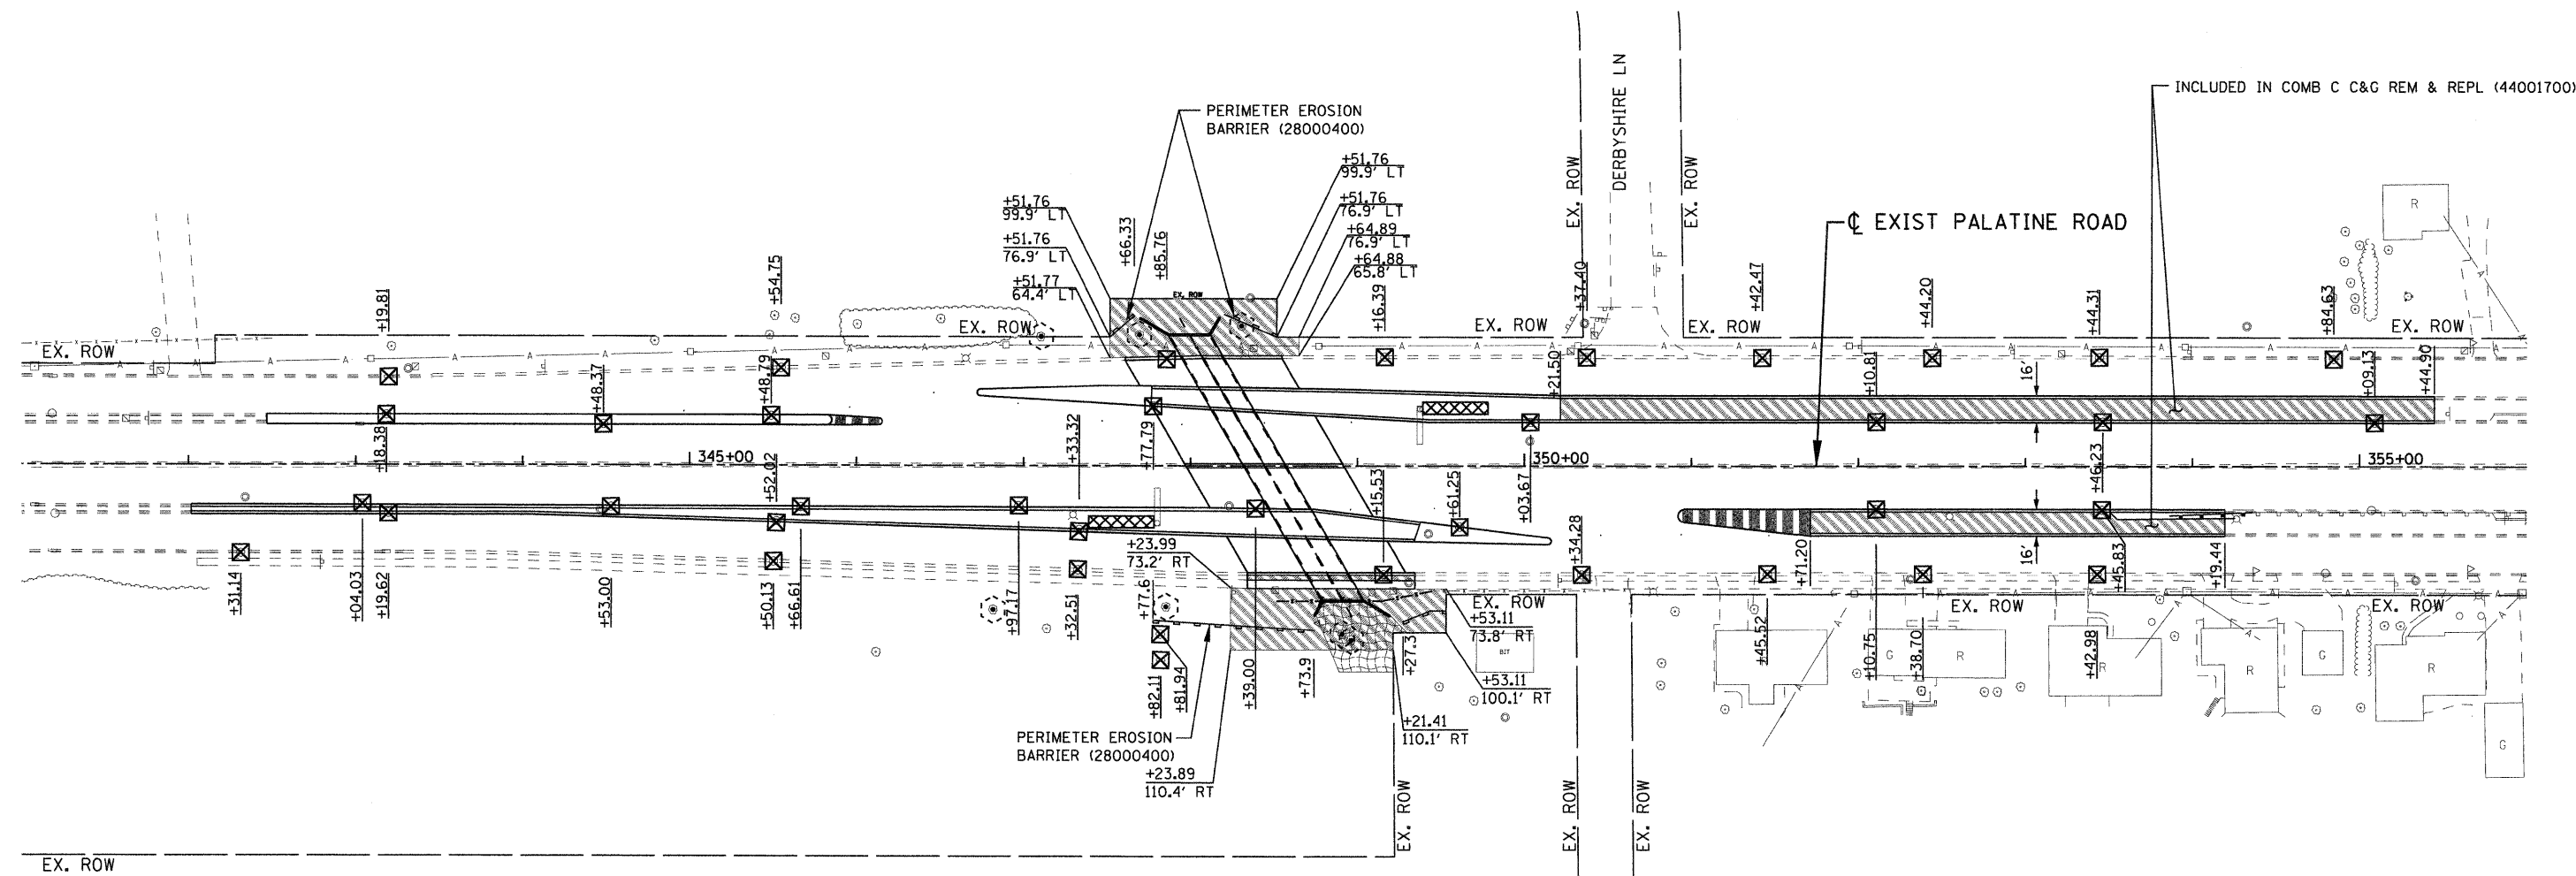


EROSION CONTROL LEGEND


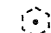
-  EROSION CONTROL BLANKET (25100630)
-  INLET FILTERS (28000510)
-  PERIMETER EROSION BARRIER (SILT FENCE) (28000400)




EROSION CONTROL NOTES

1. TEMPORARY EROSION CONTROL DEVICES SHALL BE CONSTRUCTED AS SHOWN ON THE PLANS.
2. THE CONTRACTOR SHALL CONFINE ACTIVITIES TO FALL WITHIN THE EXISTING RIGHT-OF-WAY AS SHOWN ON THE PLANS.
3. ANY DEVIATION FROM THE TEMPORARY EROSION CONTROL PLAN OR SCHEDULE BY THE CONTRACTOR SHALL BE AT THE DISCRETION OF THE ENGINEER.
4. PERIMETER EROSION BARRIER IS TO BE INSTALLED IN ALL AREAS PRIOR TO START OF CONSTRUCTION.
5. INLET AND PIPE PROTECTION FOR EXISTING STRUCTURES SHALL BE INSTALLED AT THE START OF CONSTRUCTION.

LEGEND

-  SEEDING, CLASS 4 (25000310)
-  TREE TRUNK PROTECTION (20101100)

FILE NAME =	USER NAME = 2pamid	DESIGNED - DLP	REVISED -  10/9/09	STATE OF ILLINOIS DEPARTMENT OF TRANSPORTATION	McDONALD CREEK CULVERT EROSION CONTROL AND LANDSCAPING PLANS	F.A.P. RTE. 305	SECTION 0913.1-T	COUNTY COOK	TOTAL SHEETS 39	SHEET NO. 18		
CONTRACT NO. 60E53	SCALE: 1"= 50'		SHEET NO. OF SHEETS STA. TO STA.			FED. ROAD DIST. NO. 1 ILLINOIS FED. AID PROJECT						
		DRAWN - ENTRAN	REVISED -									
		CHECKED - TMH	REVISED -									
		DATE - 03/09	REVISED -									