
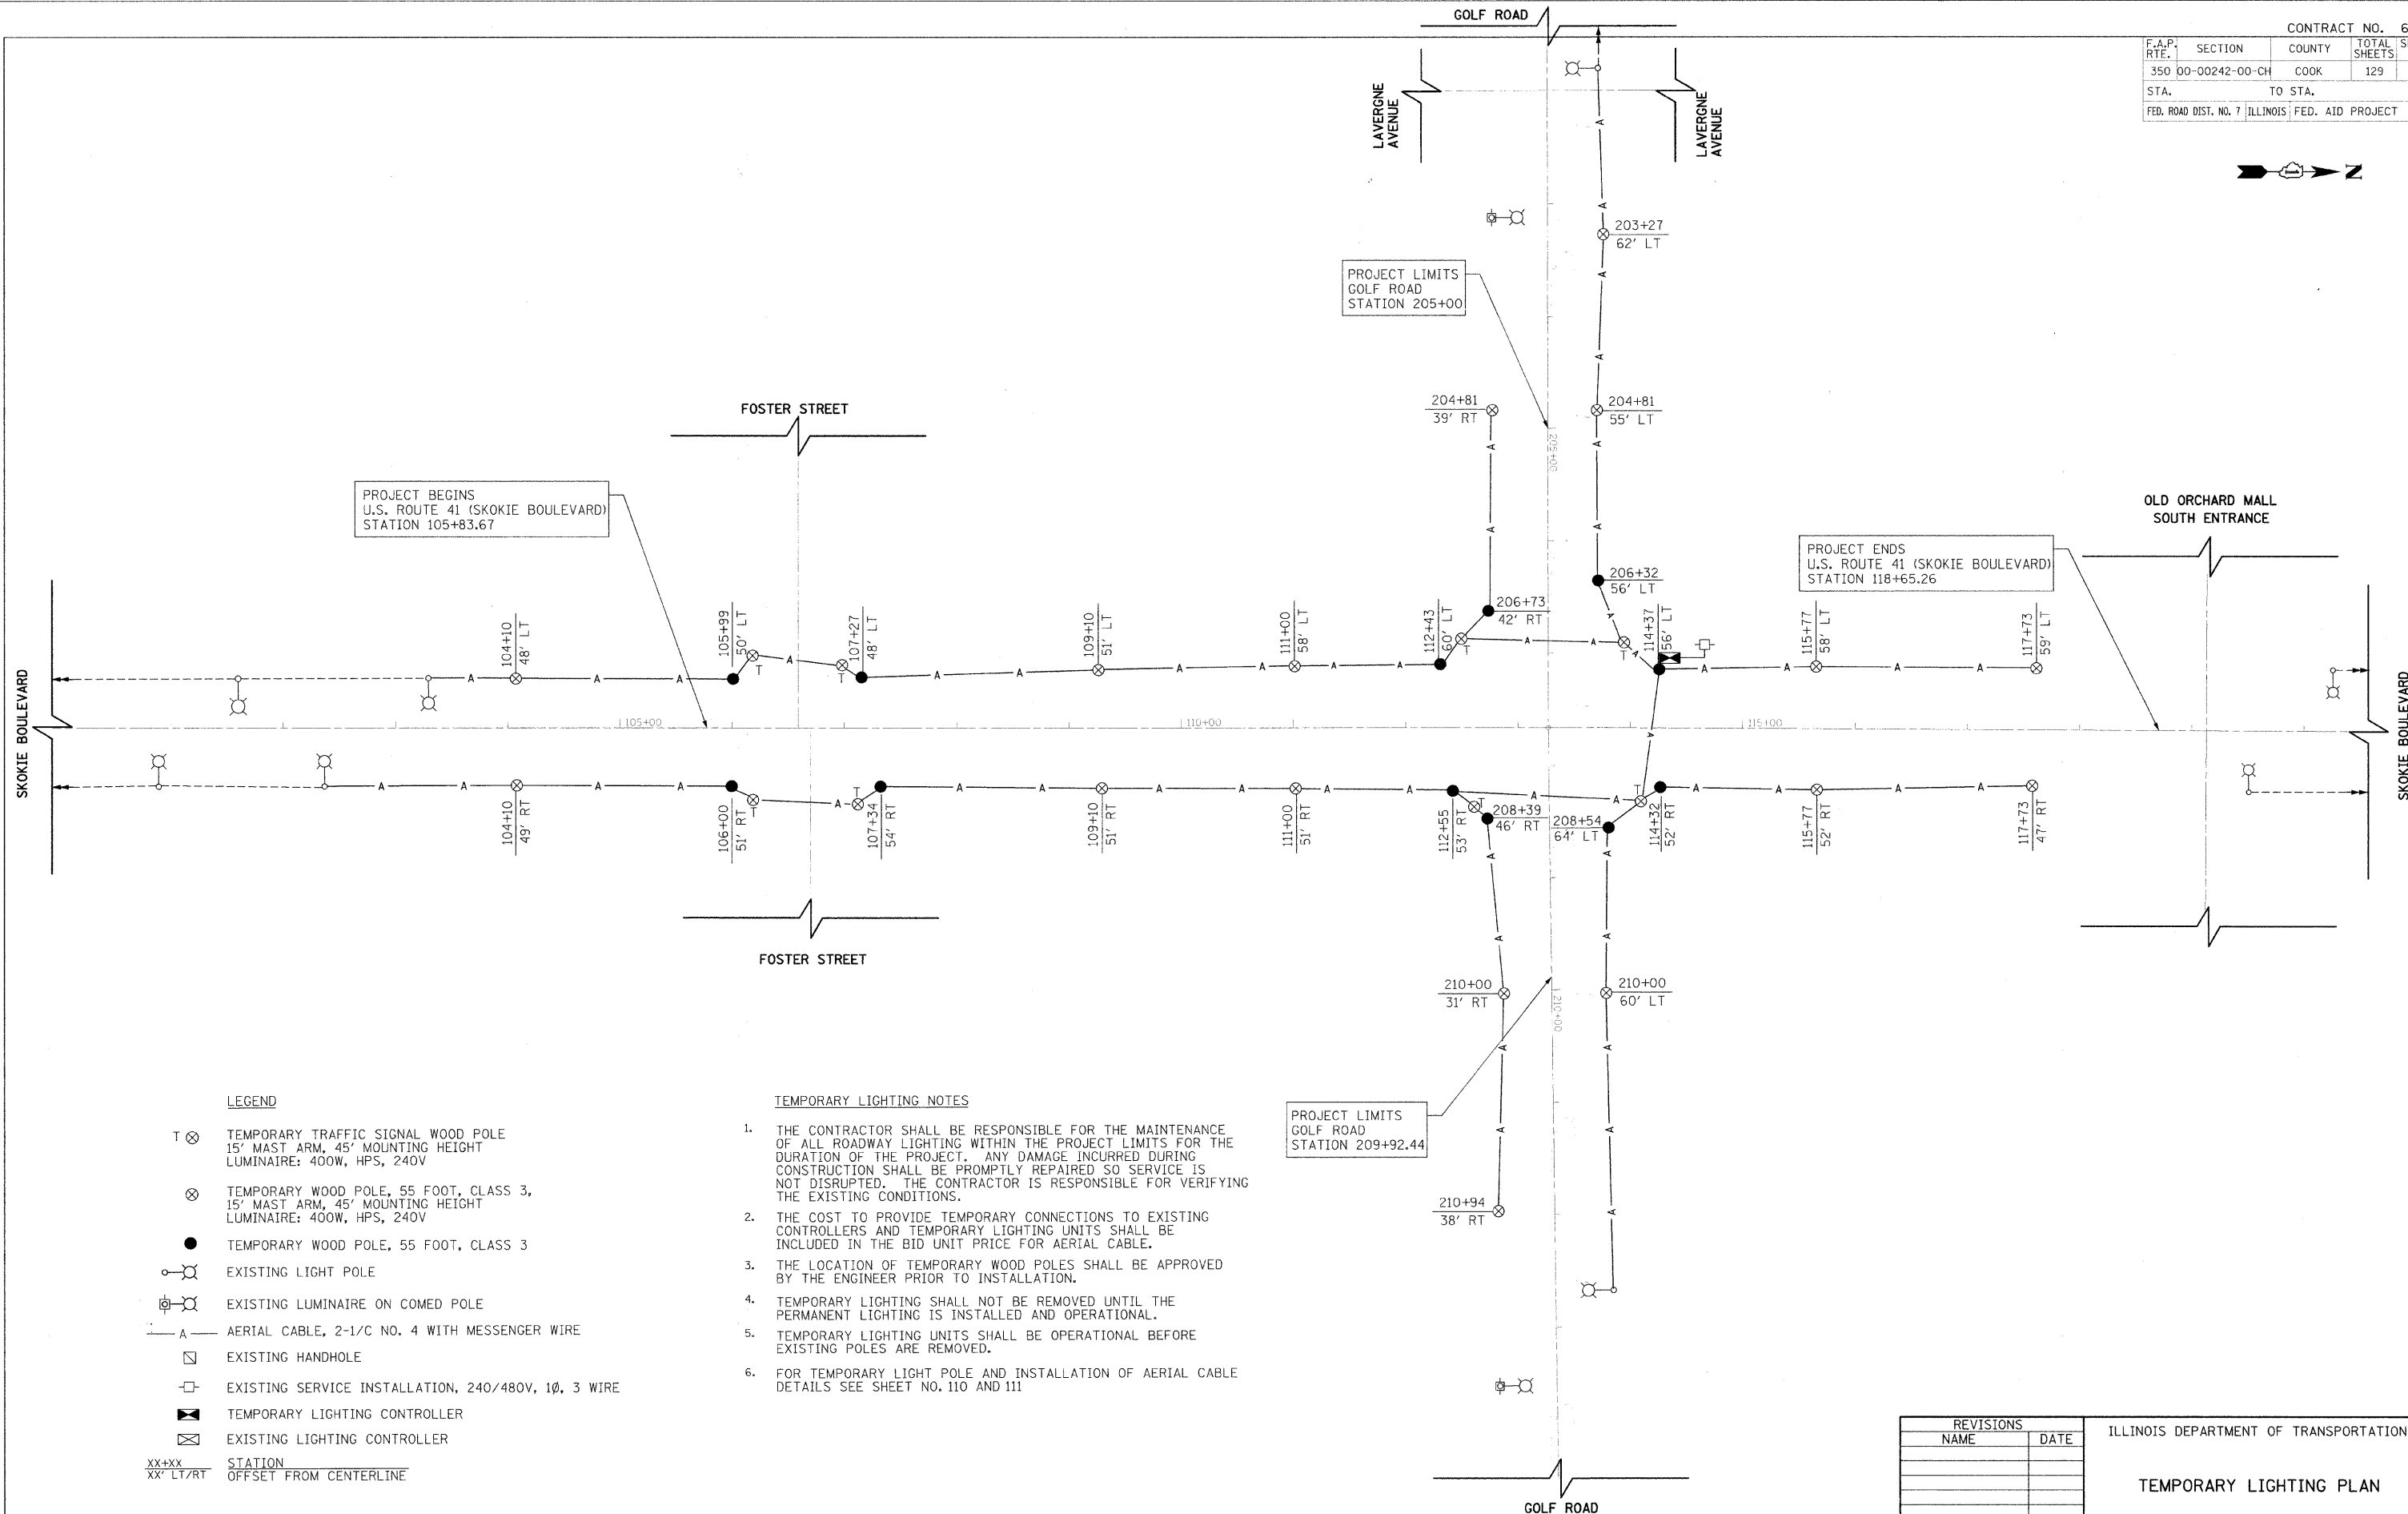


F.A.P. RTE.	SECTION	COUNTY	TOTAL SHEETS	SHEET NO.
350	00-00242-00-CH	COOK	129	90
STA.		TO STA.		
FED. ROAD DIST. NO. 7 ILLINOIS FED. AID PROJECT				

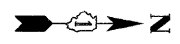

PROJECT BEGINS
U.S. ROUTE 41 (SKOKIE BOULEVARD)
STATION 105+83.67

PROJECT ENDS
U.S. ROUTE 41 (SKOKIE BOULEVARD)
STATION 118+65.26

PROJECT LIMITS
GOLF ROAD
STATION 205+00

PROJECT LIMITS
GOLF ROAD
STATION 209+92.44

LEGEND

- T ⊗ TEMPORARY TRAFFIC SIGNAL WOOD POLE
15' MAST ARM, 45' MOUNTING HEIGHT
LUMINAIRE: 400W, HPS, 240V
- ⊗ TEMPORARY WOOD POLE, 55 FOOT, CLASS 3,
15' MAST ARM, 45' MOUNTING HEIGHT
LUMINAIRE: 400W, HPS, 240V
- TEMPORARY WOOD POLE, 55 FOOT, CLASS 3
- ⊙ EXISTING LIGHT POLE
- ⊙ EXISTING LUMINAIRE ON COMED POLE
- A — AERIAL CABLE, 2-1/C NO. 4 WITH MESSENGER WIRE
- EXISTING HANDHOLE
- EXISTING SERVICE INSTALLATION, 240/480V, 1Ø, 3 WIRE
- ⊠ TEMPORARY LIGHTING CONTROLLER
- ⊠ EXISTING LIGHTING CONTROLLER
- XX+XX STATION
XX' LT/RT OFFSET FROM CENTERLINE

TEMPORARY LIGHTING NOTES

1. THE CONTRACTOR SHALL BE RESPONSIBLE FOR THE MAINTENANCE OF ALL ROADWAY LIGHTING WITHIN THE PROJECT LIMITS FOR THE DURATION OF THE PROJECT. ANY DAMAGE INCURRED DURING CONSTRUCTION SHALL BE PROMPTLY REPAIRED SO SERVICE IS NOT DISRUPTED. THE CONTRACTOR IS RESPONSIBLE FOR VERIFYING THE EXISTING CONDITIONS.
2. THE COST TO PROVIDE TEMPORARY CONNECTIONS TO EXISTING CONTROLLERS AND TEMPORARY LIGHTING UNITS SHALL BE INCLUDED IN THE BID UNIT PRICE FOR AERIAL CABLE.
3. THE LOCATION OF TEMPORARY WOOD POLES SHALL BE APPROVED BY THE ENGINEER PRIOR TO INSTALLATION.
4. TEMPORARY LIGHTING SHALL NOT BE REMOVED UNTIL THE PERMANENT LIGHTING IS INSTALLED AND OPERATIONAL.
5. TEMPORARY LIGHTING UNITS SHALL BE OPERATIONAL BEFORE EXISTING POLES ARE REMOVED.
6. FOR TEMPORARY LIGHT POLE AND INSTALLATION OF AERIAL CABLE DETAILS SEE SHEET NO. 110 AND 111

PLOT DATE = 11/14/2008
PLOT SCALE = 1"=50'
USER NAME = BUSERS

REVISIONS	
NAME	DATE

ILLINOIS DEPARTMENT OF TRANSPORTATION

TEMPORARY LIGHTING PLAN

DATE 11-14-08
DRAWN BY SRS
CHECKED BY KMM

NOT TO SCALE